


Additions and Alterations to:
Waverly High School

60-01-01-06-0-018-023



Waverly Central School District
Waverly, NY

Drawing List		
GENERAL		
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ARCHITECTS & ENGINEERS

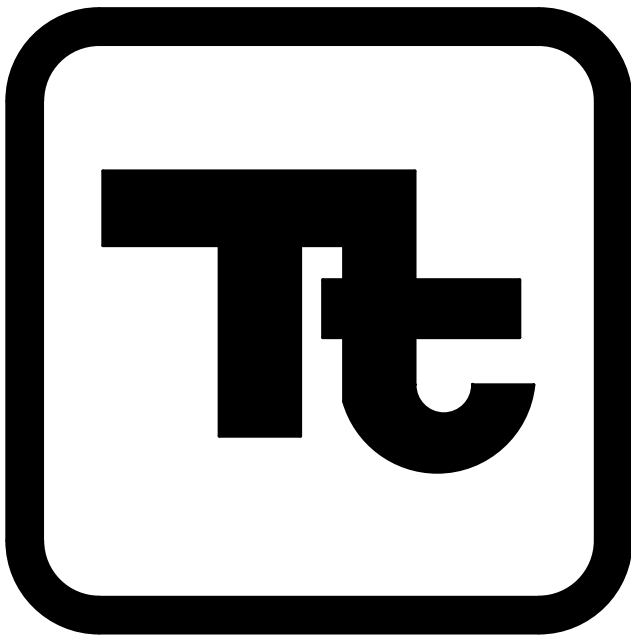Architecture Engineering Planning
& High Performance Facilities

Tetra Tech Engineers, Architects & Landscape Architects, P.C.

To the best of the Architect's knowledge, information and belief, the design of this project conforms to all applicable provisions of the New York State Uniform Fire Prevention and Building Code, the New York State Energy Conservation Code, and the building standards of the New York State Education Department.

BID SET

Volume 1 of 2

339070-22003
05/19/2023

Set No.


































Drawing Number:

G001

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A horizontal number line with arrows at both ends. There are two major tick marks labeled '5' and '6'. A single tick mark is placed exactly halfway between 5 and 6.


E	EA	EAST
EA	EA	EXHAUST AIR, EACH
EA	EA	ENTERING AIR TEMPERATURE
EA	EB	EXHAUST BOLT
EA	EC	ELECTRICAL CONTRACT
EA	ECF	ENHANCED CONCRETE
EA	EIFS	EXTERIOR INSULATION
EA	EJ	EXPOSED SURFACE, EACH
EA	EJ	EXTERIOR JOINT
EA	EL	ELECTRIC (AL)
EA	ELEM	ELEMENT
EA	ELEV	ELEVATION, ELEVATOR
EA	EM	EMERGENCY
EA	EMT	ELECTRICAL METALLIC TUBING
EA	ENC	ENCLOSURE
EA	EOD	EDGE OF DECK
EA	EO	EDGE OF SLAB
EA	EQ	EQUAL, EQUIVALENT
EA	EQC	EQUIPMENT CONTRACT
EA	EQ	EQUIPMENT
EA	ES	EXPOSED SURFACE, EACH
EA	ESF	ELASTIC SHEET FLASHING
EA	ESM	ELASTIC SHEET MATERIAL
EA	EW	EACH WAY
EA	EW	ELECTRIC WATER COLD
EA	EWT	ENTERING WATER TEMPERATURE
EA	EX	EXISTING
EA	EXH	EXHAUST
EA	EXP	EXPANSION
EA	EXT	EXTERNAL, EXTERIOR
EA	F	FAHRENHEIT
EA	FA	FIRE ALARM
EA	FAI	FRESH AIR INTAKE
EA	FCU	FAN COOLING UNIT
EA	FD	FLOOR DRAIN, FIRE DAM
EA	FE	FIRE EXTINGUISHER
EA	FE	FIRE EXTINGUISHER
EA	FEC	FIRE EXTINGUISHER CABINET
EA	FF	FINISH FLOOR FACTORY
EA	FFE	FINISH FLOOR ELEVATION
EA	FL	FINISH FLOOR
EA	FG	FLOOR GRILLE
EA	FH	FIRE HYDRANT
EA	FC	FIRE CODE CABINET
EA	FIN	FINISH (ED)
EA	FX	FIXTURE
EA	FL	FLUSH
EA	FLD	FLOOR DUCT
EA	FLEX	FLEXIBLE
EA	FL	FLASHING
EA	FLR	FLOOR (ING)
EA	FLUOR	FLUORESCENT
EA	FLM	FLOOR MOUNTED
EA	FMC	FLEXIBLE METAL CONDUIT
EA	FND	FOUNDATION
EA	FB	FRIGHT ON BOARD, FL
EA	FOG	FUEL OIL, SUPPLY
EA	FOG	FUEL OIL, RETURN
EA	FOG	FUEL OIL, GAUGE
EA	FOG	FUEL OIL, VALVE

ATV	ATMOSPHERIC VENT
BBD	BOILER BLOW DOWN
CWS	CHILLED WATER SUPPLY
CWR	CHILLED WATER RETURN
CGS	CHILLED GLYCOL SUPPLY
CGR	CHILLED GLYCOL RETURN
CDR	CONDENSATE DRAIN
C	CONDENSER WATER SUPPLY
CR	CONDENSER WATER RETURN
GS	GLYCOL SUPPLY
GR	GLYCOL RETURN
HGS	HOT GLYCOL SUPPLY
HGR	HOT GLYCOL RETURN
HPWS	HEAT PUMP SUPPLY
HPWR	HEAT PUMP RETURN
HWS	HOT WATER SUPPLY
HWR	HOT WATER RETURN
HCS	HOT/CHILLED WATER SUPPLY
HCR	HOT/CHILLED WATER RETURN
LPS	LOW PRESSURE STEAM
LPC	LOW PRESSURE CONDENSATE
LPWC	LOW PRESSURE STEAM W/ (FLOODED) CONDENSATE
MJ	MECHANICAL EQUIPMENT N/A UP: COLD WATER/NON-POTABLE
RS	REFRIGERANT SUCT
RL	REFRIGERANT LIQ
HG	REFRIGERANT HOT GAS
PD	PUMP DISCHARGE
----- REMOVE EXG. DUCT, PIPING, EQUIPMENT	
EXO	EXISTING HVAC PIPE
	BOTTOM PIPE CONNECTION
	TOP PIPE CONNECTION
	PIPE ELBOW DOWN
	PIPE ELBOW UP
	PIPE DOWN WITH CLEANOUT
	PIPE DOWN WITH SHUTOFF
	CAP OR PLUG
	FLANGE CONNECTION
	PIPING REDUCER (CONCENTRIC)
	PIPING REDUCER (ECCENTRIC)
	PIPE ANCHOR
	PIPE GUIDE
	EXPANSION COMPENSATOR
	EXPANSION JOINT
	FLEX CONNECTOR
	TEMPERATURE OR PRESSURE PROBE WELL
	THERMOMETER
	PRESSURE SWITCH
	PRESSURE GAUGE
	TEMPERATURE/ PRESSURE
	MANUAL AIR VENT
	AUTOMATIC AIR VENT
	STEAM VENT
	VACUUM BREAKER
	FLOW SWITCH
	FLOW METER
	ORIFICE METER
	VENTURI FLOW METER
	WYE STRAINER
	WYE STRAINER WITH BLOWDOWN
	DIRECTION OF FLOW
	PIPE BREAK
	WATER METER

MATERIAL	PERP	PE
MADE UP AIR UNIT	PL	PL
MAXIMUM	PLAM	PLAM
MARKER BOARD	PLAS	PLAS
THOUSAND INCH	PLV	PLV
MOTORIZED	PM	PM
MOTOR	PA	PA
MECHANICAL EQUIPMENT	PNC	PNC
MECHANICAL (L/T)	POC	POC
MEDIUM	POL	POL
MEMBRANE	POS	POS
MEZZANINE	POT	POT
MIXING FAUCET	PRE	PRE
MIXING VALVE (R)	PRP	PRP
MINI HOLE	PREP	PREP
MINIMUM	PRF	PRF
MIRROR	PROU	PROU
MISCELLANEOUS	PS	PS
MASONRY OPENING	PSF	PSF
MODULE (OR) MODEL	PSI	PSI
MO-RECEPT	PT	PT
MULTICOLOR WALL COATING	PTD	PTD
MOUNTED	PTFR	PTFR
MOUNTING	PTP	PTP
MOUNT	PVC	PVC
METAL	PWM	PWM
MARBLE THRESHOLD	PWT	PWT
MILLION	QF	QF
MASONRY VENER REQUIRED	QT	QT
NATURAL	R	R
NORMALLY CLOSED	RA	RA
NATIONAL ELECTRIC CODE	RAID	RAID
NEGATIVE	RAF	RAF
NEUTRALIZATION	RC	RC
NOT IN CONTRACT	RCB	RCB
NUMBER, NORMALLY OPEN	RCA	RCA
NOMINAL	RCP	RCP
NOISE REDUCTION COEFFICIENT	RCU	RCU
NOT TO SCALE	REC	REC
OVERALL, OUTSIDE AIR	RECD	RECD
ON CENTER	REF	REF
OUTSIDE DAMPER	REFL	REFL
OVERHEAD	REFR	REFR
OPENING	REHS	REHS
OPENING	RENF	RENF
HD OPPOSITE HAND	REM	REM
PAINT SURFACE(S) INCLUDING SPOTS	RES	RES
PARALLEL	RESIL	RESIL
PARALLEL PARTITION	RESL	RESL
PLUMBING CONTRACT (OR),	REV	REV
PIGMENTED CONCRETE	RFG	RFG
PREGAST CONCRETE	RFG	RFG
PORCELAIN ENAMEL	RFH	RFH
PREFABRICATED	RFL	RFL
PERFORATE (ON) ED	RG	RG

A horizontal number line with three tick marks. The first tick mark is labeled '15', the second is labeled '16', and the third is labeled '17'.

	CABLE TRAY - LADDER TYPE
	CABLE TRAY - BASKET TYPE
	SURFACE RACEWAY TYPE AS DESCRIBED ON DWGS.
	COMMUNICATION INTERFACE OUTLET
	CEILING MOUNT SPEAKER
	WALL MOUNT SPEAKER
	VOLUME CONTROL
	HORN SPEAKER
	PROGRAM BELL
	FLOOR BOX
	DOOR RELEASE
	SECURITY ALARM HORN
	SECURITY SENSOR
	GL - GLASS BREAK
	MD - MOTION DETECTOR
	SD - SOUND DETECTOR
	SECURITY DOOR CONTACT
	SECURITY SYSTEM KEYPAD # DENOTES DESIGNATION
	SECURITY CAMERA # DENOTES DESIGNATION
	SECURITY REQUEST TO EXIT SENSOR
	LOW-VOLTAGE POWER SUPPLY # DENOTES DESIGNATION
	SECURITY ELECTRIC LOCKING HARDWARE
	DOOR INTERCOM CALL STATION # DENOTES DESIGNATION
	ACCESS CONTROL CARD READER # DENOTES DESIGNATION
	ADA PUSH BUTTON
	SECURITY CCTV MONITOR
	SECURITY DURESS BUTTON
	EXISTING PANEL TO REMAIN
	EXISTING PANEL TO REPLACE
	NEW PANEL
	SURGE PROTECTION DEVICE
	MOTOR
	NEW MOTOR SEE SCHEDULE FOR DESCRIPTION
	PULL BOX
	JUNCTION BOX
	HAND/HAIR DRYER
	SINGLE RECEPTACLE
	DUPLEX RECEPTACLE
	DOUBLE DUPLEX RECEPTACLE
	SPECIAL PURPOSE RECEPTACLE
	DUPLEX FLOOR RECEPTACLE
	CORD REEL
	TIE/ DATA POWER POLE
	NON-FUSED DISCONNECT SWITCH
	FUSED DISCONNECT SWITCH
	MOTOR STARTER
	COMBINATION STARTER
	CONTACTOR
	ENCLOSED CIRCUIT BREAKER
	EQUIPMENT CONNECTION
	EMERGENCY OFF BUTTON
	TRANSFORMER # DENOTES DESIGNATION REFER TO RISER DIAGRAM
	UTILITY POLE
	UNDERGROUND TELEPHONE
	OVERHEAD TELEPHONE
	UNDERGROUND TELEVISION
	OVERHEAD TELEVISION
	UNDERGROUND LIGHTING
	OVERHEAD LIGHTING
	UNDERGROUND ELECTRIC
	OVERHEAD ELECTRIC
	UNDERGROUND COMPUTER
	OVERHEAD COMPUTER

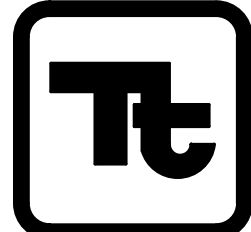complex world		CLEAR SOLUTIONS	BID SET
Tetra Tech Engineers, Architects & Landscape Architects, P.C.			
		TETRA TECH ARCHITECTS & ENGINEERS	
Waverly Central School District Waverly, NY			
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Symbols and Abbreviations - Volume 1			
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Project No.: 339070-22003		G100	









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ARCHITECTS & ENGINEERS

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Waverly Jr. Sr. High School





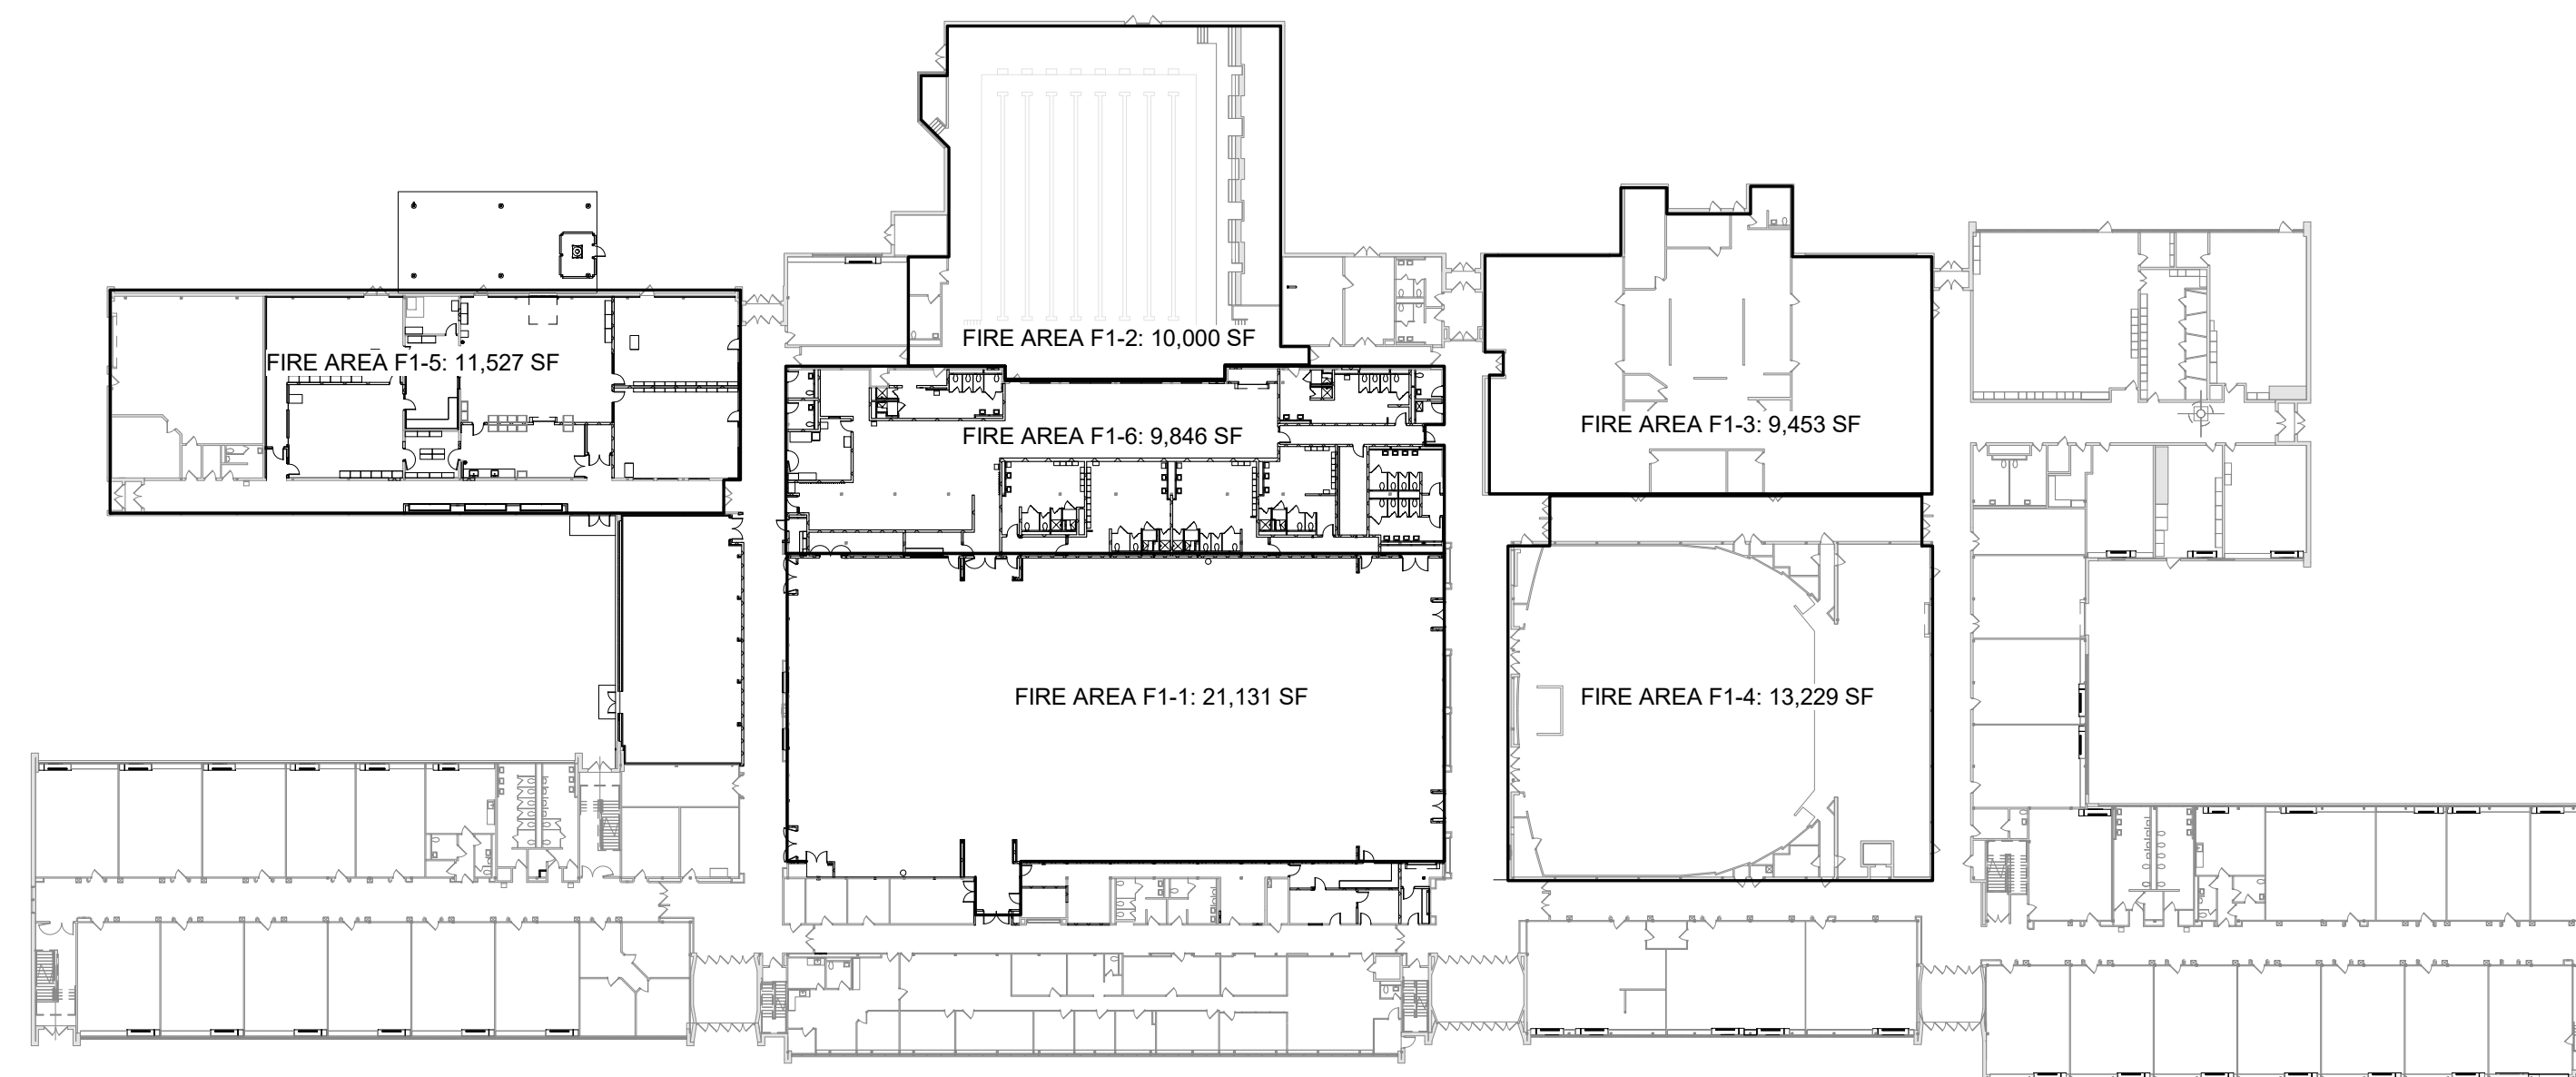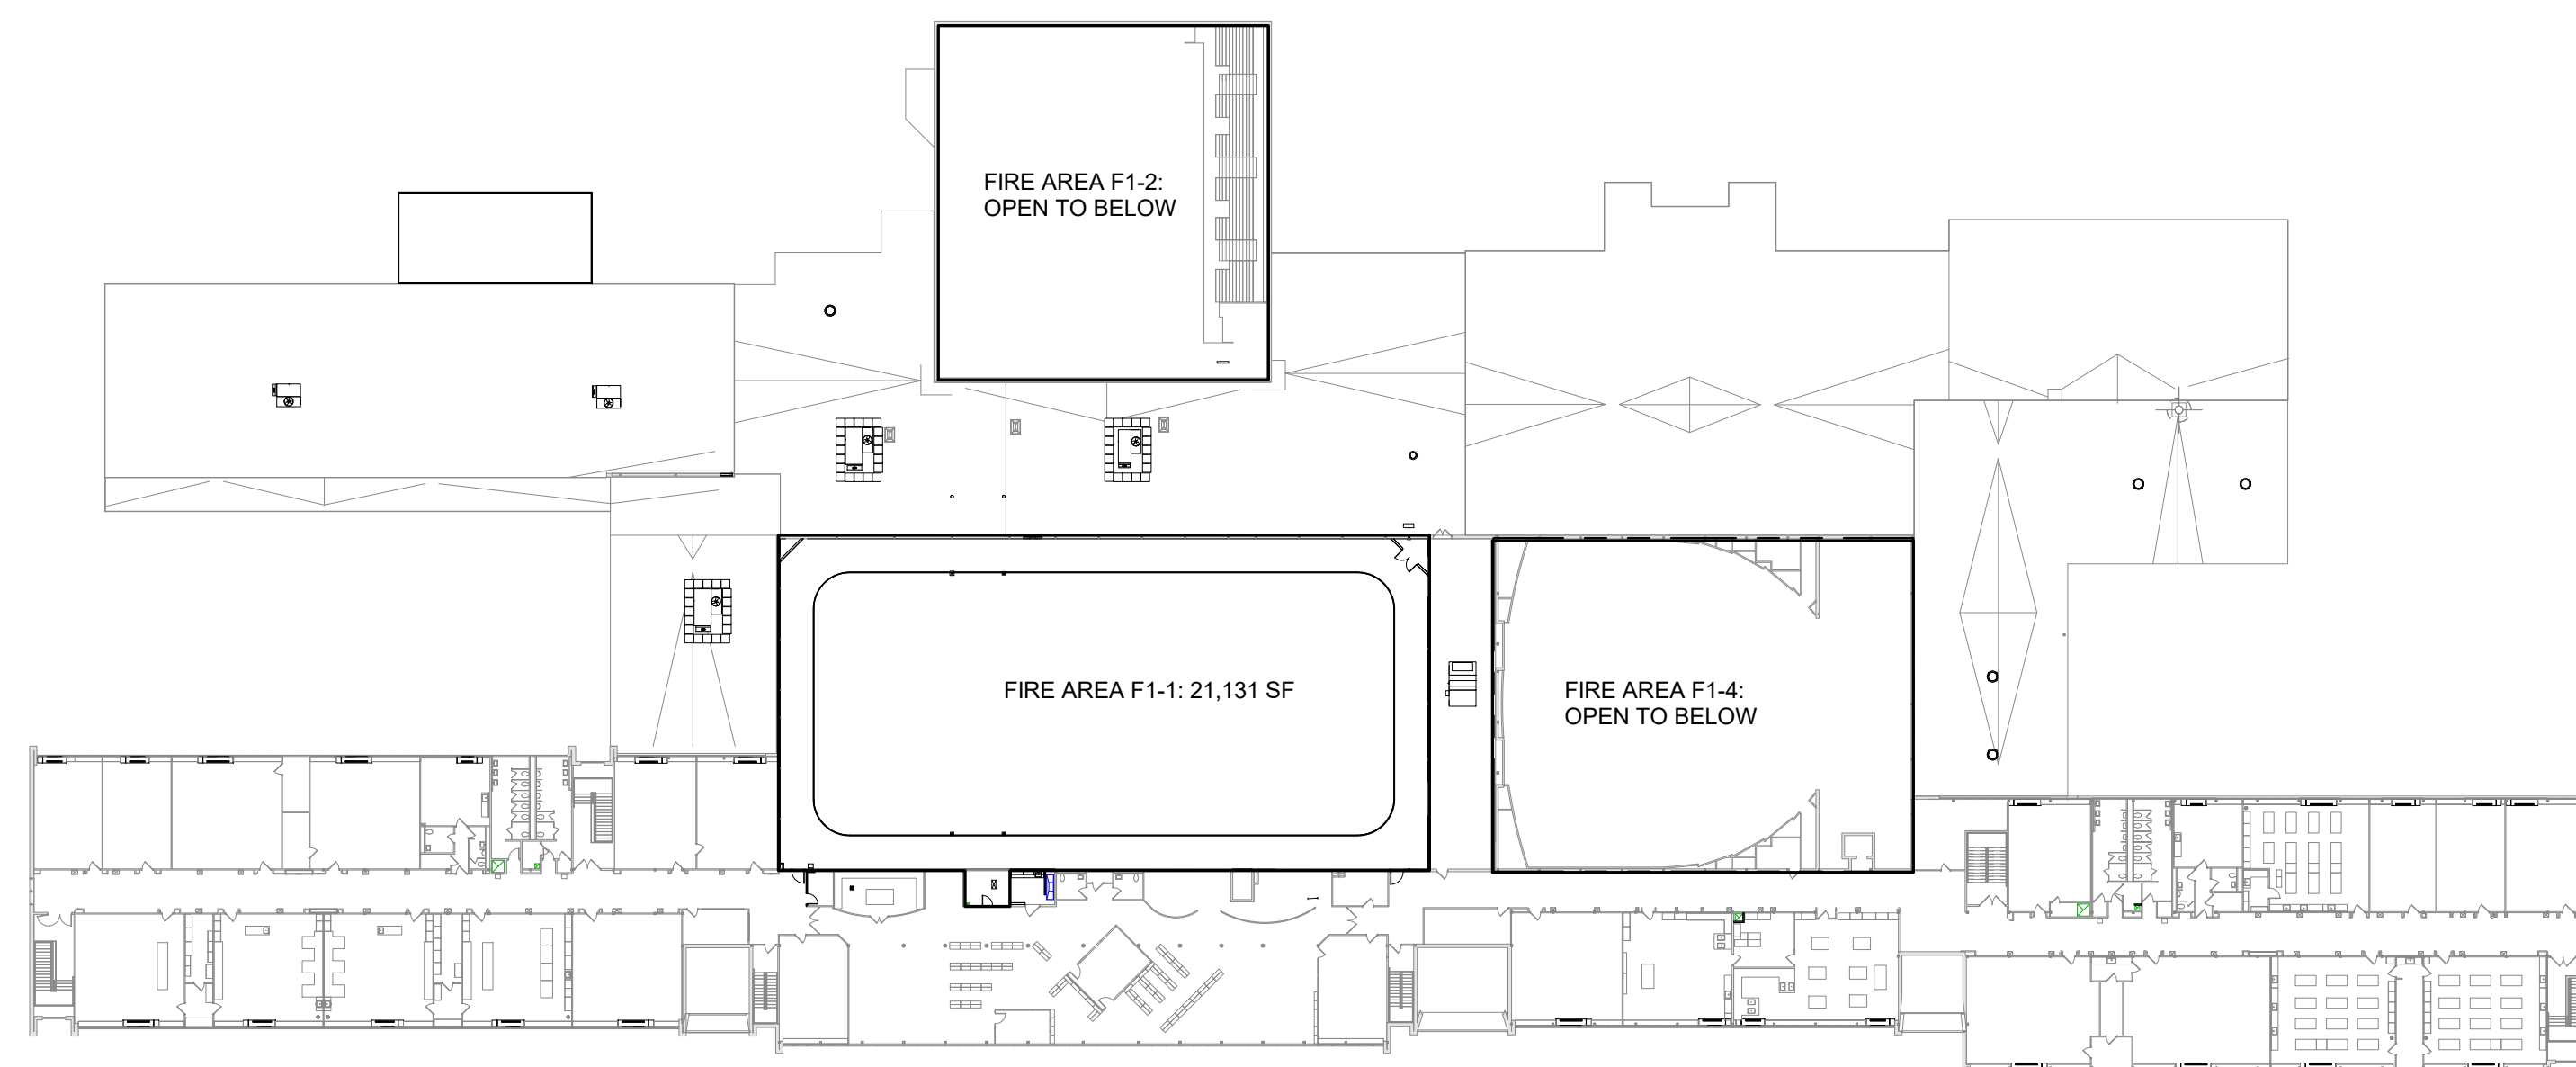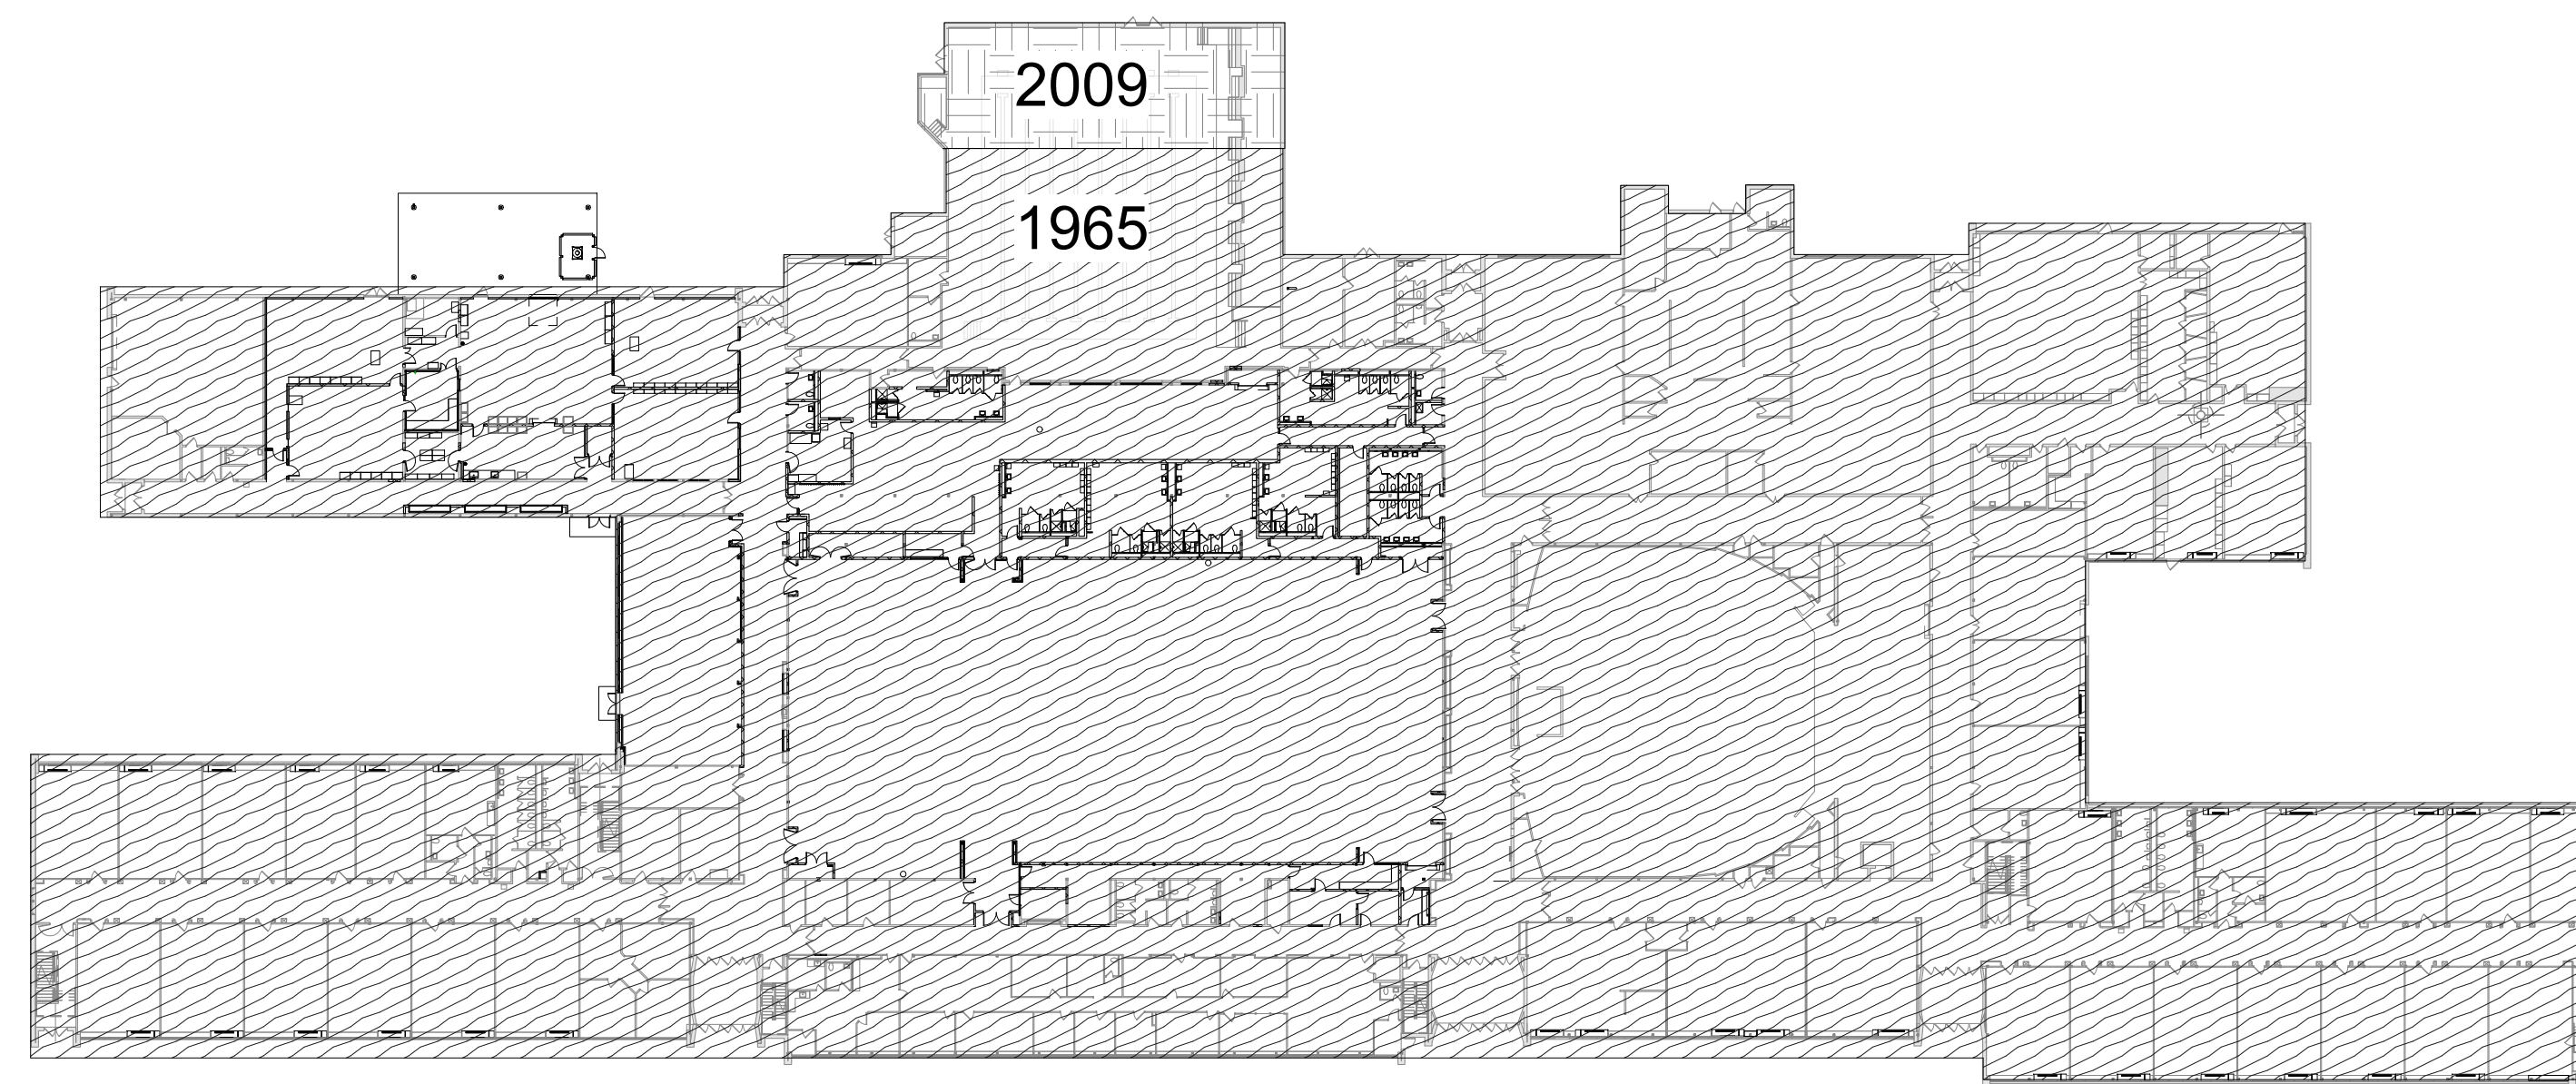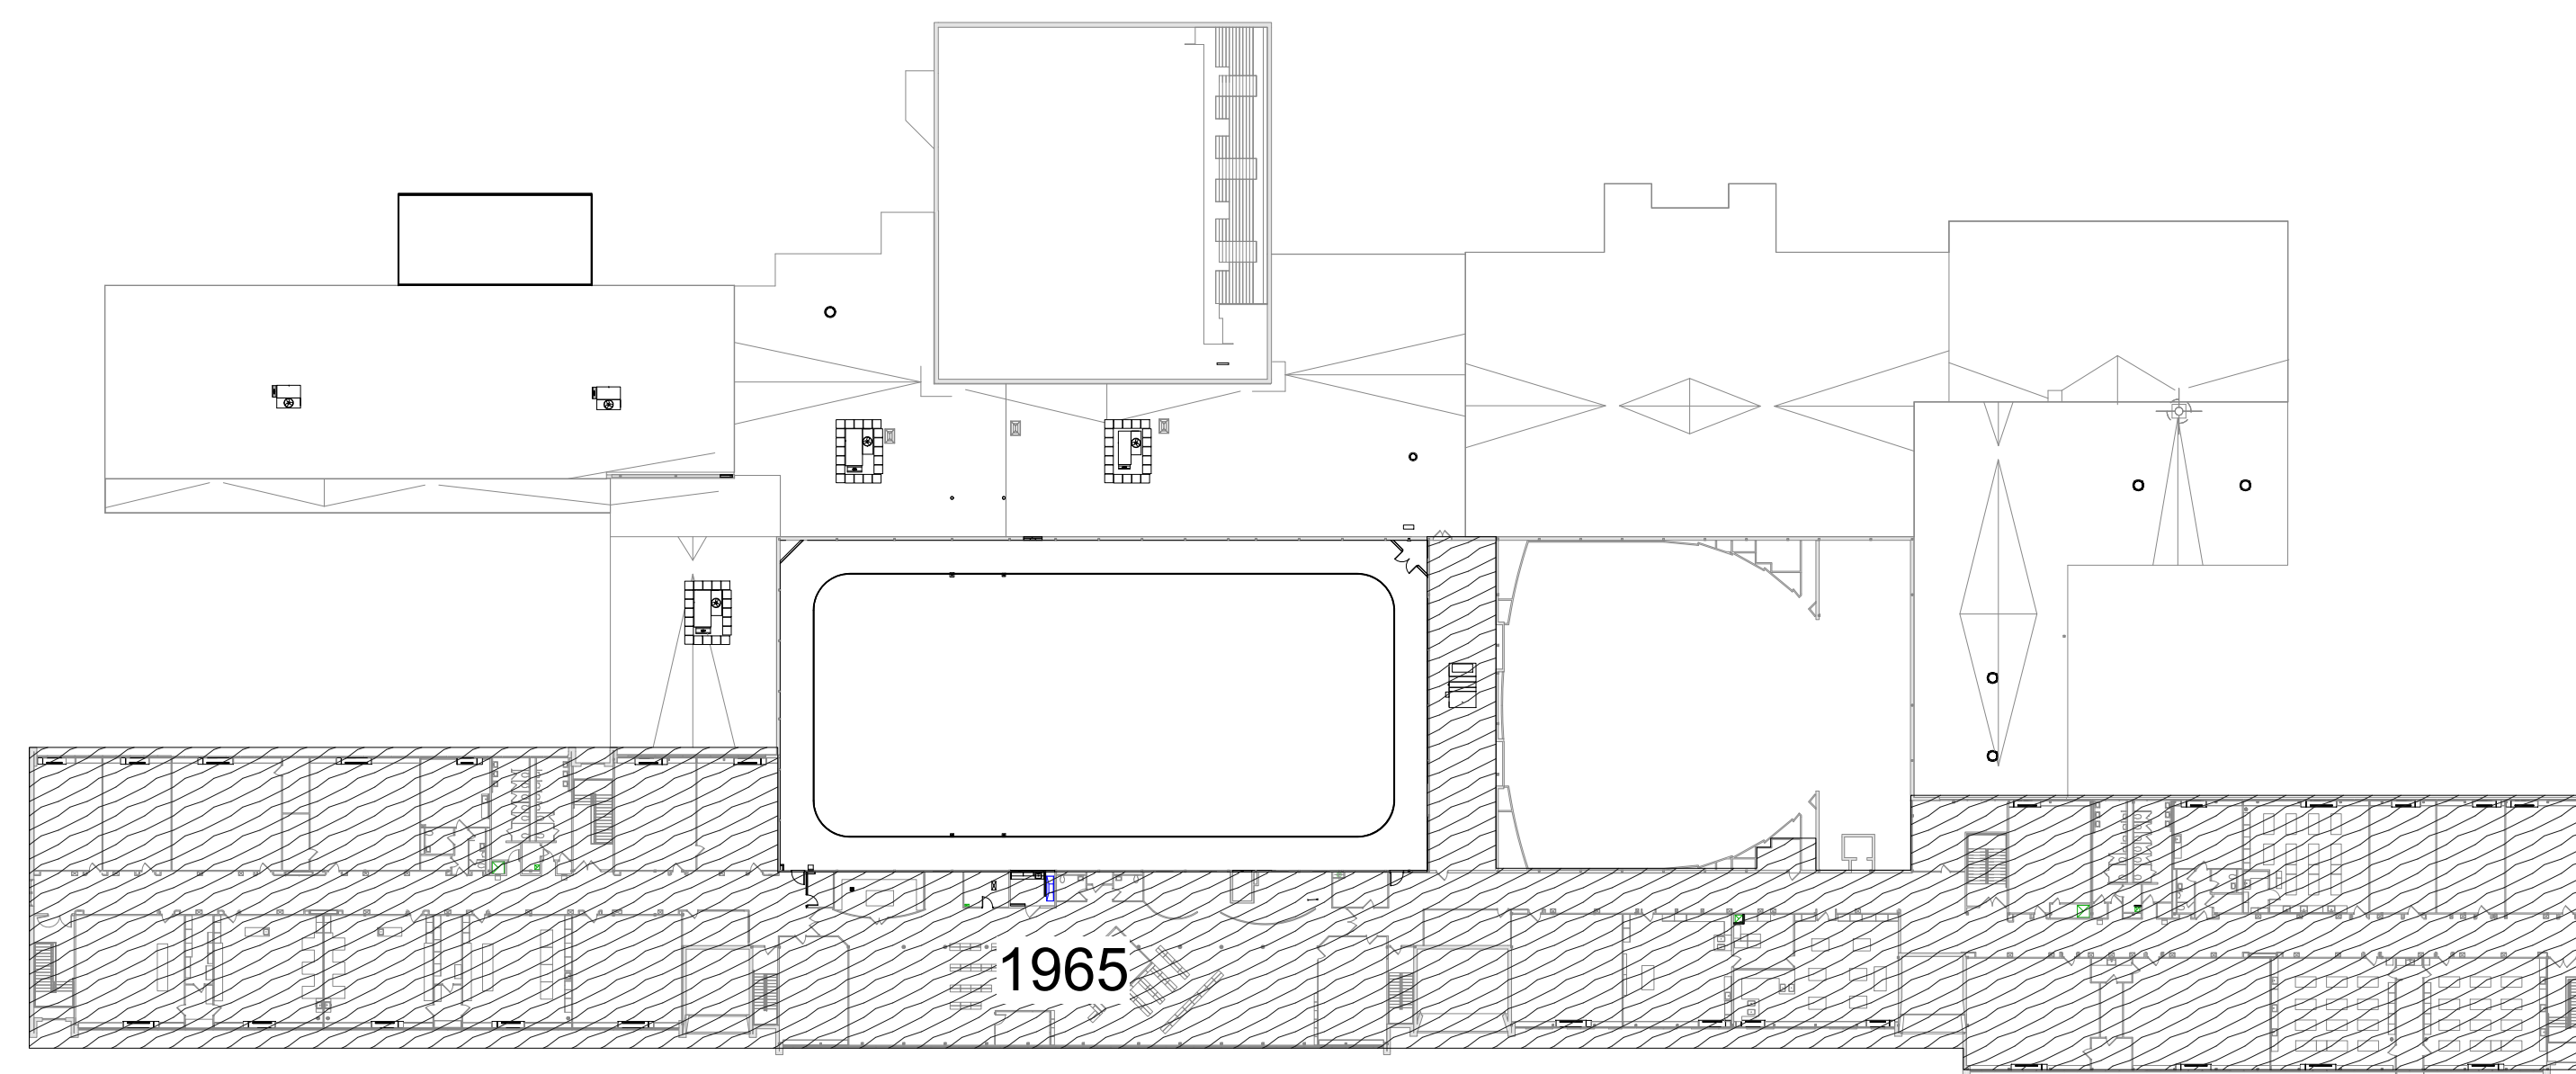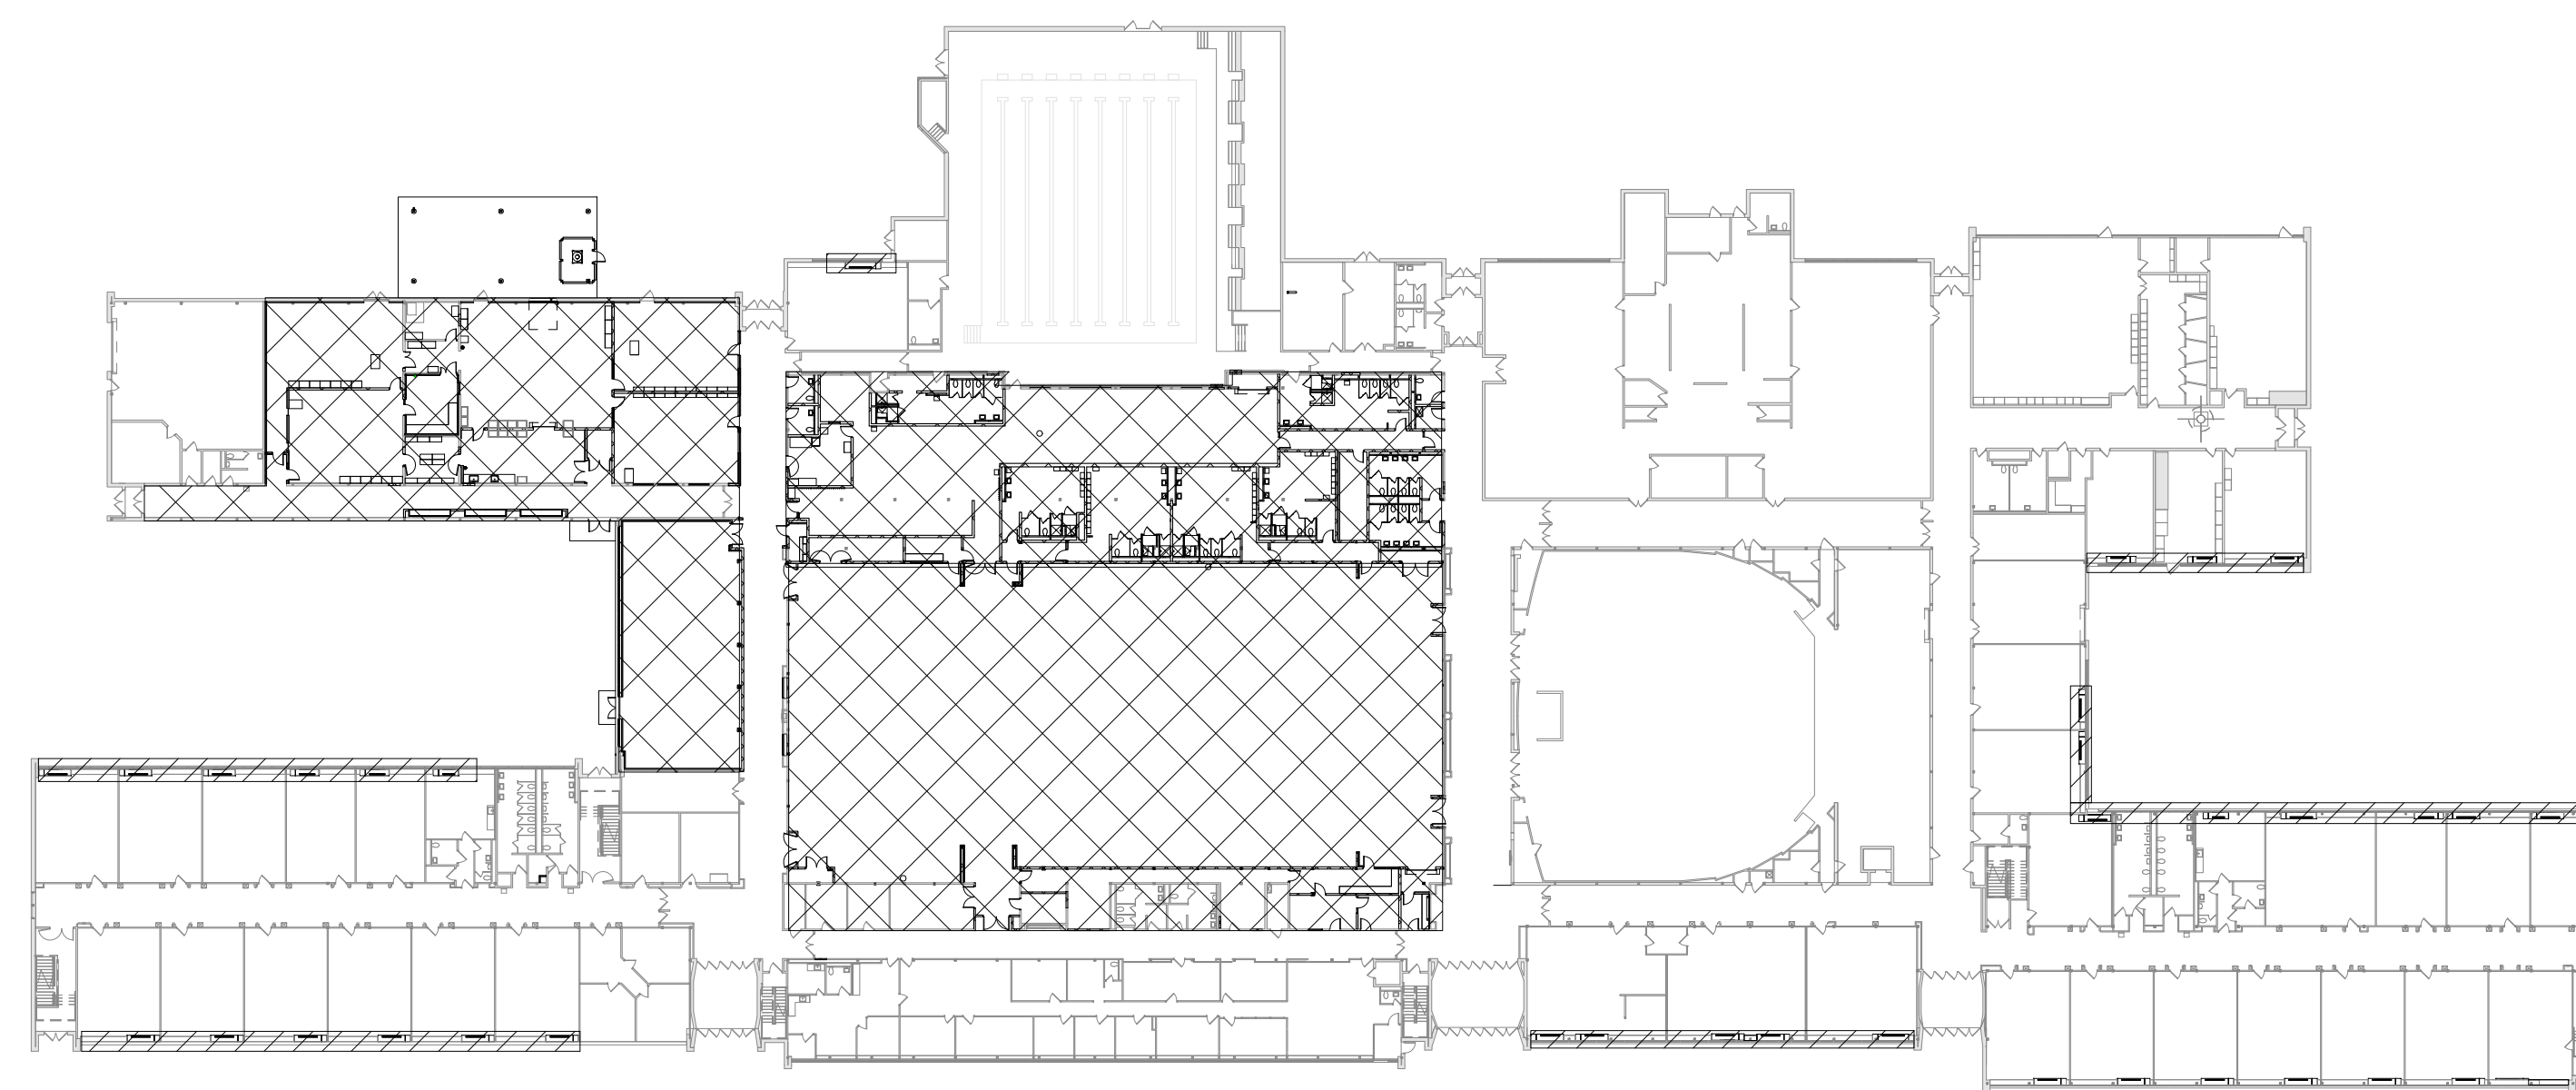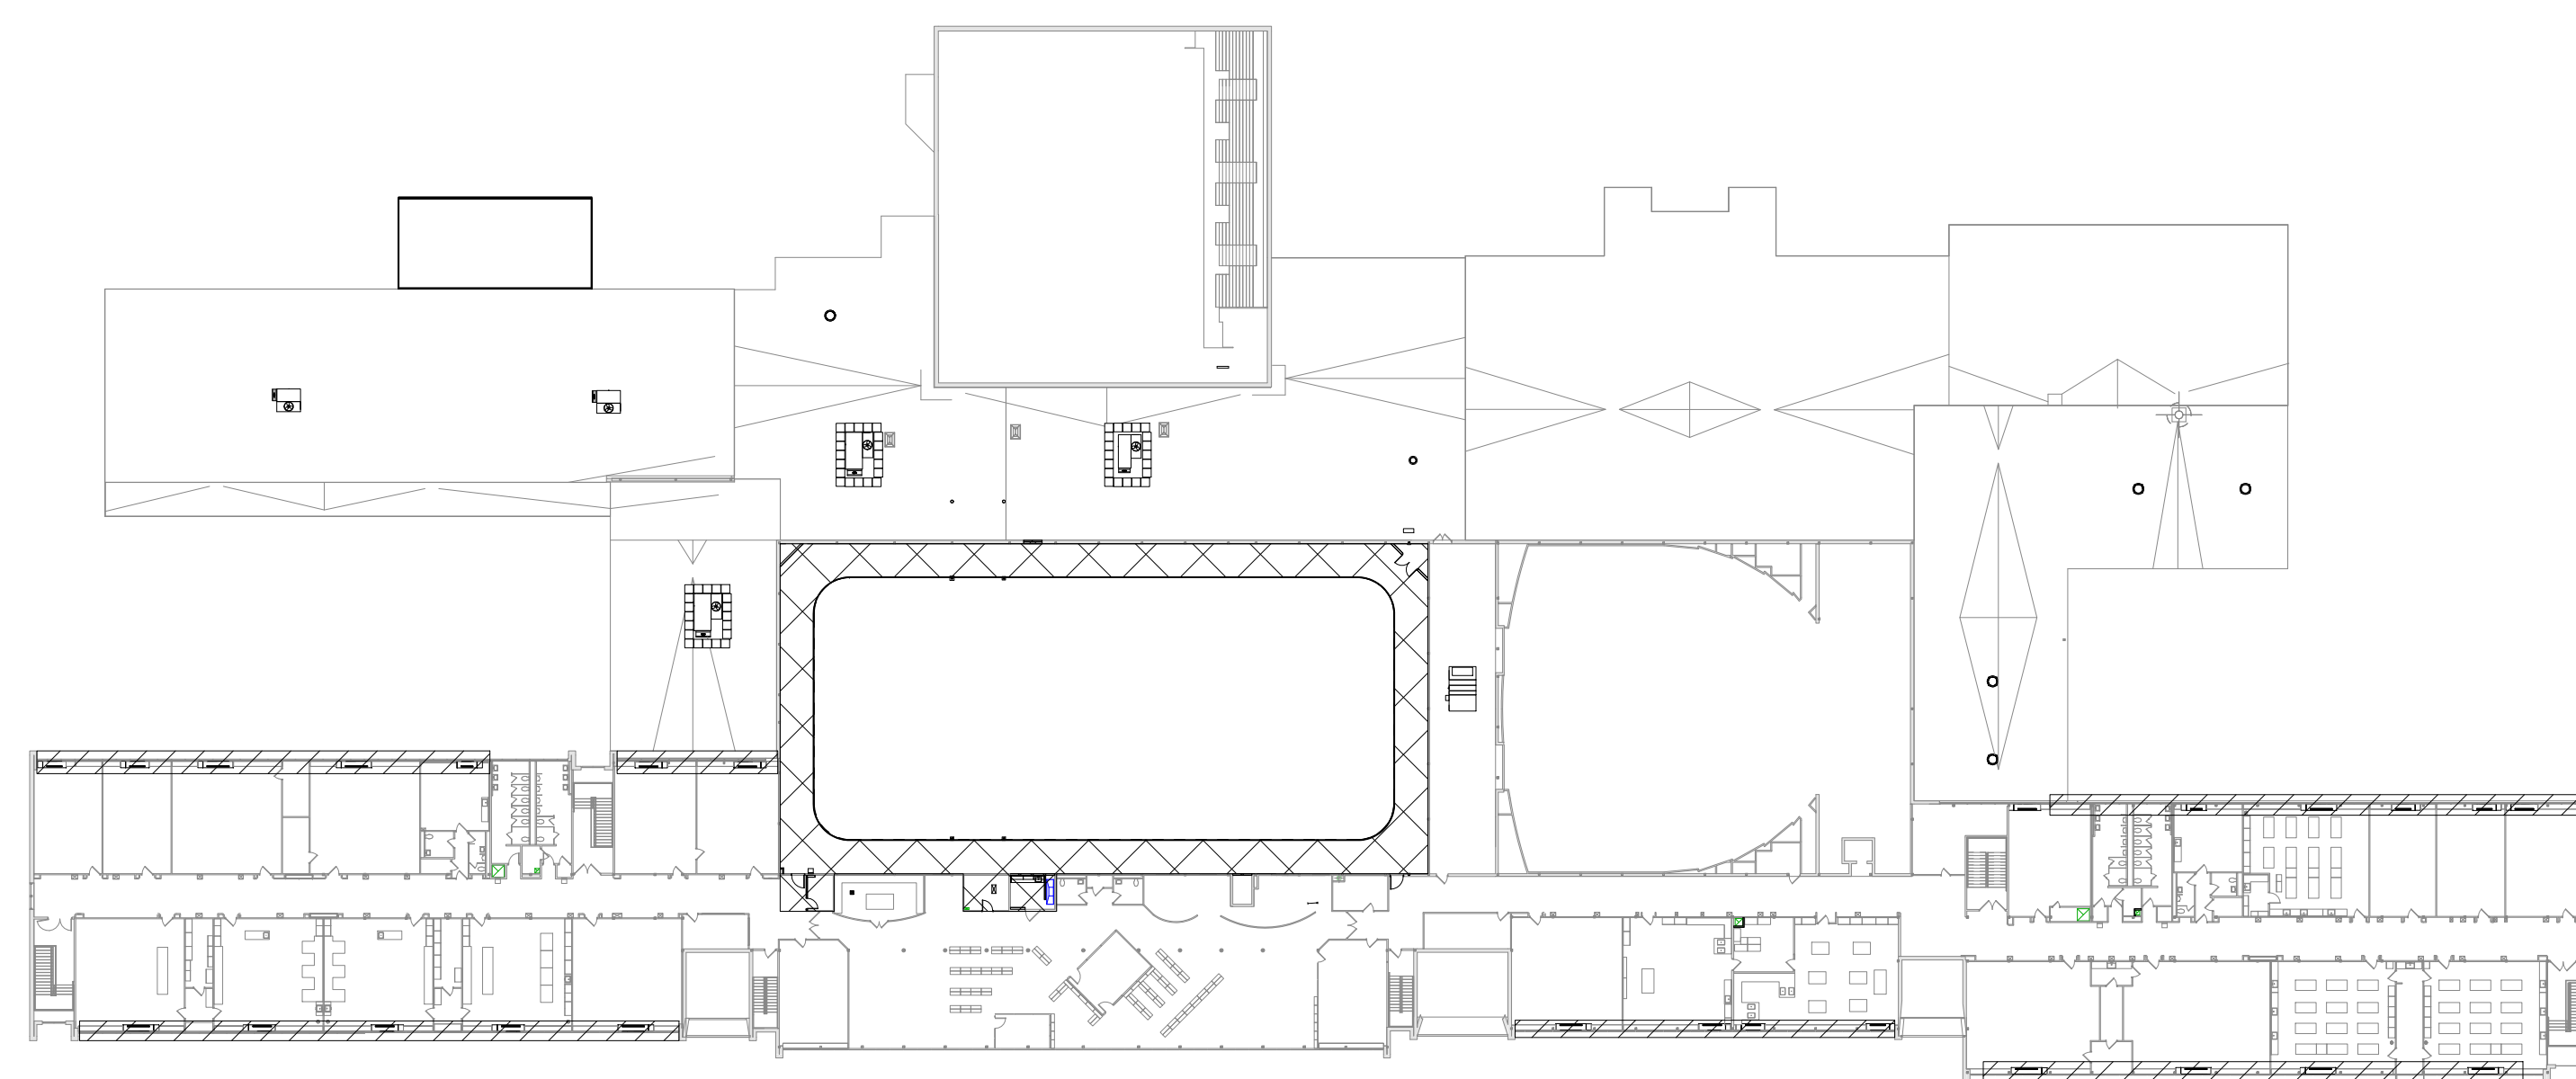

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
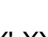




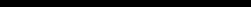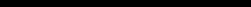


Project No.: 339070-22003



Legend

ALL WALLS, INCLUDING CORRIDOR WALLS, EXTEND TO THE ROOF DECK OR FLOOR DECK ABOVE UNLESS NOTED OTHERWISE.

	2-HOUR FIRE WALL
	2-HOUR FIRE BARRIER
	1-HOUR FIRE BARRIER
	1-HOUR FIRE PARTITION
	SMOKE PARTITION
	COMMON EGRESS PATH

	NUMBER OF OCCUPANTS IN EACH SPACE, UNO
	NUMBER OF OCCUPANTS ALONG EGRESS PATH
	TOTAL EGRESS DISTANCE PER PATH
	NEW FIRE EXTINGUISHER LOCATION
	EXISTING FIRE EXTINGUISHER LOCATION
	AREA OF REFUGE
	AUTOMATED EXTERNAL DEFIBRILLATOR (AED)
	TRUSS TYPE CONSTRUCTION IDENTIFICATION SIGNAGE
	RESCUE WINDOWS ARE SHOWN ON AA050 AND AA051

1969 ORIGINAL BUILDING
TYPE IIB CONSTRUCTION

 2009 ADDITION
TYPE IIB CONSTRUCTION

 LEVEL 1 ALTERATIONS

LEVEL 2 ALTERATIONS

SED Control No. 60-01-01-06-0-018-023

Rev. No.:	Date:	Description:




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CLEAR SOLUTIONS

Tetra Tech Engineers, Architects
& Landscape Architects, P.C.

BID SET

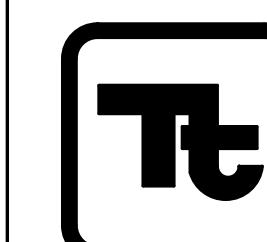

TETRA TECH
ARCHITECTS & ENGINEERS

Waverly Central School District
Waverly, NY

M	Additions and Alterations to: Waverly Jr. Sr. High School
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Code Key Plan - Vintage, Fire Area and Alterations Level First and Second Floor


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Date:	05/19/2023
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Drawing Number:

Project No.:	339070-22003
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AG351



1 First Floor - Occupancy and Egress Key Plan
1" = 20'-0"

General Code Notes

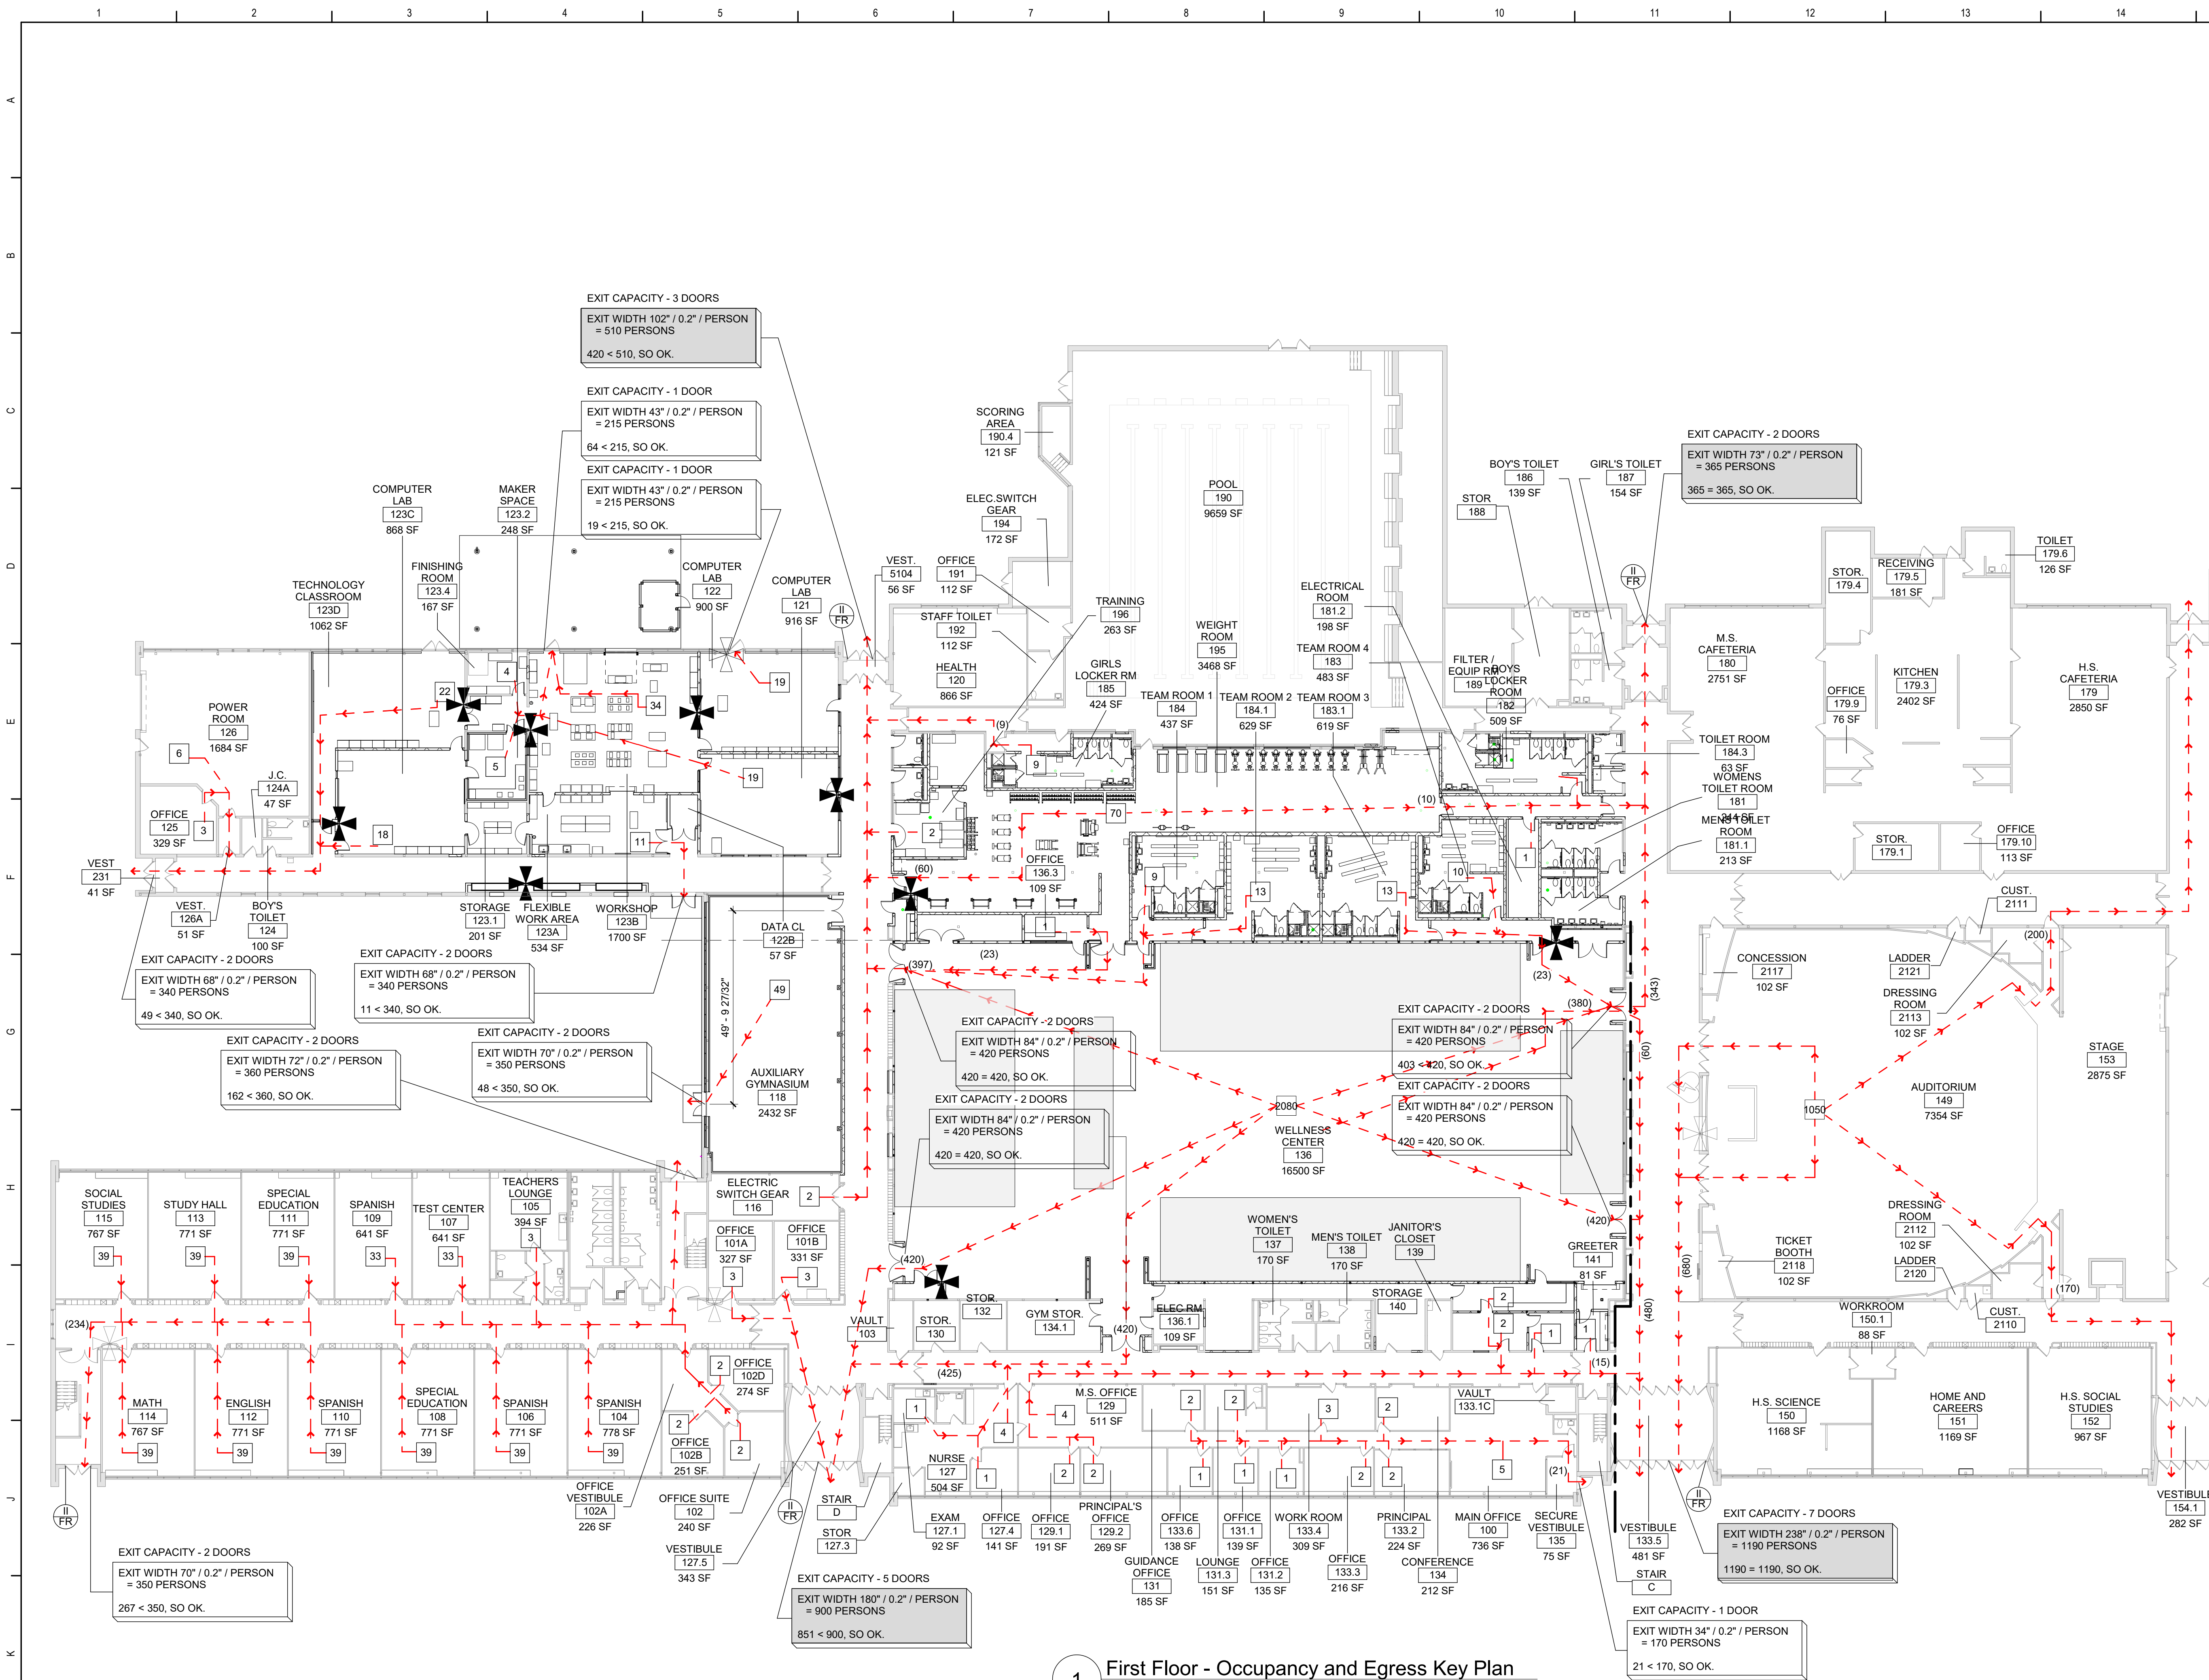- A. REFER TO CODE COMPLIANCE DRAWINGS FOR ADDITIONAL CODE COMPLIANCE INFORMATION.
- C. COORDINATE WITH FLOOR PLANS, WALL SECTIONS AND PARTITION TYPES FOR RATED WALL TYPES AND LOCATIONS. IMMEDIATELY NOTIFY ARCHITECT OF ANY WALL RATING DISCREPANCIES BETWEEN CODE COMPLIANCE DRAWINGS AND FLOOR PLANS.
- D. ALL WALLS, INCLUDING AT CORRIDORS, SHALL EXTEND COMPLETELY TO THE UNDERSIDE OF DECKING, SUPPORTING STRUCTURE OR ROOF ABOVE, TYPICAL UNLESS NOTED OTHERWISE.
- E. AT AREAS OF PROJECT WORK, COMPLETELY SEAL ALL PENETRATIONS REQUIRED TO COMPLY WITH FIRE RESISTANCE RATINGS IDENTIFIED ON THE CODE COMPLIANCE DRAWINGS, REGARDLESS IF WALL IS NEW OR EXISTING, TYPICAL UNLESS NOTED OTHERWISE.
- F. PROVIDE APPLIED FIREPROOFING TO ALL BEAMS, JOISTS AND STRUCTURAL STEEL ELEMENTS AT ALL FIRE BARRIERS, FIRE PARTITIONS, AND OTHER RATED WALLS WHERE INDICATED ON DRAWINGS, AND THAT ARE NOT COMPLETELY PROTECTED WITHIN THE RATED CONSTRUCTION. PROTECTION OF SUCH ELEMENTS SHALL MATCH THE RATING OF THE WALL THAT THE ELEMENTS ARE CONTAINED WITHIN.
- G. ALL CMU CONSTRUCTION SHALL MEET FIRE RESISTANCE REQUIREMENTS INDICATED. PROVIDED BLOCK TYPE AS REQUIRED TO COMPLY WITH UL DESIGN NUMBERS AND WALL RATINGS INDICATED, REGARDLESS IF NOTED AS SUCH ON PLAN DETAILS.

WELLNESS CENTER ASSEMBLY SPACE CALCULATION (MPS 2022):

OCCUPANT LOAD:
ASSEMBLY SPACE: FACTOR:
FLOOR AREA (16,496 SF) 0.20 (5 SQFT PER OCCUPANT)
FLOOR OCCUPANTS (8,780 / 5 SQFT PER OCCUPANT) = 1,756
BLEACHER AREA (7,716 SF) 0.30 (NUMBER OF SEATS)
NUMBER OF SEATS 1,400
FLOOR AREA (16,496 SF) - BLEACHER AREA (7,716 SF) = 8,780 SF

TOTAL OCCUPANCY = 1,756 + 1,400 = 3,156

WELLNESS CENTER CALCULATION FOR NUMBER OF DOORS:
WIDTH (IN INCHES) = OCCUPANT LOAD x FACTOR (INCHES PER OCCUPANT)
FLOOR AREA (1,756 x 0.2" PER OCCUPANT = 351.2")
BLEACHERS (1,400 x 0.3" PER OCCUPANT = 420.0")

WIDTH (IN INCHES) / DOOR SIZE = NUMBER OF DOORS
351.2" / 44" = 8
420.0" / 44" = 10
TOTAL DOORS REQUIRED = 18

CALCULATION TO JUSTIFY LOWER POSTED OCCUPANCY

WELLNESS CENTER EXIT CAPACITY OF 4 NEAREST EXITS:
(CAPACITY BOXES ARE SHADED)

420
365
1,100
840
2,815 - 680 OCCUPANTS FROM AUDITORIUM = 2135 - 55 OCCUPANTS FROM THE TEAM ROOMS = 2,080


****POST MAXIMUM OCCUPANCY IN WELLNESS CENTER AS 2080****

Legend

- ALL WALLS, INCLUDING CORRIDOR WALLS, EXTEND TO THE ROOF DECK OR FLOOR DECK ABOVE UNLESS NOTED OTHERWISE.
- 2-HOUR FIRE WALL
2-HOUR FIRE BARRIER
1-HOUR FIRE BARRIER
1-HOUR FIRE PARTITION
SMOKE PARTITION
COMMON EGRESS PATH

- XX NUMBER OF OCCUPANTS IN EACH SPACE, UNO
(XX) NUMBER OF OCCUPANTS ALONG EGRESS PATH
XX'-XX" TOTAL EGRESS DISTANCE PER PATH
NEW FIRE EXTINGUISHER LOCATION
EXISTING FIRE EXTINGUISHER LOCATION
AREA OF REFUGE
AUTOMATED EXTERNAL DEFIBRILLATOR (AED)
TRUSS TYPE CONSTRUCTION IDENTIFICATION SIGNAGE
RESCUE WINDOWS ARE SHOWN ON AA050 AND AA051

- 1969 ORIGINAL BUILDING
TYPE IIB CONSTRUCTION
2009 ADDITION
TYPE IIB CONSTRUCTION
LEVEL 1 ALTERATIONS
LEVEL 2 ALTERATIONS

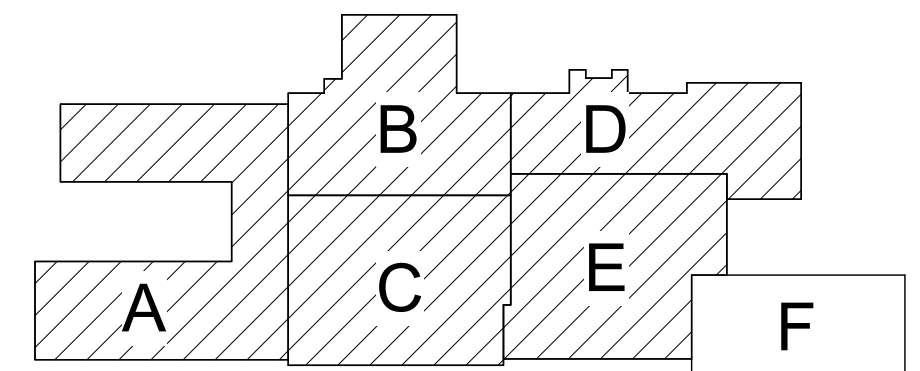

Key Plan
N.T.S.

SED Control No. 60-01-01-06-0-018-023

Rev. No.: Date: Description:



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CLEAR SOLUTIONS

Tetra Tech Engineers, Architects
& Landscape Architects, P.C.




Waverly Central School District
Waverly, NY

Additions and Alterations to:
Waverly Jr. Sr. High School

Partial First Floor - Occupancy and
Egress Plan

Drawn By: KCB Date: 05/19/2023 Drawing Number:
Project No.: 339070-22003 **AG352**

BID SET

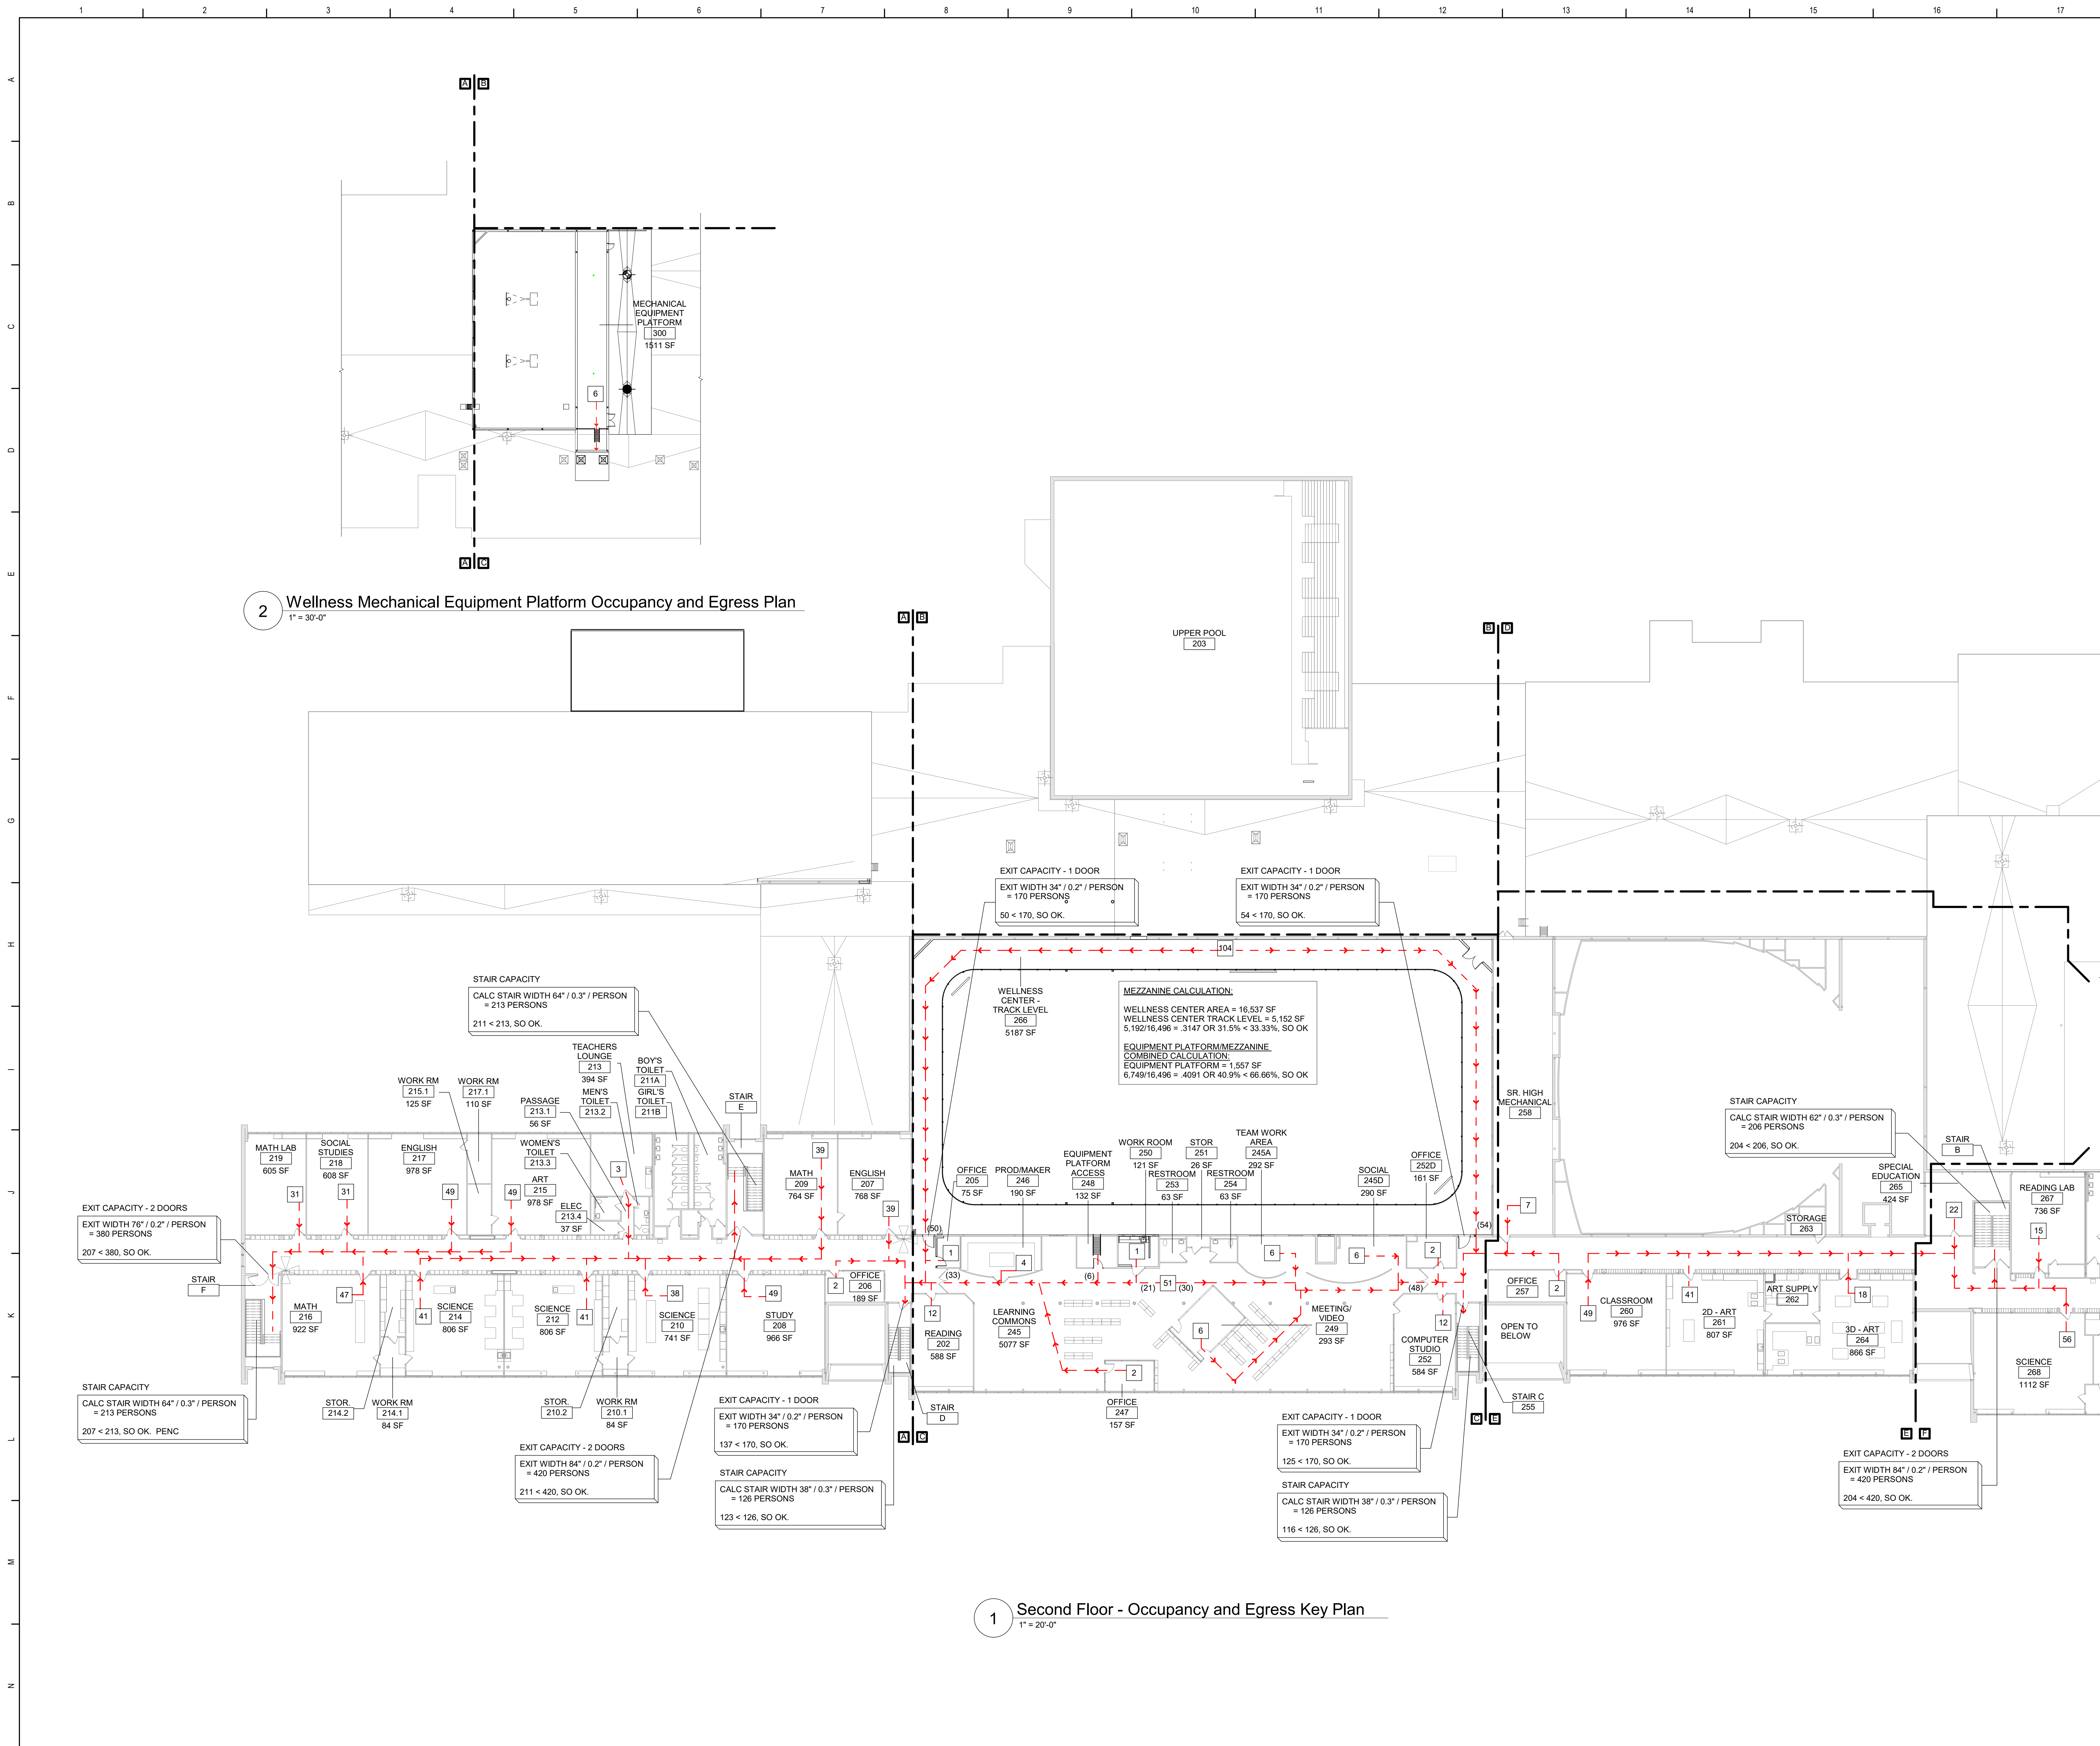

Legend

ALL WALLS, INCLUDING CORRIDOR WALLS, EXTEND TO THE ROOF DECK OR FLOOR DECK ABOVE UNLESS NOTED OTHERWISE.

- 2-HOUR FIRE WALL
- 2-HOUR FIRE BARRIER
- 1-HOUR FIRE BARRIER
- 1-HOUR FIRE PARTITION
- SMOKE PARTITION
- COMMON EGRESS PATH

XX NUMBER OF OCCUPANTS IN EACH SPACE, UNO
(XX) NUMBER OF OCCUPANTS ALONG EGRESS PATH
XX-XX* TOTAL EGRESS DISTANCE PER PATH

NEW FIRE EXTINGUISHER LOCATION
EXISTING FIRE EXTINGUISHER LOCATION
AREA OF REFUGE
AUTOMATED EXTERNAL DEFIBRILLATOR (AED)
TRUSS TYPE CONSTRUCTION IDENTIFICATION SIGNAGE
RESCUE WINDOWS ARE SHOWN ON AA050 AND AA051

1969 ORIGINAL BUILDING
TYPE IIB CONSTRUCTION
2009 ADDITION
TYPE IIB CONSTRUCTION
LEVEL 1 ALTERATIONS
LEVEL 2 ALTERATIONS

Key Plan

N.T.S.

SED Control No. 60-01-01-06-0-018-023

Rev. No.	Date	Description

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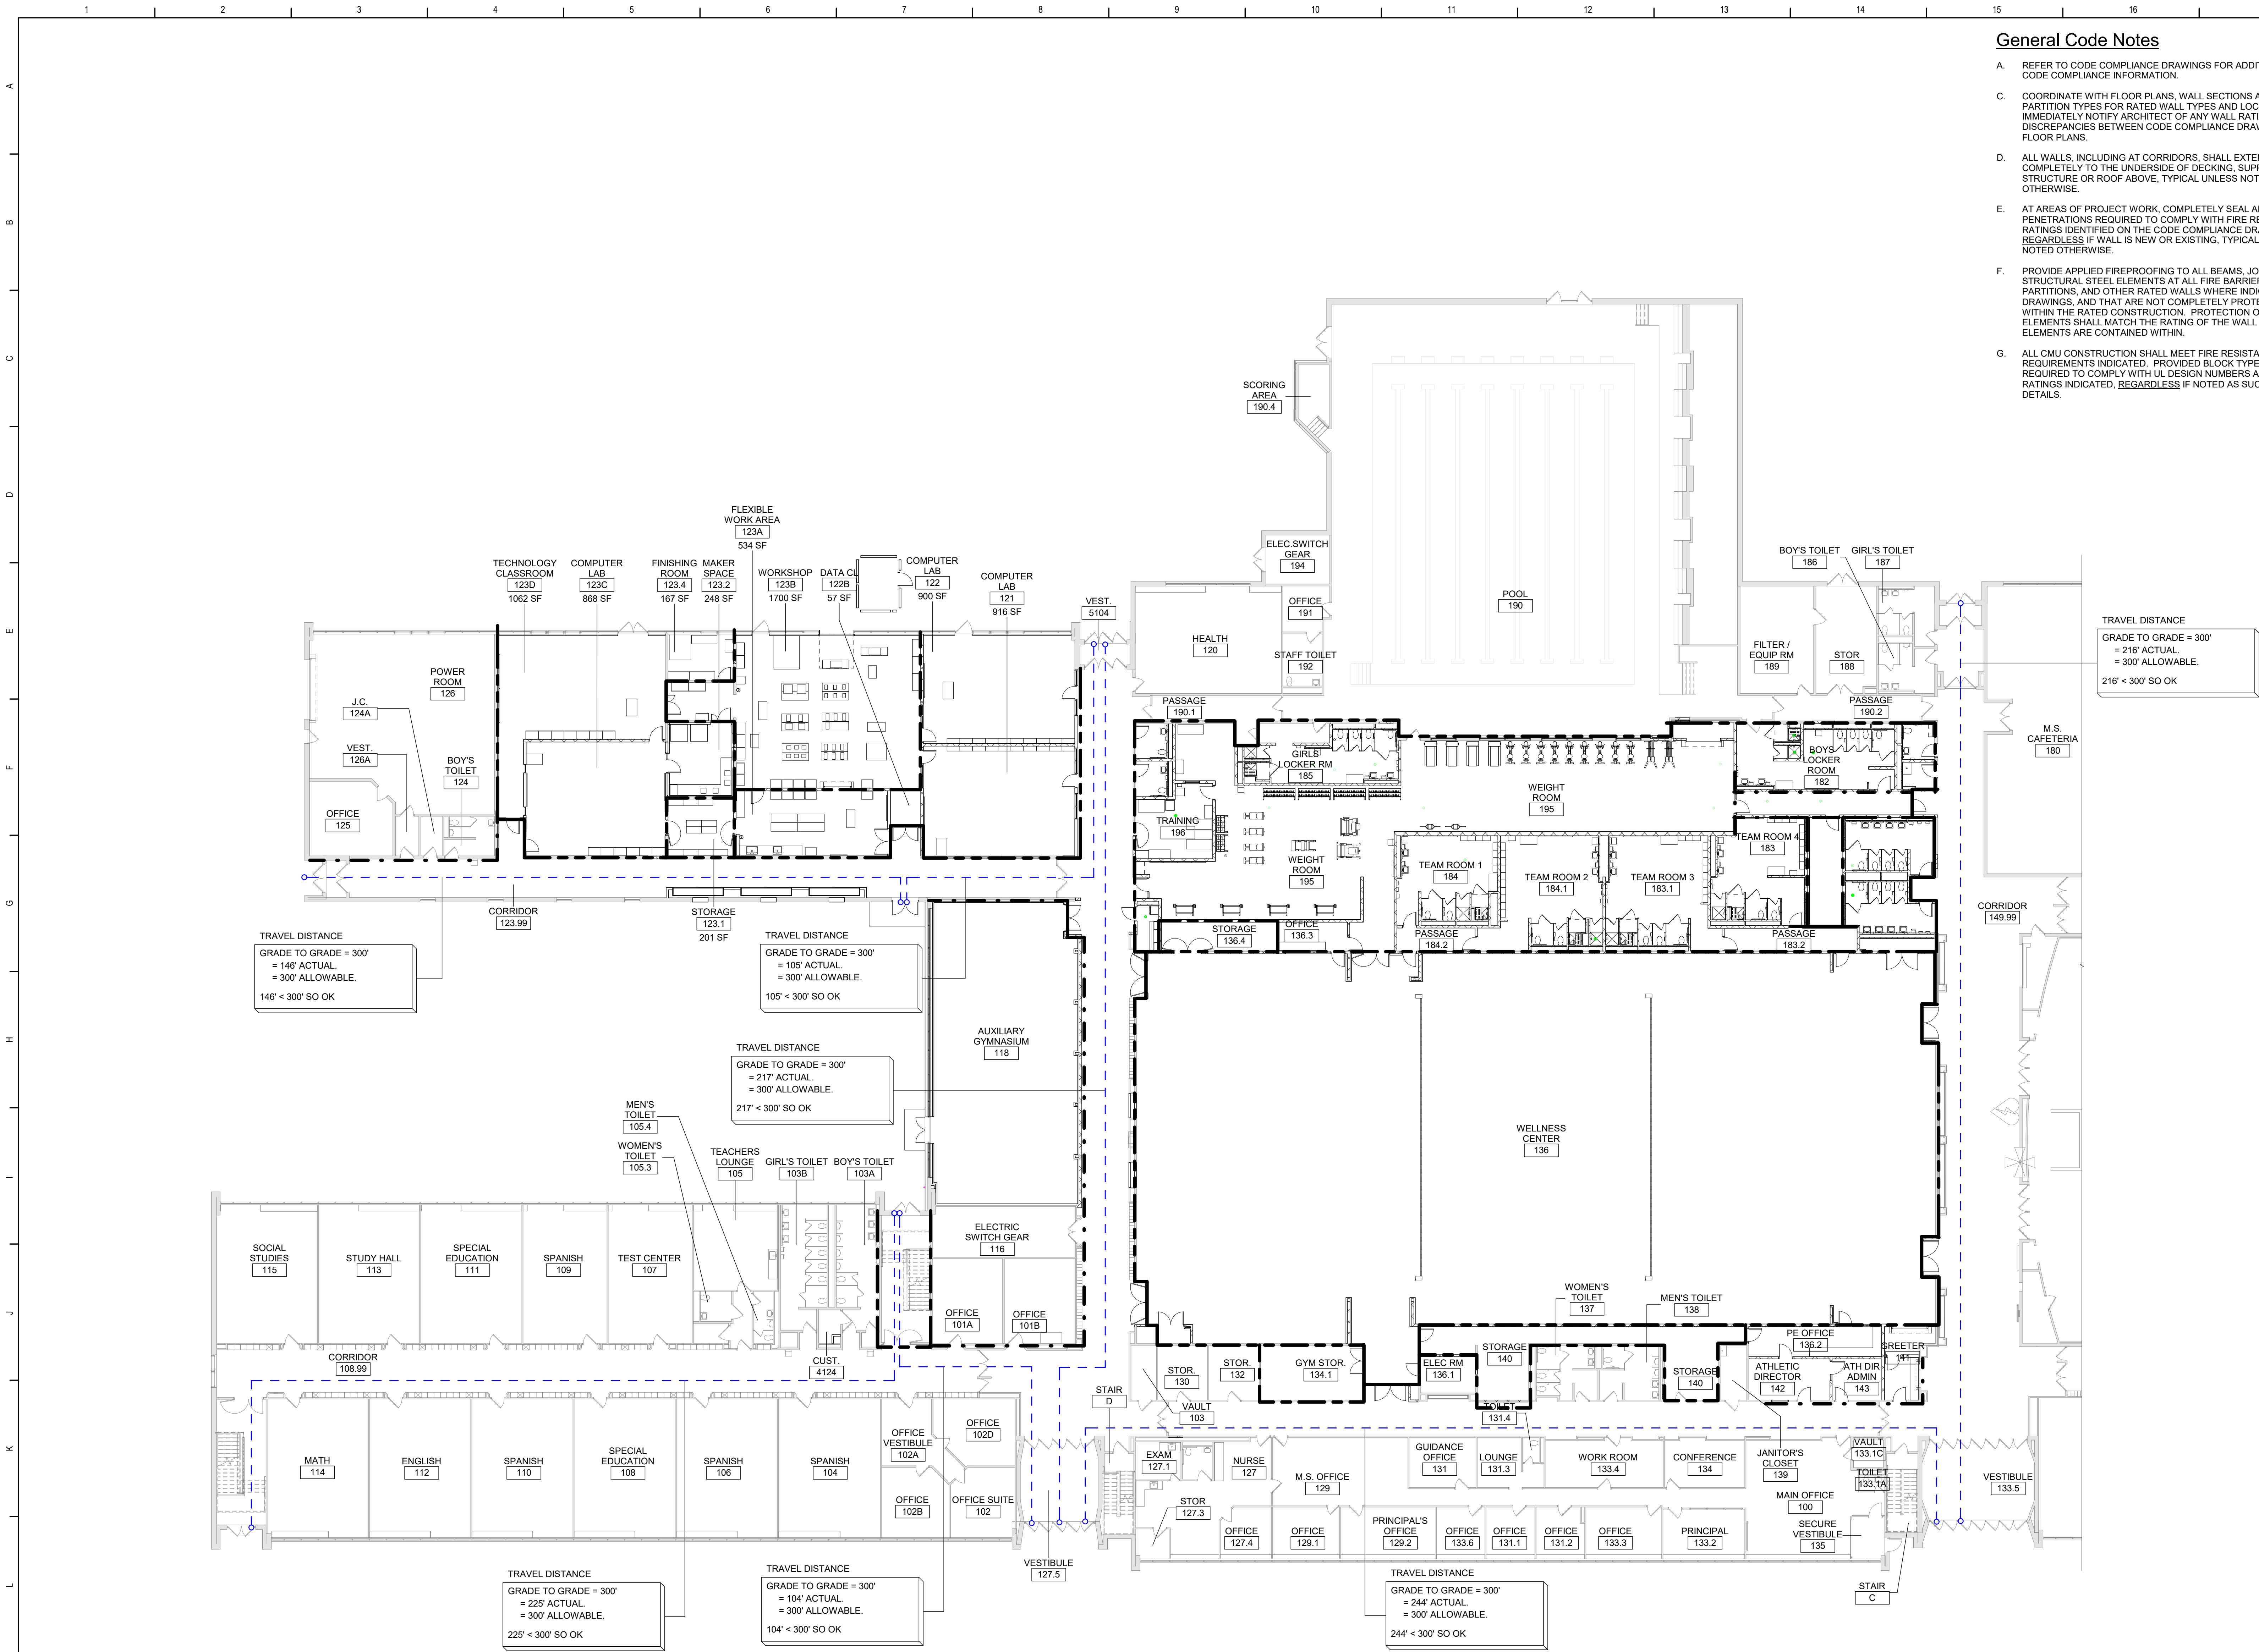
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ARCHITECTS & ENGINEERS

Waverly Central School District
Waverly, NY

Additions and Alterations to:
Waverly Jr. Sr. High School

Partial Second Floor - Occupancy and
Egress Plan

Drawn By: KCB	Date: 05/19/2023	Drawing Number:
Project No.: 339070-22003		AG353



1 Partial First Floor Travel Distances and Rated Walls Plan
1/16" = 1'-0"

General Code Notes

- A. REFER TO CODE COMPLIANCE DRAWINGS FOR ADDITIONAL CODE COMPLIANCE INFORMATION.
- C. COORDINATE WITH FLOOR PLANS, WALL SECTIONS AND PARTITION TYPES FOR RATED WALL TYPES AND LOCATIONS. IMMEDIATELY NOTIFY ARCHITECT OF ANY WALL RATING DISCREPANCIES BETWEEN CODE COMPLIANCE DRAWINGS AND FLOOR PLANS.
- D. ALL WALLS, INCLUDING AT CORRIDORS, SHALL EXTEND COMPLETELY TO THE UNDERSIDE OF DECKING, SUPPORTING STRUCTURE OR ROOF ABOVE, TYPICAL UNLESS NOTED OTHERWISE.
- E. AT AREAS OF PROJECT WORK, COMPLETELY SEAL ALL PENETRATIONS REQUIRED TO COMPLY WITH FIRE RESISTANCE RATINGS IDENTIFIED ON THE CODE COMPLIANCE DRAWINGS, REGARDLESS IF WALL IS NEW OR EXISTING, TYPICAL UNLESS NOTED OTHERWISE.
- F. PROVIDE APPLIED FIREPROOFING TO ALL BEAMS, JOISTS AND STRUCTURAL STEEL ELEMENTS AT ALL FIRE BARRIERS, FIRE PARTITIONS, AND OTHER RATED WALLS WHERE INDICATED ON DRAWINGS, AND THAT ARE NOT COMPLETELY PROTECTED WITHIN THE RATED CONSTRUCTION. PROTECTION OF SUCH ELEMENTS SHALL MATCH THE RATING OF THE WALL THAT THE ELEMENTS ARE CONTAINED WITHIN.
- G. ALL CMU CONSTRUCTION SHALL MEET FIRE RESISTANCE REQUIREMENTS INDICATED. PROVIDED BLOCK TYPE AS REQUIRED TO COMPLY WITH UL DESIGN NUMBERS AND WALL RATINGS INDICATED. REGARDLESS IF NOTED AS SUCH ON PLAN DETAILS.


General Rated Walls Notes

- A. THIS BUILDING'S ORIGINAL CONSTRUCTION WAS CONSTRUCTED WITHOUT FIRE WALLS OR FIRE BARRIERS TO CREATE FIRE AREAS. THE WORK OF THIS PROJECT IS SHOWING RATED WALLS AND CONSTRUCTION IN LOCATIONS THAT ENHANCE THE SAFETY OF THE EXISTING BUILDING BUT DOES NOT CREATE TRUE FIRE AREAS. THIS BUILDING IS PRE-EXISTING, NON-CONFORMING IN THIS RESPECT.

Legend

ALL WALLS, INCLUDING CORRIDOR WALLS, EXTEND TO THE ROOF DECK OR FLOOR DECK ABOVE UNLESS NOTED OTHERWISE.

- 2-HOUR FIRE WALL
- 2-HOUR FIRE BARRIER
- 1-HOUR FIRE BARRIER
- 1-HOUR FIRE PARTITION
- SMOKE PARTITION
- COMMON EGRESS PATH
- XX NUMBER OF OCCUPANTS IN EACH SPACE, UNO
- (XX) NUMBER OF OCCUPANTS ALONG EGRESS PATH
- XX'-XX" TOTAL EGRESS DISTANCE PER PATH
- NEW FIRE EXTINGUISHER LOCATION
- EXISTING FIRE EXTINGUISHER LOCATION
- AREA OF REFUGE
- AUTOMATED EXTERNAL DEFIBRILLATOR (AED)
- TRUSS TYPE CONSTRUCTION IDENTIFICATION SIGNAGE
- RESOLVE WINDOWS ARE SHOWN ON A4050 AND A4051
- 1969 ORIGINAL BUILDING TYPE IIB CONSTRUCTION
- 2009 ADDITION TYPE IIB CONSTRUCTION
- LEVEL 1 ALTERATIONS
- LEVEL 2 ALTERATIONS

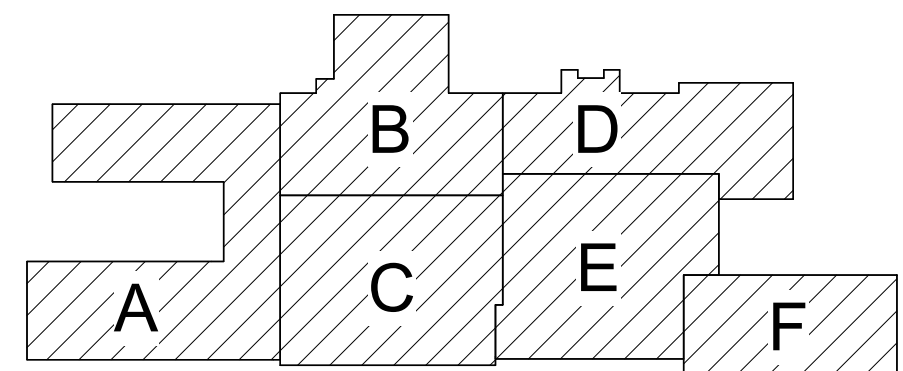

Key Plan
N.T.S.

SED Control No. 60-01-01-06-0-018-023

Rev. No.: Date: Description:



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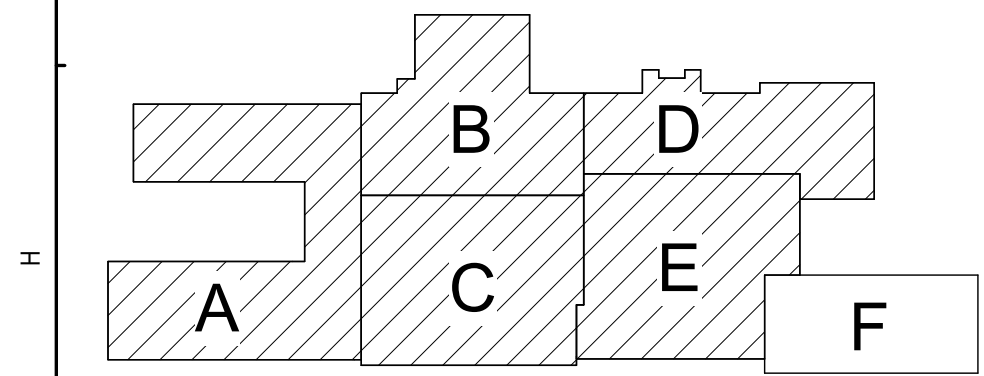
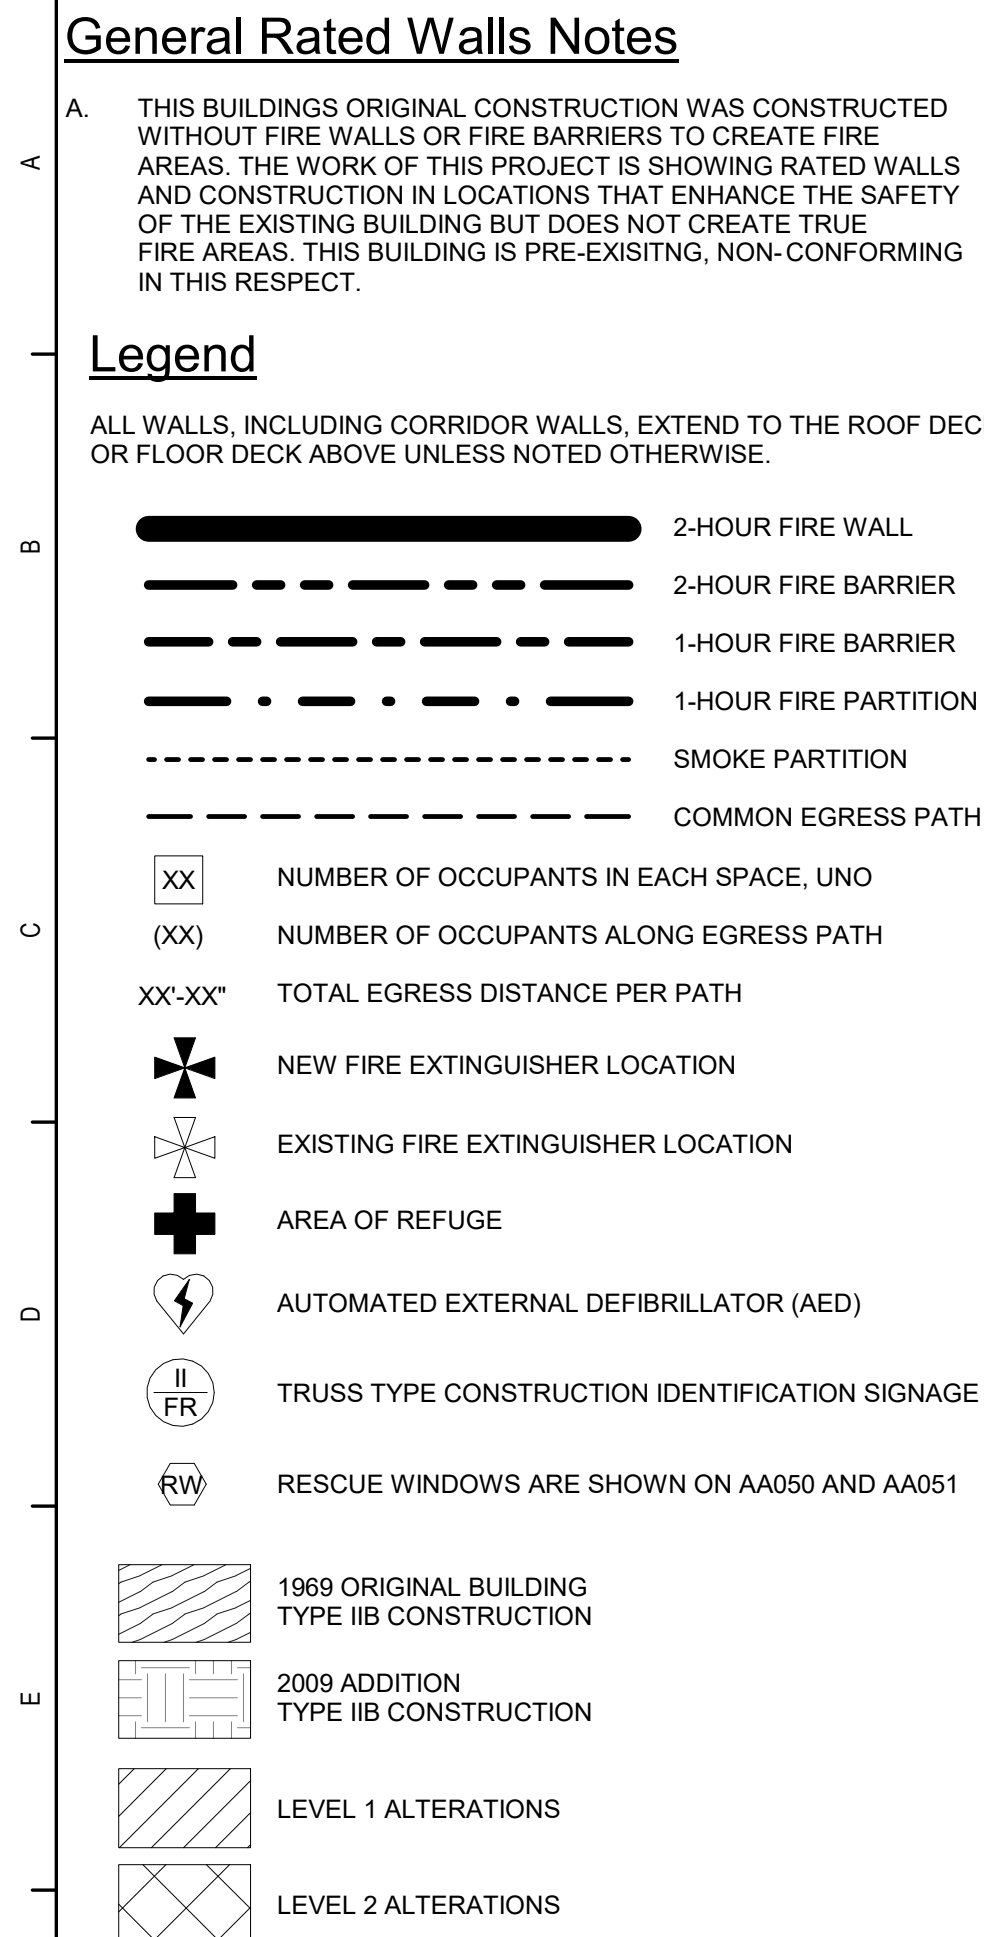
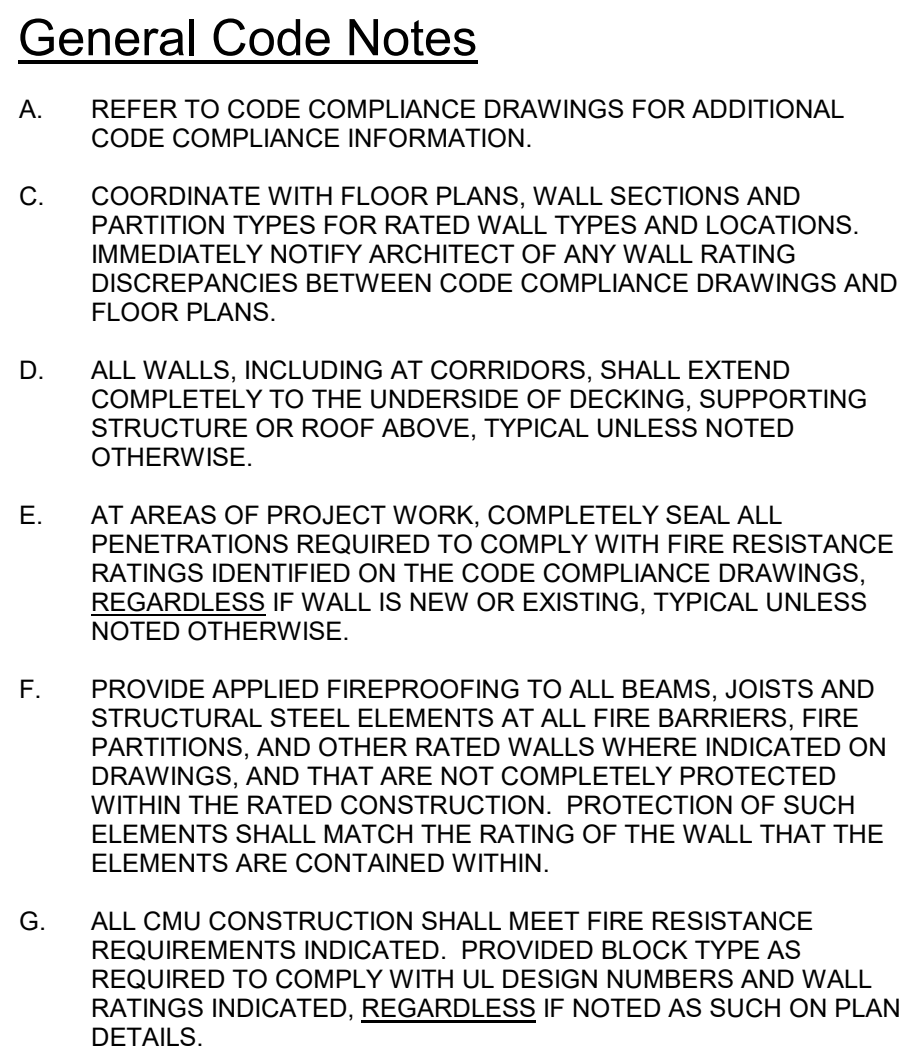


Waverly Central School District
Waverly, NY

Additions and Alterations to:
Waverly Jr. Sr. High School

Partial First Floor - Travel Distances and Rated Walls Plan

Drawn By: KCB Date: 05/19/2023 Drawing Number:
Project No.: 339070-22003 AG354



Key Plan
N.T.S.

SED Control No. 60-01-01-06-0-018-023

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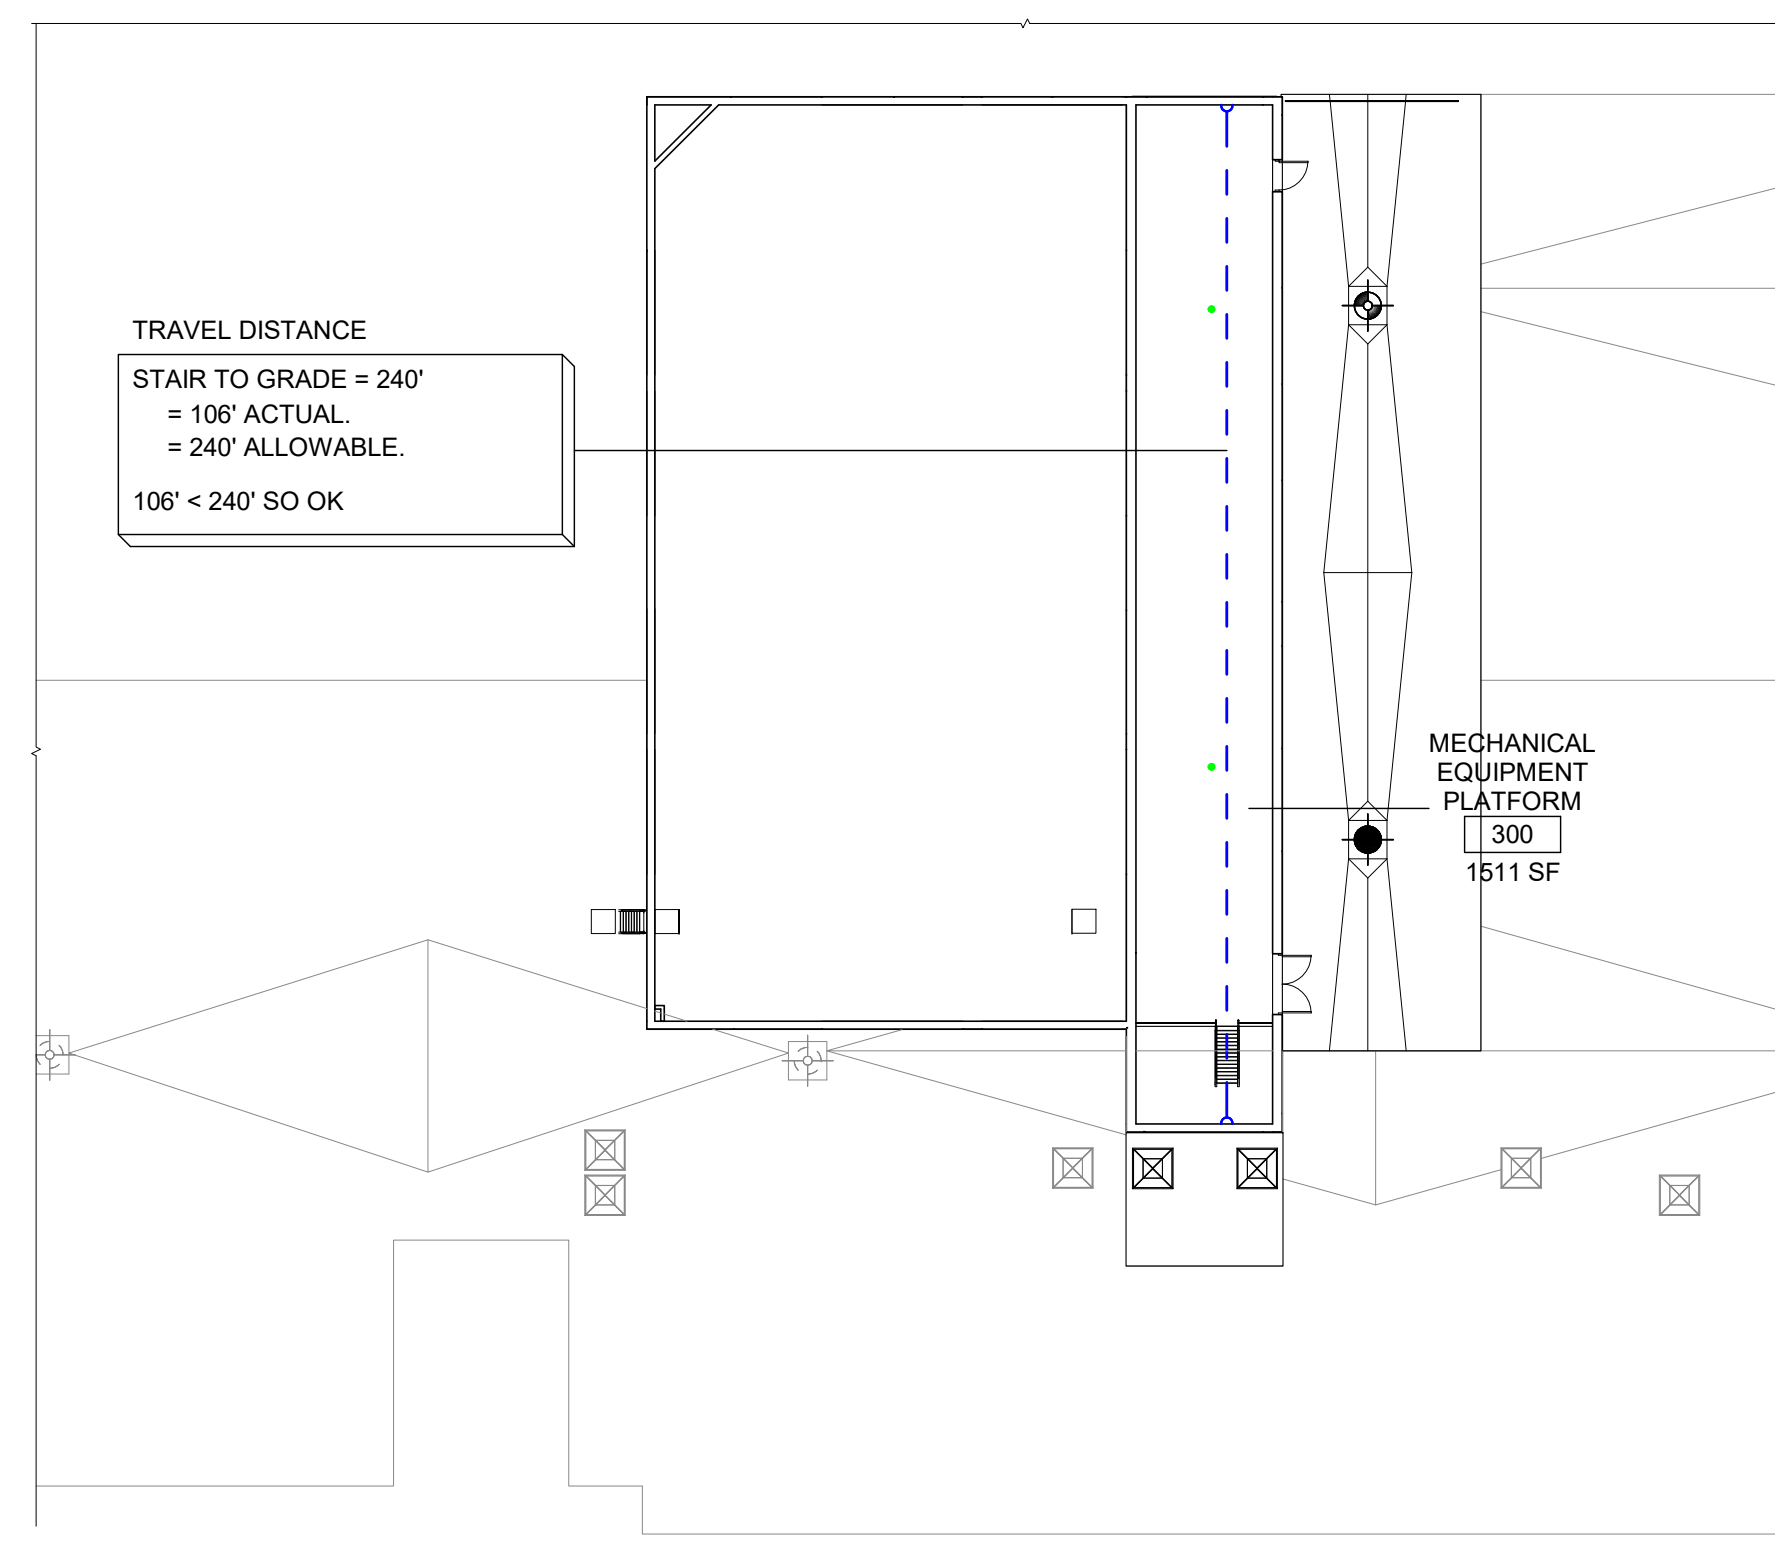


Waverly Central School District
Waverly, NY


M	Additions and Alterations to: Waverly Jr. Sr. High School
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Partial Second Floor - Travel Distances and Rated Walls Plan

N	Drawn By: KCB	Date: 05/19/2023	Drawing Number:
	Project No.: 339070-22003		AG355



2 Partial Wellness Mechanical Travel Distance and Rated Walls Plan
1" = 20'-0"

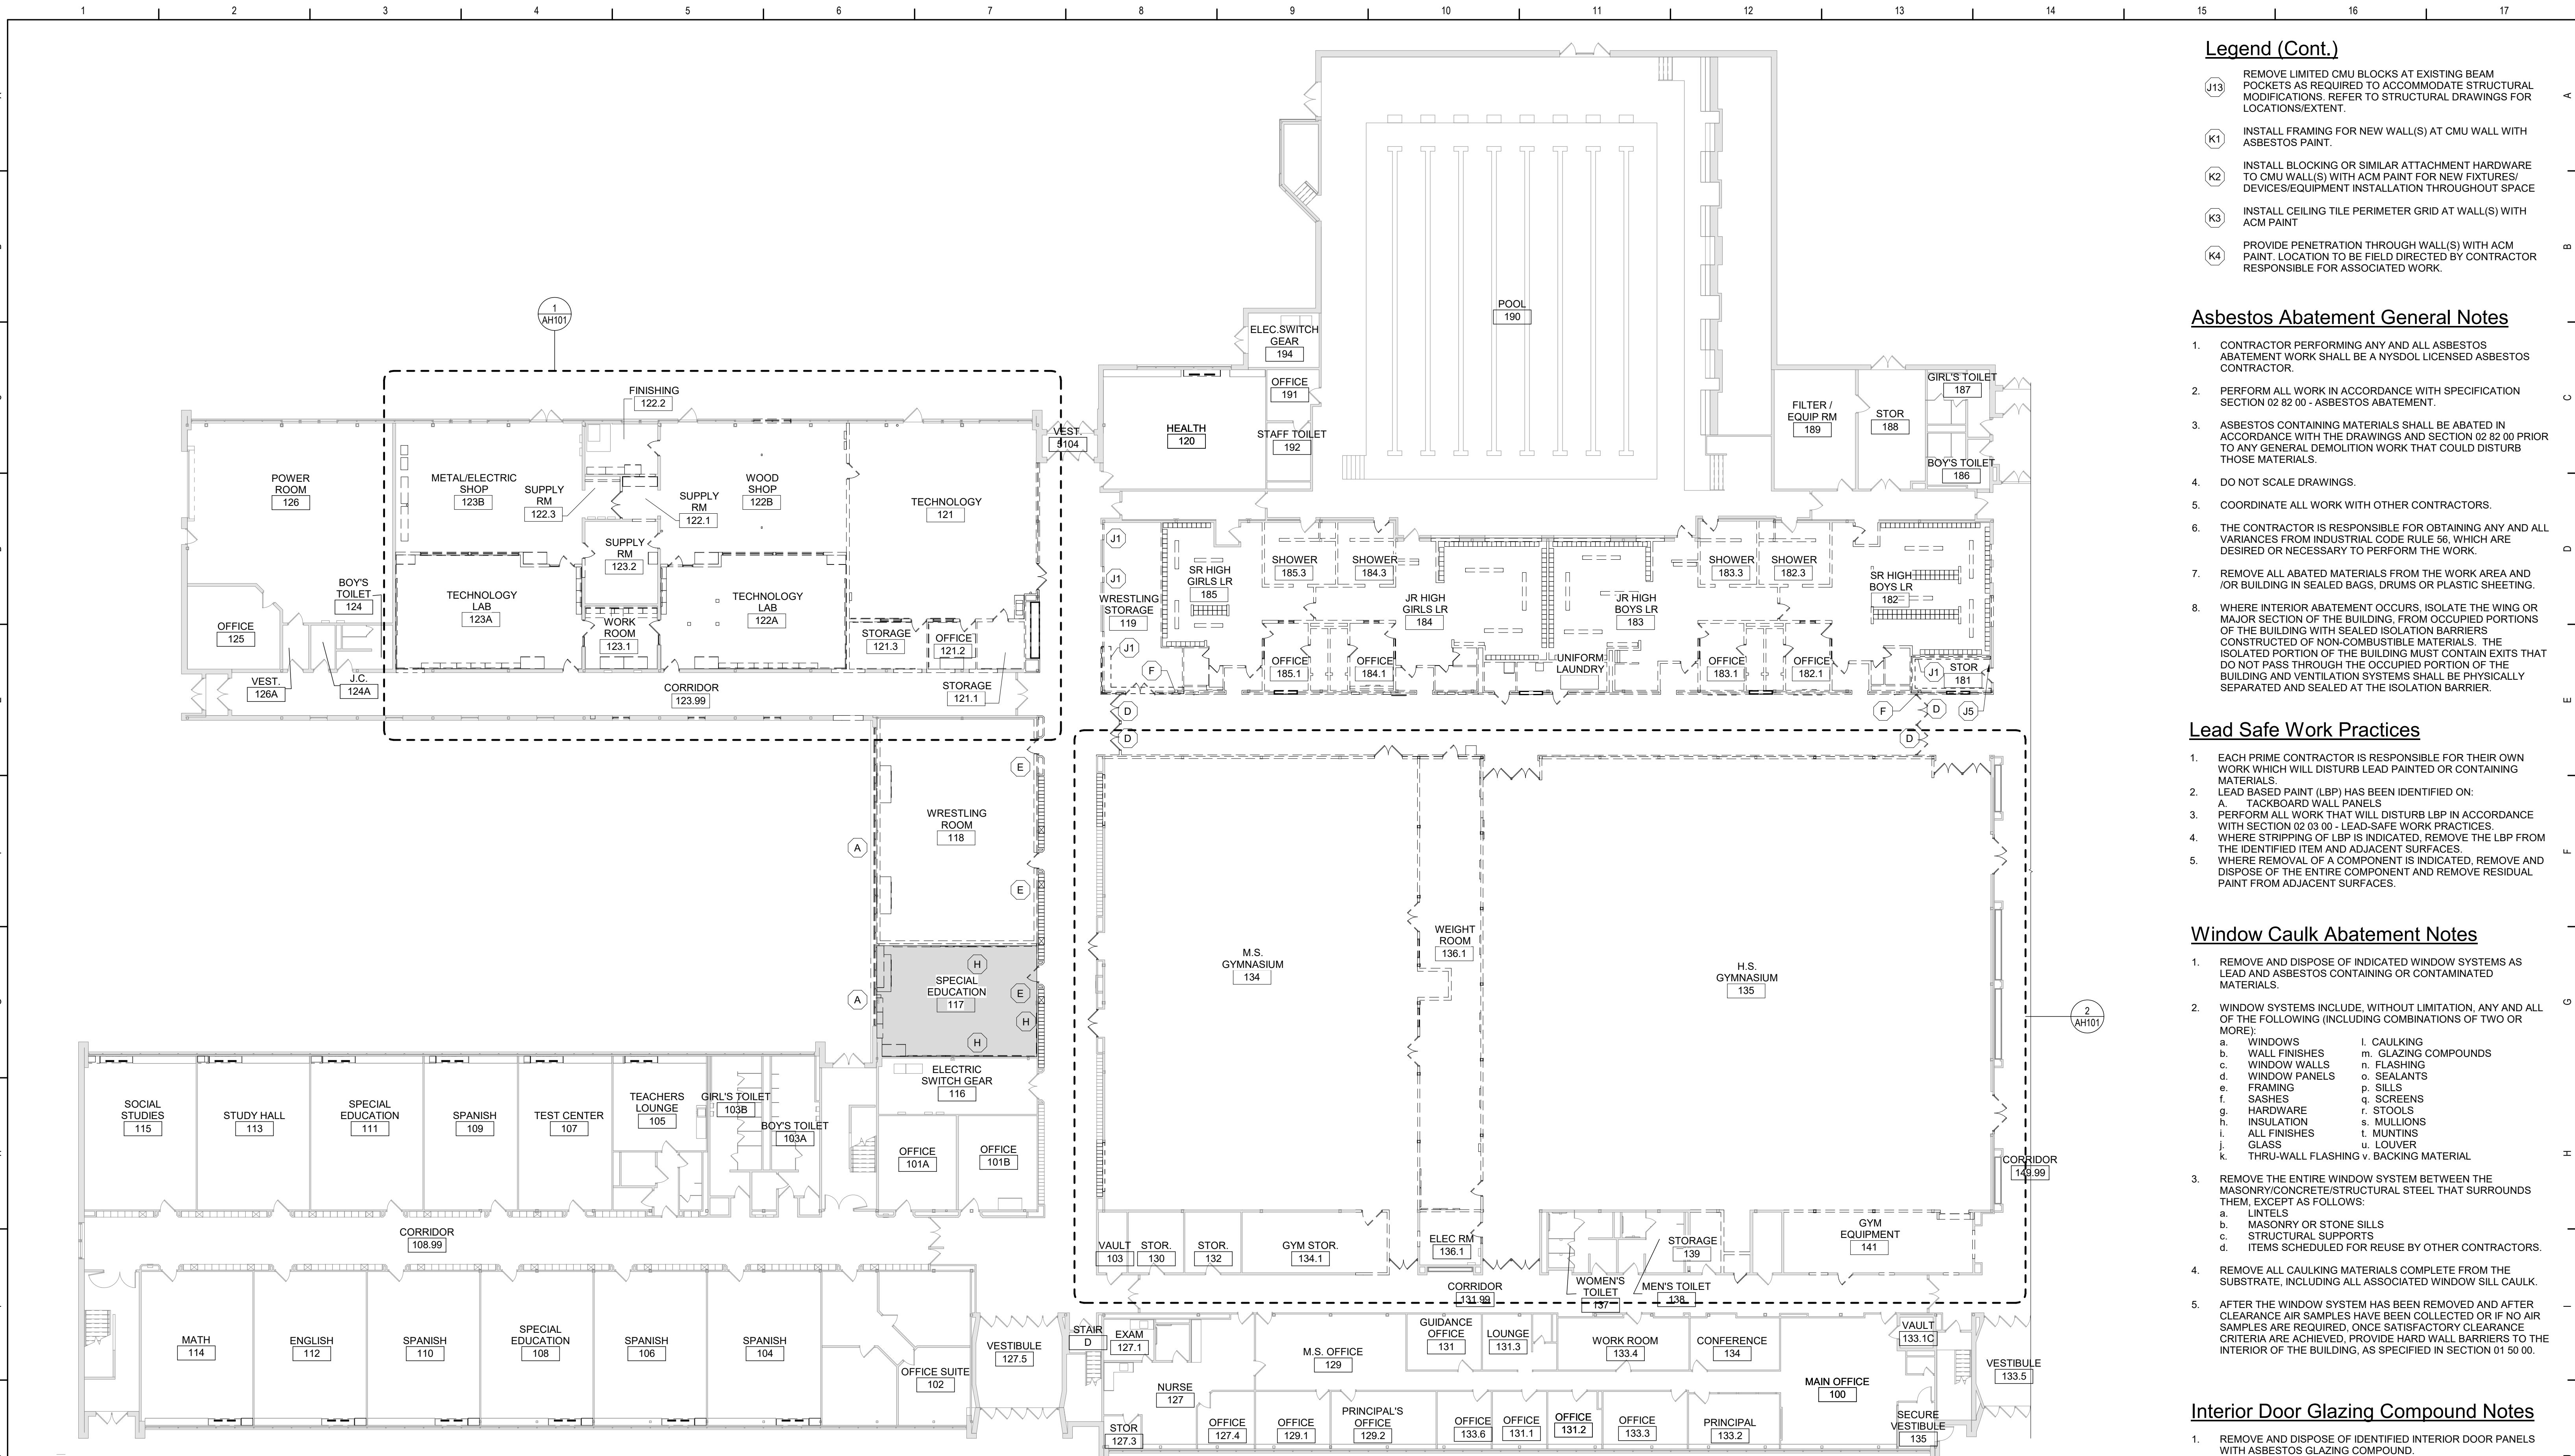

Asbestos Wall Paint Removal Notes

- PAINT/FILLER ON CMU WALLS IS ASBESTOS CONTAINING.
- PERFORM ALL WORK THAT WILL DISTURB PAINTED CMU WALLS AS AN ASBESTOS PROJECT AND IN ACCORDANCE WITH SECTION 028200 - ASBESTOS ABATEMENT.
- DISTURBANCE INCLUDES, WITHOUT LIMITATION:
 - REMOVAL OF PAINTED CMU WALLS, OR PORTIONS THEREOF;
 - PENETRATIONS THROUGH PAINTED CMU WALLS;
 - REMOVAL OF DEVICES/FIXTURES / CONSTRUCTION THAT IS ATTACHED TO OR OTHERWISE IMPACTS PAINTED CMU WALLS;
 - INSTALLATION OF NEW DEVICES / FIXTURES / CONSTRUCTION THAT IMPACTS PAINTED CMU WALLS OR;
 - PREPARING PAINTED CMU WALLS FOR PAINTING WHERE SANDING, SCRAPING OR SIMILAR ACTIVITIES OCCUR.
- COORDINATE EXTENTS OF REMOVALS AND LOCATIONS OF ATTACHMENTS WITH OTHERS.
- PERFORM REMOVALS SUCH THAT ALL PAINT REMAINING BEYOND THE LIMITS OF REMOVAL IS INTACT AND FIRMLY ADHERED. PERFORM REMOVALS SUCH THAT A CLEAN, STRAIGHT EDGE IS PROVIDED AT THE LIMIT OF PAINT REMOVAL. ENCAPSULATE EDGE OF REMAINING PAINT WITH 2 LAYERS OF FULL STRENGTH BRIDGING ENCAPSULANT.
- WHERE WALL REMOVAL IS SHOWN, COORDINATE EXTENTS OF WALL REMOVAL, OR SAWCUTTING OF NEW OPENING IN CMU WALL WITH CONTRACTORS RESPONSIBLE FOR ASSOCIATED WORK. AT ALL LIMITS OF WALL REMOVAL, LEAVE A CLEAN, STRAIGHT EDGE OF REMAINING CMU WALL.
- AT LOCATIONS OF WALLS SCHEDULED FOR REMOVAL/DEMOLITION, COORDINATE WITH OTHERS IF ITEMS ATTACHED TO WALLS ARE SCHEDULED FOR SALVAGE OR REUSE. WHERE ITEMS ARE SCHEDULED FOR SALVAGE OR REUSE, CAREFULLY REMOVE ITEMS FROM ACM WALL, CLEAN OF ALL RESIDUAL ACM PAINT, AND TURN OVER TO OTHER FOR STORAGE. WHERE ITEMS ATTACHED TO WALL ARE NOT SCHEDULED FOR SALVAGE OR REUSE, DISPOSE OF ITEMS AS ASBESTOS CONTAINING OR CONTAMINATED MATERIALS.
- AT LOCATIONS OF DOOR FRAME REMOVAL FROM WALLS WITH ACM PAINT, REMOVE DOOR FRAME FROM OPENING AND REMOVE ALL PAINT FROM DOOR JAMB/RETURN TO ALLOW FOR ASSOCIATED WORK. CONTRACTOR MAY ELECT TO CLEAN DOOR FRAME OF ANY ACM PAINT AND DISPOSE OF AS NON-ACM, OR LEAVE ANY PAINT ON THE DOOR FRAME AND DISPOSE OF DOOR FRAME AS ACM CONTAMINATED.
- AT LOCATIONS OF CASEWORK/FURNITURE REMOVAL, CLEANING, AND SALVAGE, CAREFULLY REMOVE AND PROTECT CASEWORK/ FURNITURE FROM WALL WITH ACM PAINT. COORDINATE EXTENT OF ITEMS TO BE REMOVED AND SALVAGED. INDICATED LOCATIONS INCLUDE REMOVAL/CLEANING/STORAGE OF MULTIPLE ITEMS THROUGHOUT THE INDICATED SPACE. CLEAN ITEMS OF ALL ACM PAINT AND STORE FOR REUSE.
- AT LOCATIONS OF NON-ACM WALL BASE AND MASTIC REMOVAL, REMOVE NON ACM BASE AND MASTIC AS ASBESTOS CONTAMINATED MATERIALS. COORDINATE WITH CONTRACTOR RESPONSIBLE FOR NEW BASE INSTALLATION THE HEIGHT OF THE NEW BASE AND REMOVE ACM WALL PAINT FROM THE SURFACE OF THE WALL THE CORRESPONDING HEIGHT.
- WHERE ITEMS ARE INDICATED TO BE REMOVED FROM ACM WALLS WITHIN A SPACE, REMOVE ALL ITEMS WITHIN THE SPACE WHICH ARE SCHEDULED TO BE REMOVED. COORDINATE WITH OTHER TRADES TO IDENTIFY SPECIFIC ITEMS AND ASSOCIATED RACEWAY SCHEDULE FOR REMOVAL.
- WHERE REMOVAL OF FACE OF CMU WALL IS INDICATED TO ALLOW FOR INSTALLATION OF COLUMNS, COORDINATE EXACT LOCATION AND WIDTH OF OPENING REQUIRED AND SAWCUT OPENING IN WALL. OPENING HEIGHT SHALL BE ASSUMED TO BE FULL HEIGHT OF WALL. COORDINATE HEIGHT AND WIDTH OF OPENING WITH CONTRACTOR RESPONSIBLE FOR STRUCTURAL WORK. OPENING SHALL ALSO BE LARGE ENOUGH TO ALLOW FOR ANY CONNECTIONS REQUIRED.
- WHERE REMOVAL OF FACE OF CMU WALL IS INDICATED FOR STRUCTURAL GROUT WORK, REMOVE APPROX 8" X 8" OPENING FROM FACE OF CMU WALL. THE ENTIRE INDICATED LENGTH, TO ALLOW FOR STRUCTURAL GROUTING. WHERE LENGTH IS NOT INDICATED, PERFORM REMOVALS ALONG THE ENTIRE INDICATED WALL. REMOVE ONLY FACE SHELL, NOT ENTIRE BLOCK. OPENINGS TO OCCUR APPROXIMATELY EVERY OTHER BLOCK. COORDINATE EXACT LOCATIONS, SIZE, AND EXTENT WITH CONTRACTOR RESPONSIBLE FOR STRUCTURAL WORK.
- WHERE REMOVAL OF COVERING FROM WALL SURFACE IS INDICATED, REMOVE ENTIRE SURFACE OF WALL COVERING AND ANY ASSOCIATED MATERIALS SUCH AS FASTENERS, LATH, GYPSBOARD, PLASTER, MASTIC, ETC. ALL ASSOCIATED MATERIALS, MASTIC, AND FASTENERS SHALL BE REMOVED AS ASBESTOS CONTAINING OR CONTAMINATED MATERIAL. UPON COMPLETION OF WALL COVERING AND ANY ASSOCIATED DAMAGED ACM WALL PAINT SHALL BE PATCHED AND ENCAPSULATED.
- WHERE ITEMS ARE INDICATED TO BE INSTALLED AT WALLS WITH ACM PAINT, COORDINATE WITH CONTRACTORS RESPONSIBLE FOR INSTALLATION OF ALL SCHEDULED ITEMS AND ASSOCIATED RACEWAY. INDICATED LOCATIONS MAY INCLUDE INSTALLATION OF MULTIPLE ITEMS THROUGHOUT THE SPACE. ITEMS TO BE PROVIDED BY CONTRACTOR RESPONSIBLE FOR ASSOCIATED WORK. CONTRACTOR(S) RESPONSIBLE FOR ASSOCIATED WORK SHALL PROVIDE EXACT INSTALLATION/MOUNTING LOCATIONS AND ALL REQUIRED HARDWARE.
- AT LOCATIONS OF NON-ACM CEILING GRID REMOVAL FROM ACM WALL PAINT, REMOVE CEILING GRID PERIMETER TRACK TO THE EXTENT REQUIRED TO PERFORM THE ASSOCIATED WORK. SIMILARLY, AT LOCATIONS OF NEW PERIMETER TRACK INSTALLATION, INSTALL PERIMETER TRACK TO THE SURFACE OF THE ACM WALL. COORDINATE EXACT HEIGHT OF CEILING WITH CONTRACTOR RESPONSIBLE TO INSTALL NEW CEILING. ENSURE PERIMETER TRACK IS INSTALLED AT THE PROPER HEIGHT AND IS LEVEL.
- ACM WALL PAINT IS PRESUMED TO BE PRESENT BEHIND FURRED OUT OR COVERED OVER WALLS, WHERE WALL FURRING OR COVERING IS INDICATED FOR REMOVAL. PERFORM THE REMOVAL OF THE FURRING AS AN ASBESTOS ABATEMENT PROJECT. WHERE EXISTING WALLS WITH ACM PAINT WILL RECEIVE NEW FURRING, INSTALL STUDS/HAT CHANNELS/ETC (TO BE PROVIDED BY CONTRACTOR RESPONSIBLE FOR WALL CONSTRUCTION) TO THE CMU WALL.

1 Partial First Floor Abatement Plan - Areas A, B & C
1/16" = 1'-0"

Floor Tile Abatement Notes

- IN ALL AREAS WHERE FLOOR TILE REMOVAL IS INDICATED, REMOVE AND DISPOSE OF ANY AND ALL (INCLUDING MULTIPLE LAYERS) OF THE FOLLOWING:
 - FLOOR TILE
 - WOOD UNDERLAYMENT
 - COVE BASE
 - COVE BASE MASTIC
 - CARPET
 - CARPET MASTIC
- AT ALL THRESHOLDS AND OTHER TRANSITIONS IN FLOORING (E.G. TO AN ADJACENT SPACE), COORDINATE EXTENT OF REMOVAL WITH CONTRACTOR RESPONSIBLE FOR NEW FLOORING INSTALLATION.
- ALL WORK, REMOVALS, SUBSTRATE REPAIR, ETC. SHALL BE IN ACCORDANCE WITH SPECIFICATION SECTION 02 82 00 - ASBESTOS ABATEMENT.
- REMOVE ALL MATERIALS FROM THE SUBSTRATE.
- WHERE FLOORING REMOVAL IS INDICATED UNDER CASEWORK, COORDINATE WITH OTHERS TO DETERMINE IF CASEWORK SHALL BE SALVAGED, CLEANED AND TURNED OVER FOR REINSTALLATION, OR DISPOSED OF AS ASBESTOS CONTAMINATED MATERIAL.
- WHERE FLOORING REMOVAL IS SHOWN AT DOOR THRESHOLDS OR OTHER TERMINATION POINTS TO ADJACENT SPACES, COORDINATE EXACT EXTENT OF REMOVALS SCHEDULED WITH CONTRACTOR RESPONSIBLE FOR NEW FLOORING INSTALLATION.

Asbestos and Lead Column Caulk Notes

- INTERIOR COLUMNS HAVE ASBESTOS AND LEAD CONTAINING CAULKING LOCATED AT EACH EXPOSED SIDE OF THE COLUMN. COLUMNS ARE TYPICALLY HSS COLUMNS. CAULKING IS TYPICALLY LOCATED THE FULL HEIGHT OF THE COLUMN, AND IS PRESENT BETWEEN COLUMN AND THE ADJACENT SUBSTRATE. IN SOME LOCATIONS, THE ADJACENT SUBSTRATE IS PAINTED CMU WALL WHICH ALSO HAS ASBESTOS CONTAINING PAINT PRESENT.
- AT INDICATED COLUMNS, REMOVE ALL CAULKING FROM ALL EXPOSED SIDES OF THE COLUMN (WHICH TYPICALLY IS SCHEDULED TO REMAIN). BACKING MATERIAL IS NON-ACM.
- REMOVE CAULKING AS ASBESTOS AND LEAD CONTAINING MATERIAL. REMOVE CAULK COMPLETELY FROM COLUMN AND ADJACENT SUBSTRATES.
- PERFORM REMOVALS SUCH THAT STRUCTURAL COLUMNS ARE PROTECTED FROM DAMAGE.
- WHERE CAULKING IS PRESENT AT CMU WALLS WITH ACM PAINT AND WALLS ARE SCHEDULED TO REMAIN, PERFORM REMOVAL OF CAULKING SUCH THAT WALL PAINT DISTURBANCE IS KEPT TO A MINIMUM. AT THE POINT OF REMOVAL AT ACM WALL PAINT, REMOVE ANY LOOSE ACM PAINT, AND ENCAPSULATE EDGE OF ACM PAINT WITH FULL STRENGTH BRIDGING ENCAPSULANT.
- PERFORM REMOVALS IN ACCORDANCE WITH IC96, SECTION 028200 - ASBESTOS ABATEMENT, AND SECTION 028400 - HAZARDOUS MATERIAL REMOVAL.

Legend (Cont.)

- REMOVE LIMITED CMU BLOCKS AT EXISTING BEAM POCKETS AS REQUIRED TO ACCOMMODATE STRUCTURAL MODIFICATIONS. REFER TO STRUCTURAL DRAWINGS FOR LOCATIONS/EXTENT.
- INSTALL FRAMING FOR NEW WALL(S) AT CMU WALL WITH ASBESTOS PAINT.
- INSTALL BLOCKING OR SIMILAR ATTACHMENT HARDWARE TO CMU WALL(S) WITH ACM PAINT FOR NEW FIXTURES/ DEVICES/EQUIPMENT INSTALLATION THROUGHOUT SPACE
- INSTALL CEILING TILE PERIMETER GRID AT WALL(S) WITH ACM PAINT
- PROVIDE PENETRATION THROUGH WALL(S) WITH ACM PAINT. LOCATION TO BE FIELD DIRECTED BY CONTRACTOR RESPONSIBLE FOR ASSOCIATED WORK.

Asbestos Abatement General Notes

- CONTRACTOR PERFORMING ANY AND ALL ASBESTOS ABATEMENT WORK SHALL BE A NYS/DOL LICENSED ASBESTOS CONTRACTOR.
- PERFORM ALL WORK IN ACCORDANCE WITH SPECIFICATION SECTION 02 82 00 - ASBESTOS ABATEMENT.
- ASBESTOS CONTAINING MATERIALS SHALL BE ABATED IN ACCORDANCE WITH THE DRAWINGS AND SECTION 02 82 00 PRIOR TO ANY GENERAL DEMOLITION WORK THAT COULD DISTURB THOSE MATERIALS.
- DO NOT SCALE DRAWINGS.
- COORDINATE ALL WORK WITH OTHER CONTRACTORS.
- THE CONTRACTOR IS RESPONSIBLE FOR OBTAINING ANY AND ALL VARIANCES FROM INDUSTRIAL CODE RULE 56, WHICH ARE DESIRED OR NECESSARY TO PERFORM THE WORK.
- REMOVE ALL ABATED MATERIALS FROM THE WORK AREA AND /OR BUILDING IN SEALED BAGS, DRUMS OR PLASTIC SHEETING.
- WHERE INTERIOR ABATEMENT OCCURS, ISOLATE THE WING OR MAJOR SECTION OF THE BUILDING, FROM OCCUPIED PORTIONS OF THE BUILDING WITH SEALED ISOLATION BARRIERS CONSTRUCTED OF NON-COMBUSTIBLE MATERIALS. THE ISOLATED PORTION OF THE BUILDING MUST CONTAIN EXITS THAT DO NOT PASS THROUGH THE OCCUPIED PORTION OF THE BUILDING AND VENTILATION SYSTEMS SHALL BE PHYSICALLY SEPARATED AND SEALED AT THE ISOLATION BARRIER.

Lead Safe Work Practices

- EACH PRIME CONTRACTOR IS RESPONSIBLE FOR THEIR OWN WORK WHICH WILL DISTURB LEAD PAINTED OR CONTAINING MATERIALS.
- LEAD BASED PAINT (LBP) HAS BEEN IDENTIFIED ON: TACKBOARD WALL PANELS
- PERFORM ALL WORK THAT WILL DISTURB LBP IN ACCORDANCE WITH SECTION 02 03 00 - LEAD-SAFE WORK PRACTICES
- WHERE STRIPPING OF LBP IS INDICATED, REMOVE THE LBP FROM THE IDENTIFIED ITEM AND ADJACENT SURFACES.
- WHERE REMOVAL OF A COMPONENT IS INDICATED, REMOVE AND DISPOSE OF THE ENTIRE COMPONENT AND REMOVE RESIDUAL PAINT FROM ADJACENT SURFACES.

Window Caulk Abatement Notes

- REMOVE AND DISPOSE OF INDICATED WINDOW SYSTEMS AS LEAD AND ASBESTOS CONTAINING OR CONTAMINATED MATERIALS.
- WINDOW SYSTEMS INCLUDE, WITHOUT LIMITATION, ANY AND ALL OF THE FOLLOWING (INCLUDING COMBINATIONS OF TWO OR MORE):
 - WINDOWS
 - WALL FINISHES
 - WINDOW WALLS
 - WINDOW PANELS
 - FRAMING
 - SASHES
 - HARDWARE
 - INSULATION
 - ALL FINISHES
 - GLASS
 - THRU-WALL FLASHING
 - CAULKING
 - GLAZING COMPOUNDS
 - FLASHING
 - SEALANTS
 - SILLS
 - SCREENS
 - STOOLS
 - MULLIONS
 - VENTS
 - LOUVER
 - BACKING MATERIAL
- REMOVE THE ENTIRE WINDOW SYSTEM BETWEEN THE MASONRY/CONCRETE/STRUCTURAL STEEL THAT SURROUNDS THEM, EXCEPT AS FOLLOWS:
 - LINTELS
 - MASONRY OR STONE SILLS
 - STRUCTURAL SUPPORTS
 - ITEMS SCHEDULED FOR REUSE BY OTHER CONTRACTORS.
- REMOVE ALL CAULKING MATERIALS COMPLETE FROM THE SUBSTRATE, INCLUDING ALL ASSOCIATED WINDOW SILL CAULK.
- AFTER THE WINDOW SYSTEM HAS BEEN REMOVED AND AFTER CLEARANCE AIR SAMPLES HAVE BEEN COLLECTED OR IF NO AIR SAMPLES ARE REQUIRED, ONCE SATISFACTORY CLEARANCE CRITERIA ARE ACHIEVED, PROVIDE HARD WALL BARRIERS TO THE INTERIOR OF THE BUILDING, AS SPECIFIED IN SECTION 01 50 00.

Interior Door Glazing Compound Notes

- REMOVE AND DISPOSE OF IDENTIFIED INTERIOR DOOR PANELS WITH ASBESTOS GLAZING COMPOUND.
- REMOVE PANEL FROM FRAME TO BE REMOVED BY OTHERS.

Clock/Spaker Abatement Notes

- CLOCK/SPEAKER COMBO DEVICES CONTAIN AN ASBESTOS CONTAINING MASTIC/COATING WITHIN THE DEVICE CONCEALED BEHIND THE CLOCK/SPEAKER UNIT.
- REMOVE AND DISPOSE OF CLOCK/SPEAKER DEVICE AND AS ASBESTOS CONTAINING MATERIAL.
- SOME DEVICES MAY BE ATTACHED TO ASBESTOS CONTAINING CMU WALL PAINT. WHERE THIS CONDITION EXISTS, ENSURE REMOVAL OF DEVICE DOES NOT DAMAGE ACM WALL PAINT. AT POINT OF DISCONNECT, REMOVE ANY LOOSE ACM PAINT, PATCH/FILL HOLE, AND ENCAPSULATE EDGE OF ACM PAINT AT FASTENER/ATTACHMENT POINT WITH FULL STRENGTH BRIDGING ENCAPSULANT.
- PERFORM REMOVALS IN ACCORDANCE WITH IC96 & SECTION 028200 - ASBESTOS ABATEMENT, OR A CONTRACTOR OBTAINED SITE SPECIFIC VARIANCE, IF DESIRED.

Sink Undercoating Removal Notes


- WHERE INDICATED SINKS HAVE ASBESTOS CONTAINING BLACK UNDERCOATING.
- REMOVE ENTIRE SINK AS ASBESTOS CONTAINING MATERIAL WITH MASTIC.
- CLEAN ALL REMAINING ADJACENT SUBSTRATES OF ALL RESIDUAL ACM.

Chalk/Tack/Mirror Abatement Notes

- REMOVE AND DISPOSE OF INDICATED CHALK BOARDS, TACK BOARDS, AND MIRRORS AND ASSOCIATED MASTIC WHICH IS ASSUMED TO BE ASBESTOS CONTAINING.
- COMPLETELY REMOVE THE ASSUMED ACM MASTIC FROM THE SUBSTRATE.

Legend

- REMOVE ASBESTOS CONTAINING FLOOR TILE WITH NON- ACM MASTIC
- REMOVE ASBESTOS AND LEAD CONTAINING WINDOW FRAME & SILL CAULK
- NOT USED
- NOT USED
- REMOVE INTERIOR DOOR PANEL(S) WITH ASBESTOS CONTAINING GLAZING COMPOUND
- REMOVE CLOCK/SPEAKER COMBO DEVICE WITH ASBESTOS CONTAINING COATING CONTAINED WITHIN THE DEVICE
- REMOVE ASBESTOS AND LEAD CONTAINING COLUMN CAULK
- REMOVE SINK WITH ASBESTOS CONTAINING UNDERCOATING
- REMOVE MIRROR/CHALK/TACK BOARD WITH ASSUMED ASBESTOS CONTAINING MASTIC. REMOVE MASTIC COMPLETE FROM SUBSTRATE.
- NOT USED
- REMOVE CMU WALL OR PORTION OF WALL WITH ASBESTOS PAINT
- REMOVE NON-ACM DOOR FRAME FROM CMU WALL/OPENING WITH ACM PAINT. REMOVE ACM WALL PAINT FROM OPENING.
- CAREFULLY REMOVE CASEWORK/SHELVING/FURNITURE FROM CMU WALL WITH ASBESTOS PAINT. CLEAN ITEM OF ALL ACM PAINT AND STORE FOR SALVAGE.
- REMOVE NON-ACM BASE AND MASTIC FROM CMU WALL WITH ACM PAINT. REMOVE ACM PAINT FROM BOTTOM 4- INCHES OF WALL TO ALLOW FOR INSTALLATION OF NEW BASE.
- REMOVE MISC. ITEM FROM WALL WITH ACM CMU WALL PAINT. COORDINATE WITH OTHER DRAWINGS FOR ITEM TYPE.
- REMOVE NON-ACM CEILING GRID PERIMETER FROM WALL WITH ACM PAINT
- REMOVE NON-ACM FURRING, ASSUMED TO BE INSTALLED OVER TOP OF ACM CMU WALL PAINT, FROM ALL WALLS SCHEDULED TO REMAIN
- REMOVE FACE OF CMU WALL WITH ACM PAINT TO ALLOW FOR INSTALLATION OF NEW COLUMN AND ASSOCIATED CONNECTIONS. SEE STRUCTURAL DRAWINGS. REFER TO 9/AS531.
- REMOVE WALL COVERING FROM WALL(S) WITH CMU PAINT ASSUMED TO BE PRESENT BEHIND
- AT CMU WALL WITH ASBESTOS PAINT, APPROX. AT TOP AND BOTTOM OF WALL, REMOVE FACE OF CMU WALL FOR STRUCTURAL GROUT WORK. SEE STRUCTURAL DRAWINGS. COORDINATE EXTENTS AND LOCATIONS OF REMOVALS WITH 9/AS531.
- REMOVE TOP COURSE OF ASBESTOS CONTAINING CMU WALL(S) BELOW GIRDER FOR ASSOCIATED STRUCTURAL WORK. COORDINATE WITH STRUCTURAL DRAWINGS. GIRDER IS LOCATED BETWEEN FIRST AND SECOND FLOOR LEVEL
- REMOVE LIMITED CMU BLOCKS AT SCHEDULED BEAM POCKETS AS REQUIRED TO ACCOMMODATE NEW STRUCTURAL BEAMS. REFER TO STRUCTURAL DRAWINGS FOR EXACT LOCATIONS/EXTENTS.

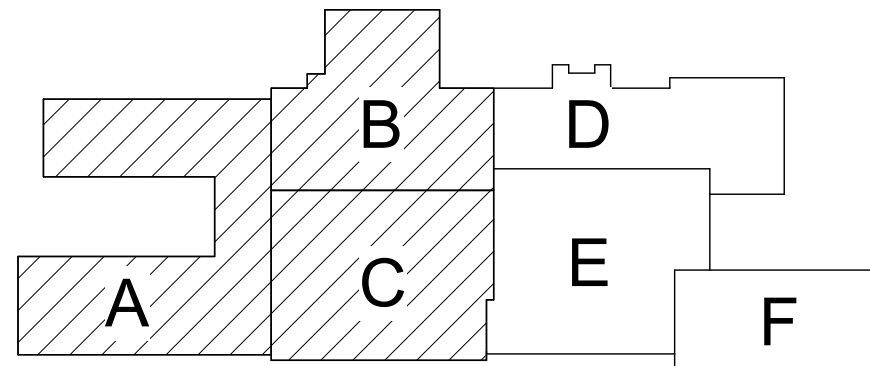

Key Plan
N.T.S.

SED Control No. 60-01-01-06-0-018-023

Rev. No.: Date: Description:



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Waverly Central School District
Waverly, NY

Additions and Alterations to:
Waverly Jr. Sr. High School

Partial First Floor Abatement Plan -
Areas A, B, & C

Drawn By:
TJT
Project No.:
339070-22003

Date:
05/19/2023

Drawing Number:

AH100



J13 REMOVE LIMITED CMU BLOCKS AT EXISTING BEAM POCKETS AS REQUIRED TO ACCOMMODATE STRUCTURAL MODIFICATIONS. REFER TO STRUCTURAL DRAWINGS FOR LOCATIONS/EXTENT.

K1 INSTALL FRAMING FOR NEW WALL(S) AT CMU WALL WITH ASBESTOS PAINT.


K2 INSTALL BLOCKING OR SIMILAR ATTACHMENT HARDWARE TO CMU WALL(S) WITH ACM PAINT FOR NEW FIXTURES/ DEVICES/EQUIPMENT INSTALLATION THROUGHOUT SPACE

K3 INSTALL CEILING TILE PERIMETER GRID AT WALL(S) WITH ACM PAINT

K4 PROVIDE PENETRATION THROUGH WALL(S) WITH ACM PAINT. LOCATION TO BE FIELD DIRECTION BY CONTRACTOR RESPONSIBLE FOR ASSOCIATED WORK.

1. REFER TO AH100 FOR ADDITIONAL ABATEMENT NOTES

	REMOVE ASBESTOS CONTAINING FLOOR TILE WITH NON-ACM MASTIC
(A)	REMOVE ASBESTOS AND LEAD CONTAINING WINDOW FRAME & SILL CAULK
(B)	NOT USED
(C)	NOT USED
(D)	REMOVE INTERIOR DOOR PANEL(S) WITH ASBESTOS CONTAINING GLAZING COMPOUND
(E)	REMOVE CLOCK/SPEAKER COMBO DEVICE WITH ASBESTOS CONTAINING COATING CONTAINED WITHIN THE DEVICE
(F)	REMOVE ASBESTOS AND LEAD CONTAINING COLUMN CAULK
(G)	REMOVE SINK WITH ASBESTOS CONTAINING UNDERCOATING
(H)	REMOVE MIRROR/CHALK/TACK BOARD WITH ASSUMED ASBESTOS CONTAINING MASTIC. REMOVE MASTIC COMPLETE FROM SUBSTRATE.
(I)	NOT USED
(J1)	REMOVE CMU WALL OR PORTION OF WALL WITH ASBESTOS PAINT
(J2)	REMOVE NON-ACM DOOR FRAME FROM CMU WALL/OPENING WITH ACM PAINT. REMOVE ACM WALL PAINT FROM OPENING.
(J3)	CAREFULLY REMOVE CASEWORK/SHELVING/FURNITURE FROM CMU WALL WITH ASBESTOS PAINT. CLEAN ITEM OF ALL ACM PAINT AND STORE FOR SALVAGE.
(J4)	REMOVE NON-ACM BASE AND MASTIC FROM CMU WALL WITH ACM PAINT. REMOVE ACM PAINT FROM BOTTOM 4-INCHES OF WALL TO ALLOW FOR INSTALLATION OF NEW BASE.
(J5)	REMOVE MISC. ITEM FROM WALL WITH ACM CMU WALL PAINT. COORDINATE WITH OTHER DRAWINGS FOR ITEM TYPE.
(J6)	REMOVE NON-ACM CEILING GRID PERIMETER FROM WALL WITH ACM PAINT.
(J7)	REMOVE NON-ACM Furring, ASSUMED TO BE INSTALLED OVER TOP OF ACM CMU WALL PAINT, FROM ALL WALLS SCHEDULED TO REMAIN
(J8)	REMOVE FACE OF CMU WALL WITH ACM PAINT TO ALLOW FOR INSTALLATION OF NEW COLUMN AND ASSOCIATED CONNECTIONS. SEE STRUCTURAL DRAWINGS. REFER TO 9/AS531.
(J9)	REMOVE WALL COVERING FROM WALL(S) WITH CMU PAINT ASSUMED TO BE PRESENT BEHIND
(J10)	AT CMU WALL WITH ASBESTOS PAINT, APPROX. AT TOP AND BOTTOM OF WALL, REMOVE FACE OF CMU WALL FOR STRUCTURAL GROUT WORK. SEE STRUCTURAL DRAWINGS. COORDINATE EXTENTS AND LOCATIONS OF REMOVALS WITH 9/AS531.
(J11)	REMOVE TOP COURSE OF ASBESTOS CONTAINING CMU WALL(S) BELOW GIRDER FOR ASSOCIATED STRUCTURAL WORK. COORDINATE WITH STRUCTURAL DRAWINGS. GIRDER IS LOCATED BETWEEN FIRST AND SECOND FLOOR LEVEL.
(J12)	REMOVE LIMITED CMU BLOCKS AT SCHEDULED BEAM POCKETS AS REQUIRED TO ACCOMMODATE NEW STRUCTURAL BEAMS. REFER TO STRUCTURAL DRAWINGS FOR EXACT LOCATIONS/EXTENTS.

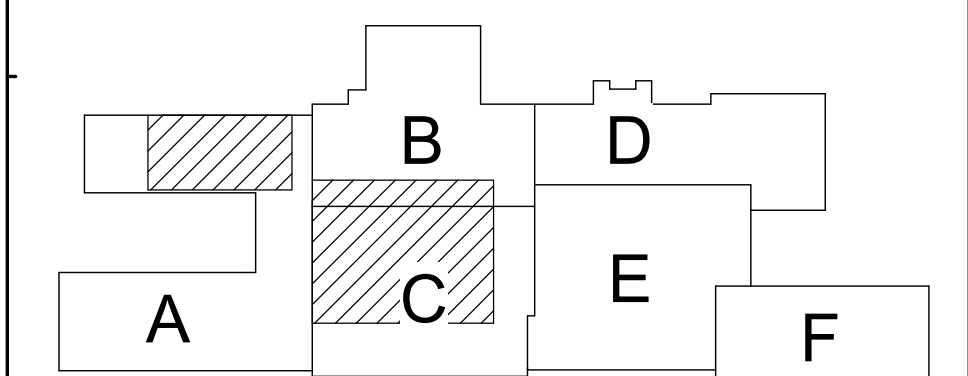

 **Key Plan**
N.T.S.

SED Control No. 60-01-01-06-0-018-023

Rev. No.:	Date:	Description:
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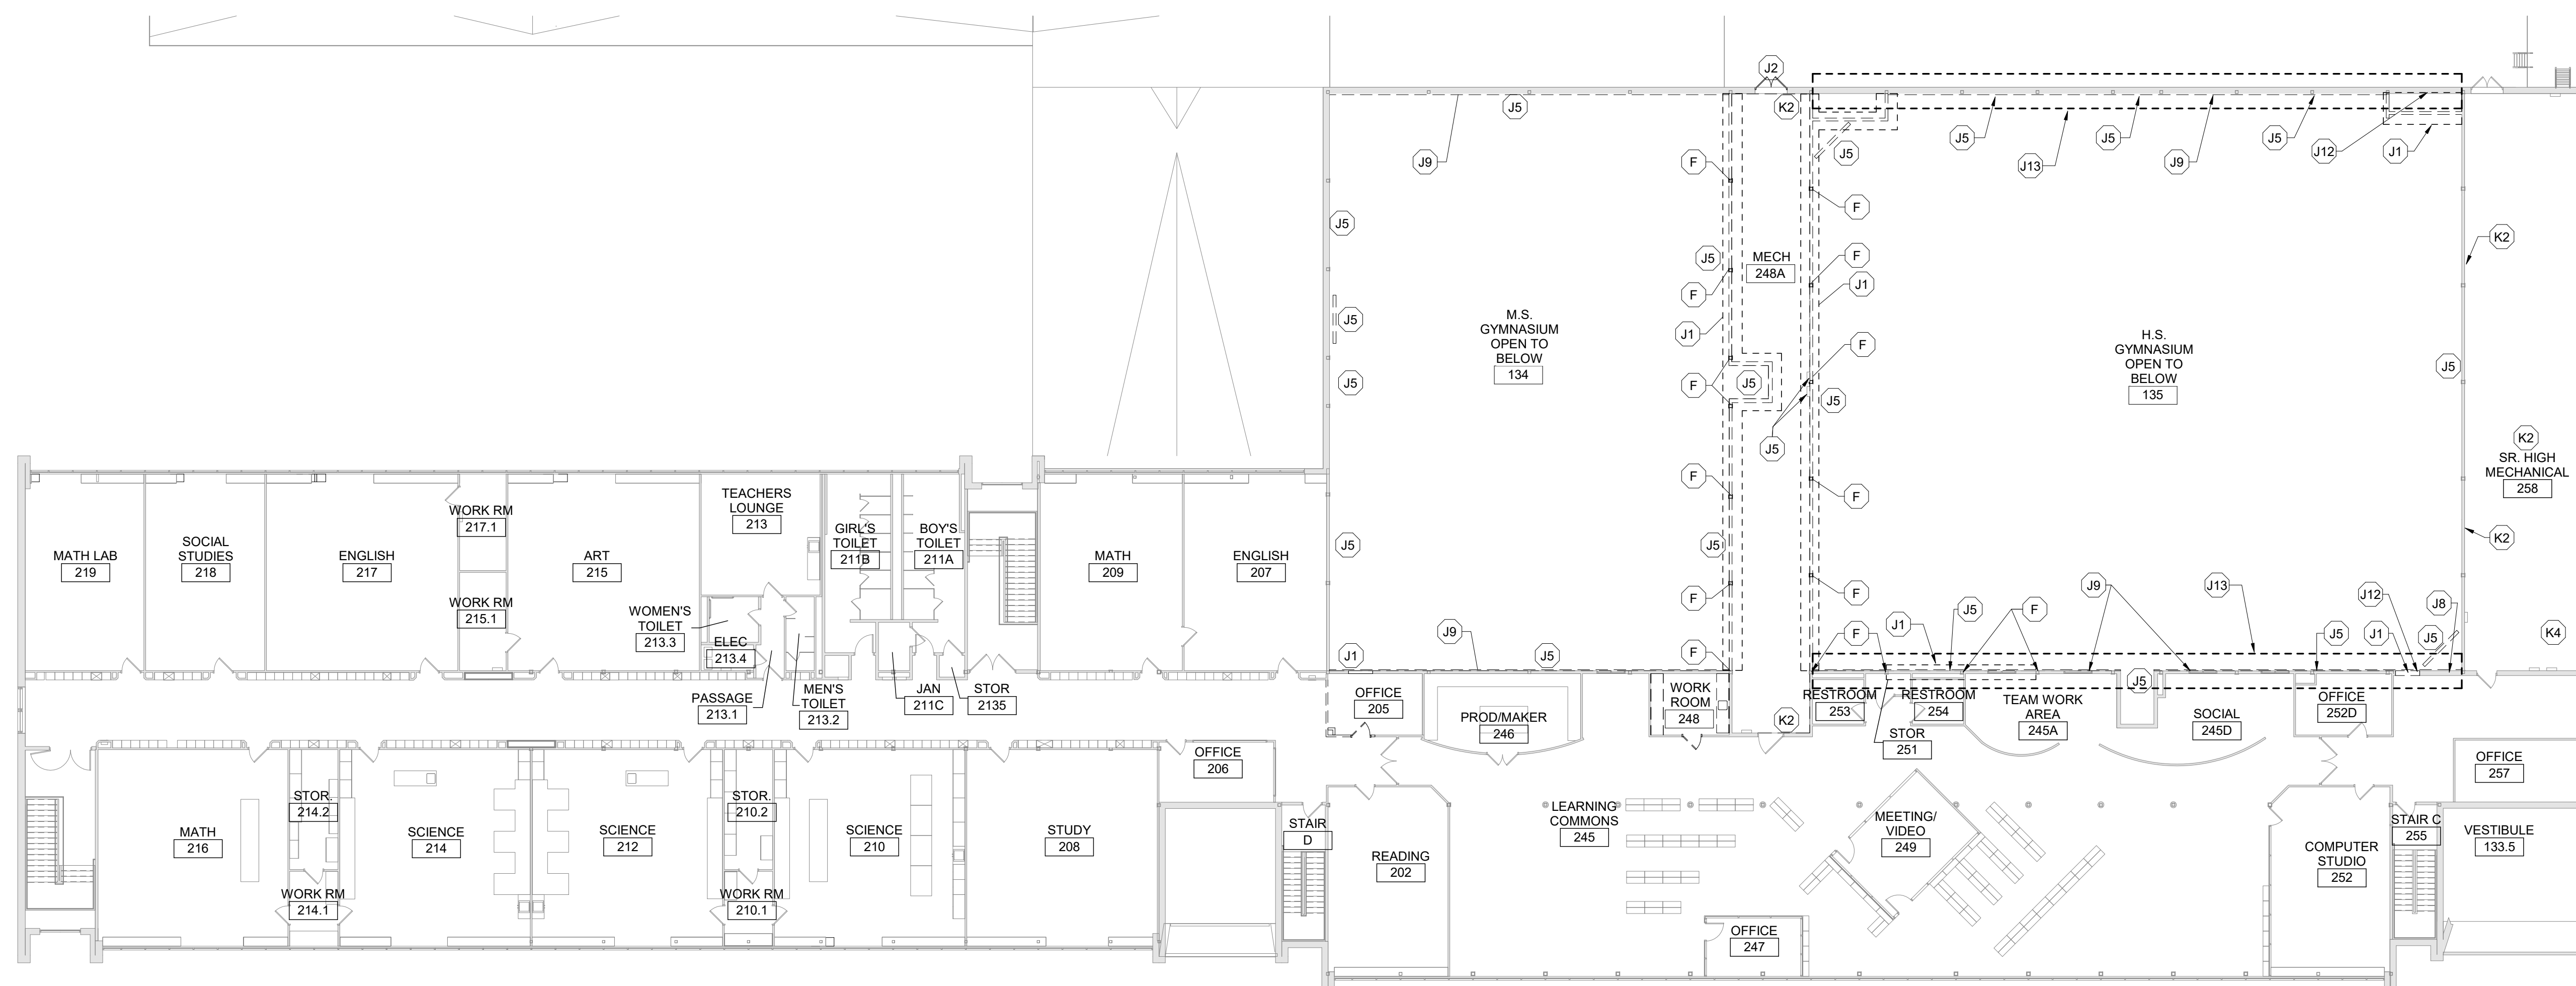


Waverly Central School District
Waverly, NY

Additions and Alterations to:
Waverly Jr. Sr. High School

Partial & Enlarged First Floor Abatement Plans

Drawn By: TJT	Date: 05/19/2023	Drawing Number:
Project No.: 339070-22003		AH101



1 Second Floor Abatement Plan
1/16" = 1'-0"

Legend (Cont.)


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|-----|--|
| J13 | REMOVE LIMITED CMU BLOCKS AT EXISTING BEAM POCKETS AS REQUIRED TO ACCOMMODATE STRUCTURAL MODIFICATIONS. REFER TO STRUCTURAL DRAWINGS FOR LOCATIONS/EXTENT. |
| K1 | INSTALL FRAMING FOR NEW WALL(S) AT CMU WALL WITH ASBESTOS PAINT. |
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Asbestos Abatement General Notes

1. REFER TO AH100 FOR ADDITIONAL ABATEMENT NOTES

Legend

- | | |
|-------|--|
| | REMOVE ASBESTOS CONTAINING FLOOR TILE WITH NON-ACM MASTIC |
| (A) | REMOVE ASBESTOS AND LEAD CONTAINING WINDOW FRAME & SILL CAULK |
| (B) | NOT USED |
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| (D) | REMOVE INTERIOR DOOR PANEL(S) WITH ASBESTOS CONTAINING GLAZING COMPOUND |
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 **Key Plan**
N.T.S.

SED Control No. 60-01-01-06-0-018-023

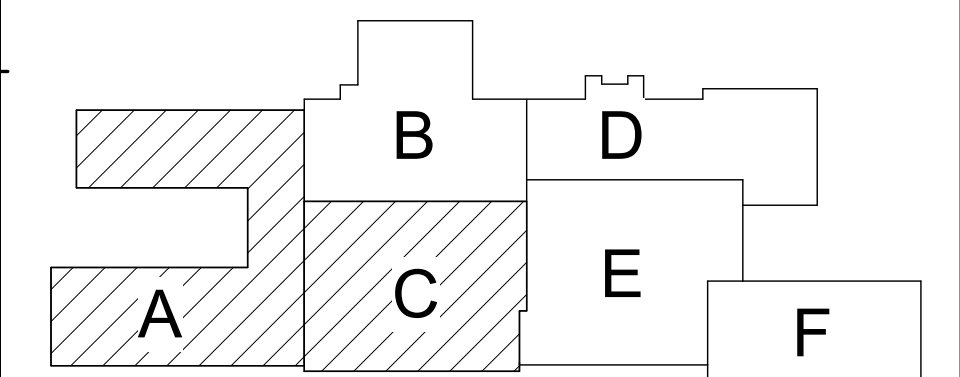Rev. No.:	Date:	Description:
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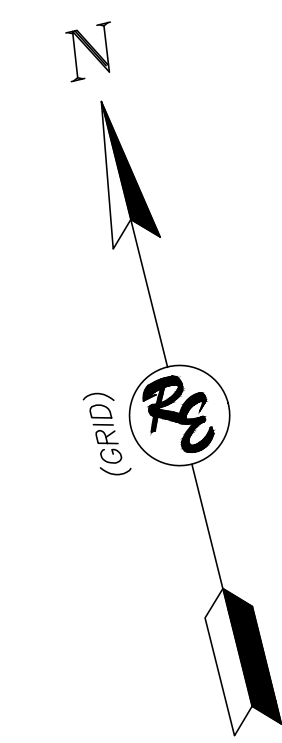
Waverly Central School District
Waverly, NY



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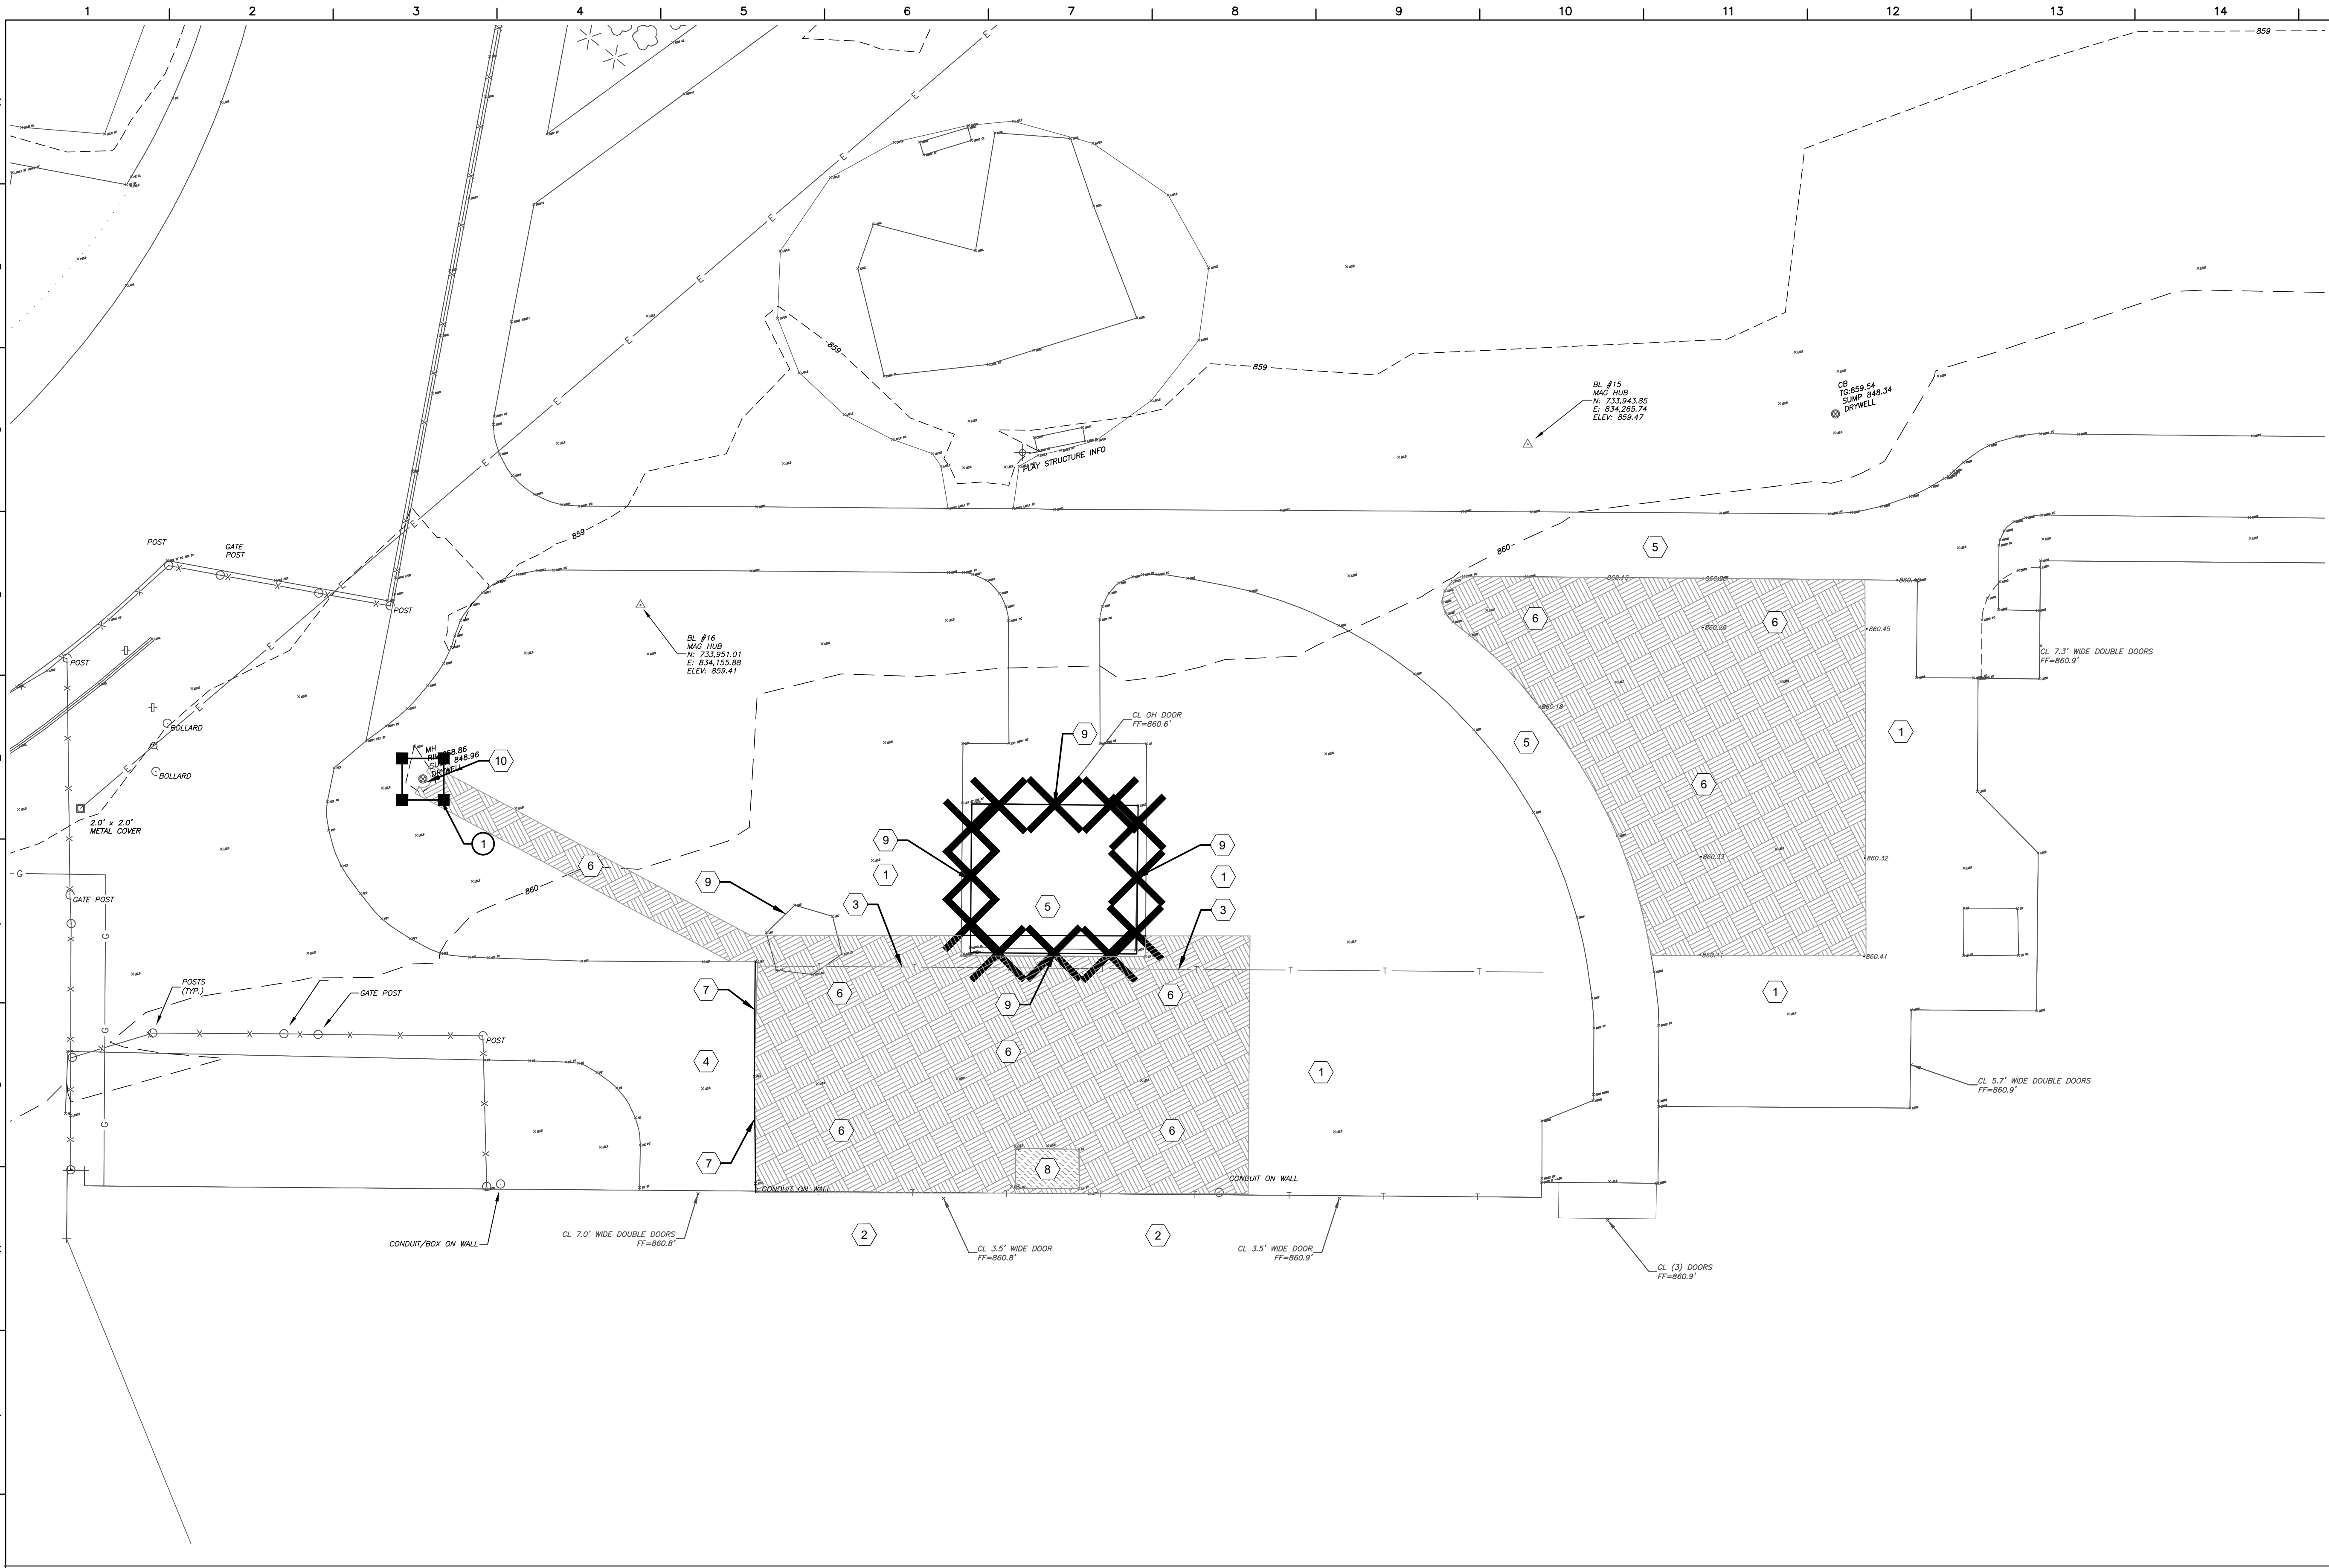
Second Floor Abatement Plan

N	Drawn By: TJT	Date: 05/19/2023	Drawing Number:
	Project No.: 339070-22003		AH102


BID SET



PROJECT #		20-22-079	
ISSUE DATE:		MAY 17, 2022	
SHEET 1 OF 1			
PROJECT NAME		WALKER Y CENTRAL SCHOOL DISTRICT TOWN OF BARTON & VILLAGE OF WAVERLY COUNTY OF TOGA, STATE OF NEW YORK	
PROJECT SURVEYOR		DAVID J. HONNICK J.S.	
DRAWING TITLE		BOUNDARY SURVEY	
MAPPING BY		JOHN FREEMAN	
SCALE		1"=40'	
			
Ravi Engineering, P.C. 2110 SOUTH CLINTON AVENUE, SUITE 1 ROCHESTER, NEW YORK 14618 TEL: (585) 223-3660 FAX: (585) 697-1762		THE INFORMATION ON THIS DRAWING WAS OBTAINED FROM THE RECORD DRAWINGS AND FIELD SURVEY. THE SURVEY WAS CONDUCTED IN ACCORDANCE WITH THE PROFESSIONAL ENGINEERING ACT AND THE RULES OF THE BOARD OF ENGINEERS OF THE STATE OF NEW YORK.	
NO.		REVISION	
DATE			



I Site Demolition Plan
1" = 10'

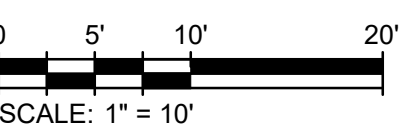

Site Preparation/Demolition Key Notes

- EXISTING LAWN AREA TO REMAIN - REPAIR AS REQUIRED
- EXISTING BUILDING STRUCTURE TO REMAIN. PROTECT.
- EXISTING UTILITY TO REMAIN, PROTECT.
- EXISTING ASPHALT TO REMAIN, PROTECT. (TYPICAL)
- EXISTING CONCRETE TO REMAIN, PROTECT. (TYPICAL)
- STRIP, SCREEN, AND STOCKPILE TOPSOIL. STOCKPILE LOCATION TO BE APPROVED BY OWNER'S REPRESENTATIVE. REMOVE SUBGRADE AS REQUIRED TO MEET DESIGN GRADES AND ACCOMMODATE NEW WORK. AVOID DAMAGE TO EXISTING BURIED UTILITIES (TYPICAL).
- SAW CUT EXISTING ASPHALT PAVEMENT AS REQUIRED FOR INSTALLATION OF ADJACENT CONCRETE PAD AND FORM, LEAVING NEAT, SMOOTH AND STRAIGHT EDGE (TYPICAL).
- REMOVE EXISTING CONCRETE PAVEMENT SECTION, INCLUDING AGGREGATE AND SUBBASE. REMOVE ADDITIONAL SUBBASE AS REQUIRED TO MEET DESIGN GRADES AND ACCOMMODATE NEW WORK.
- EXISTING STRUCTURE TO BE REMOVED BY OWNER. VERIFY DISCONNECTION OF UTILITIES PRIOR TO CONSTRUCTION.
- CORE EXISTING DRAINAGE STRUCTURE AT INVERT INDICATED ON AC120. REMOVE DEBRIS AND SEDIMENT FROM STRUCTURE FOLLOWING CORING OPERATIONS. CLEAR RIM AND SURROUNDING LAWN AS NECESSARY TO ASSURE POSITIVE DRAINAGE.

Site Preparation/Demolition General Notes

- THESE GENERAL SITE / PREPARATION / DEMOLITION NOTES REFER TO AC-SERIES DRAWINGS.
- THE INTENT OF THIS DRAWING IS TO INDICATE PREPARATORY WORK, REMOVALS AND DEMOLITION NECESSARY TO CONSTRUCT THE PROJECT AS SHOWN ON THE REST OF THE CONTRACT DRAWINGS. SOME NOTES ARE GENERAL IN NATURE AND IT SHALL BE UNDERSTOOD THAT IT IS NOT FEASIBLE TO INDICATE EACH AND EVERY SPECIFIC REMOVAL. SITE PREPARATION / DEMOLITION DRAWINGS SHALL NOT BE USED ALONE, BUT SHALL BE USED IN CONJUNCTION WITH THE OTHER DRAWINGS FOR WORK TO BE REMOVED, REUSED, AND / OR REVISED NOT INDICATED HERE.
- CONTRACTOR TO MAINTAIN UTILITY SERVICES TO BUILDINGS TO REMAIN. IF UTILITY SERVICES MUST BE INTERRUPTED THE CONTRACTOR SHALL COORDINATE THAT SHUTDOWN TO MINIMIZE IMPACT TO BUILDINGS. SEE PROJECT MANUAL REGARDING COORDINATION OF DEMOLITION WORK WITH UTILITY COMPANIES.
- THE CONTRACTOR IS RESPONSIBLE TO MAINTAIN SAFE SITE ACCESS TO PEDESTRIAN, VEHICULAR TRAFFIC, EMERGENCY AND HEALTH SAFETY AGENCIES. IF ACCESS WILL BE COMPROMISED IT WILL BE THE RESPONSIBILITY OF THE CONTRACTOR TO COORDINATE AT LEAST ONE WEEK IN ADVANCE WITH THE OWNER'S REPRESENTATIVE AND HEALTH SAFETY AGENCIES, UNLESS OTHERWISE NOTED IN THE PROJECT MANUAL.
- UTILITIES, SIDEWALKS, PAVEMENT, SLABS, FOUNDATIONS, AND MISCELLANEOUS FEATURES NOTED TO BE DEMOLISHED SHALL BE SPOILED OFF-SITE IN A LEGAL MANNER UNLESS OTHERWISE DIRECTED BY THE OWNER'S REPRESENTATIVE. NO BURNING OF DEBRIS SHALL BE ALLOWED. IMMEDIATELY BACKFILL VOIDS WITH COMPACTED GRANULAR MATERIAL AS SPECIFIED.
- WHEN A SITE FEATURE IS INDICATED TO BE REMOVED, THE SITE FEATURE, INCLUDING APPURTENANCES AND FOOTINGS, SHALL BE DISPOSED OF LEGALLY OFF SITE, UNLESS OTHERWISE INDICATED. IMMEDIATELY BACKFILL VOIDS WITH COMPACTED GRANULAR MATERIALS, AS SPECIFIED.
- WHEN A SITE FEATURE IS INDICATED TO REMAIN, IT SHALL BE PROTECTED AS INDICATED AND / OR SPECIFIED. WHEN DISTURBANCE OCCURS AROUND AN EXISTING FEATURE, THE CONTRACTOR SHALL USE ADDITIONAL PRECAUTIONS INCLUDING, BUT NOT LIMITED TO HAND DIGGING TO PROTECT THE FEATURE.
- EXISTING ON-SITE UTILITIES SHALL REMAIN UNLESS DESIGNATED FOR REMOVAL. PROTECT ALL EXISTING UTILITIES TO REMAIN.
- MANHOLES, CATCH BASINS, CLEAN OUTS, VALVE BOXES, FRAMES, COVERS AND GRATES REMAINING IN USE SHALL BE PROTECTED AND ADJUSTED TO FINAL GRADES. CONTRACTOR SHALL MAINTAIN POSITIVE DRAINAGE AT ALL TIMES.
- CONTRACTOR IS RESPONSIBLE TO VERIFY GRADES AND UTILITIES SHOWN ON EXISTING CONDITIONS PLAN PRIOR TO START OF WORK. DISCREPANCIES ARE TO BE DOCUMENTED AND SUBMITTED TO THE OWNER'S REPRESENTATIVE AT THE TIME OF DISCOVERY.
- CONTRACTOR SHALL BE RESPONSIBLE FOR RELOCATIONS, INCLUDING, BUT NOT LIMITED TO, UTILITIES, STORM DRAINAGE, SIGNS, ETC. AS INDICATED ON DESIGN DOCUMENTS.
- IF EXISTING SITE FEATURES TO REMAIN ARE DAMAGED DURING CONSTRUCTION BY CONTRACTOR, SITE FEATURES SHALL BE REPAIRED IN-KIND, TYPICAL.
- CONTRACTOR TO REMOVE OR RELOCATE, WHEN APPLICABLE, ALL CONNECTING IMPROVEMENTS, DRAIN PIPES, SANITARY SEWER PIPES, POWER POLES, AND GUY WIRES, WATER METERS AND WATER LINES, WELLS, SIDEWALKS, SIGN POLES, UNDERGROUND GAS, SEPTIC TANKS, AND ASPHALT, SHOWN AND NOT SHOWN, WITHIN CONSTRUCTION LIMITS AND WHERE NEEDED, TO ALLOW FOR NEW CONSTRUCTION AS SHOWN.
- CONTRACTOR TO NOTIFY OWNER'S REPRESENTATIVE IF UNIDENTIFIED UTILITIES ARE ENCOUNTERED INCLUDING, BUT NOT LIMITED TO, STORM SEWER, SANITARY SEWER, TELECOMMUNICATIONS SERVICE, ELECTRICAL SERVICE, GAS SERVICE, WATER SERVICE, IRRIGATION LINES. UTILITIES LINES TO REMAIN UNDISTURBED UNTIL DIRECTED BY OWNER'S REPRESENTATIVE.
- CONTRACTOR SHALL REQUEST UFPO PRIOR TO START OF ANY WORK. *DIG SAFELY NEW YORK - CALL 811 - BEFORE YOU DIG*.

Site Phasing Notes

- INSTALL SOIL EROSION AND SEDIMENT CONTROL MEASURES BEFORE SOIL DISTURBANCE AND INSTALLATION OF OTHER TEMPORARY CONSTRUCTION FEATURES.
- ACCESS ROADS AND CONSTRUCTION ENTRANCES ARE TO BE KEPT CLEAR AT ALL TIMES.
- REFER TO PROJECT MANUAL FOR PHASING INFORMATION FOR INSTALLATION OF PAVING, SIDEWALKS, CURBING AND STORM UTILITIES.
- CONTRACTOR PARKING IS RESTRICTED TO STAGING OR DESIGNATED TEMPORARY PARKING AREAS.
- AT STAGING AND OTHER TEMPORARY AREAS TO BE RESTORED TO LAWN: THOROUGHLY REMOVE GRAVEL, STONES, DEBRIS, VEGETATION, ETC. FROM EXISTING TOPSOIL AND SCARIFY TO A MINIMUM DEPTH OF 6". AMEND TOPSOIL WITH COMPOST AND NUTRITIONAL AMENDMENTS AND FINE GRADE, FERTILIZE AND SEED OR SOD.
- AT STAGING AND OTHER TEMPORARY AREAS ON EXISTING PAVING: CONTRACTOR TO REMOVE AND REPLACE EXISTING PAVING IN ACCORDANCE WITH DRAWINGS AND SPECIFICATIONS.
- PAVING THAT IS DAMAGED DUE TO CONSTRUCTION ACTIVITIES IS TO BE REMOVED AND REPLACED IN ACCORDANCE WITH DRAWINGS AND SPECIFICATIONS.
- LAWN THAT IS DAMAGED DUE TO CONSTRUCTION ACTIVITIES IS TO BE REMOVED AND THE AREA SCARIFIED. PROVIDE NEW TOPSOIL AS REQUIRED TO BRING THE AREA TO MATCH SURROUNDING GRADE. FERTILIZE AND SEED OR SOD.

Soil Erosion & Sediment Control Key Notes

- PROVIDE INLET PROTECTION IN LAWN, TYPICAL. SEE DETAIL 1 / AC500.


General Site Notes

- THESE GENERAL SITE NOTES APPLY TO AC-SERIES DRAWINGS.
- REFER TO SURVEY FOR INFORMATION ON EXISTING FEATURES. IF EXISTING FEATURES ARE MISSING, MODIFIED, OBSCURED, OR THERE IS A CONFLICT BETWEEN HOW AN EXISTING FEATURE IS PORTRAYED ON THIS SHEET AND THE SURVEY, THE SURVEY SHALL GOVERN.
- PRIOR TO CONSTRUCTION, LOCATE AND PROMINENTLY MARK THE PROPERTY LINES IN THE FIELD. PROTECT PROPERTY LINE MARKING AND MONUMENTS DURING CONSTRUCTION UNTIL FINAL ACCEPTANCE.
- THE SURVEY(S) INCLUDED IN THESE DOCUMENTS ARE PROVIDED FOR INFORMATION ONLY AND ARE THE BASE INFORMATION USED TO PREPARE THE WORK INDICATED ON THESE DRAWINGS. THE DATA INDICATED REGARDING EXISTING CONDITIONS IS NOT INTENDED AS REPRESENTATIONS OR WARRANTIES OF THEIR ACCURACY. BY INCLUSION OF THE SURVEY(S) IN THIS SET OF DOCUMENTS, TETRA TECH AND THE OWNER DO NOT ASSUME RESPONSIBILITY FOR ACCURACY OF THE SURVEY, NOR FOR INTERPRETATIONS OR CONCLUSIONS DRAWN THEREFROM BY THE CONTRACTOR.
- THE CONTRACTOR SHALL FIELD VERIFY EXISTING FEATURES, CONDITIONS, UTILITIES, PROPERTY LINES AND TOPOGRAPHY PRIOR TO COMMENCEMENT OF WORK. ANY DISCREPANCIES WHICH WILL AFFECT THE WORK REQUIRED AS PART OF THE CONTRACT DOCUMENTS SHALL BE IMMEDIATELY REPORTED IN WRITING TO THE ARCHITECT. COMMENCEMENT OF WORK WITHOUT THIS WRITTEN NOTIFICATION SHALL CONSTITUTE CONTRACTOR ACCEPTANCE OF THE EXISTING INFORMATION INDICATED ON THE DRAWINGS AS ACCURATE. NO ADJUSTMENTS TO THE CONTRACT WILL BE MADE FOR THE DISCREPANCIES BROUGHT TO THE OWNER'S ATTENTION AFTER WORK HAS BEGUN.
- NO ATTEMPT HAS BEEN MADE TO SHOW ALL UNDERGROUND UTILITIES ON THIS DRAWING. CONTACT UNDERGROUND UTILITY LOCATION ORGANIZATION AND LOCAL UTILITY COMPANIES TO VERIFY THE LOCATION OF UTILITIES PRIOR TO EARTHWORK, TRENCHING OR EXCAVATION OPERATIONS.
- CONTRACT LIMIT LINE SHALL BE TEN FEET OUTSIDE OF LIMITS OF WORK INDICATED ON THESE DRAWINGS AND NOT TO EXTEND BEYOND THE PROPERTY LINE UNLESS OTHERWISE INDICATED.
- CONTRACTOR SHALL PROVIDE CONSTRUCTION/PROTECTIVE FENCING OR OTHER MEANS NECESSARY TO PROTECT WORK AND TO ENSURE SAFETY OF THE PUBLIC, PEDESTRIANS AND VEHICULAR TRAFFIC DURING CONSTRUCTION.
- FOR INFORMATION REGARDING SUBSURFACE CONDITIONS AND TEST LOCATIONS, COORDINATE WITH OWNER REGARDING THE AVAILABILITY OF GEOTECHNICAL INFORMATION.
- AT EDGE OF ALL NEW PAVING MEETING LAWN, REMOVE EXISTING TURF TO MINIMUM OF 4-FT FROM NEW PAVEMENT EDGE, UNLESS OTHERWISE NOTED. CUT NEAT REMOVAL LINE AND SCARIFY EXISTING GRADE. PROVIDE TAMPED TOPSOIL TO BRING EXISTING GRADE FLUSH WITH NEW PAVING. SLOPE LAWN AWAY FROM PAVING TO PREVENT PONDING. FINE GRADE, FERTILIZE, SEED AND MULCH IN ACCORDANCE WITH THE PROJECT MANUAL.

SITE DEMOLITION AND PREPARATION LEGEND	
XXXX	REMOVE SITE FEATURE AS INDICATED IN DEMOLITION KEYNOTES (Outline of Feature)
	REMOVE EXISTING CONCRETE PAVEMENT SECTION AND SUBBASE AS REQUIRED
	REMOVE EXISTING LAWN AND SOIL AS REQUIRED

S.E.D. Control No. 60-01-01-06-0-018-023

Rev. No.:	Date:	Description:



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TETRA TECH
ARCHITECTS & ENGINEERS


Waverly Central School District
Waverly, NY

Additions and Alterations to:
Waverly Jr. Sr. High School


Site Demolition Plan

Drawn by: DFL	Date: 12/30/22	Drawing No.: AC100
Project No.: 339070-22003		

BID SET

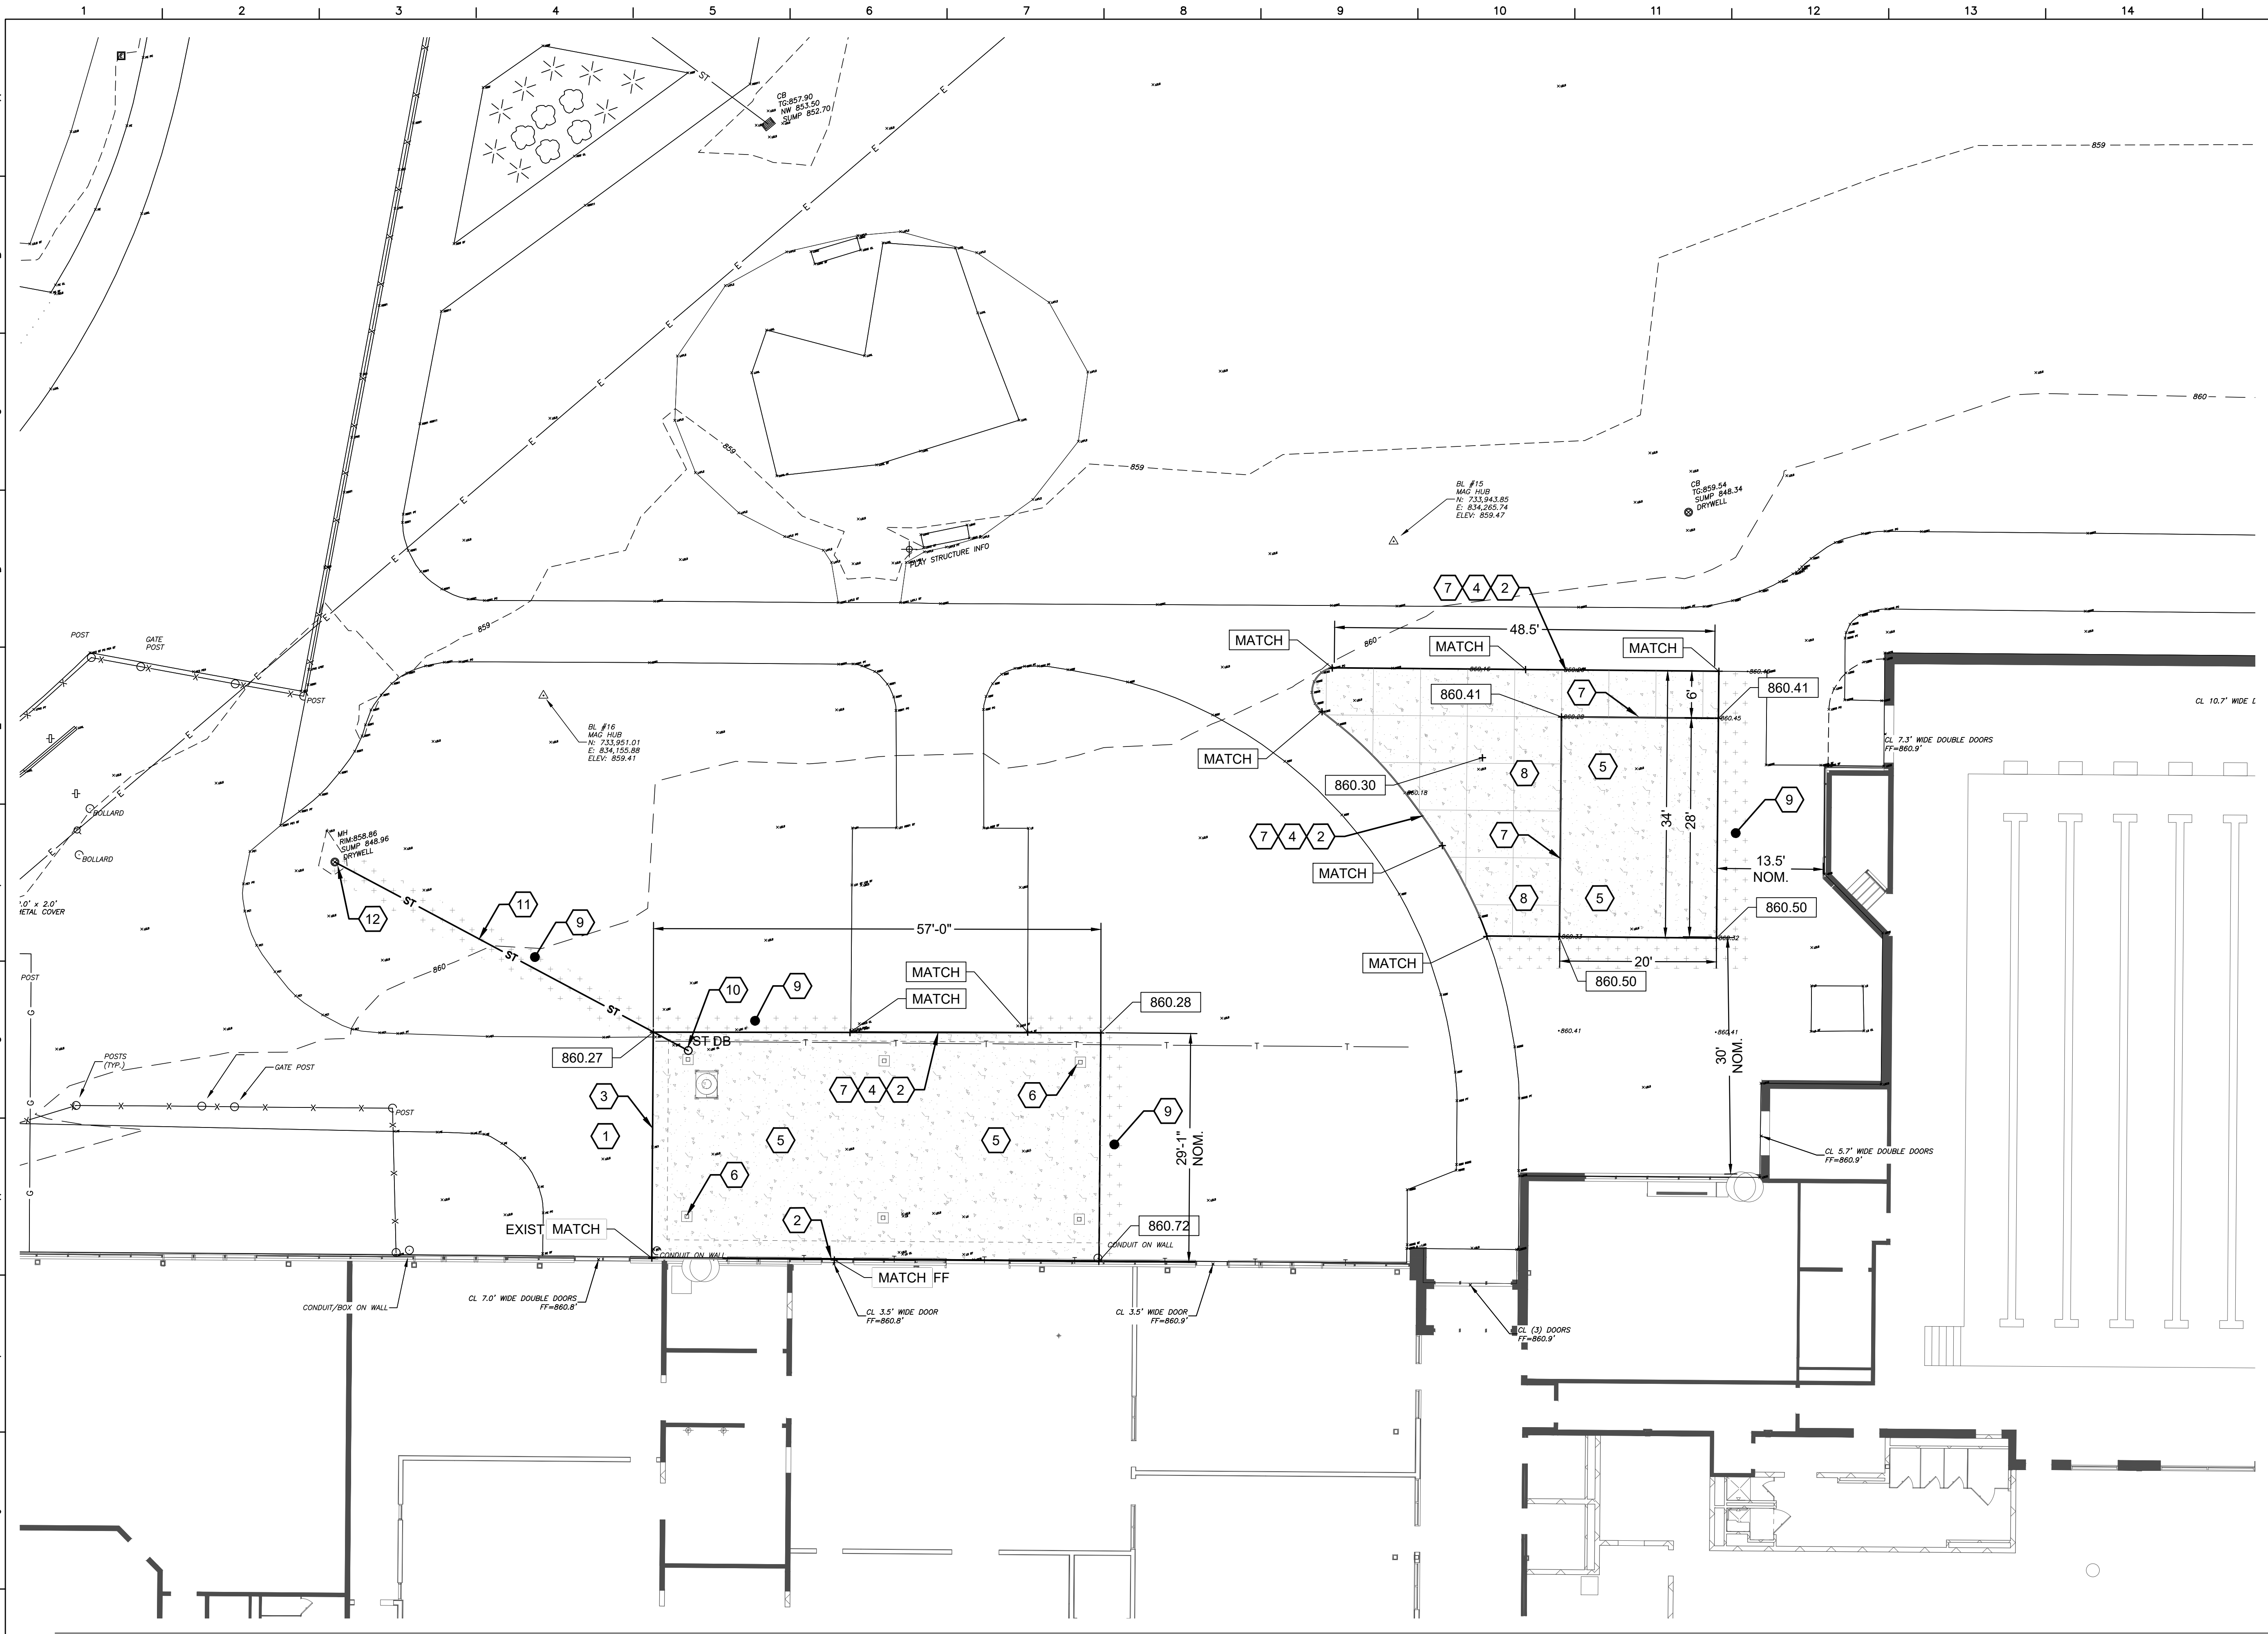

I Site Layout Plan
1" = 10'

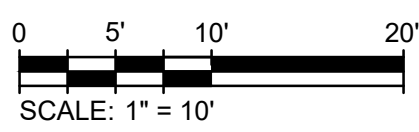

General Grading Plan Notes

1. ALL FILL MATERIALS, INCLUDING ON-SITE MATERIALS, ARE TO BE SUBMITTED FOR ARCHITECT APPROVAL BEFORE PLACEMENT. REFER TO EARTH MOVING SPECIFICATION FOR REQUIREMENTS.
2. ALL CUT OR FILL SLOPES SHALL BE 3:1 OR FLATTER UNLESS OTHERWISE NOTED.
3. EXCESS MATERIAL CUT FROM THE SITE (WITH THE EXCEPTION OF TOPSOIL) SHALL BE REMOVED FROM THE SITE AND LEGALLY DISPOSED OF PER THE PROJECT MANUAL.
4. OWNER'S GEOTECHNICAL ENGINEER TO BE PRESENT FOR ALL FILL AND COMPACTION OPERATIONS, INCLUDING TRENCHES AND STORMWATER STRUCTURES. REFER TO EARTH MOVING SPECIFICATION FOR GEOTECHNICAL TESTING REQUIREMENTS.
5. CONTRACTOR SHALL ASSURE POSITIVE DRAINAGE AWAY FROM BUILDINGS AND STRUCTURES FOR NATURAL AND PAVED AREAS.
6. SPREAD TOPSOIL TO A MINIMUM DEPTH OF 6-INCHES CONTINUOUS SETTLED DEPTH OVER AREAS OF THE SITE WHERE EARTH HAS BEEN DISTURBED, EXCEPT WHERE BUILDING OR PAVING IS PROPOSED.
7. DISTURBED AREAS THAT ARE NOT RECEIVING PAVEMENT SHALL BE FINE GRADED, SEEDED, FERTILIZED AND MULCHED AS PER THE PROJECT MANUAL.
8. AFTER FINE GRADING IS COMPLETED, INFORM THE OWNER AND A/E SO THAT AN INSPECTION OF THE FINE GRADING CAN TAKE PLACE BEFORE SEEDING IS BEGUN. IF INSPECTION DOES NOT TAKE PLACE, APPROVAL OF LAWN MAY BE DELAYED OR DENIED.
9. PROVIDE GRADE ADJUSTING RINGS OR SHIMS AT DROP-INLETS, CATCH BASINS AND MANHOLES IN AREAS SCHEDULED FOR REPAVING OR REGRADE TO BRING RIMS UP TO LEVEL OF NEW FINISHED GRADE.
10. EXISTING AND PROPOSED GRADE CONTOUR INTERVALS SHOWN AT 1-FOOT INTERVALS.
11. ALL STORM SEWER MANHOLES IN PAVED AREAS SHALL BE FLUSH WITH PAVEMENT, AND SHALL HAVE TRAFFIC BEARING LIDS.
12. CONTRACTOR SHALL ADJUST AND/OR CUT EXISTING PAVEMENT AS NECESSARY TO ASSURE A SMOOTH FIT AND CONTINUOUS GRADE.
13. CONTRACTOR SHALL COMPLY WITH ALL APPLICABLE GOVERNING CODES AND BE CONSTRUCTED TO SAME.

General Utility Plan Notes

1. CONTRACTOR IS RESPONSIBLE FOR REPAIRS OR DAMAGE TO ANY EXISTING UTILITY DURING CONSTRUCTION AT NO COST TO THE OWNER.
2. SEE PROJECT MANUAL FOR BACKFILLING AND COMPACTION REQUIREMENTS FOR UTILITY TRENCHES.
3. FILL MATERIAL IS TO BE IN PLACE AND COMPACTED BEFORE INSTALLATION OF PROPOSED UTILITIES.
4. ALL WATER AND OTHER UTILITIES SHOULD BE KEPT TEN-FEET (10-FT) APART (PARALLEL) OR WITH 18 INCH CLEARANCE WHEN CROSSING VERTICALLY (OUTSIDE EDGE OF PIPE TO OUTSIDE EDGE OF PIPE)
5. LINES UNDERGROUND SHALL BE INSTALLED, INSPECTED AND APPROVED BEFORE BACKFILLING.
6. TOPS OF EXISTING MANHOLES, DRAINAGE INLETS, HYDRANTS AND WATER LINE VALVE BOXES SHALL BE RAISED AS NECESSARY TO BE FLUSH WITH PROPOSED PAVEMENT ELEVATIONS.
7. DRAWINGS DO NOT PURPORT TO SHOW ALL EXISTING UTILITIES.
8. EXISTING UTILITIES SHALL BE VERIFIED IN FIELD PRIOR TO INSTALLATION OF ANY NEW LINES.
9. THE CONTRACTOR IS SPECIFICALLY CAUTIONED THAT THE LOCATION AND/OR ELEVATION OF EXISTING UTILITIES AS SHOWN ON THESE PLANS IS BASED ON RECORDS OF THE VARIOUS UTILITY COMPANIES AND/OR MEASUREMENTS TAKEN IN THE FIELD. THE INFORMATION IS NOT TO BE RELIED ON AS BEING EXACT OR COMPLETE. CONTRACTOR TO REFER TO PROJECT MANUAL REGARDING COORDINATION WITH UTILITY COMPANIES BEFORE ANY EXCAVATION REGARDING FIELD LOCATION OF UTILITIES.
10. THE CONTRACTOR SHALL CONDUCT REQUIRED TESTS TO THE SATISFACTION OF THE RESPECTIVE UTILITY COMPANIES AND THE OWNER'S INSPECTING AUTHORITIES.
11. CONTRACTOR SHALL COMPLY TO THE FULLEST EXTENT WITH THE LATEST STANDARDS OF OSHA DIRECTIVES OR ANY OTHER AGENCY HAVING JURISDICTION FOR EXCAVATION AND TRENCHING PROCEDURES. THE CONTRACTOR SHALL USE SUPPORT SYSTEMS, SLOPING, BENCHING, AND OTHER MEANS OF PROTECTION. THIS TO INCLUDE BUT IS NOT LIMITED TO ACCESS AND EGRESS FROM ALL EXCAVATION AND TRENCHING. CONTRACTOR IS RESPONSIBLE TO COMPLY WITH PERFORMANCE CRITERIA FOR OSHA.
12. THE CONTRACTOR SHALL BE RESPONSIBLE FOR ALL DEWATERING, PUMPING AND TREATMENT OF WATER. NO WATER FROM ANY CONSTRUCTION WORK, PROCESS OR AREA SHALL BE RELEASED DOWN STREAM OR INTO STORM SYSTEMS WITH OUT FIRST BEING TREATED TO REMOVE SEDIMENT, OILS, OR OTHER POLLUTANTS.

Site Layout and Utility Keynotes

1. EXISTING ASPHALT PAVEMENT, PROTECT.
2. SMOOTH TRANSITION FROM PROPOSED SURFACE TO ADJACENT EXISTING SURFACE, TYPICAL.
3. REPAIR ASPHALT PAVING AS REQUIRED FOLLOWING INSTALLATION OF ADJACENT CONCRETE PAD. SEE DETAIL 2 / AC500.
4. NEW CONCRETE AT EXISTING CONCRETE SIDEWALK. SEE DETAIL 3 / AC500.
5. CONCRETE PAD. SEE STRUCTURAL DRAWINGS.
6. SEE ARCHITECTURAL AND STRUCTURAL DRAWINGS FOR CANOPY INSTALLATION, TYPICAL.
7. EXPANSION JOINT AT CONCRETE SLAB. SEE DETAIL 4 / AC500.
8. CONCRETE SIDEWALK. SEE DETAILS 5 AND 6 / AC500.
9. SEEDED AREA - PROVIDE 6-INCHES OF AMENDED TOPSOIL, FINE GRADE, SEED, FERTILIZE AND MULCH. LEAVE NEAT SMOOTH EDGE, TYPICAL.
10. PROVIDE DOWNSPOUT BOOT FROM 4-INCH SQUARE ROOF DRAIN TO 6-INCH HDPE. APPROXIMATE DOWNSPOUT BOOT INV = ±856.77. REFER TO SPECIFICATIONS AND SEE DETAIL 8 / AC500.
11. PROVIDE 51 LF 6-INCH HDPE STORM PIPING AT 2.00% SLOPE. SEE DETAIL 7 / AC500.
12. CONNECT 6-INCH STORM PIPING TO EXISTING DRY WELL AT (ESTIMATED) INVERT ±855.75. VERIFY LOCATION AND DEPTH OF EXISTING STRUCTURE PRIOR TO CONSTRUCTION.

General Site Notes

Site Layout Notes

1. REFER TO DRAWING AC100 FOR GENERAL SITE NOTES THAT APPLY TO ALL AC-SERIES DRAWINGS.
1. LAYOUT DIMENSIONS GIVEN ARE FROM FACE OF BUILDING (FOB), FACE OF CURB (F.O.C.), CENTER LINE (CL) AND EDGE OF PAVEMENTS UNLESS OTHERWISE NOTED.
2. OBJECTS ARE PARALLEL OR PERPENDICULAR TO EACH OTHER UNLESS OTHERWISE NOTED.
3. PAINTED TRAFFIC MARKINGS AND TRAFFIC SIGNS TO COMPLY WITH THE LATEST EDITION OF THE NYSDOT MANUAL OF UNIFORM TRAFFIC CONTROL DEVICES AND LOCAL REQUIREMENTS.
4. VERIFY DIMENSIONS IN FIELD WITH OWNER'S REPRESENTATIVE ANY DIMENSIONS NOTED AS "V.I.F."
5. AT EDGE OF NEW PAVING MEETING LAWN: ADD TOPSOIL ALONG EDGE OF NEW PAVING TO BRING ADJACENT GRADE FLUSH WITH EDGE OF NEW PAVING AT MAXIMUM 3% SLOPE. CUT NEAT LINE IN EXISTING LAWN AT NEW TOPSOIL LIMIT LINE. REFER TO PROJECT MANUAL SIDEWALK AND ASPHALT PAVEMENT SECTIONS FOR ADDITIONAL REQUIREMENTS.
6. SCORE CONCRETE SIDEWALKS AT 5-FT SQUARE UNLESS OTHERWISE NOTED.

Site Layout Legend

	CONCRETE PAVING
	ASPHALT PAVING - AUTO DUTY
	CONCRETE WALK
	TOPSOIL, LAWN SEEDING & MULCHING

GRADING KEY

	SPOT ELEVATION
	MATCH EXISTING GRADE

S.E.D. Control No. 60-01-01-06-0-018-023

Rev. No.: Date: Description:



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Waverly Central School District
Waverly, NY


Additions and Alterations to:
Waverly Jr. Sr. High School

Site Layout, Grading and Utility Plan

Drawn by:
DFL

Date:
12/30/22

Drawing No.:
AC120

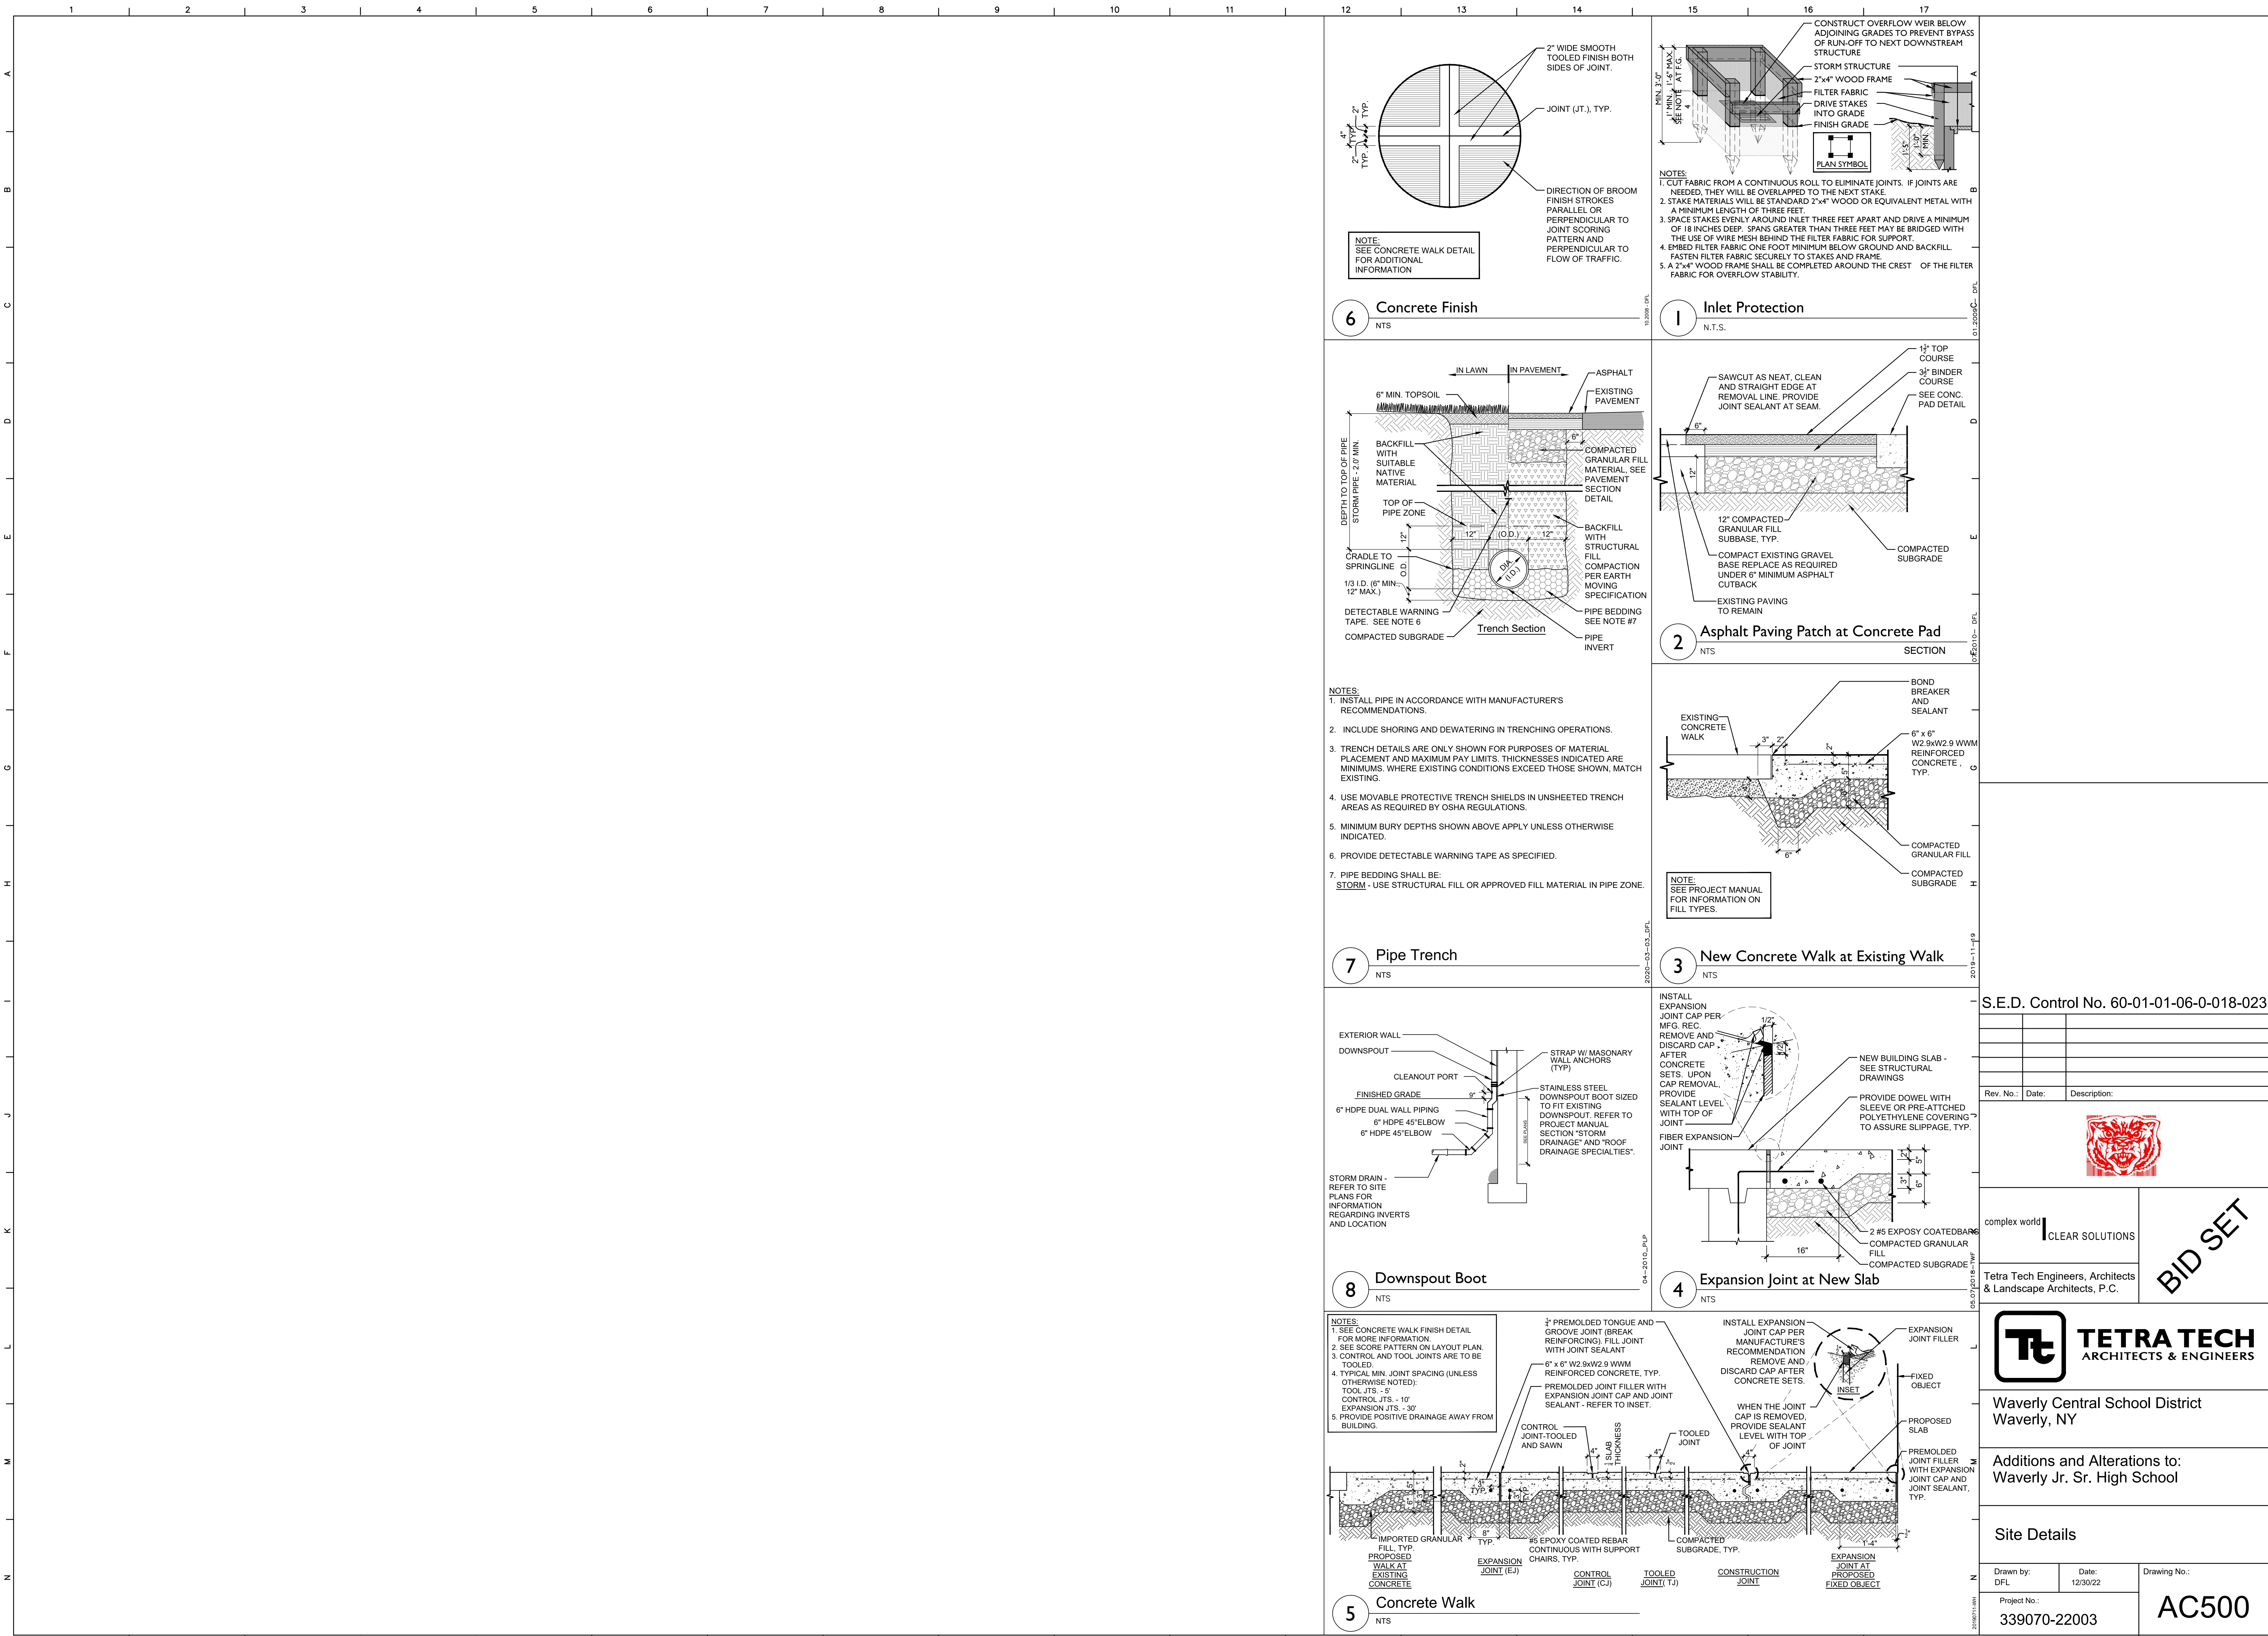

S.E.D. Control No. 60-01-01-06-0-018-023

Rev. No.:	Date:	Description:



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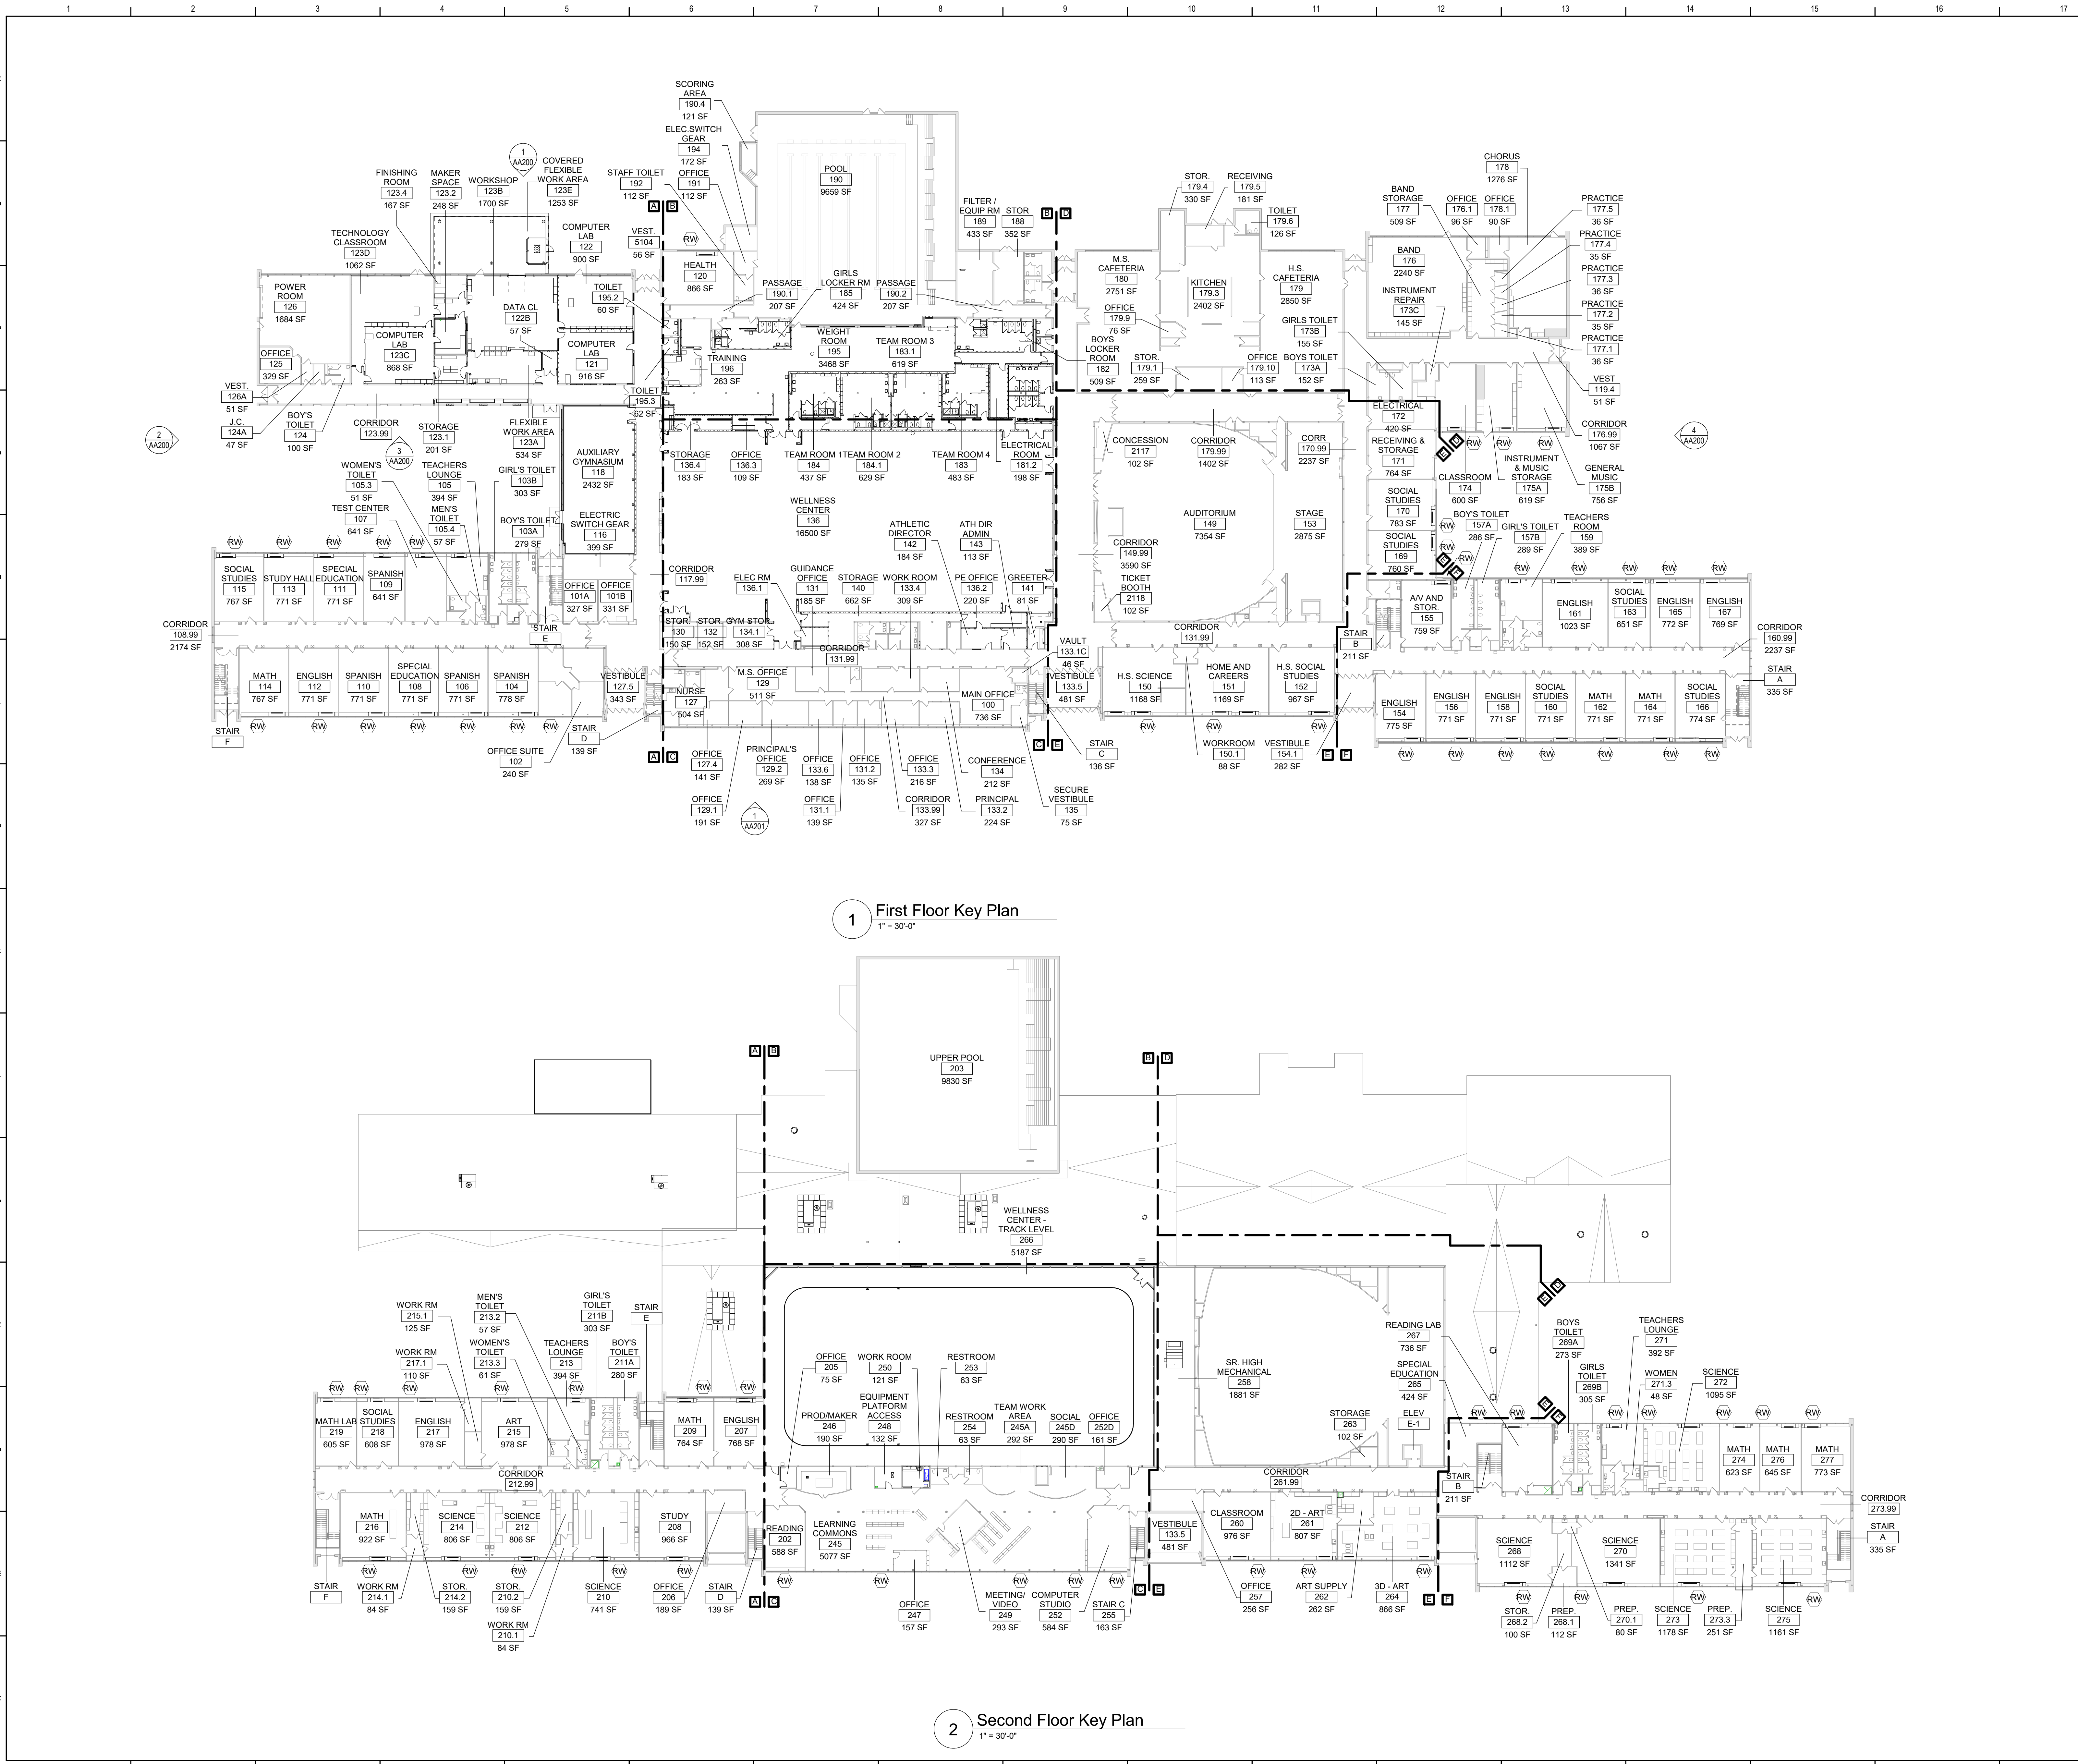


Waverly Central School District
Waverly, NY

Additions and Alterations to:
Waverly Jr. Sr. High School

Site Details

Drawn by: DFL	Date: 12/30/22	Drawing No.:
Project No.:	339070-22003	AC500




General Notes

- A. DO NOT SCALE DRAWINGS TO OBTAIN DIMENSIONS.
- B. TAKE FIELD MEASUREMENTS TO FIT THE WORK PROPERLY. VERIFY ALL EXISTING CONDITIONS AND DIMENSIONS IN THE FIELD.
- C. REFER INCONSISTENCIES TO ARCHITECT PRIOR TO COMMENCING THE WORK IN AFFECTED AREA.
- D. ITEMS ARE SHOWN DIAGRAMMATICALLY ON DRAWINGS. VERIFY SPACE REQUIREMENTS AND DIMENSIONS TO FIT THE WORK PROPERLY.
- E. NOTES SHOWN ON ONE DRAWING APPLY TO ALL SIMILAR DRAWINGS.
- F. DO NOT DISTURB CONSTRUCTION SUSPECTED OF CONTAINING HAZARDOUS MATERIAL. IF ENCOUNTERED, IMMEDIATELY NOTIFY ARCHITECT, CONSTRUCTION MANAGER AND OWNER.
- G. WHERE EXISTING CONSTRUCTION IS DAMAGED OR DISTURBED, PATCH AS REQUIRED TO RESTORE SURFACES TO THEIR ORIGINAL CONDITION.
- H. ALL ARTWORK NOT PERMANENTLY AFFIXED TO EXISTING CONSTRUCTION SHALL BE REMOVED AND STORED BY OWNER PRIOR TO BEGINNING DEMOLITION WORK. CONTACT OWNER'S AGENT(S) IF ANY ARTWORK IS ENCOUNTERED PRIOR TO START OF DEMOLITION WORK.
- I. REMOVE ALL EXISTING WALL MOUNTED ITEMS AS REQUIRED TO PERFORM WORK. SALVAGE, PROTECT AND STORE REMOVED ITEMS FOR REINSTALLATION IN SAME LOCATION. NOT ALL ITEMS HAVE BEEN IDENTIFIED ON ELEVATIONS INCLUDING, BUT NOT LIMITED TO, RECEPTACLES, DOOR HOLDERS, FIRE ALARM PULL STATIONS AND WIRE MOLDING.

Asbestos Awareness – CMU Wall Paint

- 1. CMU WALL PAINT IS ASBESTOS CONTAINING AND IS PRESENT IN AREAS OF SCHEDULED WORK. ASBESTOS PAINT IS LIMITED TO CMU WALLS.
- 2. PERFORM WORK SUCH THAT NO PAINTED CMU WALL SURFACES ARE DISTURBED. DISTURBANCE INCLUDES, BUT IS NOT LIMITED TO DETACHMENT OF EXISTING ITEMS FROM THE WALL, ATTACHMENT OF NEW ITEMS TO THE WALL.
- 3. ADDITIONAL ASBESTOS CONTAINING ITEMS ARE PRESENT AND INDICATED ELSEWHERE WITHIN THE FACILITIES. REFER TO ON-SITE ASBESTOS DOCUMENTATION FOR FURTHER INFORMATION.
- 4. SHOULD ANY PAINTED CMU WALL SURFACE BE REQUIRED TO BE IMPACTED OR DISTURBED, CONSULT THE OWNER'S ENVIRONMENTAL CONSULTANT.

RW RESCUE WINDOW

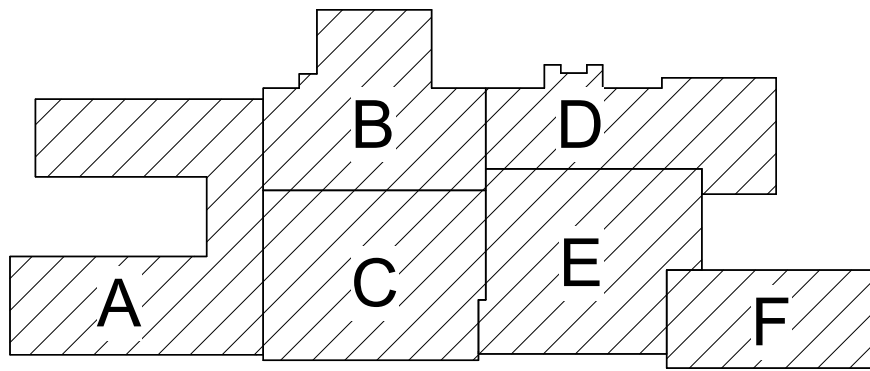

Key Plan
N.T.S.



SED Control No. 60-01-01-06-0-018-023

Rev. No.: Date: Description:



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Waverly Central School District
Waverly, NY

Additions and Alterations to:
Waverly Jr. Sr. High School


First and Second Floor Key Plans

Drawn By:
KCB
Project No.:
339070-22003


Date:
05/19/2023

Drawing Number:

AA050

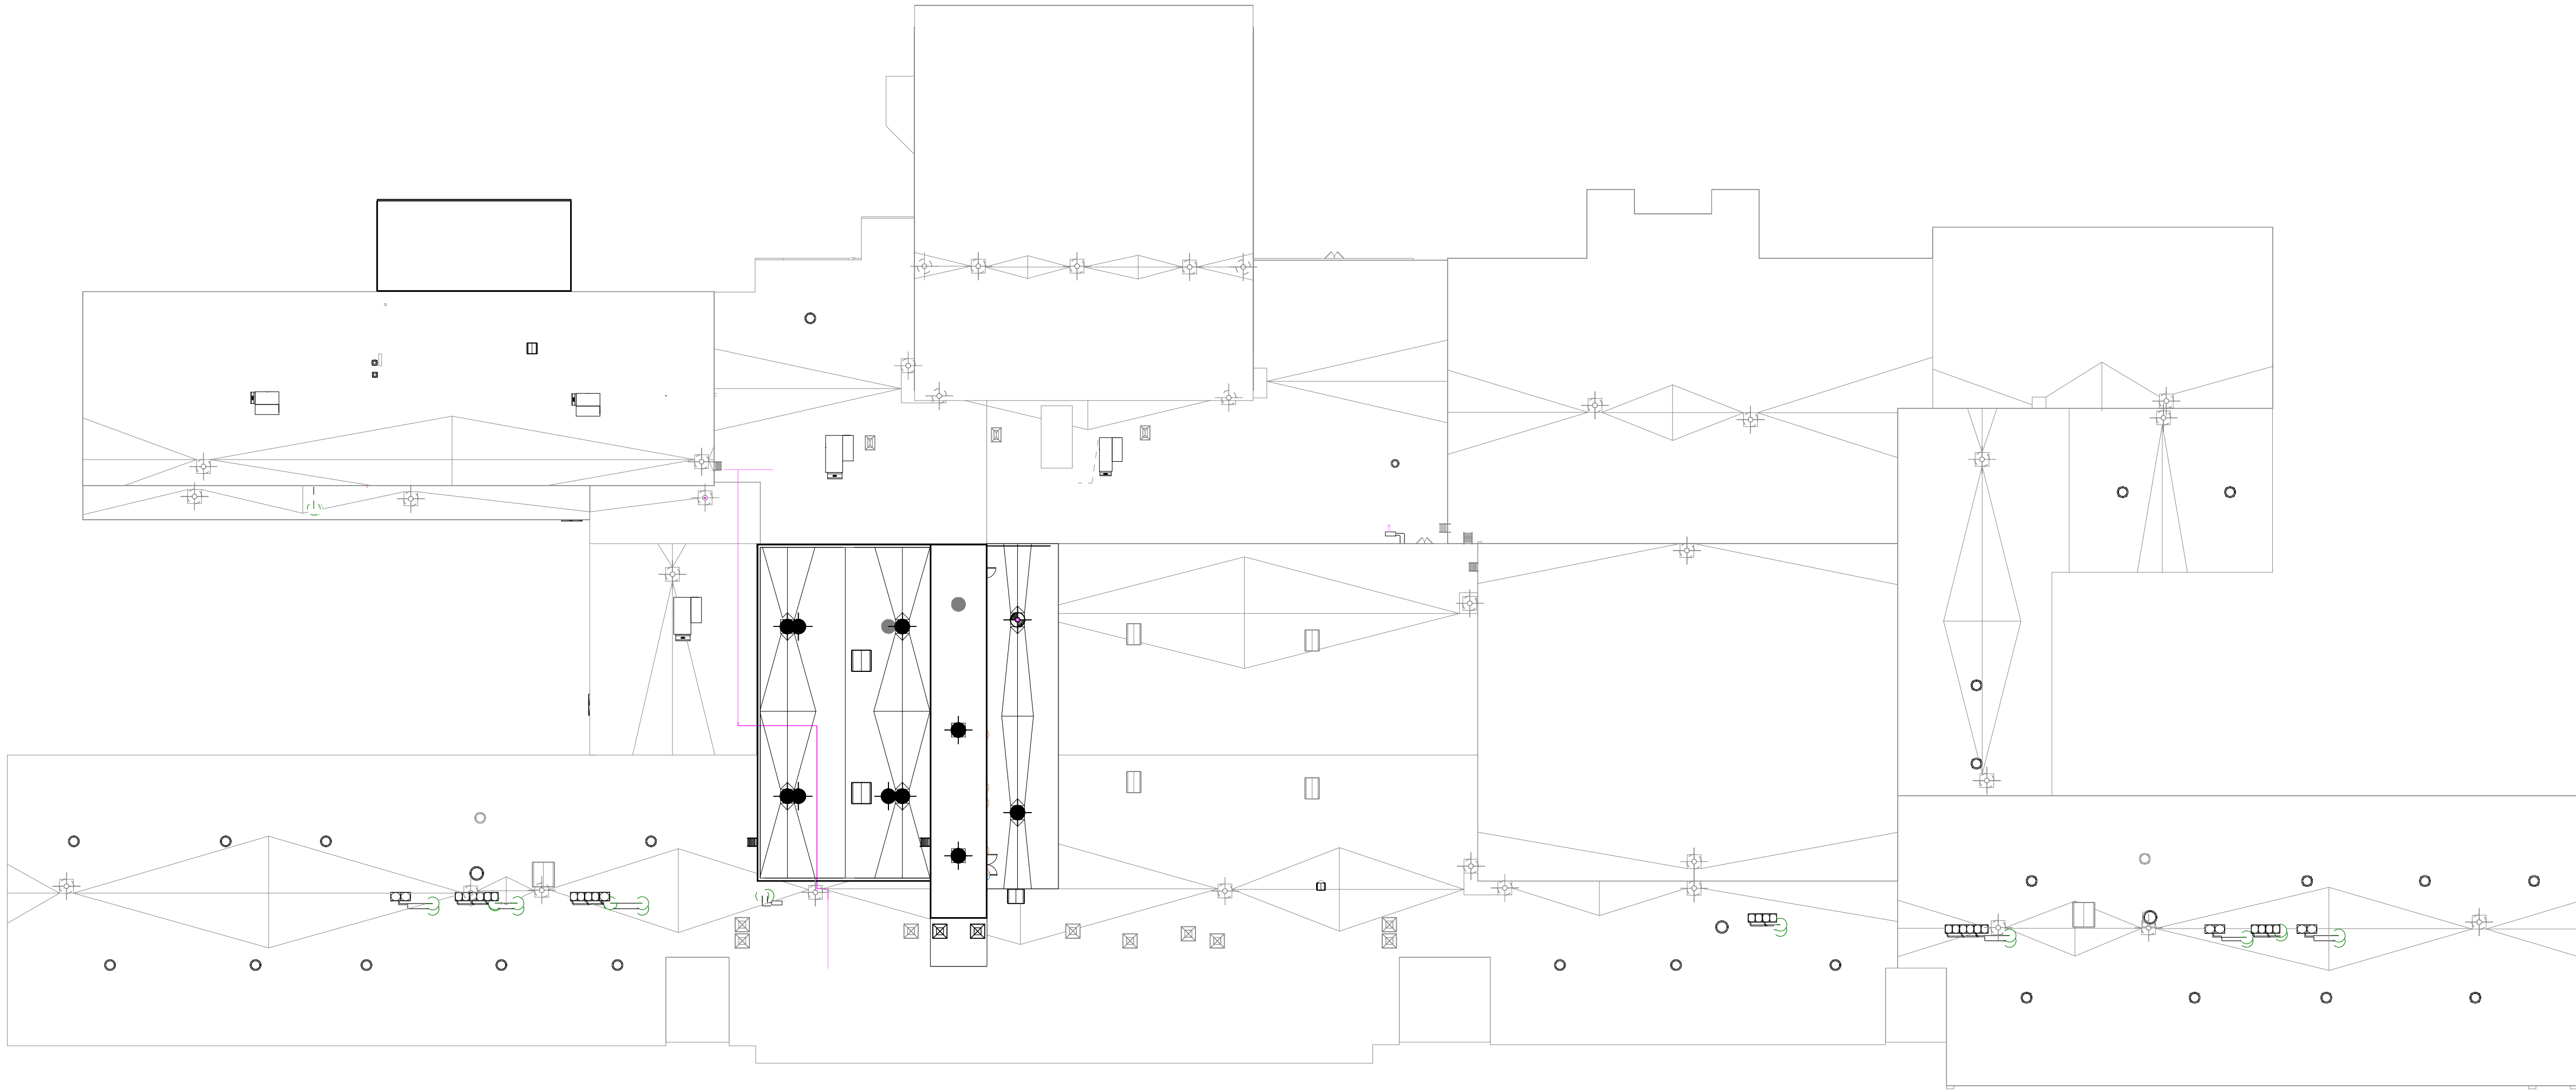

1 Roof Key Plan
1" = 30'-0"

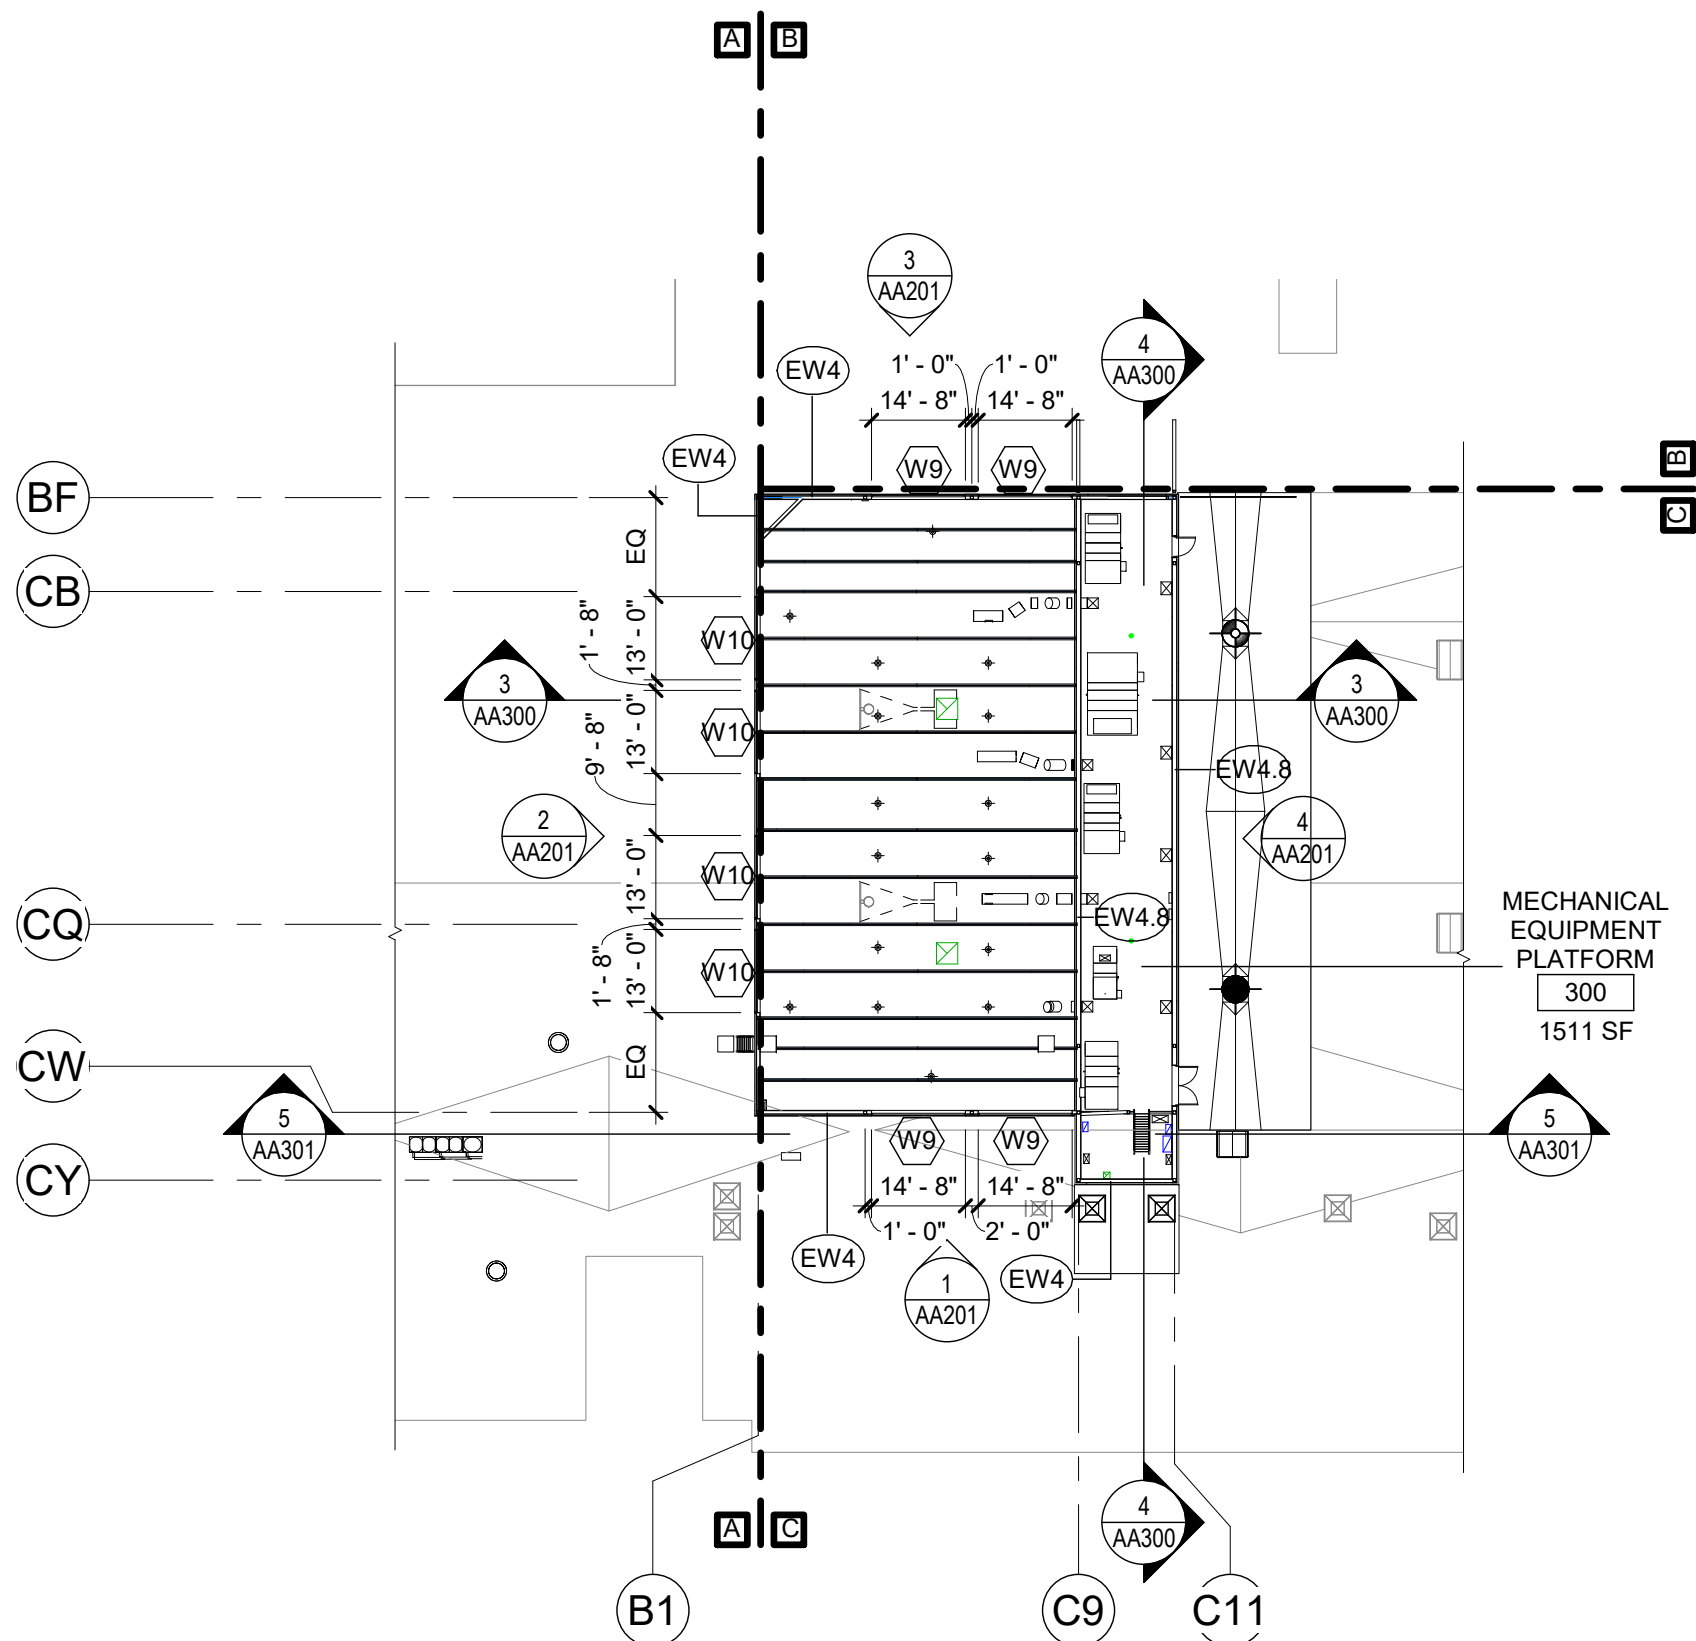

2 Mechanical Equipment Platform Key Plan
1" = 30'-0"


General Notes

- A. DO NOT SCALE DRAWINGS TO OBTAIN DIMENSIONS.
- B. TAKE FIELD MEASUREMENTS TO FIT THE WORK PROPERLY. VERIFY ALL EXISTING CONDITIONS AND DIMENSIONS IN THE FIELD.
- C. REFER INCONSISTENCIES TO ARCHITECT PRIOR TO COMMENCING THE WORK IN AFFECTED AREA.
- D. ITEMS ARE SHOWN DIAGRAMMATICALLY ON DRAWINGS. VERIFY SPACE REQUIREMENTS AND DIMENSIONS TO FIT THE WORK PROPERLY.
- E. NOTES SHOWN ON ONE DRAWING APPLY TO ALL SIMILAR DRAWINGS.
- F. DO NOT DISTURB CONSTRUCTION SUSPECTED OF CONTAINING HAZARDOUS MATERIAL. IF ENCOUNTERED, IMMEDIATELY NOTIFY ARCHITECT, CONSTRUCTION MANAGER AND OWNER.
- G. WHERE EXISTING CONSTRUCTION IS DAMAGED OR DISTURBED, PATCH AS REQUIRED TO RESTORE SURFACES TO THEIR ORIGINAL CONDITION.
- H. ALL ARTWORK NOT PERMANENTLY AFFIXED TO EXISTING CONSTRUCTION SHALL BE REMOVED AND STORED BY OWNER PRIOR TO BEGINNING DEMOLITION WORK. CONTACT OWNER'S AGENT(S) IF ANY ARTWORK IS ENCOUNTERED PRIOR TO START OF DEMOLITION WORK.
- I. REMOVE ALL EXISTING WALL MOUNTED ITEMS AS REQUIRED TO PERFORM WORK. SALVAGE, PROTECT AND STORE REMOVED ITEMS FOR REINSTALLATION IN SAME LOCATION. NOT ALL ITEMS HAVE BEEN IDENTIFIED ON ELEVATIONS INCLUDING, BUT NOT LIMITED TO, RECEPTACLES, DOOR HOLDERS, FIRE ALARM PULL STATIONS AND WIRE MOLDING.

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- 2. PERFORM WORK SUCH THAT NO PAINTED CMU WALL SURFACES ARE DISTURBED. DISTURBANCE INCLUDES, BUT IS NOT LIMITED TO DETACHMENT OF EXISTING ITEMS FROM THE WALL, ATTACHMENT OF NEW ITEMS TO THE WALL.
- 3. ADDITIONAL ASBESTOS CONTAINING ITEMS ARE PRESENT AND INDICATED ELSEWHERE WITHIN THE FACILITIES. REFER TO ON-SITE ASBESTOS DOCUMENTATION FOR FURTHER INFORMATION.
- 4. SHOULD ANY PAINTED CMU WALL SURFACE BE REQUIRE TO BE IMPACTED OR DISTURBED, CONSULT THE OWNER'S ENVIRONMENTAL CONSULTANT.

RW RESCUE WINDOW

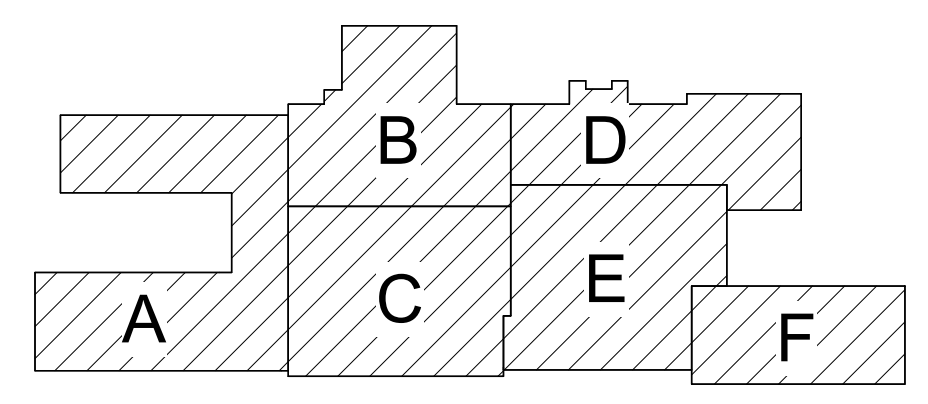

Key Plan
N.T.S.

SED Control No. 60-01-01-06-0-018-023

Rev. No.	Date	Description



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Waverly Central School District
Waverly, NY

Additions and Alterations to:
Waverly Jr. Sr. High School

Roof and Mechanical Room Key Plans

Drawn By: KCB	Date: 05/19/2023	Drawing Number: AA051
Project No.: 339070-22003		



1 First Floor Demolition Plan Area A
1/8" = 1'-0"


- 8D REMOVE EXISTING DOOR HARDWARE AND PREPARE DOOR FOR NEW HARDWARE.
- 8F CUT OPENING IN EXISTING CURTAIN WALL PANEL TO CREATE OPENING FOR NEW GLAZED PANEL. SEE EXTERIOR ELEVATIONS.
- 9A REMOVE CEILING SYSTEM AND/OR SOFFIT SYSTEM IN ITS ENTIRETY.
- 9B REMOVE PORTION OF CEILING SYSTEM AND/OR SOFFIT SYSTEM, TO EXTENT REQUIRED TO PERFORM NEW WORK. CAREFULLY TRIM CEILING GRID TO REMAIN.
- 9D REMOVE FLOOR FINISH, MASTIC, SETTING MATERIALS OR MORTAR BAD AND WALL BASE TO EXTENT REQUIRED TO PERFORM SCHEDULED WORK. AT AREAS OF FLOOR REMOVAL, LEVEL SLAB WITH ADJACENT SLABS AT LOCATIONS SCHEDULED TO RECEIVE FLOOR FINISH. INCLUDE CONCRETE FLOOR PATCHING AND LEVELING MATERIALS MAKE SURFACE LEVEL. PREPARE FOR FINISH PATCH AREAS OF WALLS TO REMAIN THAT WERE DAMAGED BY REMOVAL OF WALL BASE.
- SUFFIX KEY (FLOOR FINISH IDENTIFICATIONS):
A. CARPET
B. CERAMIC FLOOR TILE
C. CONCRETE (NATURAL OR SEALED OR STAINED OR PAINTED)
D. LINOLEUM, SHEET OR TILE
E. PORCELAIN TILE
F. POURED EPOXY
G. RUBBER FLOORING
H. TERRAZZO
I. VAT/VCT
J. VINYL SHEET
K. WOOD FLOORING
- 9E REMOVE WALL BASE AND ASSOCIATED MASTIC ONLY - EXISTING FLOOR FINISH TO REMAIN. PATCH AREAS OF WALLS TO REMAIN THAT WERE DAMAGED BY REMOVAL OF WALL BASE.
- 9F REMOVE MIRRORS. PATCH EXPOSED SURFACES TO MATCH ADJACENT FINISHES / SURFACES. PROTECT AND STORE FOR REINSTALLATION IN NEW WEIGHT ROOM.
- 9H REMOVE WALL FINISH APPLIED TO CMU WALL DOWN TO CMU WALL SURFACE. PATCH EXPOSED SURFACES TO MATCH ADJACENT FINISHES / SURFACES.
- 10A REMOVE TEACHING SURFACES INCLUDING MARKER BOARDS, TACK BOARDS AND CHALK BOARDS. PATCH EXPOSED SURFACES TO MATCH ADJACENT FINISHES / SURFACES. PROTECT AND DELIVER TO OWNER'S STORAGE LOCATION FOR THEIR RE-USE.
- 10B REMOVE TOILET COMPARTMENTS AND TOILET AND BATH ACCESSORIES IN THEIR ENTIRETY. PATCH EXPOSED SURFACES TO MATCH ADJACENT FINISHES / SURFACES TO EXTENT REQUIRED TO PERFORM SCHEDULED WORK.
- 10D REMOVE LOCKERS AND LOCKER BASE COMPLETELY. PATCH EXPOSED SURFACES TO MATCH ADJACENT FINISHES / SURFACES TO EXTENT REQUIRED TO PERFORM SCHEDULED WORK.
- 10F REMOVE BENCHES (INCLUDING ALL ASSOCIATED COMPONENTS). PATCH EXPOSED SURFACES TO MATCH ADJACENT FINISHES / SURFACES TO EXTENT REQUIRED TO PERFORM SCHEDULED WORK.
- 10H REMOVE SIGNAGE.
- 10J REMOVE OPERABLE PARTITION SYSTEM AND ASSOCIATED SOFFIT CONSTRUCTION IN ITS ENTIRETY.
- 11B REMOVE BASKETBALL BACKSTOPS IN THEIR ENTIRETY.
- 11C REMOVE SCOREBOARDS IN THEIR ENTIRETY INCLUDING WIRING AND CONTROLS.
- 11D REMOVE BALANCE OF GYM EQUIPMENT IN ITS ENTIRETY.
- 11E REMOVE GYM WALL PADS IN THEIR ENTIRETY.
- 12A REMOVE CASEWORK, SHELVING AND EQUIPMENT IN ITS ENTIRETY. PATCH EXPOSED SURFACES TO MATCH EXISTING ADJACENT FINISHES.
- 12B REMOVE DISPLAY CASEWORK (INCLUDING ALL ASSOCIATED COMPONENTS).
- 12C DETACH EXISTING BLEACHER BANK FROM WALL. PROTECT FOR MODIFICATION AND REINSTALLATION.
- 12D CAREFULLY DETACH AND MOVE EXISTING CASEWORK AND COUNTERTOP AWAY FROM EXTERIOR WALL. PERFORM WORK IN SUCH THAT ACM FLOOR TILE ADJACENT TO CASEWORK IS NOT DISTURBED. REMOVE CASEWORK UNIT SHOWN DASHED. SALVAGE CASEWORK UNIT(S) NOT SHOWN DASHED FOR REINSTALLATION WITH NEW CASEWORK UNIT SIZED TO ACCOMMODATE LARGER UNIT VENTILATOR. EXISTING COUNTERTOP AND GRILLE TO BE CUT DOWN TO NEW LENGTH REQUIRED FOR LARGER UNIT VENTILATOR. COUNTERTOP TO BE SHORTENED BY CUTTING THE END AGAINST THE EXISTING WALL. REFER TO NEW WORK PLANS FOR TYPICAL LAYOUTS.
- 12F REMOVE EXISTING CASEWORK UNITS IN THEIR ENTIRETY. SALVAGE AND TURN OVER TO OWNER'S STORAGE LOCATION.
- 23 EXISTING MECHANICAL EQUIPMENT TO BE REMOVED. REFER TO MECHANICAL DRAWINGS.

General Demolition Notes

- A. - - - - - REMOVE ITEMS INDICATED BY DASHED LINE.
- B. KEYED DEMOLITION TAGS REFER TO SPECIFIC LOCATIONS AS FOLLOWS:
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- C. WHEN AN ITEM IS INDICATED TO BE DEMOLISHED REMOVE ALL ASSOCIATED COMPONENTS AS PART OF THAT WORK.
- D. ALL ARTWORK NOT PERMANENTLY AFFIXED TO EXISTING CONSTRUCTION SHALL BE REMOVED AND STORED BY OWNER PRIOR TO BEGINNING DEMOLITION WORK. CONTACT OWNER'S AGENT(S) IF ANY ARTWORK IS ENCOUNTERED PRIOR TO START OF DEMOLITION WORK.
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- F. REFER TO HAZARDOUS MATERIALS DRAWINGS FOR HAZARDOUS MATERIAL WORK. COORDINATE ALL WORK IDENTIFIED ON ALL TRADES DEMOLITION DRAWINGS WITH HAZARDOUS MATERIALS DRAWINGS PRIOR TO BEGINNING ANY DEMOLITION WORK. ALL HAZARDOUS MATERIAL WORK INDICATED ON DRAWINGS SHALL BE REMOVED AND LEGALLY DISPOSED OF AS PART OF BASE BID.
- G. PATCH ALL EXPOSED SURFACES TO REMAIN TO MATCH EXISTING AND ADJACENT SURFACES, TYPICAL.

Demolition Key Notes

- 1B REMOVE INTERIOR PARTITION FULL-HEIGHT, PORTION AS INDICATED OR AS REQUIRED TO PERFORM SCHEDULED WORK. EXISTING STRUCTURE TO REMAIN. UNO SEE STRUCT DWGS.
- 1C SAW CUT, OR ENLARGE EXISTING, OPENING IN WALL TO EXTENT REQUIRED TO PERFORM SCHEDULED WORK. PROVIDE LINTEL PER LINTEL SCHEDULE. PATCH EXPOSED SURFACES TO MATCH ADJACENT FINISHES / SURFACES.
- 1D REMOVE CONCRETE FLOOR ASSEMBLY, PORTION INDICATED OR REQUIRED TO PERFORM SCHEDULED WORK. SEE STRUCT DWGS.
- 1H REMOVE FIRE EXTINGUISHER AND BRACKET MOUNTED SYSTEM. SALVAGE AND PROTECT FOR RE-INSTALLATION.
- 1J REMOVE FIRE EXTINGUISHER AND CABINET.
- 7A REMOVE ROOFING SYSTEM DOWN TO EXG STRUCT DECK.
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- 8B REMOVE DOOR AND FRAME COMPLETELY. PATCH EXPOSED SURFACES TO MATCH ADJACENT FINISHES / SURFACES.
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Key Plan
N.T.S.

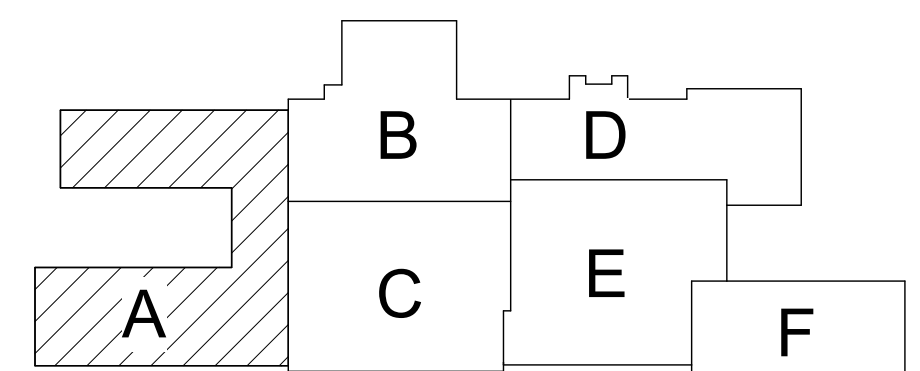SED Control No. 60-01-01-06-0-018-023

Rev. No.:	Date:	Description:



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CLEAR SOLUTIONS

Tetra Tech Engineers, Architects & Landscape Architects, P.C.




Waverly Central School District
Waverly, NY

Additions and Alterations to:
Waverly Jr. Sr. High School

First Floor Demolition Plan Area A

Drawn By: KCB	Date: 05/19/2023	Drawing Number: AA100
Project No.: 339070-22003		

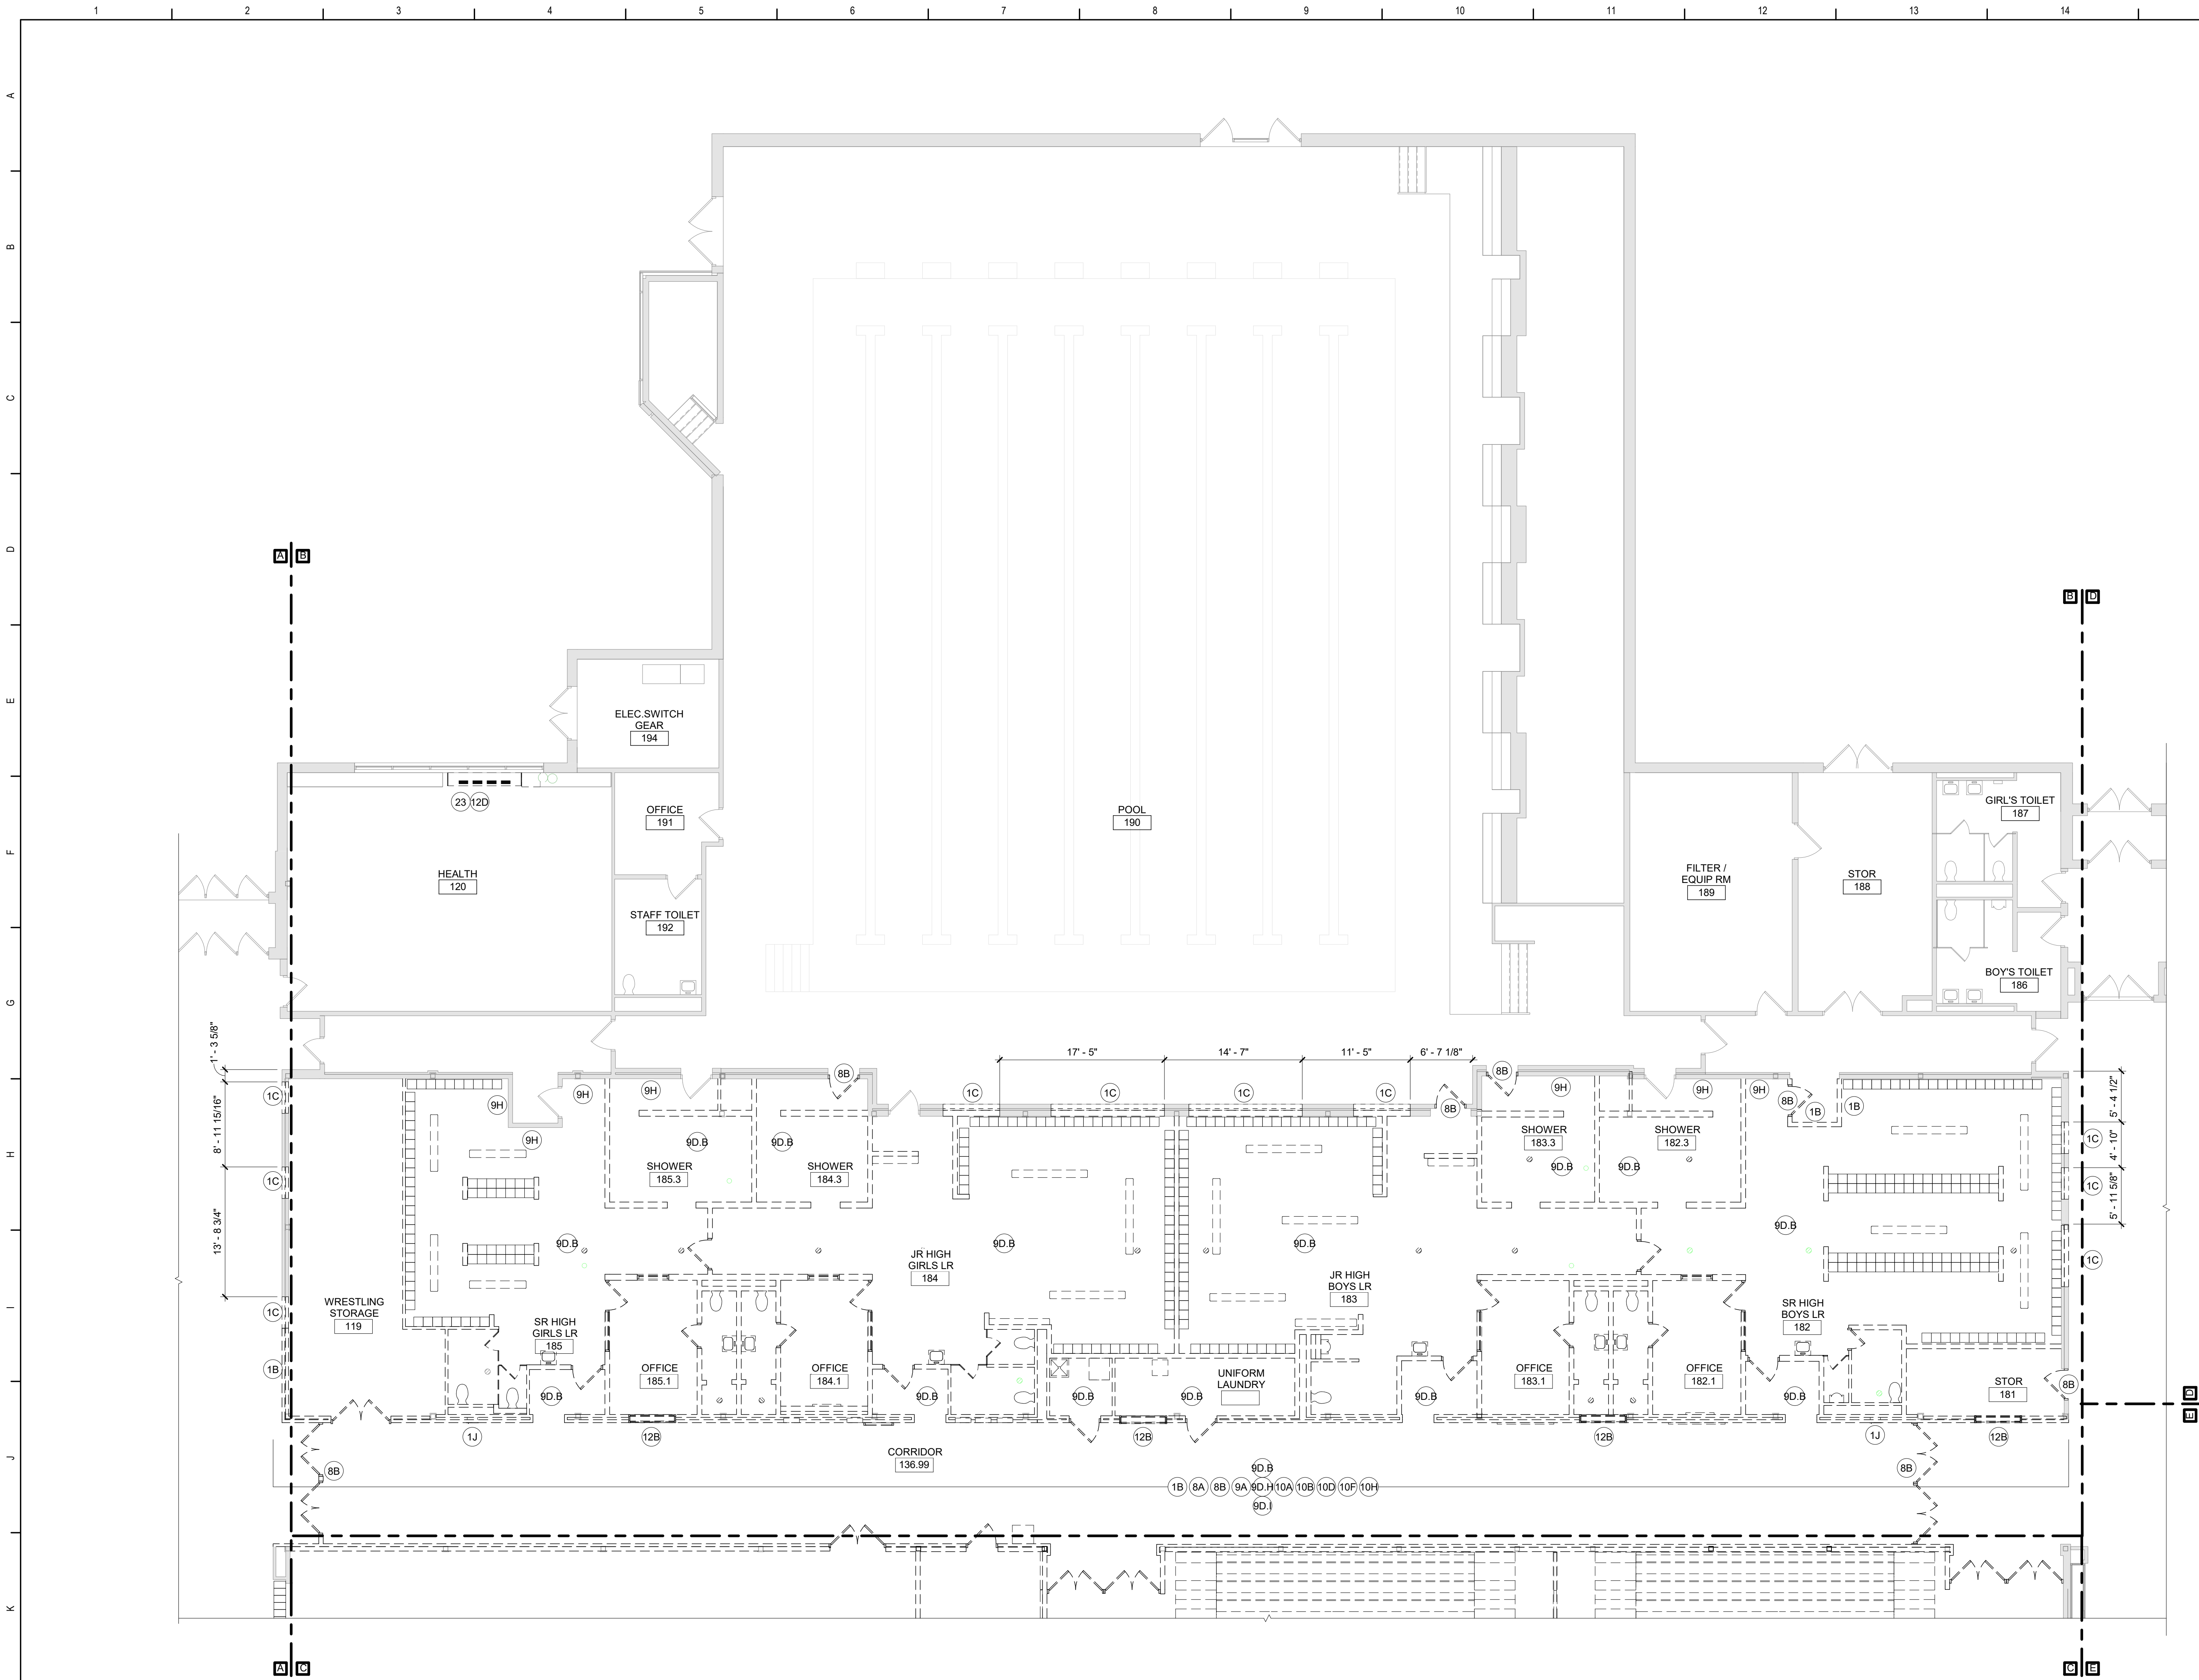

1 First Floor Demolition Plan Area B
1/8" = 1'-0"


- 8D REMOVE EXISTING DOOR HARDWARE AND PREPARE DOOR FOR NEW HARDWARE.
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- 9D REMOVE FLOOR FINISH, MASTIC, SETTING MATERIALS OR MORTAR BAD AND WALL BASE TO EXTENT REQUIRED TO PERFORM SCHEDULED WORK. AT ALL AREAS OF FLOOR REMOVAL, LEVEL SLAB WITH ADJACENT SLABS AT LOCATIONS SCHEDULED TO RECEIVE FLOOR FINISH. INCLUDE CONCRETE FLOOR PATCHING AND LEVELING MATERIALS TO MAKE SURFACE LEVEL. PREPARE FOR FINISH. PATCH AREAS OF WALLS TO REMAIN THAT WERE DAMAGED BY REMOVAL OF WALL BASE.
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General Demolition Notes

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Rev. No.: Date: Description:



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Waverly Central School District
Waverly, NY


Additions and Alterations to:
Waverly Jr. Sr. High School

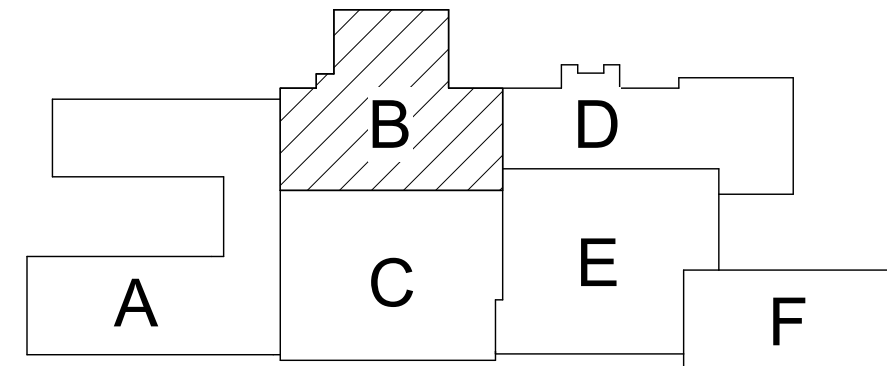First Floor Demolition Plan Area B

Drawn By: KCB
Project No.: 339070-22003

Date: 05/19/2023

Drawing Number: AA101

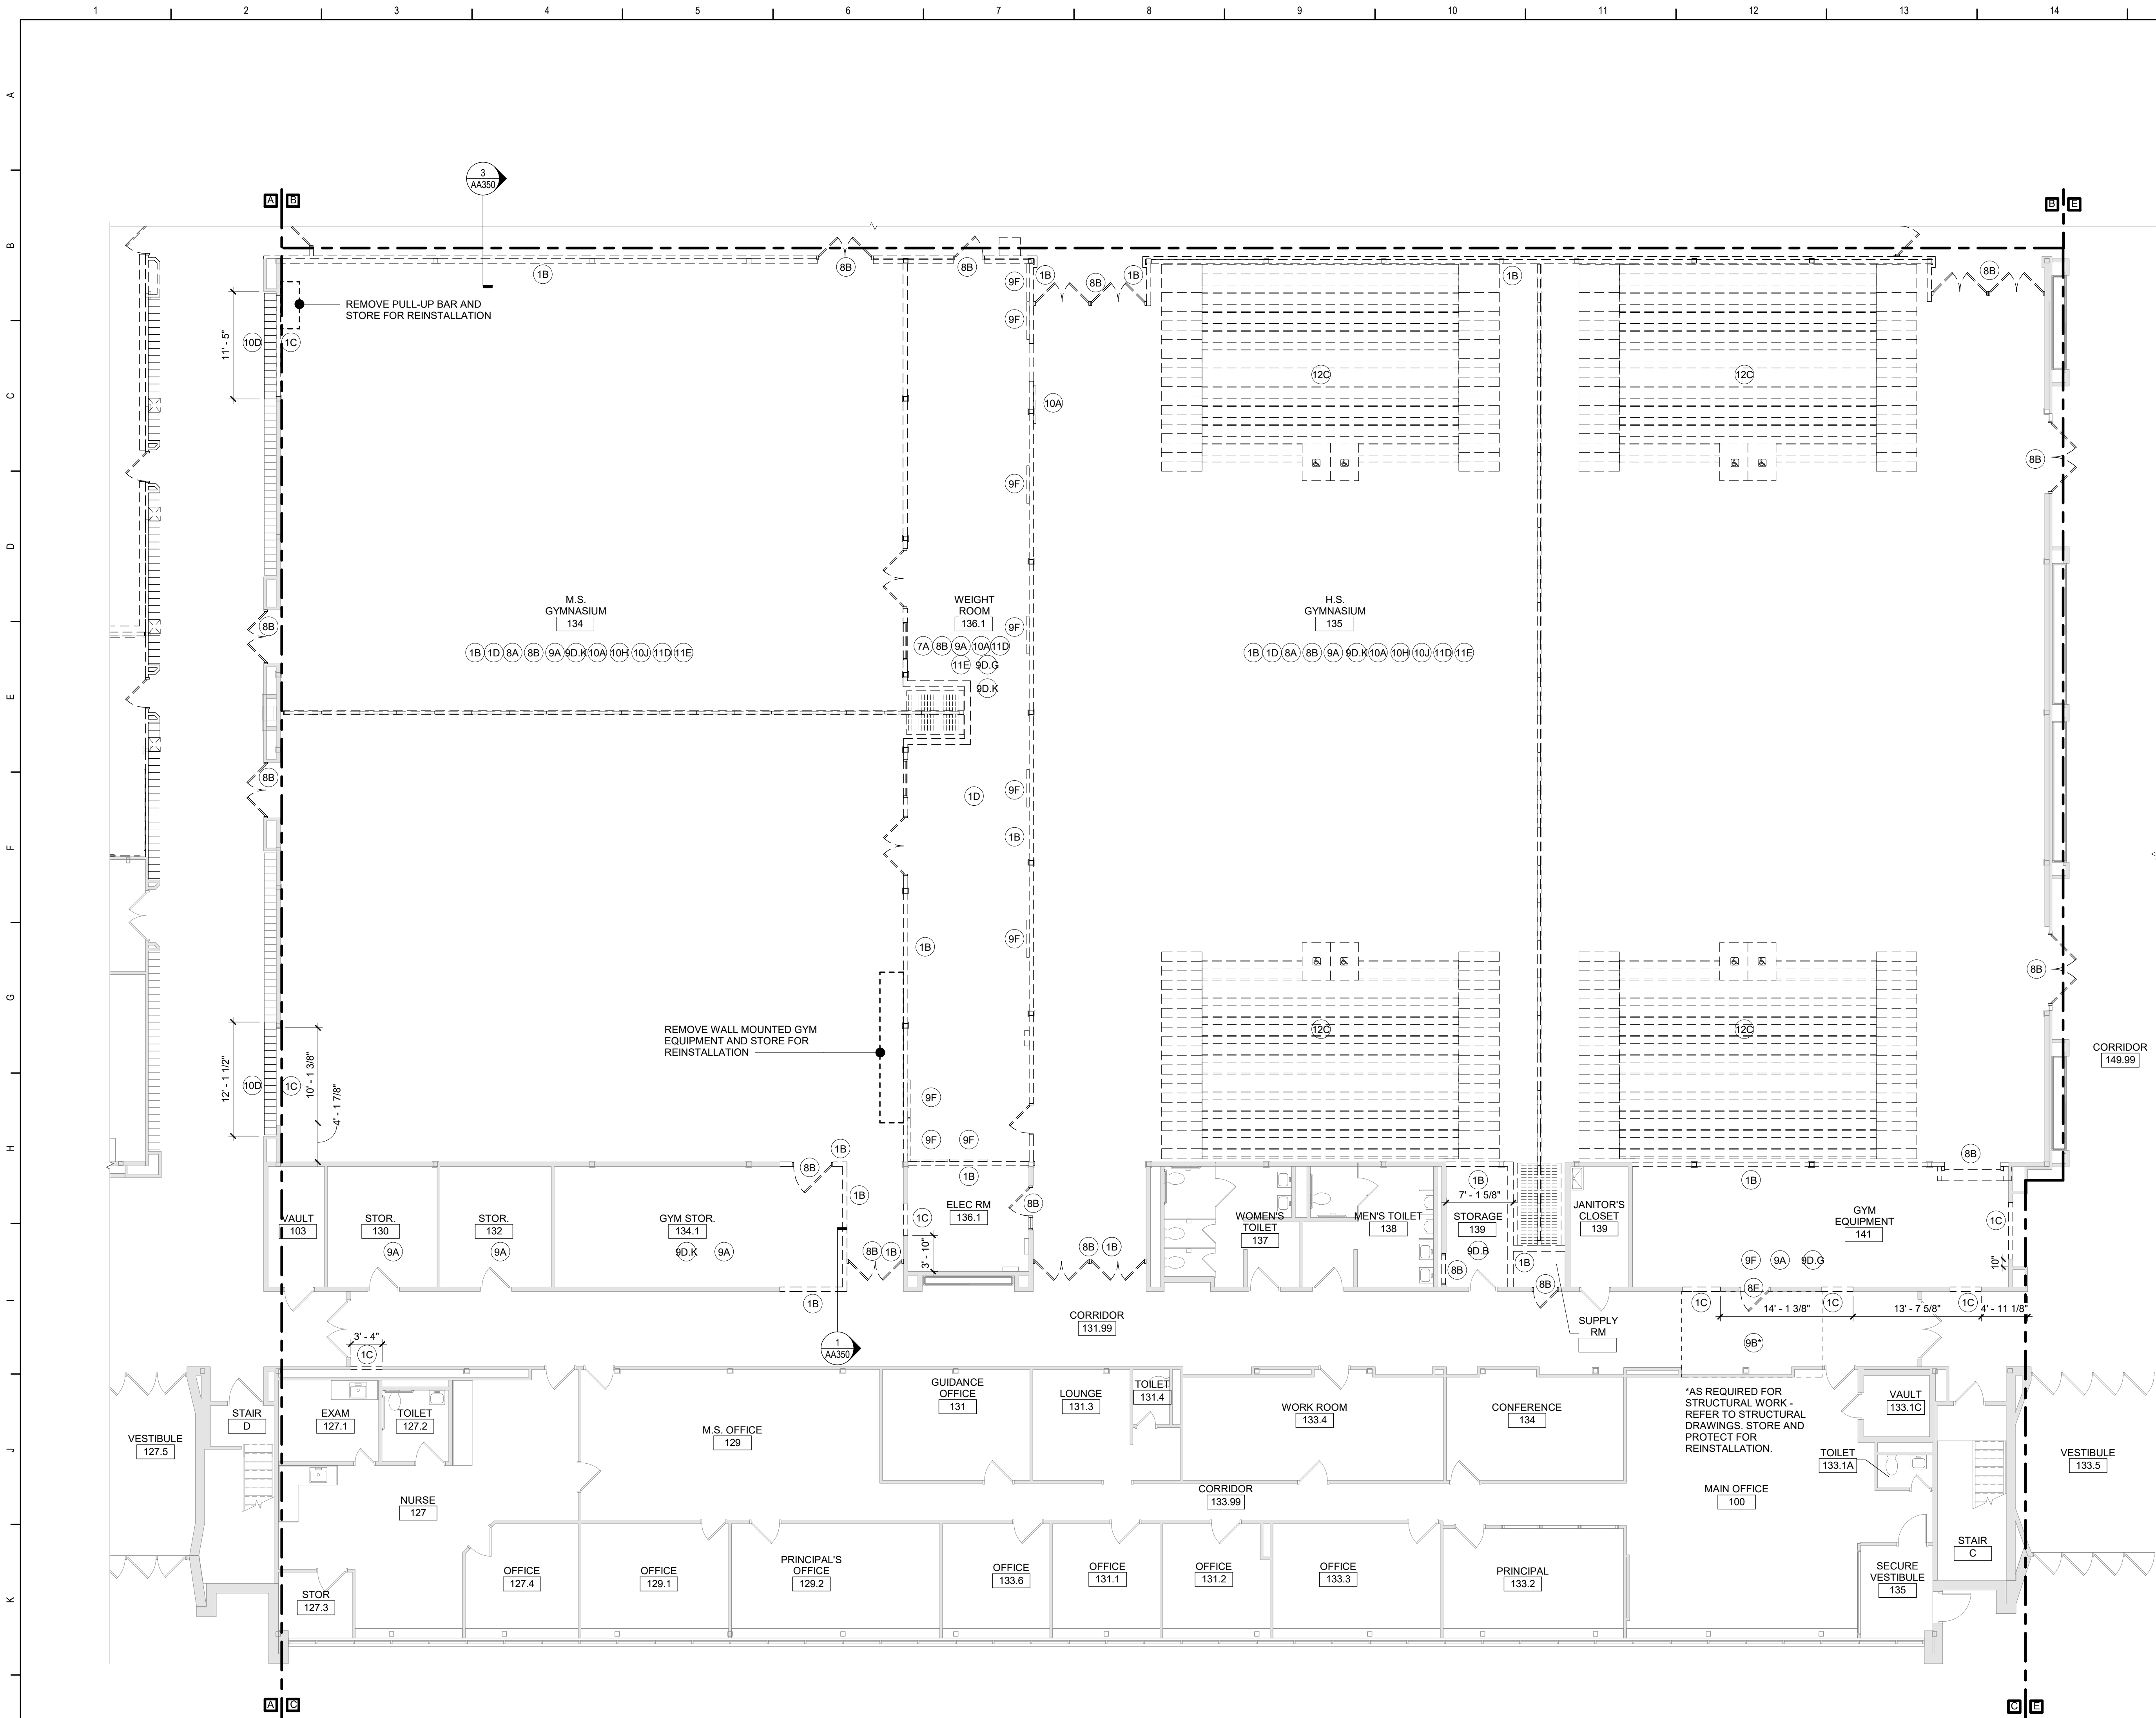

1 First Floor Demolition Plan Area C
1/8" = 1'-0"


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SED Control No. 60-01-01-06-0-018-023

Rev. No.: Date: Description:



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CLEAR SOLUTIONS

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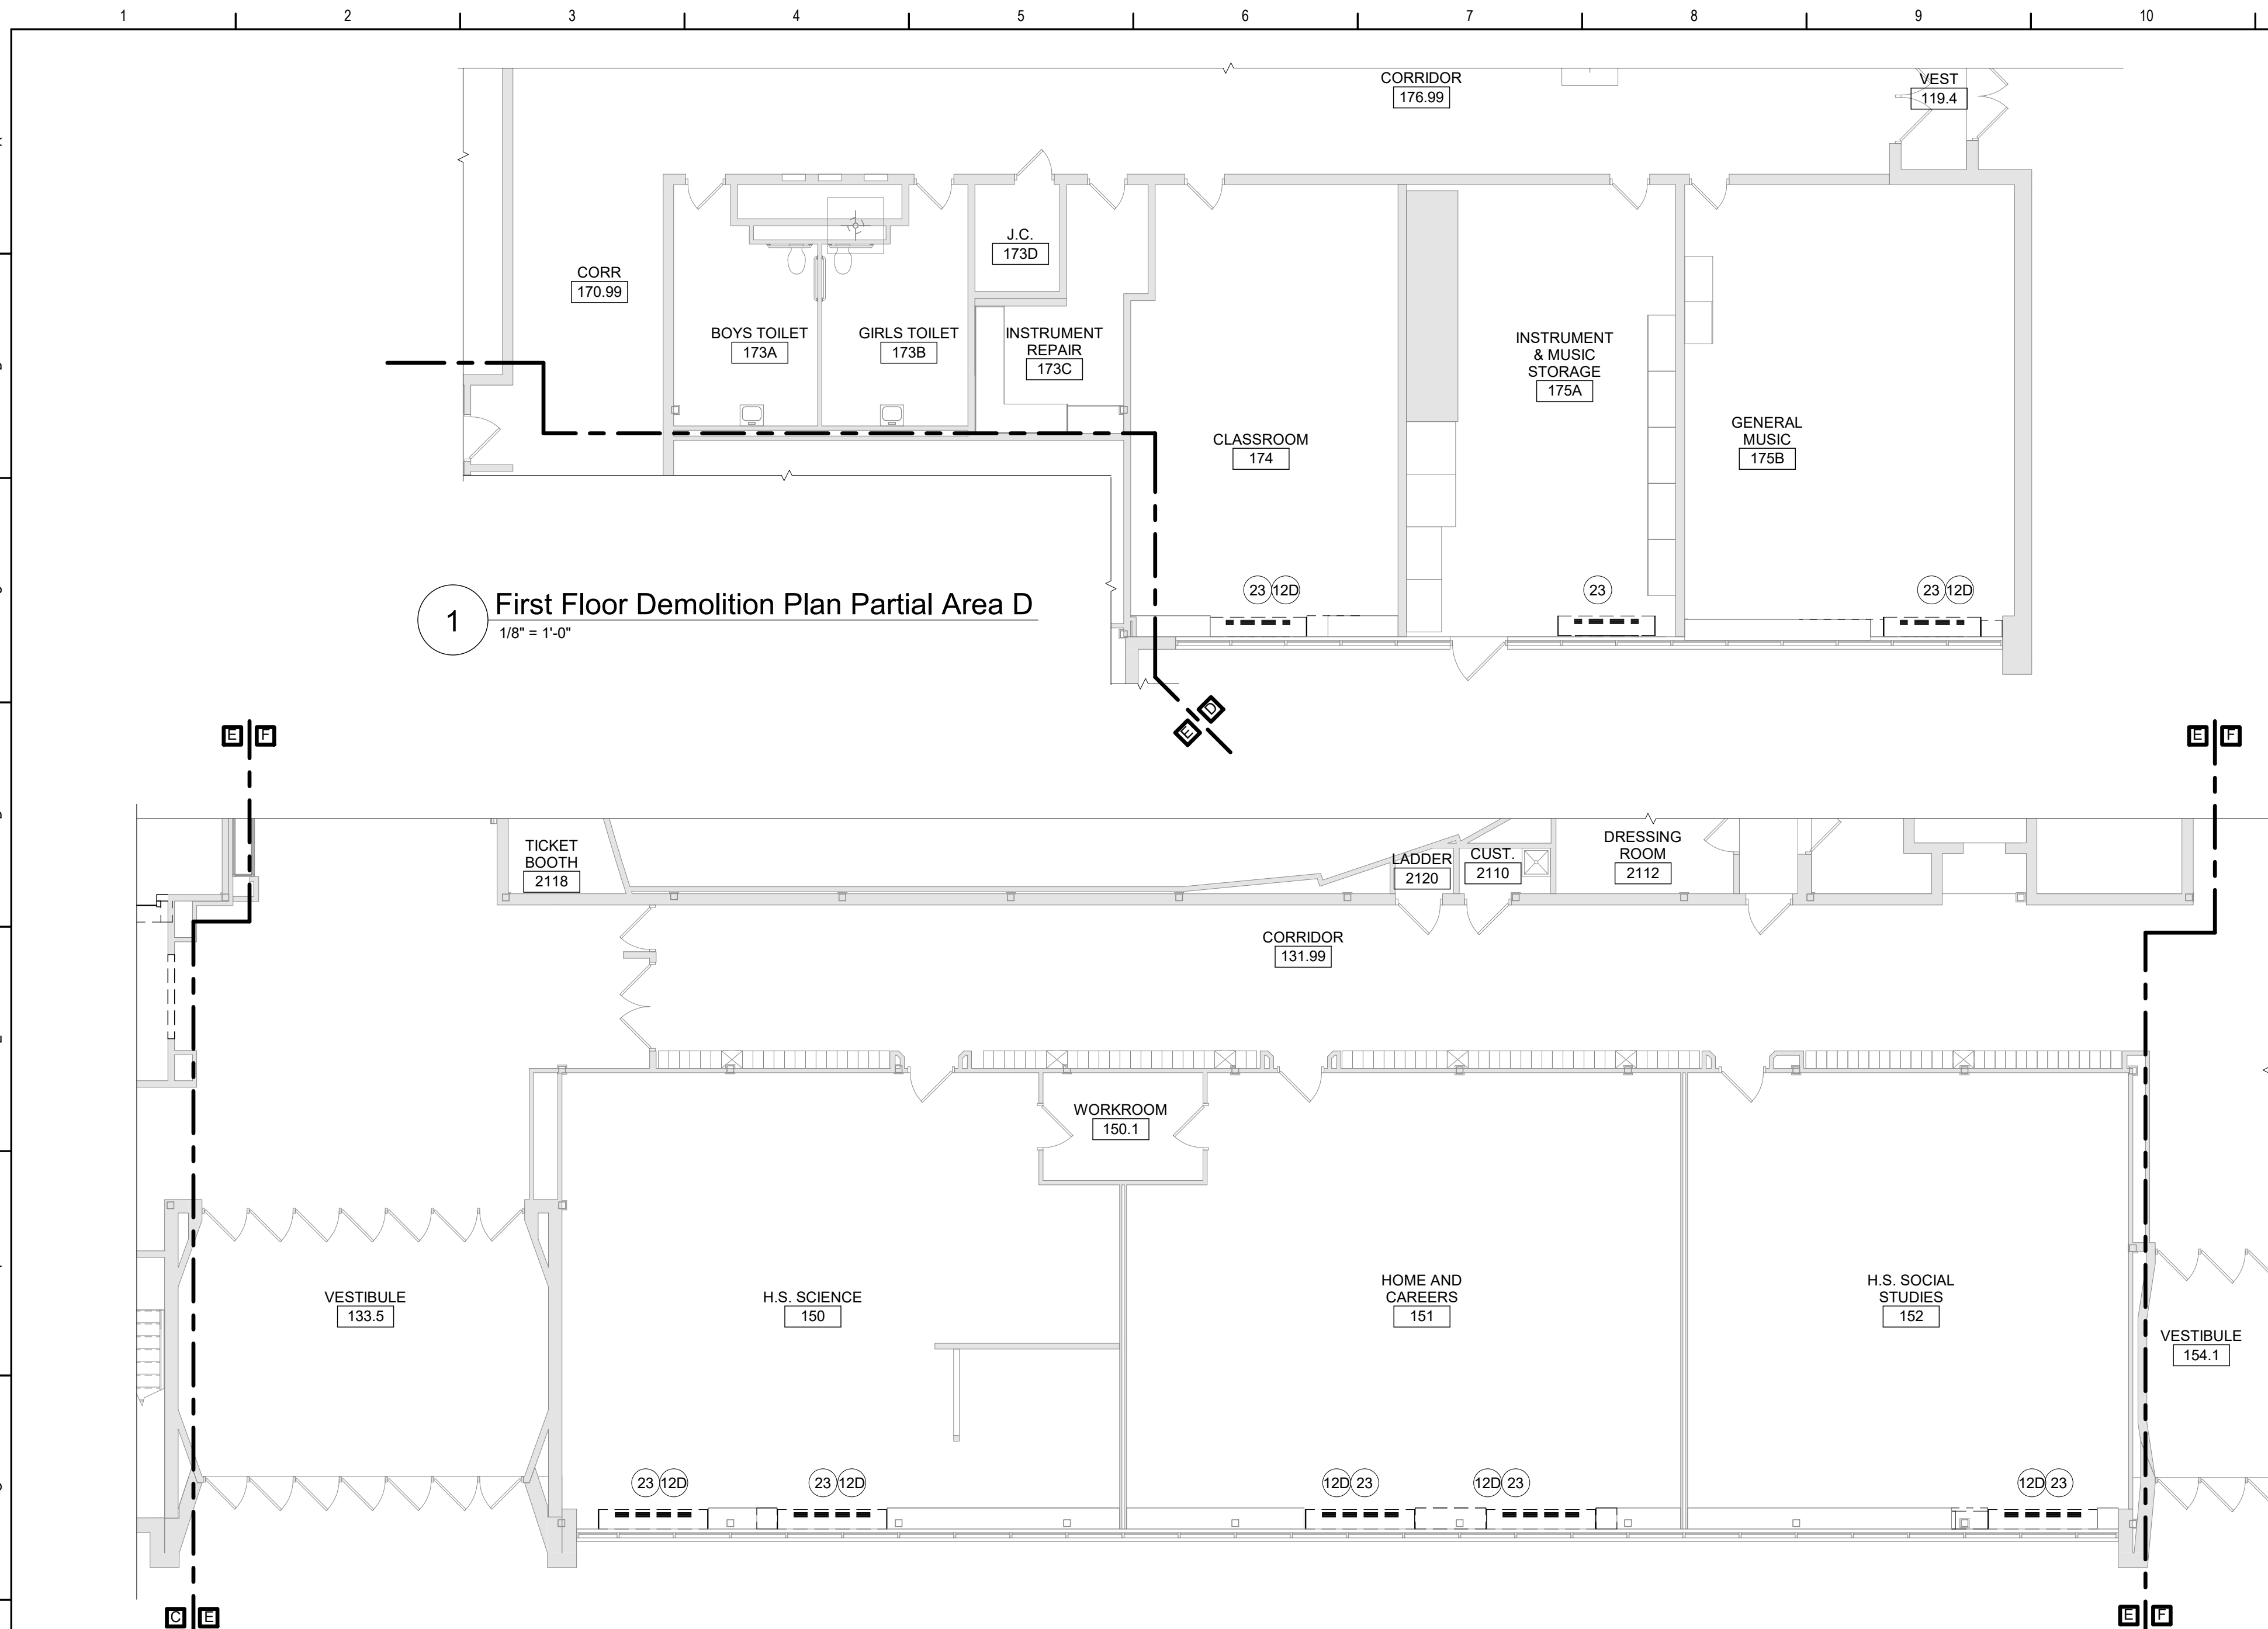


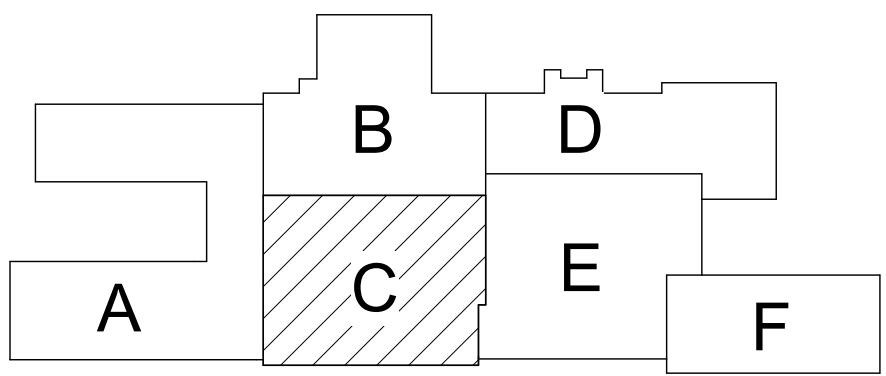Waverly Central School District
Waverly, NY


Additions and Alterations to:
Waverly Jr. Sr. High School

First Floor Demolition Plan Area C


Drawn By: KCB Date: 05/19/2023 Drawing Number: 339070-22003
Project No.: AA102



1 First Floor Demolition Plan Partial Area D
1/8" = 1'-0"

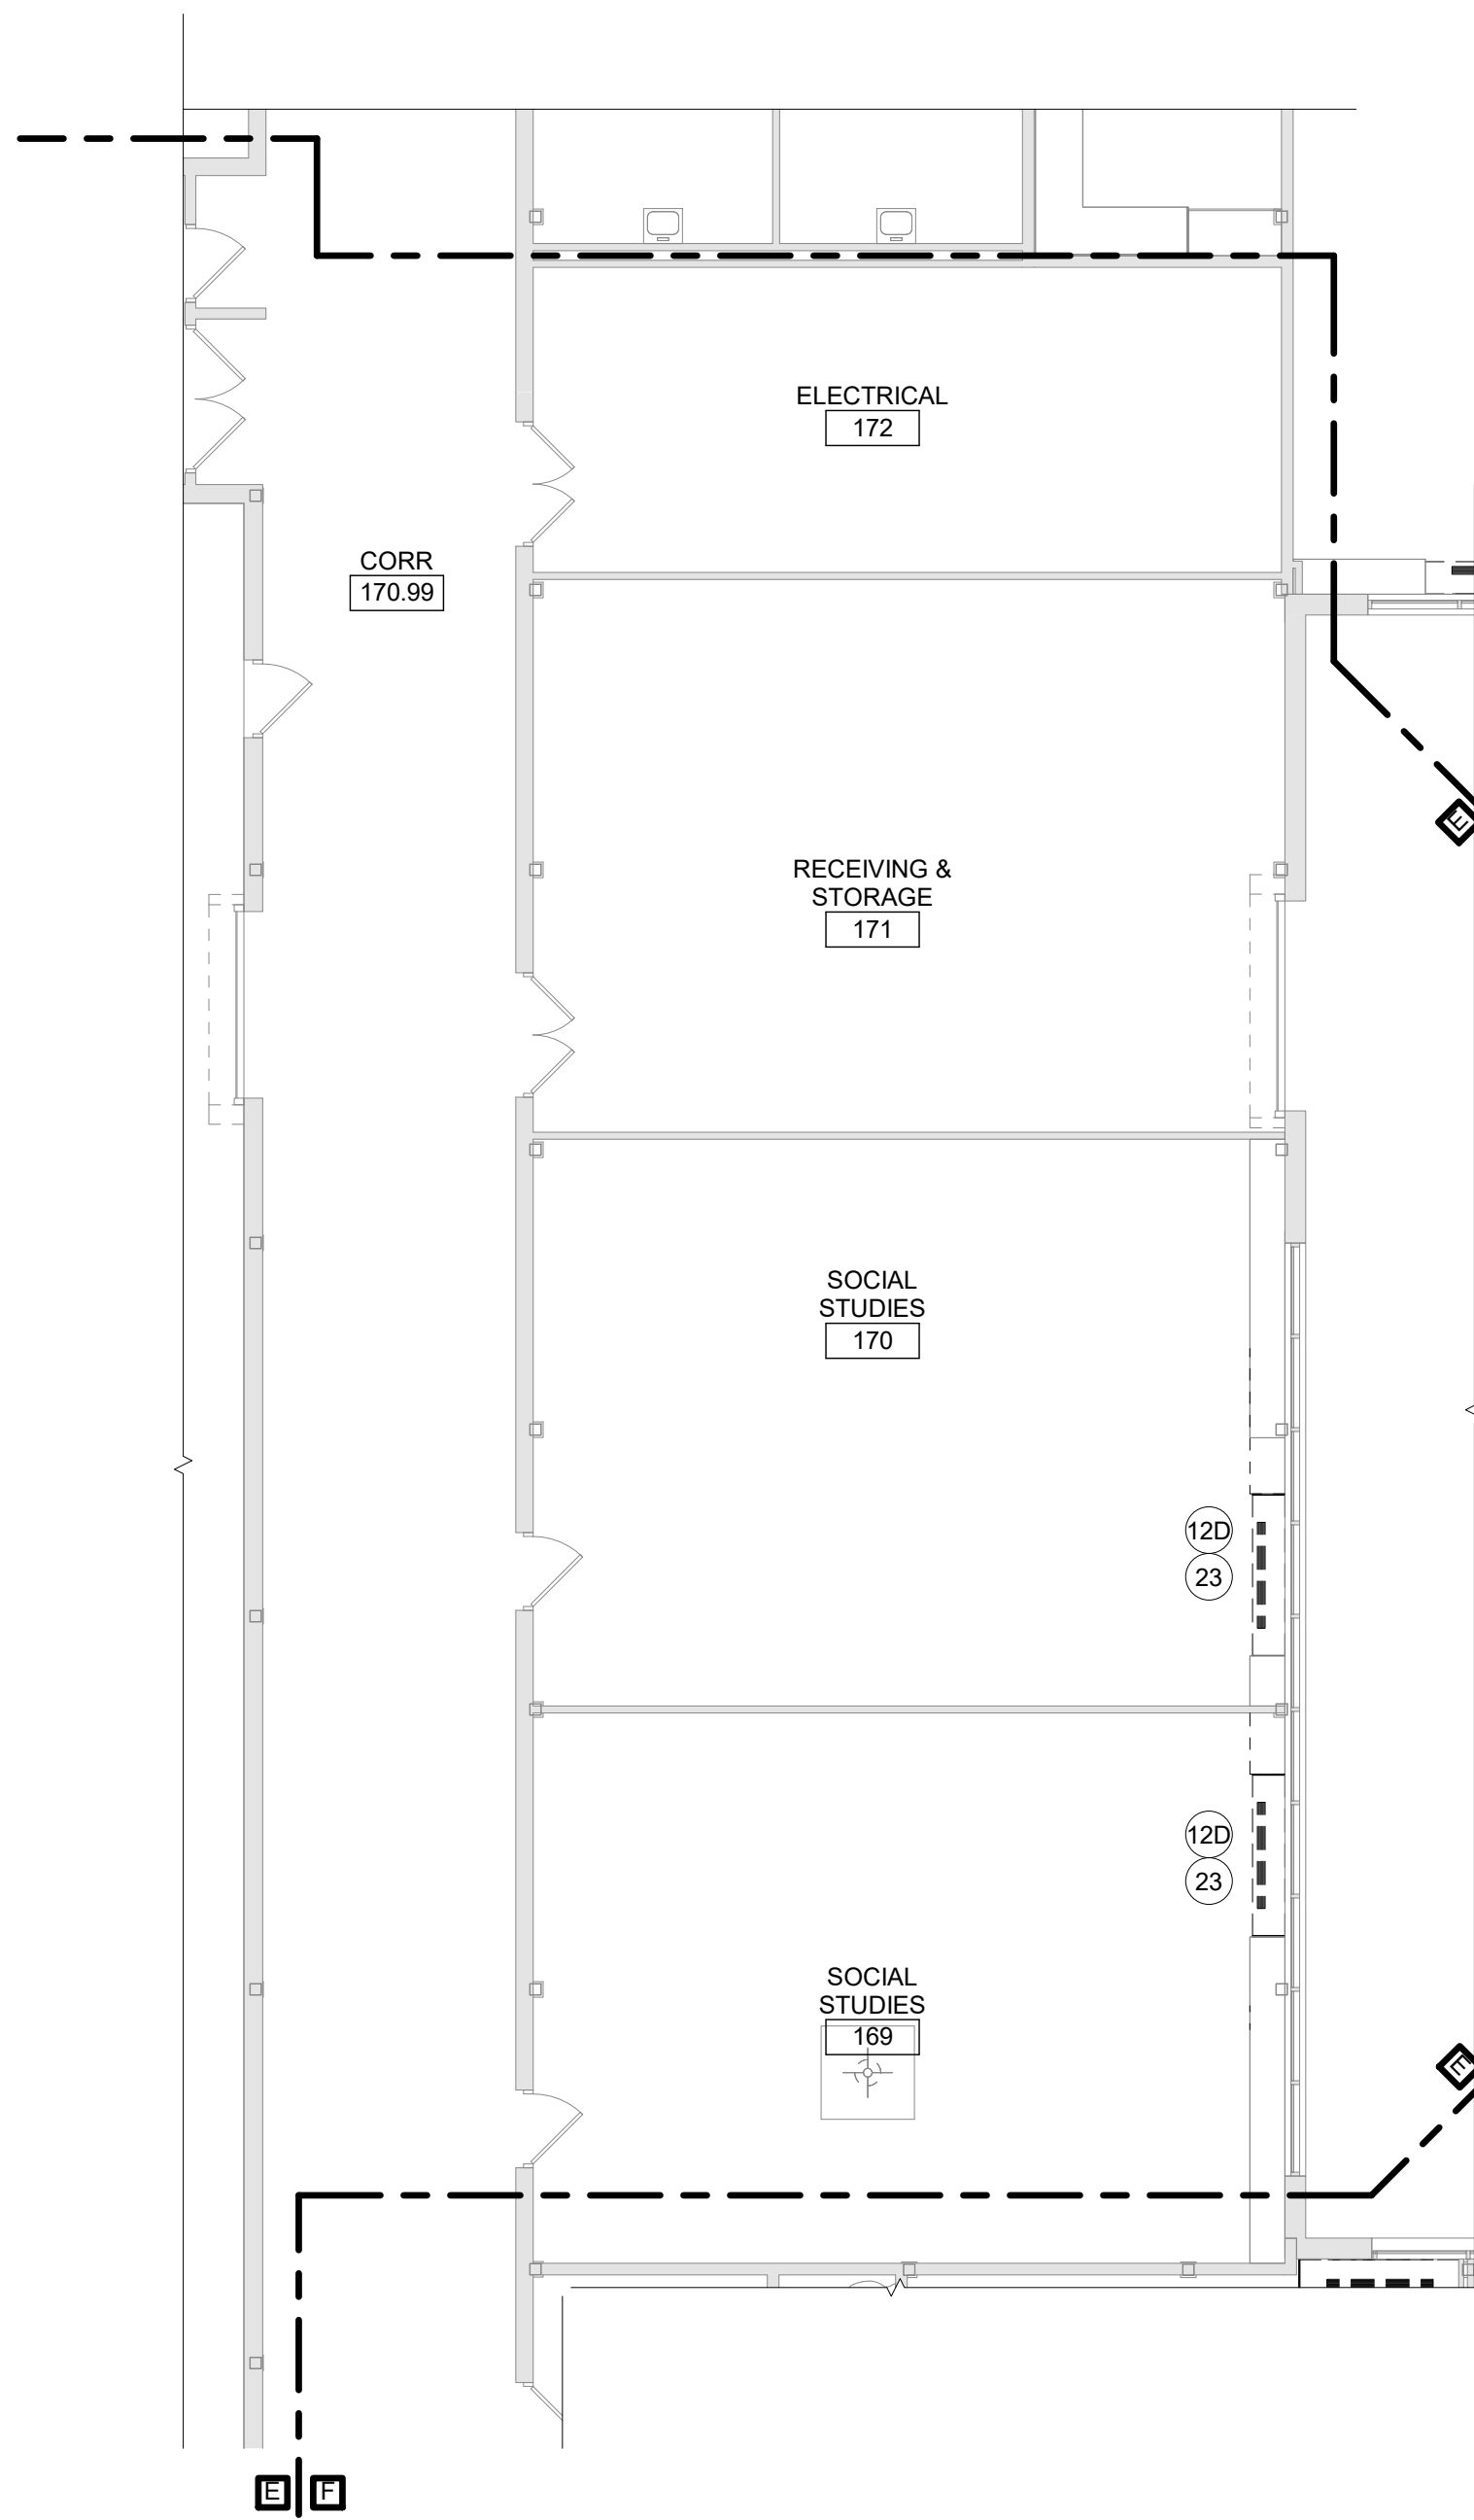

3 First Floor Demolition Plan Partial Area E
1/8" = 1'-0"

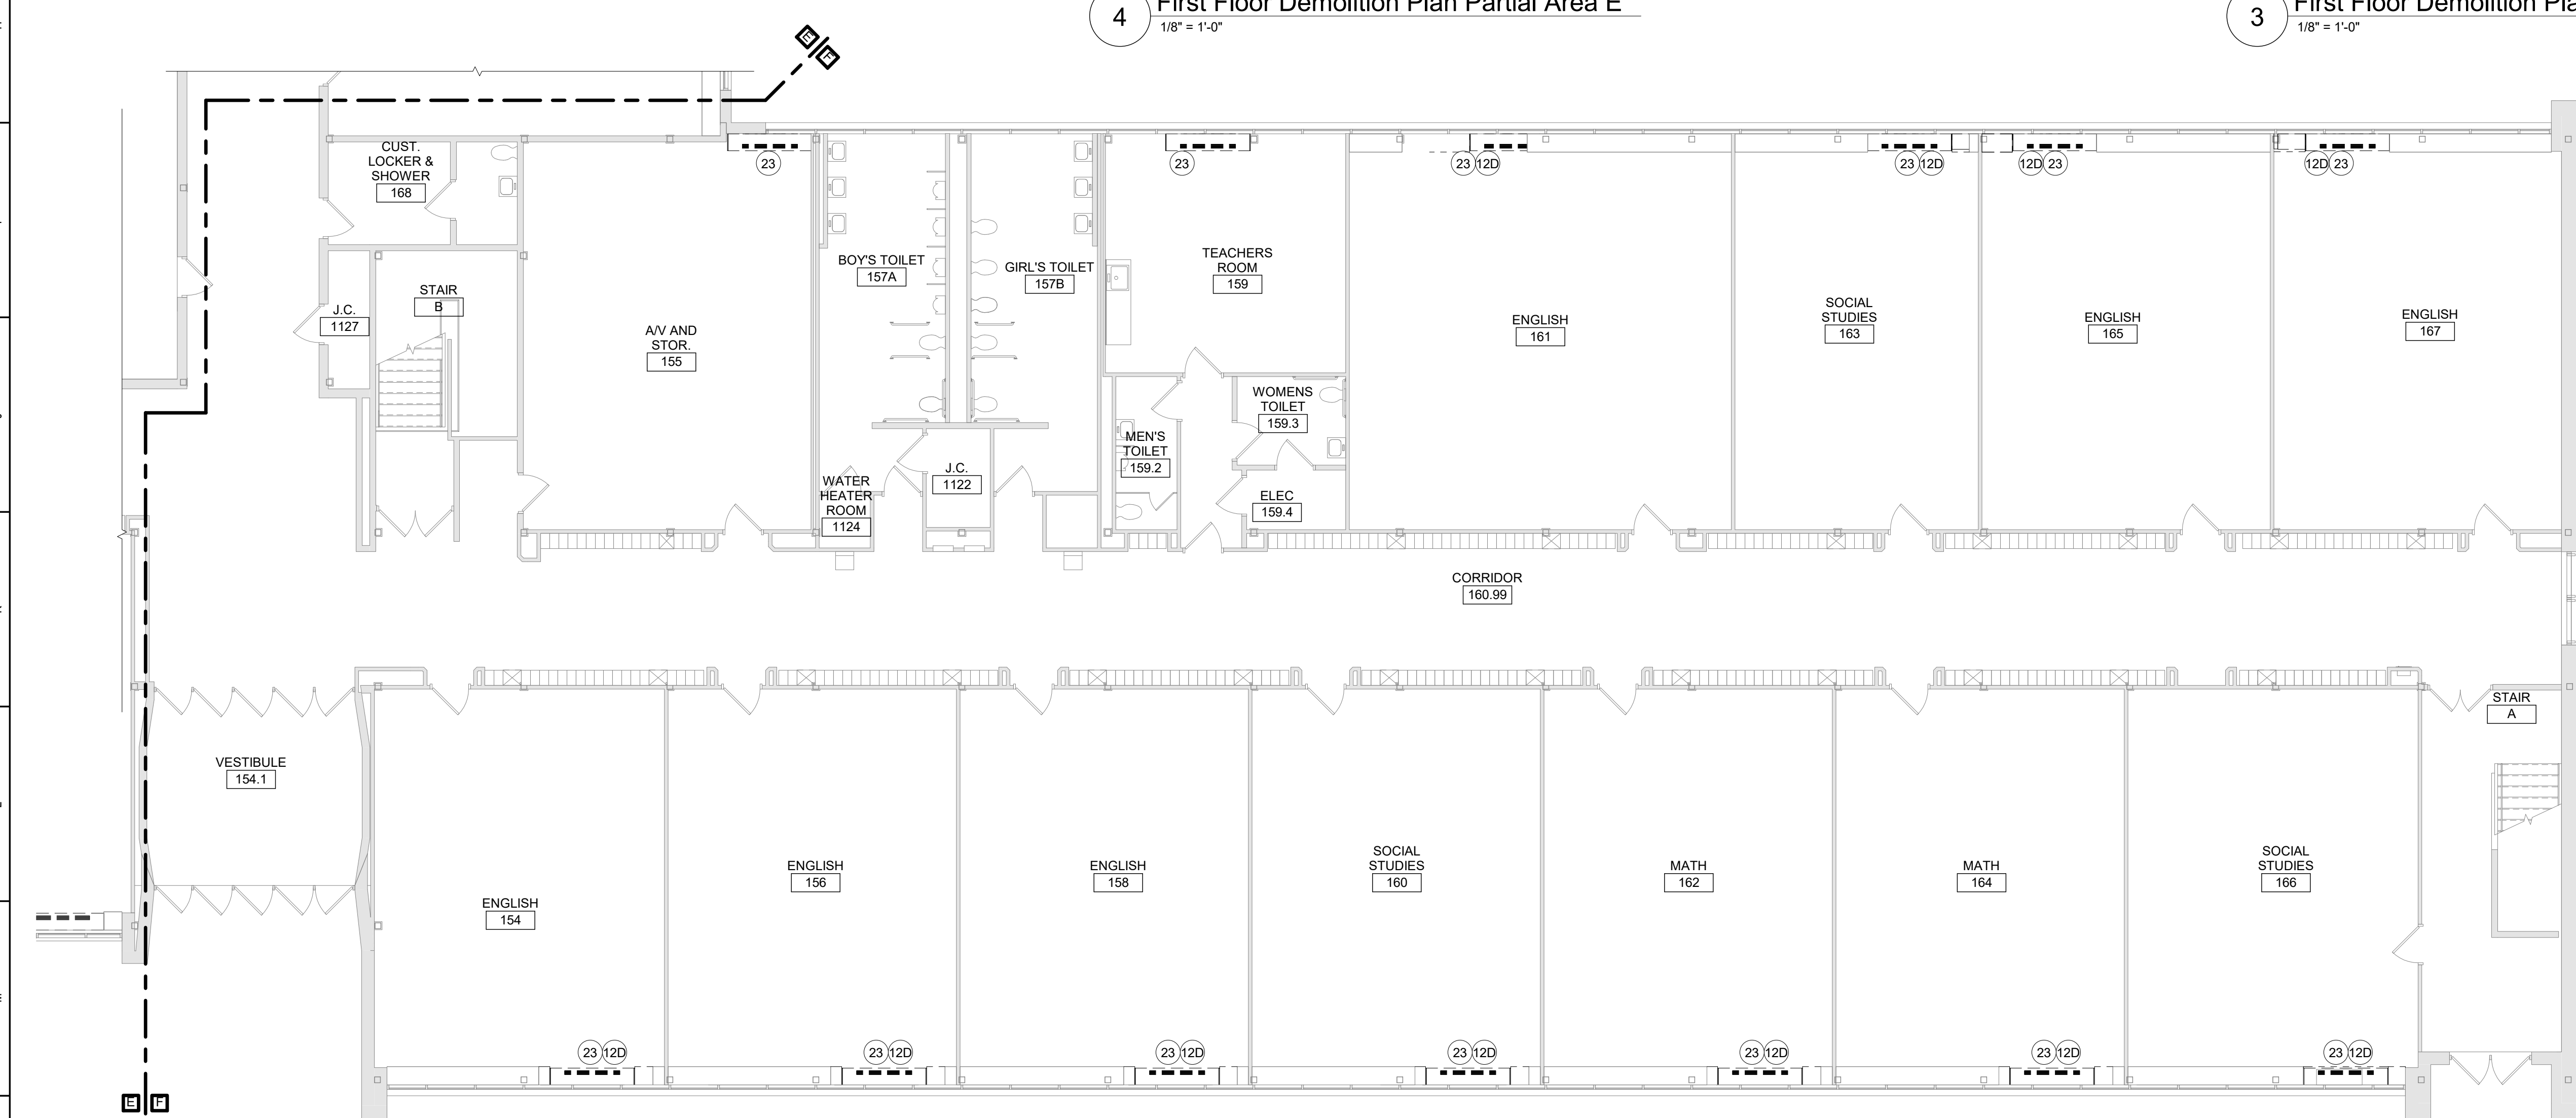

2 First Floor Demolition Plan Area F
1/8" = 1'-0"


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- (12A) REMOVE CASEWORK, SHELVING AND EQUIPMENT IN ITS ENTIRETY. PATCH EXPOSED SURFACES TO MATCH EXISTING ADJACENT FINISHES.
- (12B) REMOVE DISPLAY CASEWORK (INCLUDING ALL ASSOCIATED COMPONENTS).
- (12C) DETACH EXISTING BLEACHER BANK FROM WALL, PROTECT FOR MODIFICATION AND REINSTALLATION.
- (12D) CAREFULLY DETACH AND MOVE EXISTING CASEWORK AND COUNTERTOP AWAY FROM EXTERIOR WALL. PERFORM WORK IN SUCH THAT ACM FLOOR TILE ADJACENT TO CASEWORK IS NOT DISTURBED. REMOVE CASEWORK UNIT SHOWN DASHED. SALVAGE CASEWORK UNIT(S) NOT SHOWN DASHED FOR REINSTALLATION WITH NEW CASEWORK UNIT SIZED TO ACCOMMODATE LARGER UNIT VENTILATOR. EXISTING COUNTERTOP AND GRILLE TO BE CUT DOWN TO NEW LENGTH REQUIRED FOR LARGER UNIT VENTILATOR. COUNTERTOP TO BE SHORTENED BY CUTTING THE END AGAINST THE EXISTING WALL. REFER TO NEW WORK PLANS FOR TYPICAL LAYOUTS.
- (12F) REMOVE EXISTING CASEWORK UNITS IN THEIR ENTIRETY. SALVAGE AND TURN OVER TO OWNER'S STORAGE LOCATION.
- (23) EXISTING MECHANICAL EQUIPMENT TO BE REMOVED, REFER TO MECHANICAL DRAWINGS.

General Demolition Notes


- A. - - - - - REMOVE ITEMS INDICATED BY DASHED LINE.
- B. KEYED DEMOLITION TAGS REFER TO SPECIFIC LOCATIONS AS FOLLOWS:
- DEMOLITION TAGS LOCATED WITHIN THE MIDDLE OF A SPACE REFER TO DEMOLITION OF ALL ITEMS OF THAT SAME TYPE WITHIN THAT ENTIRE SPACE.
 - DEMOLITION TAGS PLACED IMMEDIATELY ON OR ADJACENT TO A DASHED LINE INDICATING ITEM REMOVAL OR THAT HAVE A LEADER POINTING TO SPECIFIC ITEM(S) REFER TO DEMOLITION OF THAT SPECIFIC ITEM ONLY OF THAT TYPE WITHIN THAT SPACE.
 - DEMOLITION TAGS IN SERIES REFER TO DEMOLITION OF ALL THOSE ITEMS EITHER WITHIN THAT ENTIRE SPACE OR TO THE SPACE IDENTIFIED BY THAT LEADER.
- C. WHEN AN ITEM IS INDICATED TO BE DEMOLISHED REMOVE ALL ASSOCIATED COMPONENTS AS PART OF THAT WORK.
- D. ALL ARTWORK NOT PERMANENTLY AFFIXED TO EXISTING CONSTRUCTION SHALL BE REMOVED AND STORED BY OWNER PRIOR TO BEGINNING DEMOLITION WORK. CONTACT OWNERS AGENT(S) IF ANY ARTWORK IS ENCOUNTERED PRIOR TO START OF DEMOLITION WORK.
- E. REMOVAL INDICATED ON ARCHITECTURAL DRAWINGS DOES NOT INDICATE FULL EXTENT OF PROJECT'S DEMOLITION WORK. COORDINATE WORK IDENTIFIED ON ALL TRADES' DEMOLITION DRAWINGS, PRIOR TO BEGINNING ANY DEMOLITION WORK. COORDINATE EXACT LOCATIONS AND EXTENTS OF DEMOLITION WORK (VIF, TYP ALL) WITH APPROPRIATE NEW WORK DRAWINGS PRIOR TO BEGINNING ANY DEMOLITION WORK, TYPICAL ALL TRADES.
- F. REFER TO HAZARDOUS MATERIALS DRAWINGS FOR HAZARDOUS MATERIAL WORK. COORDINATE ALL WORK IDENTIFIED ON ALL TRADES' DEMOLITION DRAWINGS WITH HAZARDOUS MATERIALS DRAWINGS PRIOR TO BEGINNING ANY DEMOLITION WORK. ALL HAZARDOUS MATERIAL WORK INDICATED ON DRAWINGS SHALL BE REMOVED AND LEGALLY DISPOSED OF AS PART OF BASE BID.
- G. PATCH ALL EXPOSED SURFACES TO REMAIN TO MATCH EXISTING AND ADJACENT SURFACES. TYPICAL.

Demolition Key Notes

- (1B) REMOVE INTERIOR PARTITION FULL-HEIGHT. PORTION AS INDICATED OR AS REQUIRED TO PERFORM SCHEDULED WORK. EXISTING STRUCTURE TO REMAIN. UNO SEE STRUCT DWGS.
- (1C) SAW CUT, OR ENLARGE EXISTING, OPENING IN WALL TO EXTENT REQUIRED TO PERFORM SCHEDULED WORK. PROVIDE LINTEL PER LINTEL SCHEDULE. PATCH EXPOSED SURFACES TO MATCH ADJACENT FINISHES / SURFACES.
- (1D) REMOVE CONCRETE FLOOR ASSEMBLY. PORTION INDICATED OR REQUIRED TO PERFORM SCHEDULED WORK. SEE STRUCT DWGS.
- (1H) REMOVE FIRE EXTINGUISHER AND BRACKET MOUNTED SYSTEM. SALVAGE AND PROTECT FOR RE-INSTALLATION.
- (1J) REMOVE FIRE EXTINGUISHER AND CABINET.
- (7A) REMOVE ROOFING SYSTEM DOWN TO EXG STRUCT DECK.
- (6A) REMOVE WINDOW, STOREFRONT OR CURTAIN WALL SYSTEM COMPLETELY. PREPARE OPENING TO EXTENT REQUIRED TO PERFORM SCHEDULED WORK. PATCH EXPOSED SURFACES TO MATCH ADJACENT FINISHES / SURFACES.
- (6B) REMOVE DOOR AND FRAME COMPLETELY. PATCH EXPOSED SURFACES TO MATCH ADJACENT FINISHES / SURFACES.
- (6C) ENLARGE OPENING IN CURTAIN WALL PANEL TO ACCOMMODATE NEW LOUVER OR DUCTWORK. REFER TO MECH DRAWINGS.

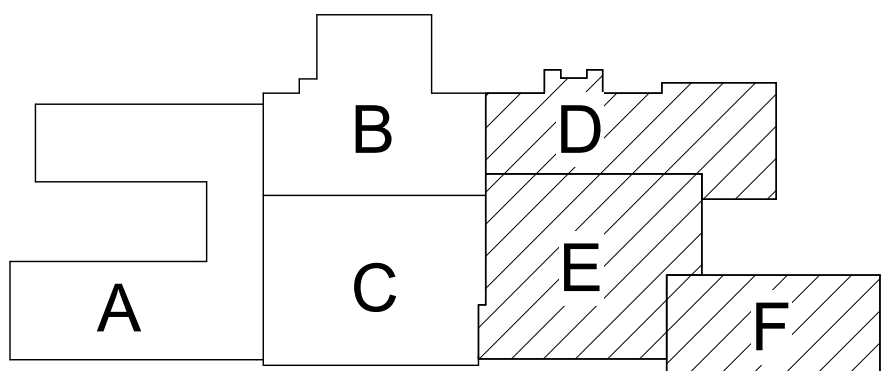

Key Plan
N.T.S.

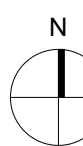

SED Control No. 60-01-01-06-0-018-023

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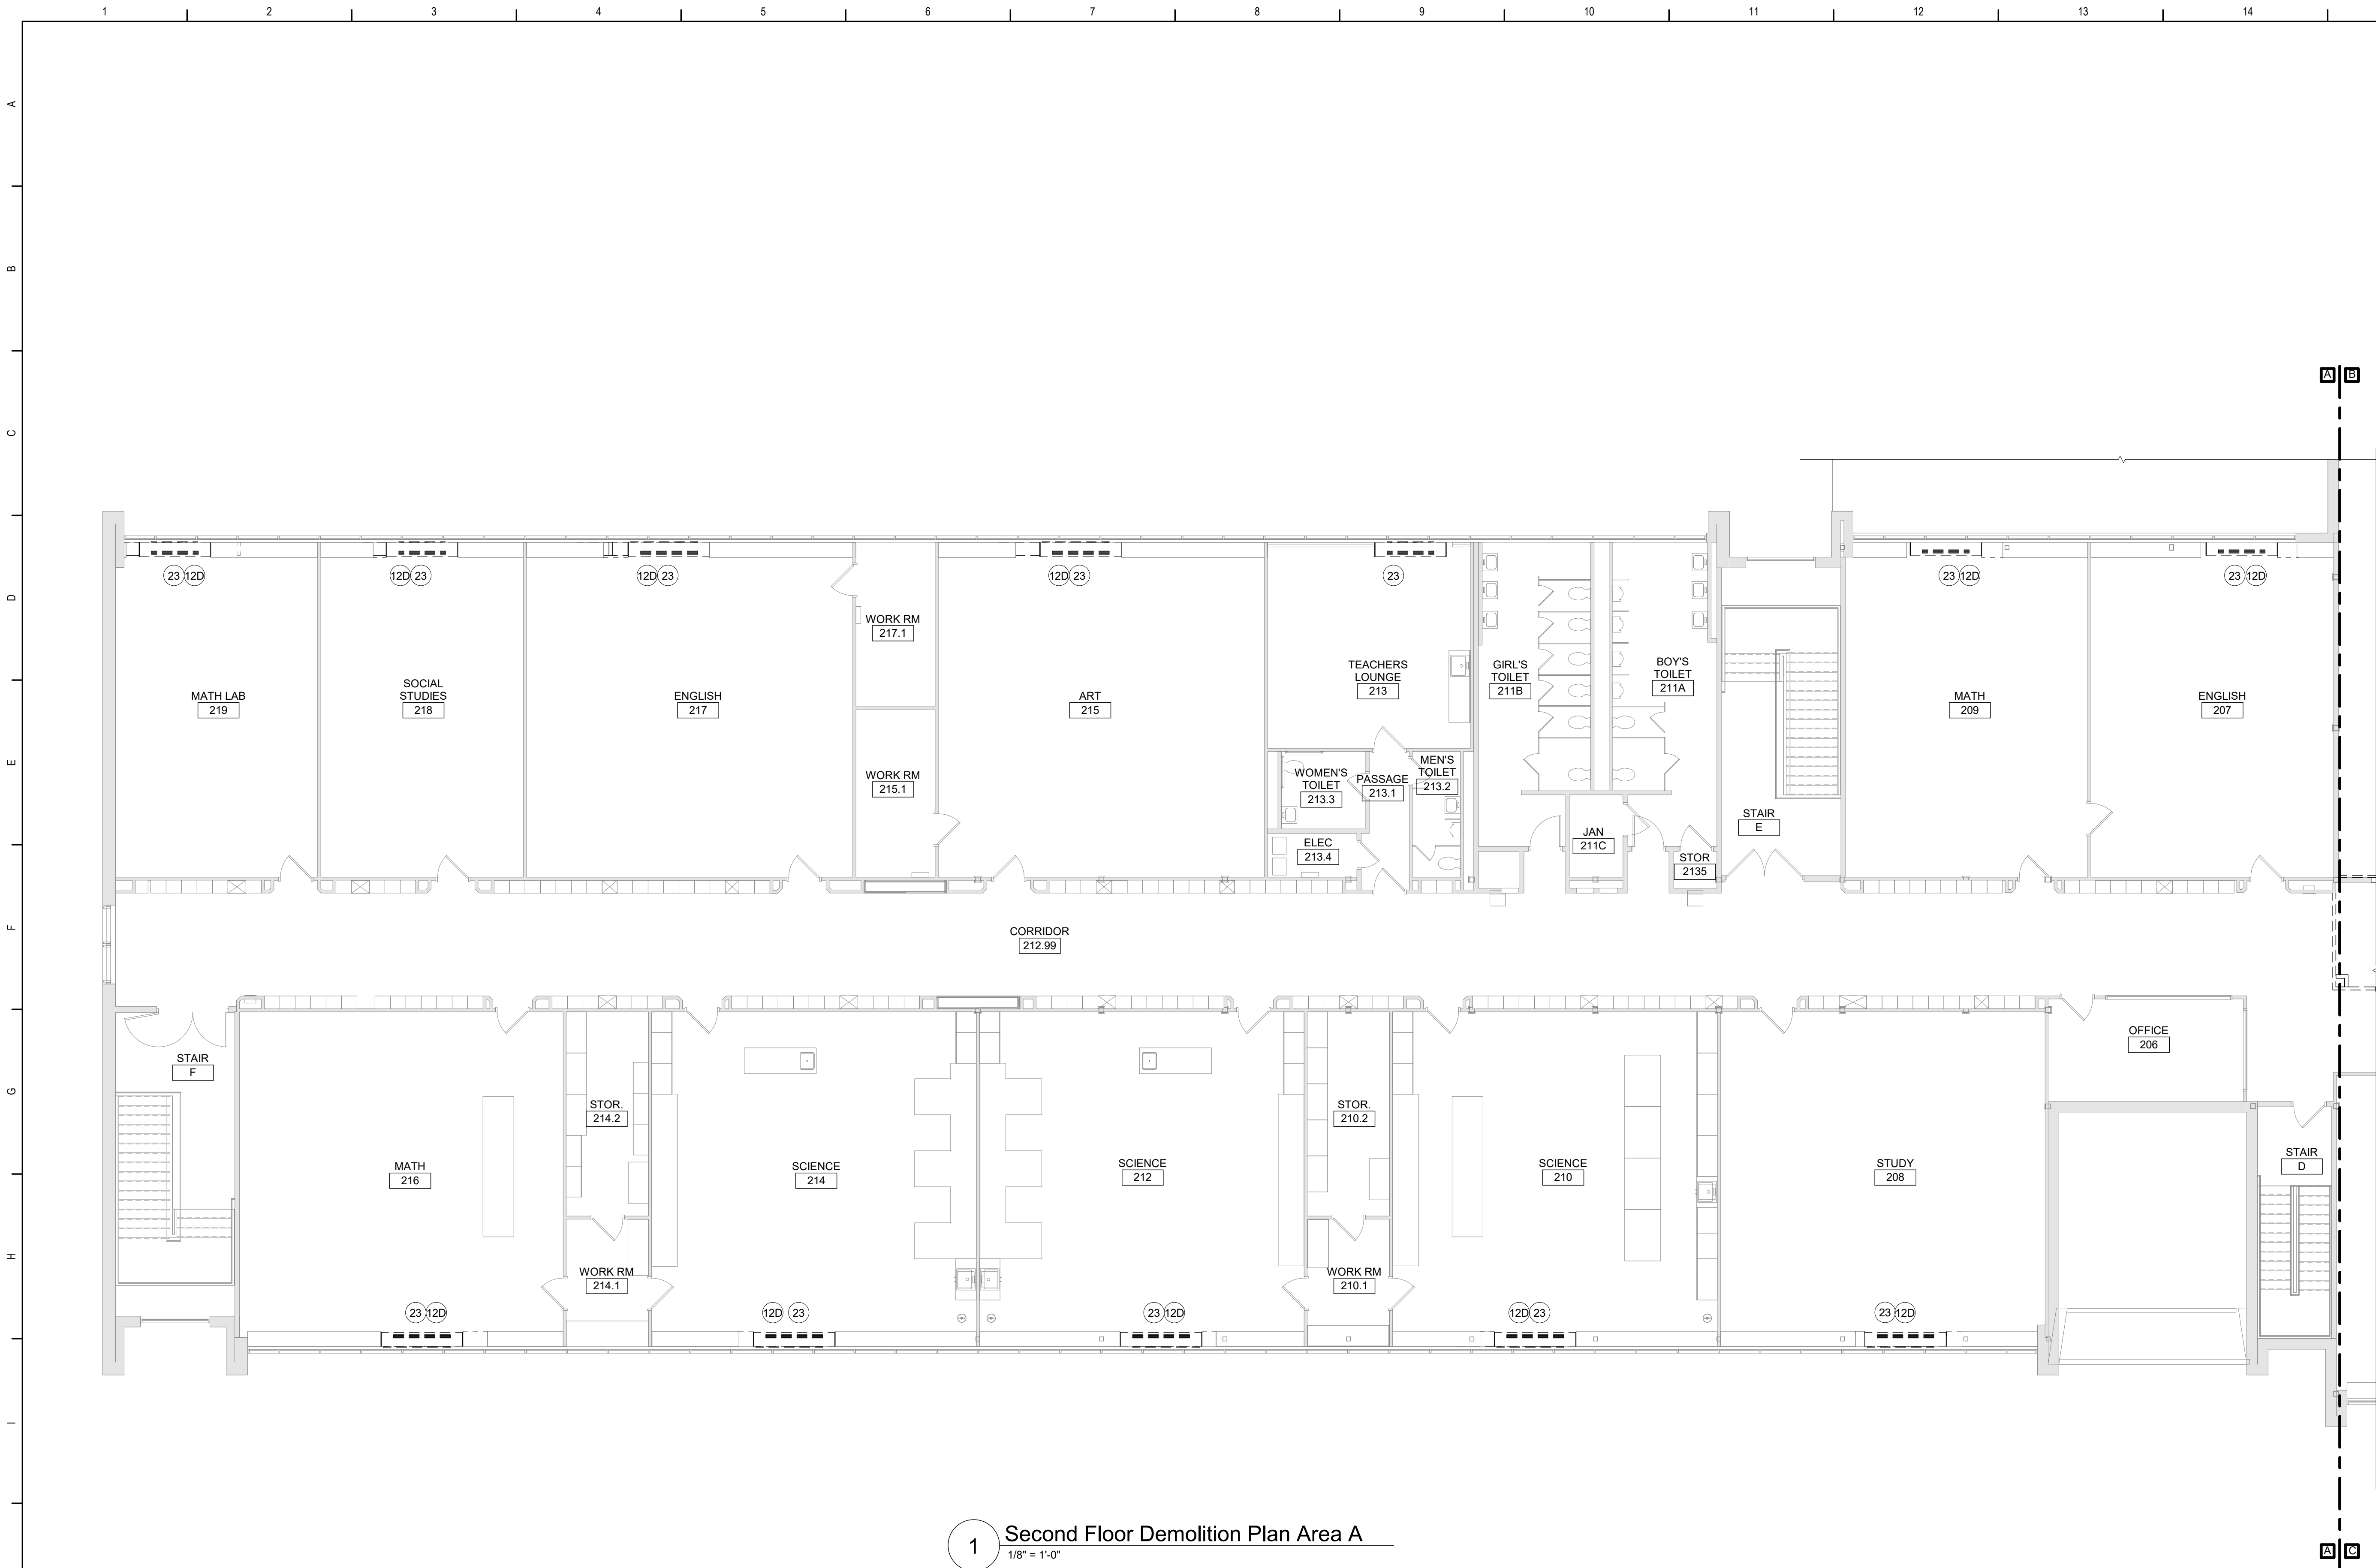
Waverly Central School District
Waverly, NY

Additions and Alterations to:
Waverly Jr. Sr. High School

First Floor Demolition Plan Partial
Areas D and E and First Floor
Demolition Plan Area F

Drawn By: KCB	Date: 05/19/2023	Drawing Number: AA103
Project No.: 339070-22003		

BID SET



1 Second Floor Demolition Plan Area A
1/8" = 1'-0"


- (8D) REMOVE EXISTING DOOR HARDWARE AND PREPARE DOOR FOR NEW HARDWARE.
- (8F) CUT OPENING IN EXISTING CURTAIN WALL PANEL TO CREATE OPENING FOR NEW GLAZED PANEL. SEE EXTERIOR ELEVATIONS.
- (9A) REMOVE CEILING SYSTEM AND/OR SOFFIT SYSTEM IN ITS ENTIRETY.
- (9B) REMOVE PORTION OF CEILING SYSTEM AND/OR SOFFIT SYSTEM, TO EXTENT REQUIRED TO PERFORM NEW WORK. CAREFULLY TRIM CEILING GRID TO REMAIN.
- (9D) REMOVE FLOOR FINISH, MASTIC, SETTING MATERIALS OR MORTAR BAD AND WALL BASE TO EXTENT REQUIRED TO PERFORM SCHEDULED WORK. AT ALL AREAS OF FLOOR REMOVAL, LEVEL SLAB WITH ADJACENT SLABS AT LOCATIONS SCHEDULED TO RECEIVE FLOOR FINISH. INCLUDE CONCRETE FLOOR PATCHING AND LEVELING MATERIALS TO MAKE SURFACE LEVEL. PREPARE FOR FINISH. PATCH AREAS OF WALLS TO REMAIN THAT WERE DAMAGED BY REMOVAL OF WALL BASE.
- SUFFIX KEY (FLOOR FINISH IDENTIFICATIONS):
 - A. CARPET
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 - F. POURED EPOXY
 - G. RUBBER FLOORING
 - H. TERRAZZO
 - I. VAT/CT
 - J. VINYL SHEET
 - K. WOOD FLOORING
- (9E) REMOVE WALL BASE AND ASSOCIATED MASTIC ONLY - EXISTING FLOOR FINISH TO REMAIN. PATCH AREAS OF WALLS TO REMAIN THAT WERE DAMAGED BY REMOVAL OF WALL BASE.
- (9F) REMOVE MIRRORS. PATCH EXPOSED SURFACES TO MATCH ADJACENT FINISHES / SURFACES. PROTECT AND STORE FOR REINSTALLATION IN NEW WEIGHT ROOM.
- (9H) REMOVE WALL FINISH APPLIED TO CMU WALL DOWN TO CMU WALL SURFACE. PATCH EXPOSED SURFACES TO MATCH ADJACENT FINISHES / SURFACES.
- (10A) REMOVE TEACHING SURFACES INCLUDING MARKER BOARDS, TACK BOARDS AND CHALK BOARDS. PATCH EXPOSED SURFACES TO MATCH ADJACENT FINISHES / SURFACES. PROTECT AND DELIVER TO OWNER'S STORAGE LOCATION FOR THEIR RE-USE.
- (10B) REMOVE TOILET COMPARTMENTS AND TOILET AND BATH ACCESSORIES IN THEIR ENTIRETY. PATCH EXPOSED SURFACES TO MATCH ADJACENT FINISHES / SURFACES TO EXTENT REQUIRED TO PERFORM SCHEDULED WORK.
- (10D) REMOVE LOCKERS AND LOCKER BASE COMPLETELY. PATCH EXPOSED SURFACES TO MATCH ADJACENT FINISHES / SURFACES TO EXTENT REQUIRED TO PERFORM SCHEDULED WORK.
- (10F) REMOVE BENCHES (INCLUDING ALL ASSOCIATED COMPONENTS). PATCH EXPOSED SURFACES TO MATCH ADJACENT FINISHES / SURFACES TO EXTENT REQUIRED TO PERFORM SCHEDULED WORK.
- (10H) REMOVE SIGNAGE.
- (10J) REMOVE OPERABLE PARTITION SYSTEM AND ASSOCIATED SOFFIT CONSTRUCTION IN ITS ENTIRETY.
- (11B) REMOVE BASKETBALL BACKSTOPS IN THEIR ENTIRETY.
- (11C) REMOVE SCOREBOARDS IN THEIR ENTIRETY INCLUDING WIRING AND CONTROLS.
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- (12D) CAREFULLY DETACH AND MOVE EXISTING CASEWORK AND COUNTERTOP AWAY FROM EXTERIOR WALL. PERFORM WORK IN SUCH THAT ACM FLOOR TILE ADJACENT TO CASEWORK IS NOT DISTURBED. REMOVE CASEWORK UNIT SHOWN DASHED. SALVAGE CASEWORK. UNIT(S) NOT SHOWN DASHED FOR REINSTALLATION WITH NEW CASEWORK UNIT SIZED TO ACCOMMODATE LARGER UNIT VENTILATOR. EXISTING COUNTERTOP AND GRILLE TO BE CUT DOWN TO NEW LENGTH REQUIRED FOR LARGER UNIT VENTILATOR. COUNTERTOP TO BE SHORTENED BY CUTTING THE END AGAINST THE EXISTING WALL. REFER TO NEW WORK PLANS FOR TYPICAL LAYOUTS.
- (12F) REMOVE EXISTING CASEWORK UNITS IN THEIR ENTIRETY. SALVAGE AND TURN OVER TO OWNER'S STORAGE LOCATION.
- (23) EXISTING MECHANICAL EQUIPMENT TO BE REMOVED. REFER TO MECHANICAL DRAWINGS.

General Demolition Notes

- A. - - - - - REMOVE ITEMS INDICATED BY DASHED LINE.
- B. KEYED DEMOLITION TAGS REFER TO SPECIFIC LOCATIONS AS FOLLOWS:
 - 1. DEMOLITION TAGS LOCATED WITHIN THE MIDDLE OF A SPACE REFER TO DEMOLITION OF ALL ITEMS OF THAT SAME TYPE WITHIN THAT ENTIRE SPACE.
 - 2. DEMOLITION TAGS PLACED IMMEDIATELY ON OR ADJACENT TO A DASHED LINE INDICATING ITEM REMOVAL OR THAT HAVE A LEADER POINTING TO SPECIFIC ITEM(S) REFER TO DEMOLITION OF THAT SPECIFIC ITEM ONLY OF THAT TYPE WITHIN THAT SPACE.
 - 3. DEMOLITION TAGS IN SERIES REFER TO DEMOLITION OF ALL THOSE ITEMS EITHER WITHIN THAT ENTIRE SPACE OR TO THE SPACE IDENTIFIED BY THAT LEADER.
- C. WHEN AN ITEM IS INDICATED TO BE DEMOLISHED REMOVE ALL ASSOCIATED COMPONENTS AS PART OF THAT WORK.
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- E. REMOVAL INDICATED ON ARCHITECTURAL DRAWINGS DOES NOT INDICATE FULL EXTENT OF PROJECT'S DEMOLITION WORK. COORDINATE WORK IDENTIFIED ON ALL TRADES' DEMOLITION DRAWINGS. PRIOR TO BEGINNING ANY DEMOLITION WORK, COORDINATE EXACT LOCATIONS AND EXTENTS OF DEMOLITION WORK (VIF, TYP ALL) WITH APPROPRIATE NEW WORK DRAWINGS PRIOR TO BEGINNING ANY DEMOLITION WORK, TYPICAL ALL TRADES.
- F. REFER TO HAZARDOUS MATERIALS DRAWINGS FOR HAZARDOUS MATERIAL WORK. COORDINATE ALL WORK IDENTIFIED ON ALL TRADES' DEMOLITION DRAWINGS WITH HAZARDOUS MATERIALS DRAWINGS PRIOR TO BEGINNING ANY DEMOLITION WORK. ALL HAZARDOUS MATERIAL WORK INDICATED ON DRAWINGS SHALL BE REMOVED AND LEGALLY DISPOSED OF AS PART OF BASE BID.
- G. PATCH ALL EXPOSED SURFACES TO REMAIN TO MATCH EXISTING AND ADJACENT SURFACES, TYPICAL.

Demolition Key Notes

- (1B) REMOVE INTERIOR PARTITION FULL-HEIGHT. PORTION AS INDICATED OR AS REQUIRED TO PERFORM SCHEDULED WORK. EXISTING STRUCTURE TO REMAIN. UNO SEE STRUCT DWGS.
- (1C) SAW CUT, OR ENLARGE EXISTING, OPENING IN WALL TO EXTENT REQUIRED TO PERFORM SCHEDULED WORK. PROVIDE LINTEL PER LINTEL SCHEDULE. PATCH EXPOSED SURFACES TO MATCH ADJACENT FINISHES / SURFACES.
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- (1H) REMOVE FIRE EXTINGUISHER AND BRACKET MOUNTED SYSTEM. SALVAGE AND PROTECT FOR RE-INSTALLATION.
- (1J) REMOVE FIRE EXTINGUISHER AND CABINET.
- (7A) REMOVE ROOFING SYSTEM DOWN TO EXG STRUCT DECK.
- (8A) REMOVE WINDOW, STOREFRONT OR CURTAIN WALL SYSTEM COMPLETELY. PREPARE OPENING TO EXTENT REQUIRED TO PERFORM SCHEDULED WORK. PATCH EXPOSED SURFACES TO MATCH ADJACENT FINISHES / SURFACES.
- (8B) REMOVE DOOR AND FRAME COMPLETELY. PATCH EXPOSED SURFACES TO MATCH ADJACENT FINISHES / SURFACES.
- (8C) ENLARGE OPENING IN CURTAIN WALL PANEL TO ACCOMMODATE NEW LOUVER OR DUCTWORK. REFER TO MECH DRAWINGS.

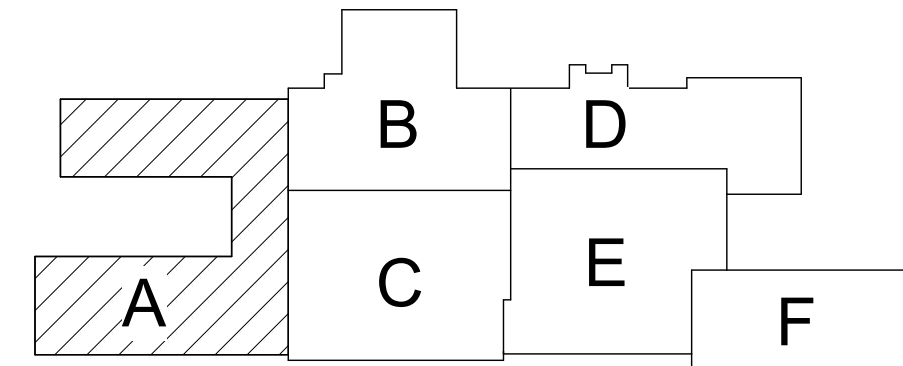

Key Plan
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SED Control No. 60-01-01-06-0-018-023

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Waverly Central School District
Waverly, NY

Additions and Alterations to:
Waverly Jr. Sr. High School


Second Floor Demolition Plan Area A

Drawn By: KCB	Date: 05/19/2023	Drawing Number: AA104
Project No.: 339070-22003		




- 12F REMOVE EXISTING CASEWORK UNITS IN THEIR ENTIRETY. SALVAGE AND TURN OVER TO OWNER'S STORAGE LOCATION
- 23 EXISTING MECHANICAL EQUIPMENT TO BE REMOVED, REFER MECHANICAL DRAWINGS.

8C ENLARGE OPENING IN CURTAIN WALL PANEL TO ACCOMMODATE
NEW LOUVER OR DUCTWORK. REFER TO MECH DRAWINGS.

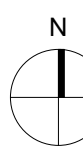

AA105

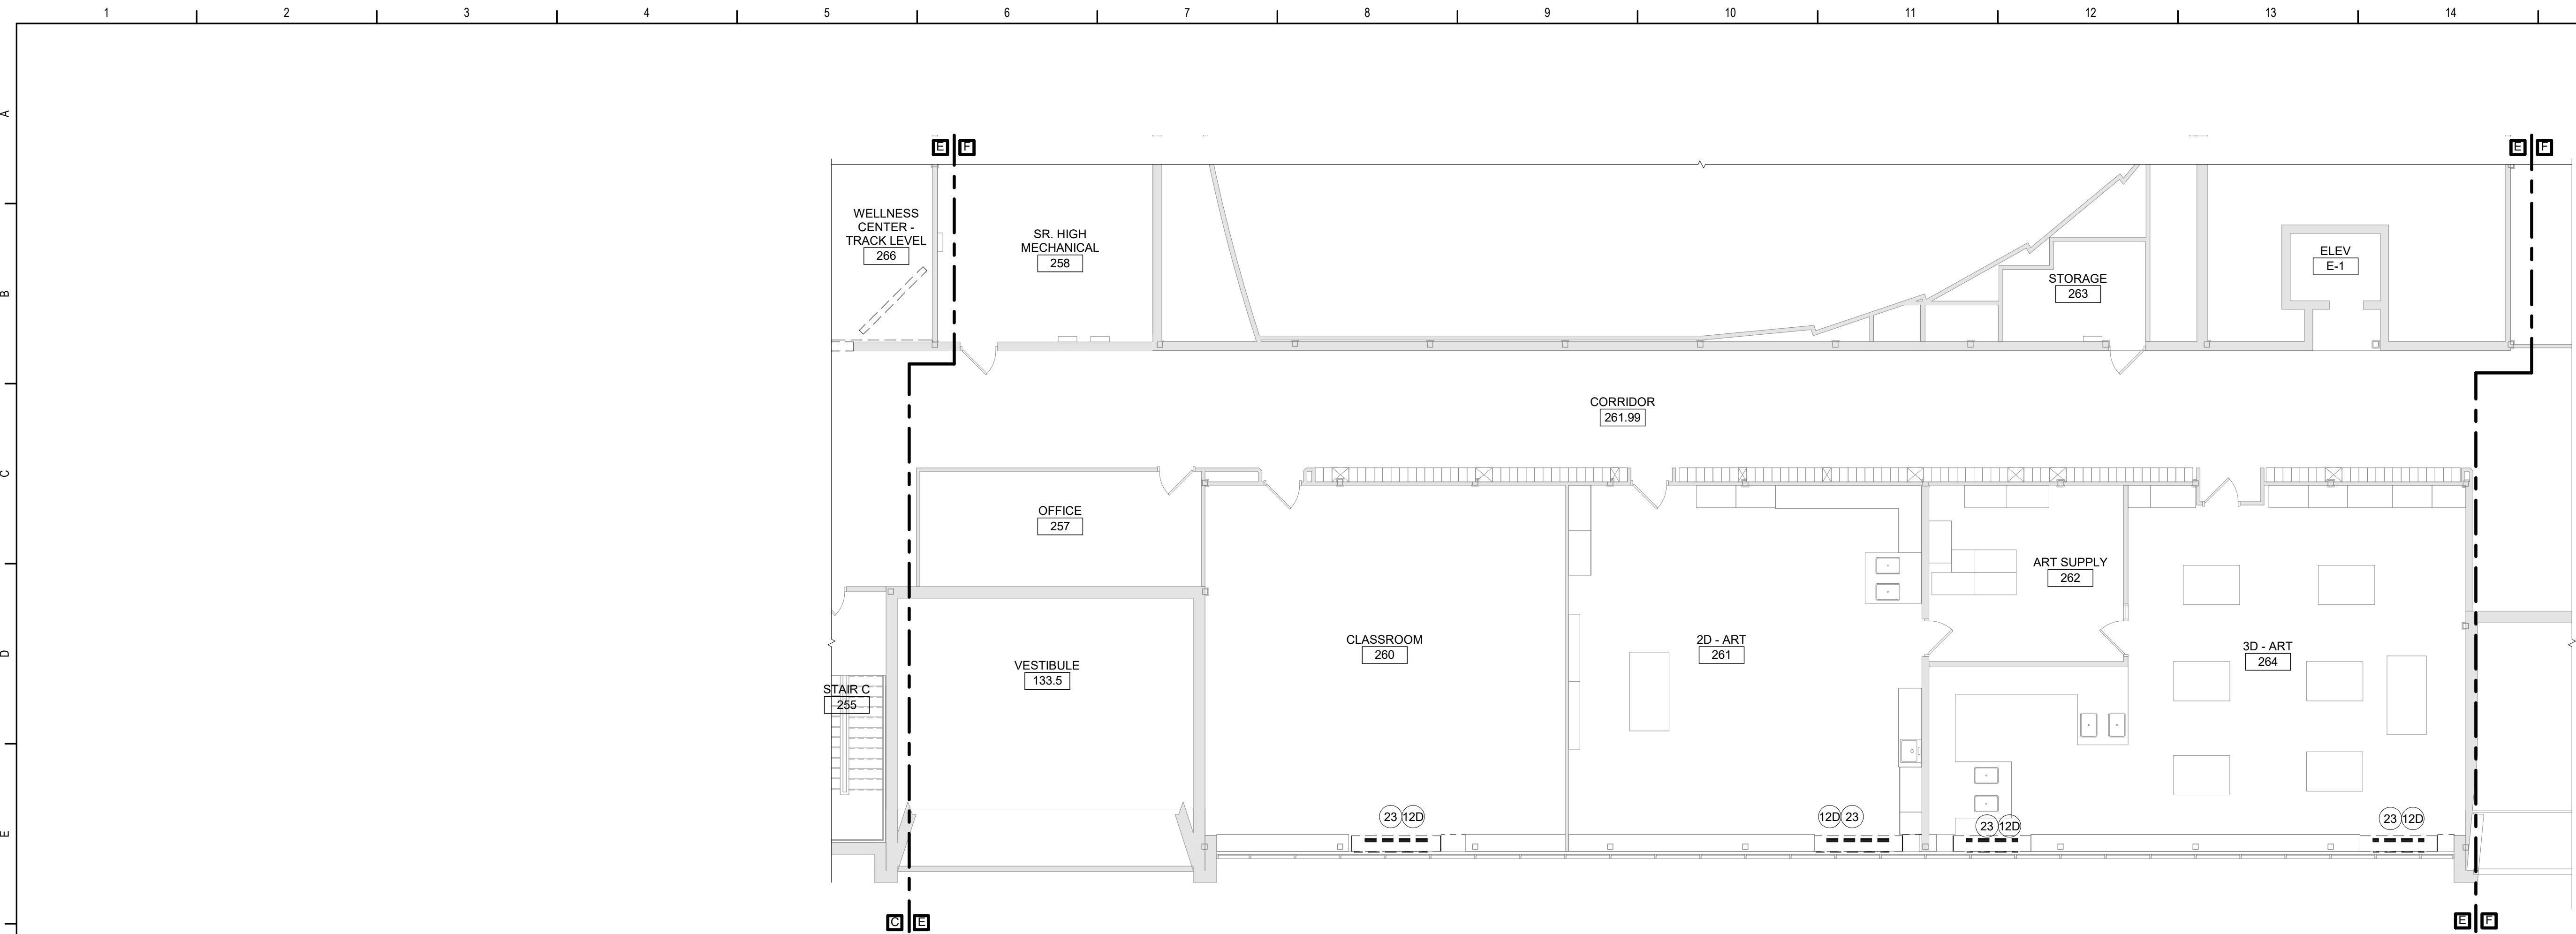

1 Second Floor Demolition Plan Partial Area E
1/8" = 1'-0"


80. REMOVE EXISTING DOOR HARDWARE AND PREPARE DOOR FOR NEW HARDWARE.
- 8F. CUT OPENING IN EXISTING CURTAIN WALL PANEL TO CREATE OPENING FOR NEW GLAZED PANEL. SEE EXTERIOR ELEVATIONS.
- 9A. REMOVE CEILING SYSTEM AND/OR SOFFIT SYSTEM IN ITS ENTIRETY.
- 9B. REMOVE PORTION OF CEILING SYSTEM AND/OR SOFFIT SYSTEM TO EXTENT REQUIRED TO PERFORM NEW WORK. CAREFULLY TRIM CEILING GRID TO REMAIN.
- 9D. REMOVE FLOOR FINISH, MASTIC, SETTING MATERIALS OR MORTAR BAD AND WALL BASE TO EXTENT REQUIRED TO PERFORM SCHEDULED WORK. AT ALL AREAS OF FLOOR REMOVAL, LEVEL SLAB WITH ADJACENT SLABS AT LOCATIONS SCHEDULED TO RECEIVE FLOOR FINISH. INCLUDE CONCRETE FLOOR PATCHING AND LEVELING MATERIALS TO MAKE SURFACE LEVEL. PREPARE FOR FINISH. PATCH AREAS OF WALLS TO REMAIN THAT WERE DAMAGED BY REMOVAL OF WALL BASE.
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General Demolition Notes

- A. - - - - - REMOVE ITEMS INDICATED BY DASHED LINE.
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- F. REFER TO HAZARDOUS MATERIALS DRAWINGS FOR HAZARDOUS MATERIAL WORK. COORDINATE ALL WORK IDENTIFIED ON ALL TRADES' DEMOLITION DRAWINGS WITH HAZARDOUS MATERIALS DRAWINGS PRIOR TO BEGINNING ANY DEMOLITION WORK. ALL HAZARDOUS MATERIAL WORK INDICATED ON DRAWINGS SHALL BE REMOVED AND LEGALLY DISPOSED OF AS PART OF BASE BID.
- G. PATCH ALL EXPOSED SURFACES TO REMAIN TO MATCH EXISTING AND ADJACENT SURFACES, TYPICAL.

Demolition Key Notes

- 1B. REMOVE INTERIOR PARTITION FULL-HEIGHT, PORTION AS INDICATED OR AS REQUIRED TO PERFORM SCHEDULED WORK. EXISTING STRUCTURE TO REMAIN. UNO SEE STRUCT DWGS.
- 1C. SAW CUT, OR ENLARGE EXISTING, OPENING IN WALL TO EXTENT REQUIRED TO PERFORM SCHEDULED WORK. PROVIDE LINTEL PER LINTEL SCHEDULE. PATCH EXPOSED SURFACES TO MATCH ADJACENT FINISHES / SURFACES.
- 1D. REMOVE CONCRETE FLOOR ASSEMBLY, PORTION INDICATED OR REQUIRED TO PERFORM SCHEDULED WORK. SEE STRUCT DWGS.
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Key Plan
N.T.S.

SED Control No. 60-01-01-06-0-018-023

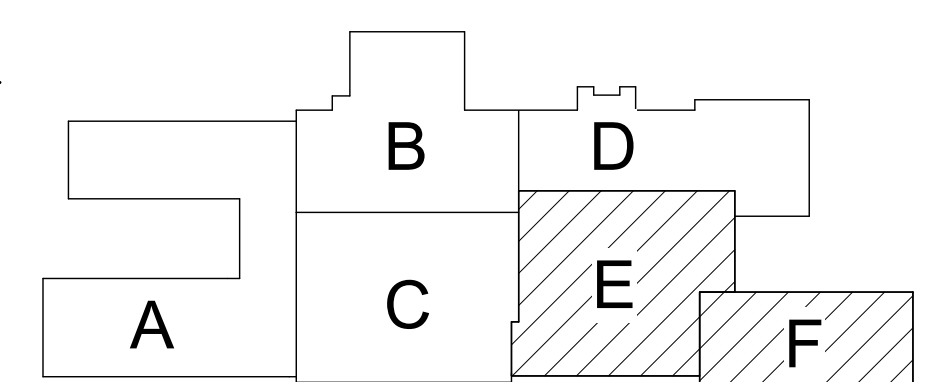Rev. No.: Date: Description:



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CLEAR SOLUTIONS

Tetra Tech Engineers, Architects
& Landscape Architects, P.C.




Waverly Central School District
Waverly, NY


Additions and Alterations to:
Waverly Jr. Sr. High School

Second Floor Demolition Plan Partial
Area E and Area F


Drawing By: KCB
Project No.: 339070-22003
Date: 05/19/2023
Drawing Number: AA106

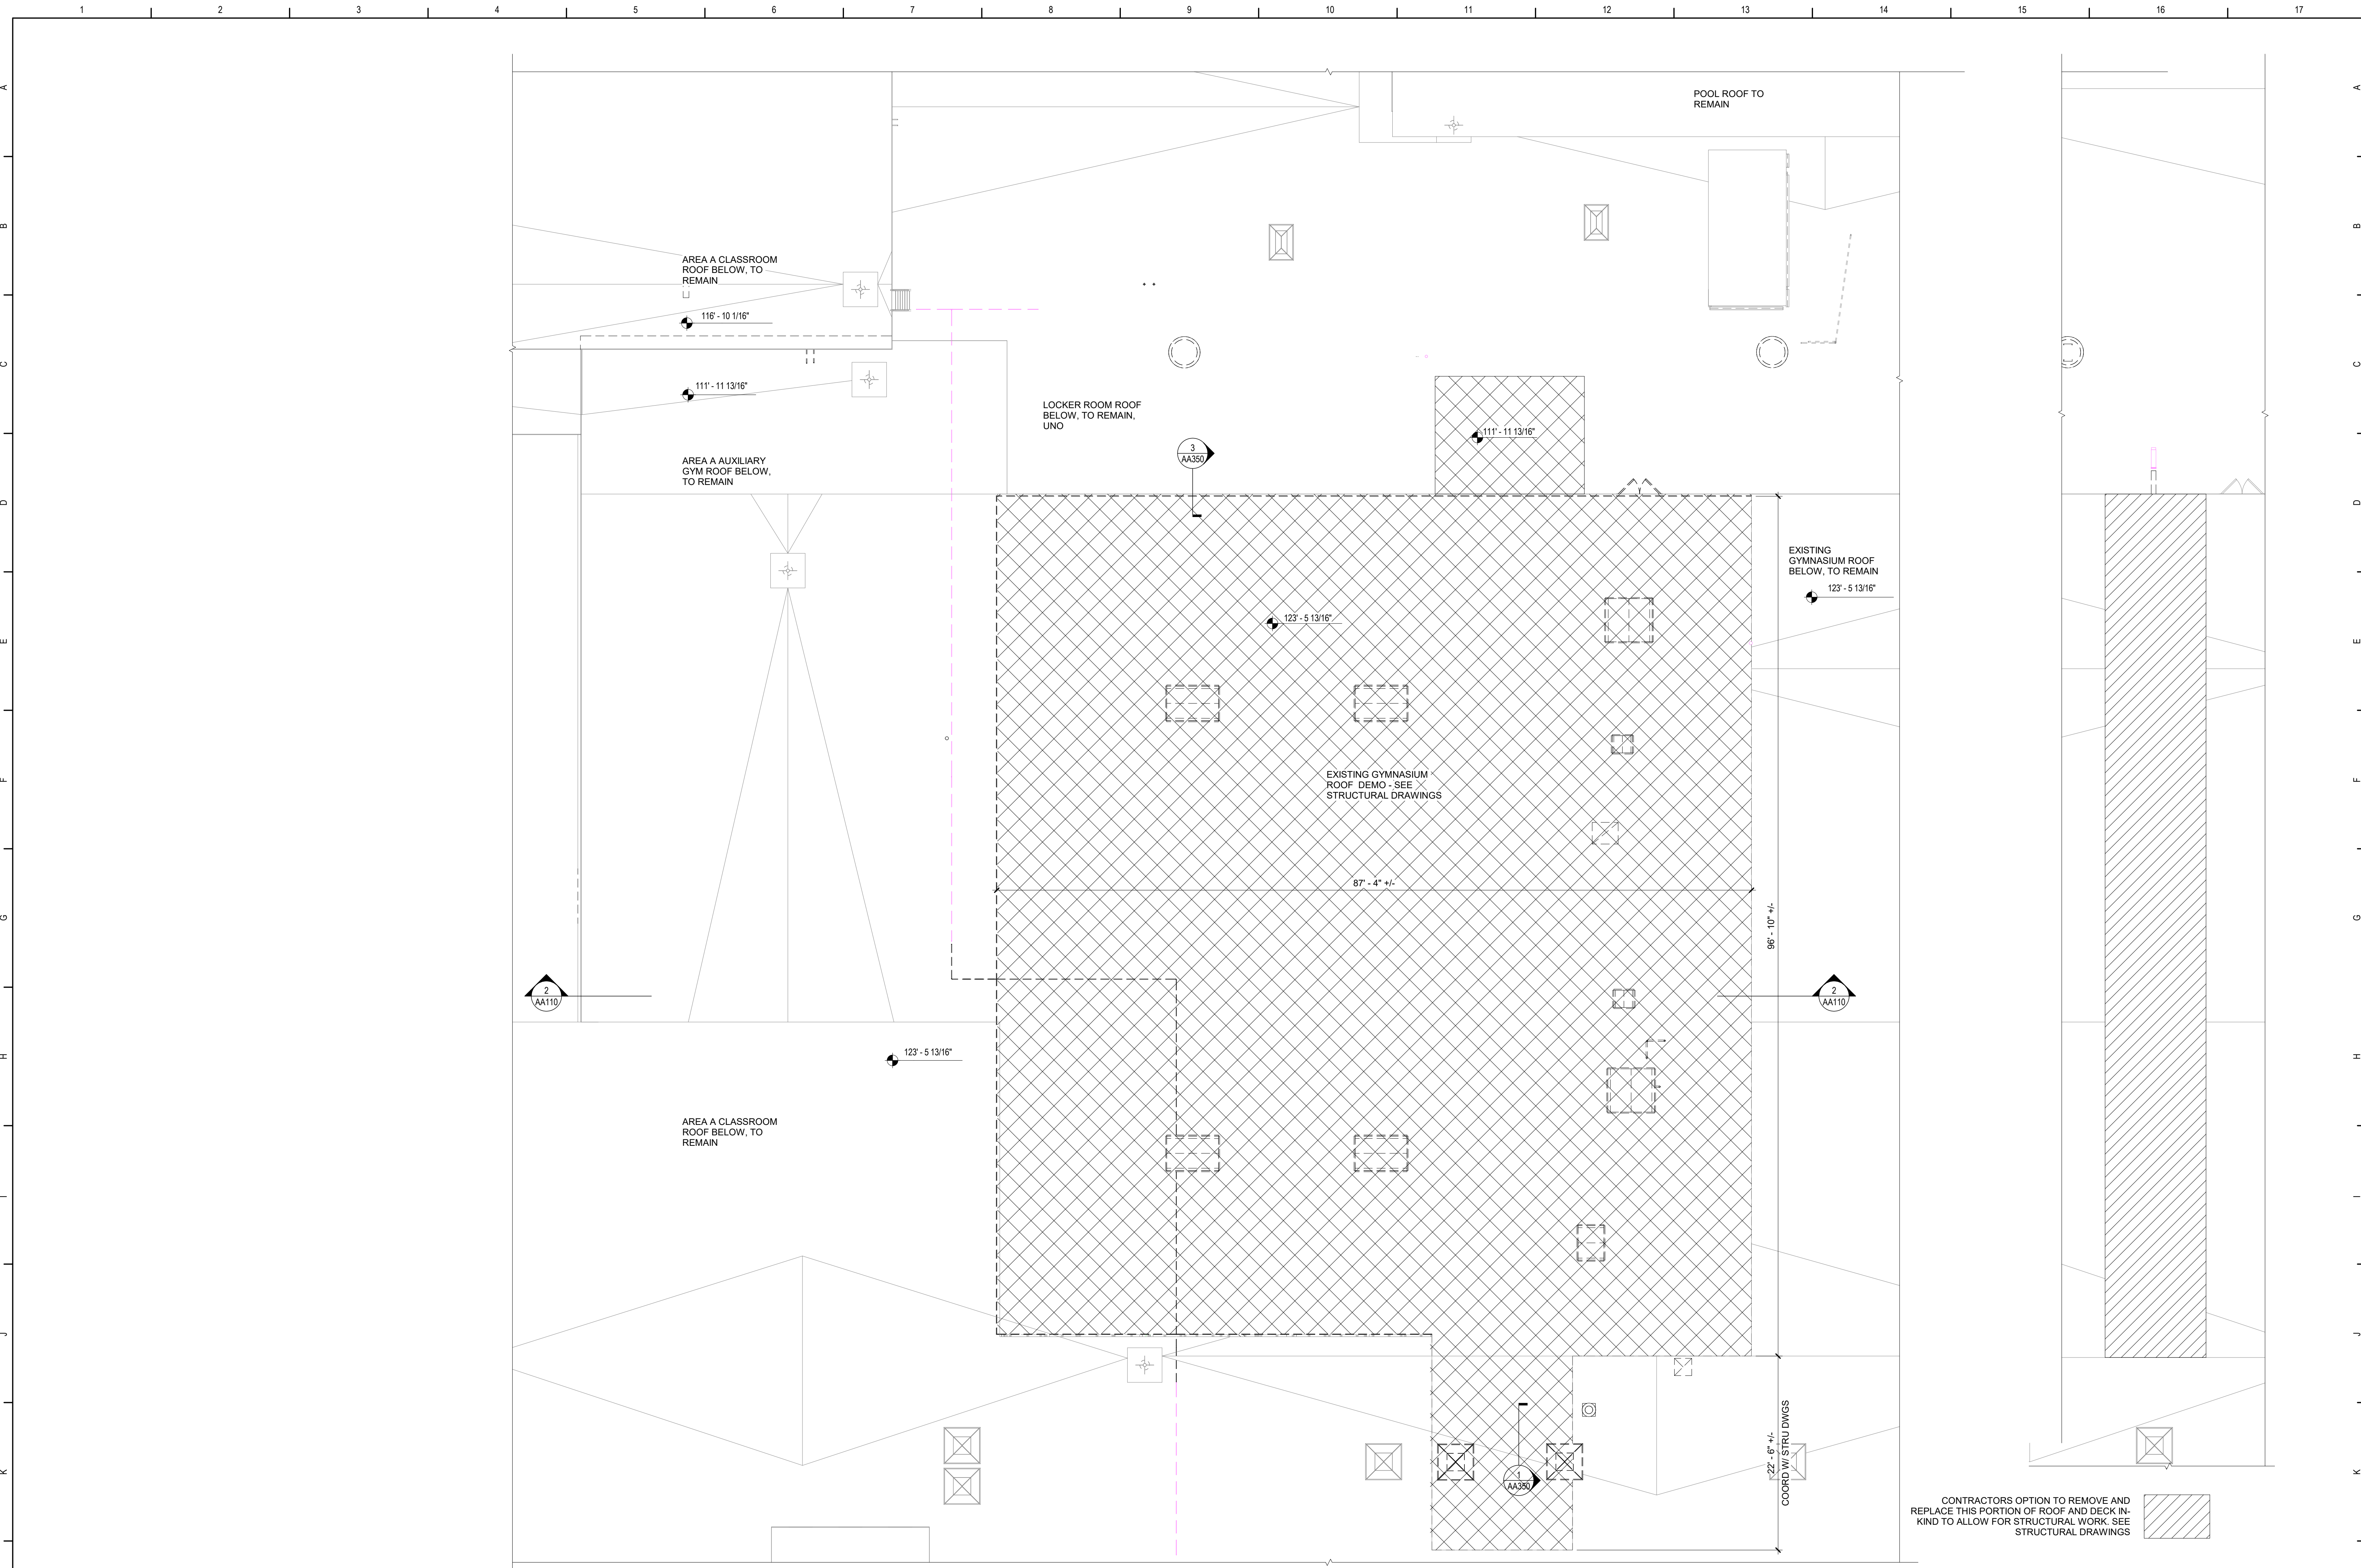

1 Roof - Partial Demolition Plan
1/8" = 1'-0"

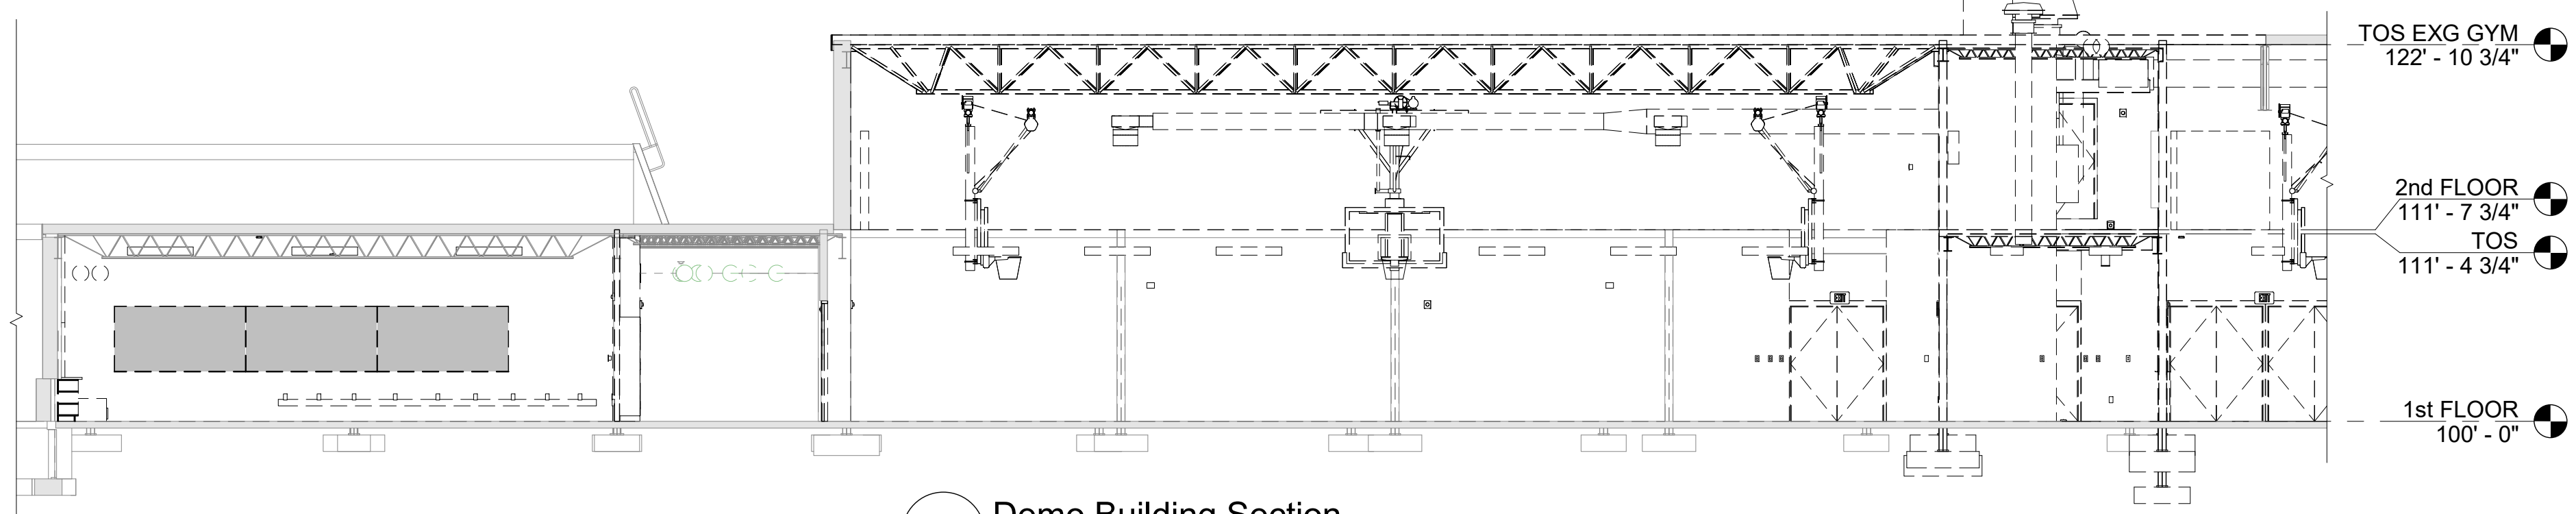


2 Demo Building Section
1/8" = 1'-0"

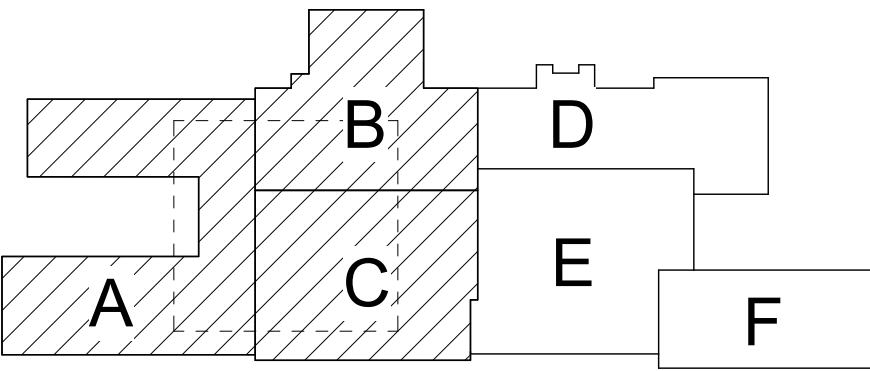

Key Plan
N.T.S.

SED Control No. 60-01-01-06-0-018-023

Rev. No.:	Date:	Description:

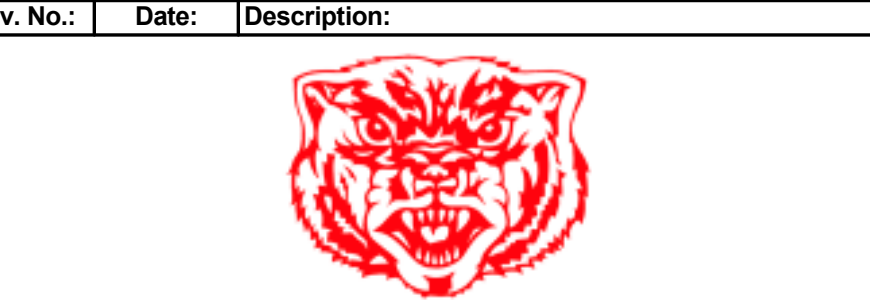

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Tetra Tech Engineers, Architects
& Landscape Architects, P.C.

BID SET




Waverly Central School District
Waverly, NY

Additions and Alterations to:
Waverly Jr. Sr. High School

Roof Demolition Plan

Drawn By: KCB	Date: 05/19/2023	Drawing Number: AA110
Project No.: 339070-22003		

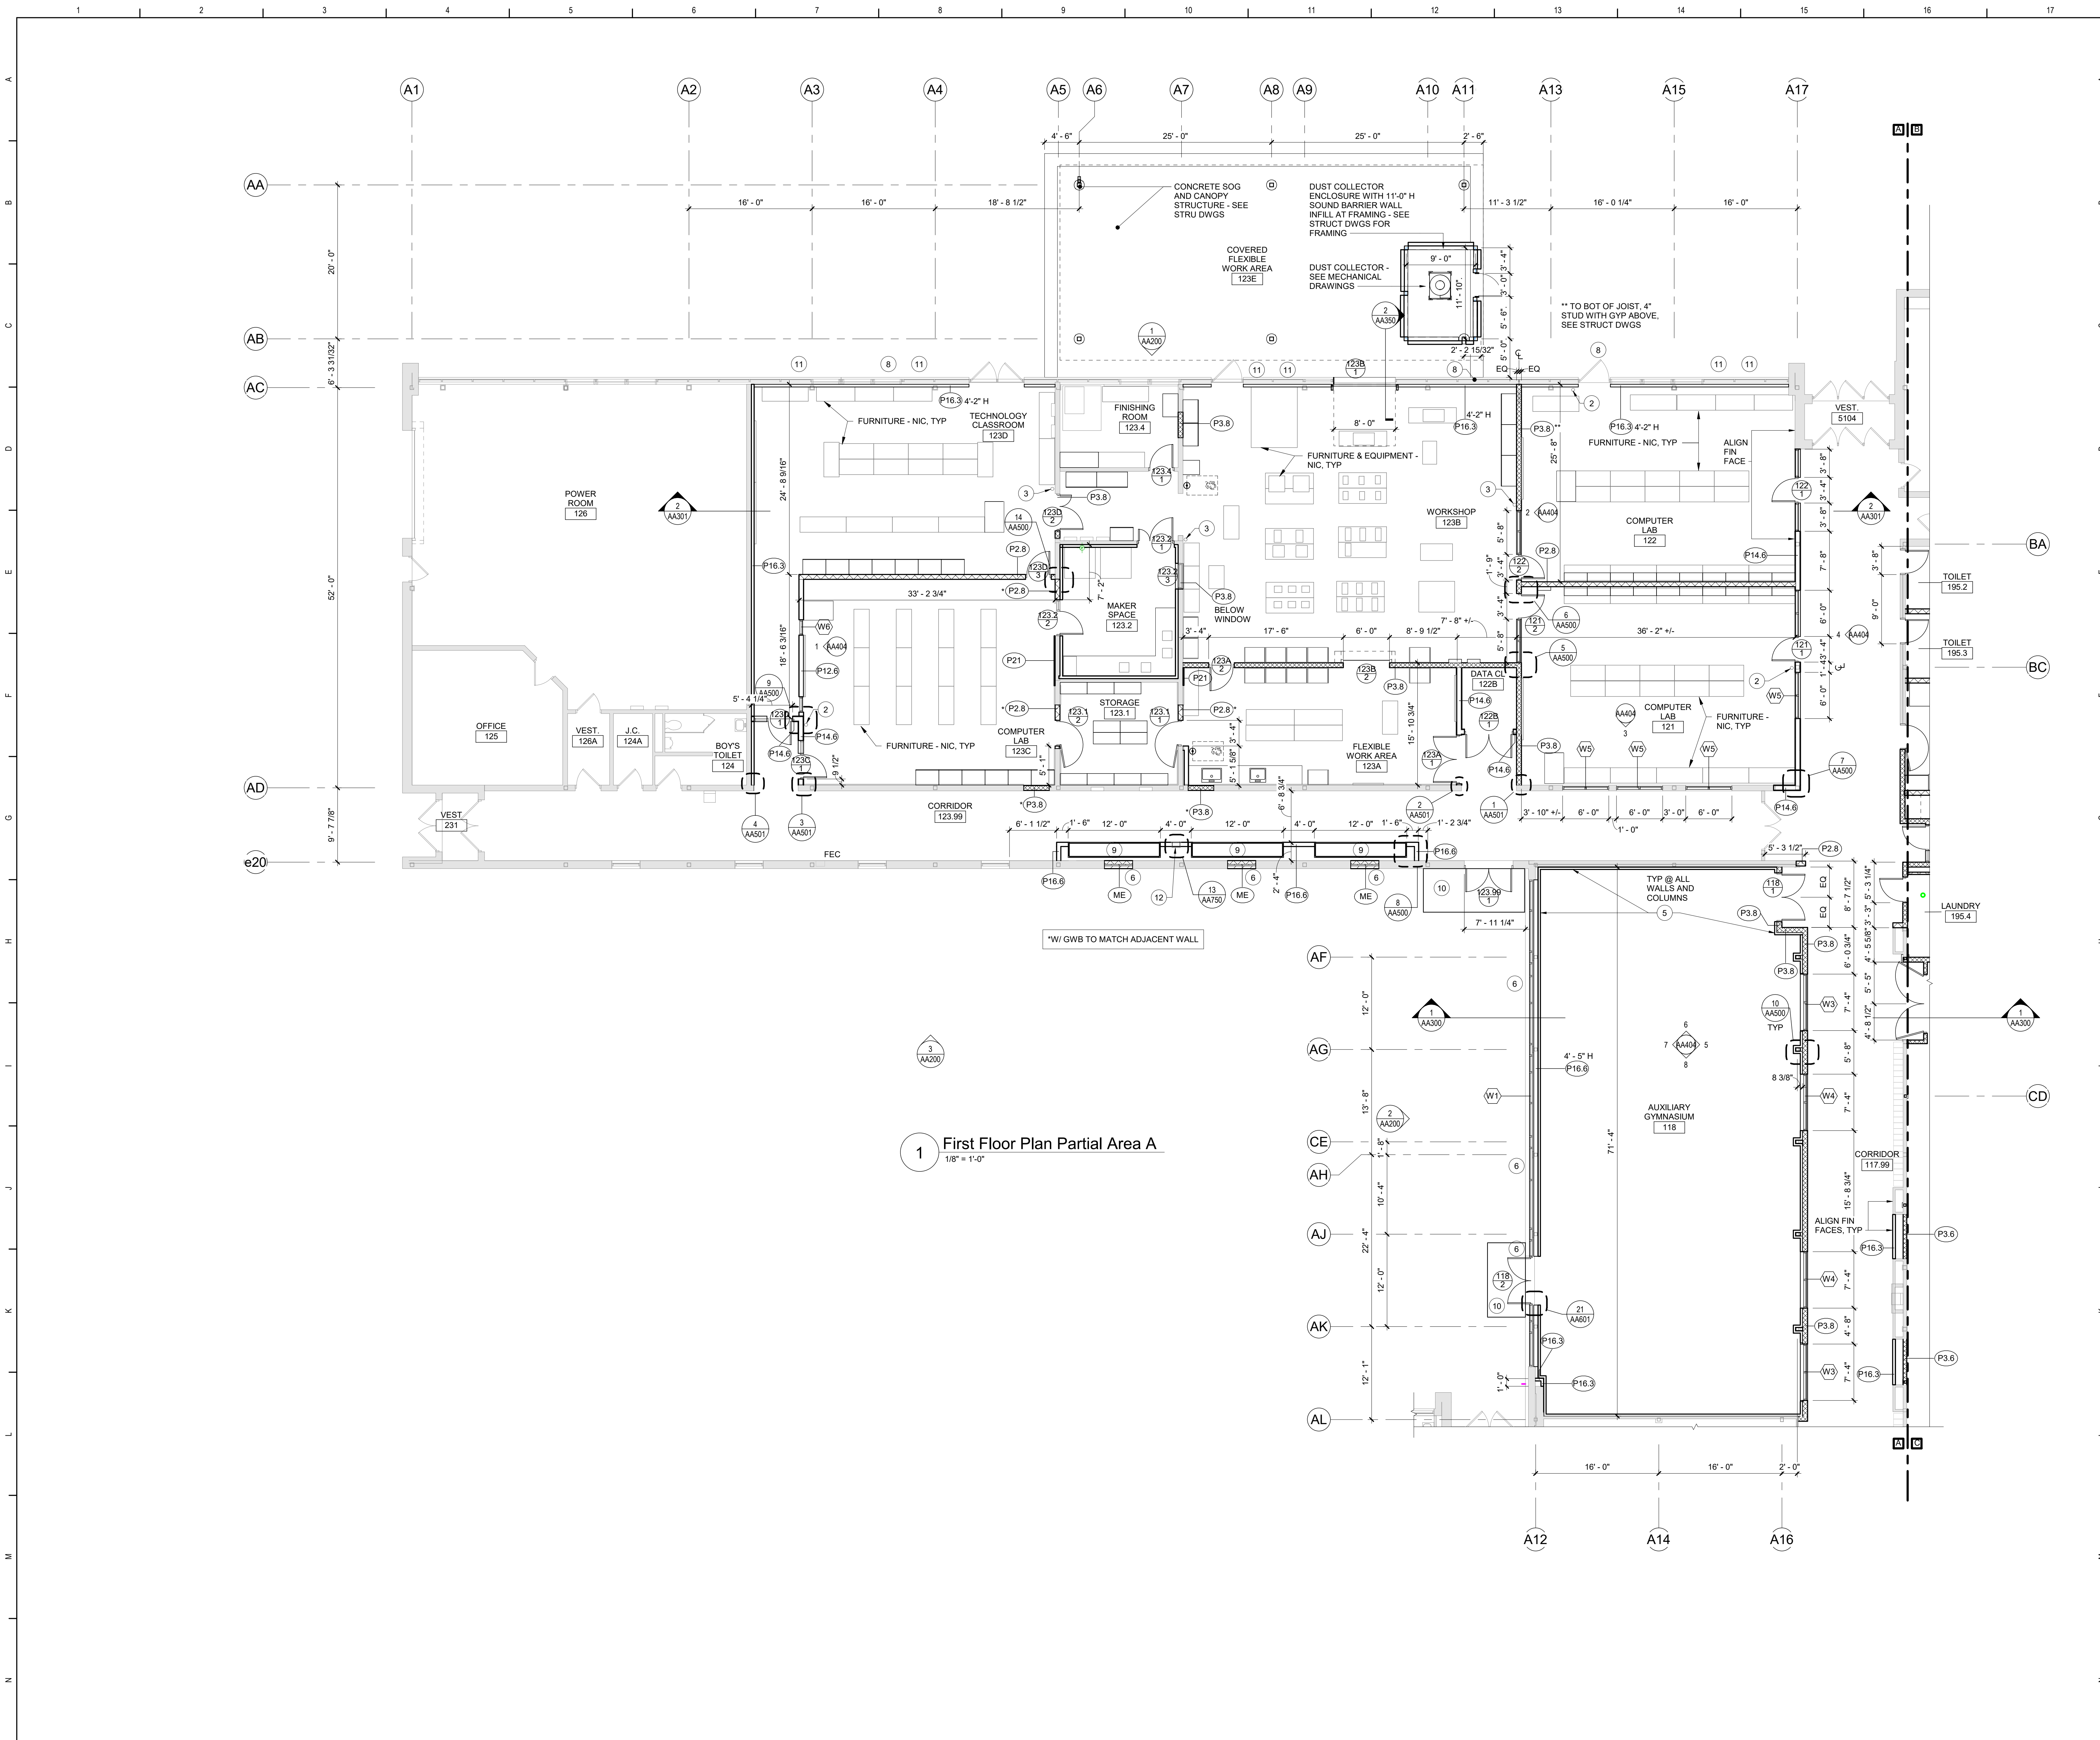


1 First Floor Plan Partial Area A
1/8" = 1'-0"

General Plan Notes

- A. WHERE EXISTING CONSTRUCTION IS DAMAGED OR DISTURBED, PATCH AS REQUIRED TO RESTORE SURFACES TO THEIR ORIGINAL CONDITION. AT EXISTING STRUCTURAL STEEL TO REMAIN THAT WILL BE EXPOSED, PREP SURFACES FOR PAINTING, TYP.
- B. PARTITION TYPE TAGS APPLY TO ENTIRE LENGTH OF WALL INDICATED BY THAT TAG, REGARDLESS OF OPENINGS WITHIN THAT WALL, TYPICAL UNLESS NOTED OTHERWISE.
- C. INFILL AREAS OF FINISH REMOVALS WITH REPAIR MATERIAL. PROVIDE SUBSTRATE LEVEL AS REQUIRED SO SCHEDULED FINISHED FLOOR WILL MATCH THAT OF ADJACENT AREAS.
- D. PROVIDE BRACING WITHIN CHASES AS FOLLOWS:
 - 1. MASONRY WALLS: FULL-HEIGHT 4" CMU BRACES AT MAXIMUM SPACING OF 8'-0" OC.
 - 2. GYPSUM BOARD/TILE BACKING PANELS ON METAL FRAMING: FULL-HEIGHT 6" METAL STUD BRACES AT MAXIMUM SPACING OF 11'-0" OC.
- E. HINGE SIDE ROUGH OPENING OF DOOR FRAME TO BE LOCATED 4" FROM ADJACENT WALL UNO.
- F. REFER TO ALTERNATES SPECIFICATION SECTION 01 23 00 FOR ANY ALTERNATES IN THIS AREA.

Keyed Plan Notes

- 1 EXISTING LOUVER TO REMAIN.
- 2 INSTALL RELOCATED FIRE EXTINGUISHER AND BRACKET MOUNTED SYSTEM.
- 3 PROVIDE NEW BRACKET MOUNTED FIRE EXTINGUISHER.
- 4 PROVIDE NEW FINISHED LOCKER END PANEL TO MATCH EXISTING LOCKERS.
- 5 FIXED WALL PADS - SEE DETAIL 11/AA750.
- 6 INFILL EXTERIOR WALL OPENING WITH CMU, AIR BARRIER, INSULATION AND BRICK, THICKNESS, COLOR, AND BOND PATTERN TO MATCH EXISTING. TOOTH-IN MASONRY, TYPICAL.
- 7 INFILL INTERIOR WALL OPENING WITH METAL STUD AND GYP BD, THICKNESS TO MATCH EXISTING, TYPICAL. TYPICAL SIZE 12"x30". REFER TO MECHANICAL DRAWINGS FOR ADDITIONAL INFORMATION.
- 8 PROVIDE NEW INSULATED PANEL IN EXISTING CURTAIN WALL. COORDINATE WITH MECHANICAL DRAWINGS.
- 9 DISPLAY CASE - REFER TO DETAIL 9/AA751 AND SPECIFICATIONS.
- 10 DOOR STOOP - REFER TO STRUCTURAL DRAWINGS.
- 11 NEW GLAZED PANELS IN EXISTING CURTAIN WALL FRAMING.
- 12 PROVIDE NEW FIRE EXTINGUISHER AND CABINET.

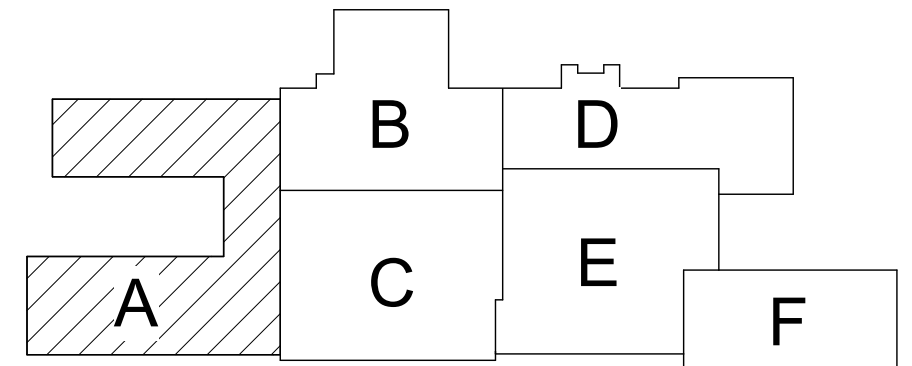

Key Plan
N.T.S.

SED Control No. 60-01-01-06-0-018-023

Rev. No.: Date: Description:



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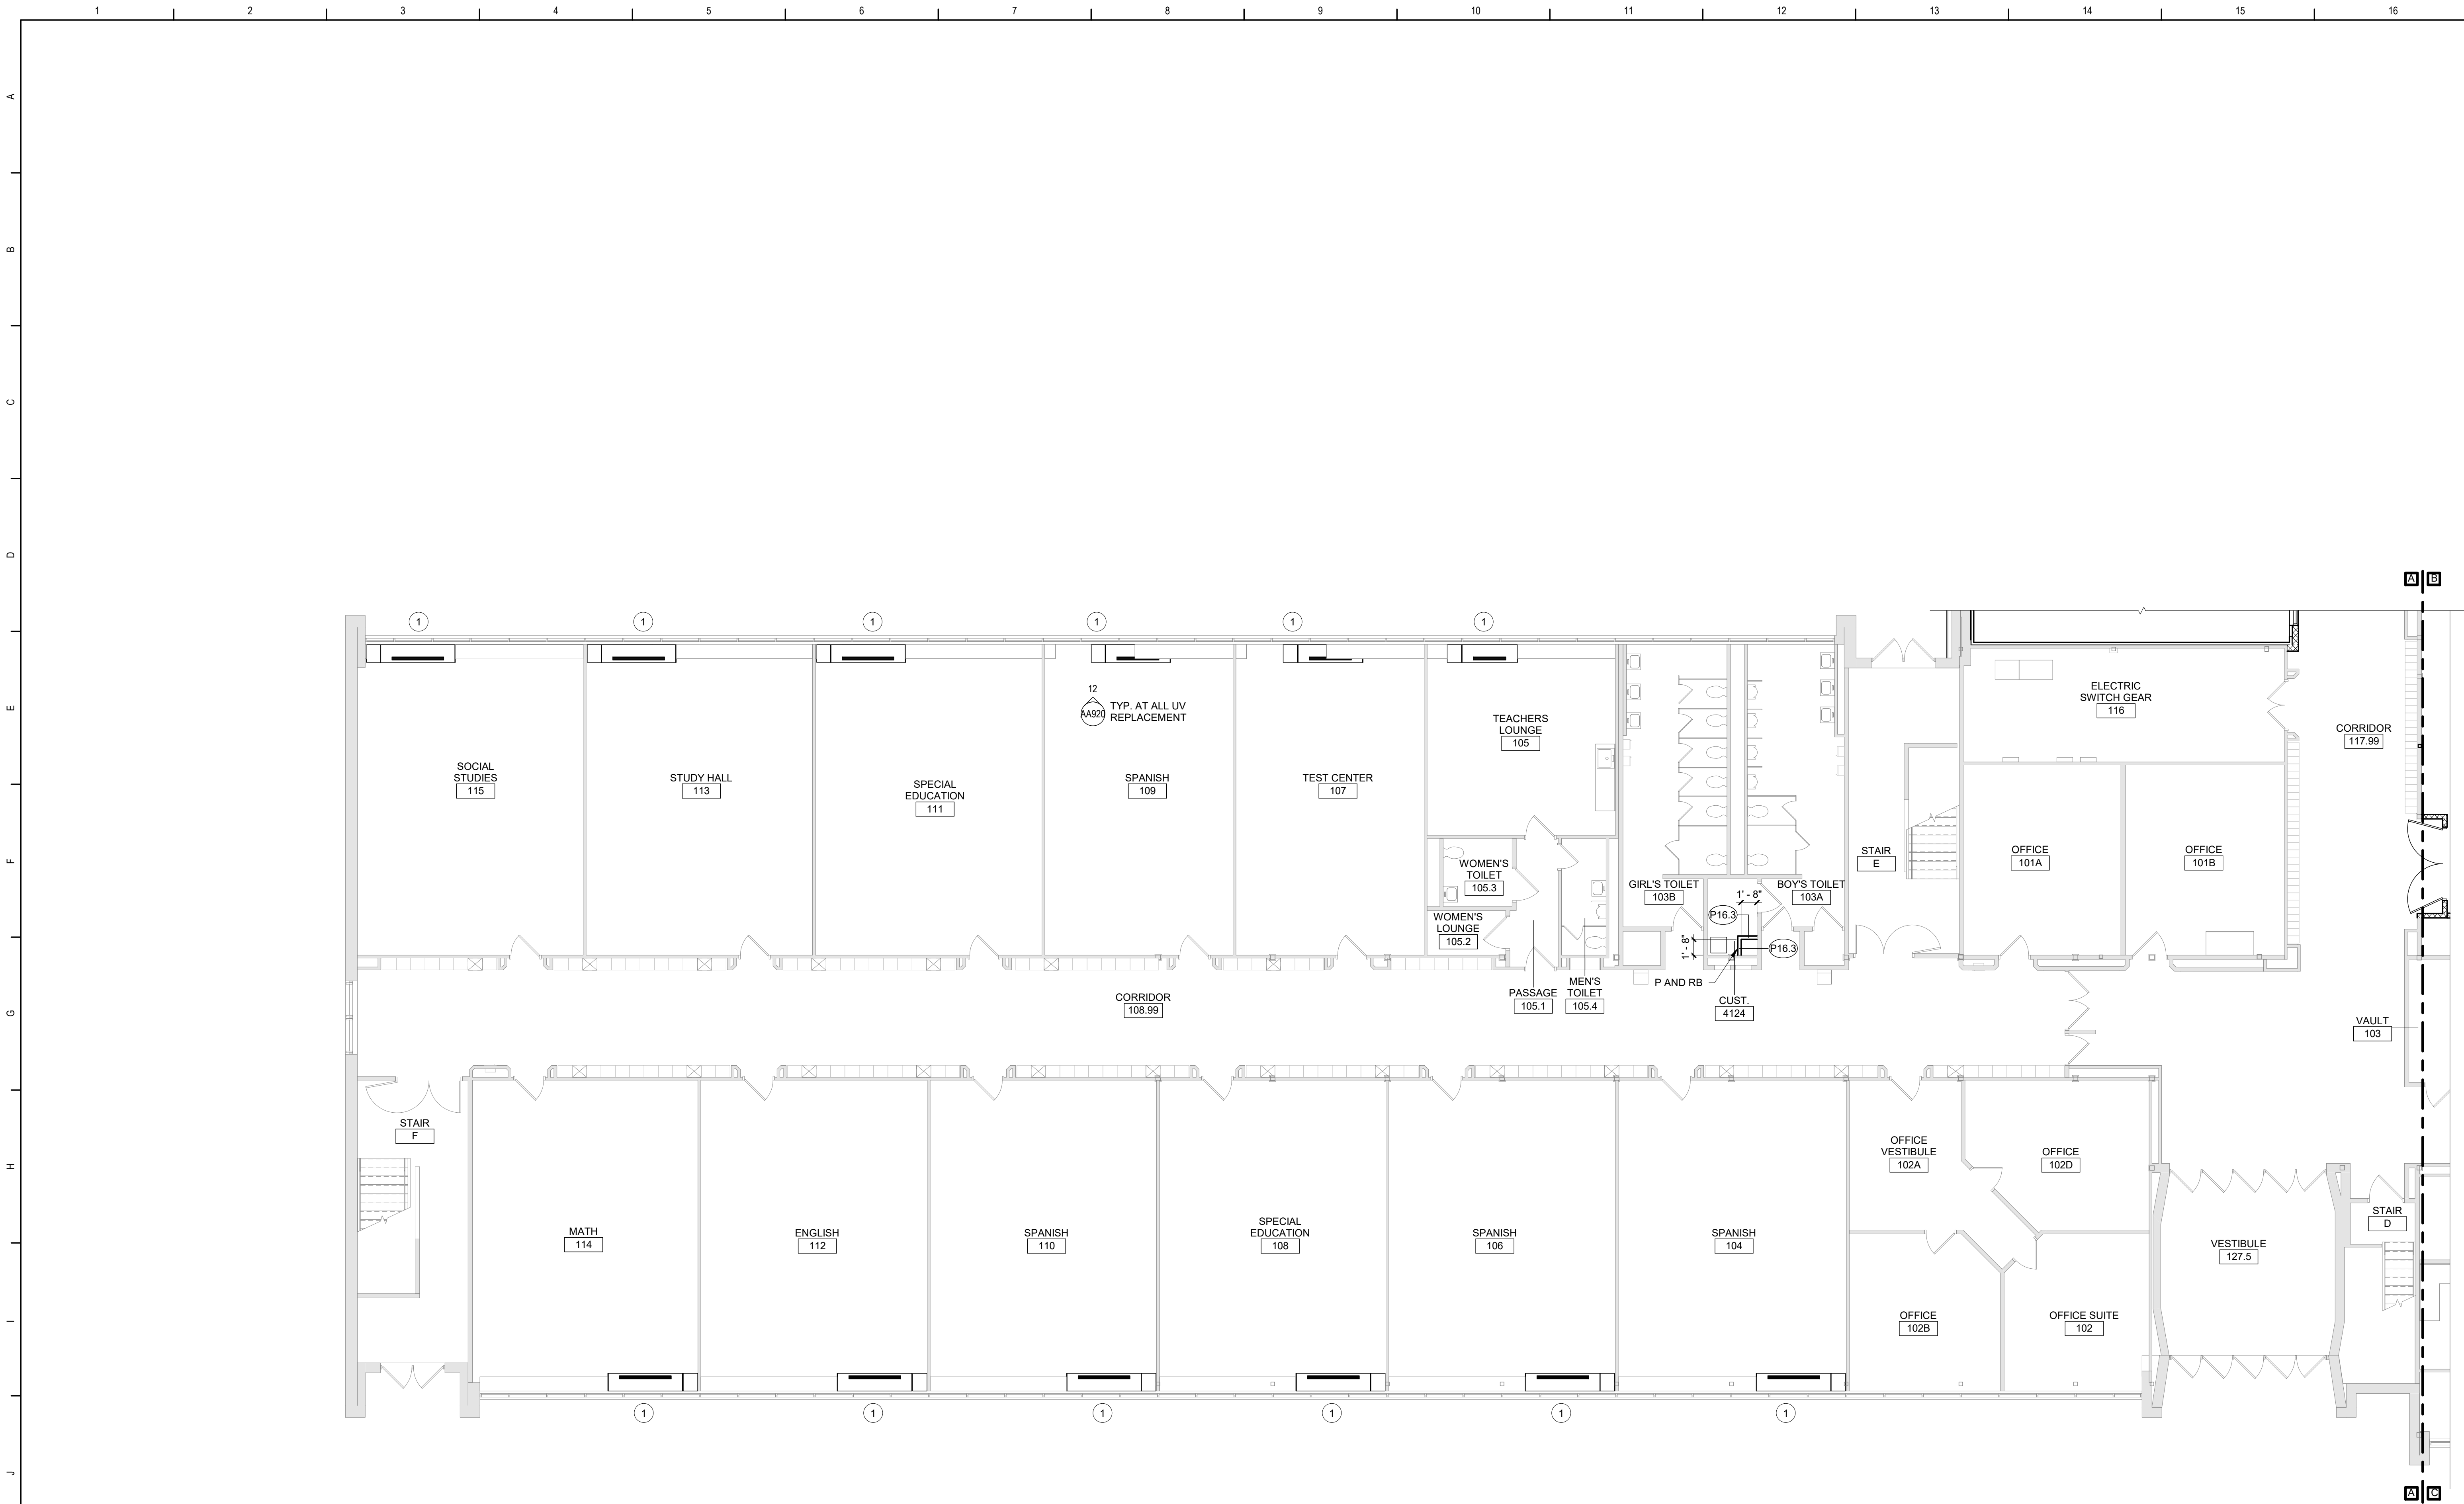


Waverly Central School District
Waverly, NY

Additions and Alterations to:
Waverly Jr. Sr. High School

First Floor Plan Partial Area A

Drawn By: KCB Date: 05/19/2023 Drawing Number:
Project No.: 339070-22003 AA130




1 First Floor Plan Partial Area A
1/8" = 1'-0"

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Key Plan
N.T.S.

SED Control No. 60-01-01-06-0-018-023

Rev. No.: Date: Description:

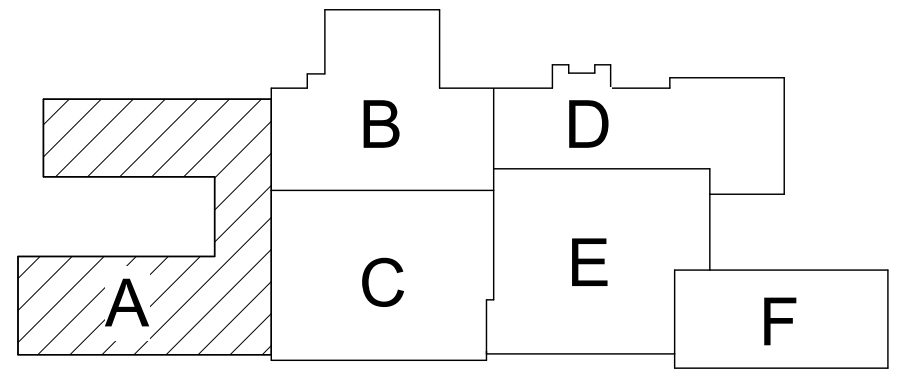

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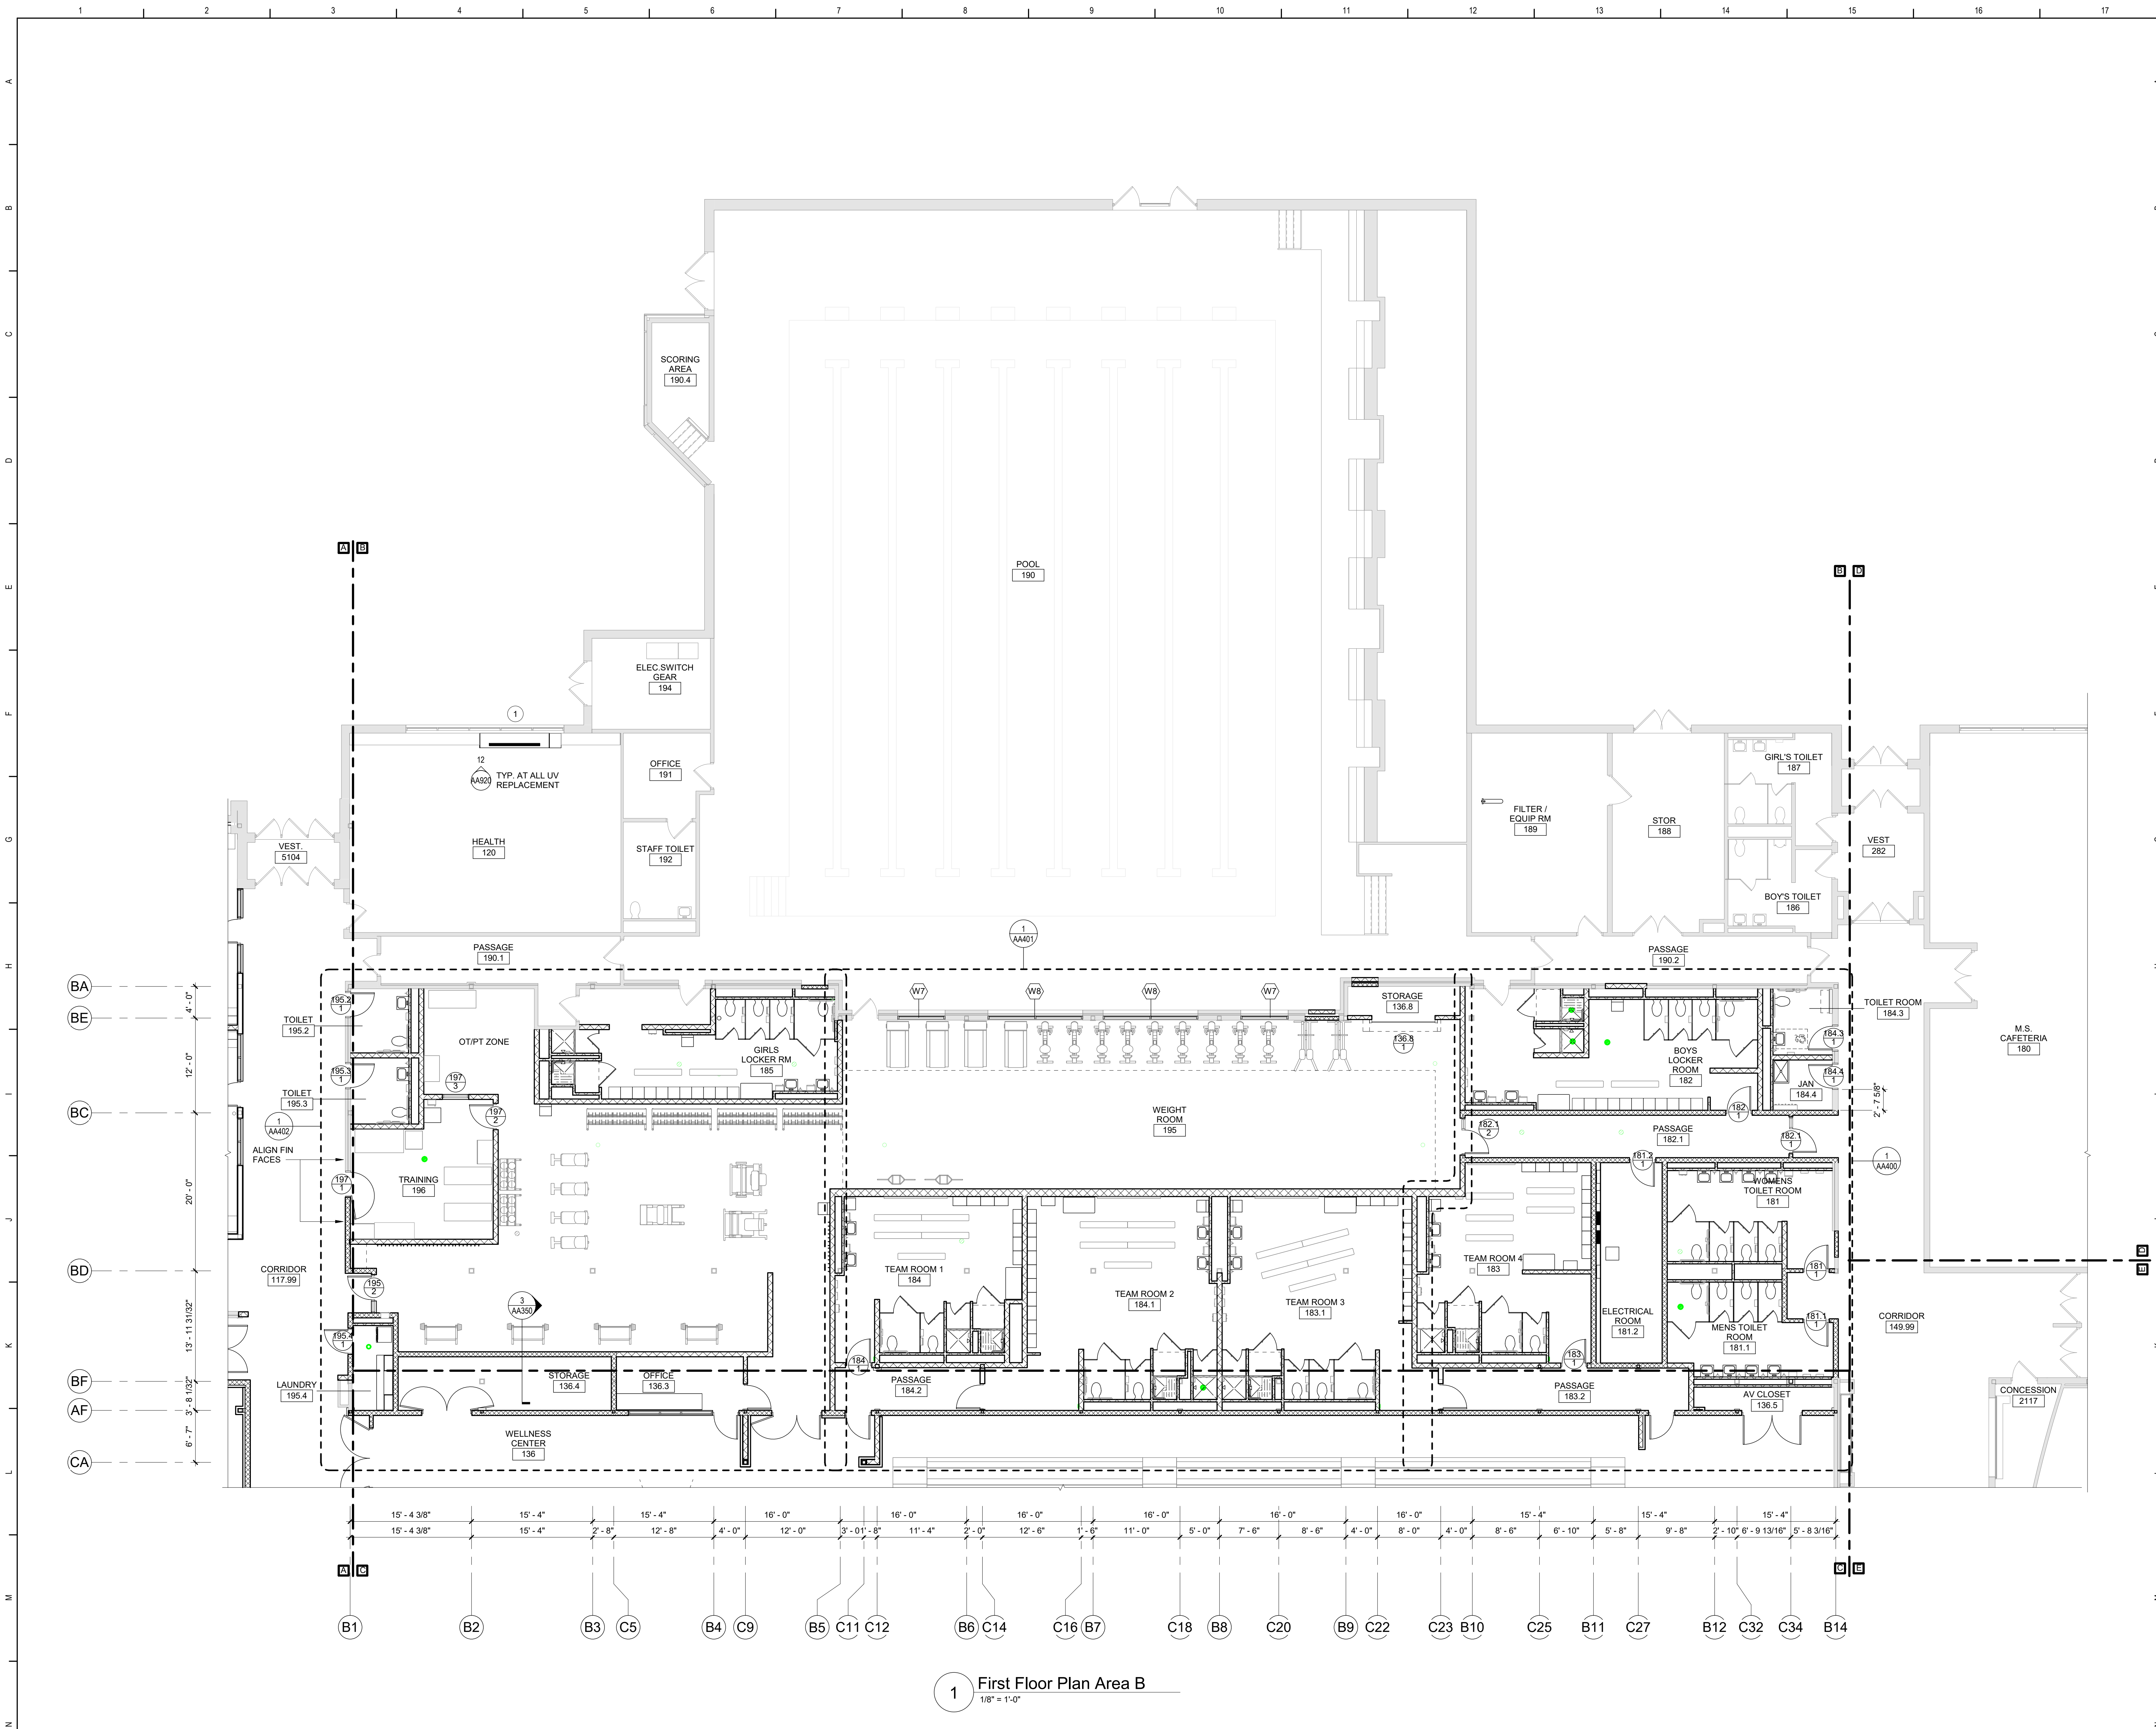


Waverly Central School District
Waverly, NY

Additions and Alterations to:
Waverly Jr. Sr. High School

First Floor Plan Partial Area A

Drawn By: KCB Date: 05/19/2023 Drawing Number:
Project No.: 339070-22003
AA131




1 First Floor Plan Area B
1/8" = 1'-0"

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Key Plan
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Waverly Central School District
Waverly, NY


Additions and Alterations to:
Waverly Jr. Sr. High School

First Floor Plan Area B


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Project No.: 339070-22003
AA132

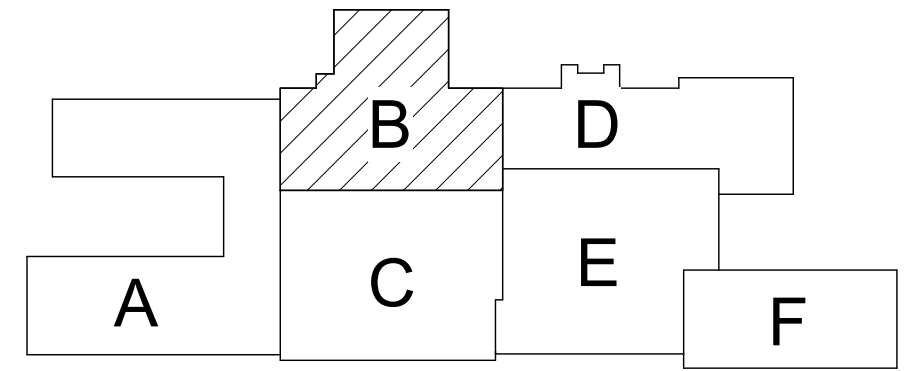


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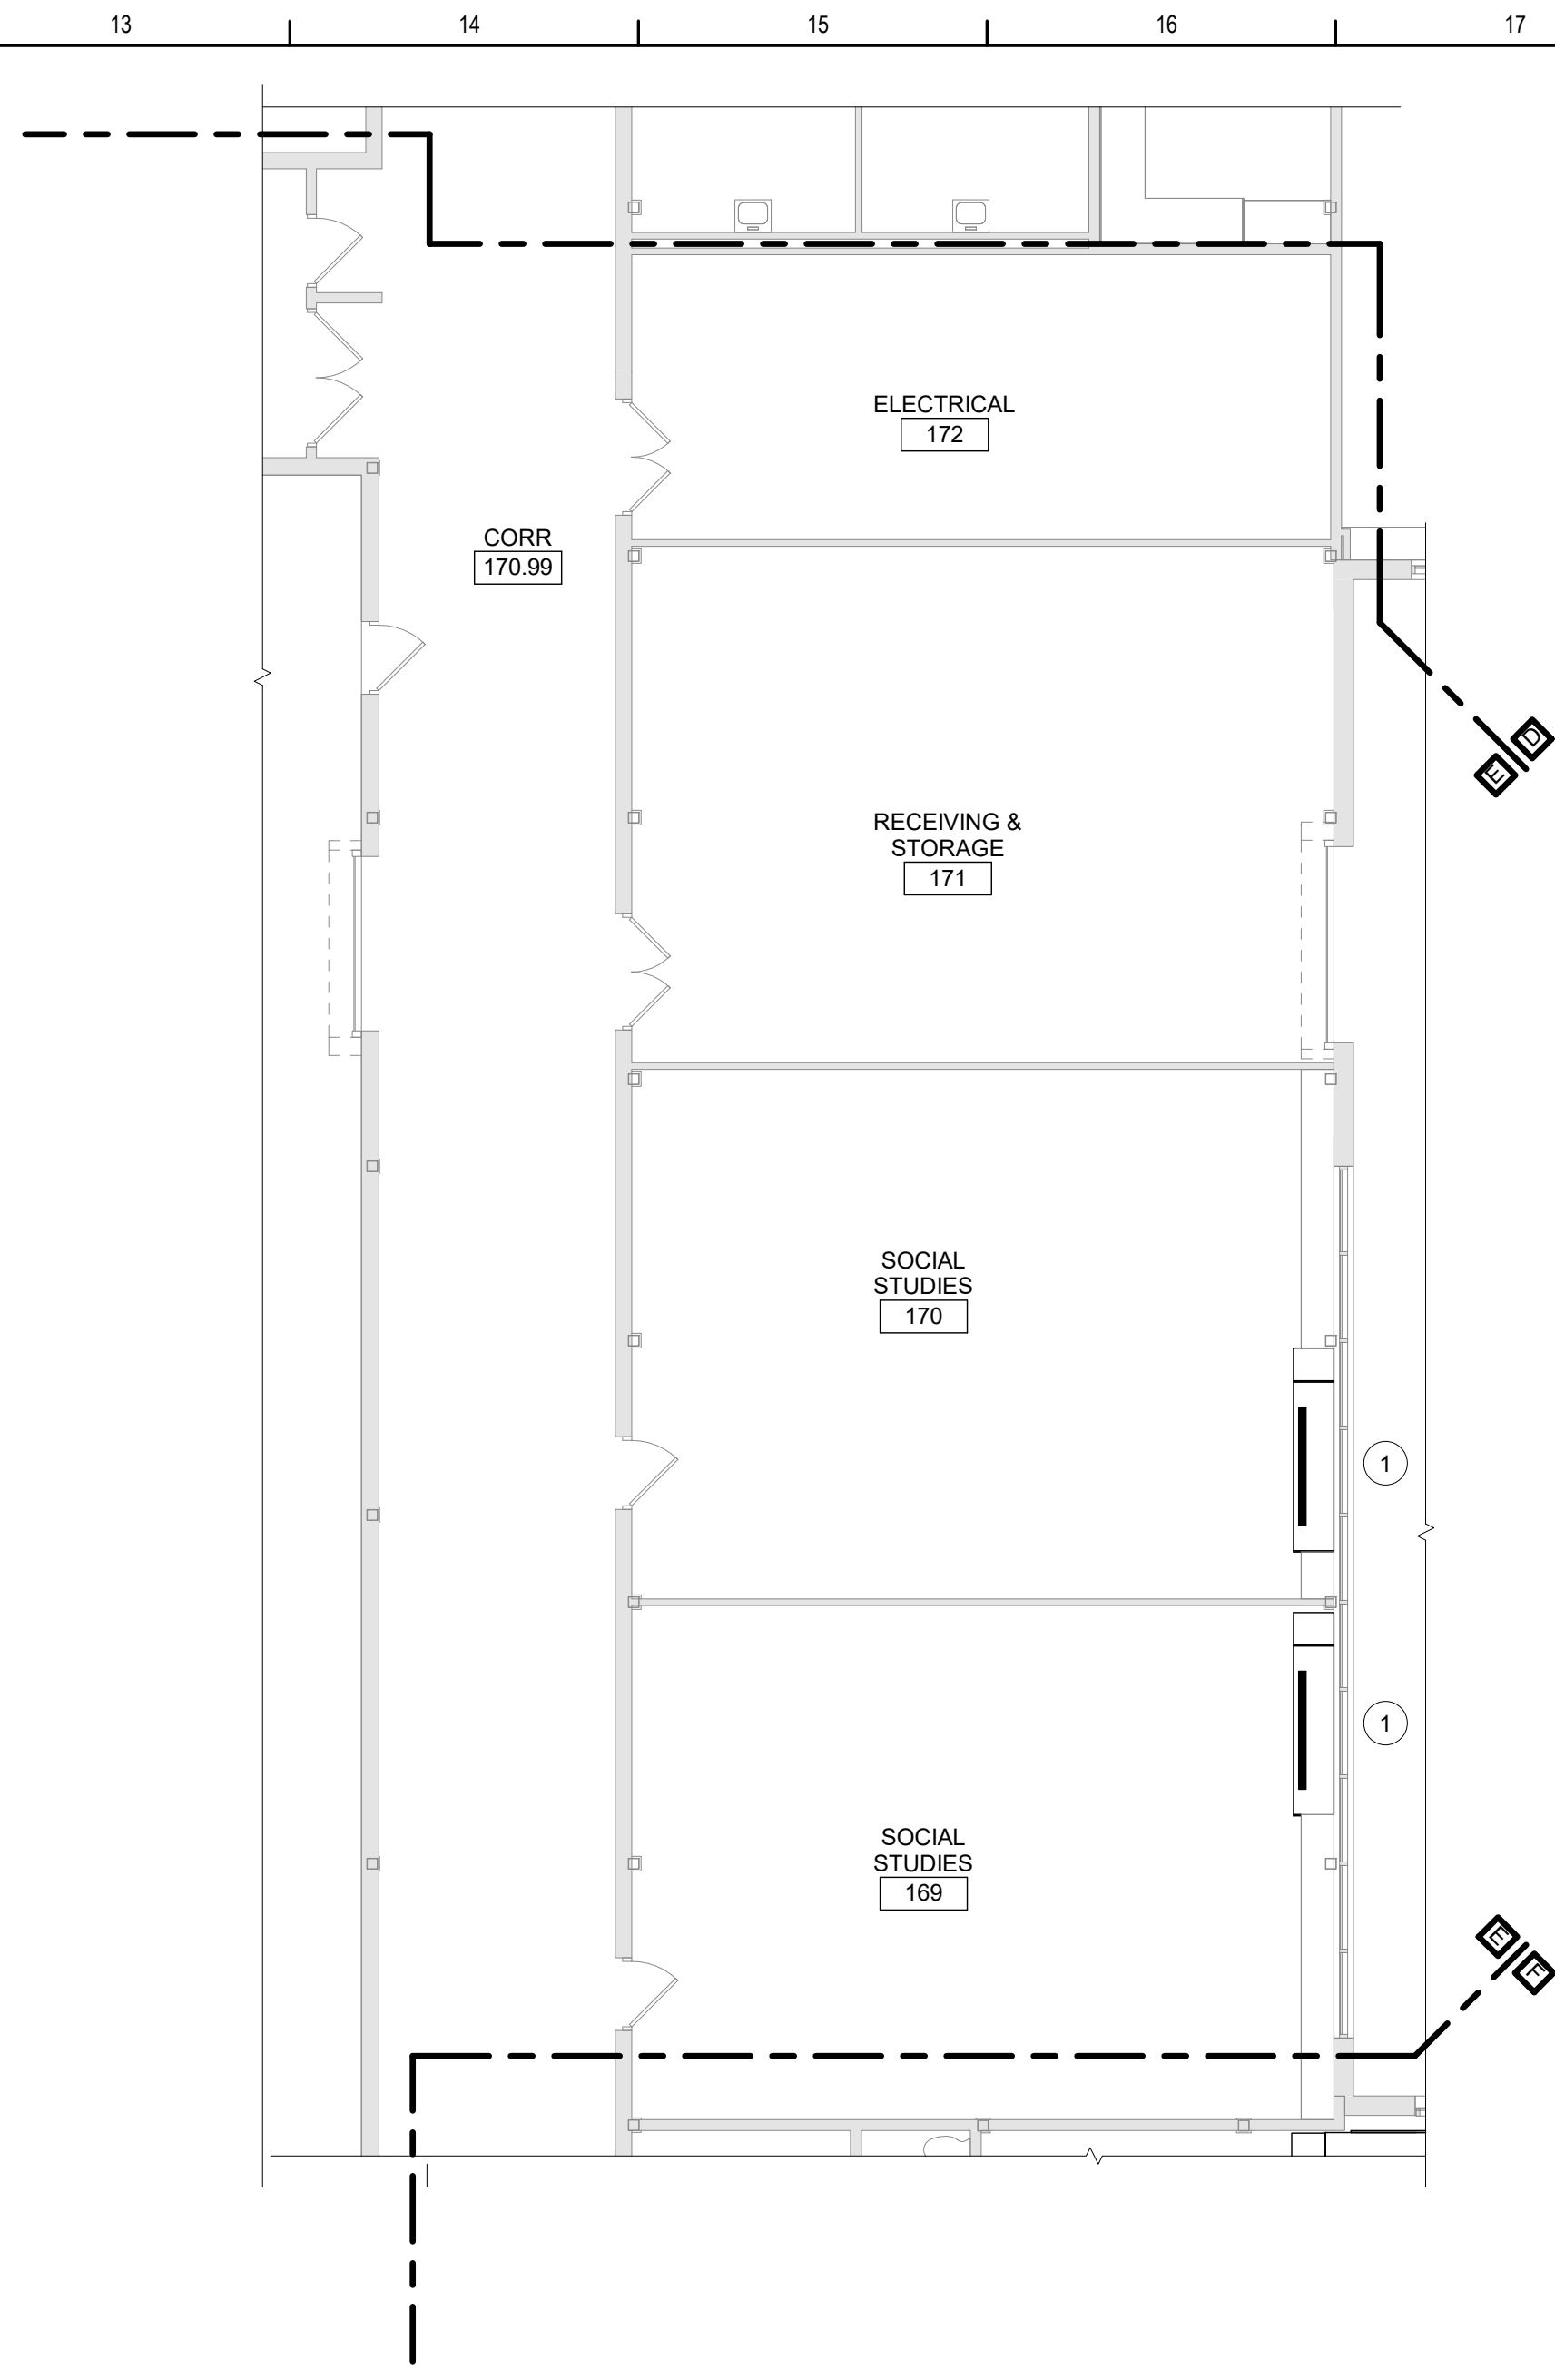
1 First Floor Plan Partial Area D
1/8" = 1'-0"

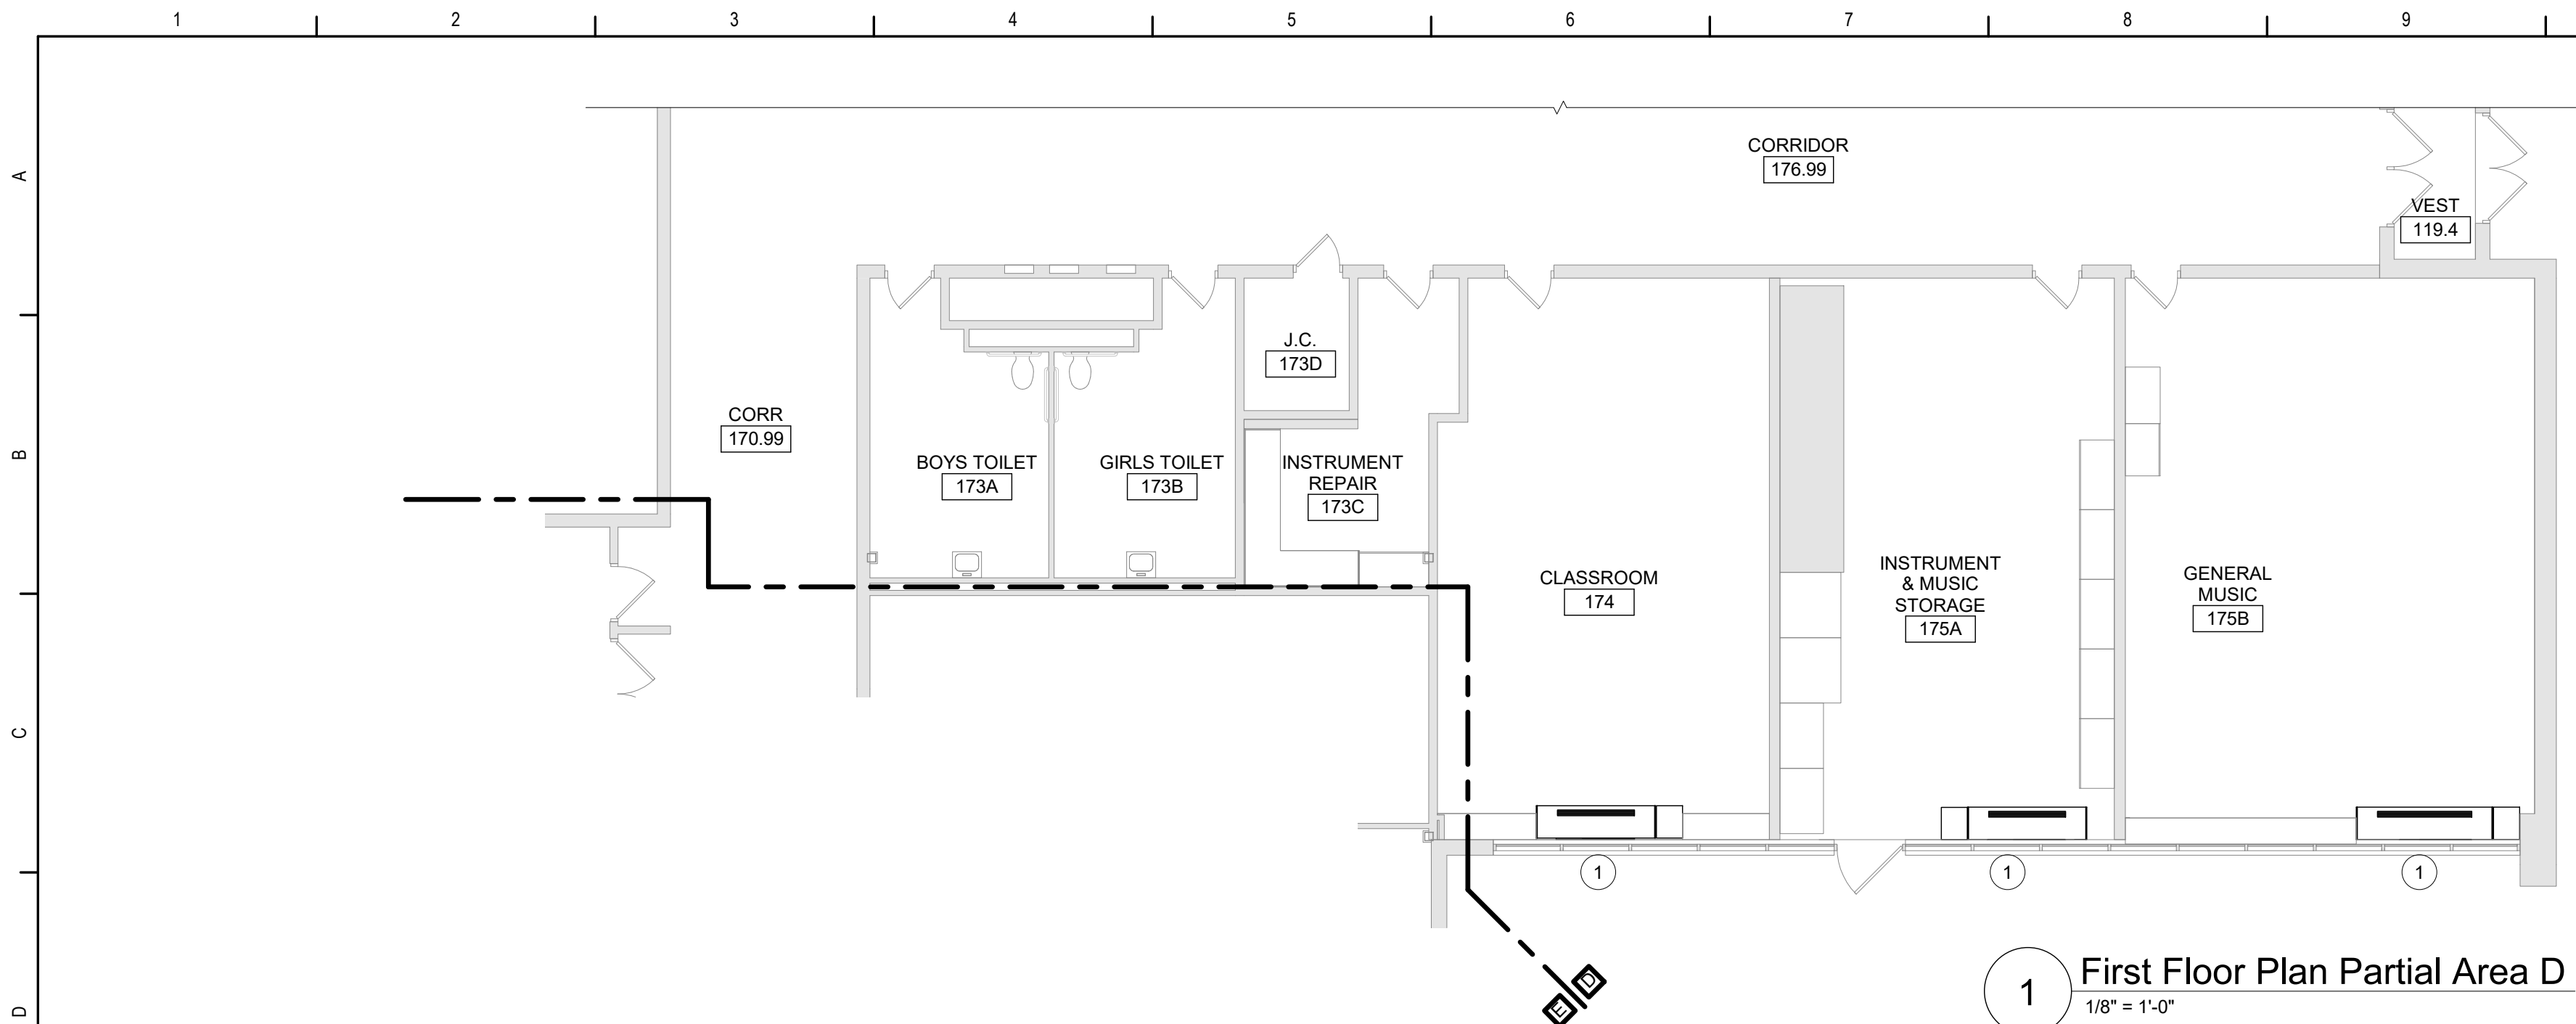

3 First Floor Plan Partial Area E
1/8" = 1'-0"

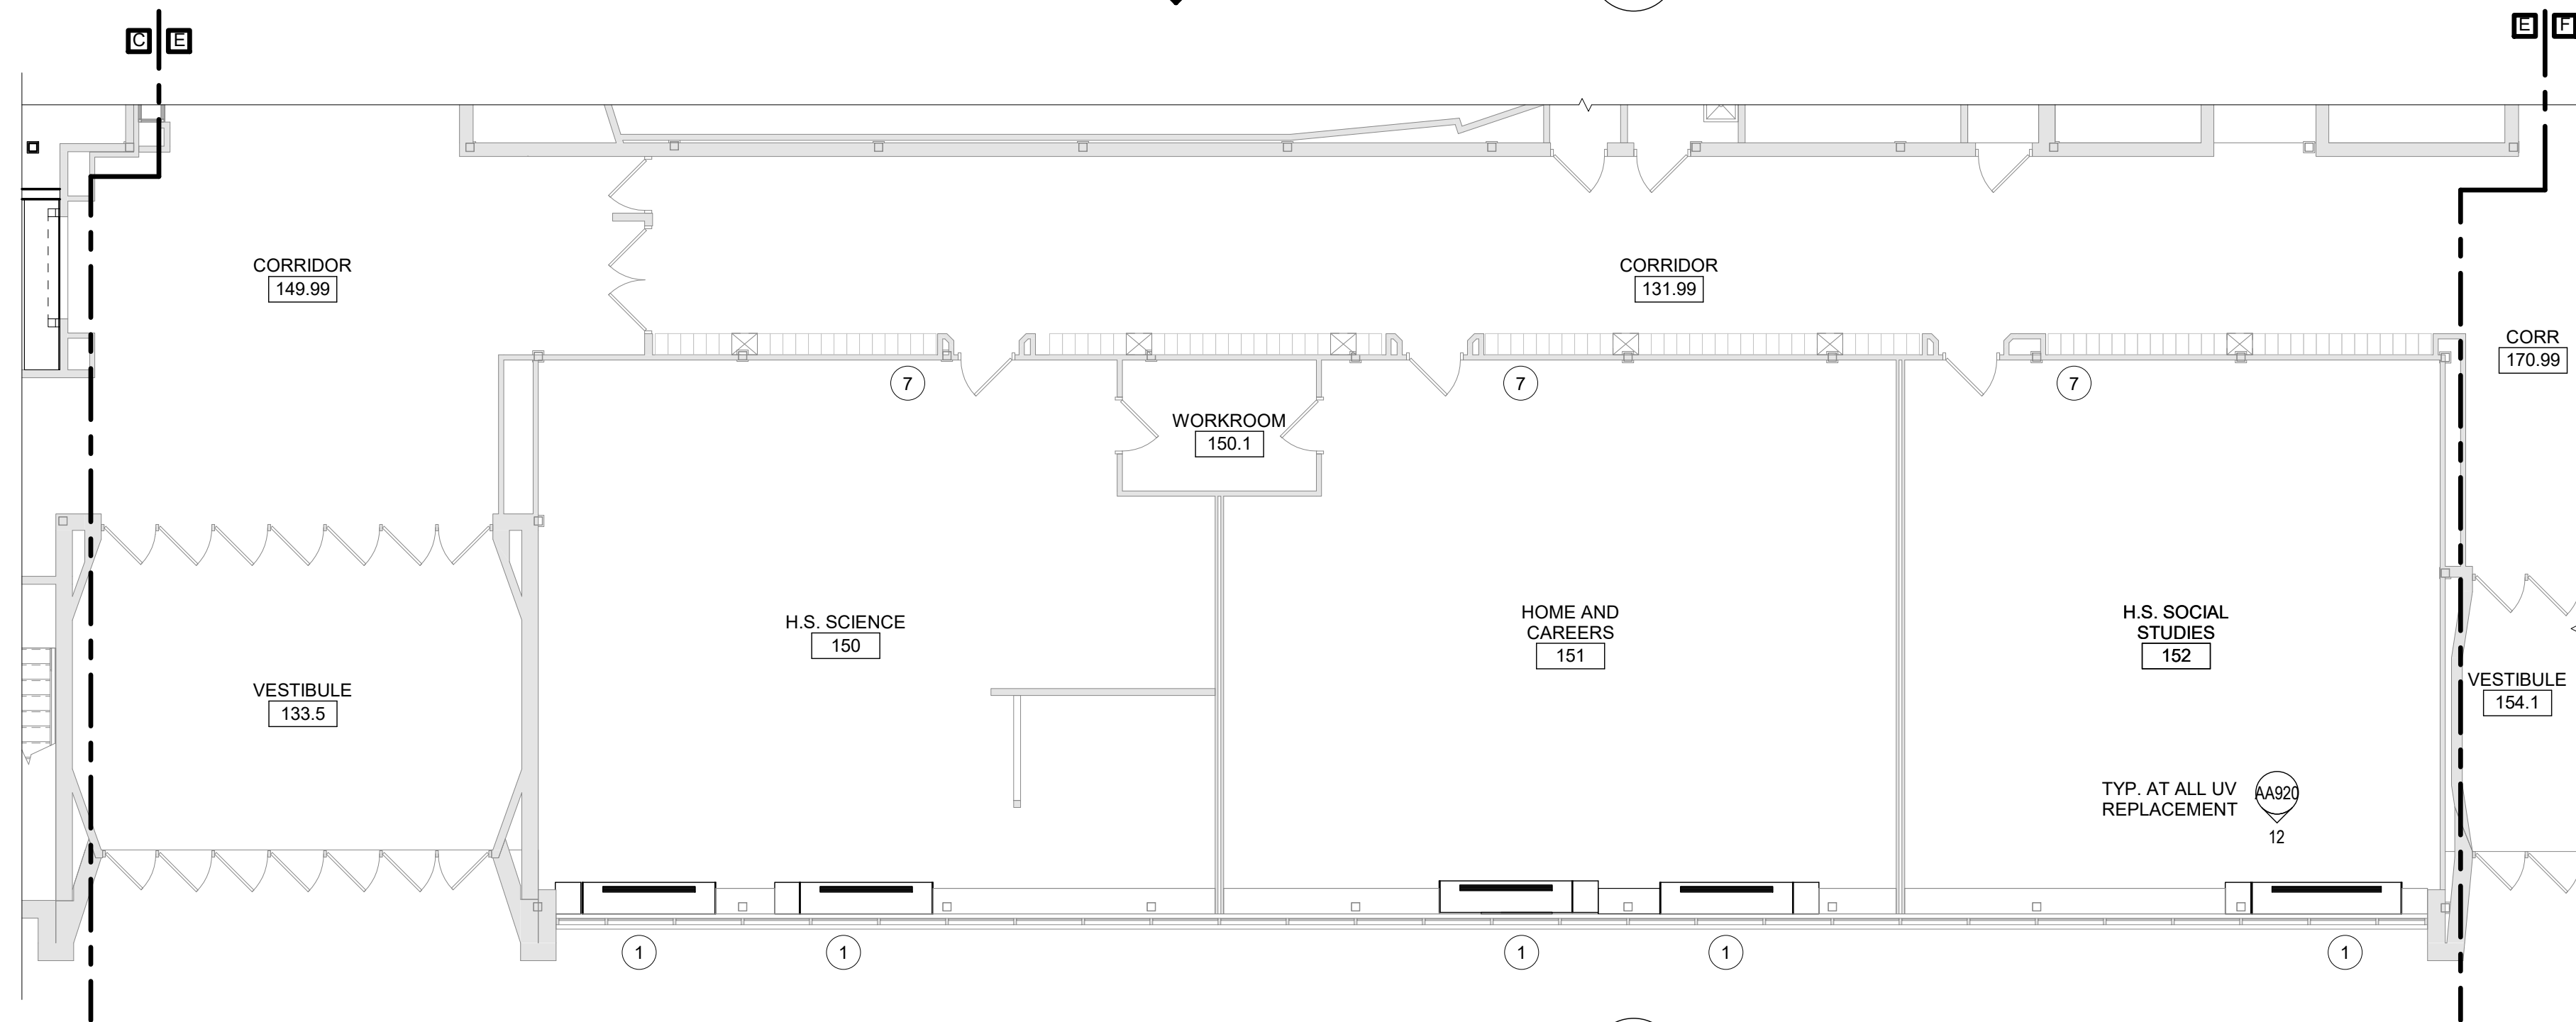

2 First Floor Plan Area F
1/8" = 1'-0"

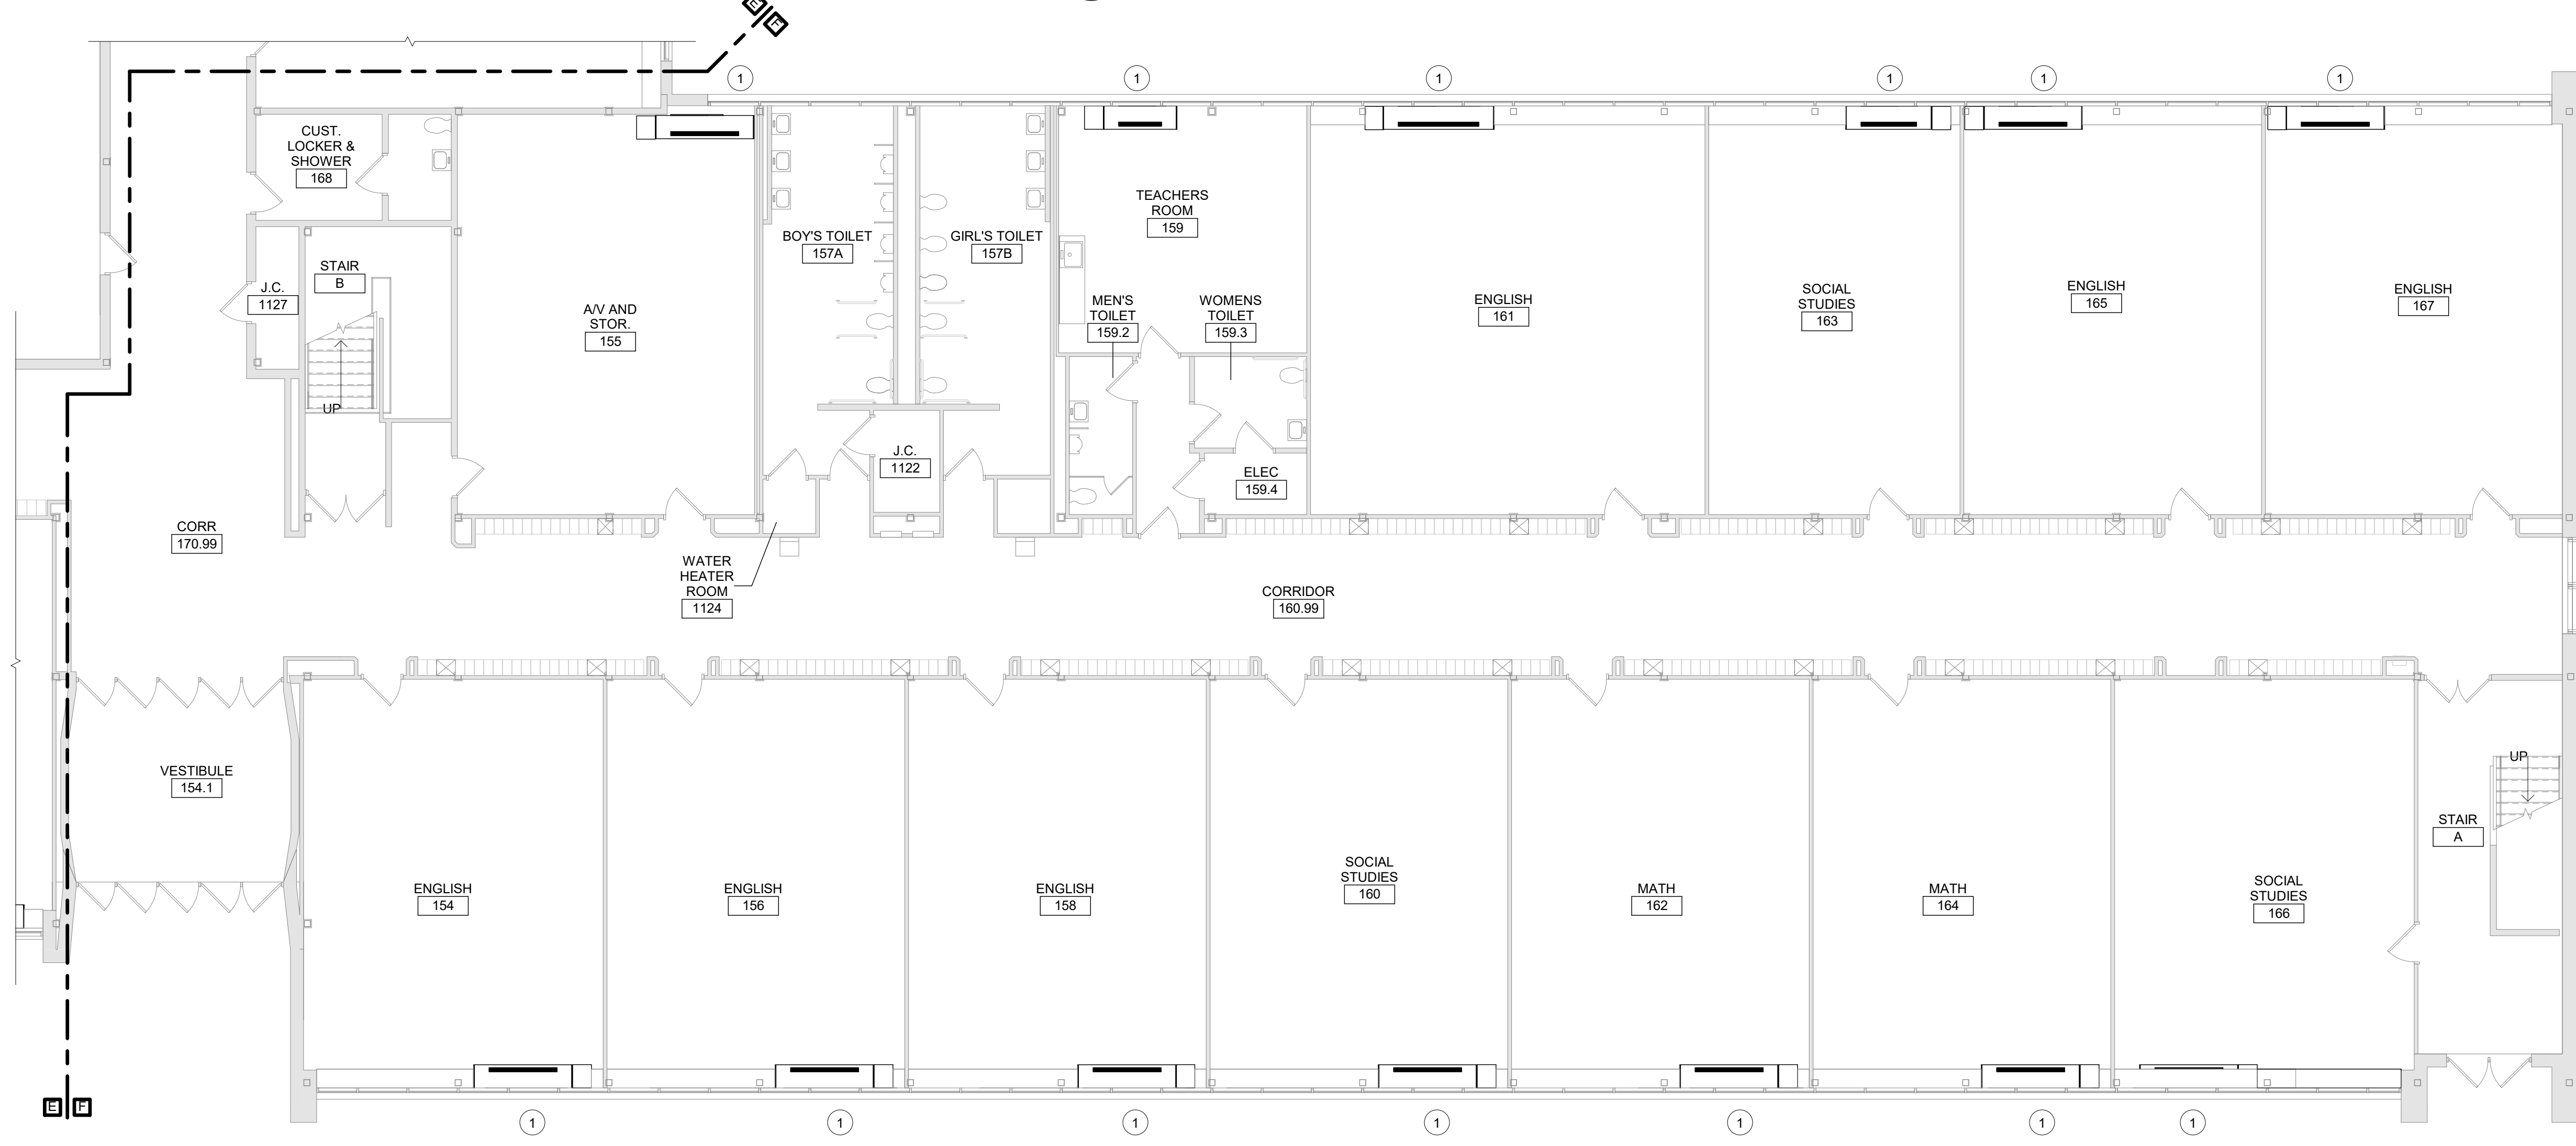


4 First Floor Plan Partial Area E
1/8" = 1'-0"

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Key Plan
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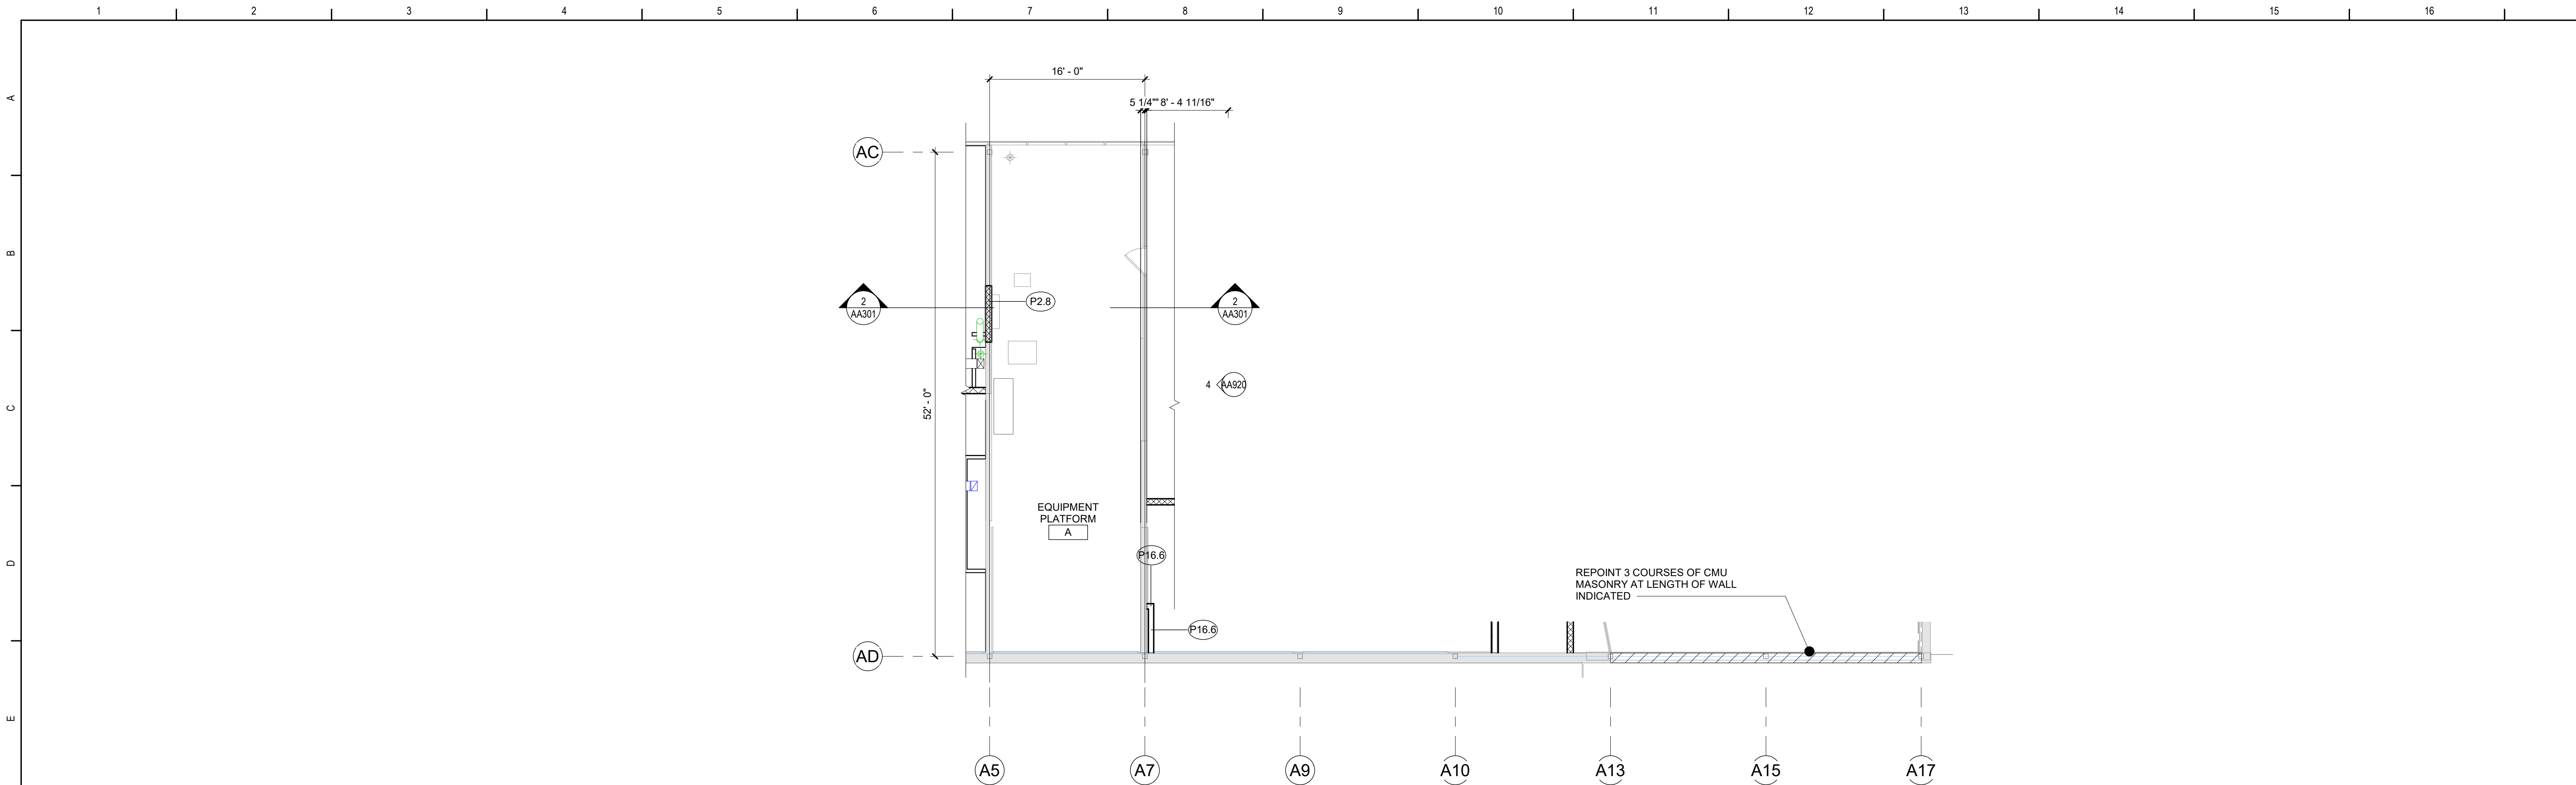


Waverly Central School District
Waverly, NY


Additions and Alterations to:
Waverly Jr. Sr. High School

First Floor Plan Partial Areas D and E
and First Floor Plan Area F

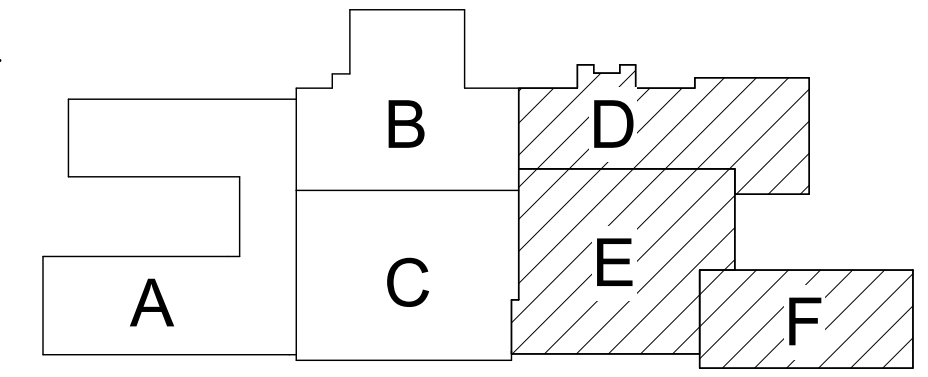Drawn By: KCB Date: 05/19/2023 Drawing Number:
Project No.: 339070-22003
AA134



2 Equipment Platform Area A
1/8" = 1'-0"

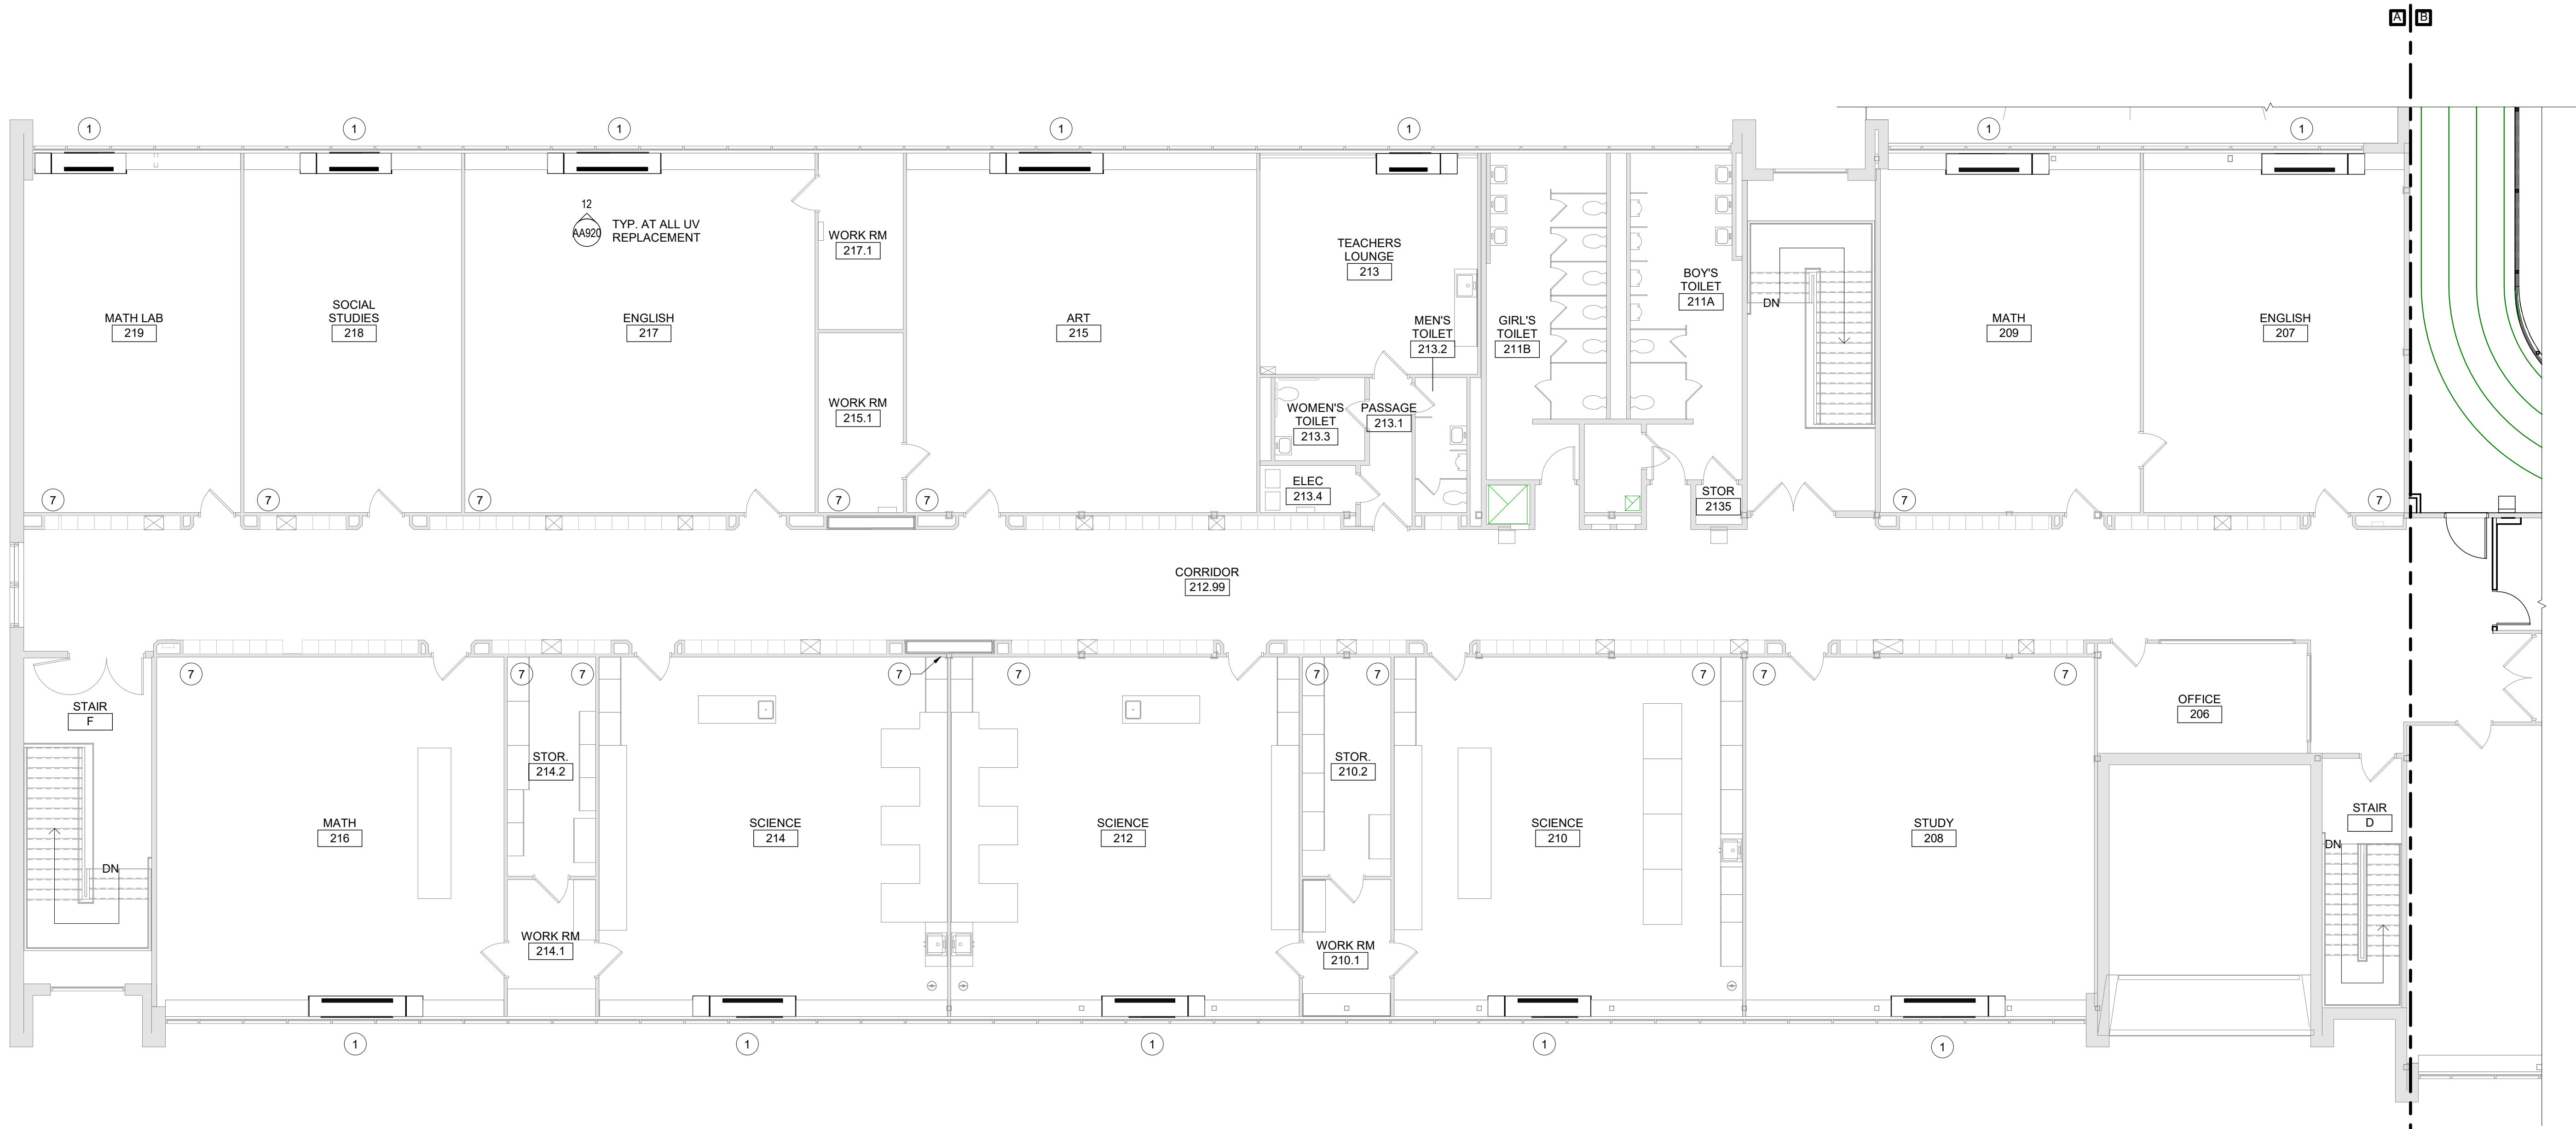


1 Second Floor Plan Area A
1/8" = 1'-0"

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Key Plan
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SED Control No. 60-01-01-06-0-018-023

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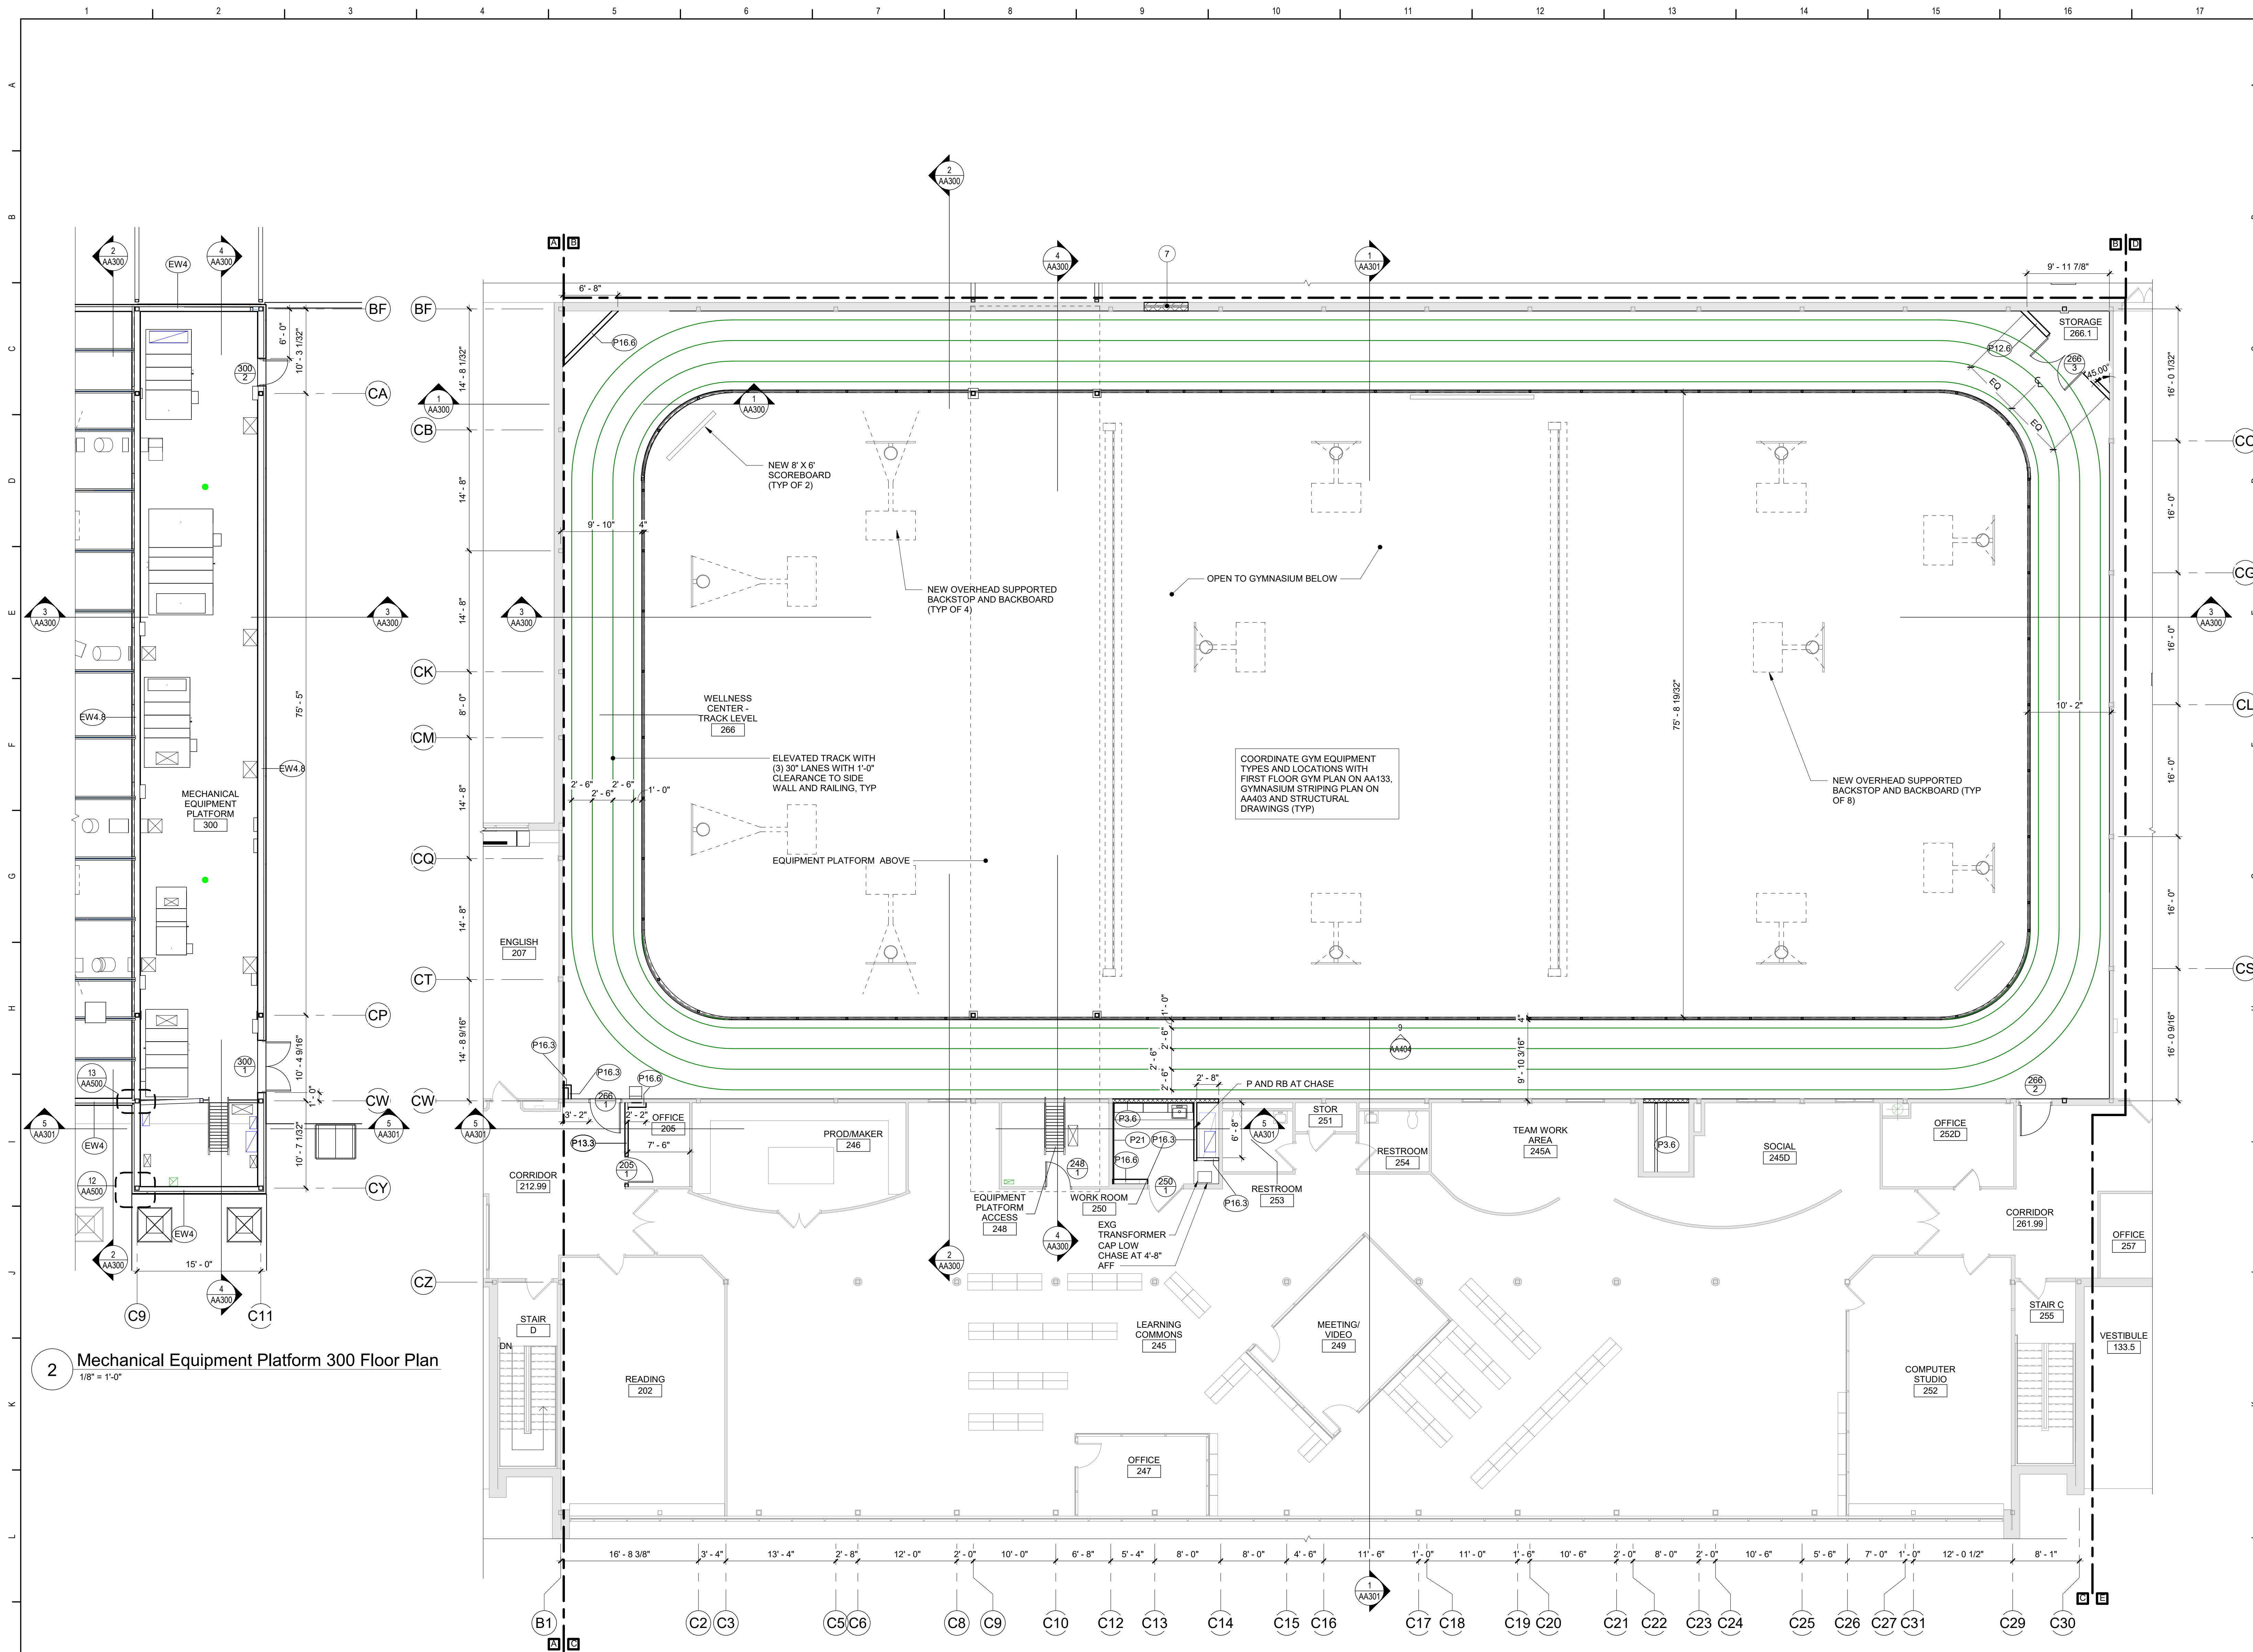


Waverly Central School District
Waverly, NY

Additions and Alterations to:
Waverly Jr. Sr. High School

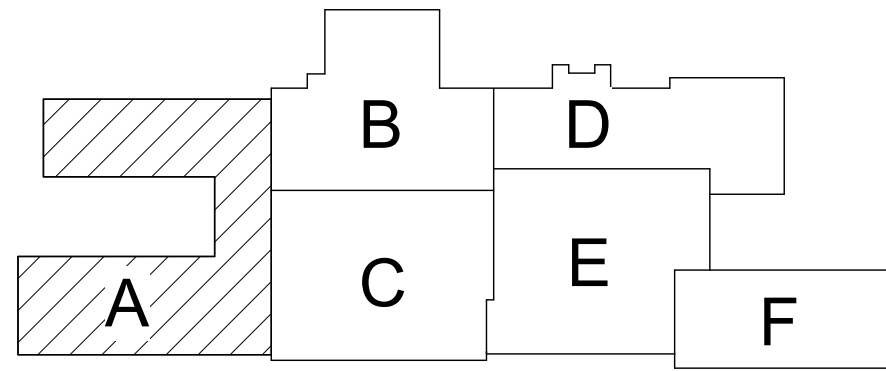
Second Floor Area A

Drawn By: KCB	Date: 05/19/2023	Drawing Number: AA135
Project No.: 339070-22003		



- General Plan Notes**
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Key Plan
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SED Control No. 60-01-01-06-0-018-023

Rev. No.	Date	Description

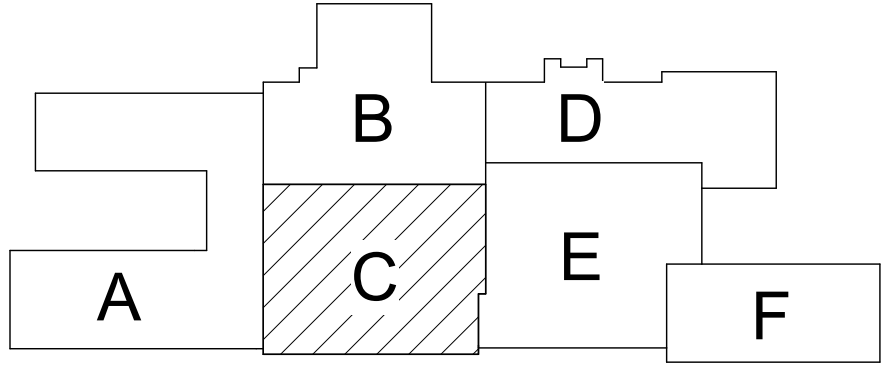

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BID SET




Waverly Central School District
Waverly, NY

Additions and Alterations to:
Waverly Jr. Sr. High School

Second Floor Area C and Mechanical
Equipment Platform 300 Floor Plans

Drawn By: KCB	Date: 05/19/2023	Drawing Number: AA136
Project No.: 339070-22003		

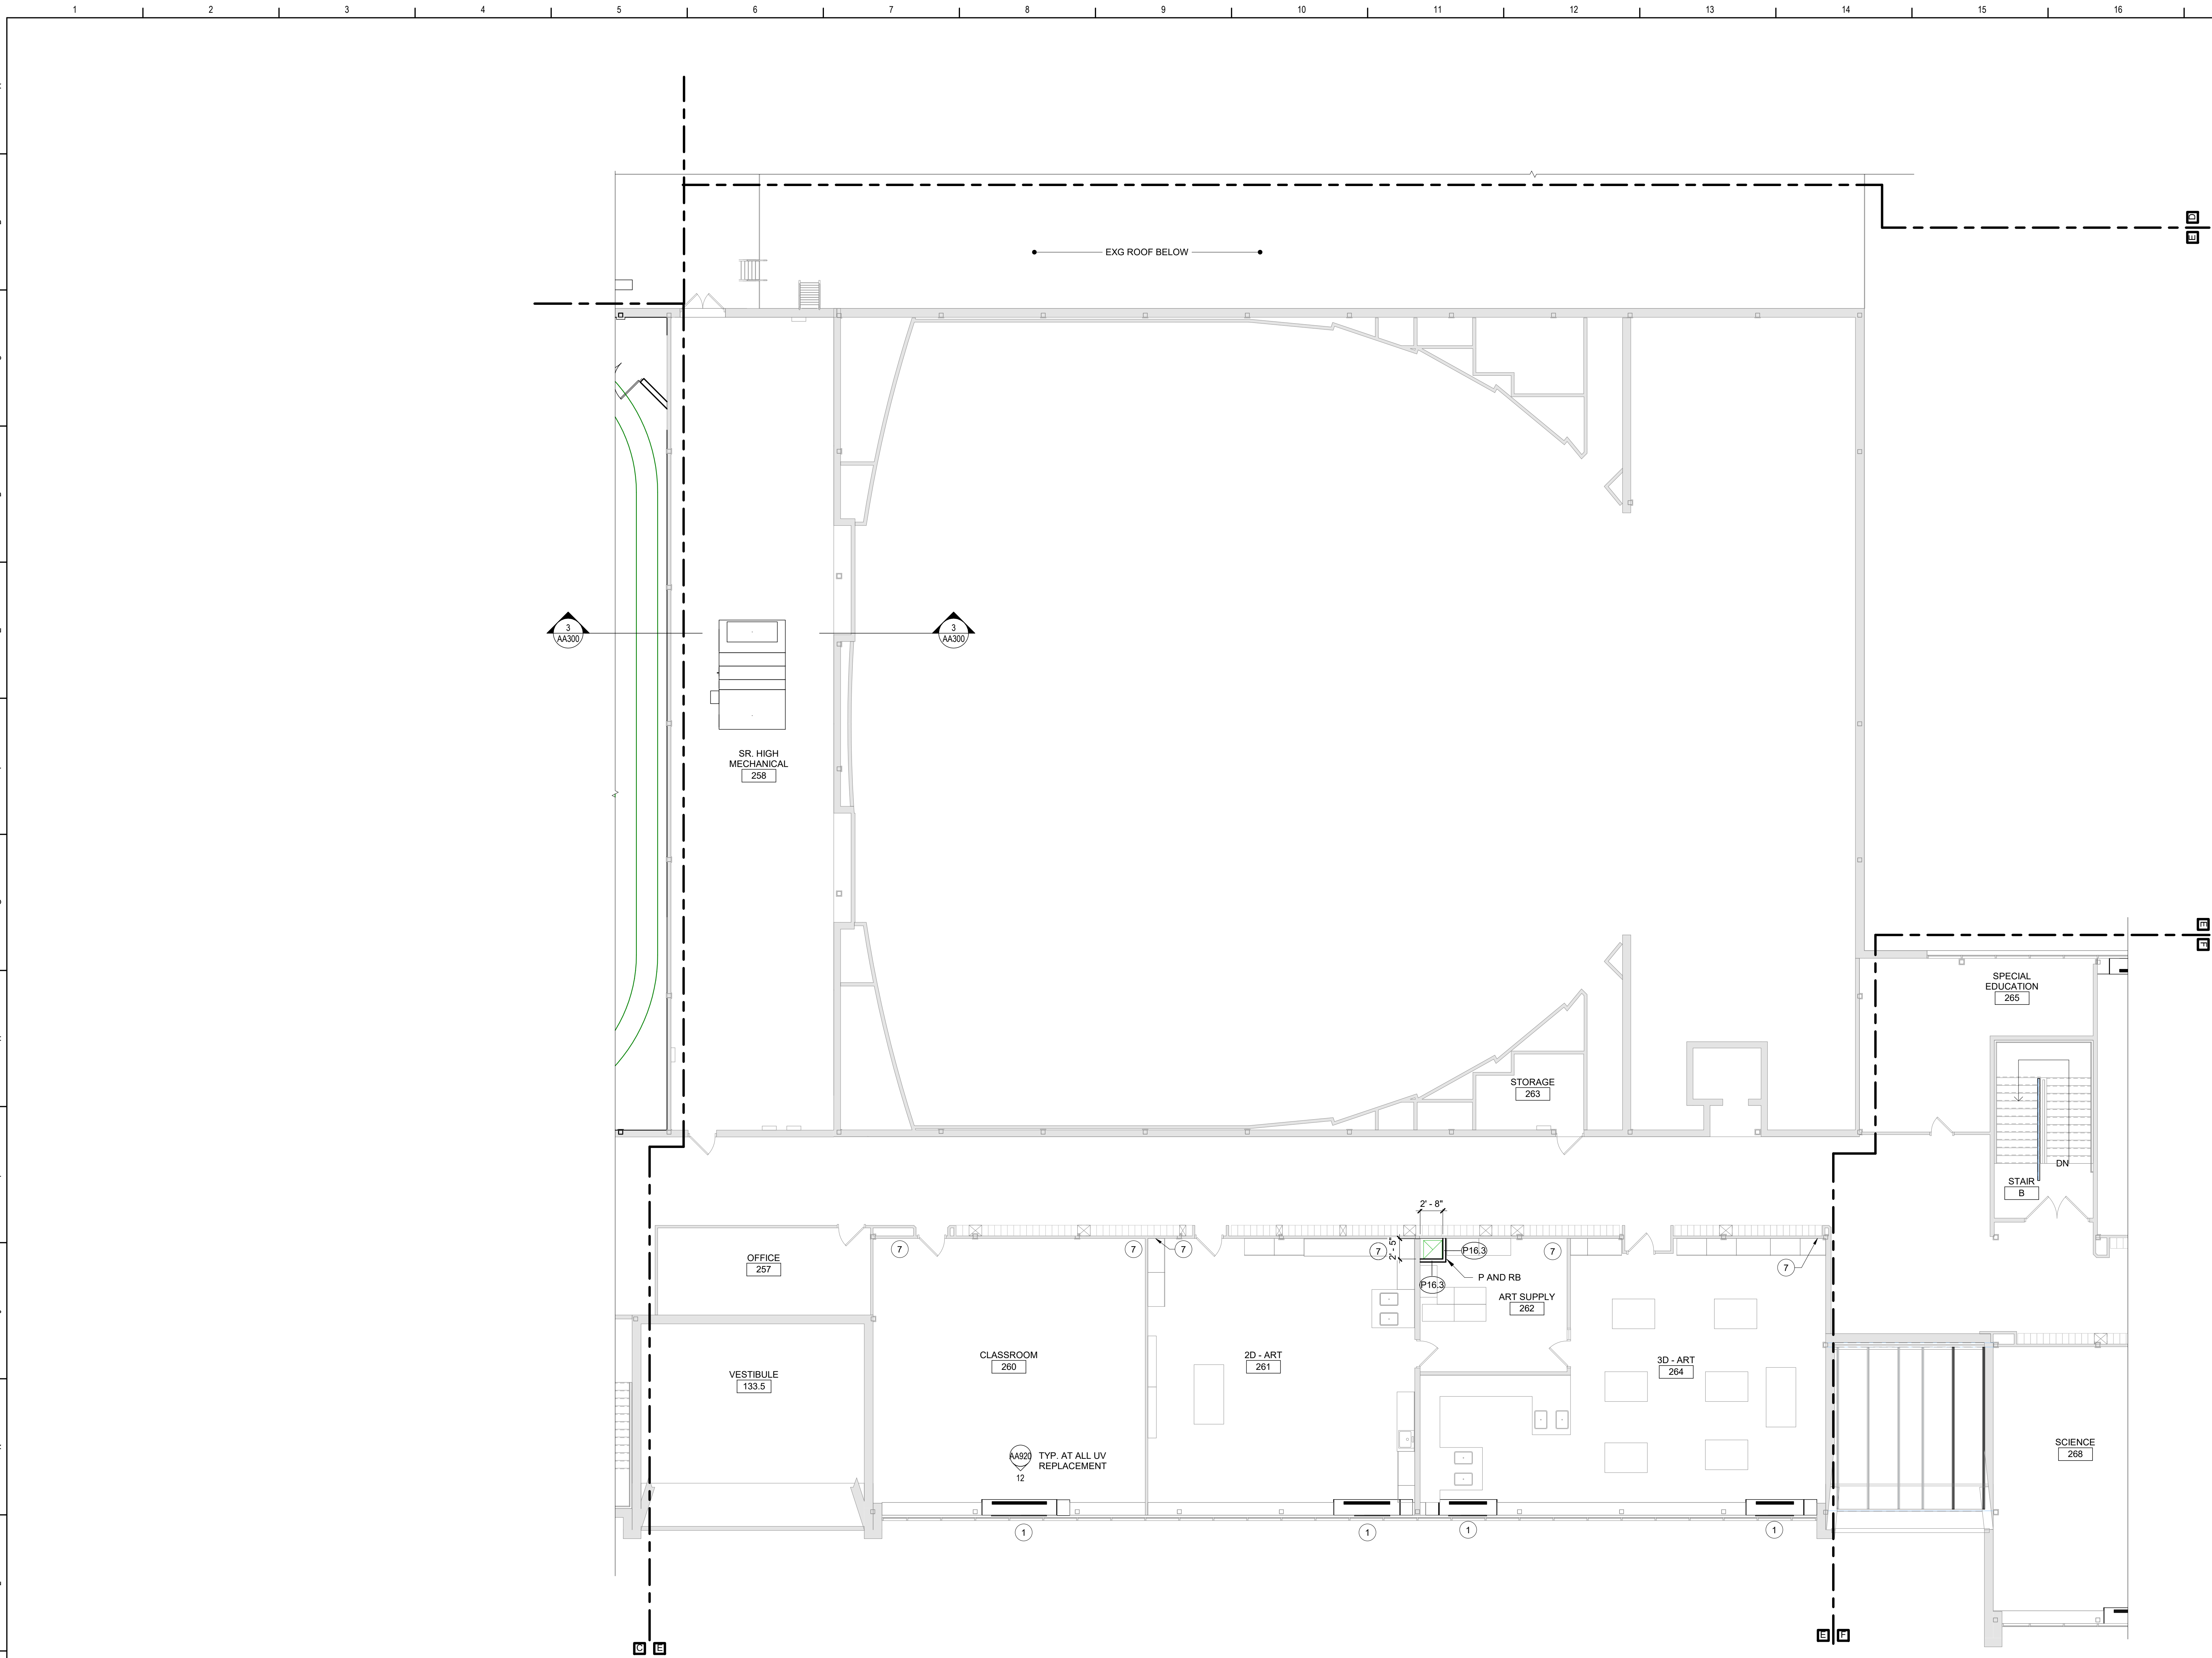


1 Second Floor Plan Area E
1/8" = 1'-0"

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Key Plan
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Rev. No.:	Date:	Description:



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Waverly Central School District
Waverly, NY

Additions and Alterations to:
Waverly Jr. Sr. High School

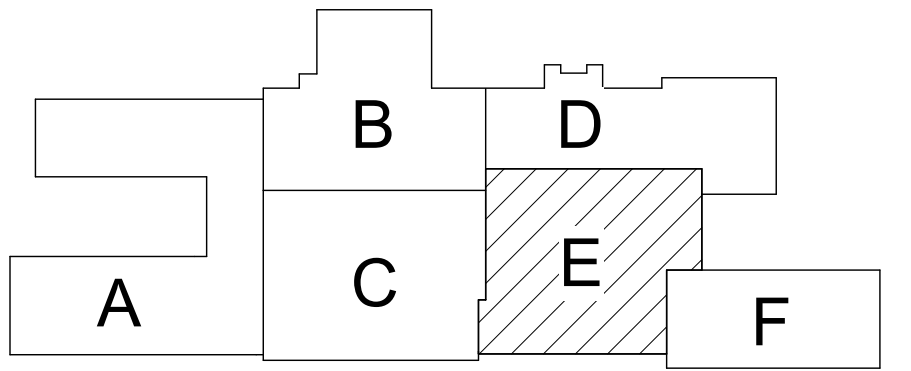Second Floor Plan Area E

Drawn By: KCB	Date: 05/19/2023	Drawing Number: AA137
Project No.: 339070-22003		



- ## Keyed Plan Notes
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 - 12 PROVIDE NEW FIRE EXTINGUISHER AND CABINET.





<p> III </p> <p> Additions and Alterations to: Waverly Jr. Sr. High School </p>

Drawn By: KCB	Date: 05/19/2023	Drawing Number: <div style="font-size: 2em; font-weight: bold;">AA138</div>
Project No.: 339070-22003		



1 First Floor Reflected Ceiling Plan Area B
1/8" = 1'-0"

General Ceiling Notes

A. LIGHTING AND OTHER CEILING-MOUNTED FIXTURES ARE SHOWN FOR DRAWING CLARITY. COORDINATE ALL CEILING WORK PRIOR TO INSTALLATION OF CEILING GRID.

B. CEILING HEIGHT IS 9'-0" ABOVE FINISHED FLOOR (UNO).

C. CENTER CEILING-MOUNTED ITEMS (LIGHTS, GRILLES, DETECTORS, SPRINKLER HEAD, ETC) WITHIN THE CEILING PANELS AND GRIDS UNLESS THE PANELS ARE SCORED, CENTER ITEMS WITHIN THE PATTERN OF SCORED PANELS.

D. PAINT ALL NEW EXPOSED LINTELS.

E. PROVIDE CONTROL JOINTS IN GYPSUM BOARD CEILINGS AND SOFFITS AS DETAILED ON DRAWINGS (MAXIMUM 20'-0" OC, EVENLY SPACED, TYP UNO).

F. PATCH CEILING SYSTEMS TO REMAIN THAT HAVE BEEN DISTURBED BY SCHEDULED WORK TO MATCH ADJACENT CONSTRUCTION PRIOR TO PAINTING.

G. X 9'-0" DESIGNATES BOTTOM OF CEILING ABOVE FINISHED FLOOR AT THAT POINT UNO. DESIGNATION "ME" INDICATES MATCH EXISTING CEILING HEIGHT.

H. USE MOLD-RESISTANT GYPSUM BOARD FOR GYPSUM CEILINGS IN TEAM ROOMS AND TOILET ROOMS.

Ceiling Types

A1 X-X" ACOUSTIC PANEL CEILING

A2 X-X" ACOUSTIC PANEL CEILING

A3 X-X" METAL MESH CEILING PANELS

B X-X" PAINTED 1/2" GYPSUM CEILING ON SUPPORT MATERIALS (GRID SUSPENSION SYSTEM, TYP UNO)

F X-X" PAINTED EXPOSED STRUCTURAL SYSTEM, SUPPORT MATERIALS AND FASTENERS, MECHANICAL SYSTEM, ELECTRICAL ITEMS AND PIPING

G X-X" UNPAINTED EXPOSED STRUCTURAL SYSTEM, SUPPORT MATERIALS AND FASTENERS, MECHANICAL SYSTEM, ELECTRICAL ITEMS AND PIPING

Key Plan

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SED Control No. 60-01-01-06-0-018-023

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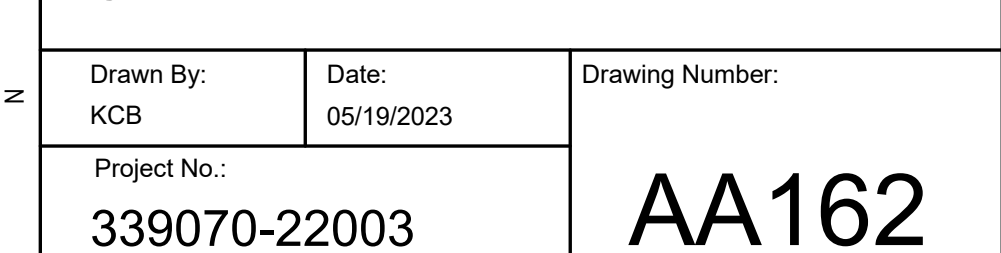
TETRA TECH
ARCHITECTS & ENGINEERS

Waverly Central School District
Waverly, NY

Additions and Alterations to:
Waverly Jr. Sr. High School

First Floor Reflected Ceiling Plan Area B

Drawn By: KCB	Date: 05/19/2023	Drawing Number: AA161
Project No.: 339070-22003		



1 First Floor Reflected Ceiling Plan Area C
1/8" = 1'-0"



2 Mechanical Room 300 Reflected Ceiling Plan
1/8" = 1'-0"


1 Second Floor Reflected Ceiling Plan Area C
1/8" = 1'-0"

General Ceiling Notes

- A. LIGHTING AND OTHER CEILING-MOUNTED FIXTURES ARE SHOWN FOR DRAWING CLARITY. COORDINATE ALL CEILING WORK PRIOR TO INSTALLATION OF CEILING GRID.
- B. CEILING HEIGHT IS 9'-0" ABOVE FINISHED FLOOR (UNO).
- C. CENTER CEILING-MOUNTED ITEMS (LIGHTS, GRILLES, DETECTORS, SPRINKLER HEAD, ETC) WITHIN THE CEILING PANELS AND GRIDS UNLESS THE PANELS ARE SCORED. CENTER TEMS WITHIN THE PATTERN OF SCORED PANELS.
- D. PAINT ALL NEW EXPOSED LINTELS.
- E. PROVIDE CONTROL JOINTS IN GYPSUM BOARD CEILINGS AND SOFFITS AS DETAILED ON DRAWINGS (MAXIMUM 20'-0" OC, EVENLY SPACED, TYP UNO).
- F. PATCH CEILING SYSTEMS TO REMAIN THAT HAVE BEEN DISTURBED BY SCHEDULED WORK TO MATCH ADJACENT CONSTRUCTION PRIOR TO PAINTING.
- G. DESIGNATES BOTTOM OF CEILING ABOVE FINISHED FLOOR AT THAT POINT UNO. DESIGNATION 'ME' INDICATES MATCH EXISTING CEILING HEIGHT.
- H. USE MOLD-RESISTANT GYPSUM BOARD FOR GYPSUM CEILINGS IN TEAM ROOMS AND TOILET ROOMS.

Ceiling Types

- A1 X-X" ACOUSTIC PANEL CEILING
- A2 X-X" ACOUSTIC PANEL CEILING
- A3 X-X" METAL MESH CEILING PANELS
- B X-X" PAINTED 1/2" GYPSUM CEILING ON SUPPORT MATERIALS (GRID SUSPENSION SYSTEM, TYP UNO)
- F X-X" PAINTED EXPOSED STRUCTURAL SYSTEM, SUPPORT MATERIALS AND FASTENERS, MECHANICAL SYSTEM, ELECTRICAL ITEMS AND PIPING
- G X-X" UNPAINTED EXPOSED STRUCTURAL SYSTEM, SUPPORT MATERIALS AND FASTENERS, MECHANICAL SYSTEM, ELECTRICAL ITEMS AND PIPING

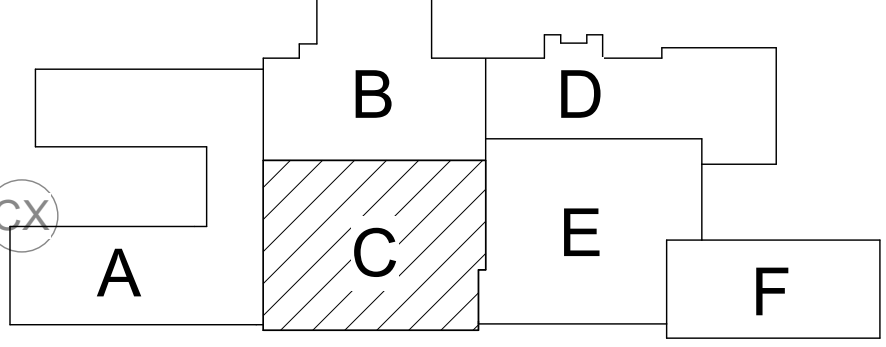

Key Plan
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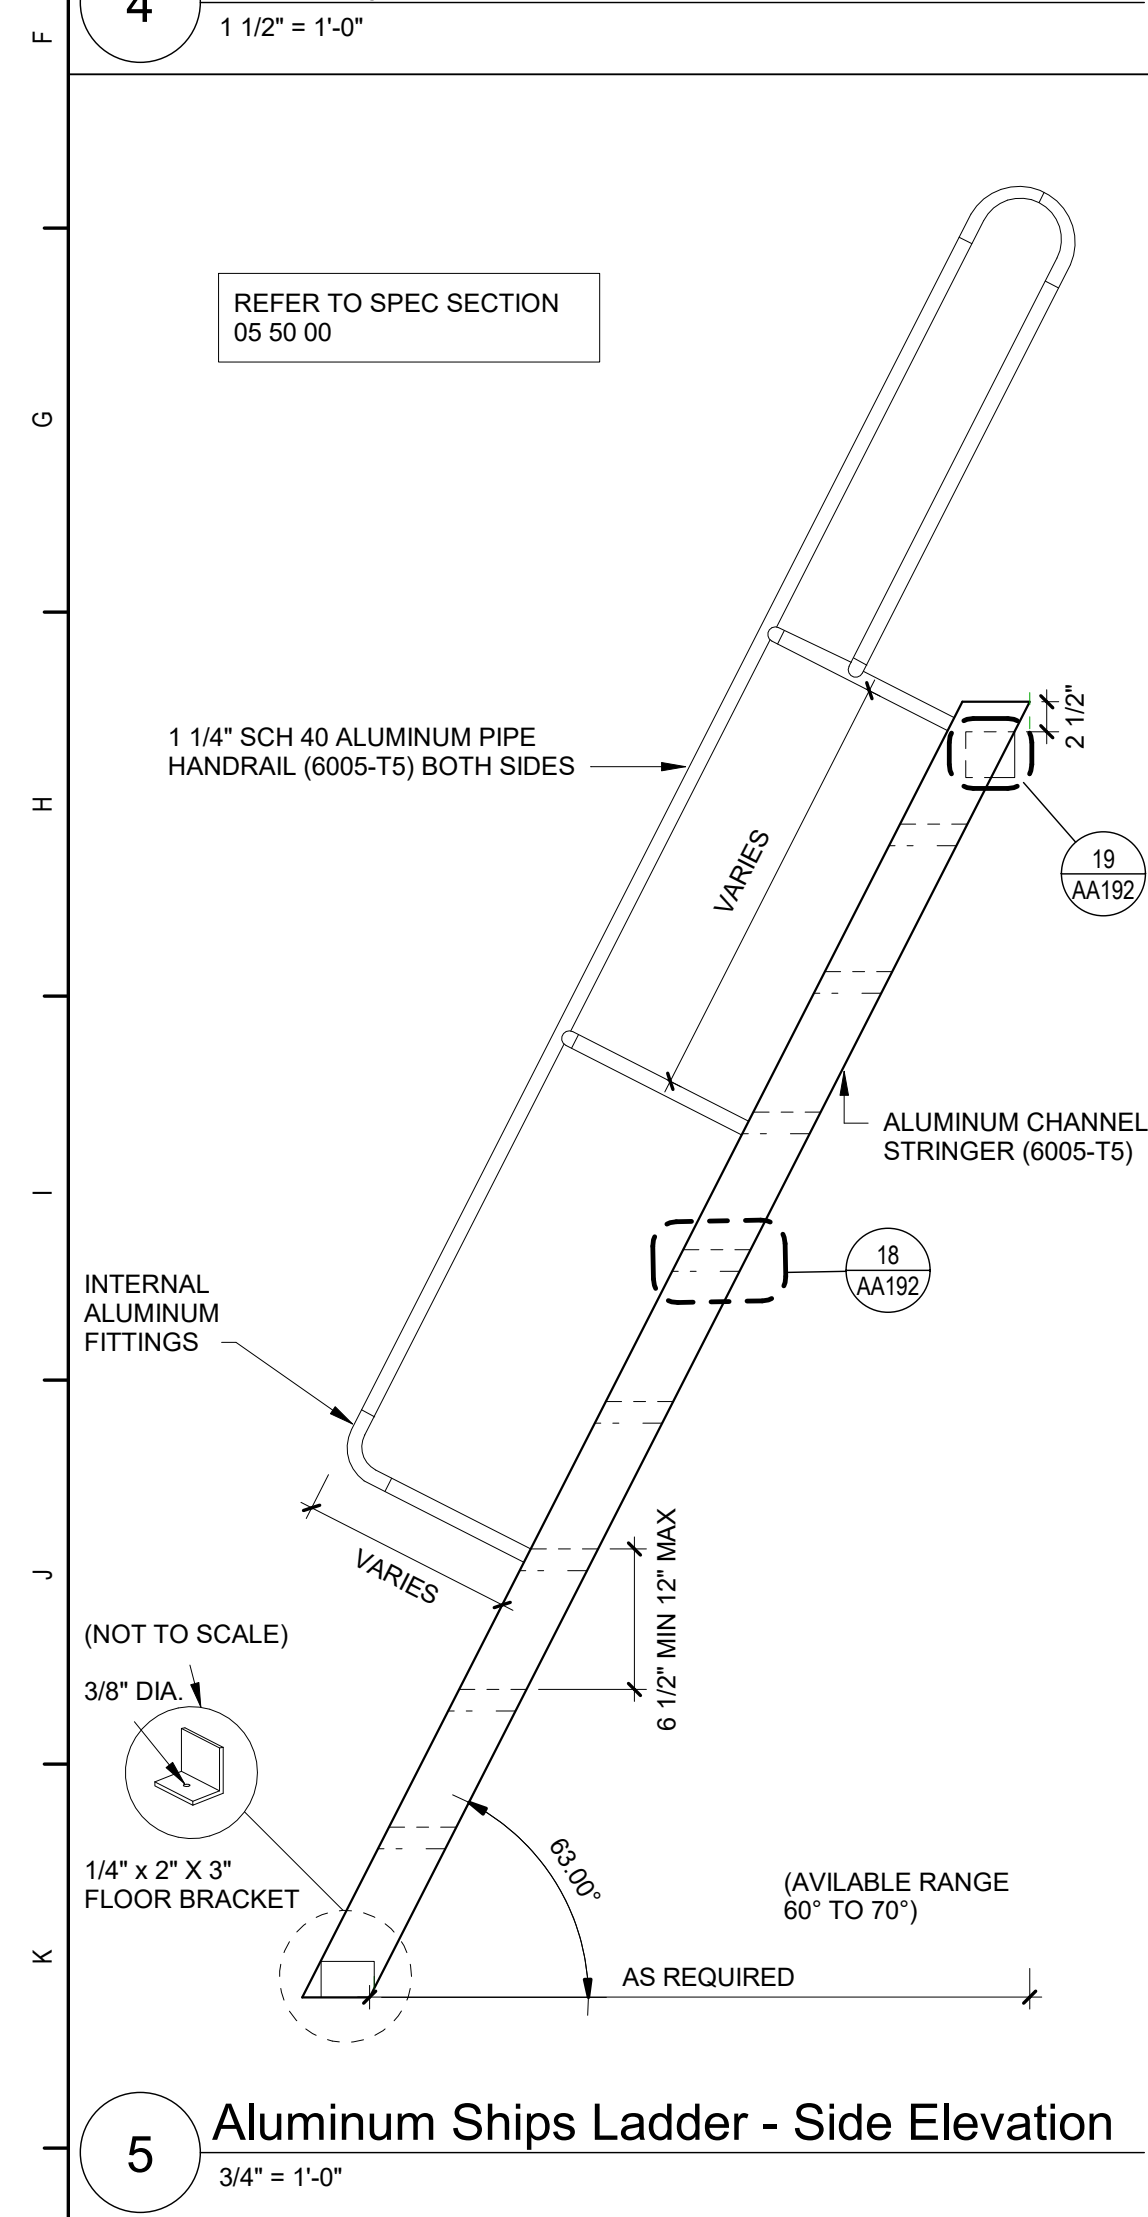


Waverly Central School District
Waverly, NY

Additions and Alterations to:
Waverly Jr. Sr. High School


Second Floor Area C and Mechanical
Room 300 Reflected Ceiling Plans

Drawn By: KCB Date: 05/19/2023 Drawing Number:
Project No.: 339070-22003
AA163




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| Drawn By:
KCB | Date:
05/19/2023 | Drawing Number:

AA190 |
| Project No.:
339070-22003 | | |

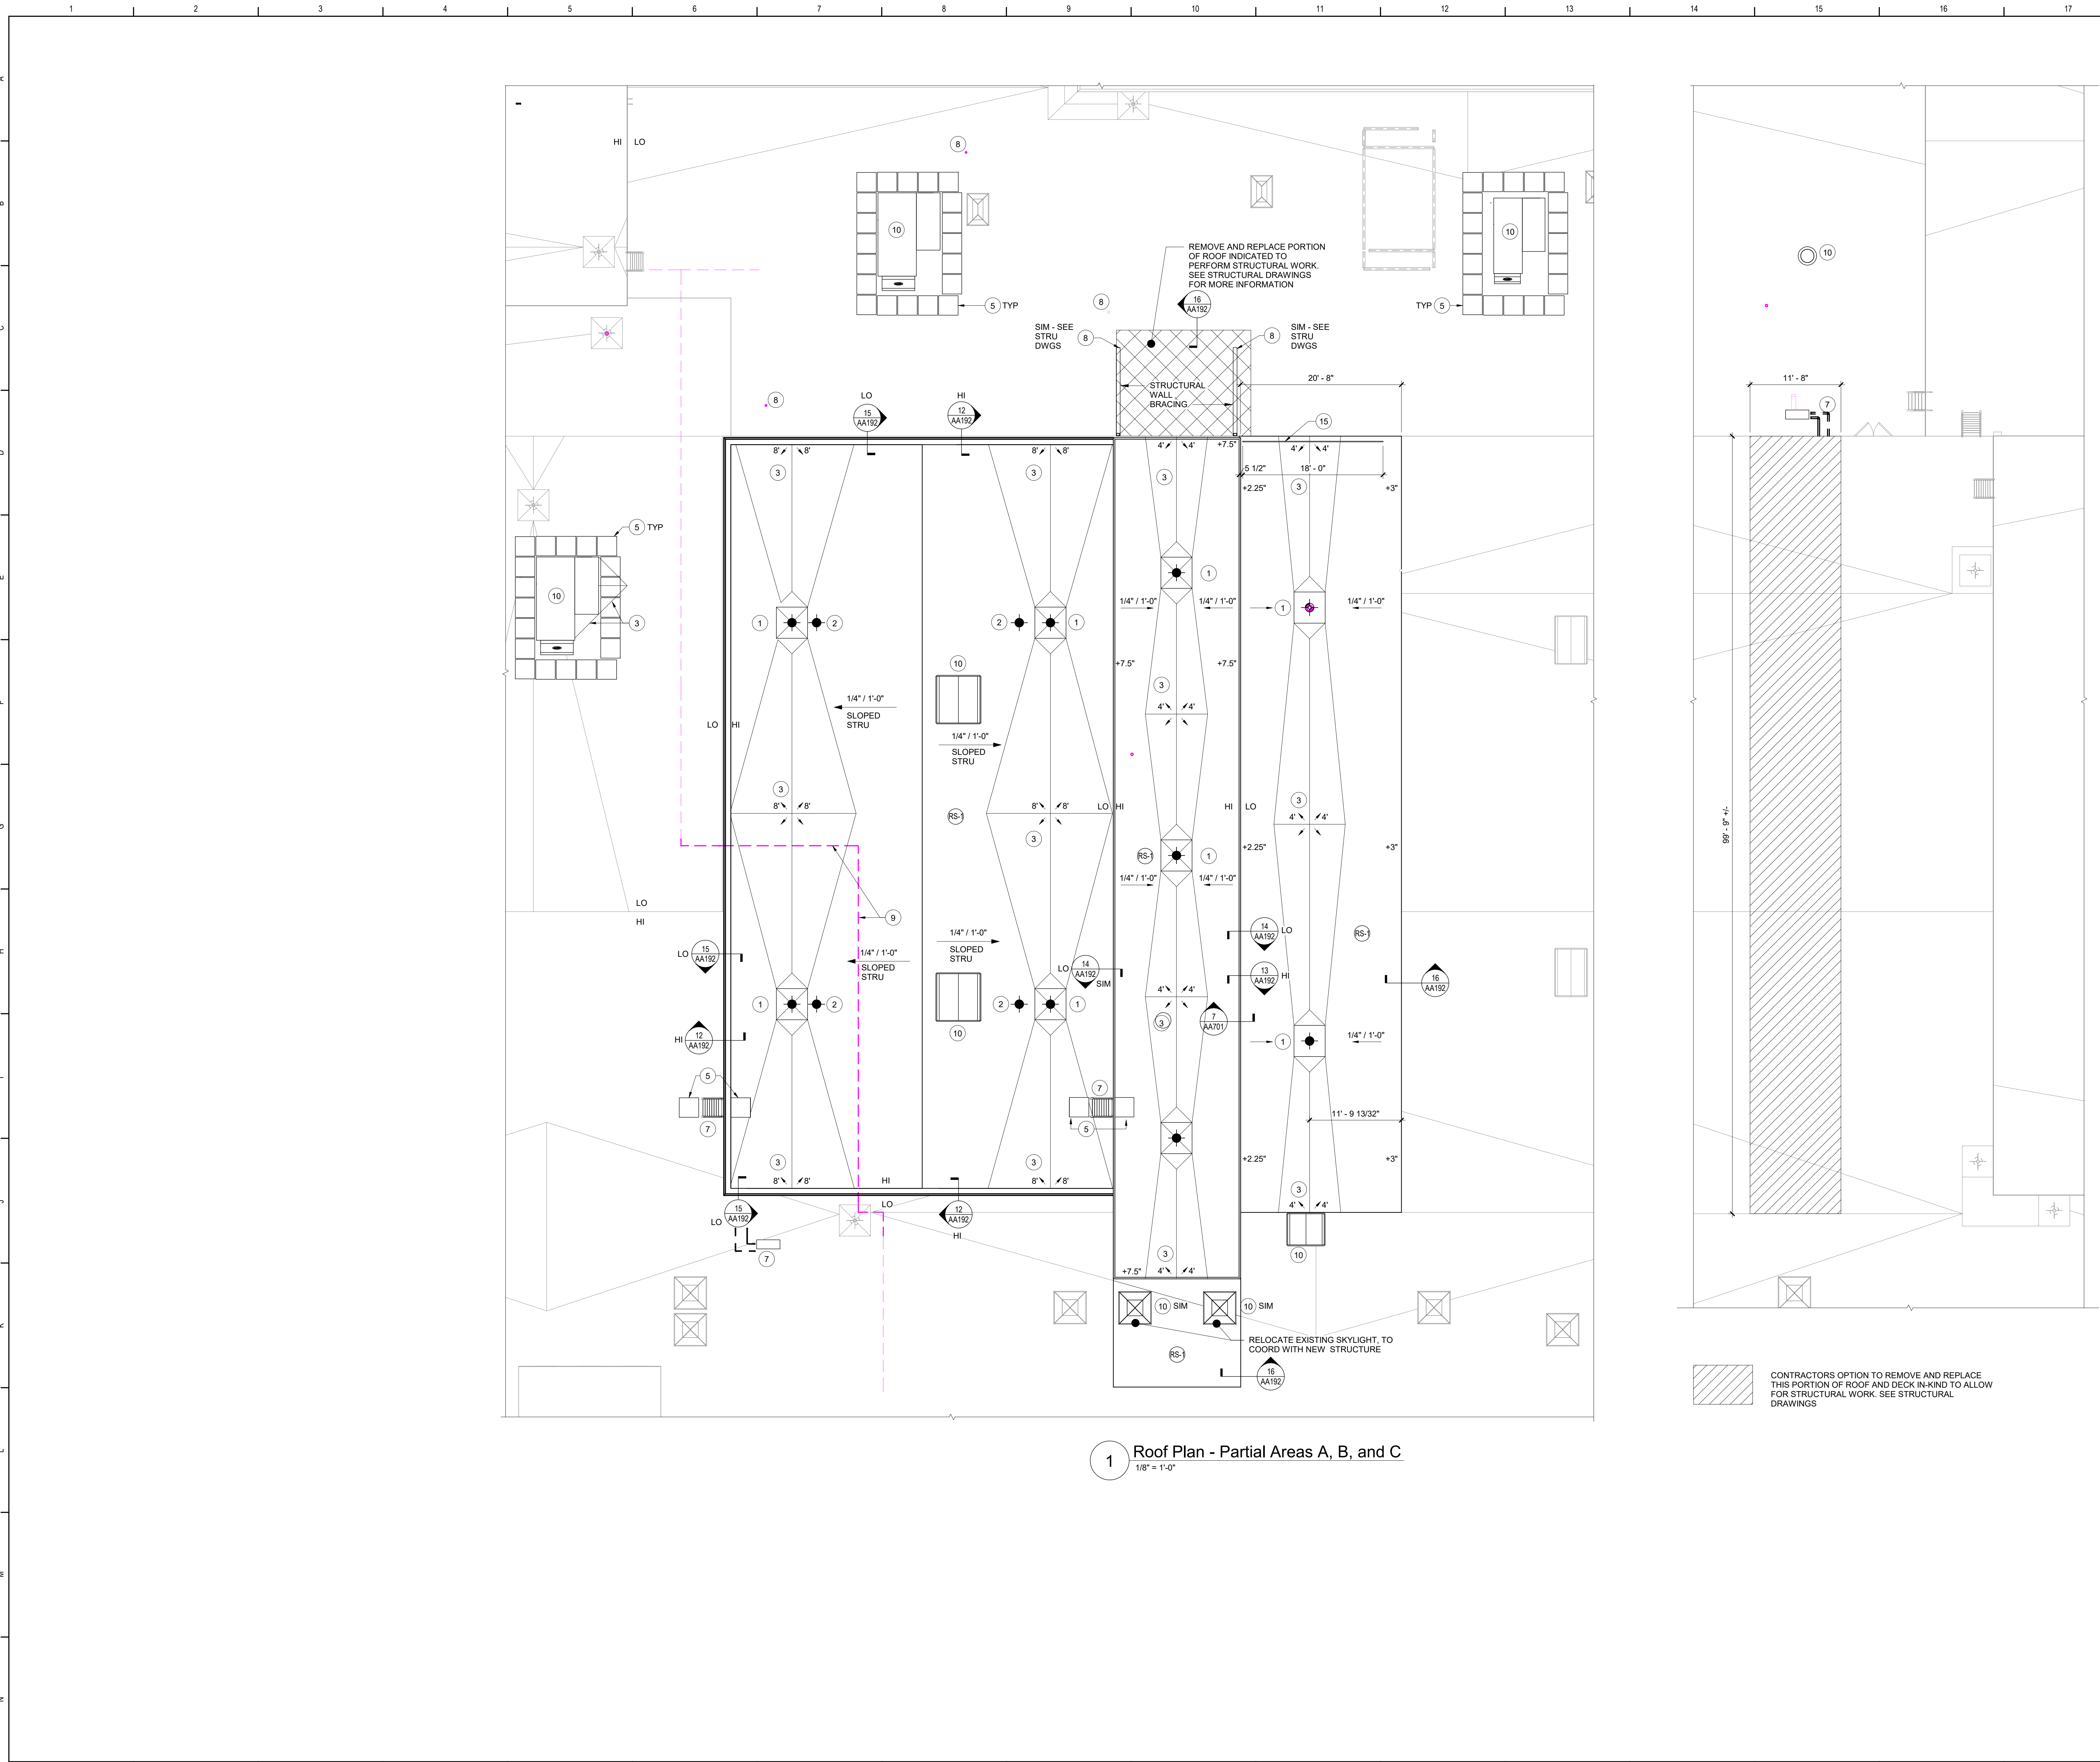

Roof Key Notes

- 1 ROOF DRAIN TYPE "A" (STANDARD), TYP. INSTALL IN TAPERED SUMP. SEE DET. 2/AA192
- 2 ROOF DRAIN TYPE "B" (OVERFLOW), TYP. DO NOT INSTALL IN TAPERED SUMP. SEE DET. 3/AA192
- 3 TAPERED INSULATION CRICKET (TYP). SLOPE 1/2"/FT. TYP ALL SIDES, SIZE AS REQUIRED (VIF).
- 4 NOT USED
- 5 WALKWAY PAD (TYP). SEE DETAIL. 8/AA192
- 6 NOT USED
- 7 ALUM SHIPS LADDER. SEE DETAILS 5/AA190 AND 20/AA192
- 8 VENT PIPE OR HOT FLUE PIPE PENETRATION (VIF), TYP. SEE DETAILS 5/AA192 AND 6/AA192
- 9 HORIZONTAL PIPING ON PIPE SUPPORTS (TYP). SEE DETAIL 9/AA192
- 10 ROOF CURB-MOUNTED EQUIPMENT (TYP). SEE DETAIL 4/AA192
- 11 EQUIPMENT ON EQUIPMENT SUPPORTS (TYP). SEE DETAIL 7/AA192
- 12 CUT AND REMOVE STRESSED ROOF MEMBRANE AT VERTICAL ELEVATION TRANSITION (APPROX 3") BETWEEN ROOF FIELD AND CENTER OF TOP ROOF EDGE CURB. PREPARE SUBSTRATE AND PROVIDE 60 MIL. NON-REINFORCED, FULLY-ADHERED EPDM ROOF MEMBRANE STRIPPED-INTO FIELD MEMBRANE AT ROOF FIELD AND AT TOP OF CURB WITH 6" SEAM TAPE. PROVIDE MECHANICAL MEMBRANE ATTACHMENT AT INSIDE CORNER PER ROOF SYSTEM MANUFACTURER'S REQUIREMENTS. ALL WORK IS TO BE PERFORMED BY A FIRESTONE LICENSED APPLICATOR, UTILIZING MATERIALS AND METHODS APPROVED BY FIRESTONE IN COMPLIANCE WITH ALL WARRANTY REQUIREMENTS. WORK IS TO BE INSPECTED BY FIRESTONE AND INCLUDED IN THE MANUFACTURER'S EXISTING ROOF WARRANTY.
- 13 EXISTING PIPE OVER ROOF TO REMAIN, REFER TO PLBG DRAWINGS
- 14 REMOVE EXISTING DRAIN STRAINER, REMOVE EXISTING STAND PIPE IN DRAIN, REPLACE DRAIN STRAINER
- 15 MOVABLE SAFETY RAILING SYSTEM, SEE SPECIFICATIONS

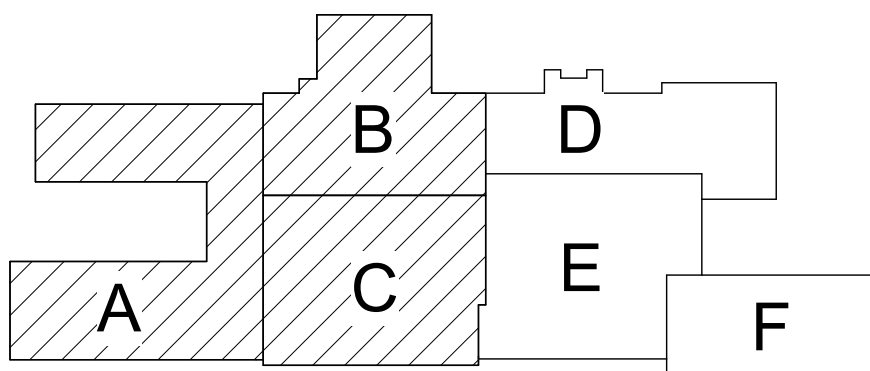

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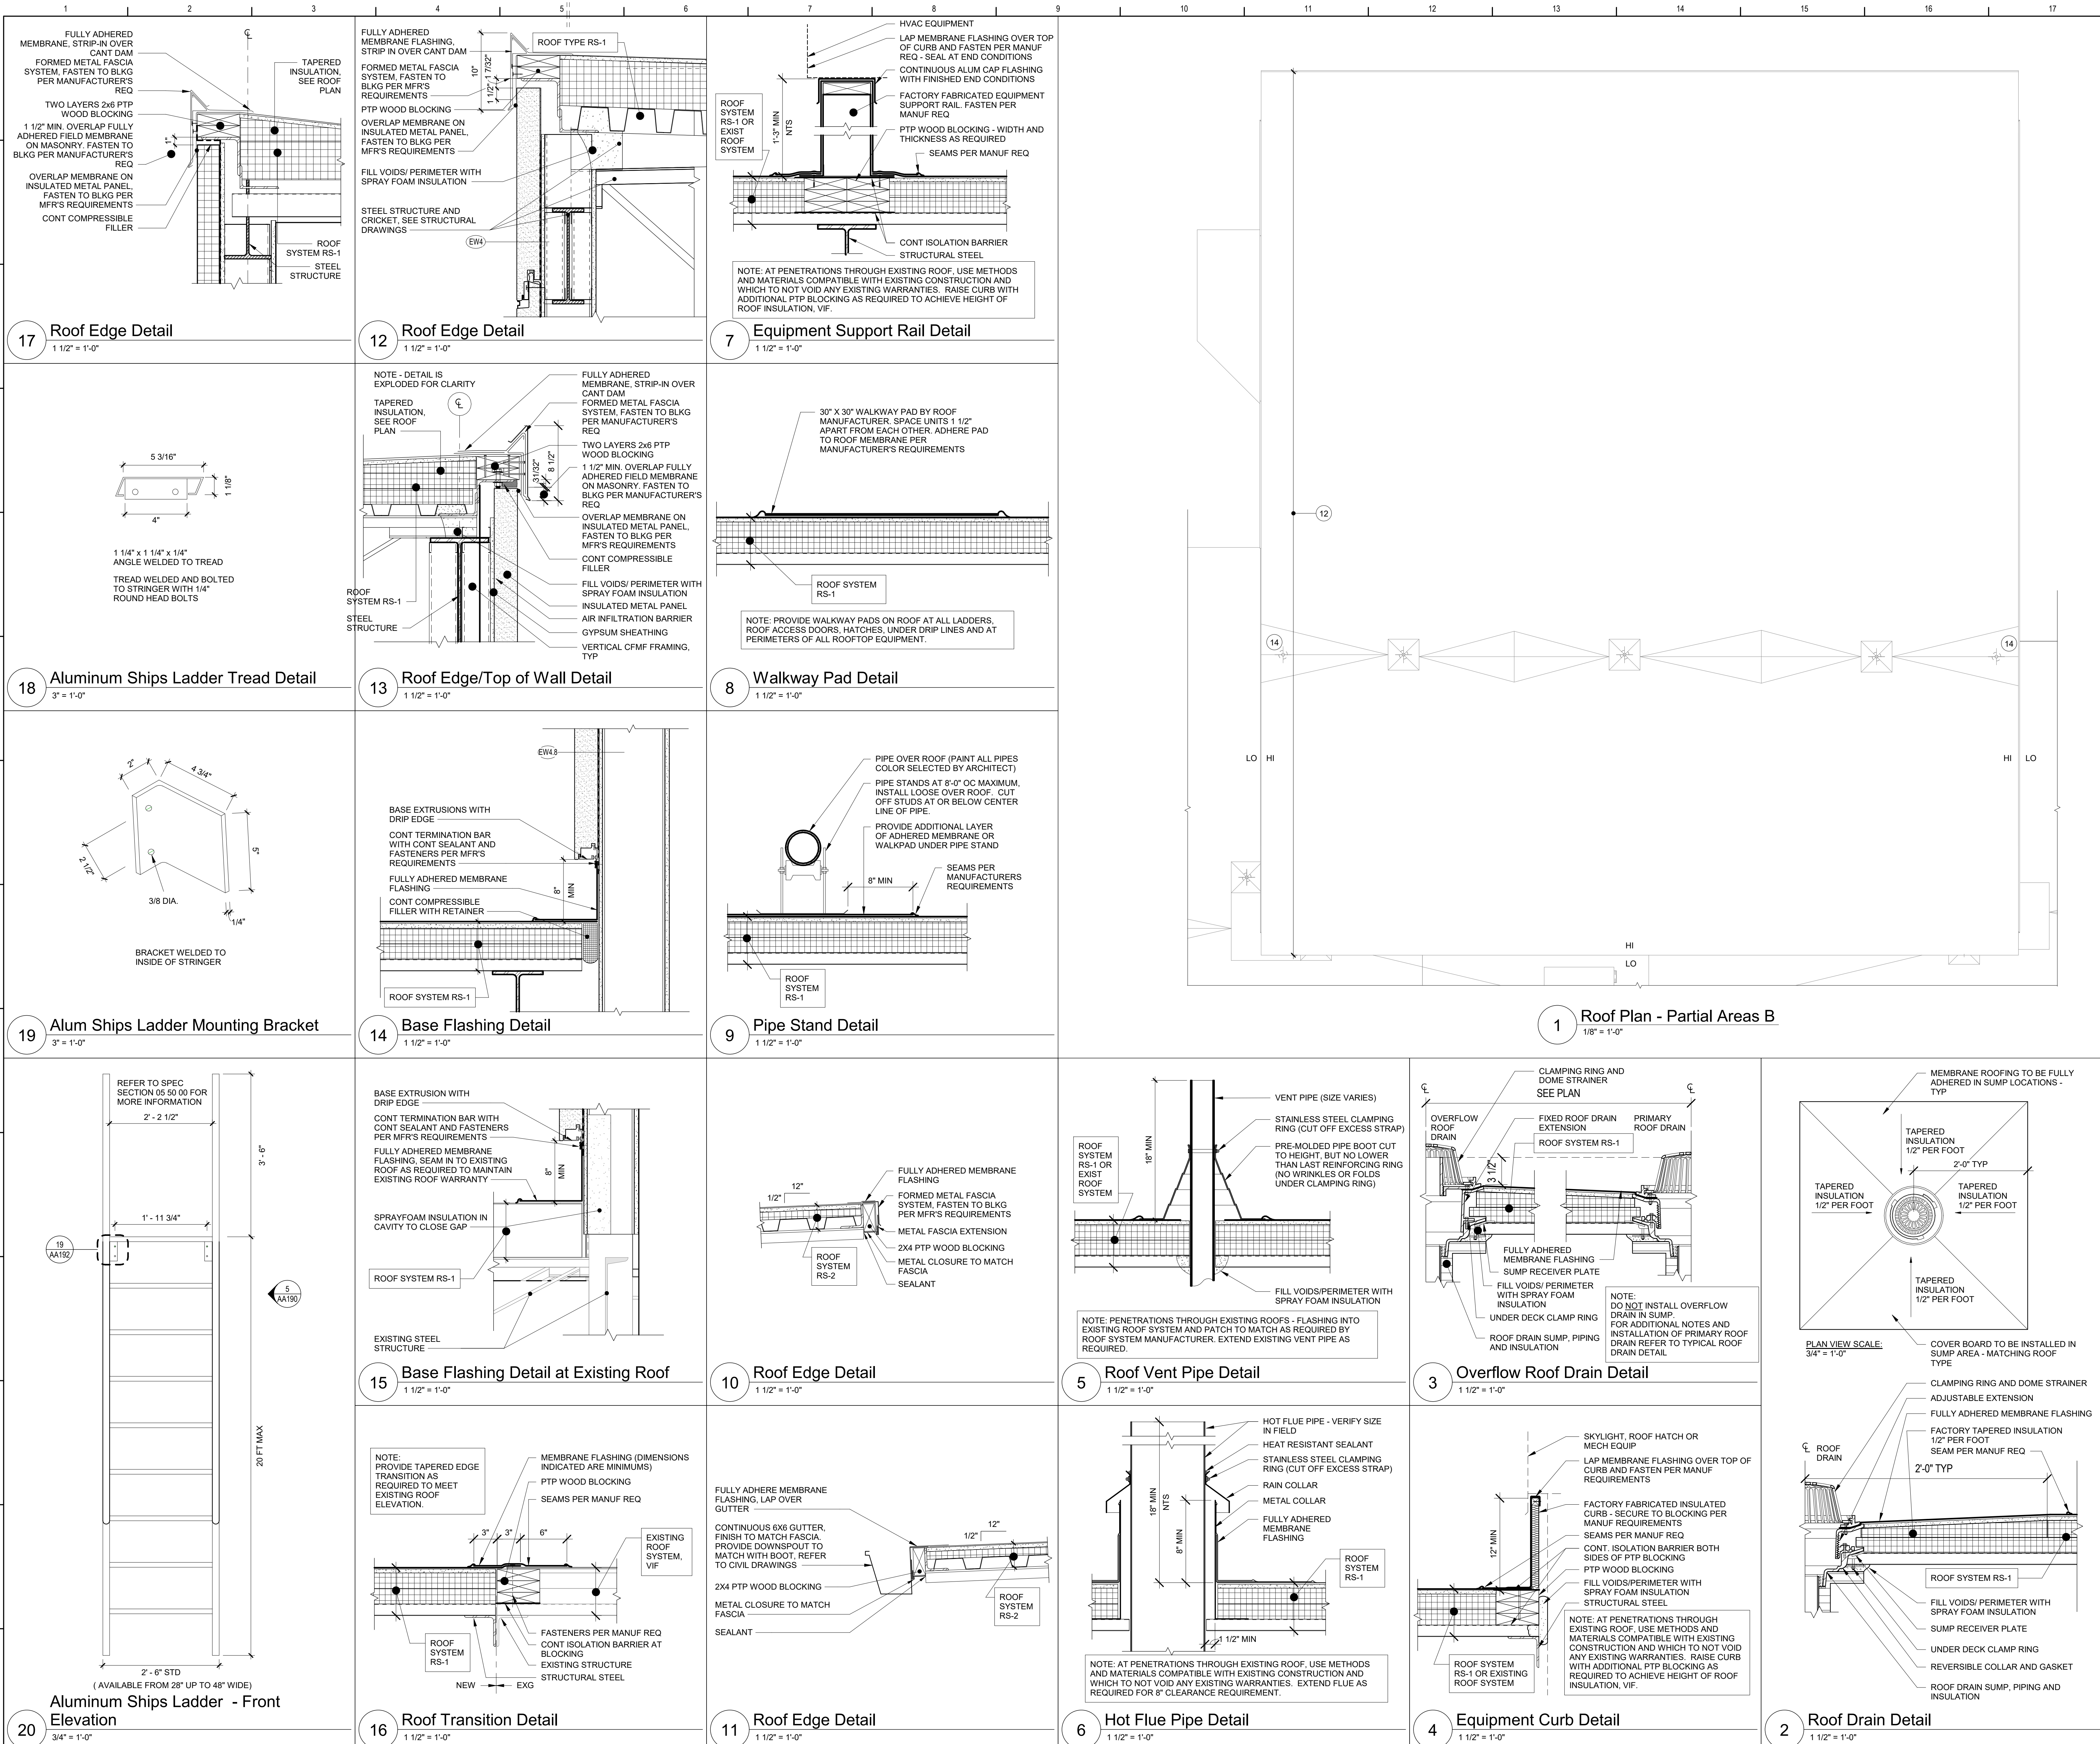


Waverly Central School District
Waverly, NY

Additions and Alterations to:
Waverly Jr. Sr. High School


Roof Plan - Partial Areas A, B, and C

Drawn By: Author
Date: 05/19/2023
Project No.: 339070-22003
Drawing Number: AA191



Roof Key Notes

- 1 ROOF DRAIN TYPE "A" (STANDARD), TYP. INSTALL IN TAPERED SUMP. SEE DET 2/AA192
- 2 ROOF DRAIN TYPE "B" (OVERFLOW), TYP. DO NOT INSTALL IN TAPERED SUMP. SEE DET 3/AA192
- 3 TAPERED INSULATION CRICKET (TYP). SLOPE 1/2"/FT. TYP. ALL SIZES, SIZE AS REQUIRED (VIF).
- 4 NOT USED
- 5 WALKWAY PAD (TYP). SEE DETAIL 8/AA192
- 6 NOT USED
- 7 ALUM SHIPS LADDER. SEE DETAILS 5/AA190 AND 20/AA192
- 8 VENT PIPE OR HOT FLUE PIPE PENETRATION (VIF), TYP. SEE DETAILS 5/AA192 AND 6/AA192
- 9 HORIZONTAL PIPING ON PIPE SUPPORTS (TYP). SEE DETAIL 9/AA192
- 10 ROOF CURB-MOUNTED EQUIPMENT (TYP). SEE DETAIL 4/AA192
- 11 EQUIPMENT ON EQUIPMENT SUPPORTS (TYP). SEE DETAIL 7/AA192
- 12 CUT AND REMOVE STRESSED ROOF MEMBRANE AT VERTICAL ELEVATION TRANSITION (APPROX 3") BETWEEN ROOF FIELD AND CENTER OF TOP ROOF EDGE CURB. PREPARE SUBSTRATE AND PROVIDE 60-MIL, NON-REINFORCED, FULLY-ADHERED EPDM ROOF MEMBRANE STRIPPED-INTO FIELD MEMBRANE AT ROOF FIELD AND AT TOP OF CURB WITH 6" SEAM TAPE. PROVIDE MECHANICAL MEMBRANE ATTACHMENT AT INSIDE CORNER PER ROOF SYSTEM MANUFACTURER'S REQUIREMENTS. ALL WORK IS TO BE PERFORMED BY A FIRESSTONE LICENSED APPLICATOR, UTILIZING MATERIALS AND METHODS APPROVED BY FIRESSTONE IN COMPLIANCE WITH ALL WARRANTY REQUIREMENTS. WORK IS TO BE INSPECTED BY FIRESSTONE AND INCLUDED IN THE MANUFACTURER'S EXISTING ROOF WARRANTY.
- 13 EXISTING PIPE OVER ROOF TO REMAIN, REFER TO PLBG DRAWINGS
- 14 REMOVE EXISTING DRAIN STRAINER. REMOVE EXISTING STAND PIPE IN DRAIN, REPLACE DRAIN STRAINER.
- 15 MOVABLE SAFETY RAILING SYSTEM, SEE SPECIFICATIONS

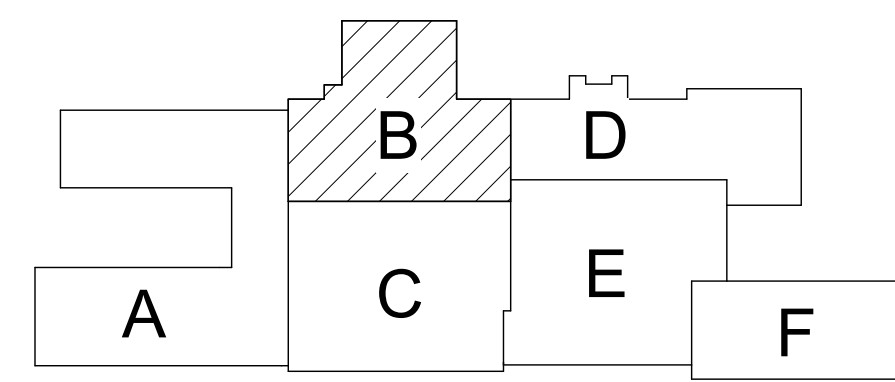

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Waverly Central School District
Waverly, NY

Additions and Alterations to:
Waverly Jr. Sr. High School

Roof Plan - Area B and Details


Drawn By: Author Date: 05/19/2023 Drawing Number: 339070-22003

AA192

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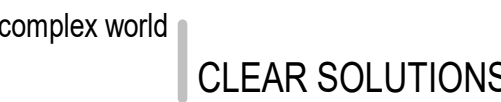


- 1 ROOF DRAIN TYPE "A" (STANDARD). TYP. INSTALL IN TAPERED
SUMP. SEE DET. 2/A/192
- 2 ROOF DRAIN TYPE "B" (OVERFLOW). TYP. DO NOT INSTALL IN
TAPERED SUMP. SEE DET. 3/A/192
- 3 TAPERED INSULATION CRUIK (TYP.) SLOPE 1/2"/FT. TYP. ALL
SIZES. SIZE AS REQUIRED (V/F).
- 4 NOT USED
- 5 WALKWAY PAD (TYP). SEE DETAIL. 6/A/192
- 6 NOT USED
- 7 ALUM SHIPS LADDER. SEE DETAILS 5/A/190 AND 20/A/192
- 8 VENT PIPE AT HOT FLUE PIPE PENETRATION (V/F). TYP. SEE
DETAILS 5/A/192 AND 6/A/192
- 9 HORIZONTAL PIPING ON PIPE SUPPORTS (TYP). SEE DETAIL.
9/A/192
- 10 ROOF CURB-MOUNTED EQUIPMENT (TYP). SEE DETAIL. 4/A/192
7/A/192
- 11 CUT AND REMOVE STRESSED ROOF MEMBRANE AT VERTICAL
ELEVATION TRANSITION (APPROX 3") BETWEEN ROOF FIELD AND
CENTER OF TOP ROOF EDGE CURB. PREPARE SUBSTRATE AND
20-GAL. NON-REINFORCED FULLY-ADHERED EPDM
ROOF MEMBRANE STRIPPED-INTO FIELD MEMBRANE AT ROOF
FIELD AND AT TOP OF CURB WITH 6" SEAM TAP. PROVIDE
MEMBRANE MEMBRANE ATTACHMENT AT INSIDE CORNER PER
ROOF SYSTEM MANUFACTURER'S REQUIREMENTS. ALL WORK I
TO BE PERFORMED BY A FIRESTONE LICENSED APPLICATOR.
UTILIZING MATERIALS AND METHODS APPROVED BY FIRESTONE
IN COMPLIANCE WITH ALL WARRANTY REQUIREMENTS. WORK I
TO BE INSPECTED BY FIRESTONE AND INCLUDED IN THE
MANUFACTURER'S EXISTING ROOF WARRANTY
- 13 EXISTING PIPE OVER ROOF TO REMAIN. REFER TO PLOD
DRAWINGS
- 14 REMOVE EXISTING DRAIN STRAINER. REMOVE EXISTING STAND
PIPE IN DRAIN. REPLACE DRAIN STRAINER.
- 15 MOVABLE SAFETY RAILING SYSTEM. SEE SPECIFICATIONS

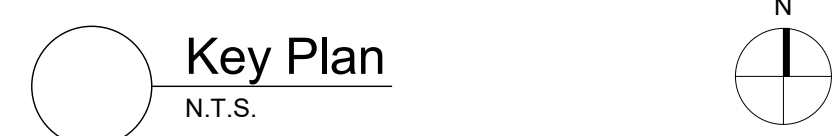

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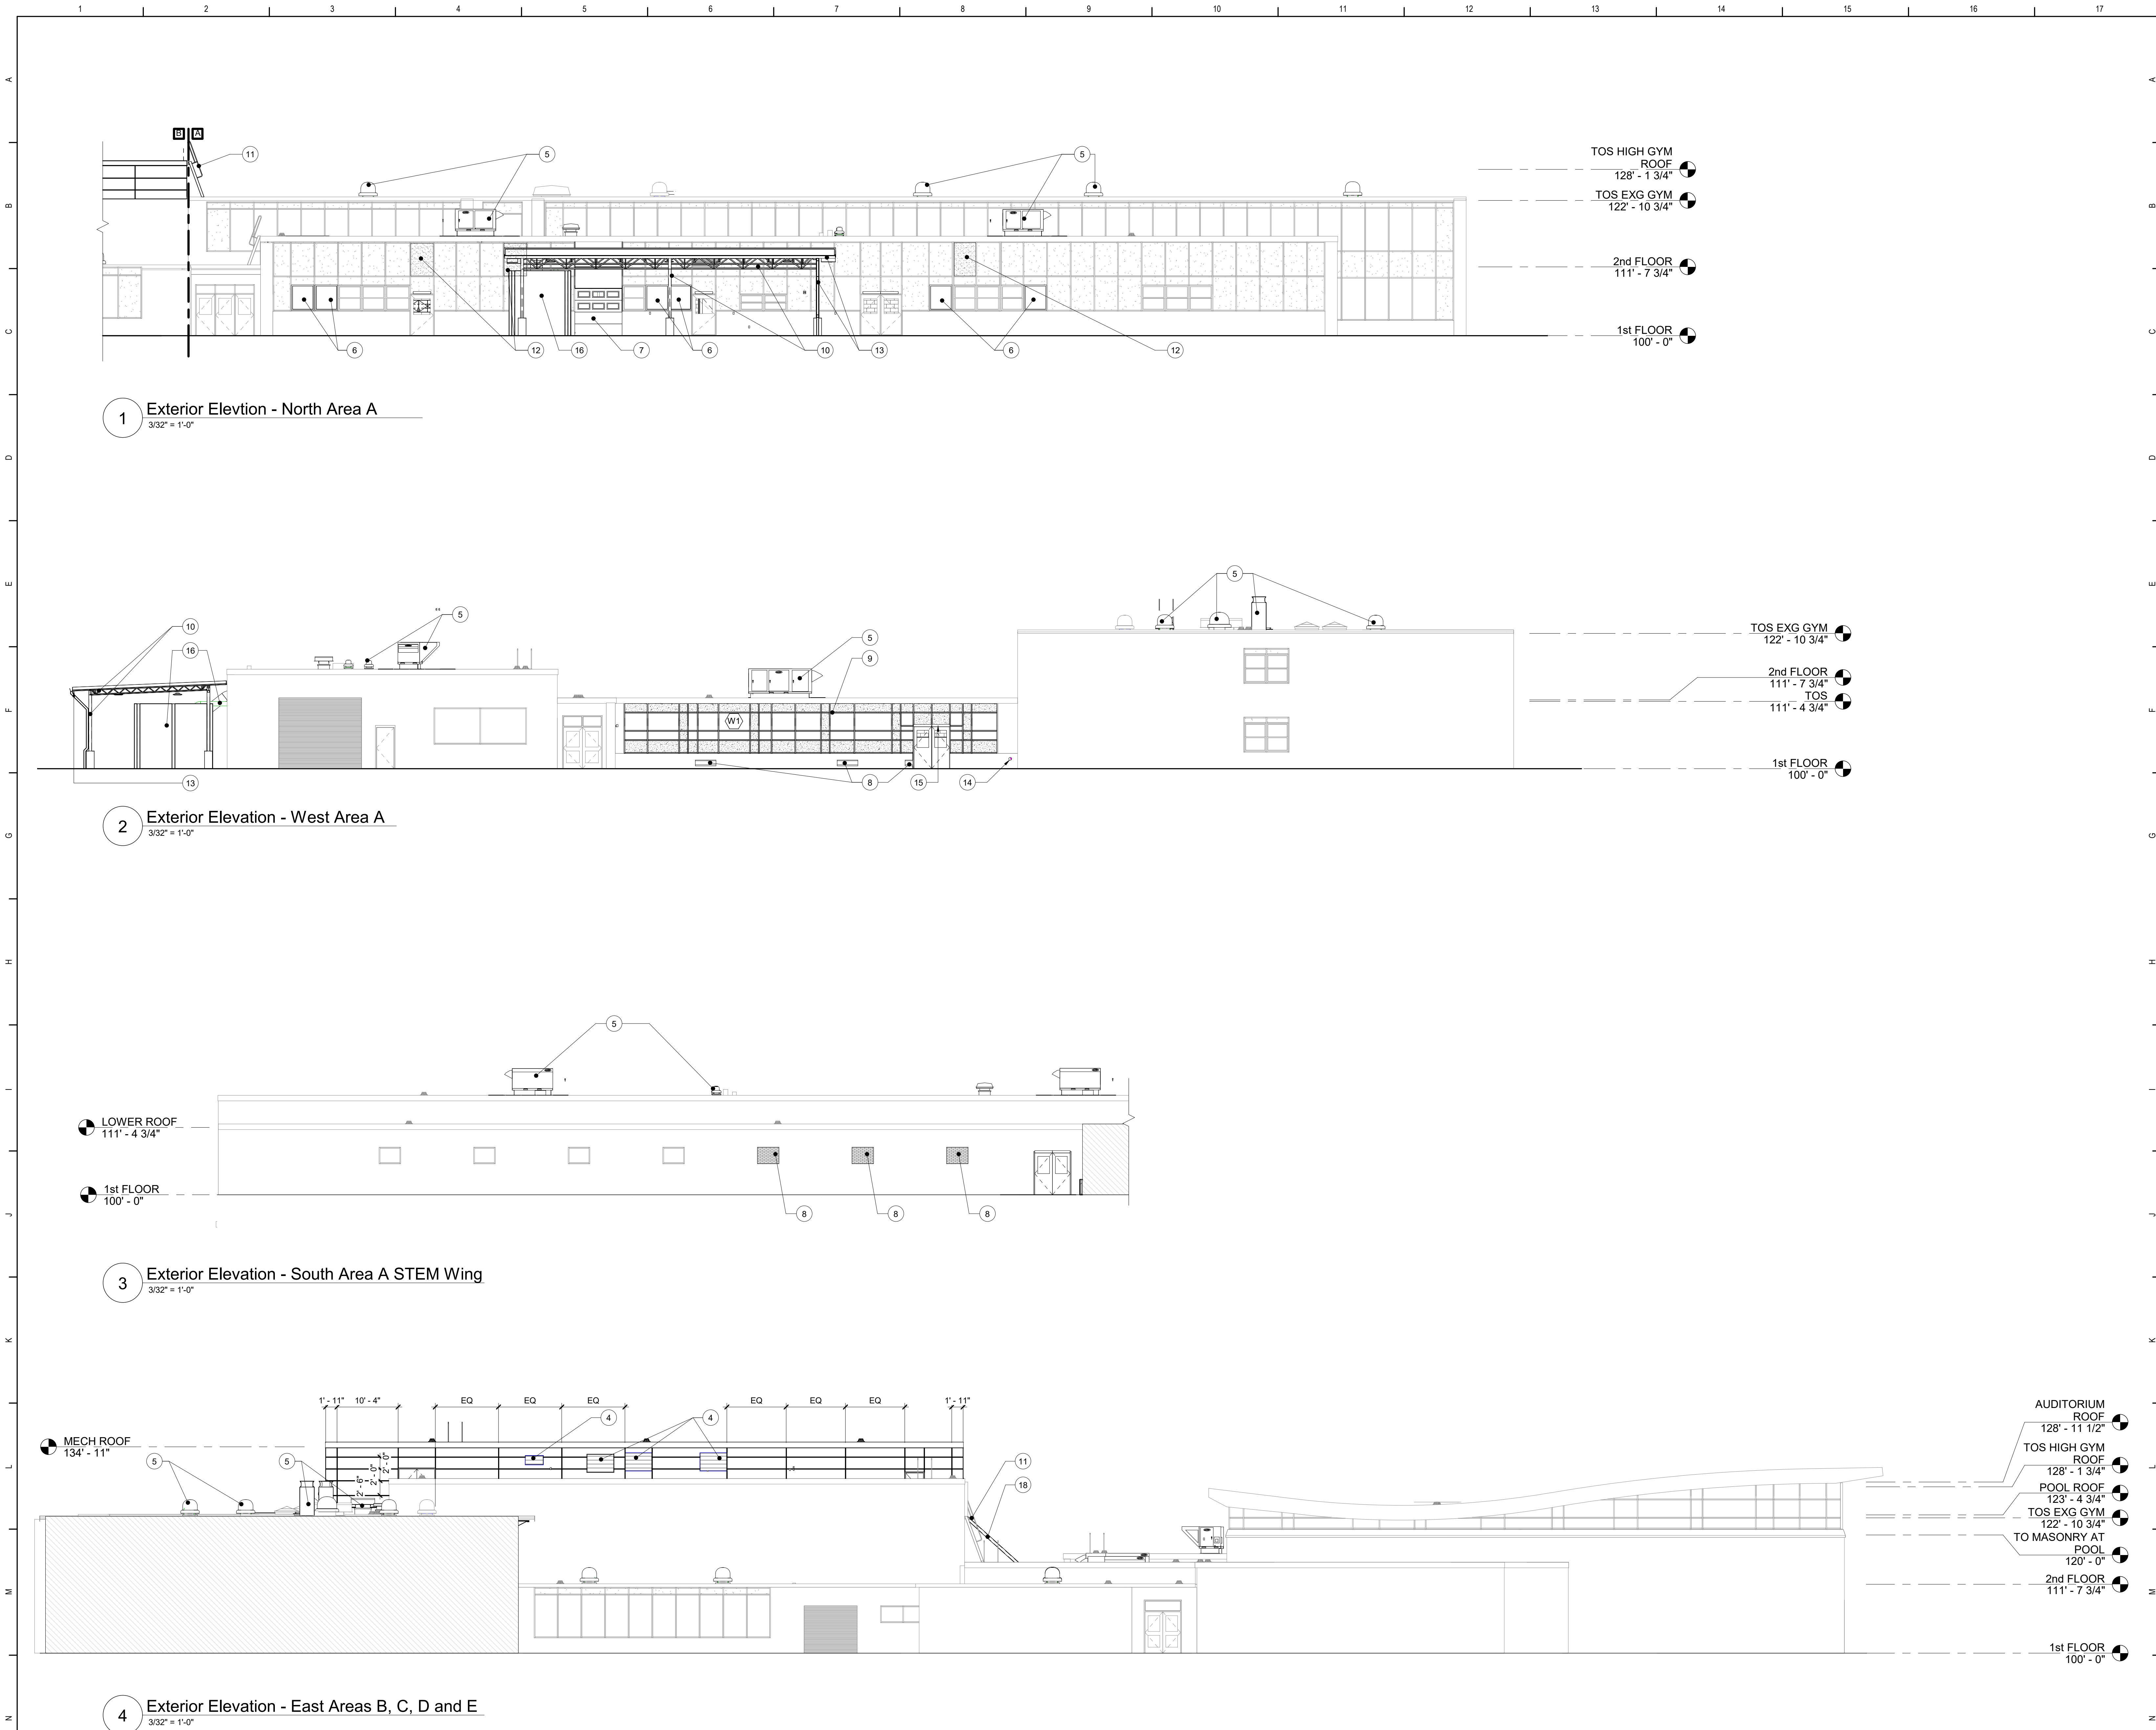


Waverly Central School District
Waverly, NY


Additions and Alterations to Waverly Jr. Sr. High School

Roof Plan - Area F

Drawn By: MDG	Date: 05/19/2023	Drawing Number: AA194
Project No.: 339070-22003		



- General Elevation Notes**
- A. NOTES DESCRIBED ON ONE ELEVATION APPLY TO ALL ELEVATIONS, TYPICAL UNLESS OTHERWISE NOTED.
 - B. PAINT ALL NEW EXPOSED STEEL LINTELS ACCENT COLOR SELECTED BY ARCHITECT.
- Keyed Elevation Notes**
- 1 INSULATED METAL PANELS
 - 2 ALUMINUM WINDOWS INTEGRAL TO METAL WALL PANEL SYSTEM
 - 3 ROOF FASCIA
 - 4 MECHANICAL LOUVER - REFER TO MECHANICAL DRAWINGS
 - 5 MECHANICAL EQUIPMENT OR DUCTWORK - REFER TO MECHANICAL DRAWINGS
 - 6 NEW INSULATED GLAZED PANEL IN EXISTING CURTAIN WALL FRAMING. GLASS TYPE TO BE FGEHCL
 - 7 NEW SECTIONAL OVERHEAD DOOR IN EXISTING CURTAIN WALL FRAMING
 - 8 INFILL EXTERIOR WALL OPENING WITH CMU, AIR BARRIER, INSULATION AND BRICK, THICKNESS, COLOR, AND BOND PATTERN TO MATCH EXISTING. TOOTH-IN MASONRY, TYPICAL.
 - 9 ALUMINUM STOREFRONT SYSTEM
 - 10 CANOPY STRUCTURE - PAINT TYP
 - 11 ROOF ACCESS SHIPS LADDER
 - 12 PROVIDE NEW INSULATED PANEL IN EXISTING FRAMING
 - 13 GUTTER AND DOWNSPOUT
 - 14 DOWNSPOUT NOZZLE - SEE PLUMBING DRAWINGS
 - 15 EXTERIOR LIGHT - SEE ELECTRICAL DRAWINGS
 - 16 NEW DUST COLLECTOR IN STEEL FRAMED ACOUSTIC LOUVER SYSTEM - SEE STRU AND MECH DRAWINGS
 - 17 MOVABLE SAFETY RAIL - SEE SPECIFICATIONS
 - 18 STRUCTURAL WALL BRACING - SEE STRUCTURAL DRAWINGS

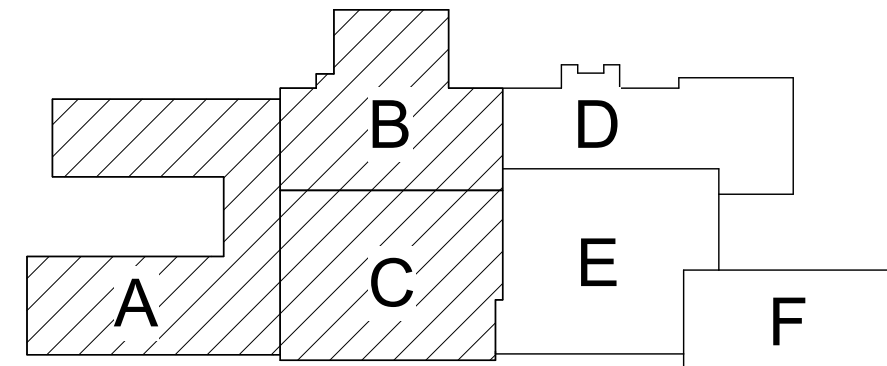

Key Plan
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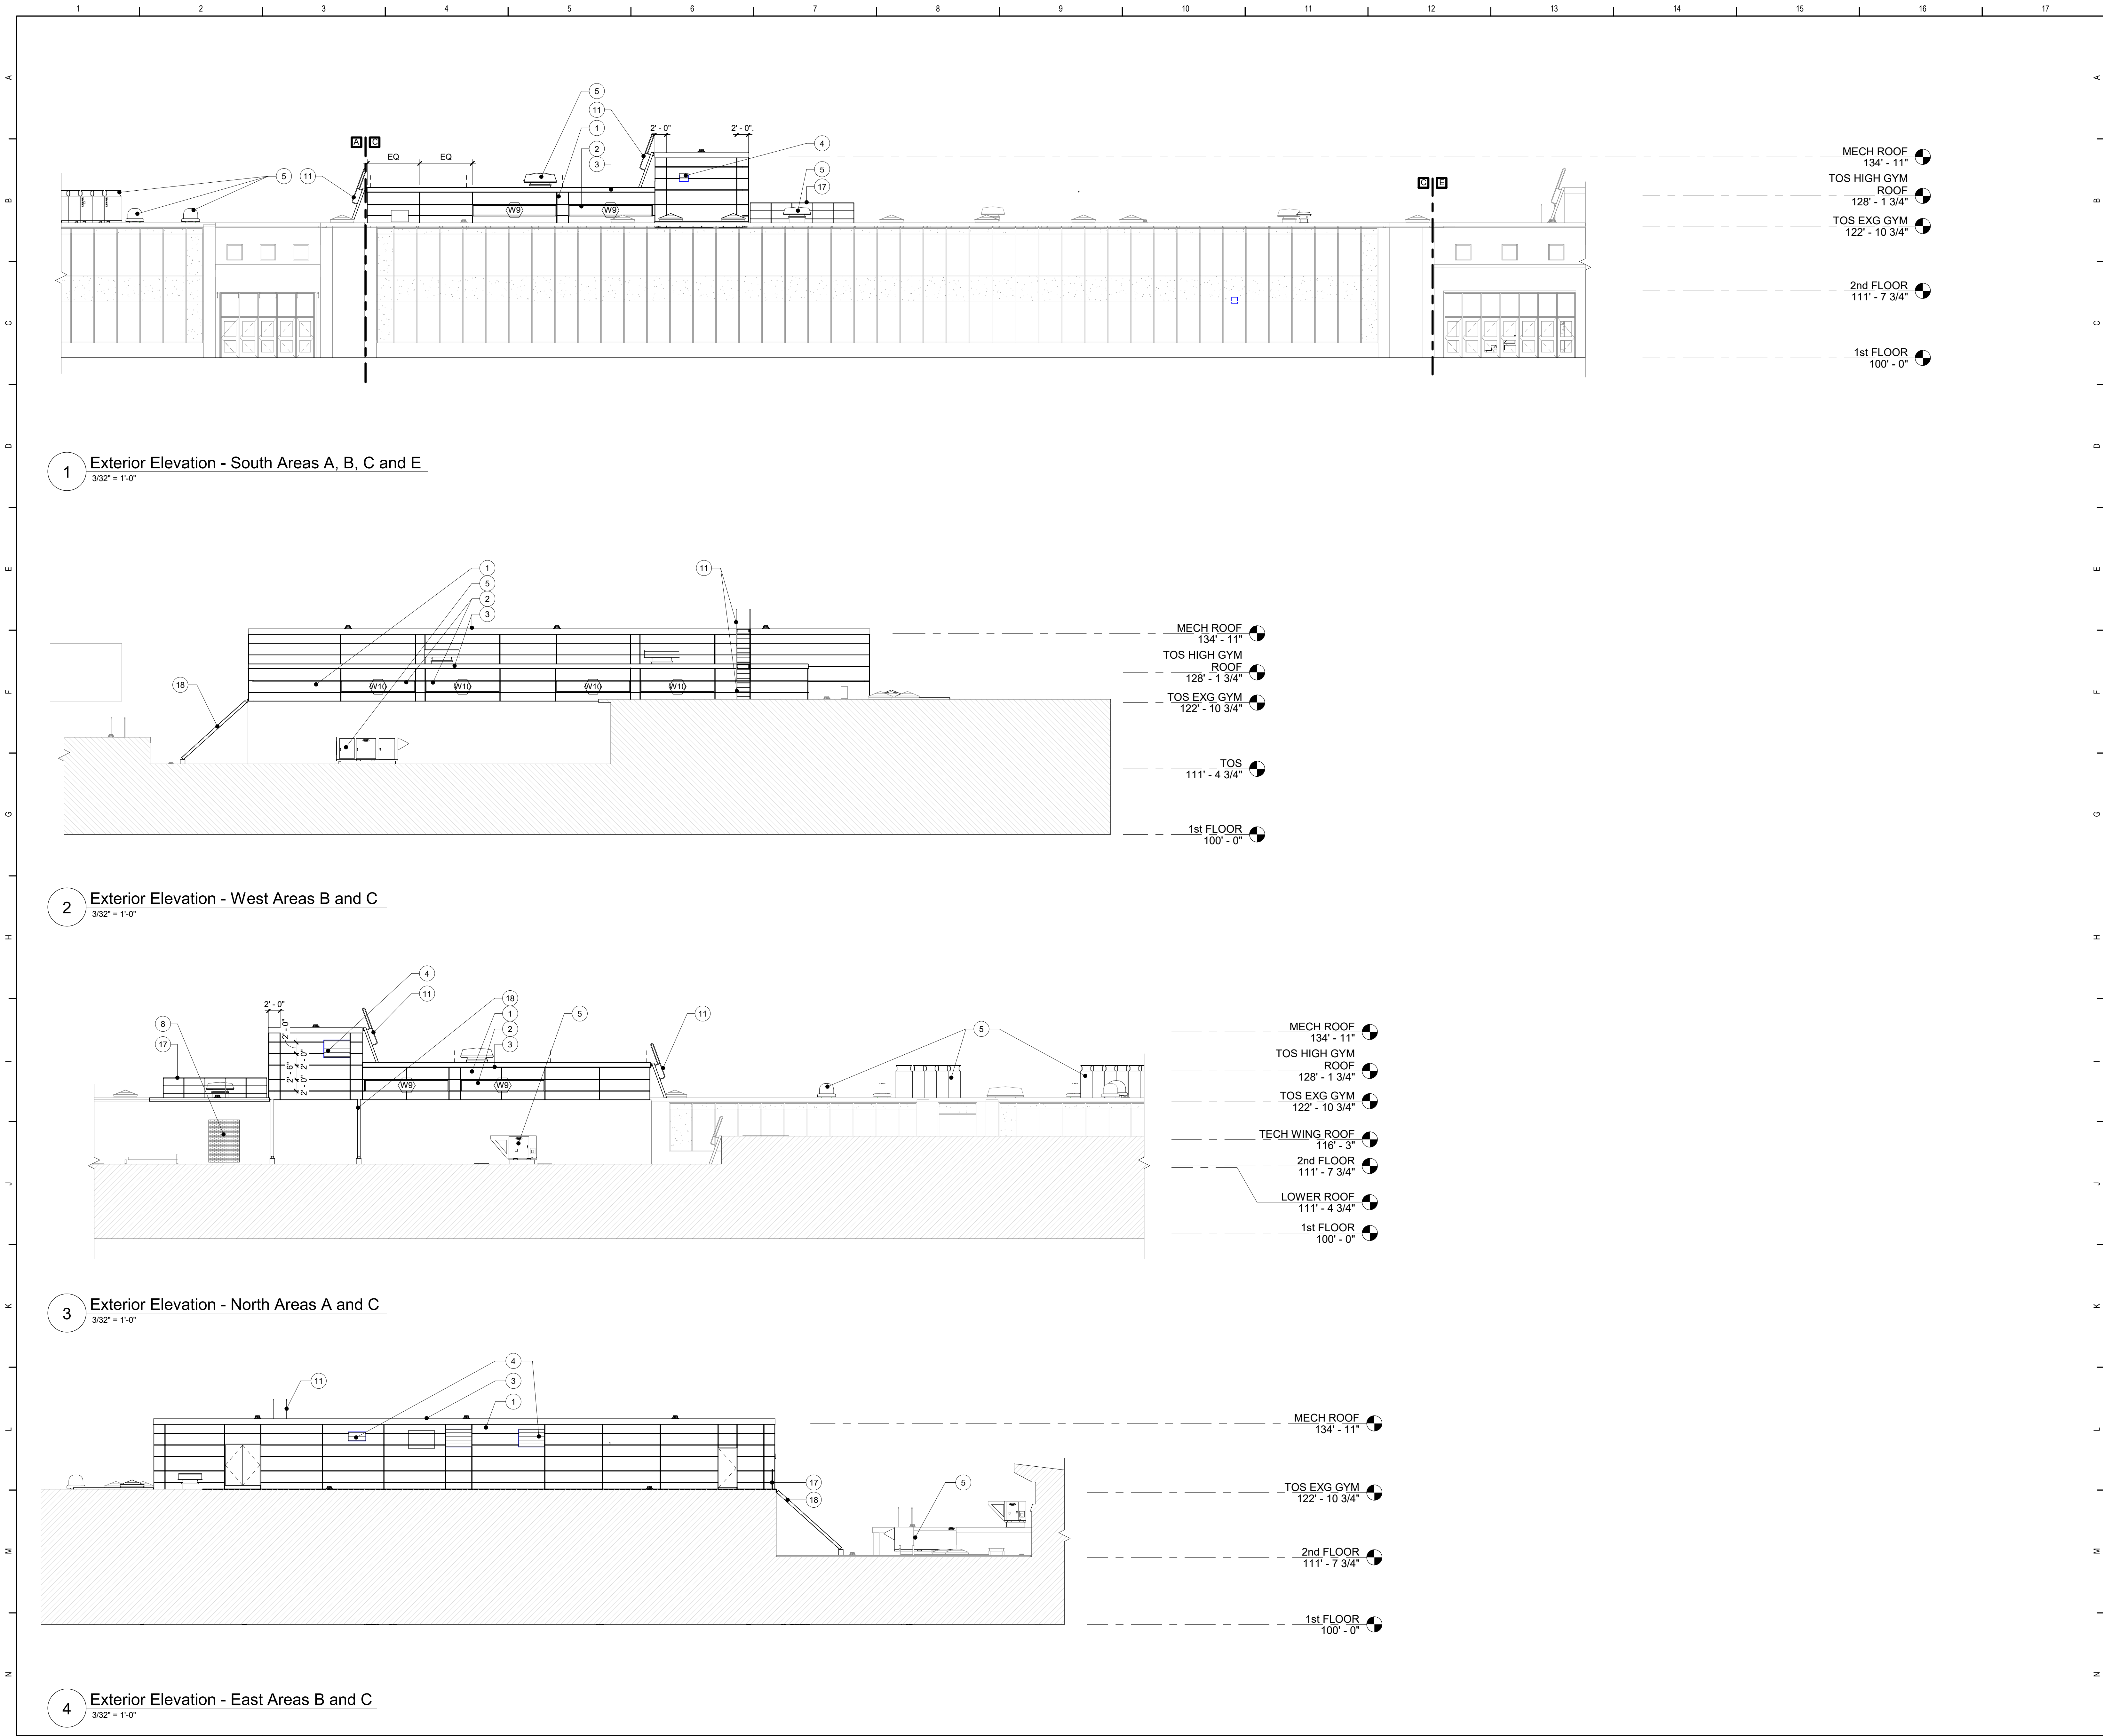


Waverly Central School District
Waverly, NY


Additions and Alterations to:
Waverly Jr. Sr. High School

Exterior Elevations

Drawn By: KCB	Date: 05/19/2023	Drawing Number:
Project No.: 339070-22003	AA200	



- General Elevation Notes**
- A. NOTES DESCRIBED ON ONE ELEVATION APPLY TO ALL ELEVATIONS, TYPICAL UNLESS OTHERWISE NOTED.
 - B. PAINT ALL NEW EXPOSED STEEL LINTELS ACCENT COLOR SELECTED BY ARCHITECT.
- Keyed Elevation Notes**
- 1 INSULATED METAL PANELS
 - 2 ALUMINUM WINDOWS INTEGRAL TO METAL WALL PANEL SYSTEM
 - 3 ROOF FASCIA
 - 4 MECHANICAL LOUVER - REFER TO MECHANICAL DRAWINGS
 - 5 MECHANICAL EQUIPMENT OR DUCTWORK - REFER TO MECHANICAL DRAWINGS
 - 6 NEW INSULATED GLAZED PANEL IN EXISTING CURTAIN WALL FRAMING. GLASS TYPE TO BE FCG/HCL
 - 7 NEW SECTIONAL OVERHEAD DOOR IN EXISTING CURTAIN WALL FRAMING
 - 8 INFILL EXTERIOR WALL OPENING WITH CMU, AIR BARRIER, INSULATION AND BRICK, THICKNESS, COLOR, AND BOND PATTERN TO MATCH EXISTING. TOOTH-IN MASONRY, TYPICAL.
 - 9 ALUMINUM STOREFRONT SYSTEM
 - 10 CANOPY STRUCTURE - PAINT TYP
 - 11 ROOF ACCESS SHIPS LADDER
 - 12 PROVIDE NEW INSULATED PANEL IN EXISTING FRAMING
 - 13 GUTTER AND DOWNSPOUT
 - 14 DOWNSPOUT NOZZLE - SEE PLUMBING DRAWINGS
 - 15 EXTERIOR LIGHT - SEE ELECTRICAL DRAWINGS
 - 16 NEW DUST COLLECTOR IN STEEL FRAMED ACOUSTIC LOUVER SYSTEM - SEE STRU AND MECH DRAWINGS
 - 17 MOVABLE SAFETY RAIL - SEE SPECIFICATIONS
 - 18 STRUCTURAL WALL BRACING - SEE STRUCTURAL DRAWINGS

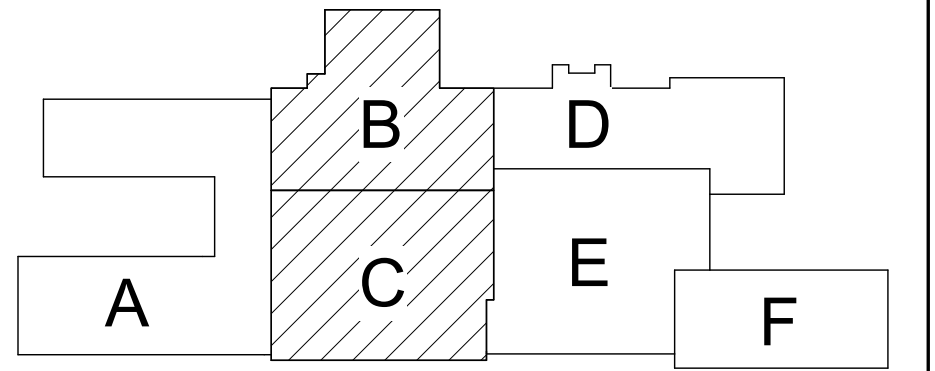

Key Plan
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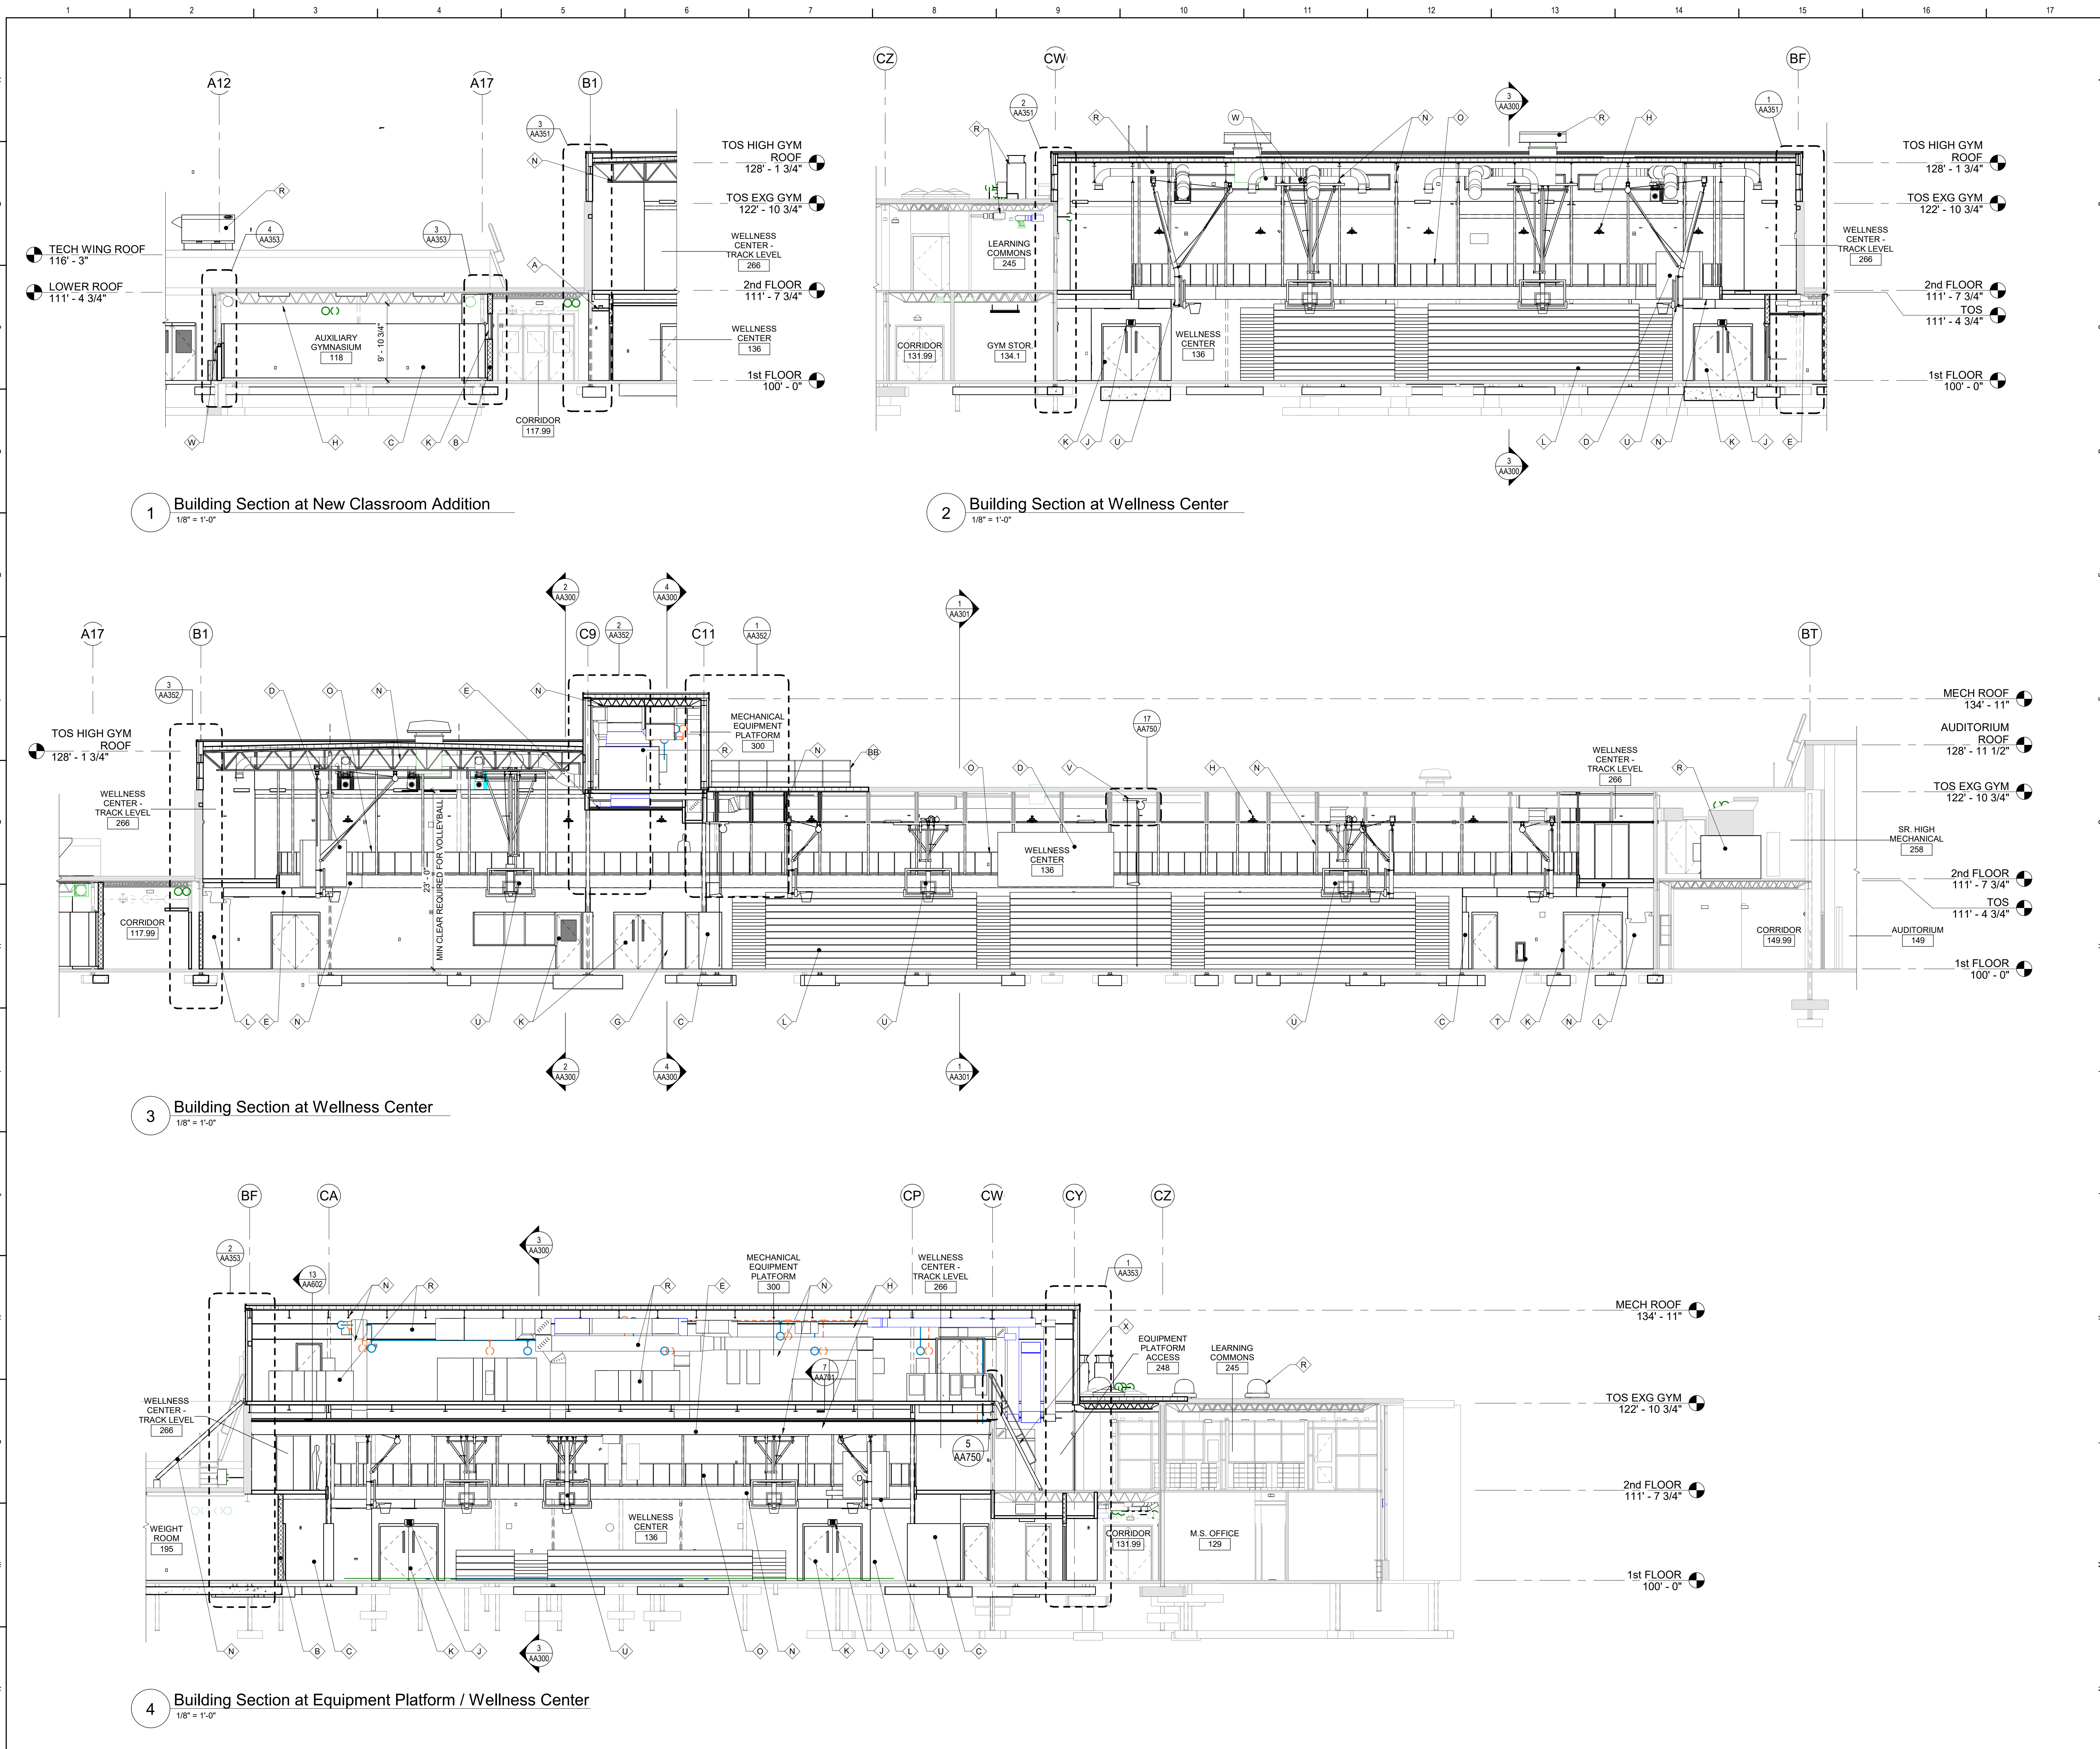


Waverly Central School District
Waverly, NY


Additions and Alterations to:
Waverly Jr. Sr. High School

Exterior Elevations

Drawn By: KCB	Date: 05/19/2023	Drawing Number:
Project No.: 339070-22003	AA201	



- Keyed Building Section Notes**
- 5/8" GYPSUM. BD. ON METAL STUDS
 - CONCRETE MASONRY UNITS
 - GYM WALL PADS - REFER TO SPECIFICATIONS
 - SCOREBOARD OR VIDEO DISPLAY - REFER TO SPECIFICATIONS
 - CEILINGS AND SOFFITS - SEE REFLECTED CEILING PLANS
 - CASEWORK OR FURNITURE - REFER TO ENLARGED PLANS AND INTERIOR ELEVATIONS
 - PORTABLE BLEACHERS - REFER TO SPECIFICATIONS
 - REFER TO ELECTRICAL DRAWINGS FOR LIGHTING LOCATIONS AND INFORMATION
 - EXIT SIGN - REFER TO ELECTRICAL DRAWINGS
 - DOOR OR INTERIOR WINDOW - REFER TO DOOR SCHEDULE
 - FLOOR SUPPORTED BLEACHERS - REFER TO SPECIFICATIONS
 - 5/8" GYP BD ADHERED TO BLOCK OR CIP CONC - REFER TO PLAN AND SECTION DRAWINGS
 - STEEL STRUCTURE - REFER TO STRUCTURAL DRAWINGS
 - PAINTED STEEL PIPE RAILINGS WITH MESH INFILL
 - SPEAKER BOX - REFER TO ELECTRICAL DRAWINGS
 - BASE - REFER TO FINISH DRAWINGS
 - MECHANICAL EQUIPMENT OR DUCTWORK - REFER TO MECHANICAL DRAWINGS
 - MAT HOIST - REFER TO SPECIFICATIONS
 - FIRE EXTINGUISHER CABINET
 - BASKETBALL BACKSTOP ASSEMBLY - REFER TO SPECIFICATIONS
 - MOTORIZED CENTER-ROLL CURTAIN - REFER TO SPECIFICATIONS
 - WINDOW, STOREFRONT OR CURTAIN WALL SYSTEM - REFER TO TYPES AND DETAILS ON A601
 - SHIPS LADDER - REFER TO DETAIL ON AA750
 - AIR COMPRESSOR - REFER TO PLUMBING DRAWINGS
 - NOT USED
 - DUST COLLECTOR IN STEEL FRAMED ACOUSTIC LOUVER ENCLOSURE - SEE STRU AND MECH DWGS
 - MOVABLE SAFETY RAIL - REFER TO SPECIFICATIONS

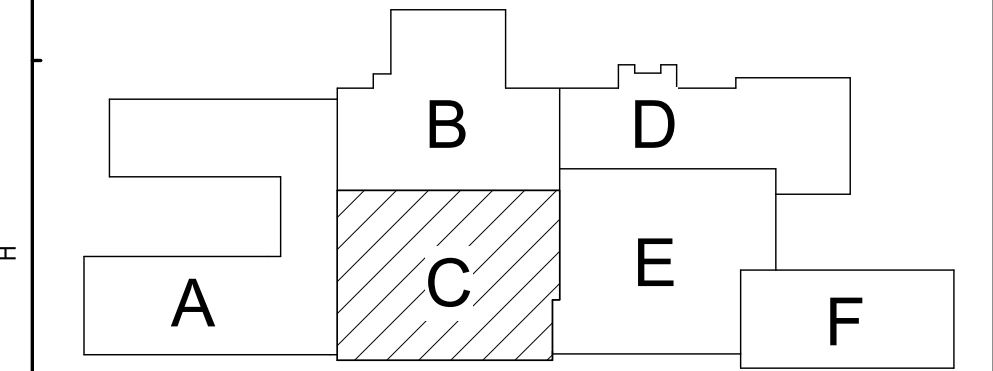

Key Plan
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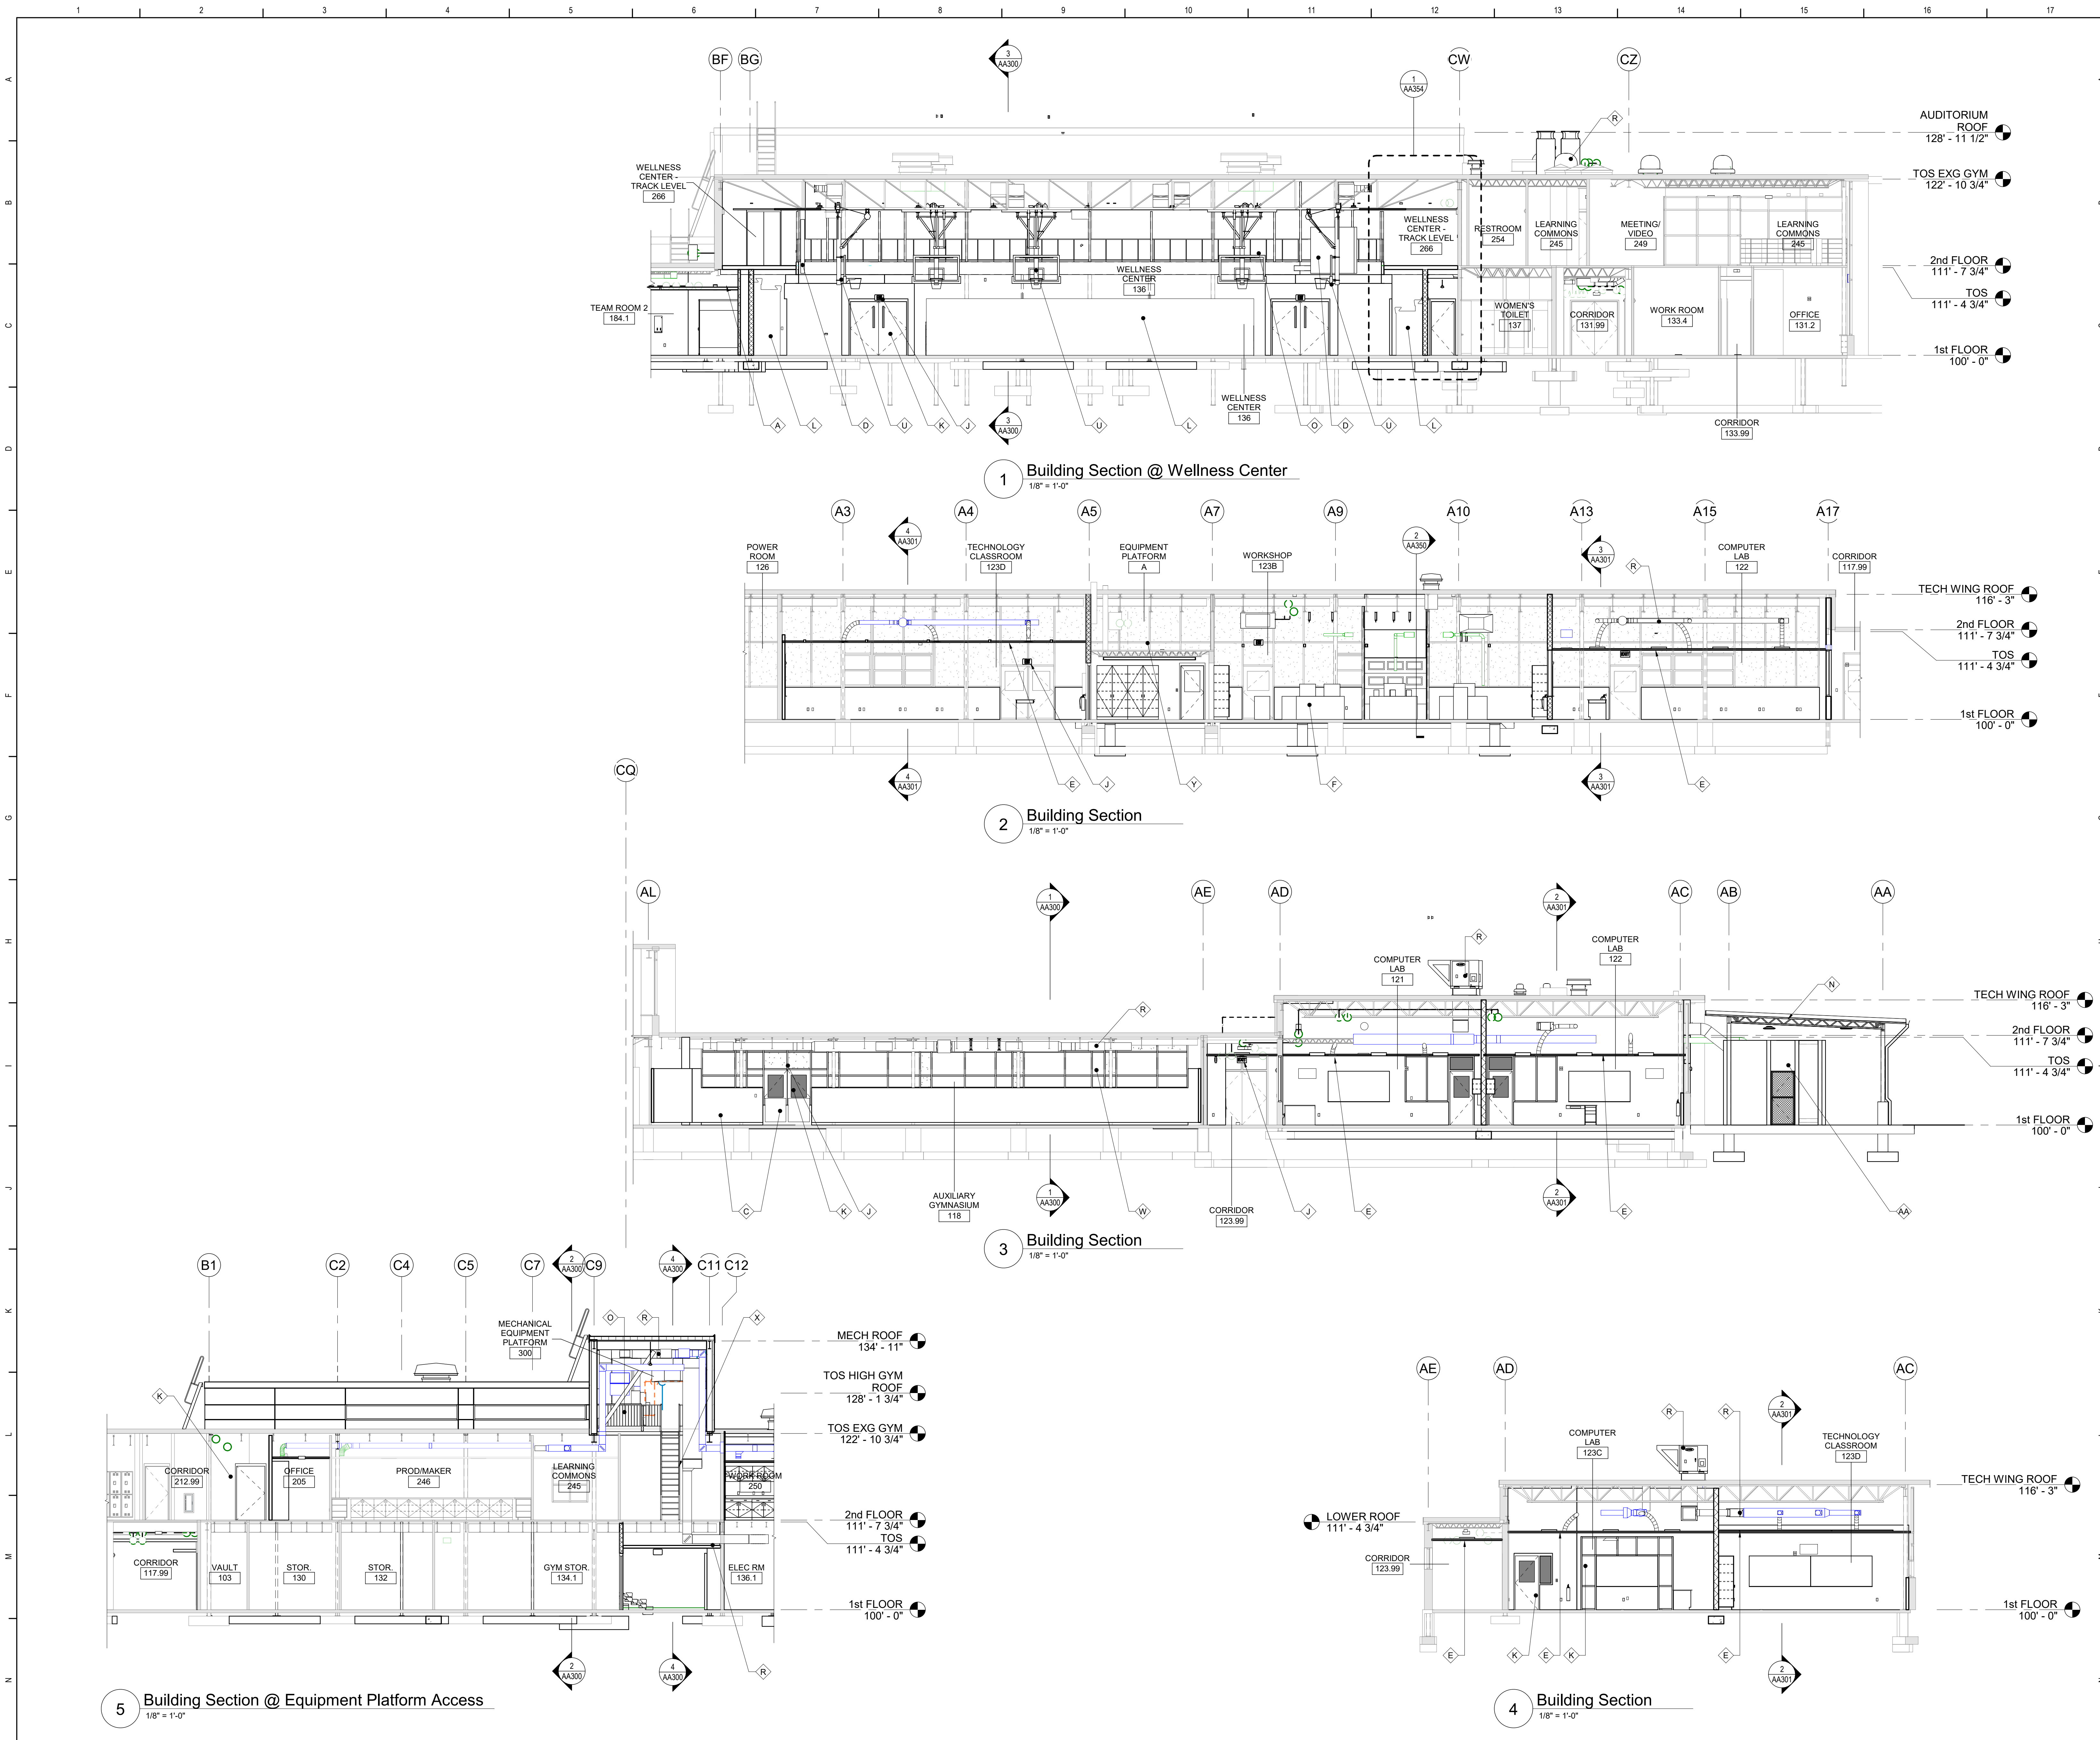


Waverly Central School District
Waverly, NY

Additions and Alterations to:
Waverly Jr. Sr. High School


Building Sections

Drawn By: KCB	Date: 05/19/2023	Drawing Number:
Project No.: 339070-22003		AA300



Keyed Building Section Notes

- 5/8" GYPSUM. BD. ON METAL STUDS
- CONCRETE MASONRY UNITS
- GYM WALL PADS - REFER TO SPECIFICATIONS
- SCOREBOARD OR VIDEO DISPLAY - REFER TO SPECIFICATIONS
- CEILINGS AND SOFFITS - SEE REFLECTED CEILING PLANS
- CASEWORK OR FURNITURE - REFER TO ENLARGED PLANS AND INTERIOR ELEVATIONS
- PORTABLE BLEACHERS - REFER TO SPECIFICATIONS
- REFER TO ELECTRICAL DRAWINGS FOR LIGHTING LOCATIONS AND INFORMATION
- EXIT SIGN - REFER TO ELECTRICAL DRAWINGS
- DOOR OR INTERIOR WINDOW - REFER TO DOOR SCHEDULE
- FLOOR SUPPORTED BLEACHERS - REFER TO SPECIFICATIONS
- 5/8" GYP BD ADHERED TO BLOCK OR CIP CONC - REFER TO PLAN AND SECTION DRAWINGS
- STEEL STRUCTURE - REFER TO STRUCTURAL DRAWINGS
- PAINTED STEEL PIPE RAILINGS WITH MESH INFILL
- SPEAKER BOX - REFER TO ELECTRICAL DRAWINGS
- BASE - REFER TO FINISH DRAWINGS
- MECHANICAL EQUIPMENT OR DUCTWORK - REFER TO MECHANICAL DRAWINGS
- MAT HOIST - REFER TO SPECIFICATIONS
- FIRE EXTINGUISHER CABINET
- BASKETBALL BACKSTOP ASSEMBLY - REFER TO SPECIFICATIONS
- MOTORIZED CENTER-ROLL CURTAIN - REFER TO SPECIFICATIONS
- WINDOW, STOREFRONT OR CURTAIN WALL SYSTEM - REFER TO TYPES AND DETAILS ON A601
- SHIPS LADDER - REFER TO DETAIL ON AA750
- AIR COMPRESSOR - REFER TO PLUMBING DRAWINGS
- NOT USED
- DUST COLLECTOR IN STEEL FRAMED ACOUSTIC LOUVER ENCLOSURE - SEE STRU AND MECH DWGS
- MOVABLE SAFETY RAIL - REFER TO SPECIFICATIONS

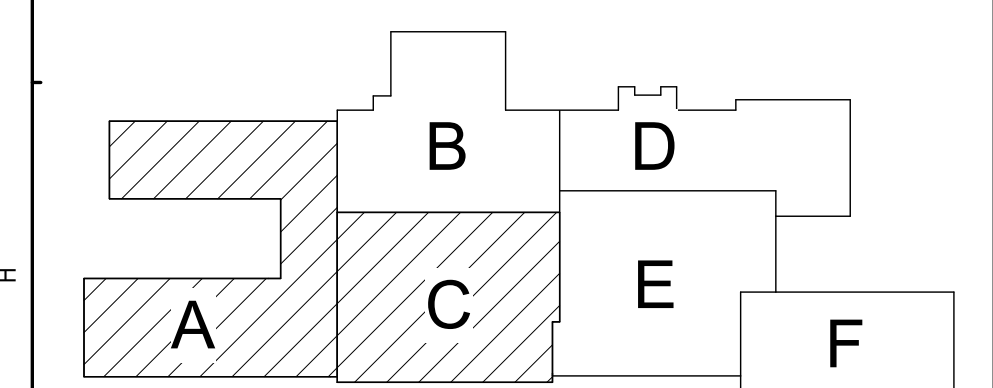

Key Plan
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& Landscape Architects, P.C.

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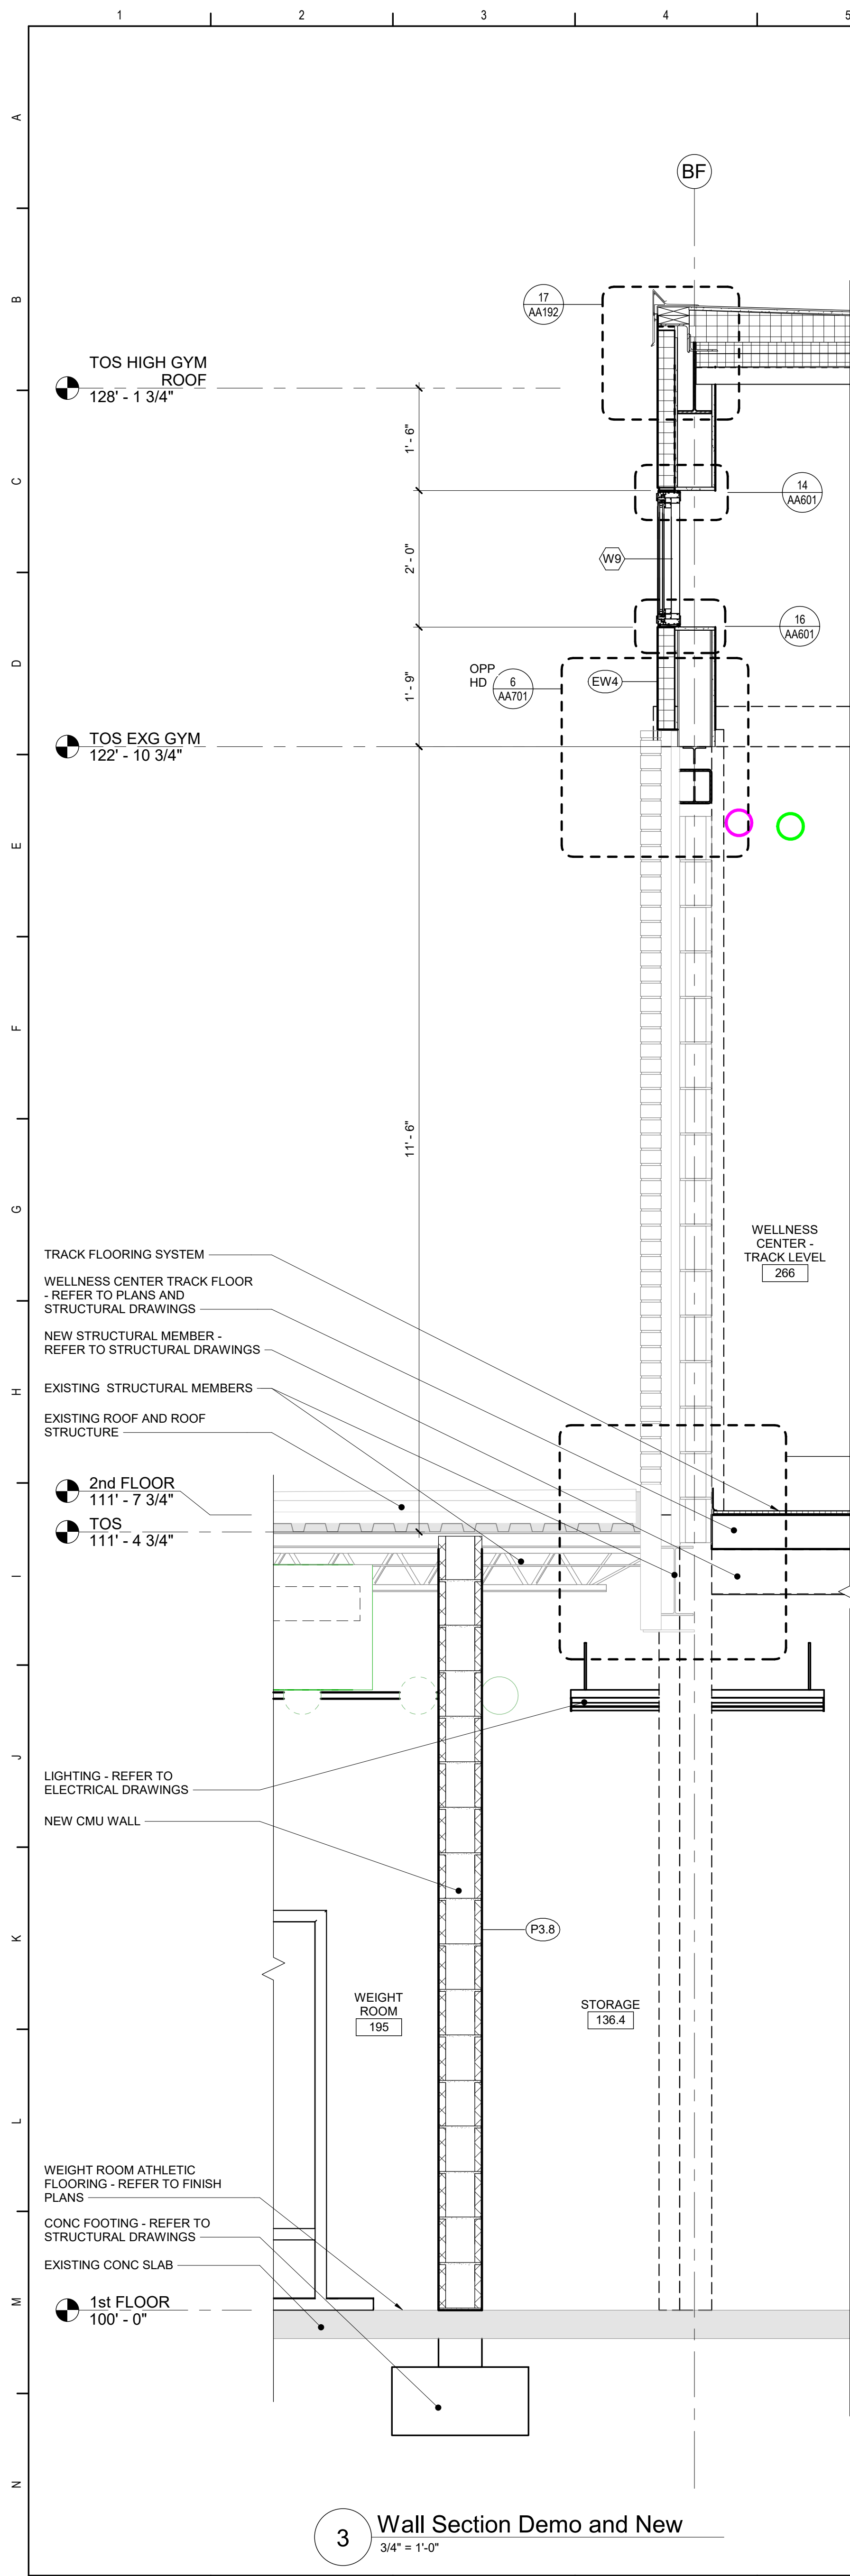
TETRA TECH
ARCHITECTS & ENGINEERS

Waverly Central School District
Waverly, NY


Additions and Alterations to:
Waverly Jr. Sr. High School

Building Sections


Drawn By: KCB	Date: 05/19/2023	Drawing Number:
Project No.: 339070-22003	AA301	



3 Wall Section Demo and New
3/4" = 1'-0"

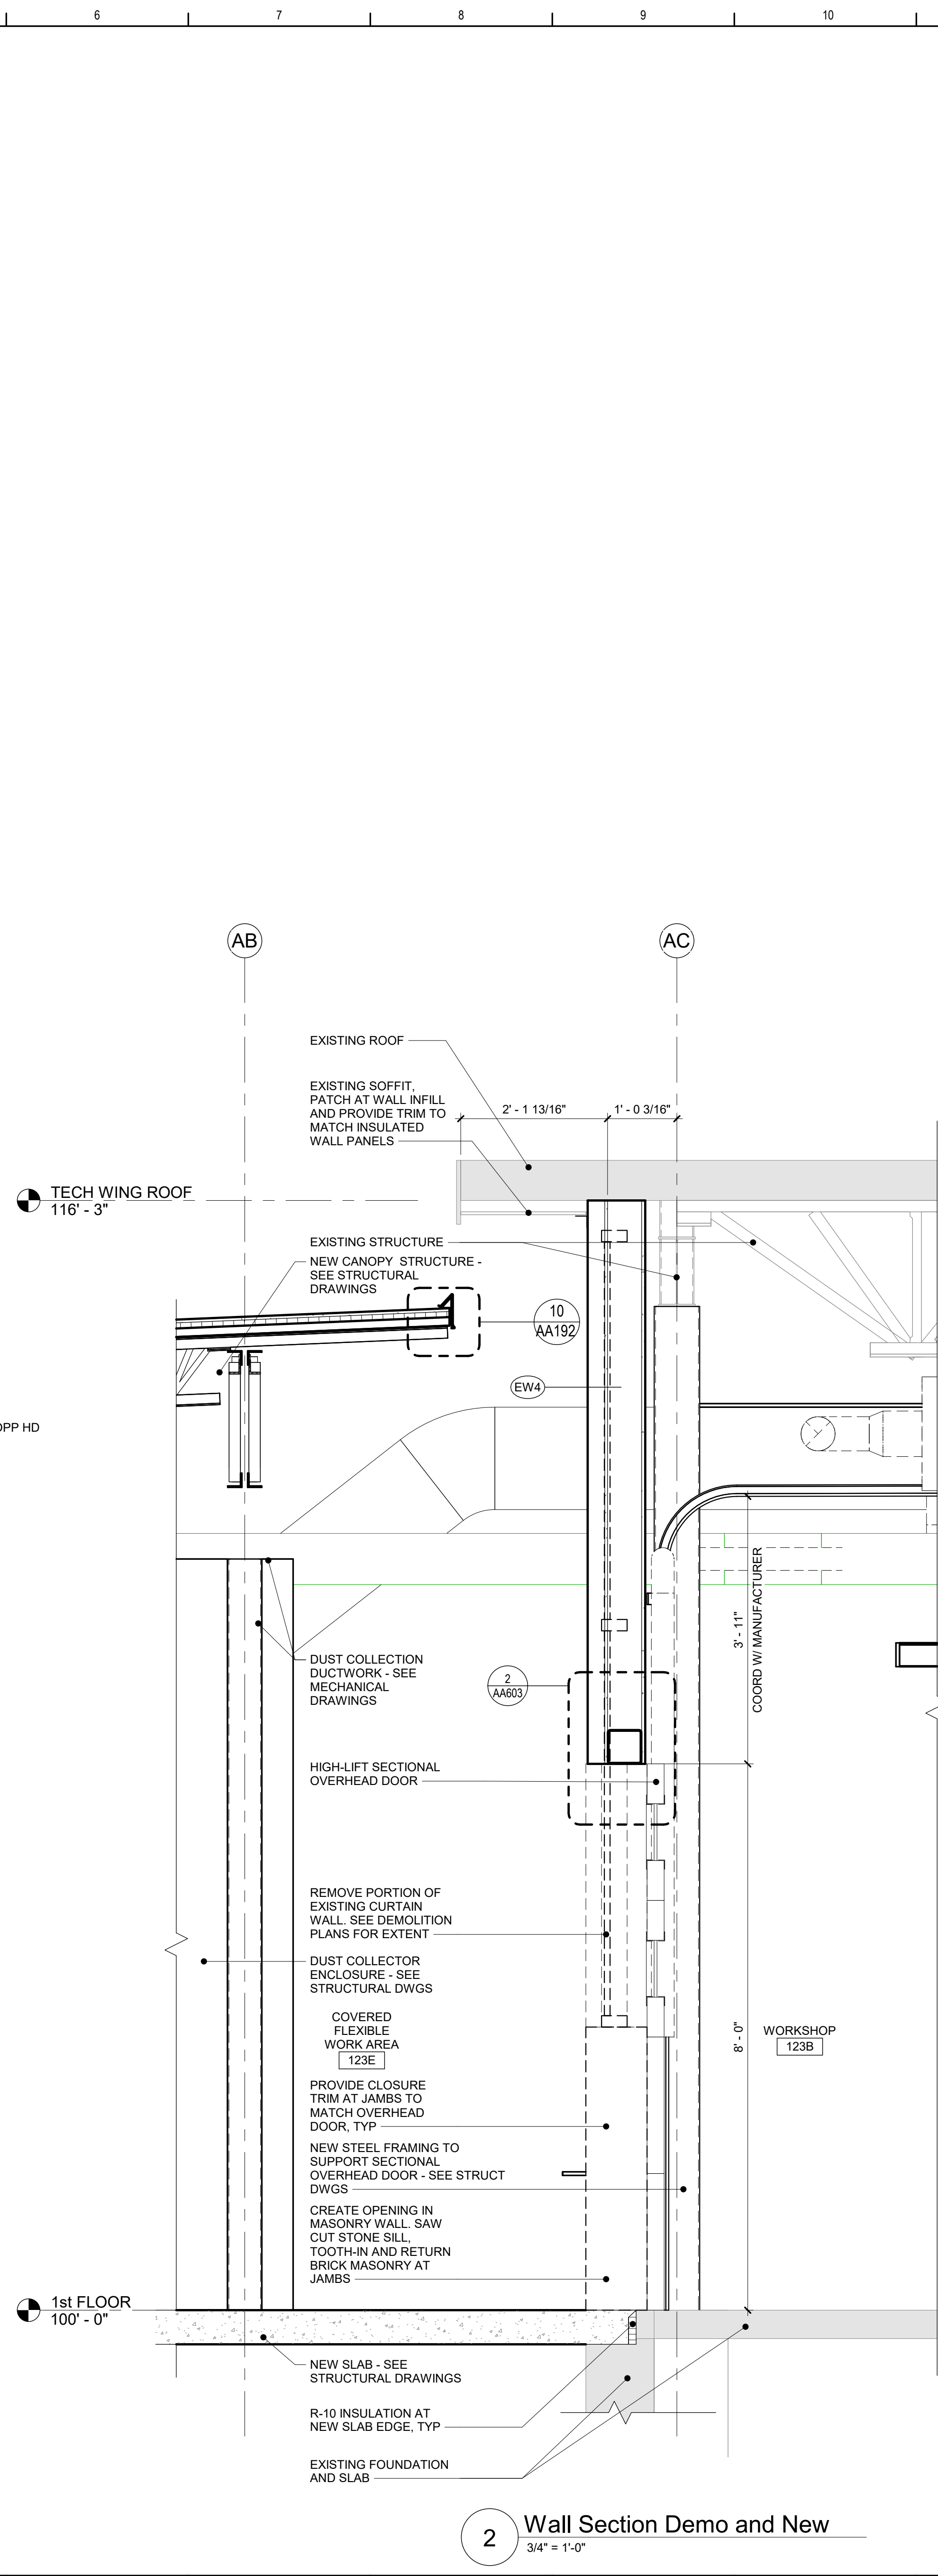

2 Wall Section Demo and New
3/4" = 1'-0"

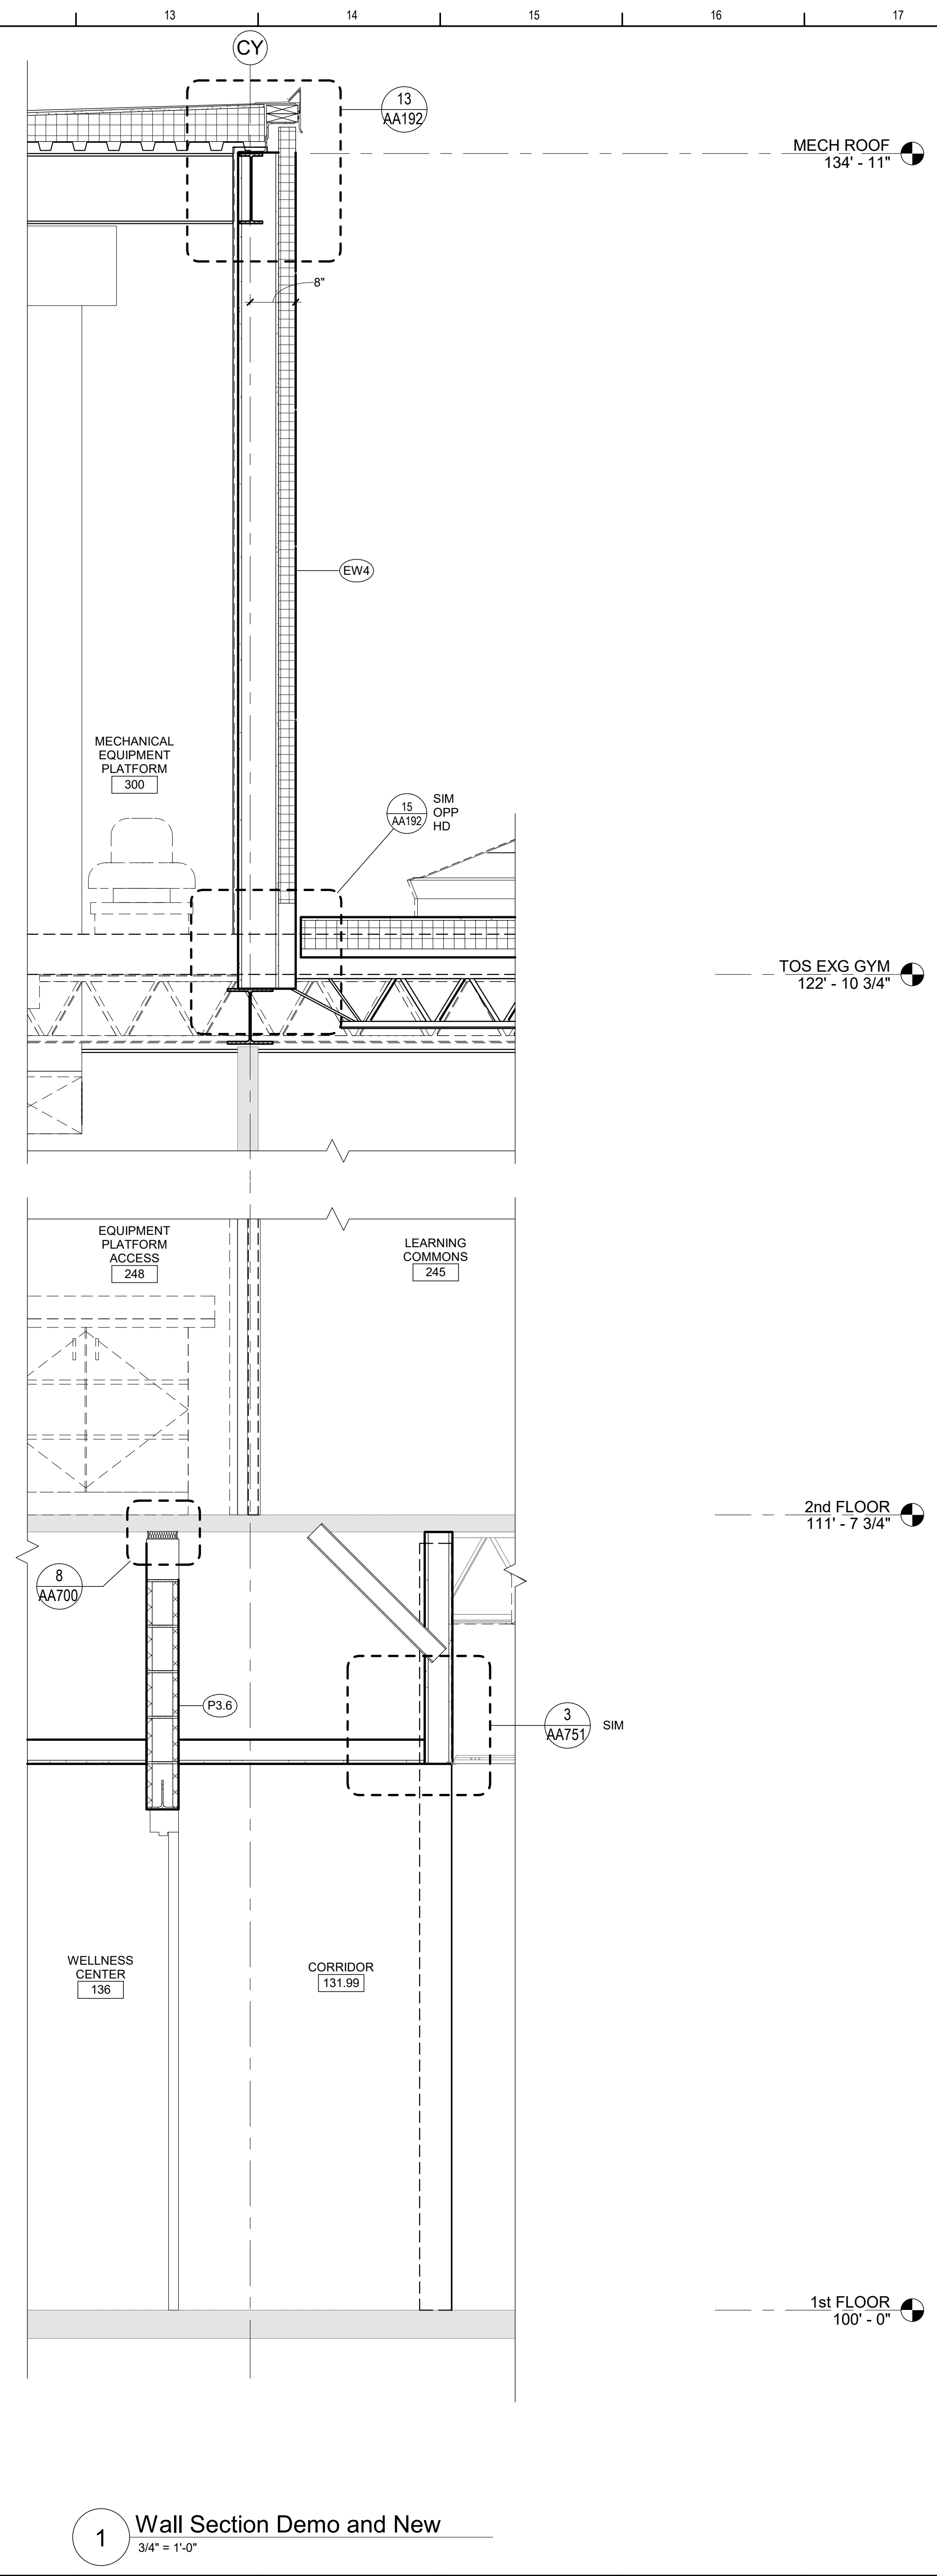

1 Wall Section Demo and New
3/4" = 1'-0"

General Construction Notes

- A. DETAILS AND SECTIONS INDICATE SPECIFIC MATERIALS AND LAYOUT DIMENSIONS. REFER TO MASONRY PLAN DETAILS FOR SPECIFIC REQUIREMENTS REGARDING CONTROL AND EXPANSION JOINTS, TIES AND REINFORCEMENT, ETC.
- B. ALL NOTES DESCRIBED ON ONE SECTION OR DETAIL APPLY TO ALL SECTIONS OR DETAILS, TYPICAL UNLESS NOTED OTHERWISE.
- C. REFER TO FINISH DRAWINGS FOR FINISH INFORMATION.
- D. REFER TO DOOR SCHEDULE FOR ADDITIONAL DOOR INFORMATION.
- E. REFER TO STRUCTURAL DRAWINGS FOR SPECIFIC FRAMING DETAILS, LINTEL DETAILS AND SHEAR WALL DETAILS.

Key Plan

N.T.S.

SED Control No. 60-01-01-06-0-018-023

Rev. No.	Date	Description

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TETRA TECH


ARCHITECTS & ENGINEERS

Waverly Central School District
Waverly, NY


Additions and Alterations to:
Waverly Jr. Sr. High School

Wall Sections

Drawn By: KCB	Date: 05/19/2023	Drawing Number:
Project No.: 339070-22003		AA350

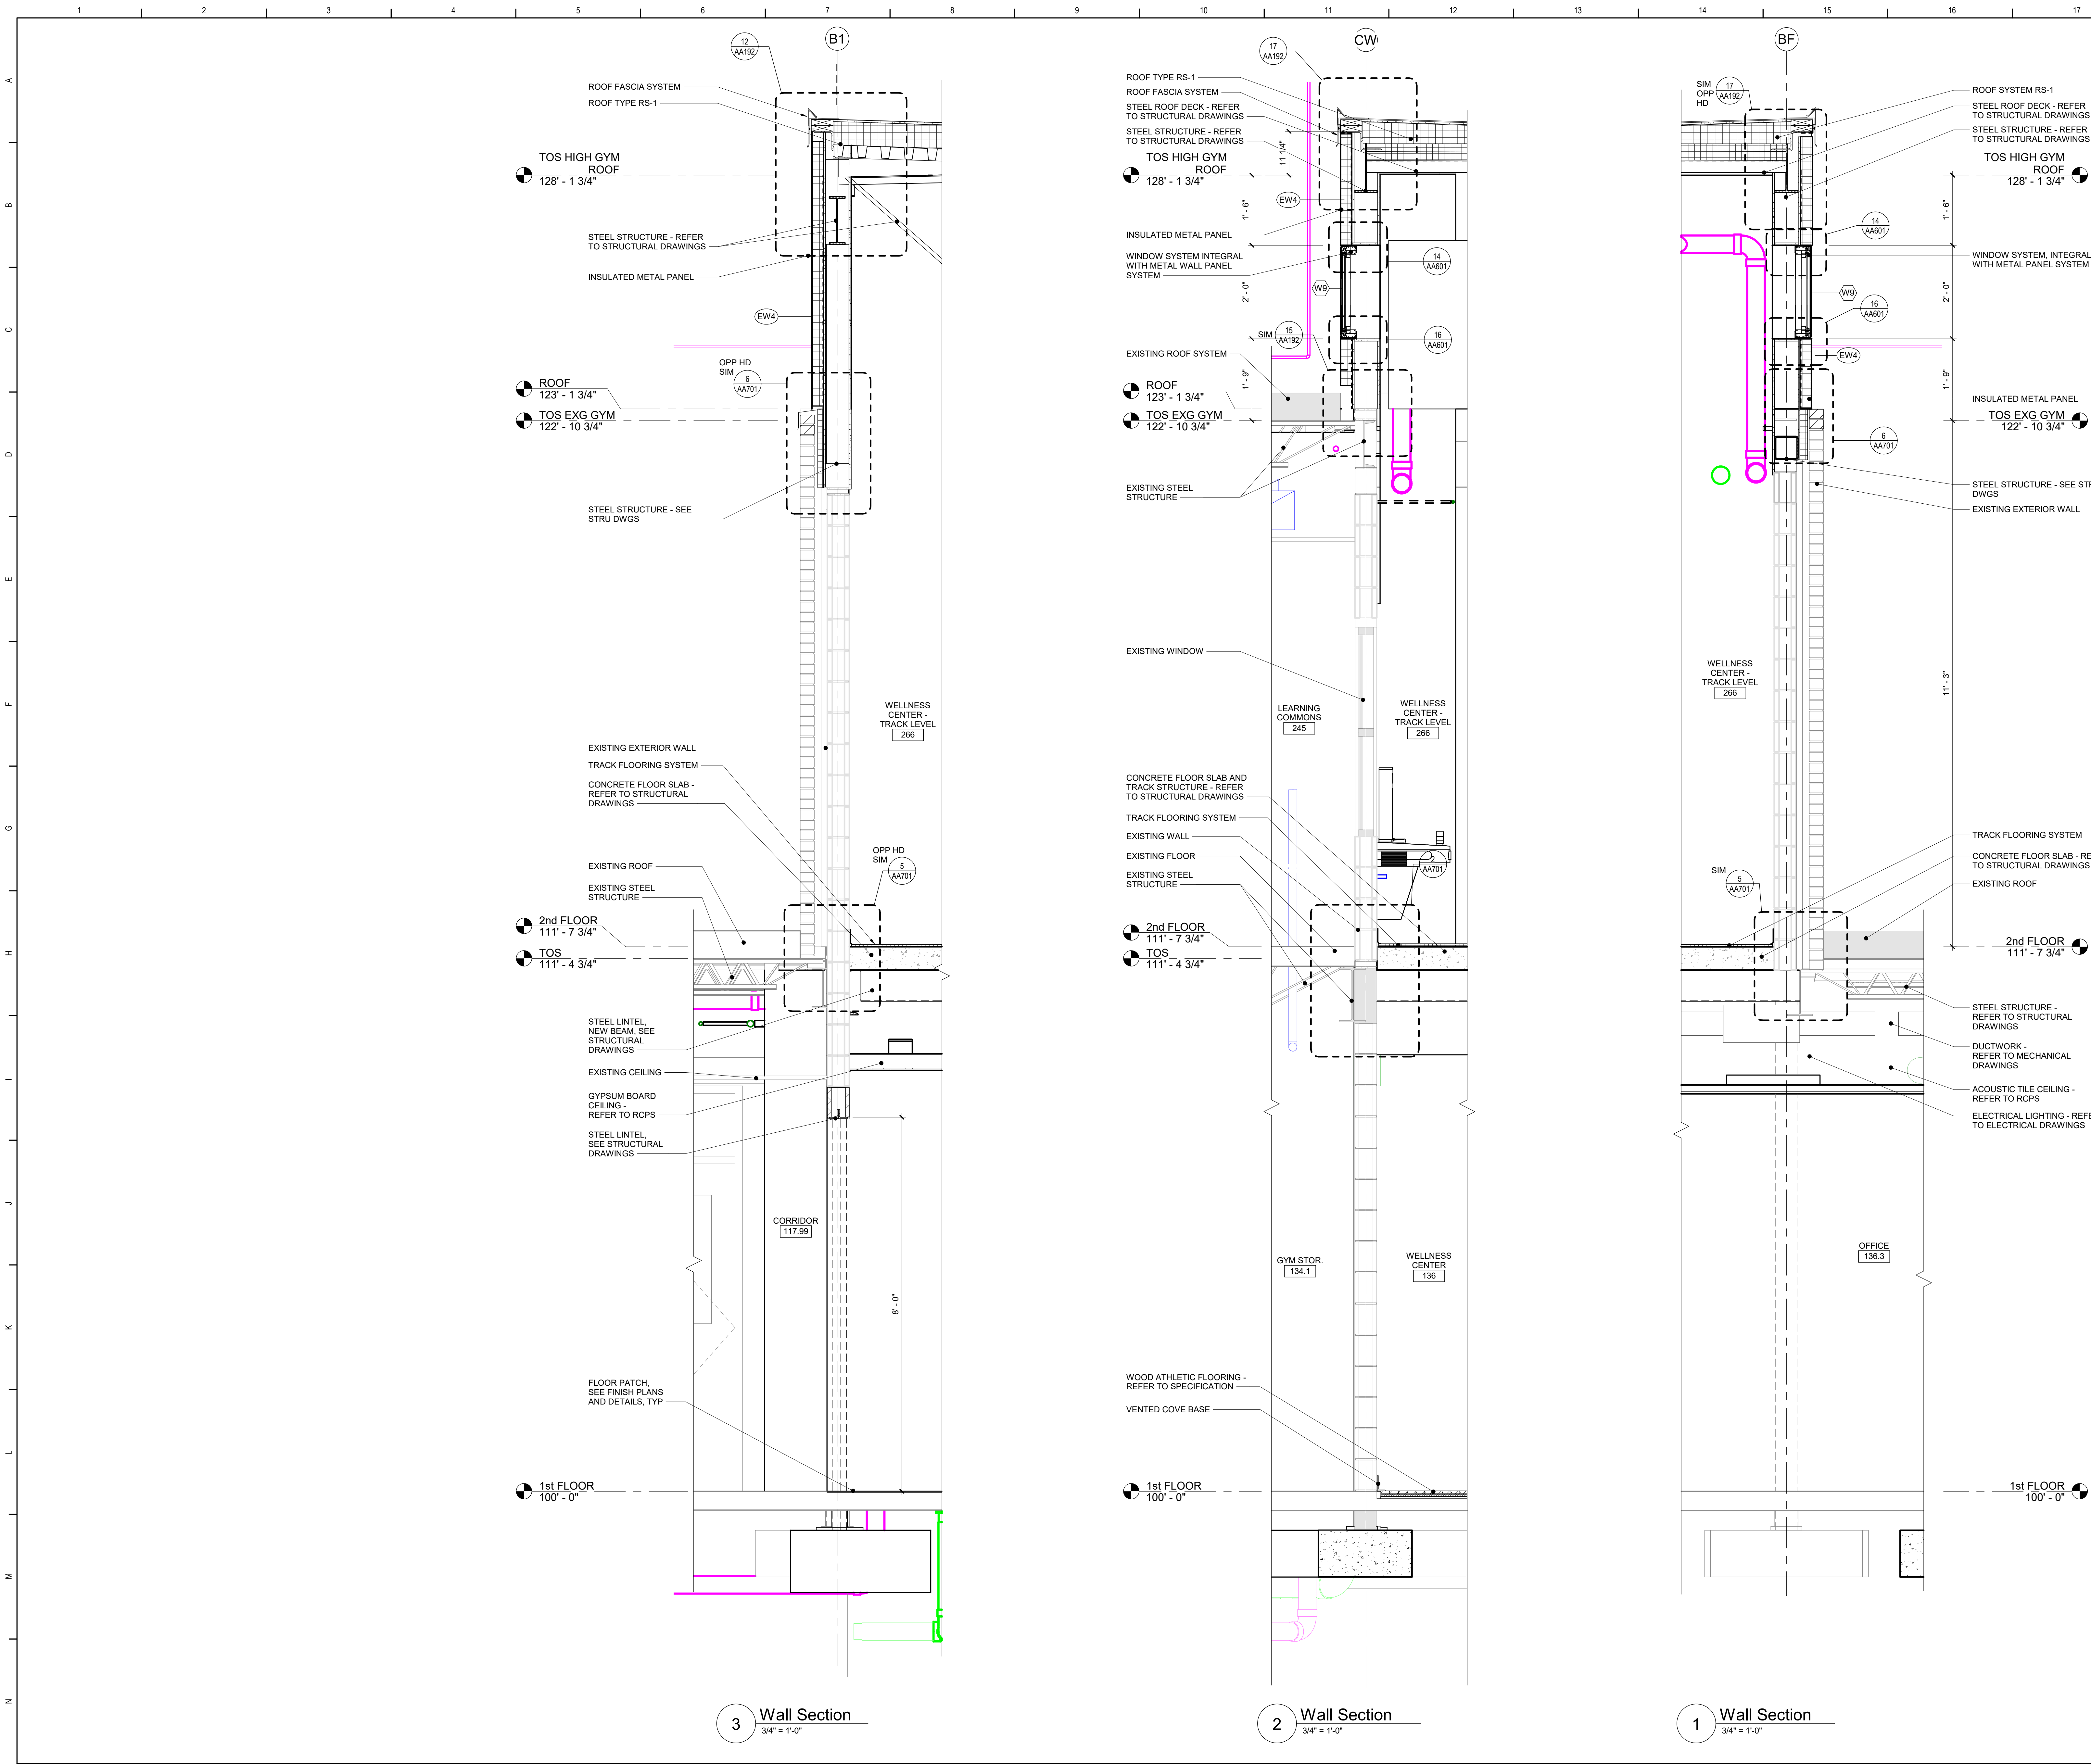

- General Construction Notes**
- A. DETAILS AND SECTIONS INDICATE SPECIFIC MATERIALS AND LAYOUT DIMENSIONS. REFER TO MASONRY PLAN DETAILS FOR SPECIFIC REQUIREMENTS REGARDING CONTROL AND EXPANSION JOINTS, TIES AND REINFORCEMENT, ETC.
 - B. ALL NOTES DESCRIBED ON ONE SECTION OR DETAIL APPLY TO ALL SECTIONS OR DETAILS, TYPICAL UNLESS NOTED OTHERWISE.
 - C. REFER TO FINISH DRAWINGS FOR FINISH INFORMATION.
 - D. REFER TO DOOR SCHEDULE FOR ADDITIONAL DOOR INFORMATION.
 - E. REFER TO STRUCTURAL DRAWINGS FOR SPECIFIC FRAMING DETAILS, LINTEL DETAILS AND SHEAR WALL DETAILS.

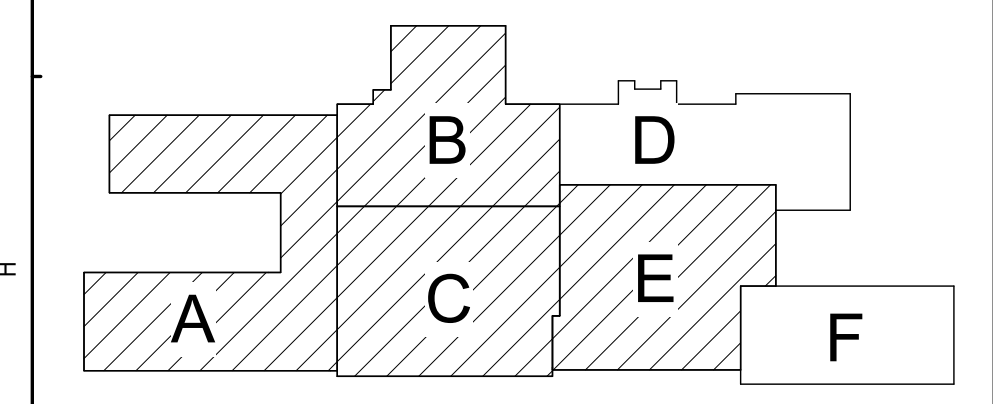

Key Plan
N.T.S.

SED Control No. 60-01-01-06-0-018-023

Rev. No.:	Date:	Description:



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BID SET




Waverly Central School District
Waverly, NY


Additions and Alterations to:
Waverly Jr. Sr. High School

Wall Sections

Drawn By: KCB	Date: 05/19/2023	Drawing Number:
Project No.:	339070-22003	AA351

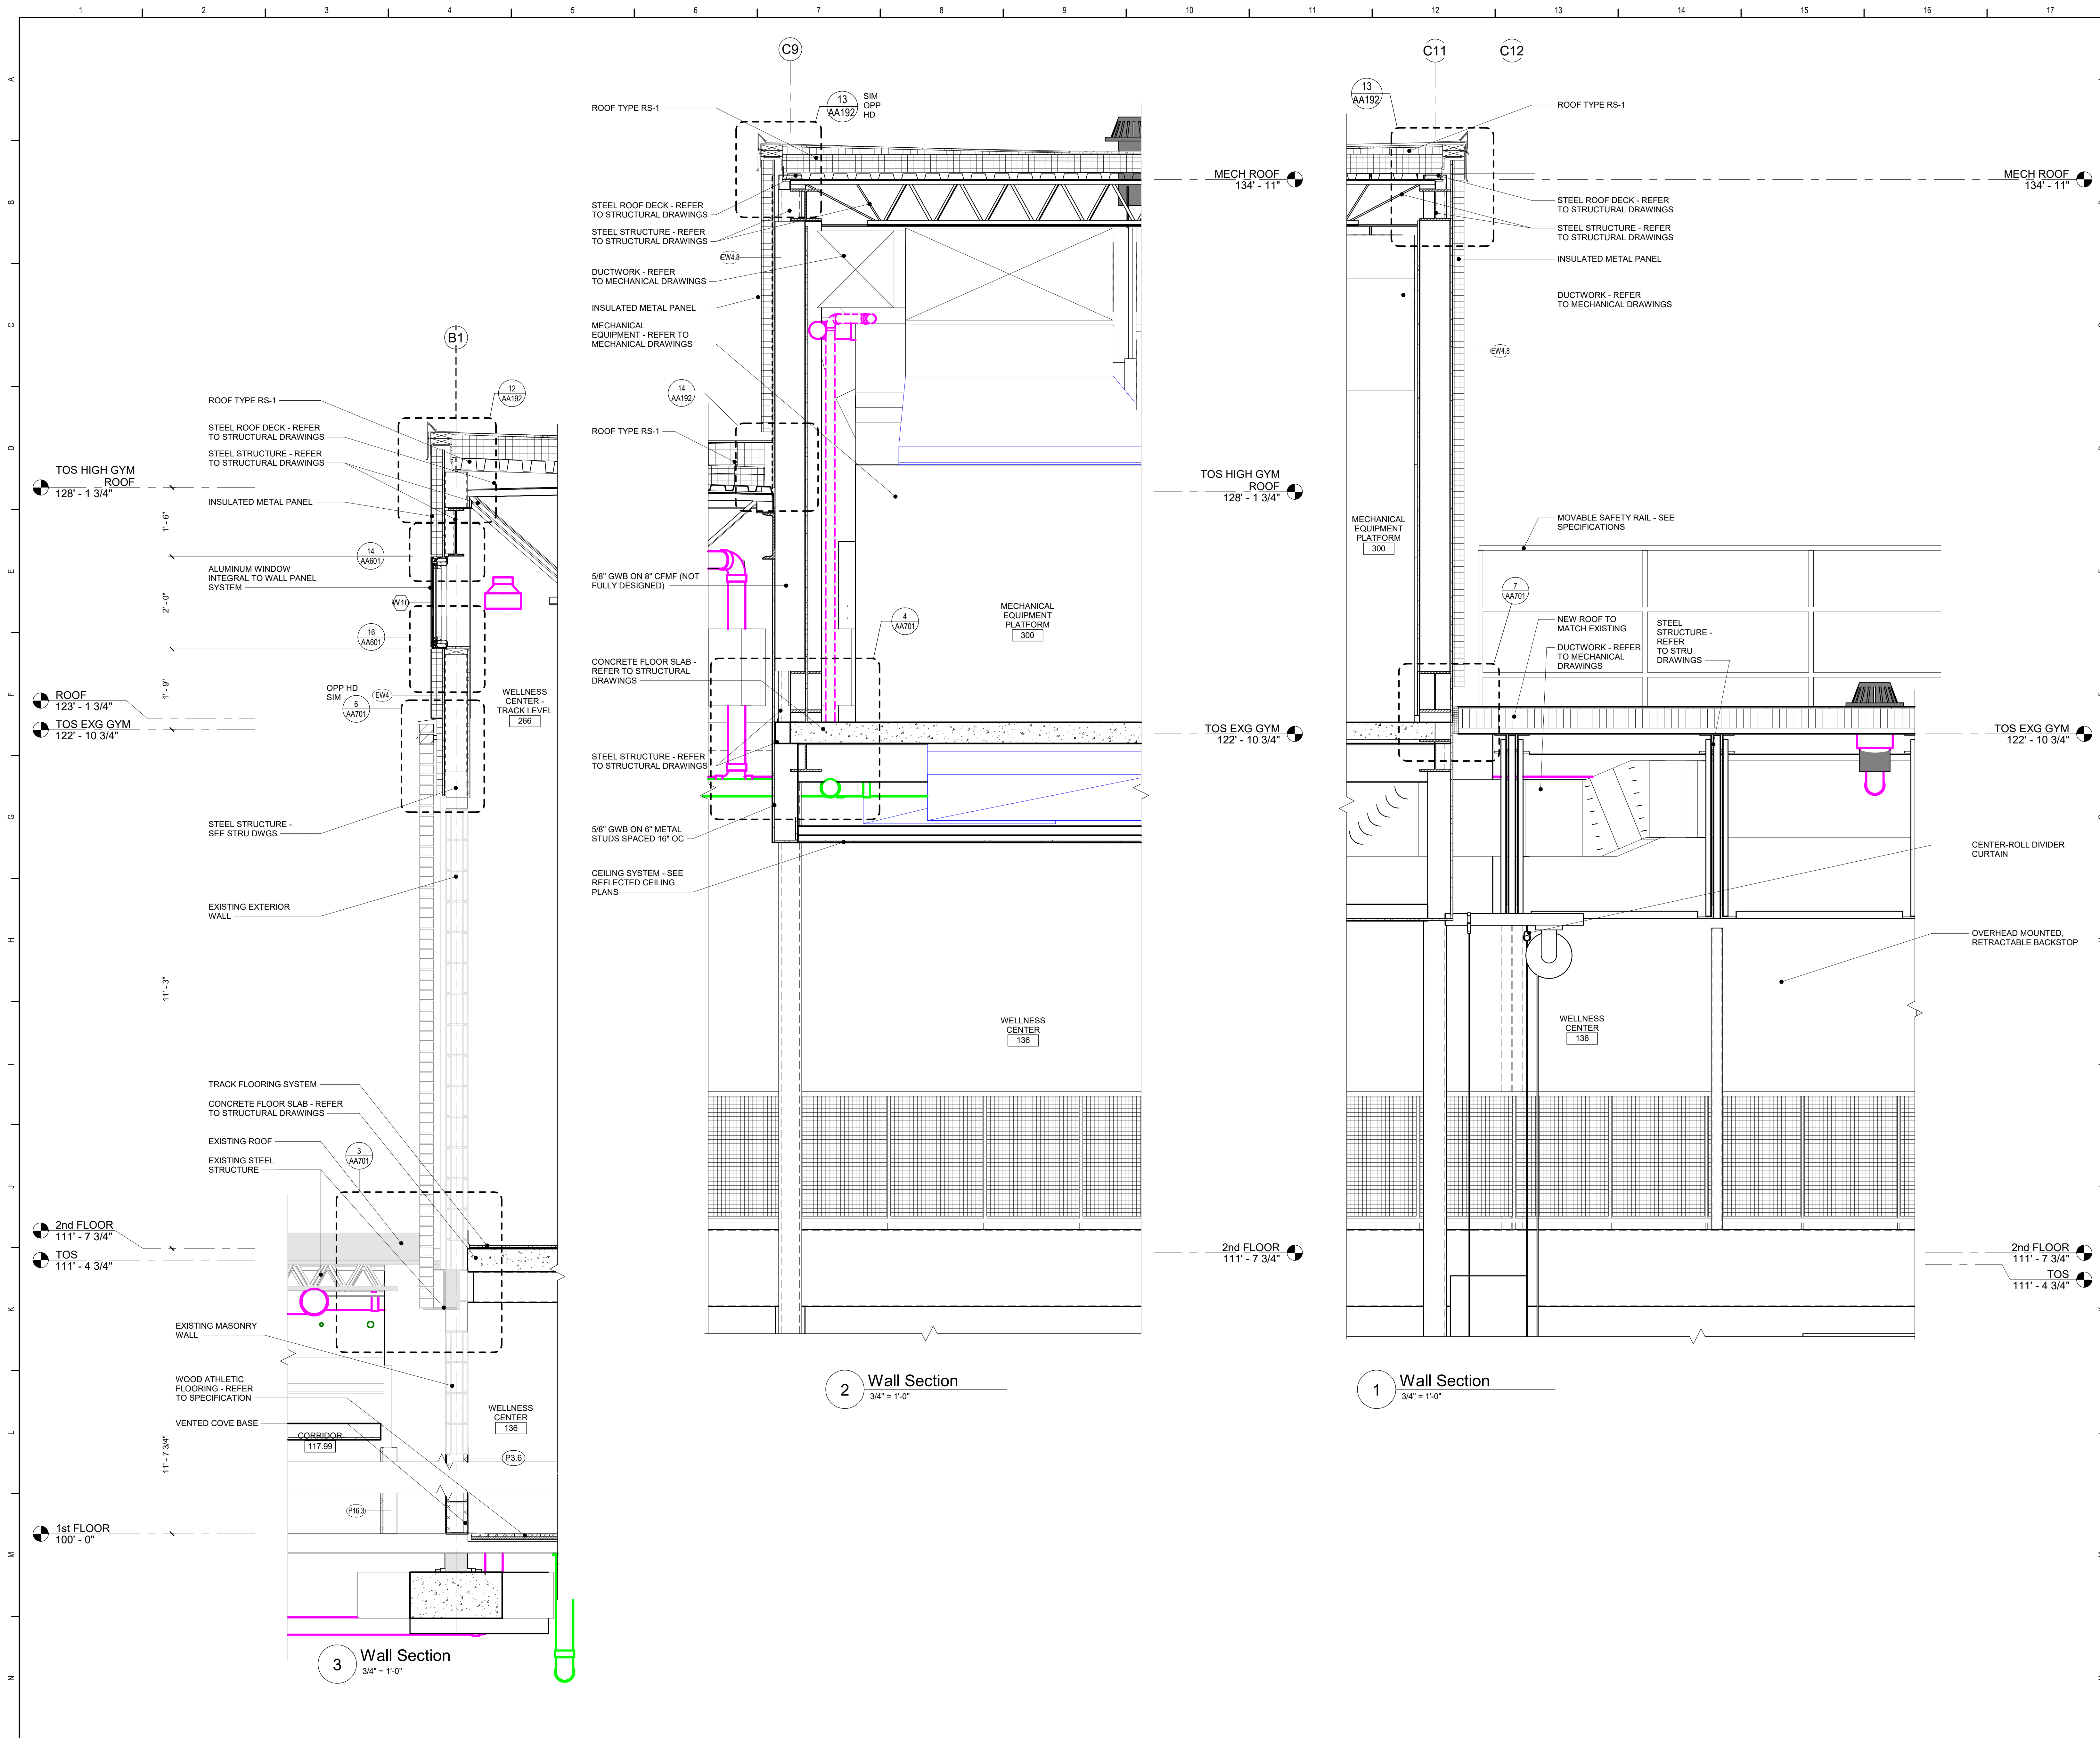

- General Construction Notes**
- A. DETAILS AND SECTIONS INDICATE SPECIFIC MATERIALS AND LAYOUT DIMENSIONS. REFER TO MASONRY PLAN DETAILS FOR SPECIFIC REQUIREMENTS REGARDING CONTROL AND EXPANSION JOINTS, TIES AND REINFORCEMENT, ETC.
 - B. ALL NOTES DESCRIBED ON ONE SECTION OR DETAIL APPLY TO ALL SECTIONS OR DETAILS, TYPICAL UNLESS NOTED OTHERWISE.
 - C. REFER TO FINISH DRAWINGS FOR FINISH INFORMATION.
 - D. REFER TO DOOR SCHEDULE FOR ADDITIONAL DOOR INFORMATION.
 - E. REFER TO STRUCTURAL DRAWINGS FOR SPECIFIC FRAMING DETAILS, LINTEL DETAILS AND SHEAR WALL DETAILS.

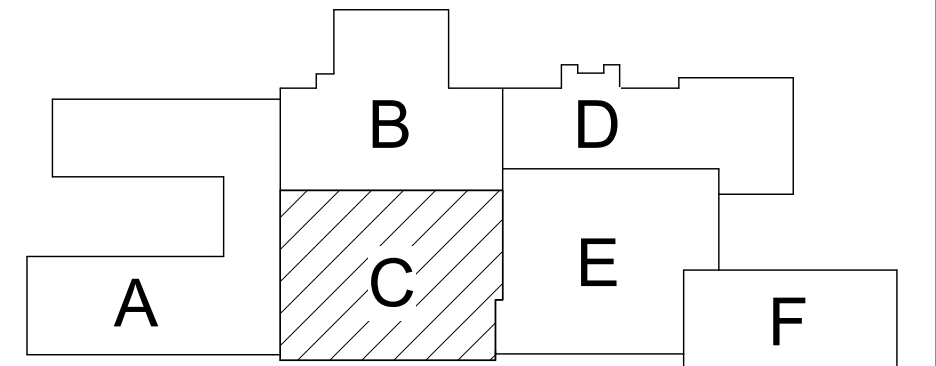

Key Plan
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SED Control No. 60-01-01-06-0-018-023

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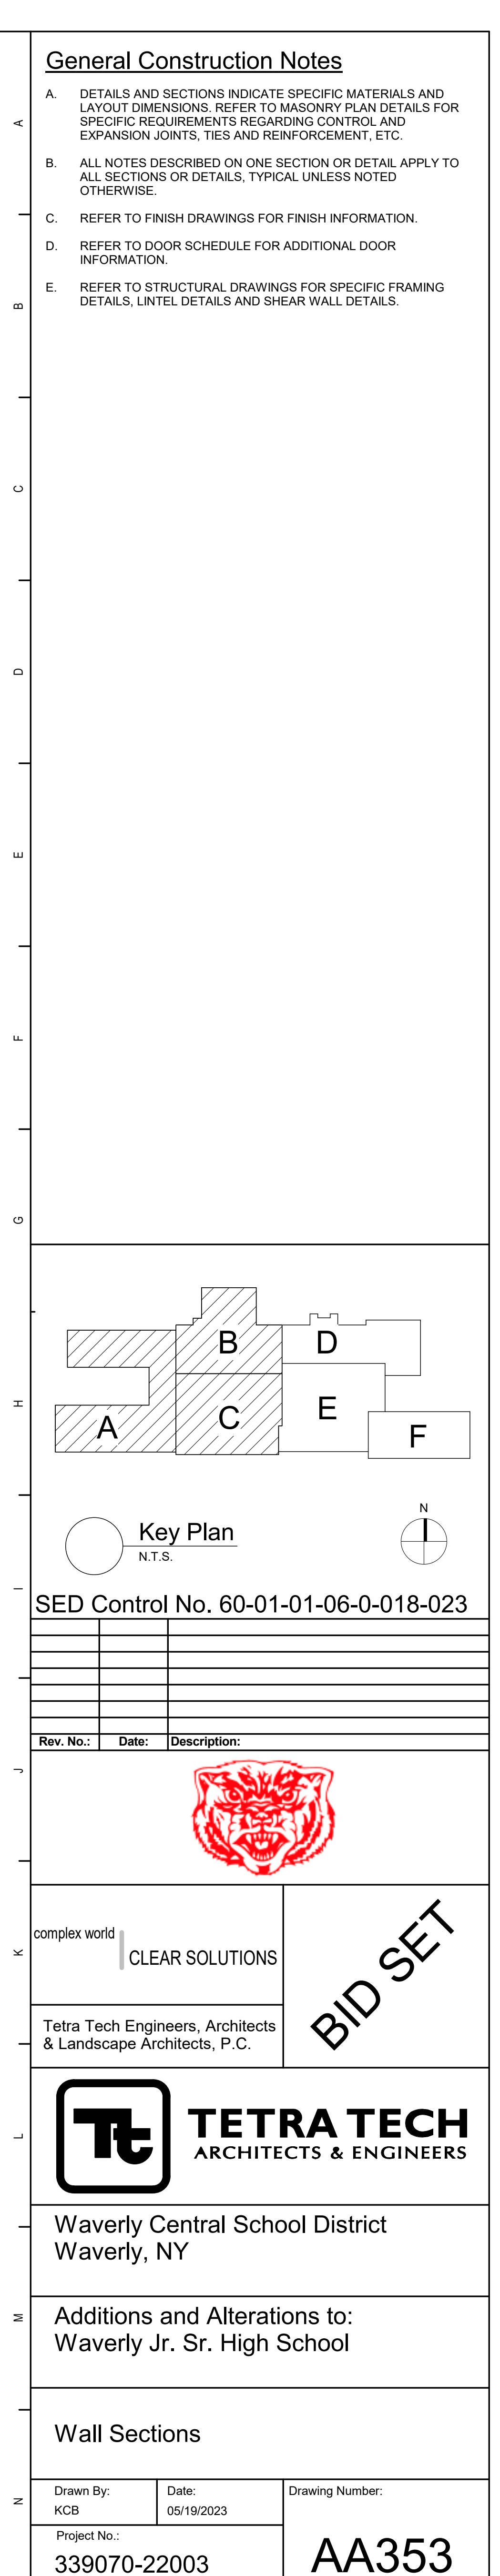



Waverly Central School District
Waverly, NY

Additions and Alterations to:
Waverly Jr. Sr. High School

Wall Sections

Drawn By: KCB
Date: 05/19/2023
Project No.: 339070-22003
Drawing Number: AA352



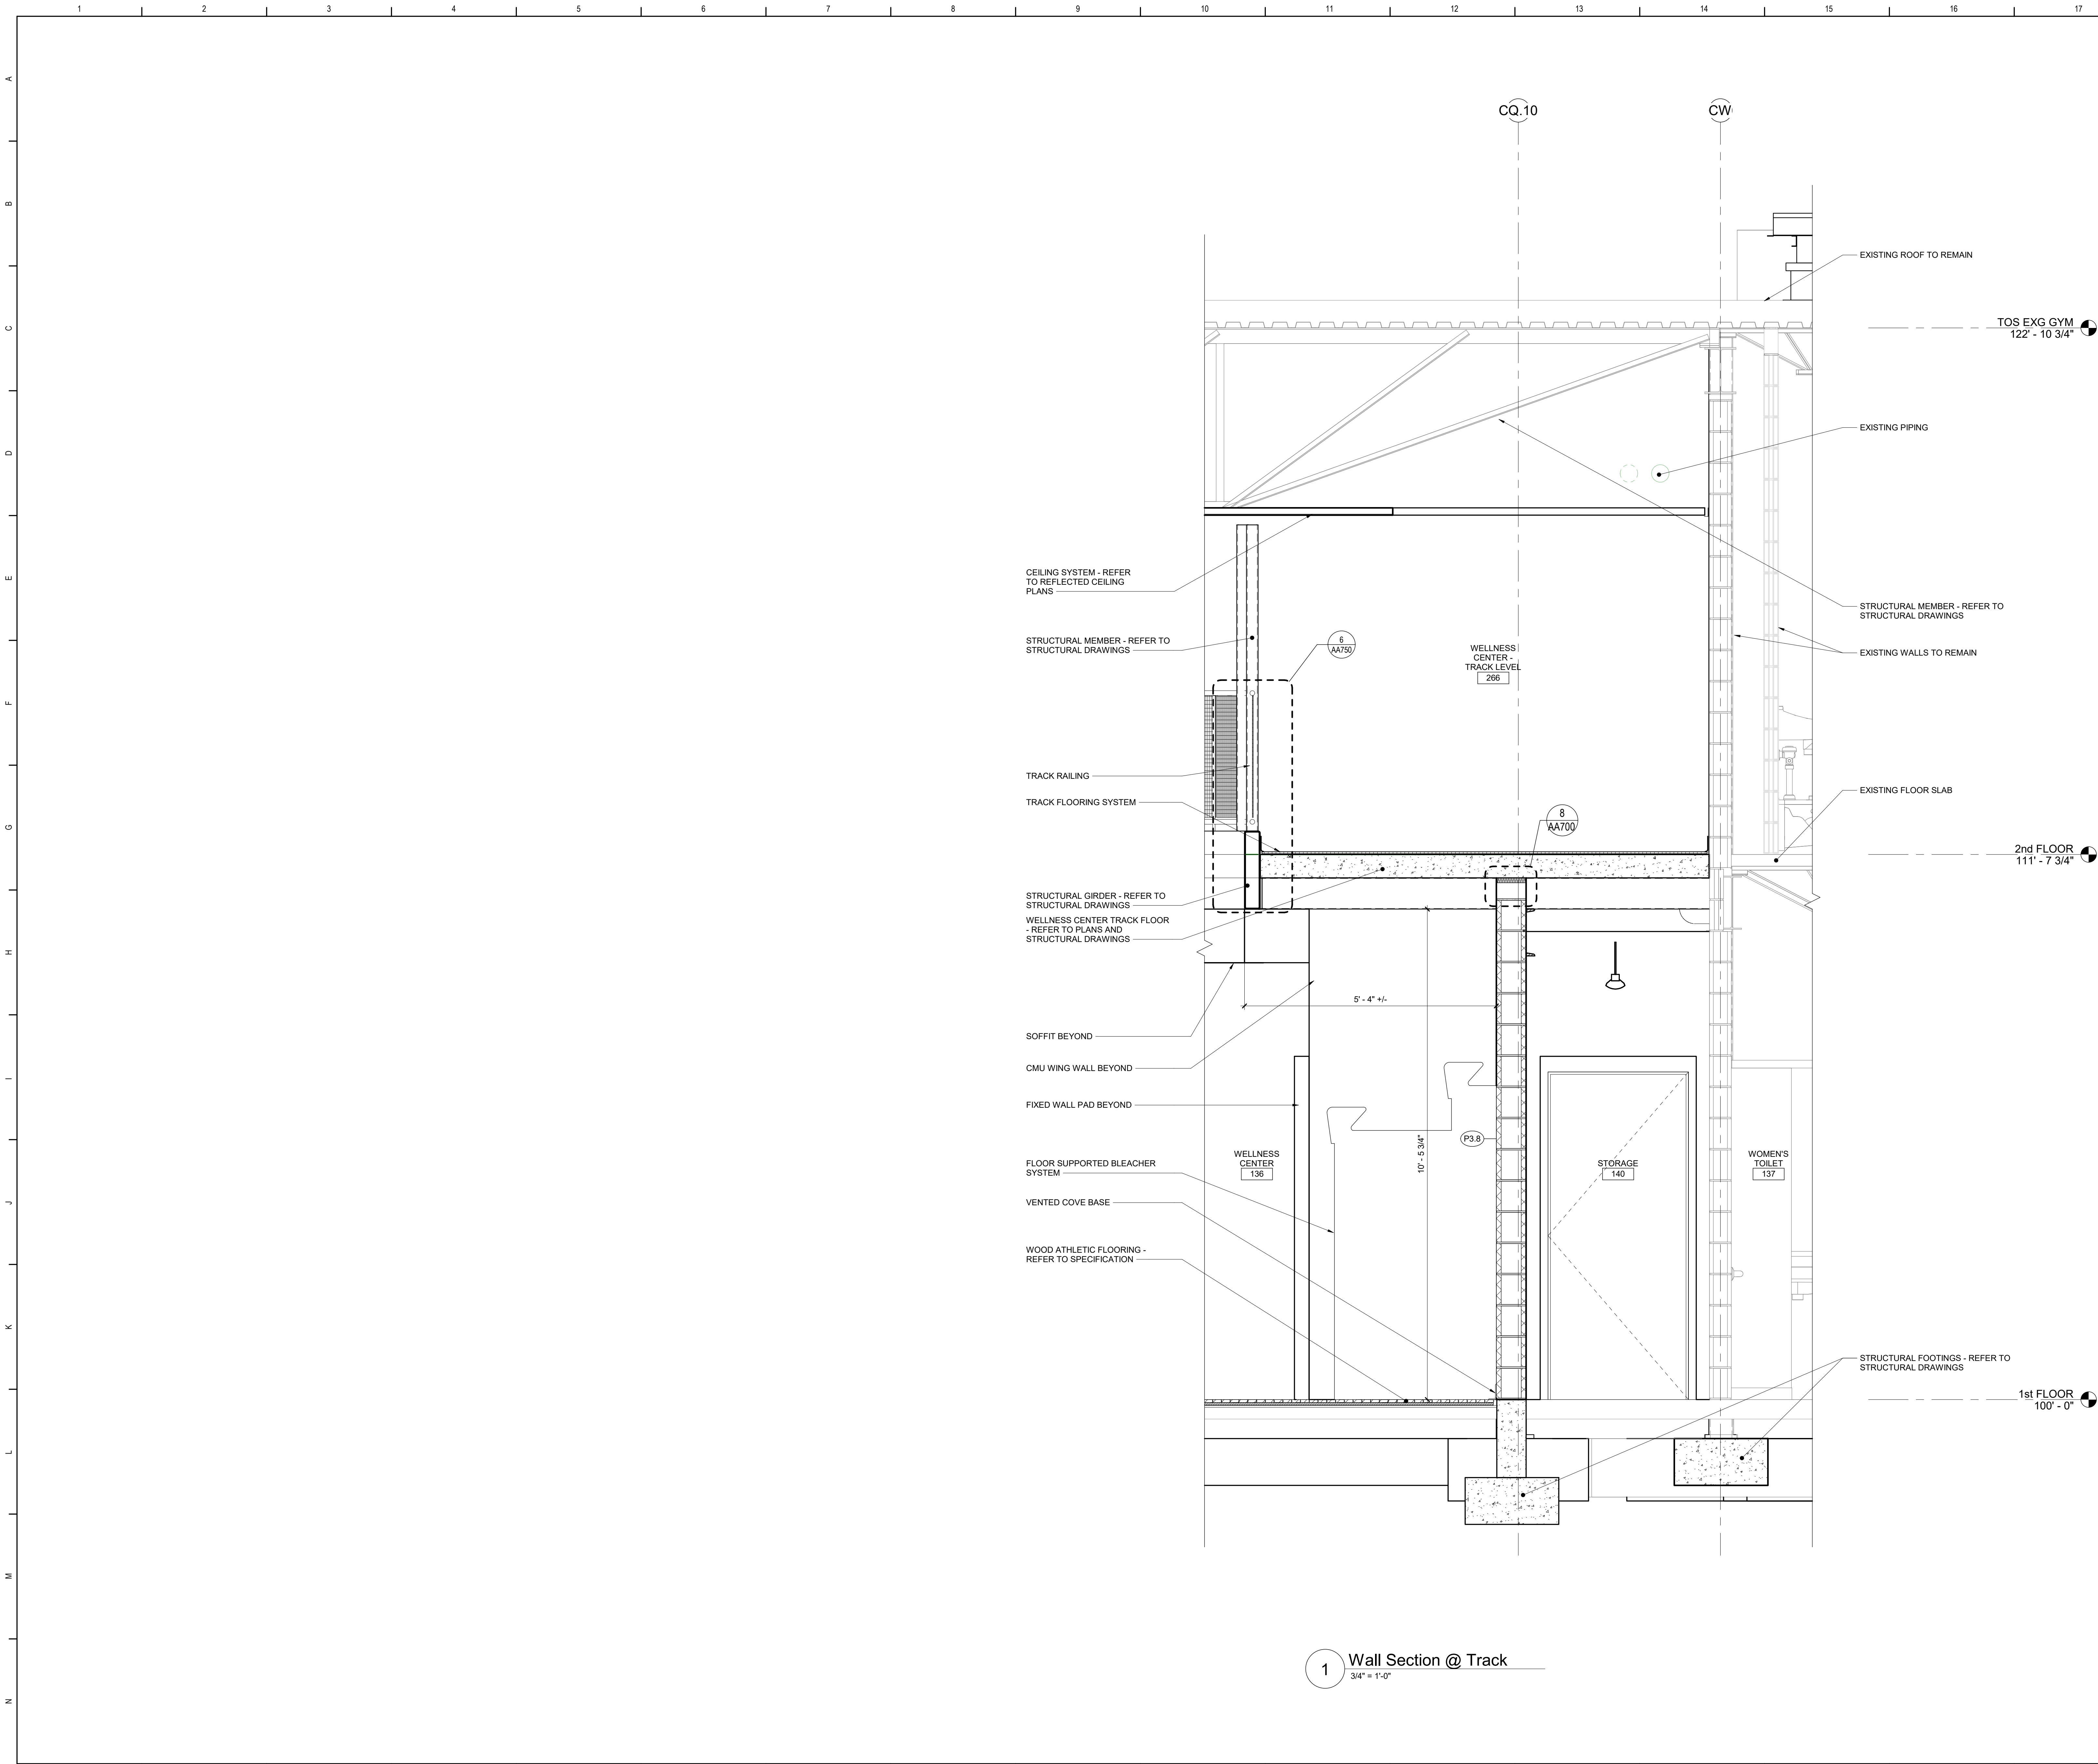

General Construction Notes

A. DETAILS AND SECTIONS INDICATE SPECIFIC MATERIALS AND LAYOUT DIMENSIONS. REFER TO MASONRY PLAN DETAILS FOR SPECIFIC REQUIREMENTS REGARDING CONTROL AND EXPANSION JOINTS, TIES AND REINFORCEMENT, ETC.

B. ALL NOTES DESCRIBED ON ONE SECTION OR DETAIL APPLY TO ALL SECTIONS OR DETAILS, TYPICAL UNLESS NOTED OTHERWISE.

C. REFER TO FINISH DRAWINGS FOR FINISH INFORMATION.

D. REFER TO DOOR SCHEDULE FOR ADDITIONAL DOOR INFORMATION.

E. REFER TO STRUCTURAL DRAWINGS FOR SPECIFIC FRAMING DETAILS, LINTEL DETAILS AND SHEAR WALL DETAILS.

Key Plan
N.T.S.

SED Control No. 60-01-01-06-0-018-023

Rev. No.	Date	Description

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BID SET


TETRA TECH
ARCHITECTS & ENGINEERS

Waverly Central School District
Waverly, NY


Additions and Alterations to:
Waverly Jr. Sr. High School

Wall Sections


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Project No.: 339070-22003		

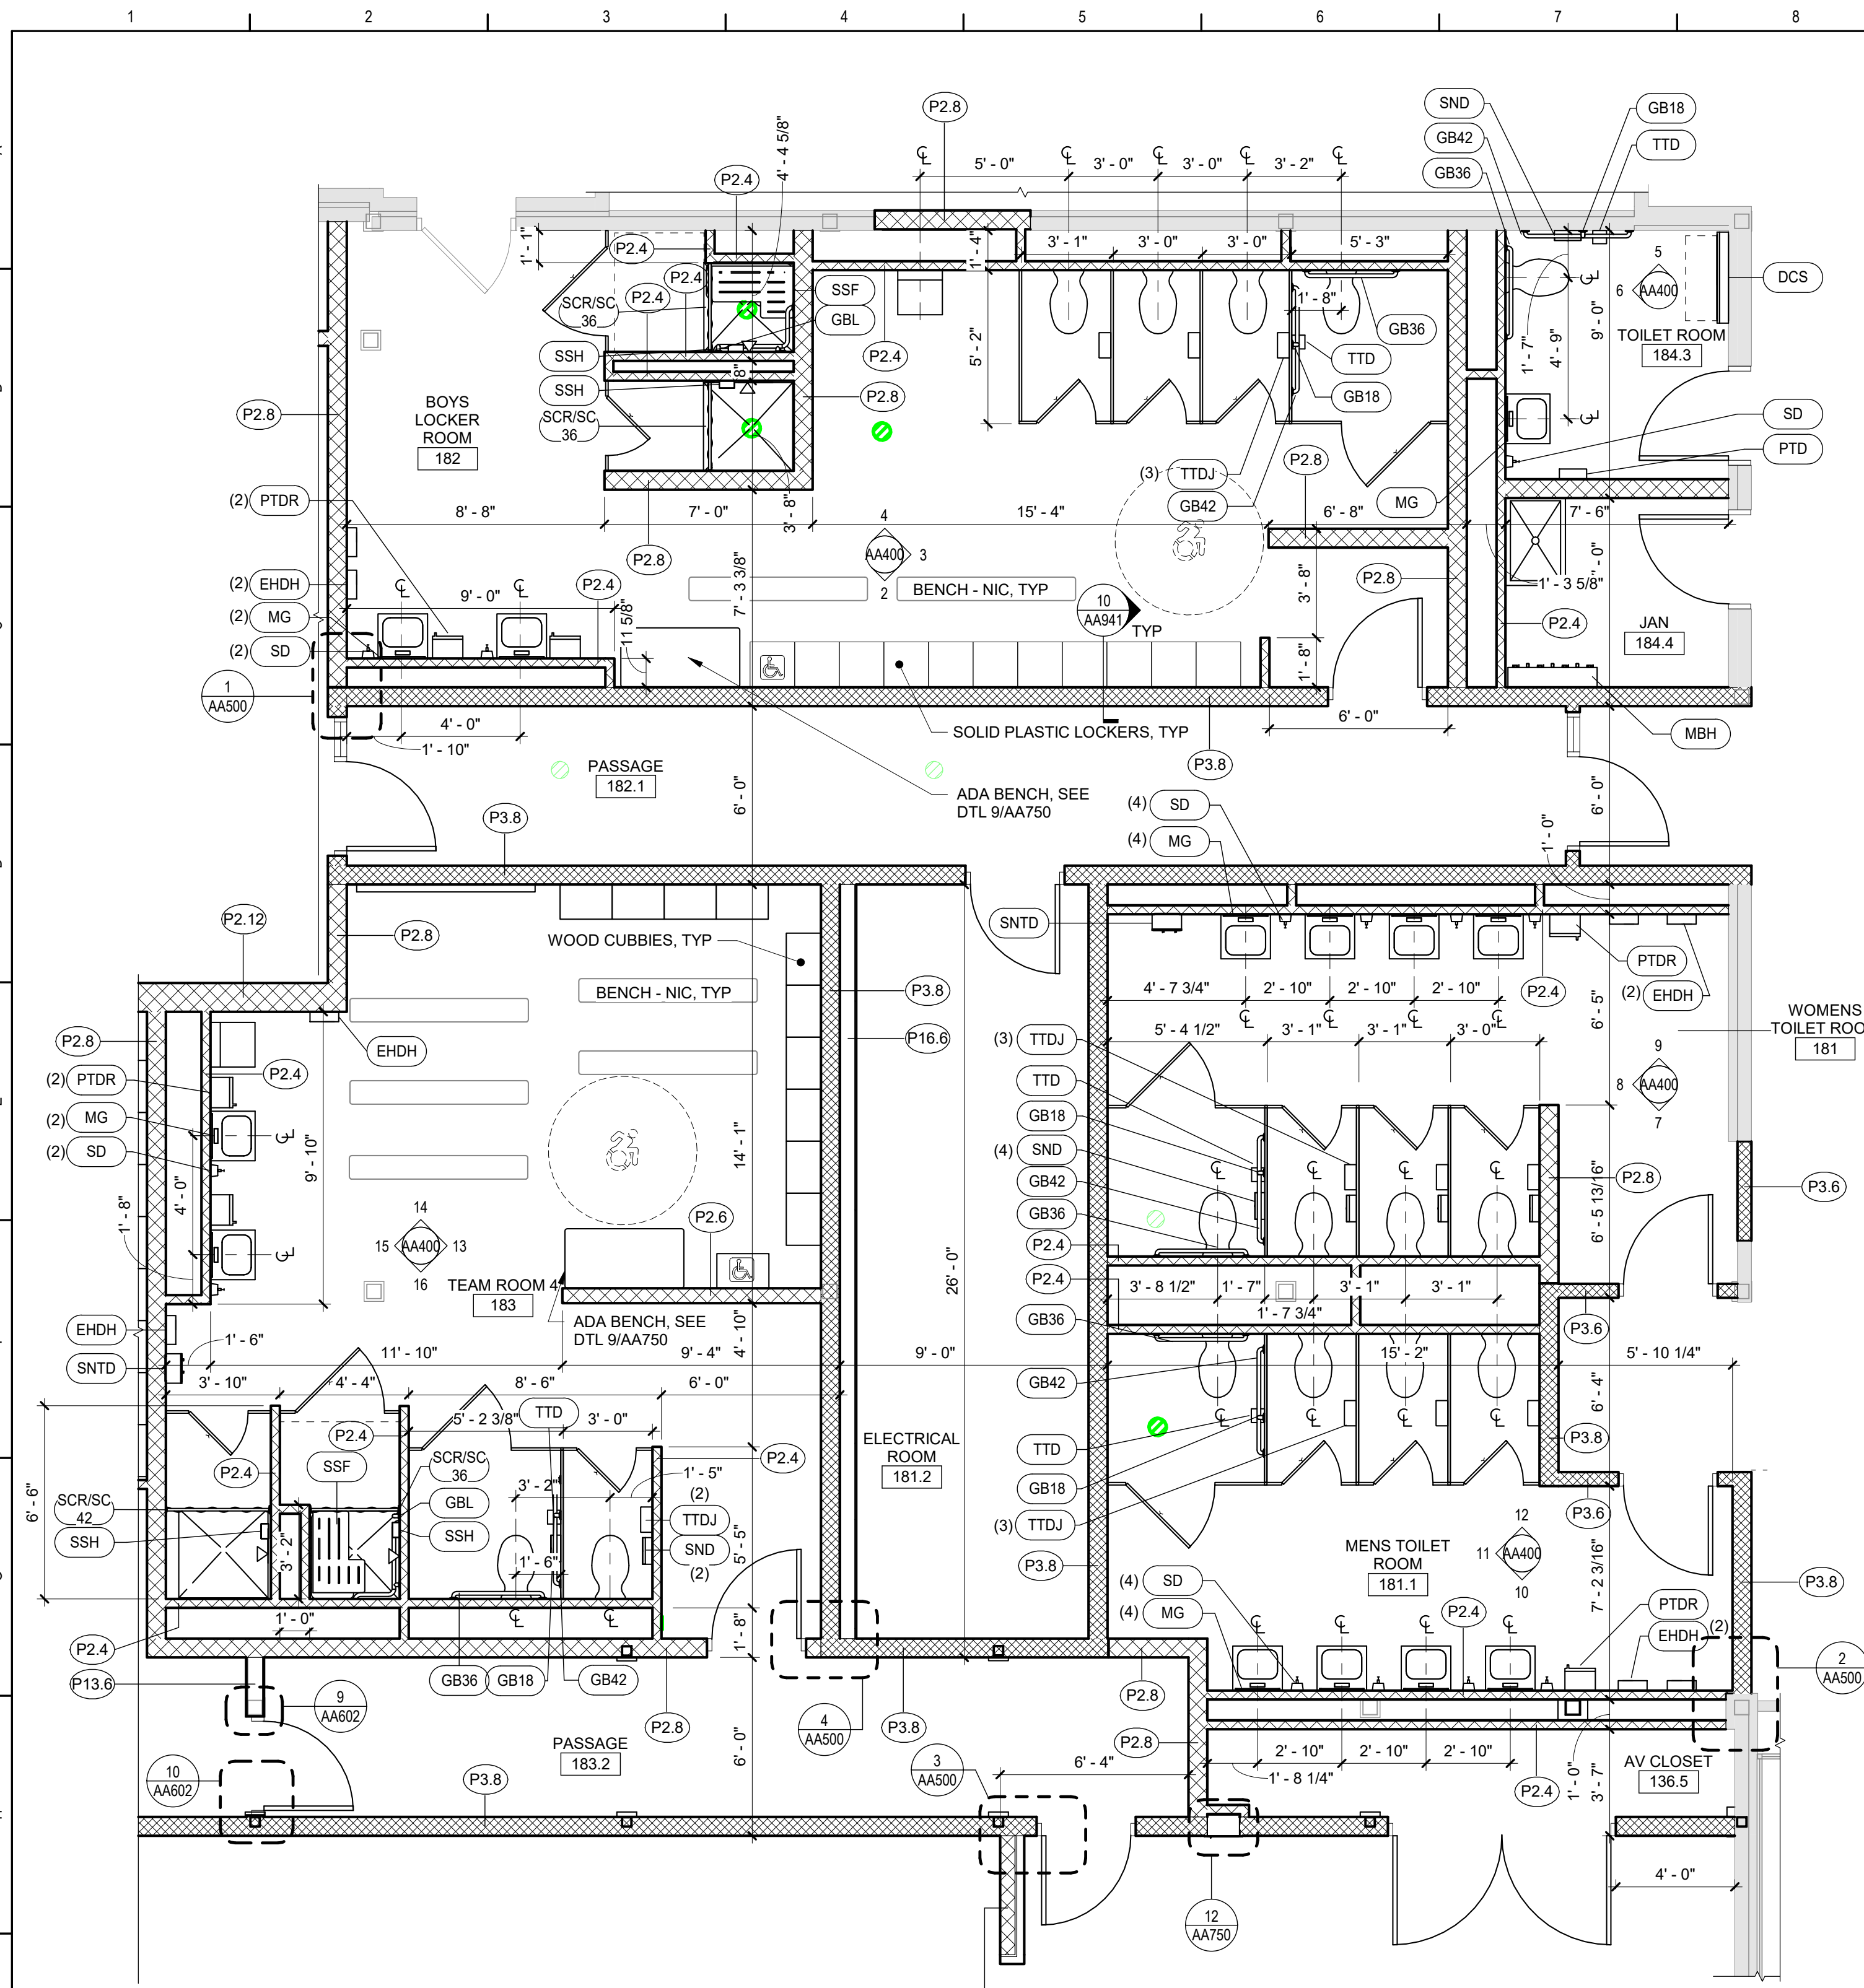


1 Enlarged Plan - Team and Toilet Rooms
1/4" = 1'-0"

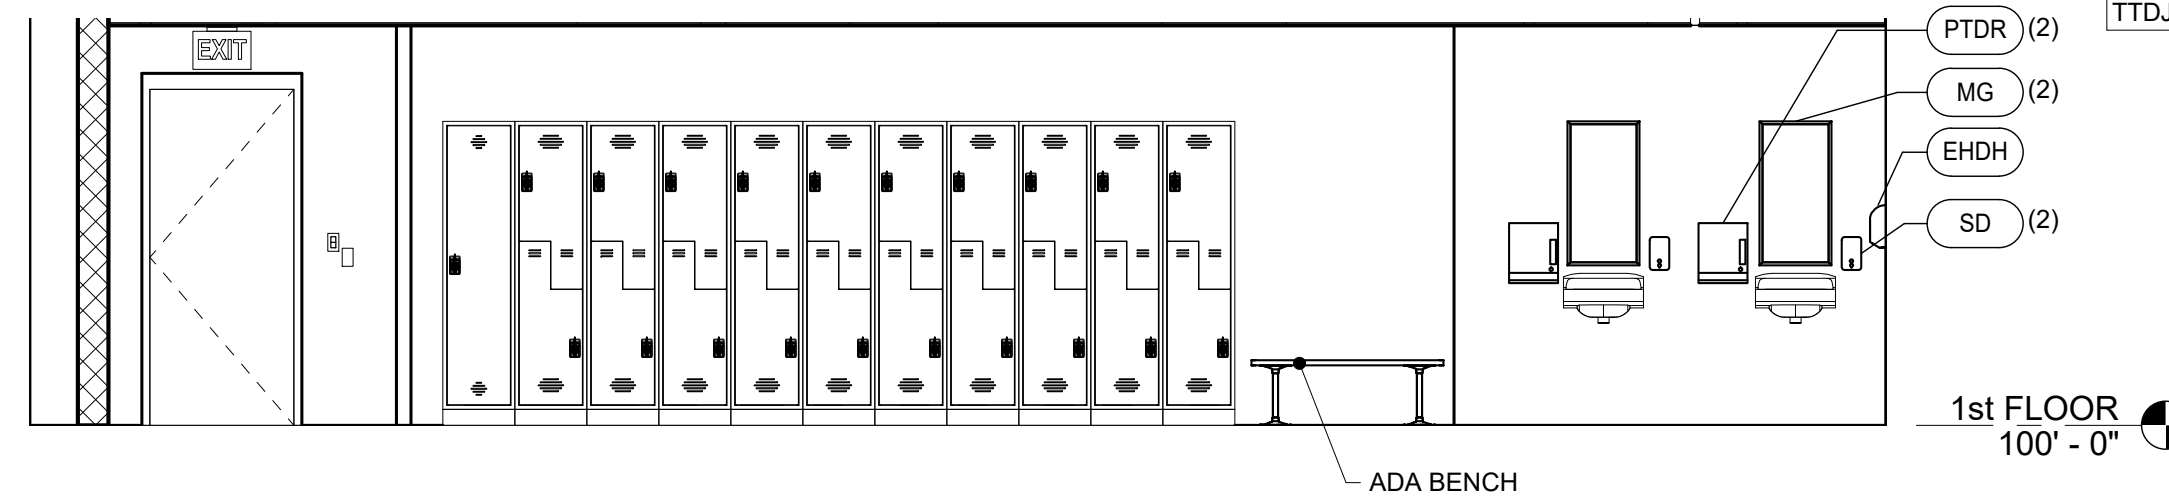


2 Interior Elevation
1/4" = 1'-0"

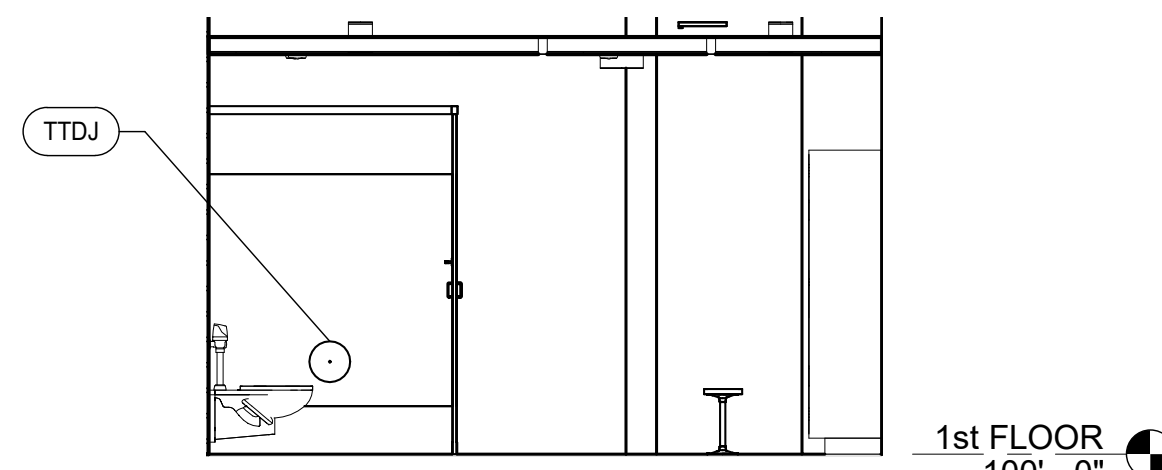


3 Interior Elevation
1/4" = 1'-0"

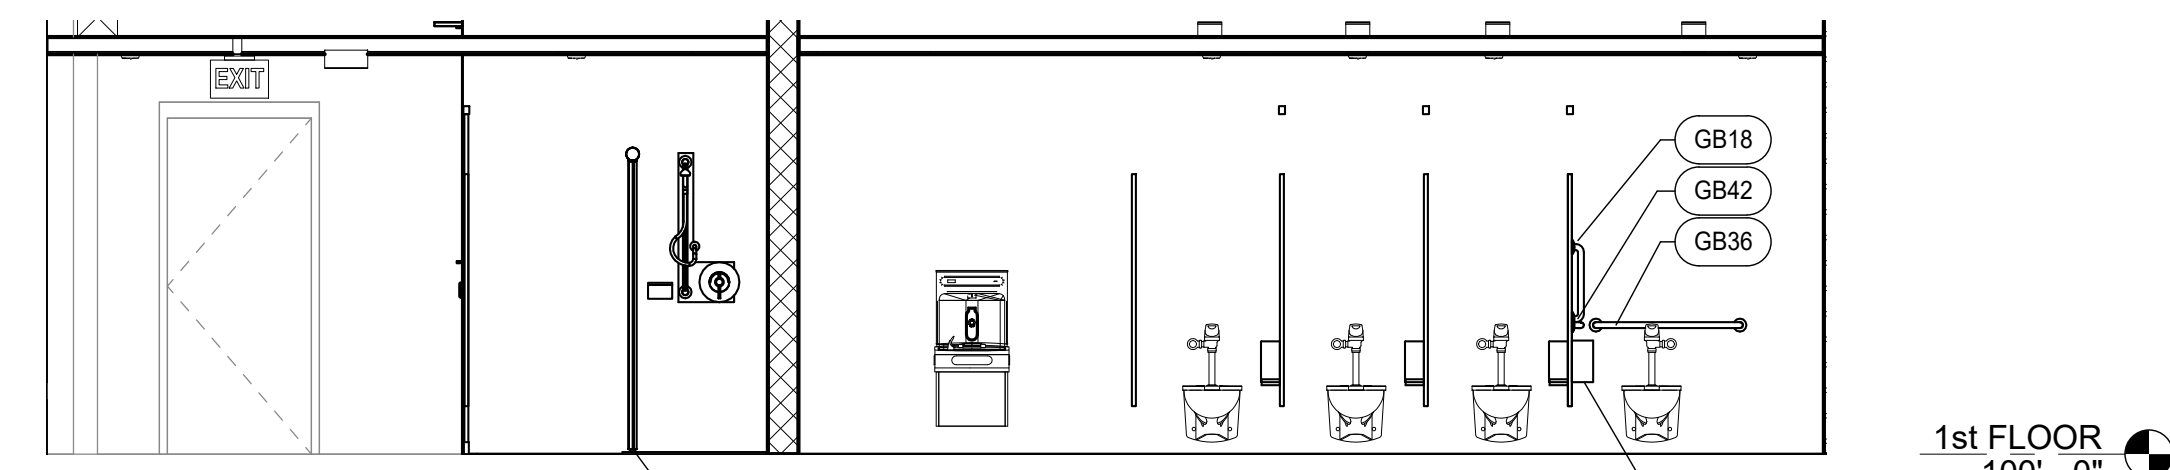


4 Interior Elevation
1/4" = 1'-0"

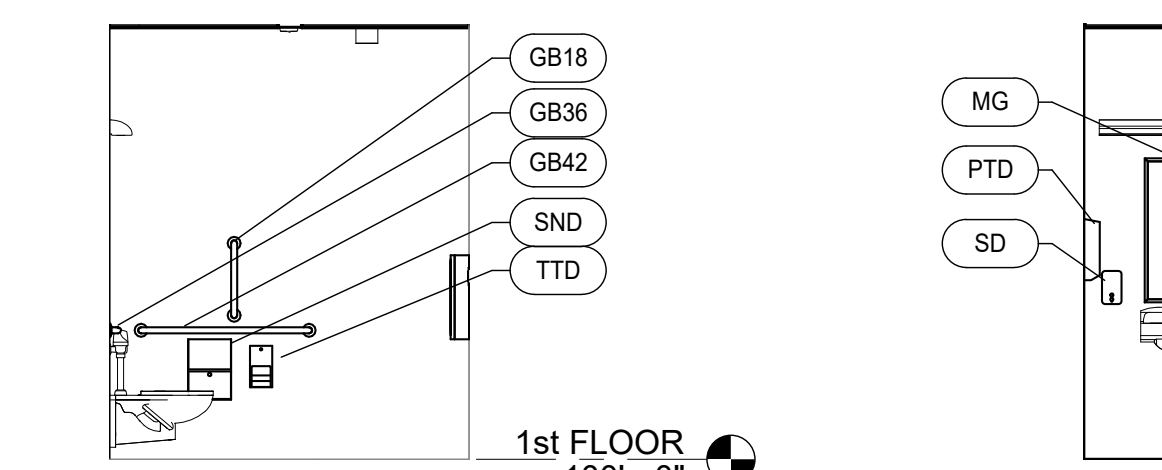


5 Interior Elevation
1/4" = 1'-0"

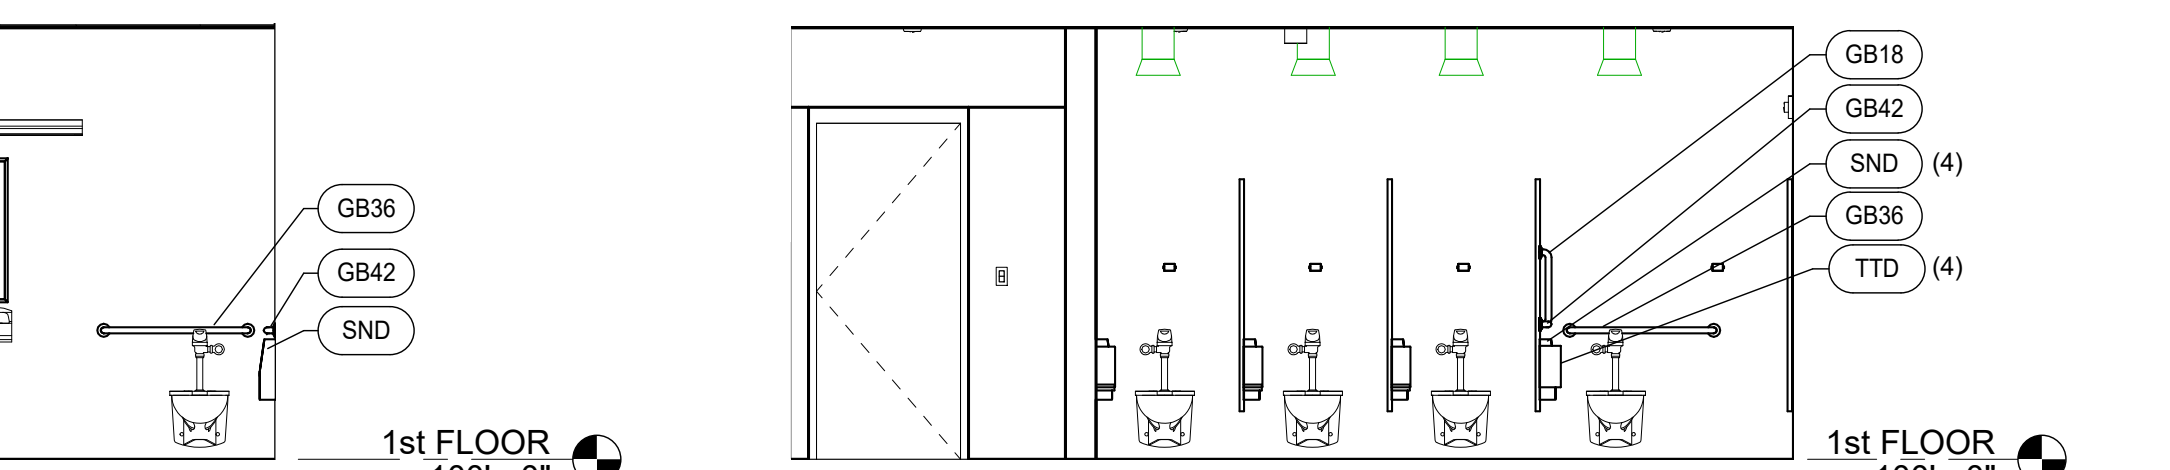


6 Interior Elevation
1/4" = 1'-0"

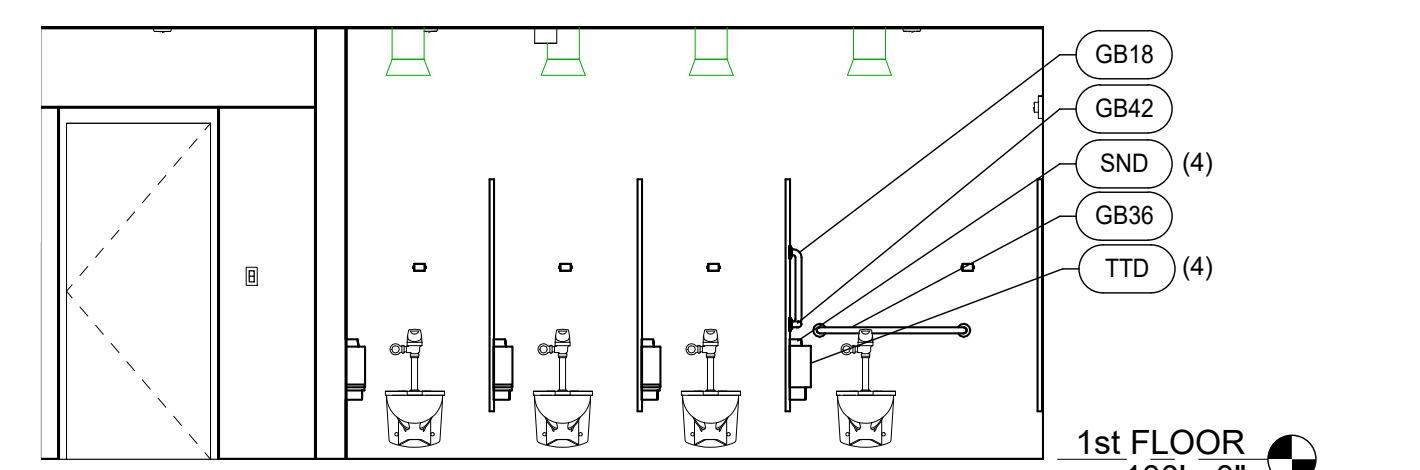


7 Interior Elevation
1/4" = 1'-0"

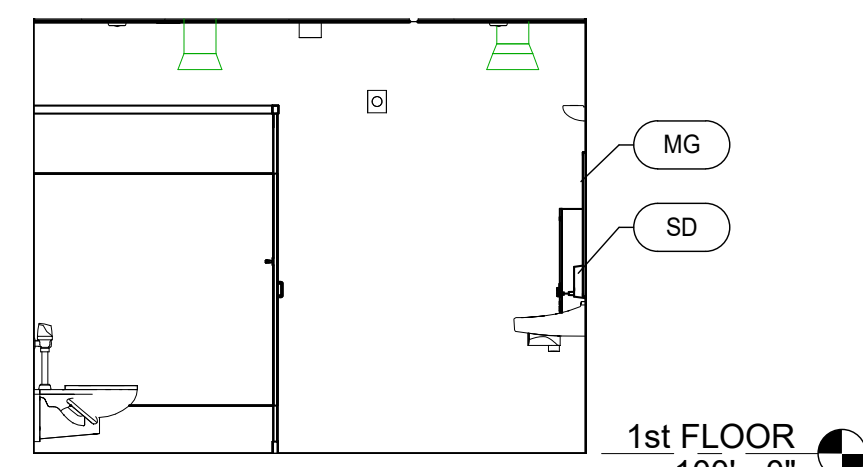


8 Interior Elevation
1/4" = 1'-0"

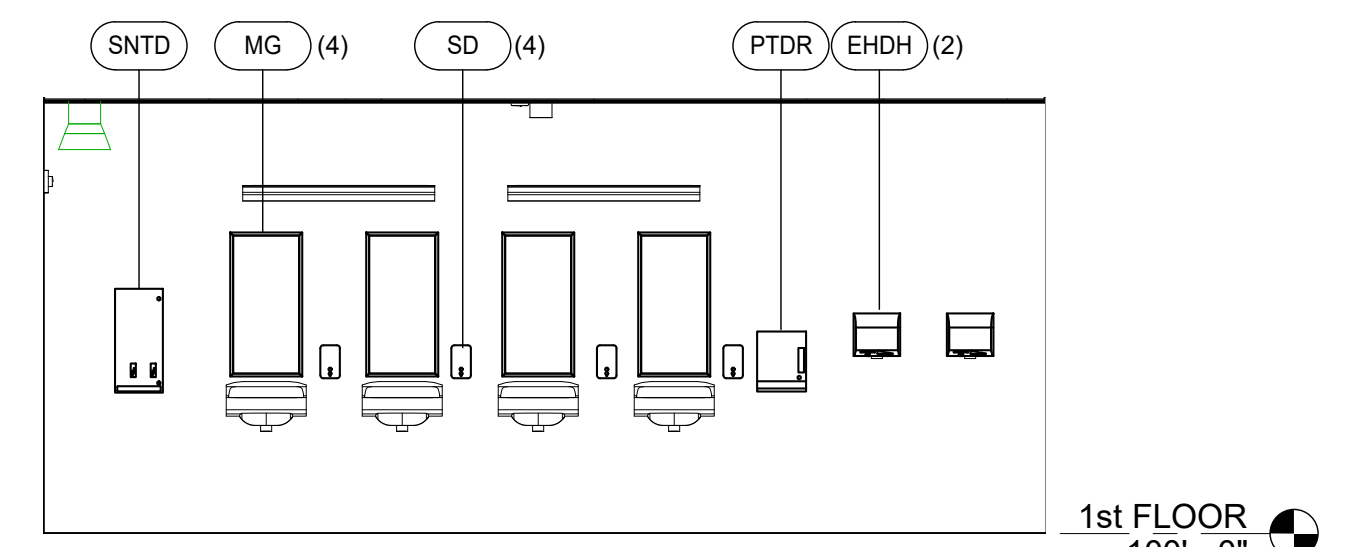


9 Interior Elevation
1/4" = 1'-0"

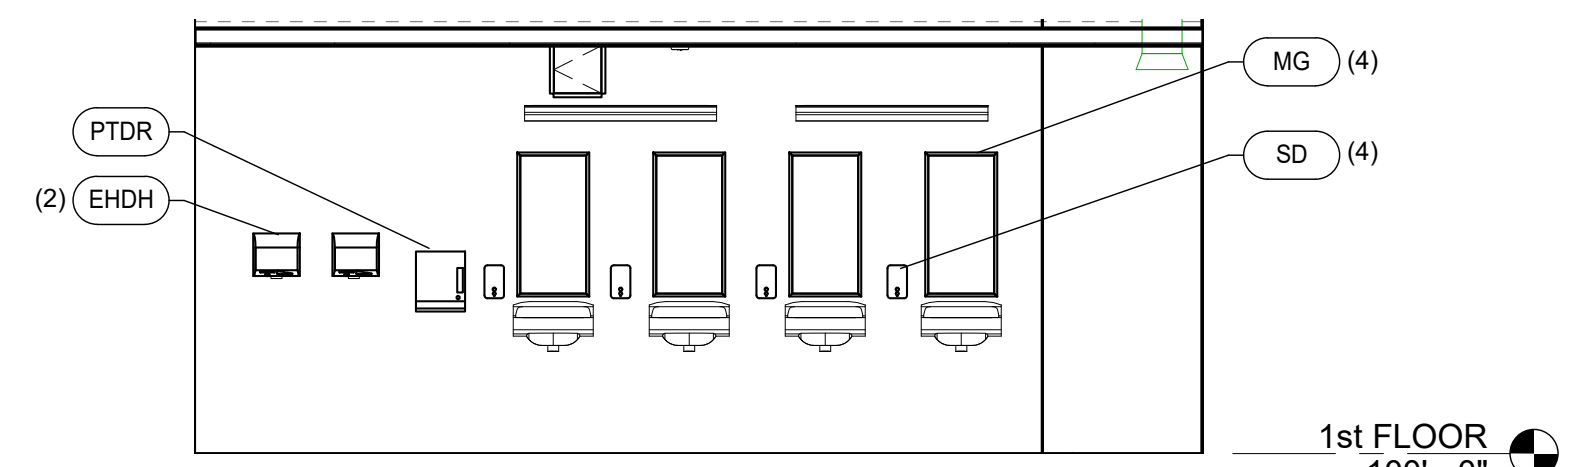


10 Interior Elevation
1/4" = 1'-0"

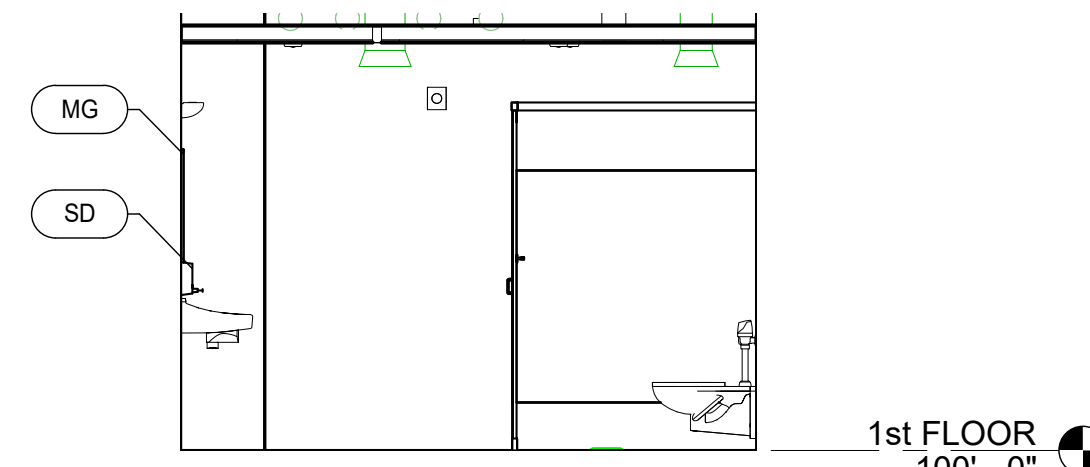


11 Interior Elevation
1/4" = 1'-0"

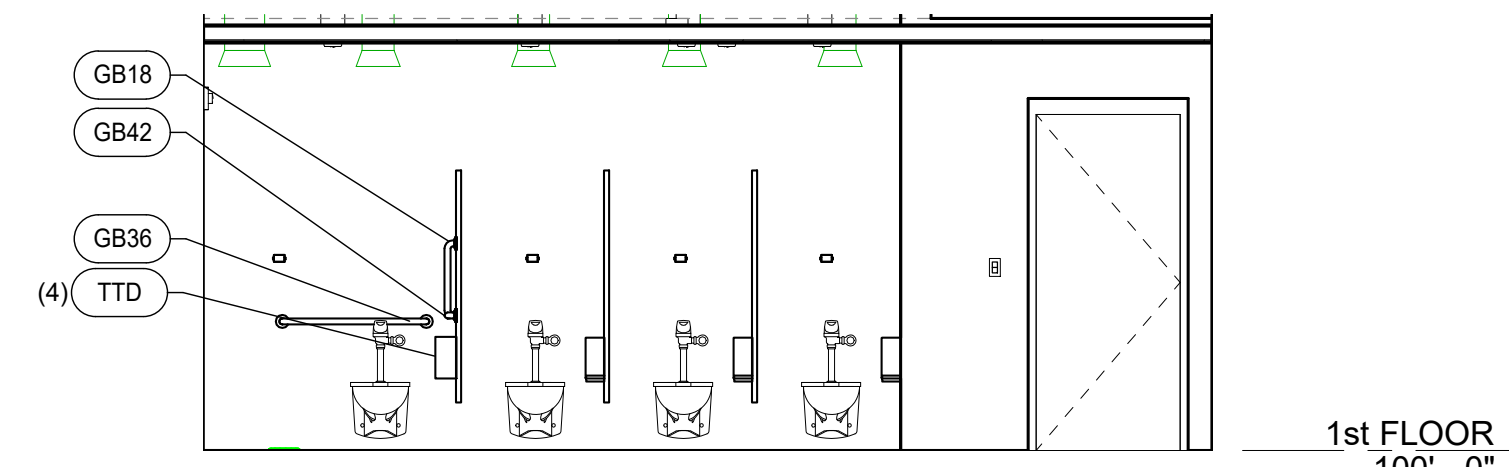


12 Interior Elevation
1/4" = 1'-0"

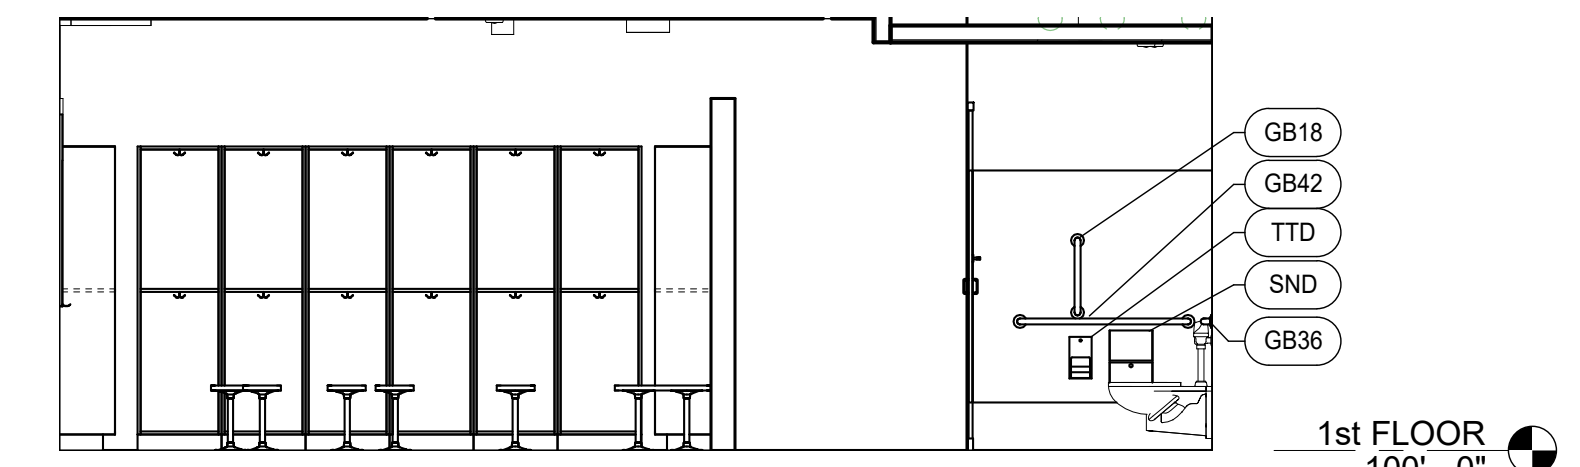


13 Interior Elevation
1/4" = 1'-0"

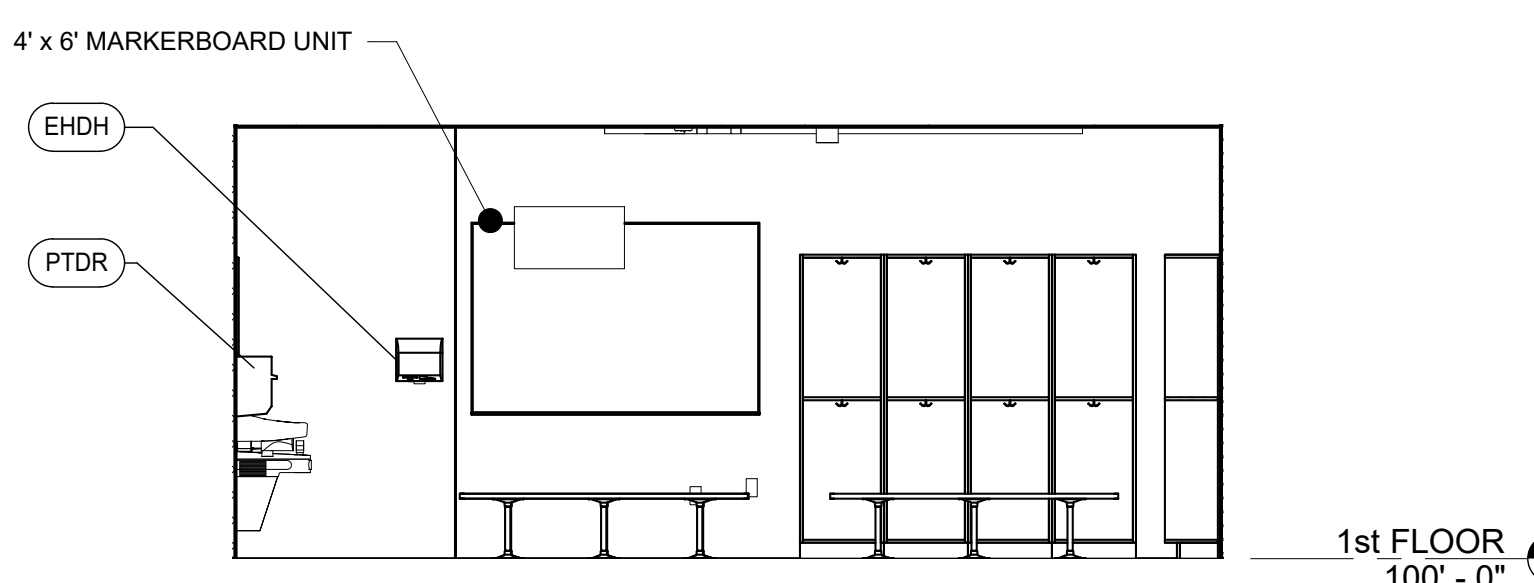

14 Interior Elevation
1/4" = 1'-0"

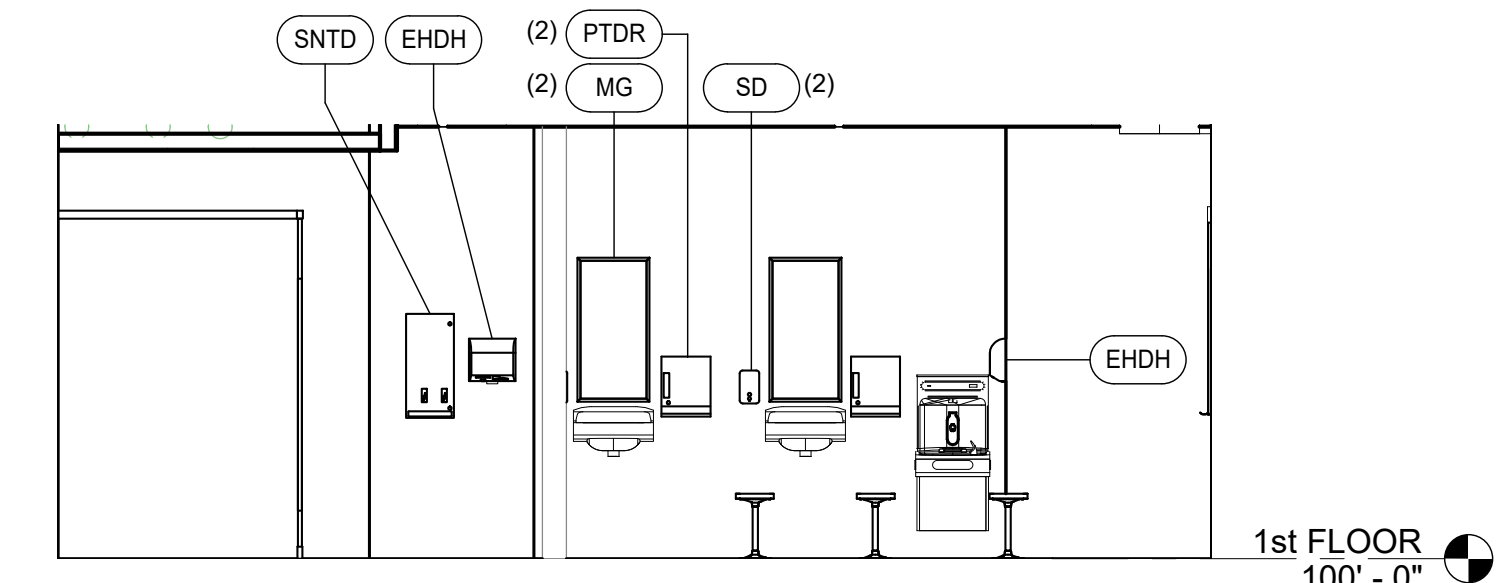

15 Interior Elevation
1/4" = 1'-0"

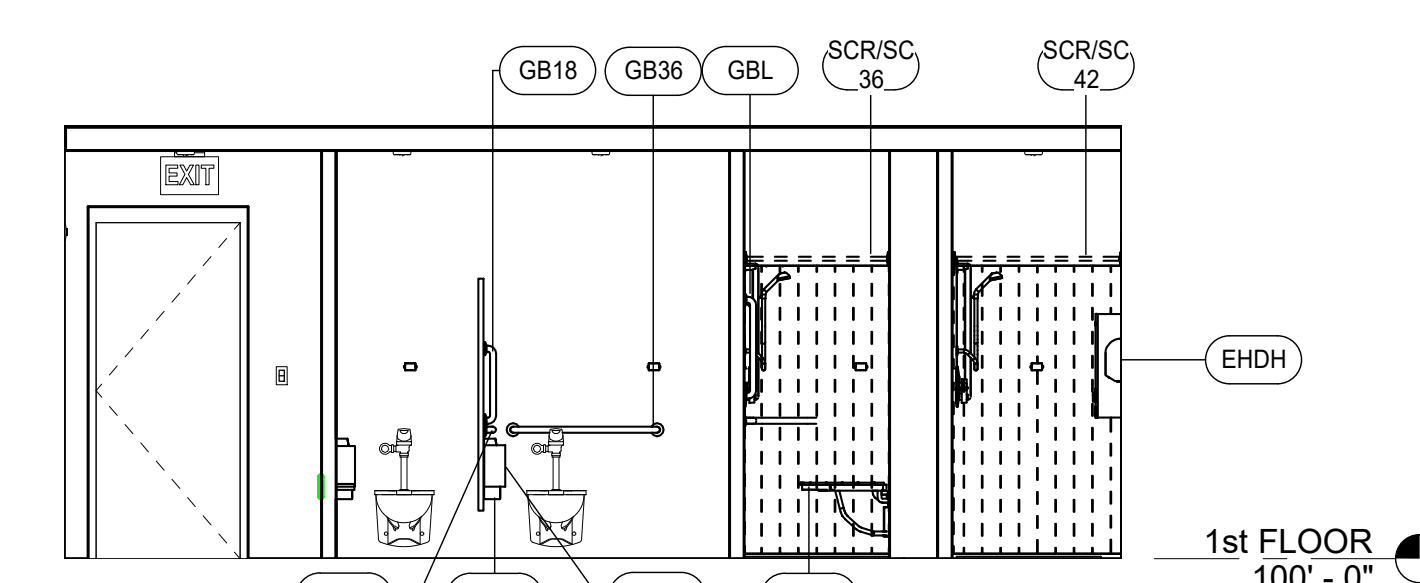


16 Interior Elevation
1/4" = 1'-0"

Toilet Room Accessory Schedule		
ITEM	DESCRIPTION	COMMENTS
GB18	18" GRAB BAR - VERTICAL	
GBL	24" GRAB BAR - VERTICAL AND L-SHAPED SHOWER GRAB BARS	
GB36	36" GRAB BAR - HORIZONTAL	
SCR/SC 36	36" SHOWER ROD & CURTAIN	INCLUDES ROD, CURTAIN AND HOOKS
GB42	42" GRAB BAR - HORIZONTAL	
SCR/SC 42	42" SHOWER ROD & CURTAIN	INCLUDES ROD, CURTAIN AND HOOKS
DCS	DIAPER CHANGING STATION	
EHDH	ELECTRIC HAND DRYER - HIGH SPEED - NARROW	18"W X 36"H
MG	MIRROR	
MBH	MOP AND BROOM HOLDER	
PTD	PAPER TOWEL DISPENSER - FOLDED	
PTDR	PAPER TOWEL DISPENSER - ROLL	
RH	ROBE HOOK	PROVIDED WITH TOILET AND SHOWER COMPARTMENTS ON INSIDE OF EACH DOOR, TYP
SNTD	SANITARY NAPKIN AND TAMPON DISPENSER - SURFACE MOUNTED	
SND	SANITARY NAPKIN DISPOSAL	
SSF	SHOWER SEAT - FOLDING	
SD	SOAP DISPENSER - VERTICAL	
SSH	SOAP SHELF	
TTD	TOILET TISSUE DISPENSER	
TTDJ	TOILET TISSUE DISPENSER - JUMBO	

General Toilet Room Notes

- A. DIMENSION CONVENTIONS, UNLESS NOTED OTHERWISE, ARE AS FOLLOWS:
- DIMENSIONS INDICATED FOR PLUMBING FIXTURE CENTERLINES ARE MEASURED FROM FACE OF WALL FINISH.
- B. CENTER ALL TOILET PARTITION DOORS WITHIN WIDTH OF STALL (UNLESS NOTED OTHERWISE). PROVIDE DOORS SIZED AS FOLLOWS:
- TYPICAL STALLS: 24" WIDE, TYPICAL EXCEPT AS LISTED BELOW.
 - ADA AND AMBULATORY STALLS: 34" WIDE.
- C. REFER TO AA750 FOR TOILET ROOM ACCESSORY MOUNTING HEIGHTS AND TYPICAL LAYOUT DIMENSIONS.
- D. PROVIDE FILLER PANELS AS REQUIRED AT PLASTIC LOCKERS AND WOOD CUBBIES.
- E. PROVIDE SHOWER COMPARTMENTS AT SHOWERS AND TOILET PARTITIONS AT TOILETS.

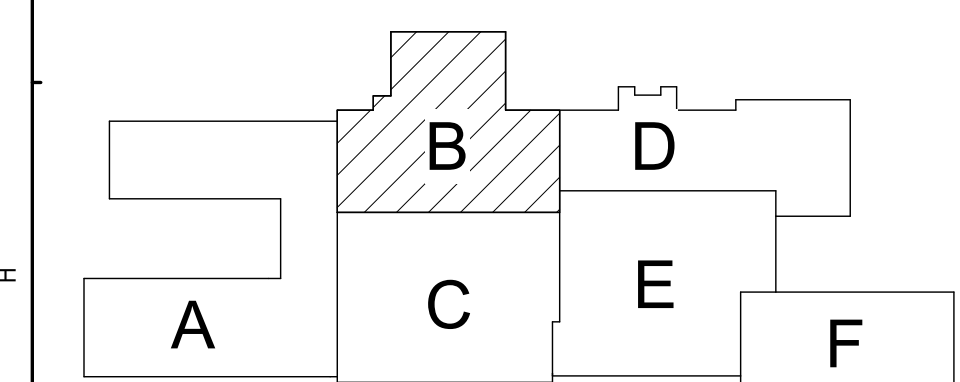

Key Plan
N.T.S.

SED Control No. 60-01-01-06-0-018-023

Rev. No.: Date: Description:



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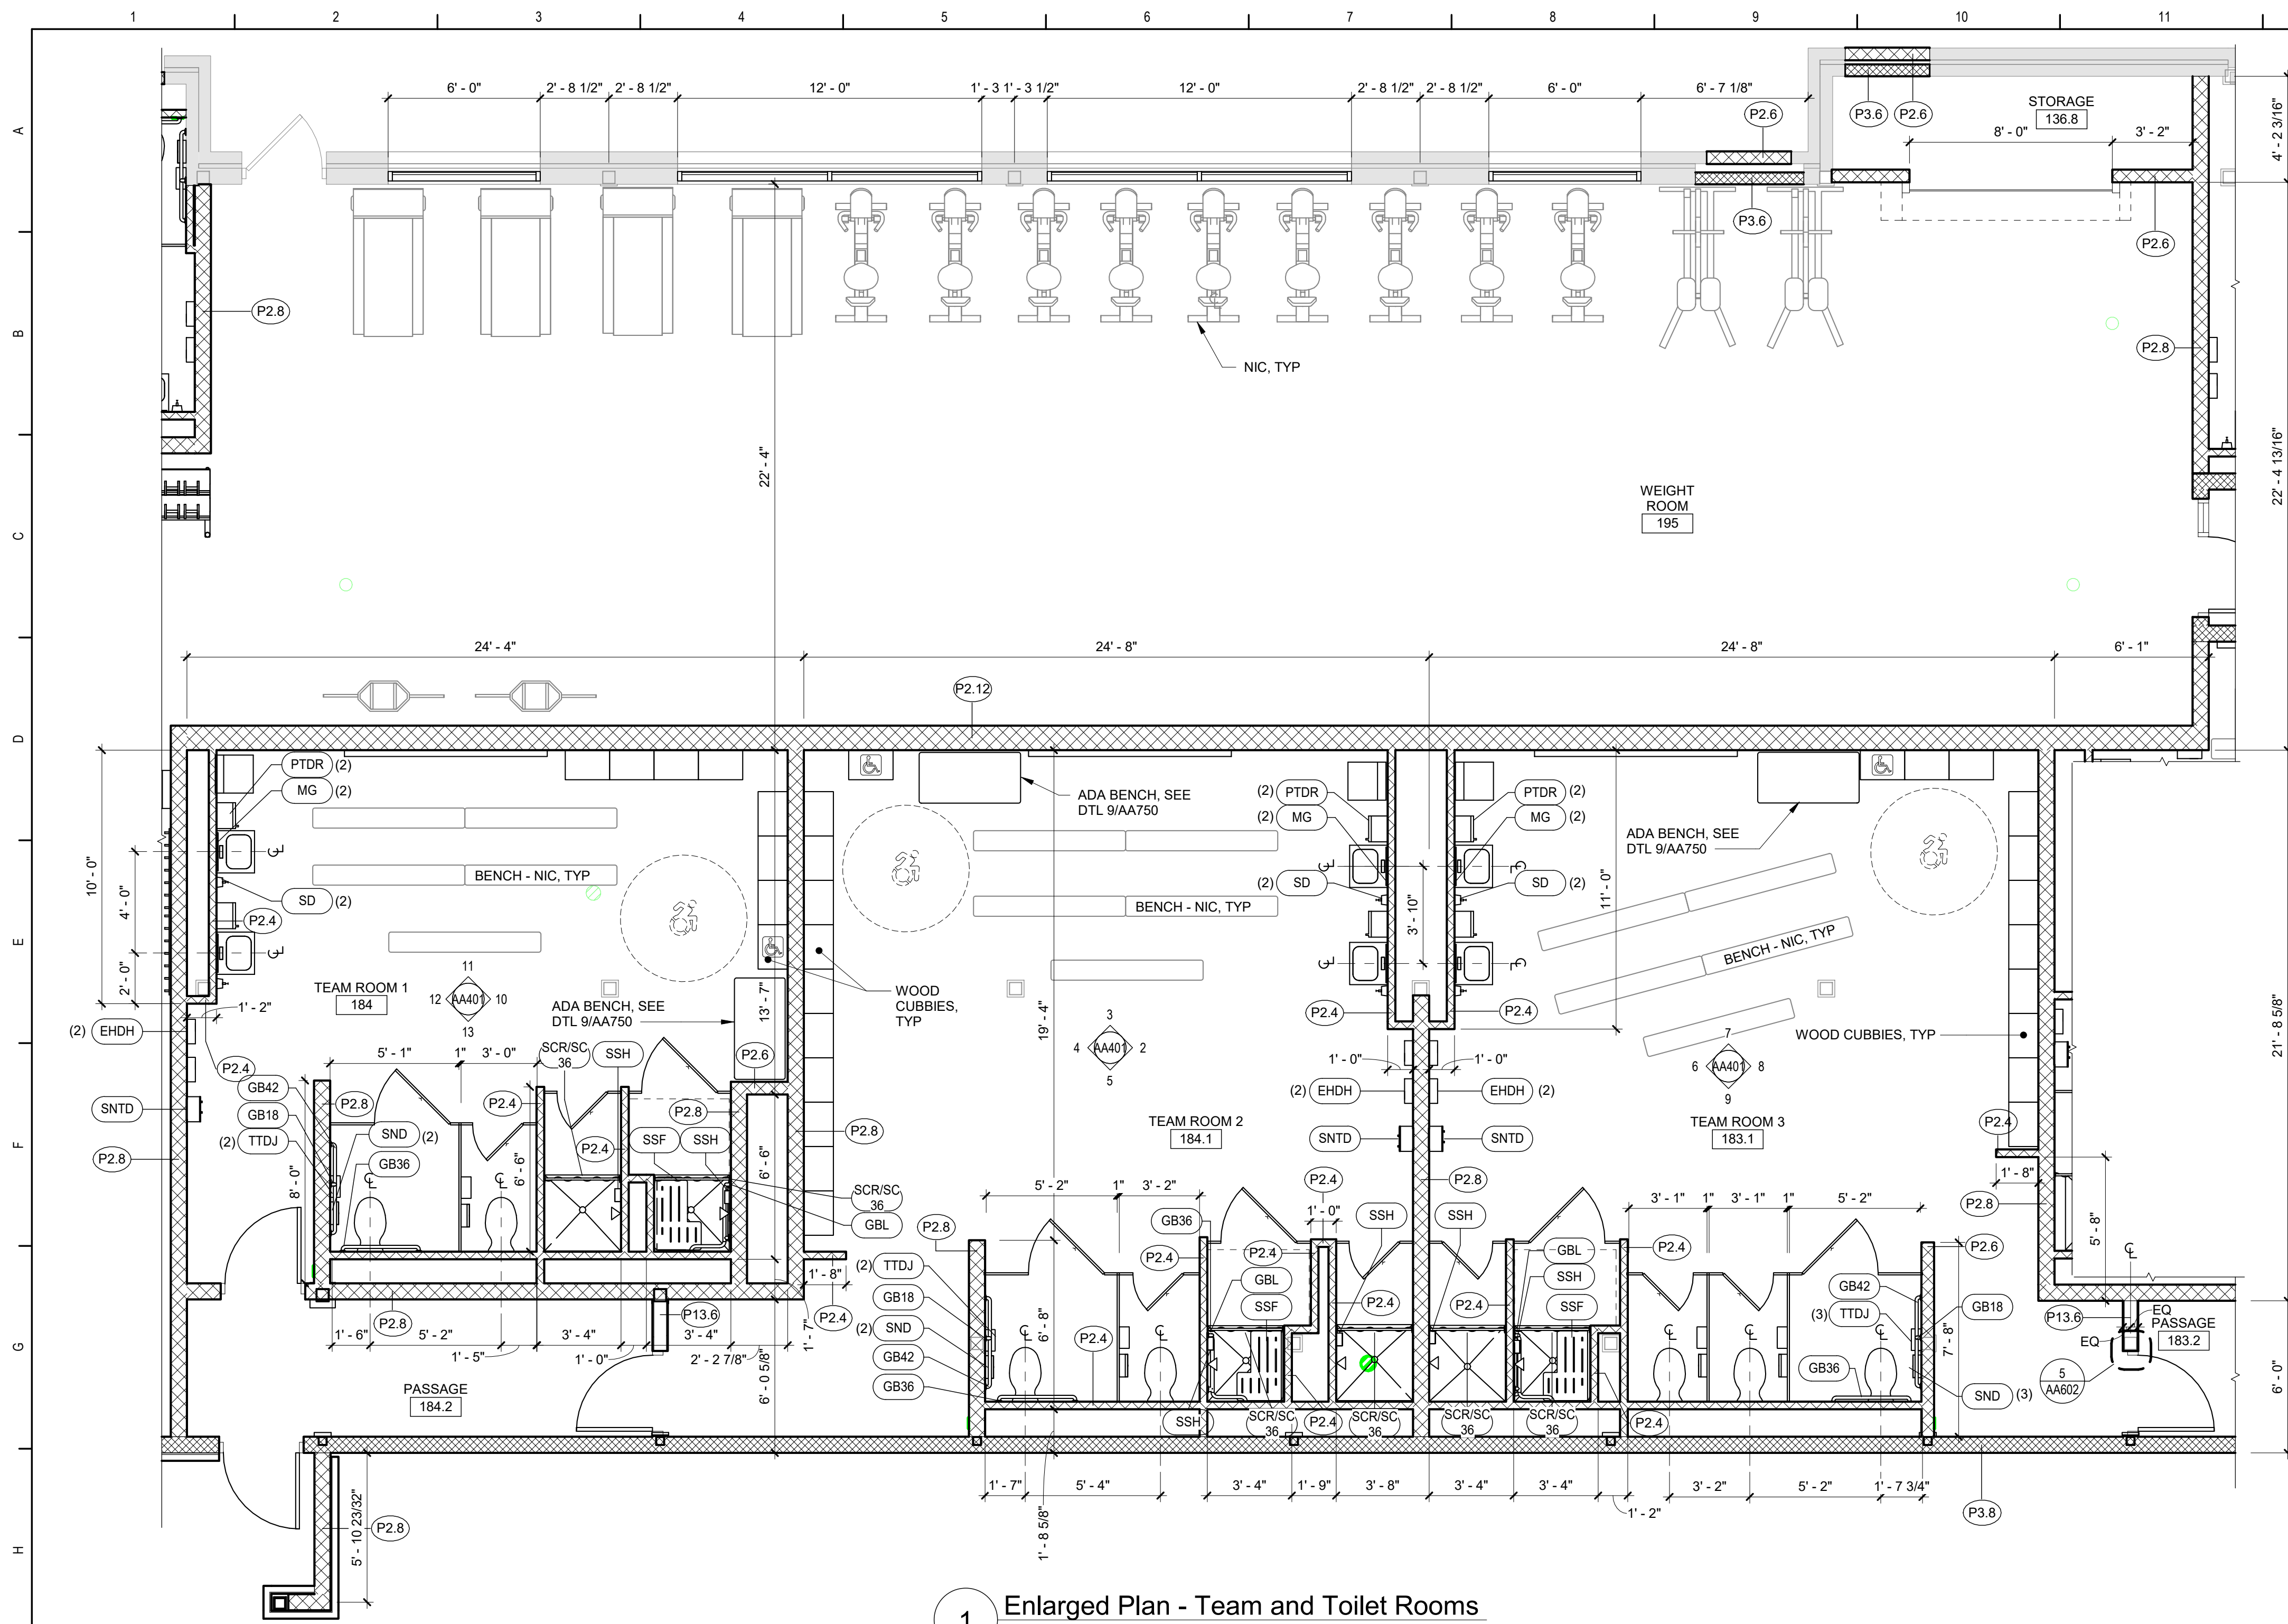


Waverly Central School District
Waverly, NY


Additions and Alterations to:
Waverly Jr. Sr. High School

Enlarged Team Room/Toilet Room
Plans and Interior Elevations


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Date: 05/19/2023
Project No.: 339070-22003
Drawing Number: AA400




1 Enlarged Plan - Team and Toilet Rooms
1/4" = 1'-0"

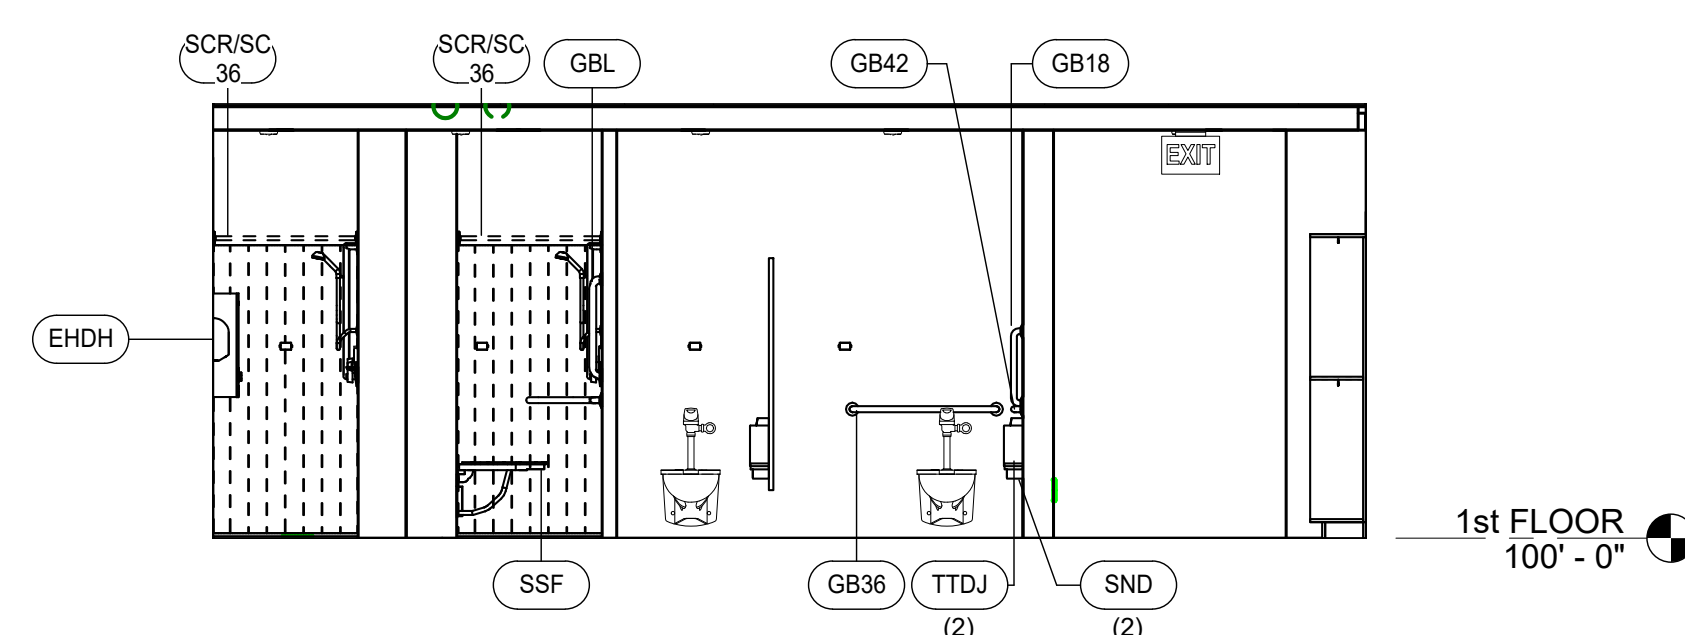


5 Interior Elevation
1/4" = 1'-0"

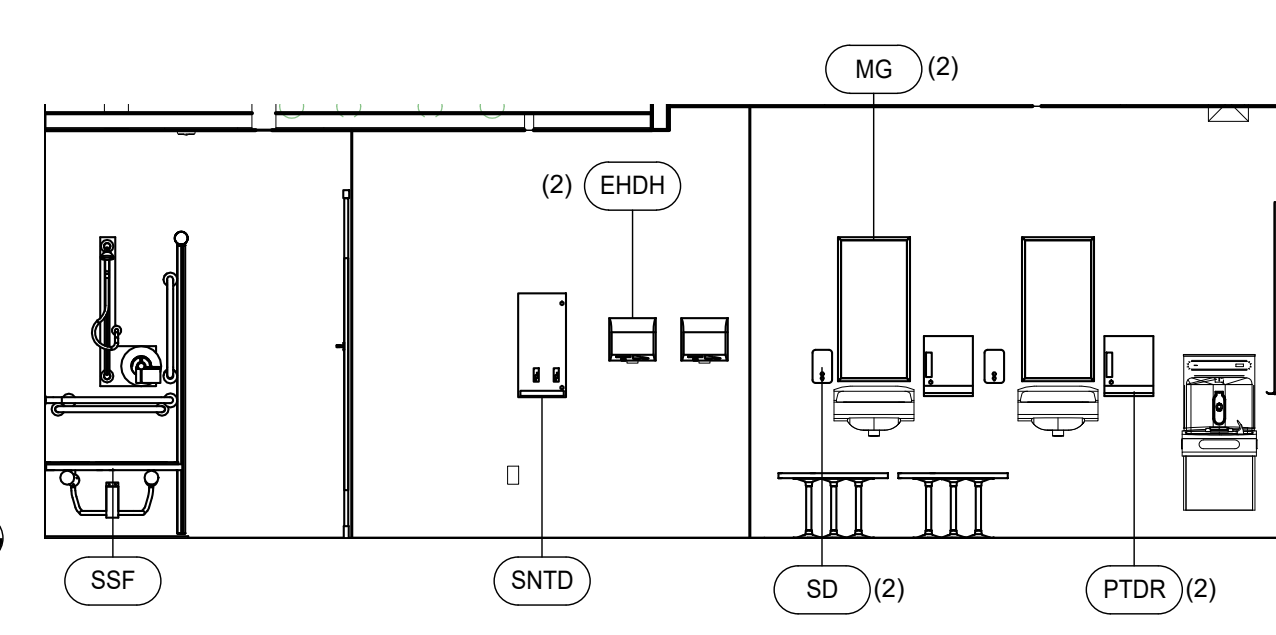


6 Interior Elevation
1/4" = 1'-0"

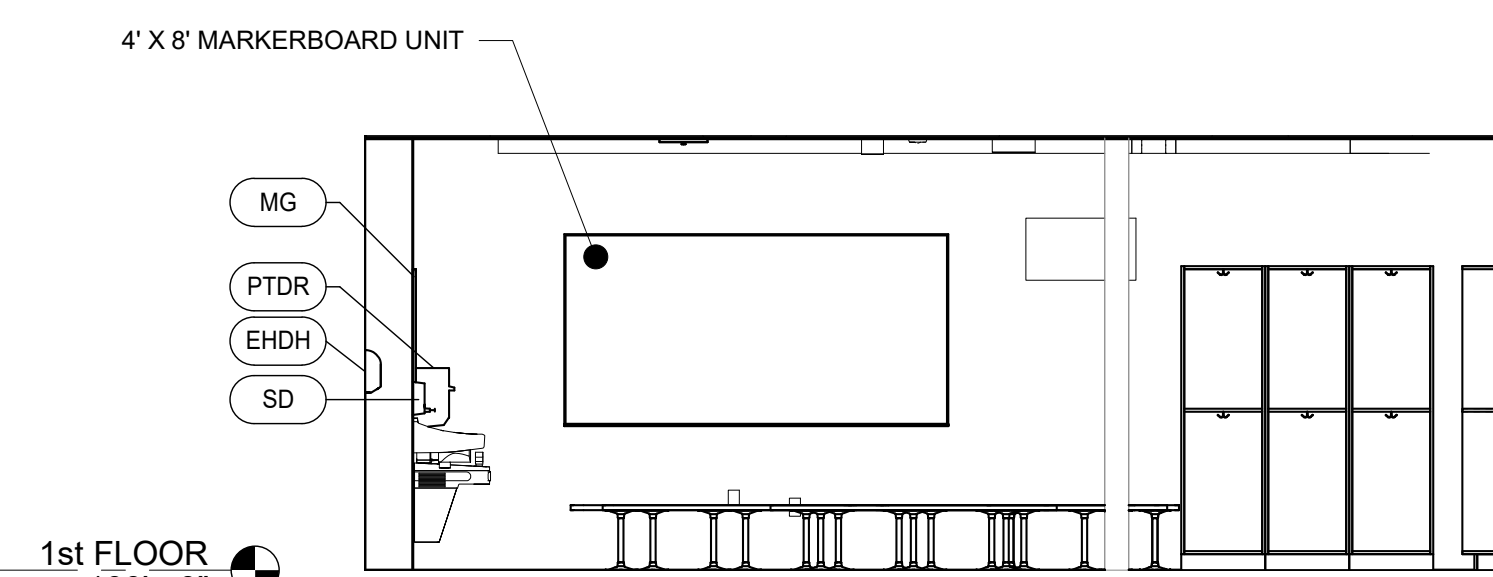

7 Interior Elevation
1/4" = 1'-0"

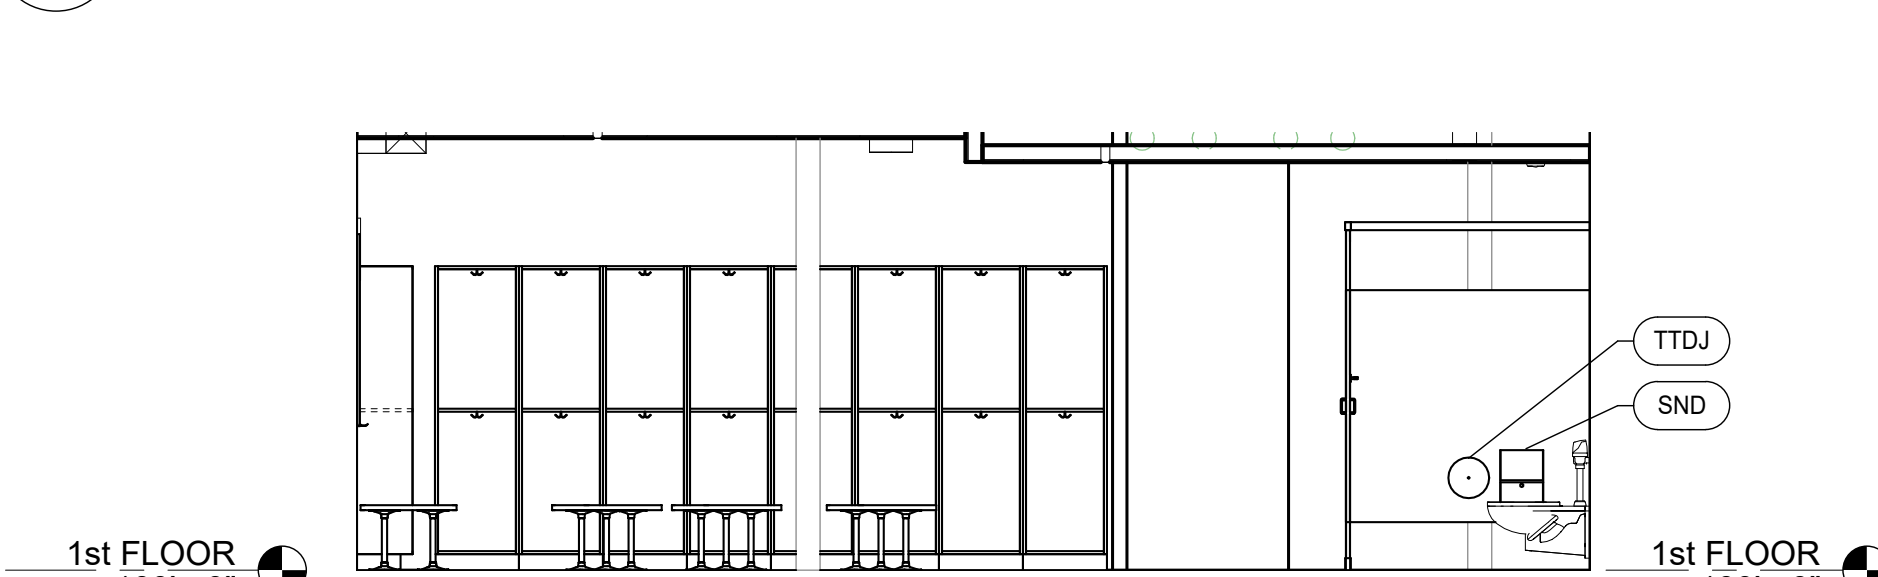


8 Interior Elevation
1/4" = 1'-0"

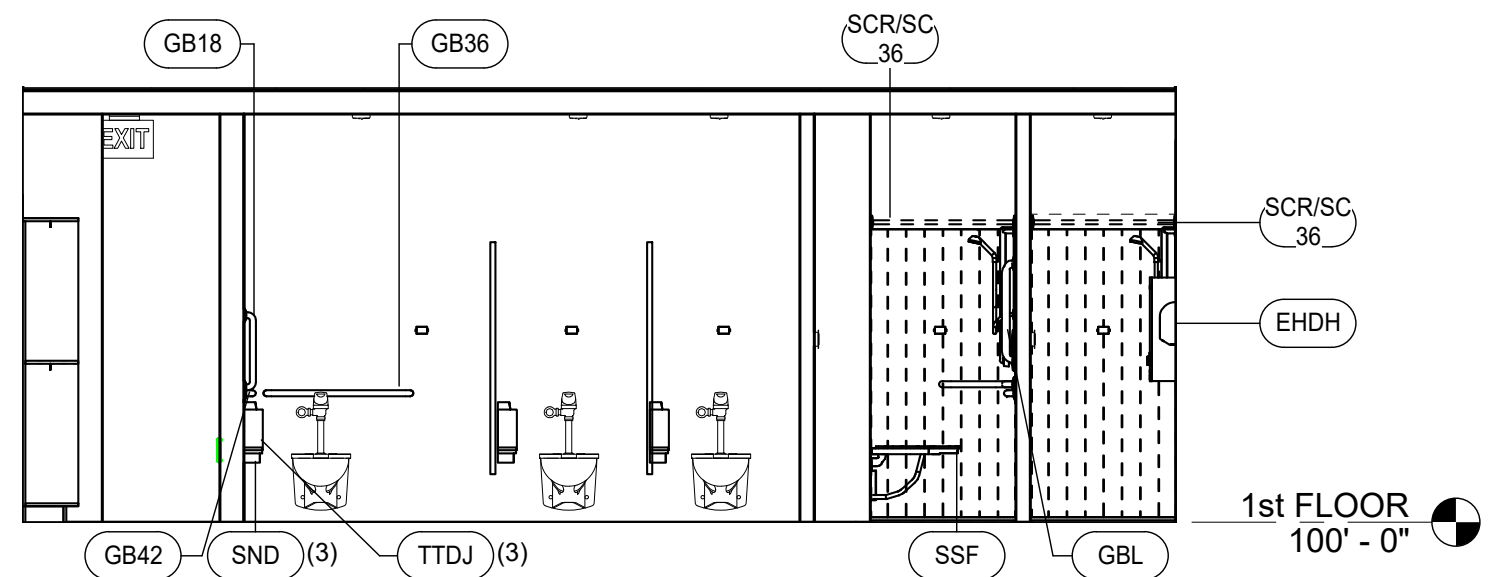


9 Interior Elevation
1/4" = 1'-0"




10 Interior Elevation
1/4" = 1'-0"

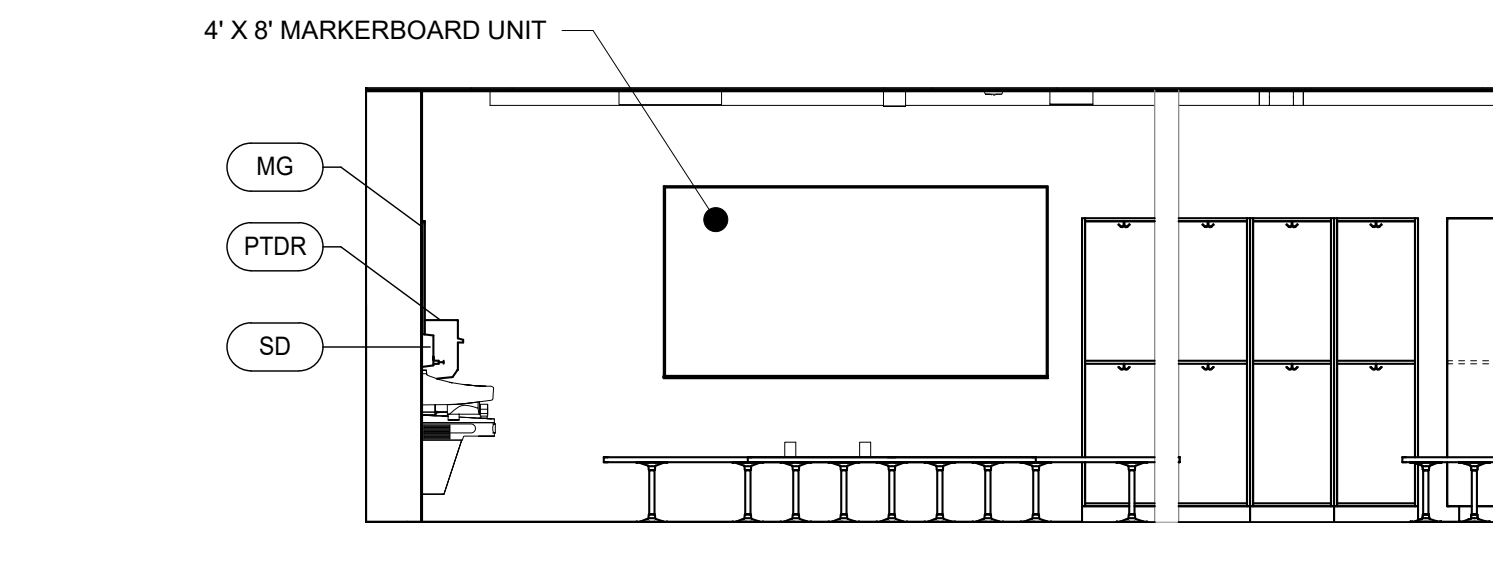

11 Interior Elevation
1/4" = 1'-0"

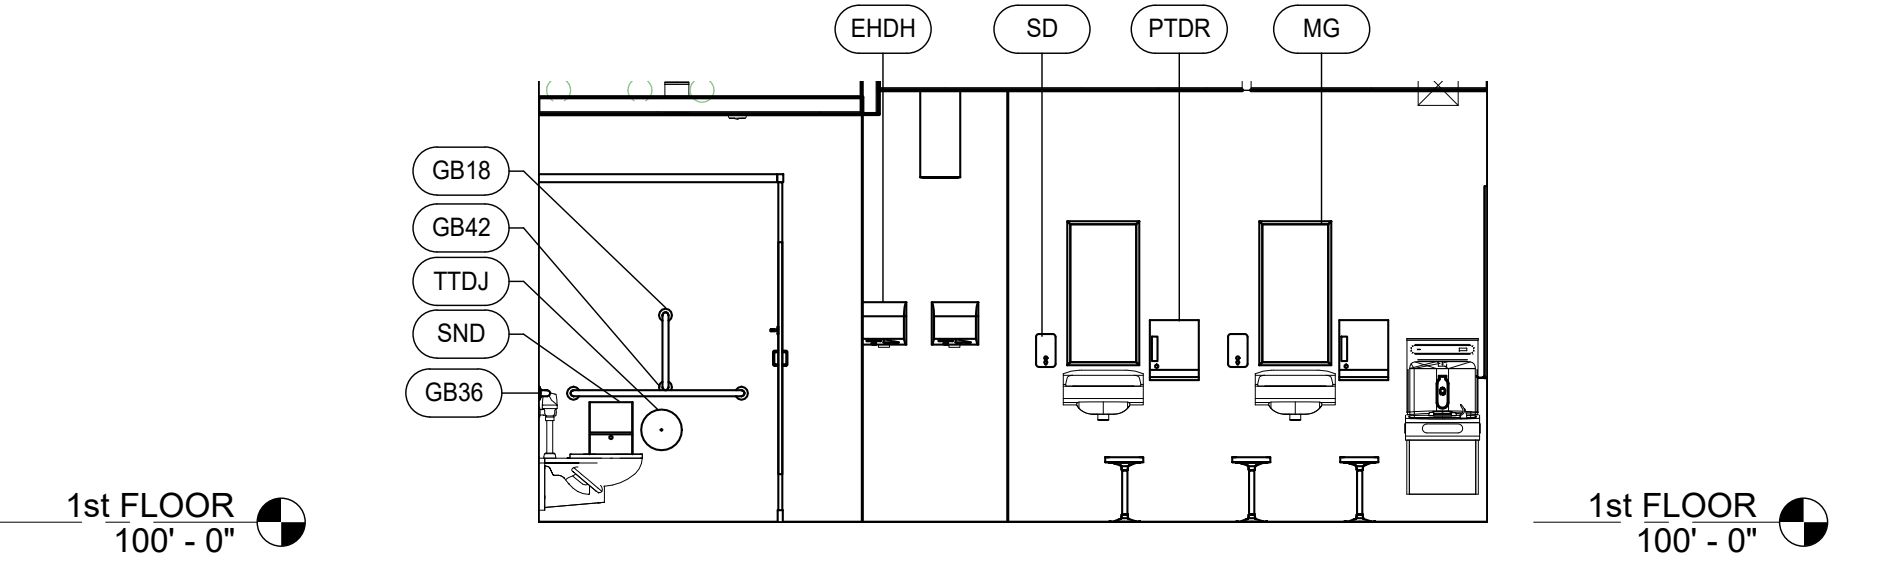


12 Interior Elevation
1/4" = 1'-0"

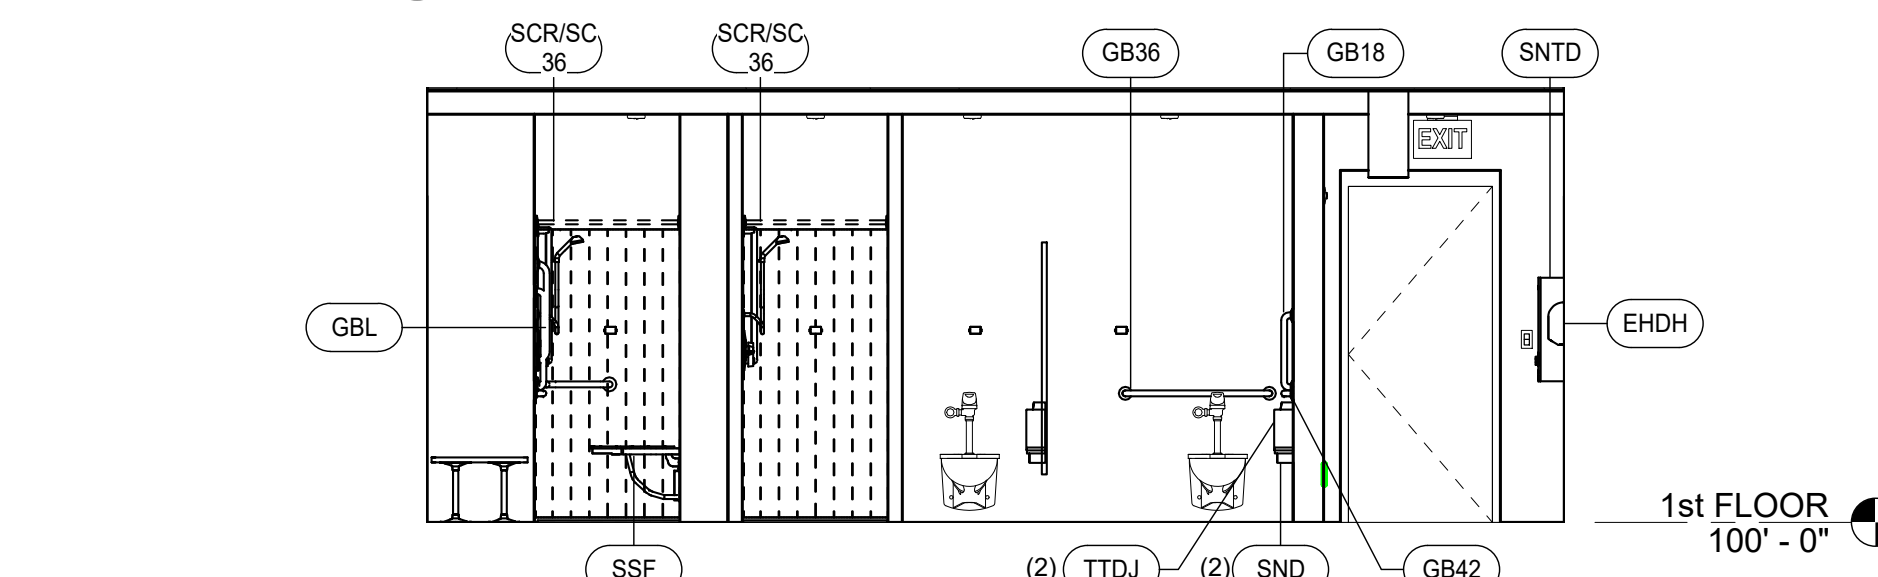

13 Interior Elevation
1/4" = 1'-0"

Toilet Room Accessory Schedule		
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SNTD	SANITARY NAPKIN AND TAMPON DISPENSER - SURFACE MOUNTED	
SND	SANITARY NAPKIN DISPOSAL	
SSF	SHOWER SEAT - FOLDING	
SD	SOAP DISPENSER - VERTICAL	
SSH	SOAP SHELF	
TTD	TOILET TISSUE DISPENSER	
TTDJ	TOILET TISSUE DISPENSER - JUMBO	

- General Toilet Room Notes**
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- B. CENTER ALL TOILET PARTITION DOORS WITHIN WIDTH OF STALL (UNLESS NOTED OTHERWISE). PROVIDE DOORS SIZED AS FOLLOWS:
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- C. REFER TO AA750 FOR TOILET ROOM ACCESSORY MOUNTING HEIGHTS AND TYPICAL LAYOUT DIMENSIONS.
- D. PROVIDE FILLER PANELS AS REQUIRED AT PLASTIC LOCKERS AND WOOD CUBBIES.
- E. PROVIDE SHOWER COMPARTMENTS AT SHOWERS AND TOILET PARTITIONS AT TOILETS.

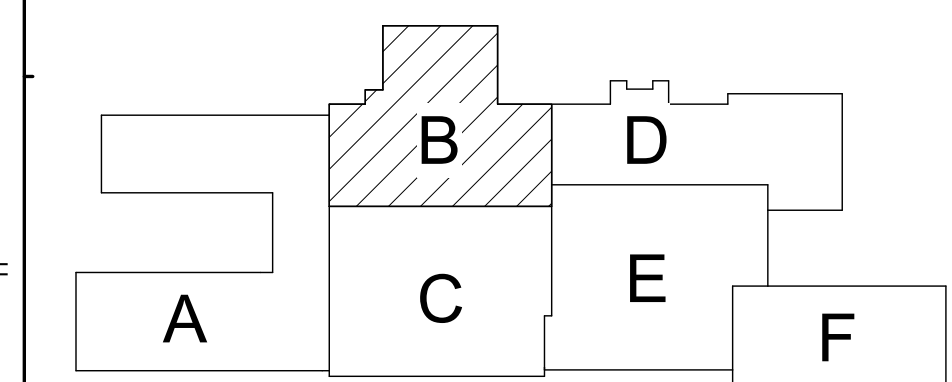

Key Plan
N.T.S.

SED Control No. 60-01-01-06-0-018-023

Rev. No.: Date: Description:



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Waverly Central School District
Waverly, NY


Additions and Alterations to:
Waverly Jr. Sr. High School

Enlarged Team Room/Toilet Room
Plans and Interior Elevations

Drawn By: KCB
Project No.: 339070-22003

Date: 05/19/2023

Drawing Number: AA401

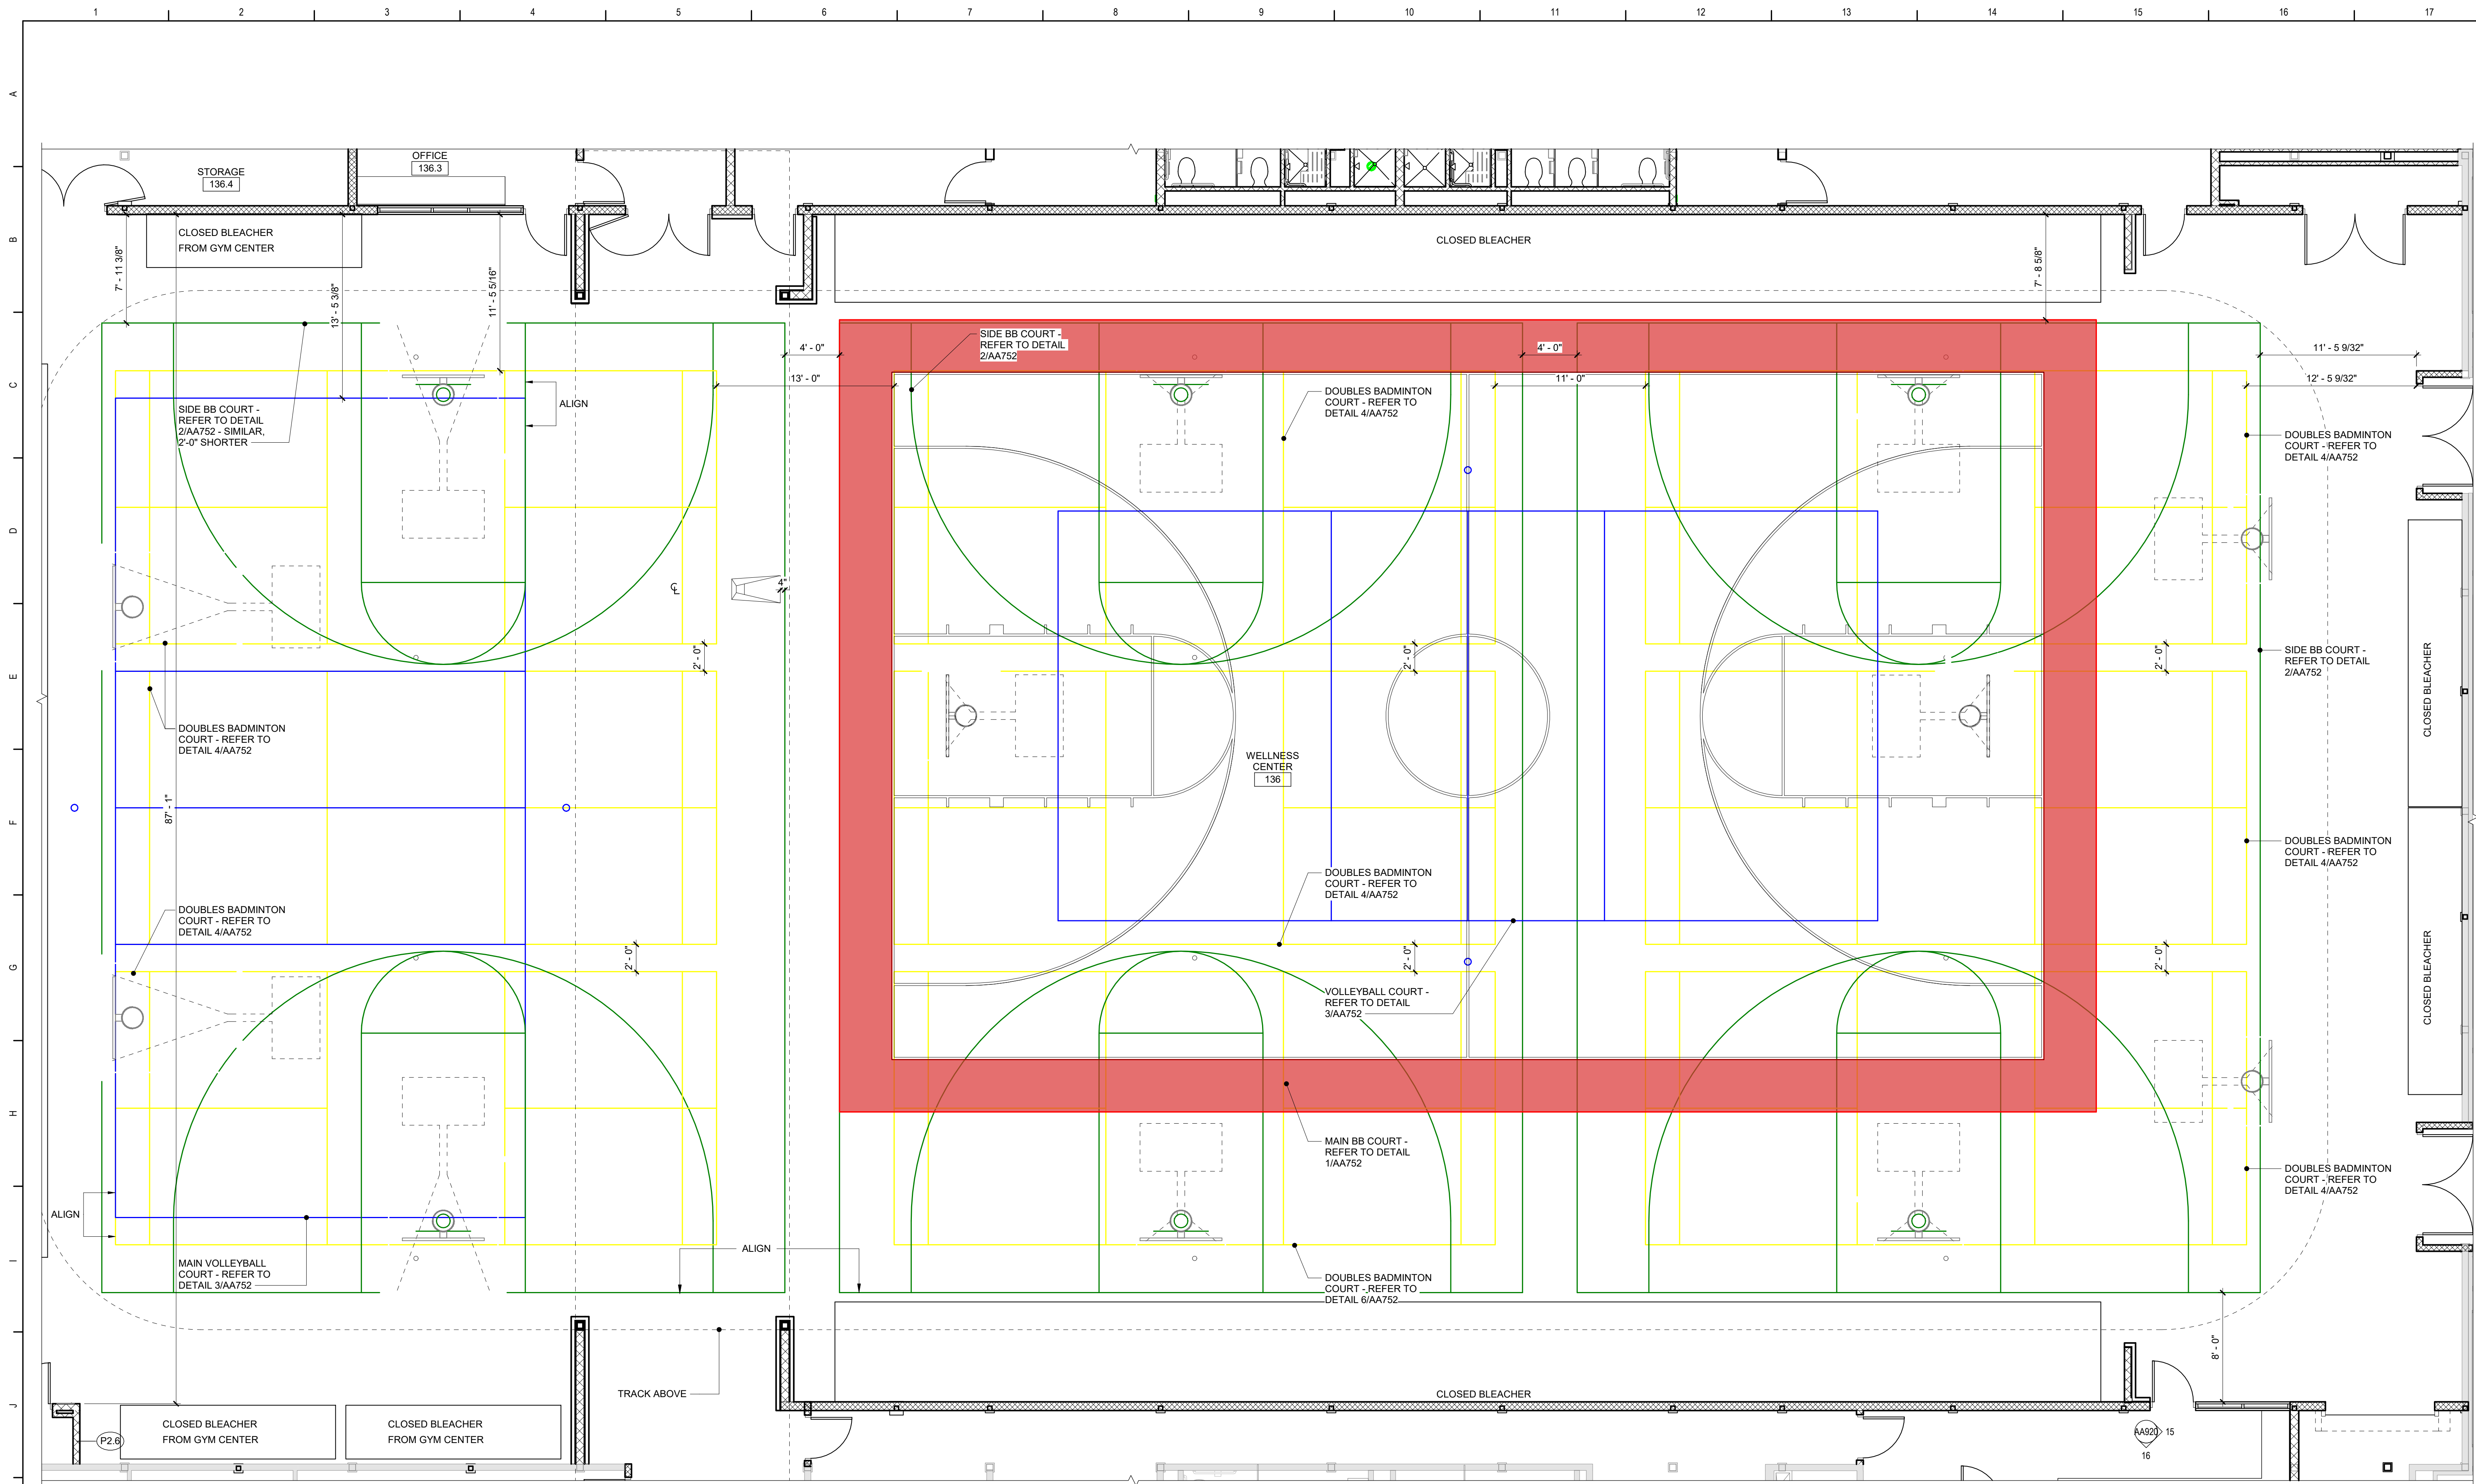


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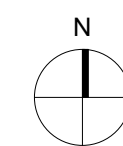
1 2 3 4 5 6 7 8 9 10 11 12 13 14 15 16 17

Striping Plan Notes

- A. REFER TO GENERAL NOTES ON KEY PLANS FOR ADDITIONAL INFORMATION.
- B. REFER TO FINISH DRAWINGS FOR FINISH INFORMATION.
- C. REFER TO AA753 FOR COLOR RENDERING OF FLOOR DESIGN INTENT AND FOR LEVEL OF COMPLEXITY OF STRIPING AND LOGOS. FINAL DESIGN TO BE DETERMINED DURING SUBMITTAL PROCESS.
- D. FOR PURPOSES OF COURT LINE OVERLAPS, PRIORITY OF COURTS ARE AS FOLLOWS:
1. MAIN BASKETBALL, INCLUDING APRON/TEXT/GRAPHICS (1 COURT)
 2. MAIN VOLLEYBALL (1 COURT)
 3. SIDE BASKETBALL (3 COURTS)
 4. SIDE VOLLEYBALL (1 COURT)
 5. DOUBLES BADMINTON (9 COURTS)
- E. EXACT LINE STRIPING COLORS TO BE SELECTED BY ARCHITECT ISSUED DURING CONSTRUCTION FROM MFR'S FULL LINE OF STANDARD AND CUSTOM COLORS.
- F. ASSUME EACH TYPE OF COURT TO BE A DIFFERENT COLOR AND APRONS, KEYS AND GRAPHICS WILL BE DIFFERENT COLORS THAN OTHER STRIPING.

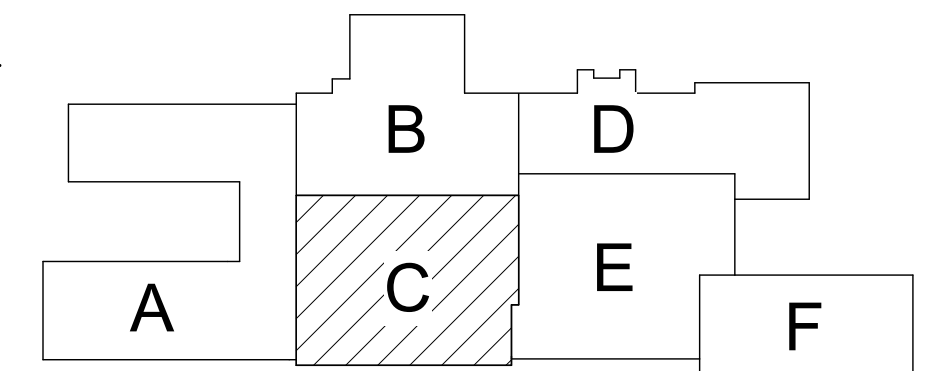

Key Plan
N.T.S.



SED Control No. 60-01-01-06-0-018-023

Rev. No.: Date: Description:



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Waverly Central School District
Waverly, NY

Additions and Alterations to:
Waverly Jr. Sr. High School

Enlarged Striping Plan

Drawn By:
KCB
Project No.:
339070-22003


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05/19/2023

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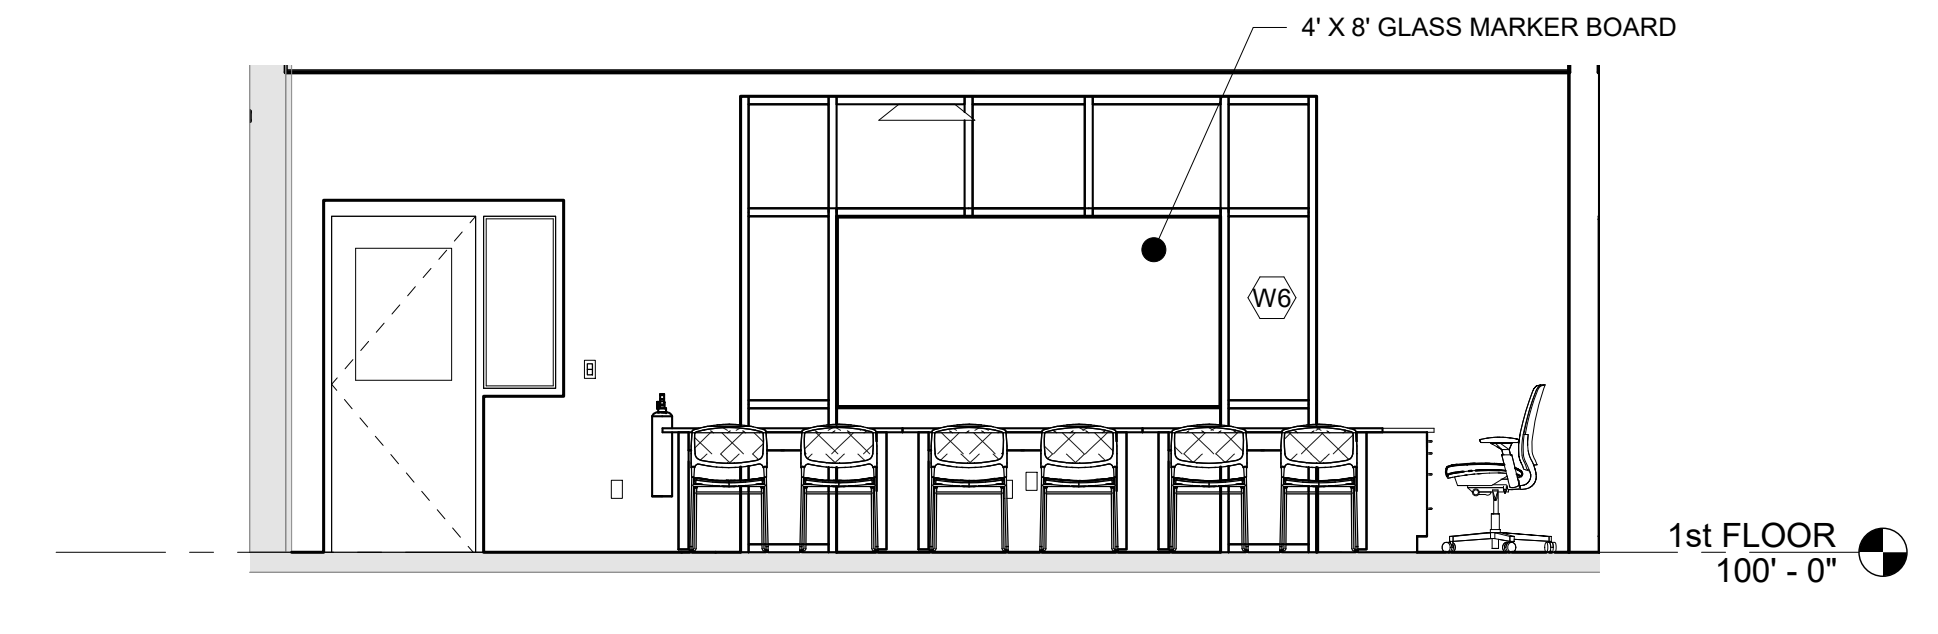
1 Striping Plan - Wellness Center

3/16" = 1'-0"


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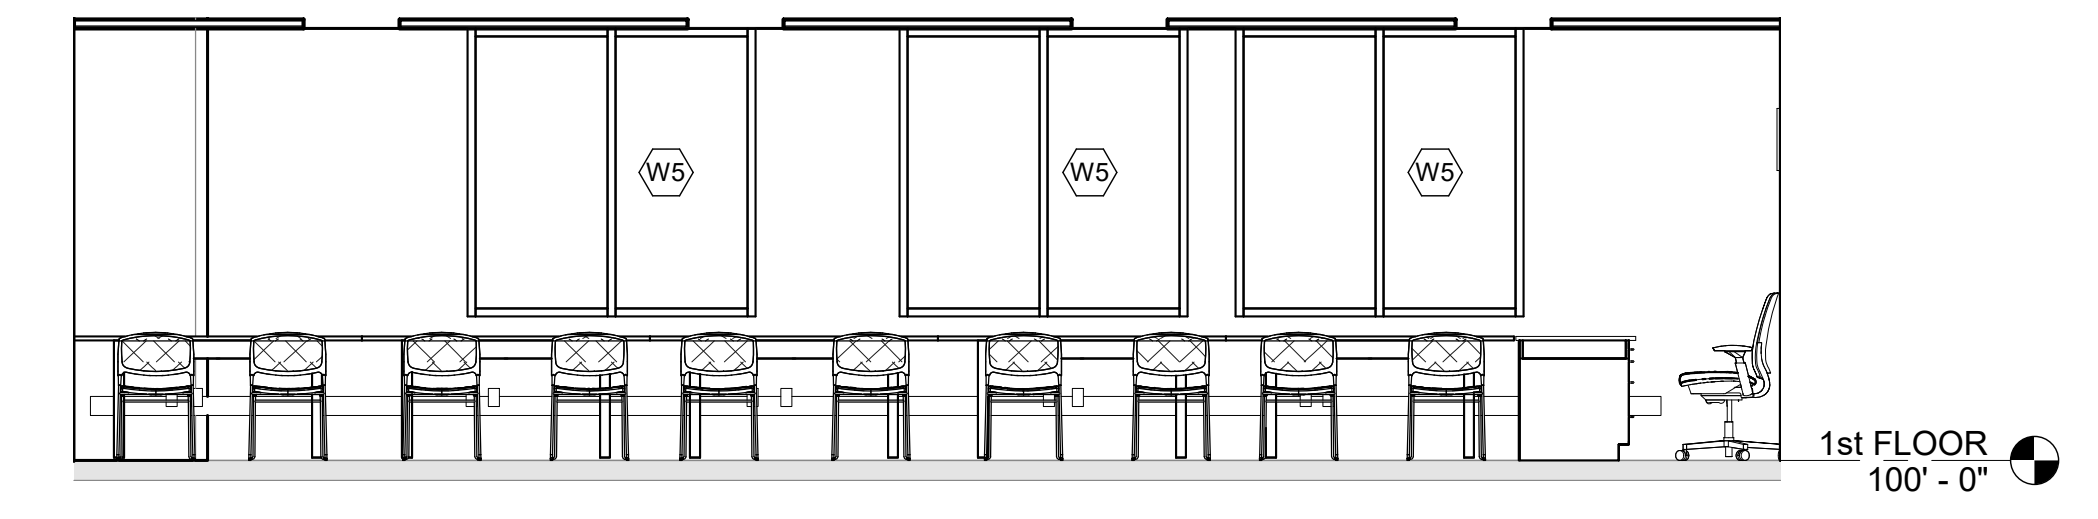
2 Interior Elevation - Computer Labs 121 and 122
1/4" = 1'-0"

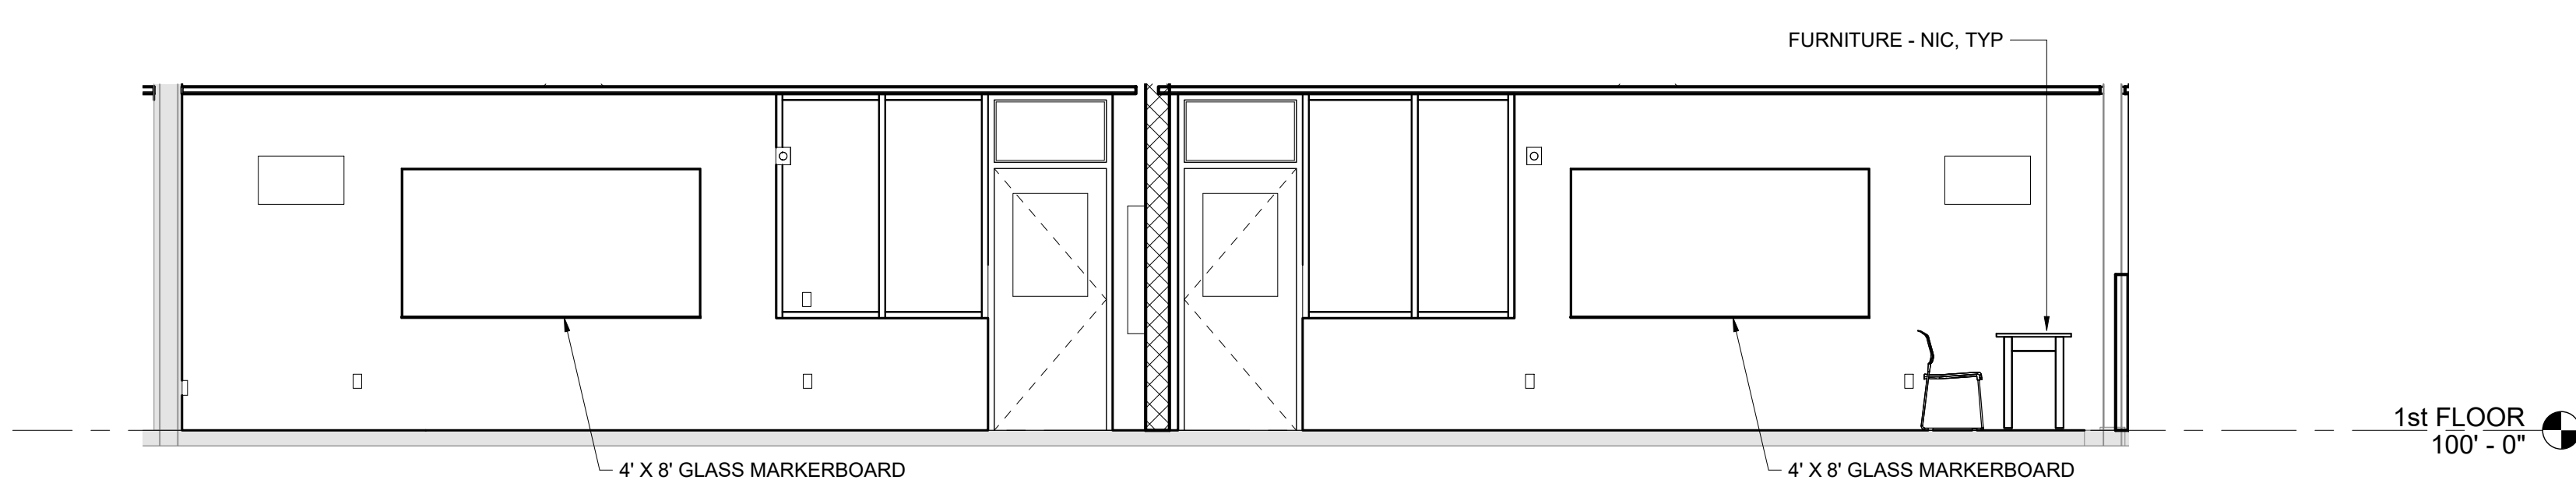


1 Interior Elevation - Computer Lab 123c
1/4" = 1'-0"




4 Interior Elevation - Corridor 117.99 Near Vest. 5104
1/4" = 1'-0"

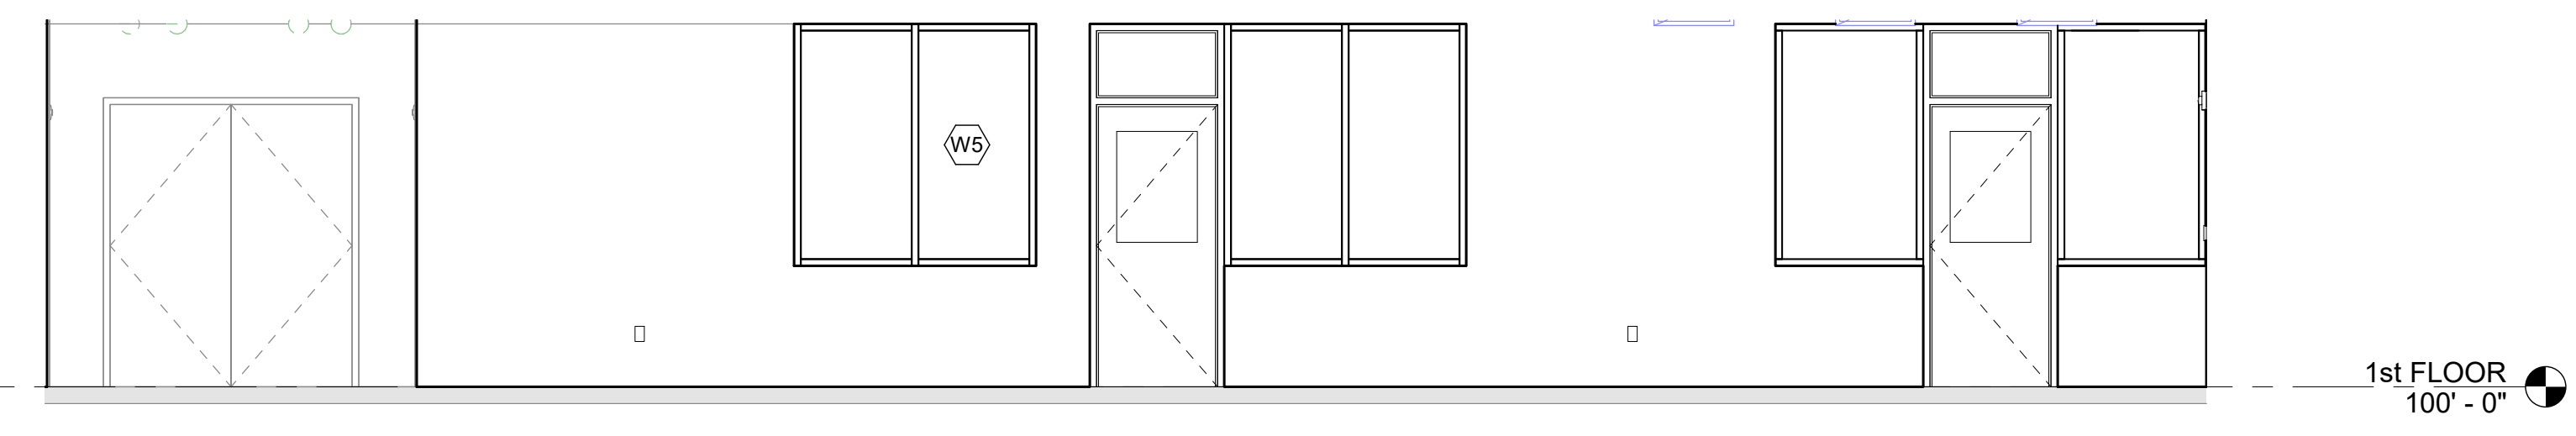


3 Interior Elevation - Computer Lab 121
1/4" = 1'-0"

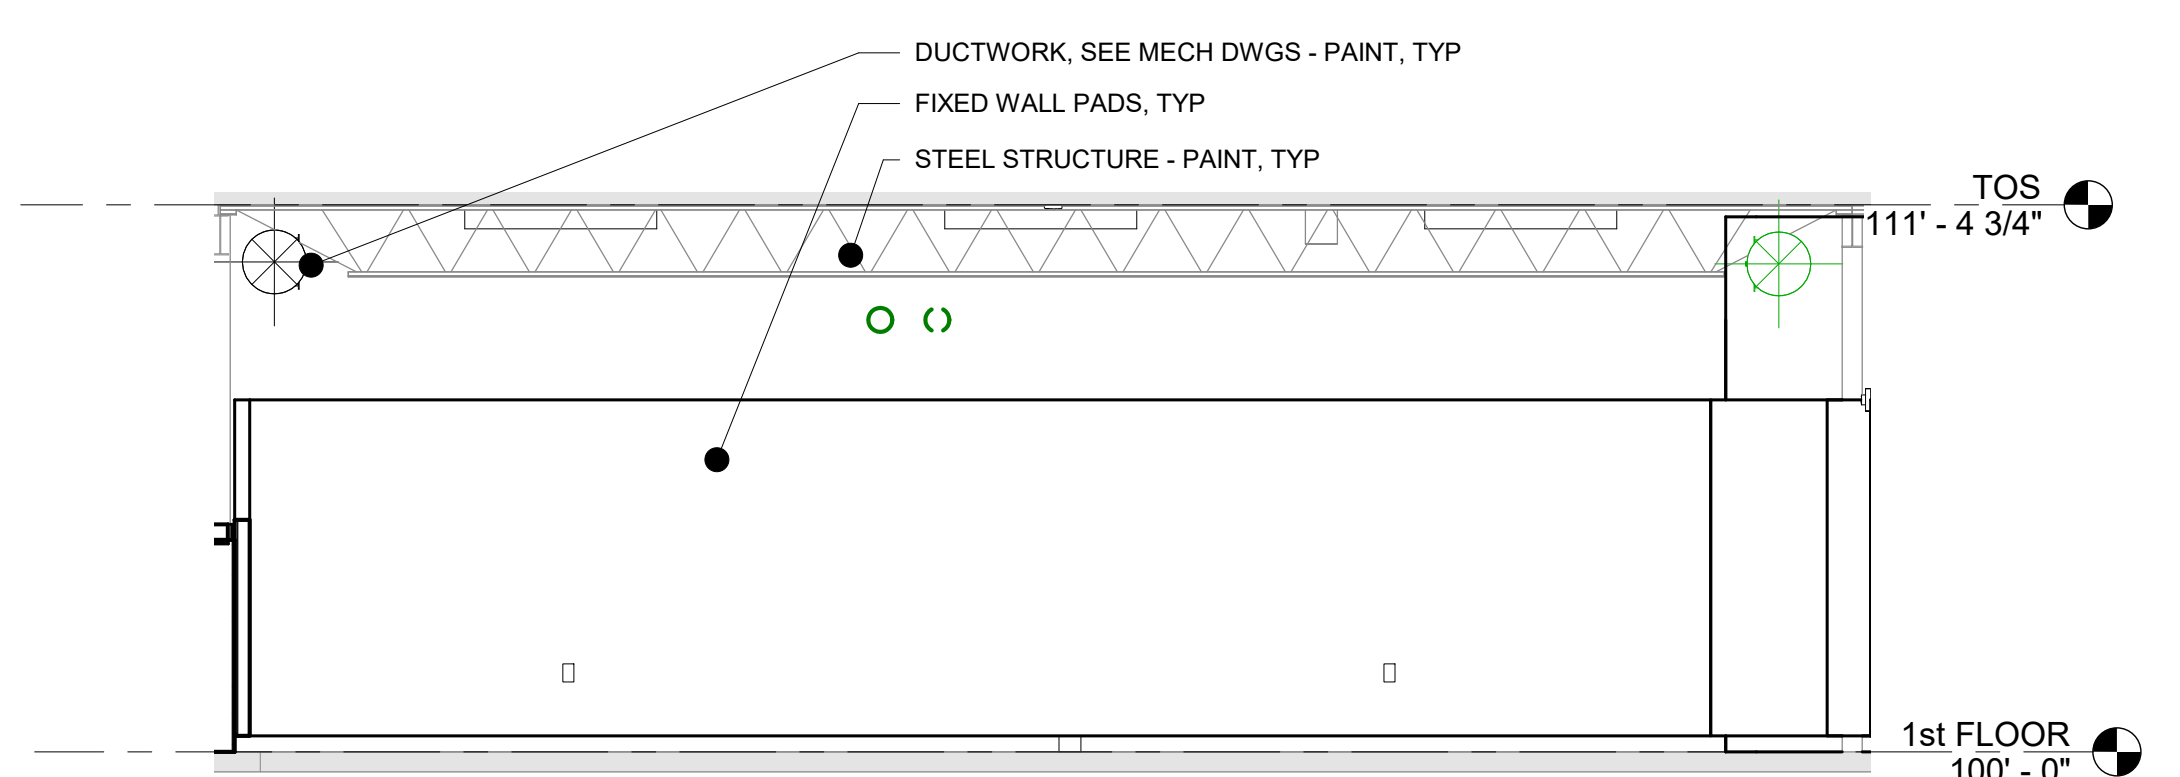


6 Interior Elevation - Auxiliary Gymnasium
1/4" = 1'-0"

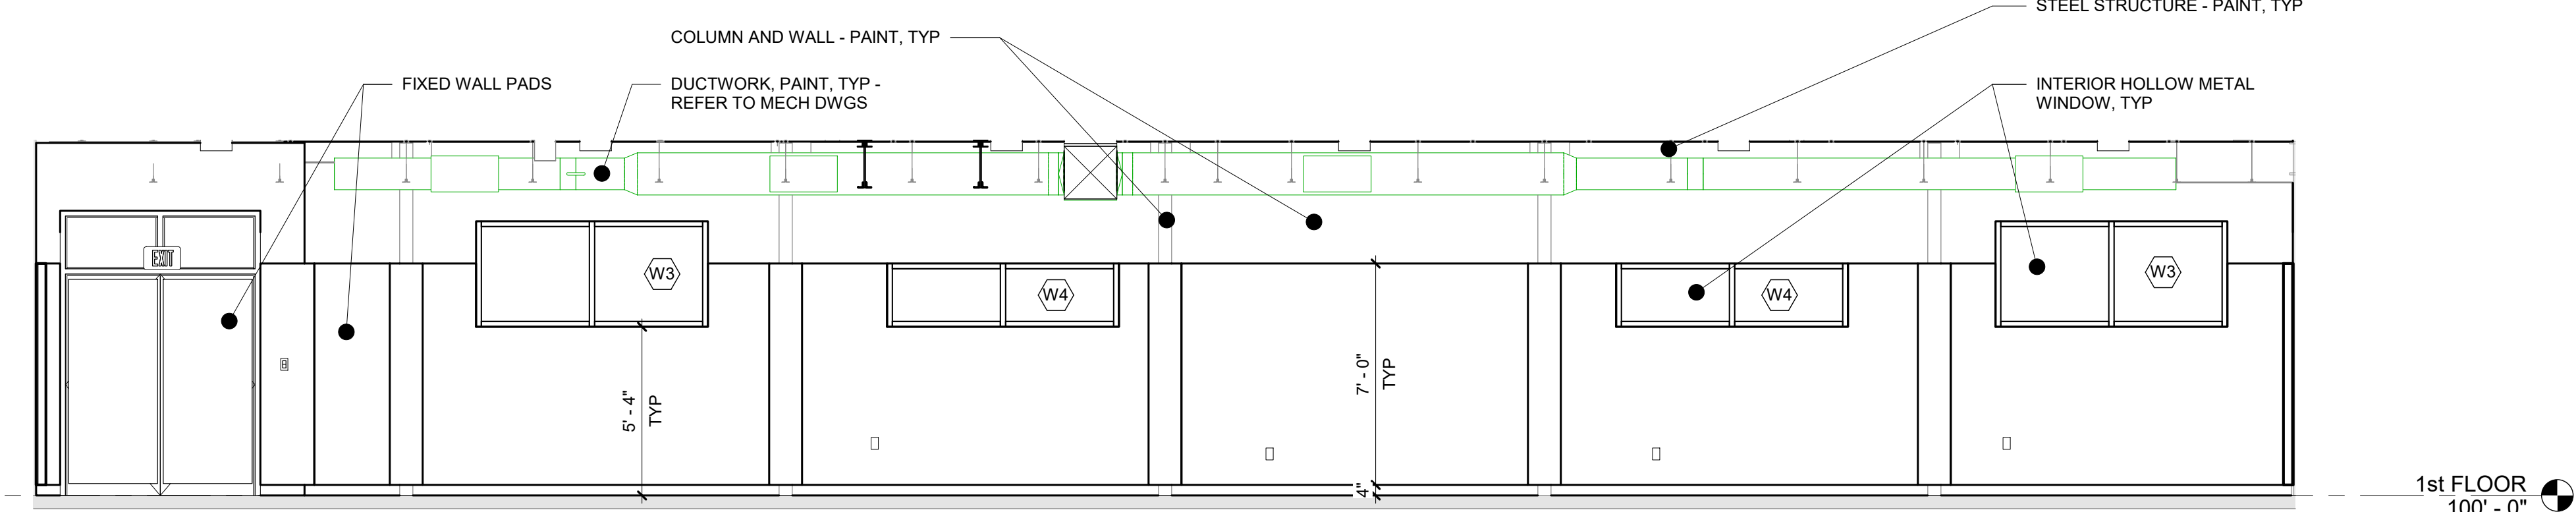


5 Interior Elevation - Auxiliary Gymnasium
1/4" = 1'-0"

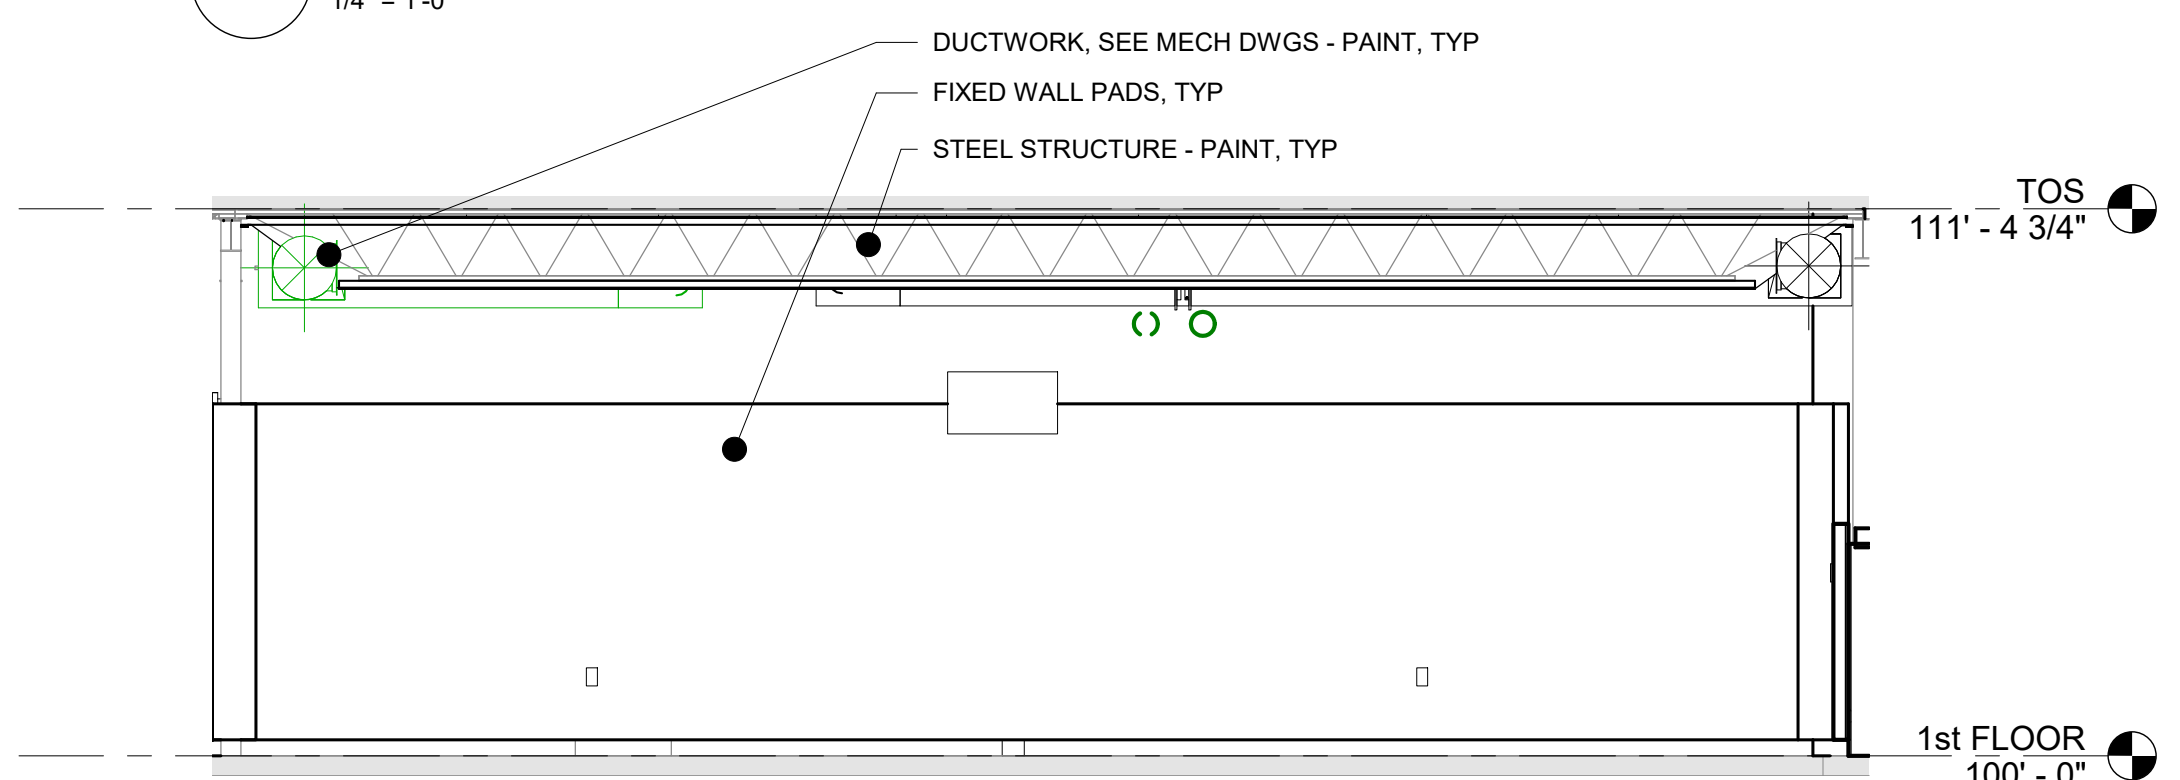


8 Interior Elevation - Auxiliary Gymnasium
1/4" = 1'-0"

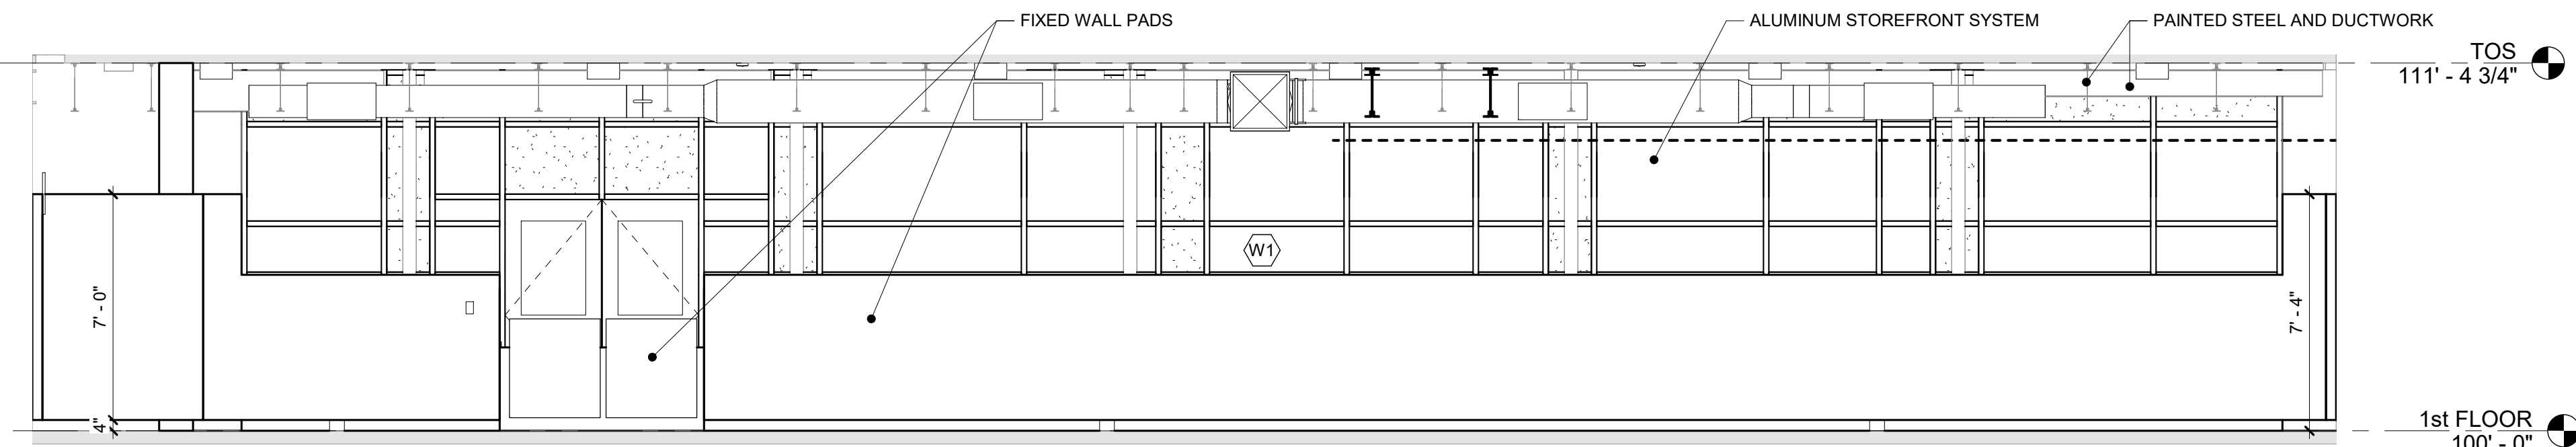

7 Interior Elevation - Auxiliary Gymnasium
1/4" = 1'-0"

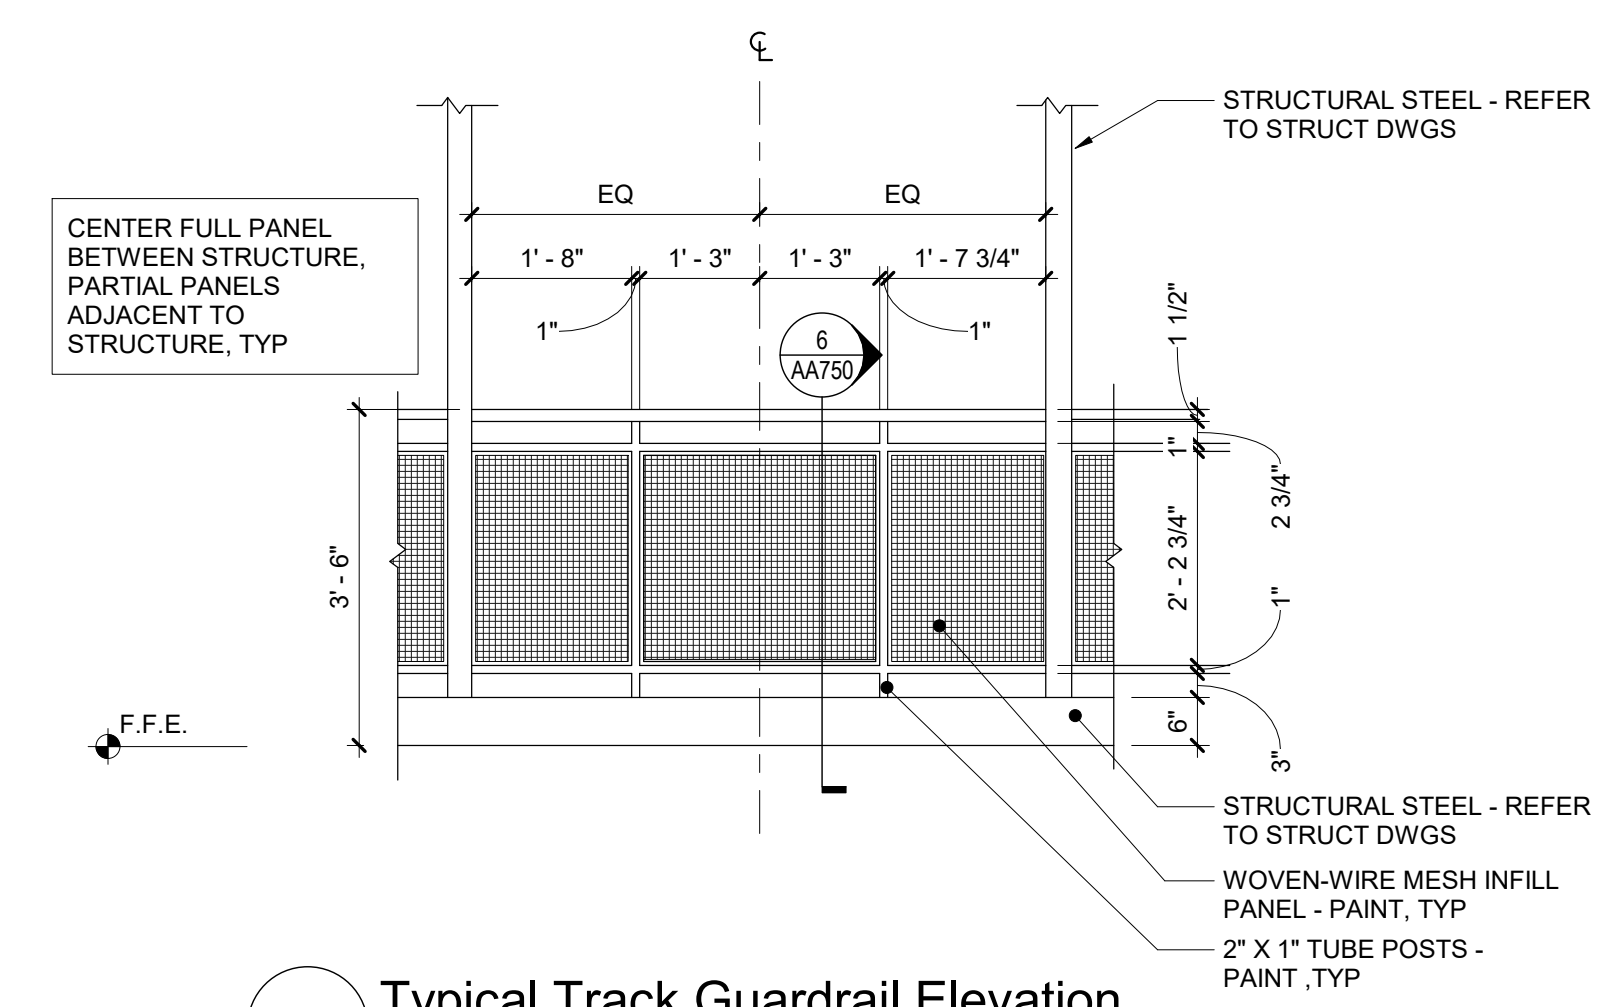

9 Typical Track Guardrail Elevation
1/2" = 1'-0"

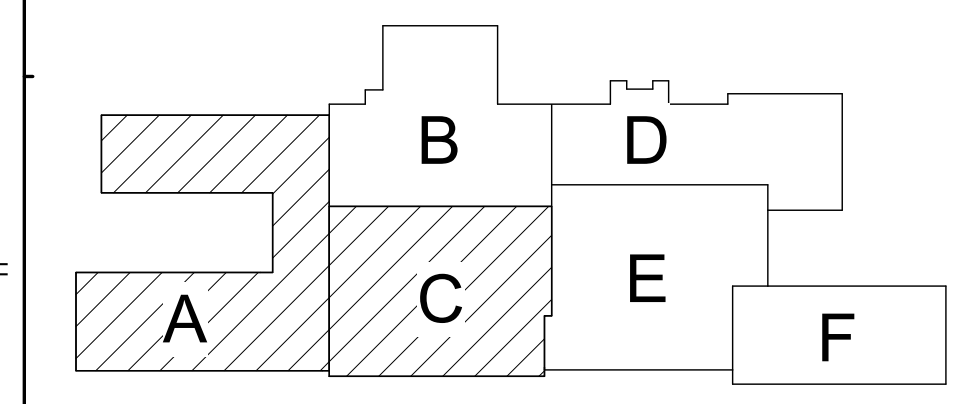

Key Plan
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Waverly Central School District
Waverly, NY


Additions and Alterations to:
Waverly Jr. Sr. High School

Interior Elevations


Drawn By: KCB
Project No.: 339070-22003

Date: 05/19/2023

Drawing Number: AA404

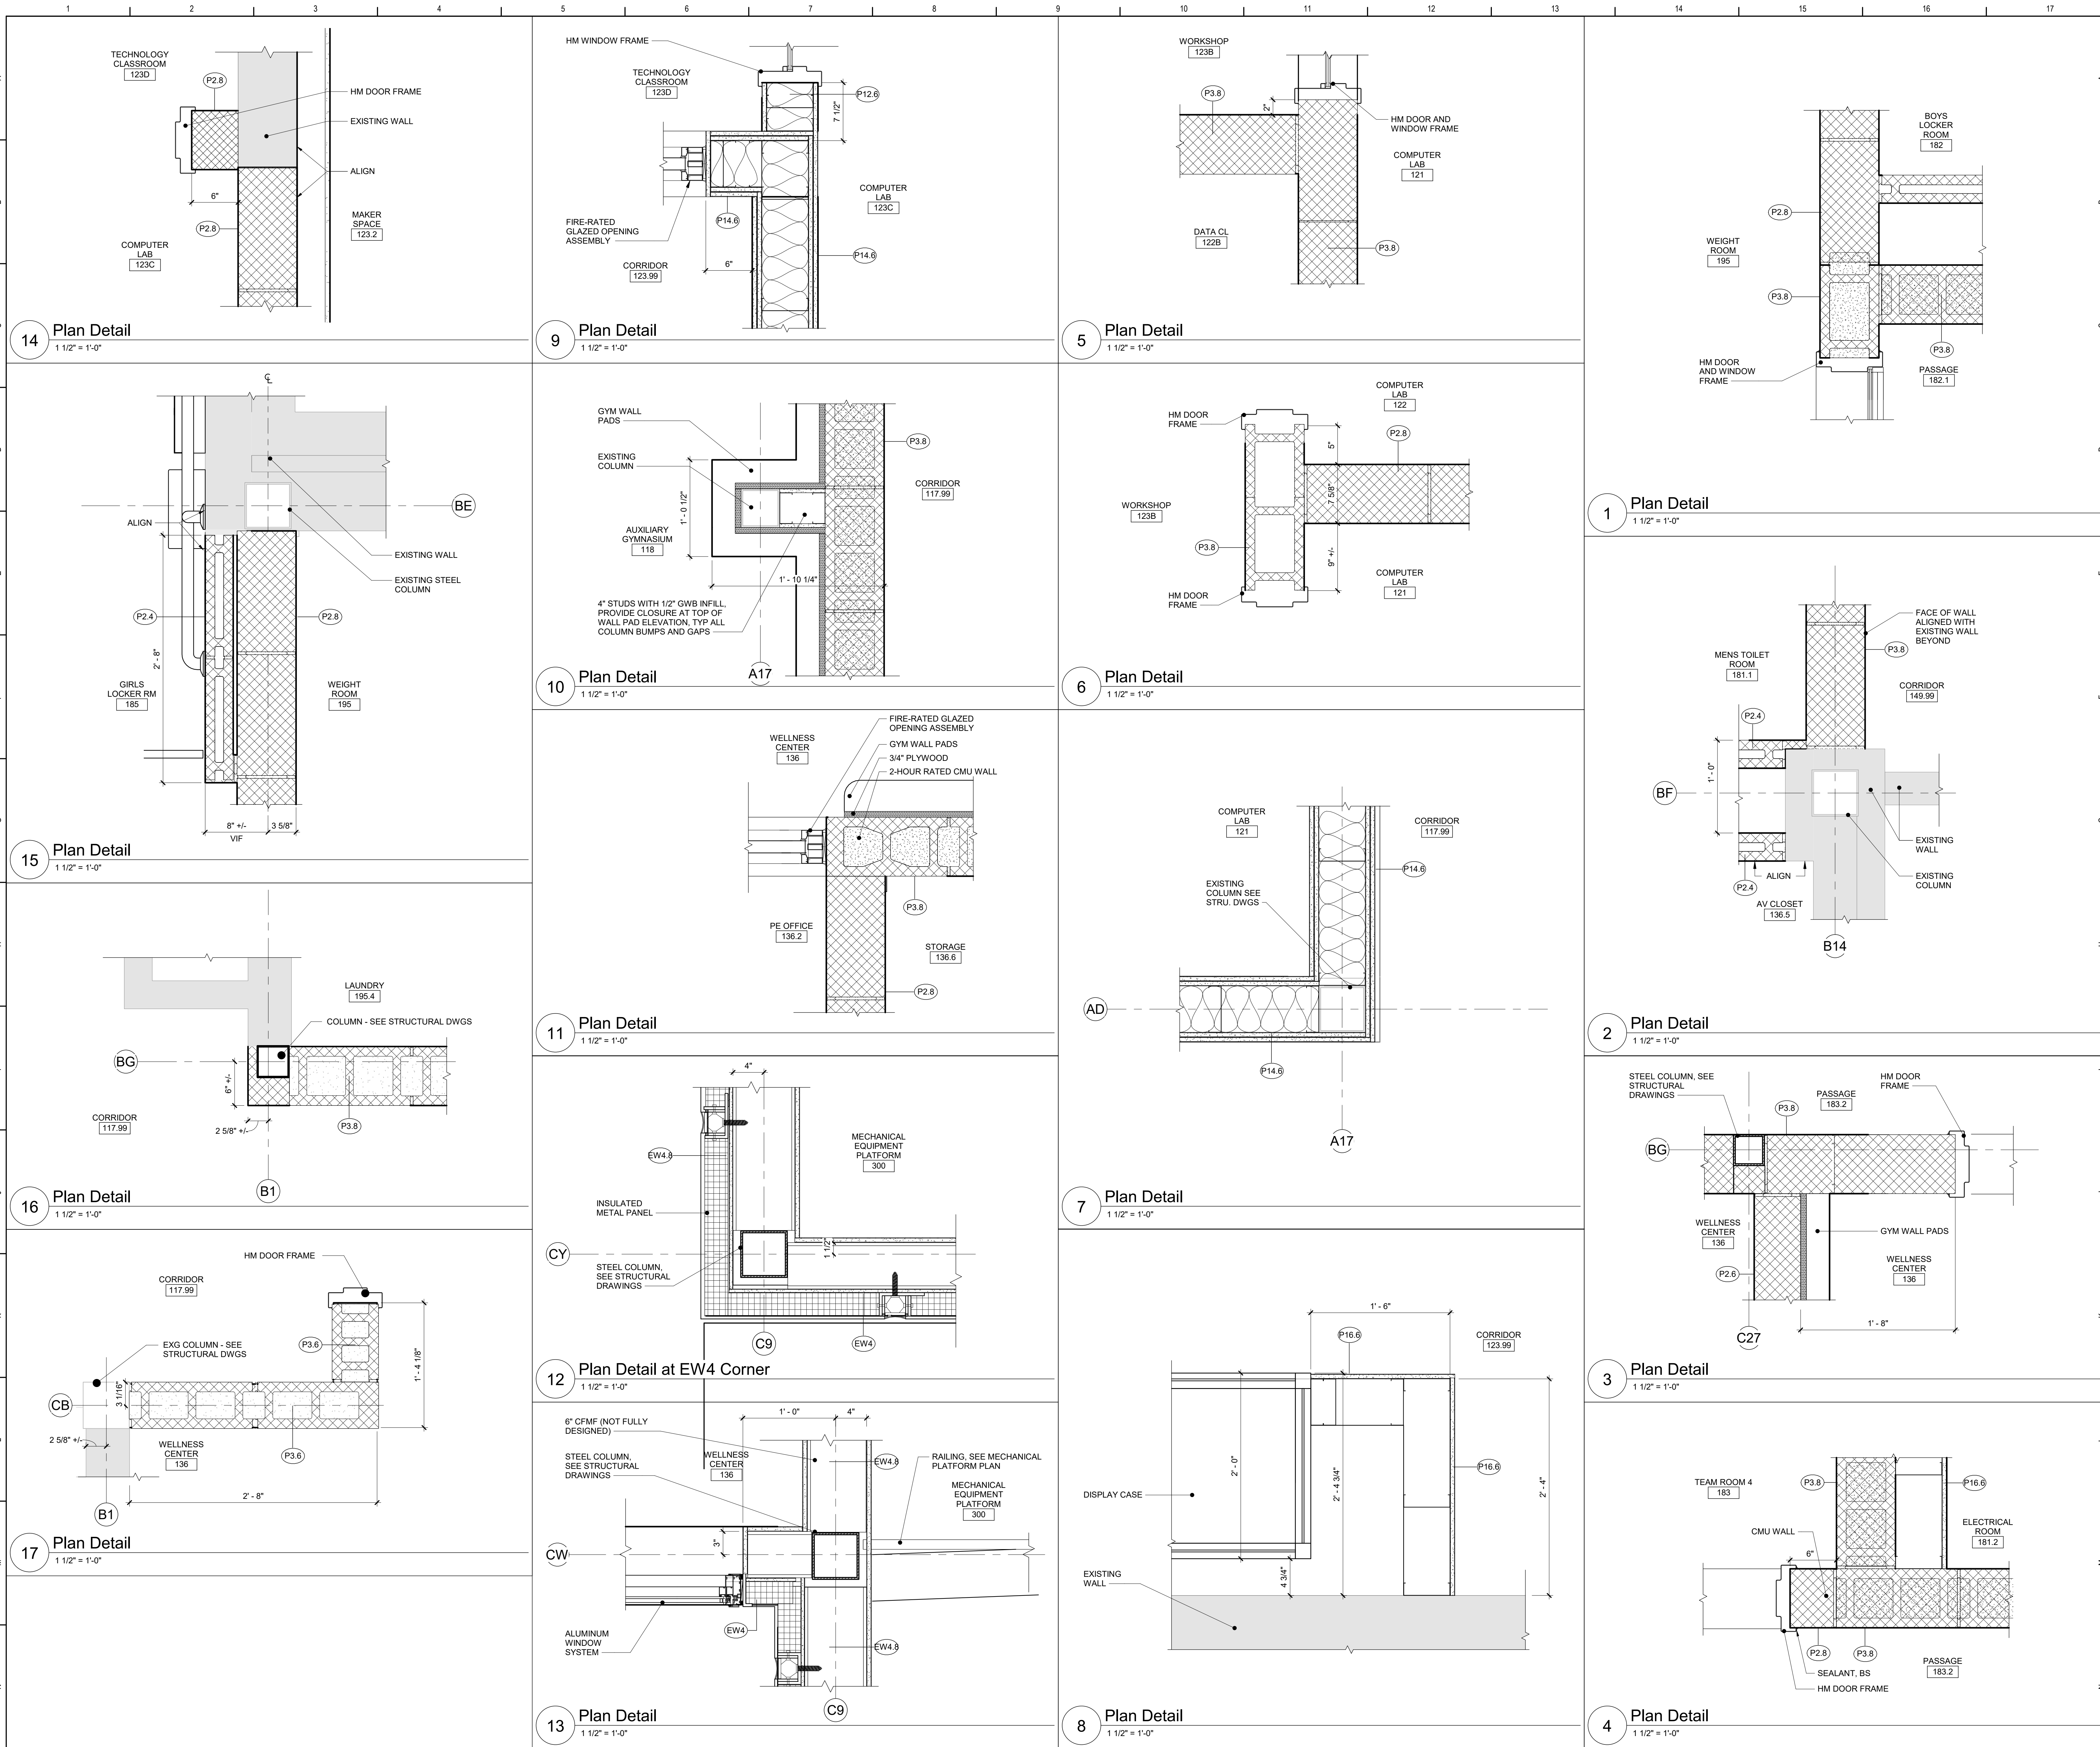

- General Construction Notes**
- A. DETAILS AND SECTIONS INDICATE SPECIFIC MATERIALS AND LAYOUT DIMENSIONS. REFER TO MASONRY PLAN DETAILS FOR SPECIFIC REQUIREMENTS REGARDING CONTROL AND EXPANSION JOINTS, TIES AND REINFORCEMENT, ETC.
 - B. ALL NOTES DESCRIBED ON ONE SECTION OR DETAIL APPLY TO ALL SECTIONS OR DETAILS, TYPICAL UNLESS NOTED OTHERWISE.
 - C. REFER TO FINISH DRAWINGS FOR FINISH INFORMATION.
 - D. REFER TO DOOR SCHEDULE FOR ADDITIONAL DOOR INFORMATION.
 - E. REFER TO STRUCTURAL DRAWINGS FOR SPECIFIC FRAMING DETAILS, LINTEL DETAILS AND SHEAR WALL DETAILS.

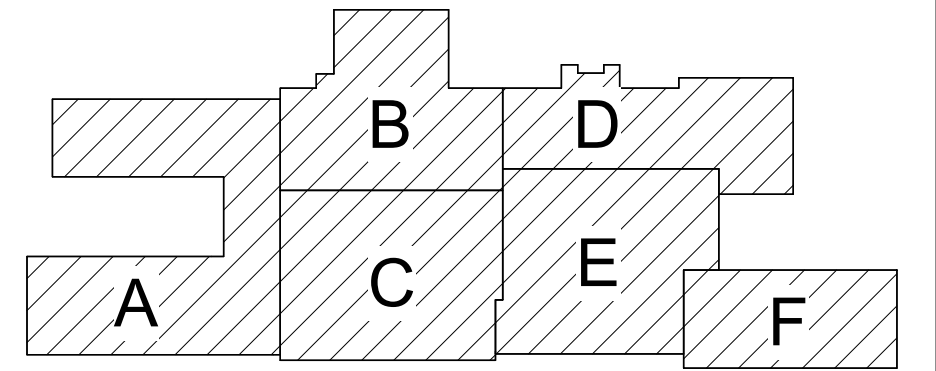

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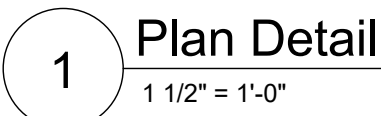
TETRA TECH
ARCHITECTS & ENGINEERS


Waverly Central School District
Waverly, NY

Additions and Alterations to:
Waverly Jr. Sr. High School


Plan Details

Drawn By: KCB	Date: 05/19/2023	Drawing Number:
Project No.: 339070-22003		AA500


$$1\frac{1}{2}'' = 1'-0''$$
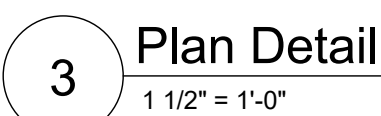
$$1\frac{1}{2}'' = 1'-0''$$


1 1/2" = 1'-0"

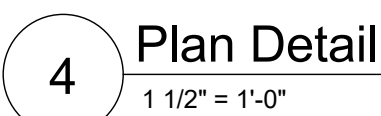

1 1/2" = 1'-0"

- A. DETAILS AND SECTIONS INDICATE SPECIFIC MATERIALS AND LAYOUT DIMENSIONS. REFER TO MASONRY PLAN DETAILS FOR SPECIFIC REQUIREMENTS REGARDING CONTROL AND EXPANSION JOINTS, TIES AND REINFORCEMENT, ETC.
- B. ALL NOTES DESCRIBED ON ONE SECTION OR DETAIL APPLY TO ALL SECTIONS OR DETAILS, TYPICAL UNLESS NOTED OTHERWISE.
- C. REFER TO FINISH DRAWINGS FOR FINISH INFORMATION.
- D. REFER TO DOOR SCHEDULE FOR ADDITIONAL DOOR INFORMATION.
- E. REFER TO STRUCTURAL DRAWINGS FOR SPECIFIC FRAMING DETAILS, LINTEL DETAILS AND SHEAR WALL DETAILS.



Key Plan
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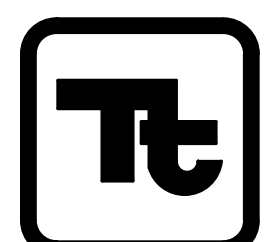
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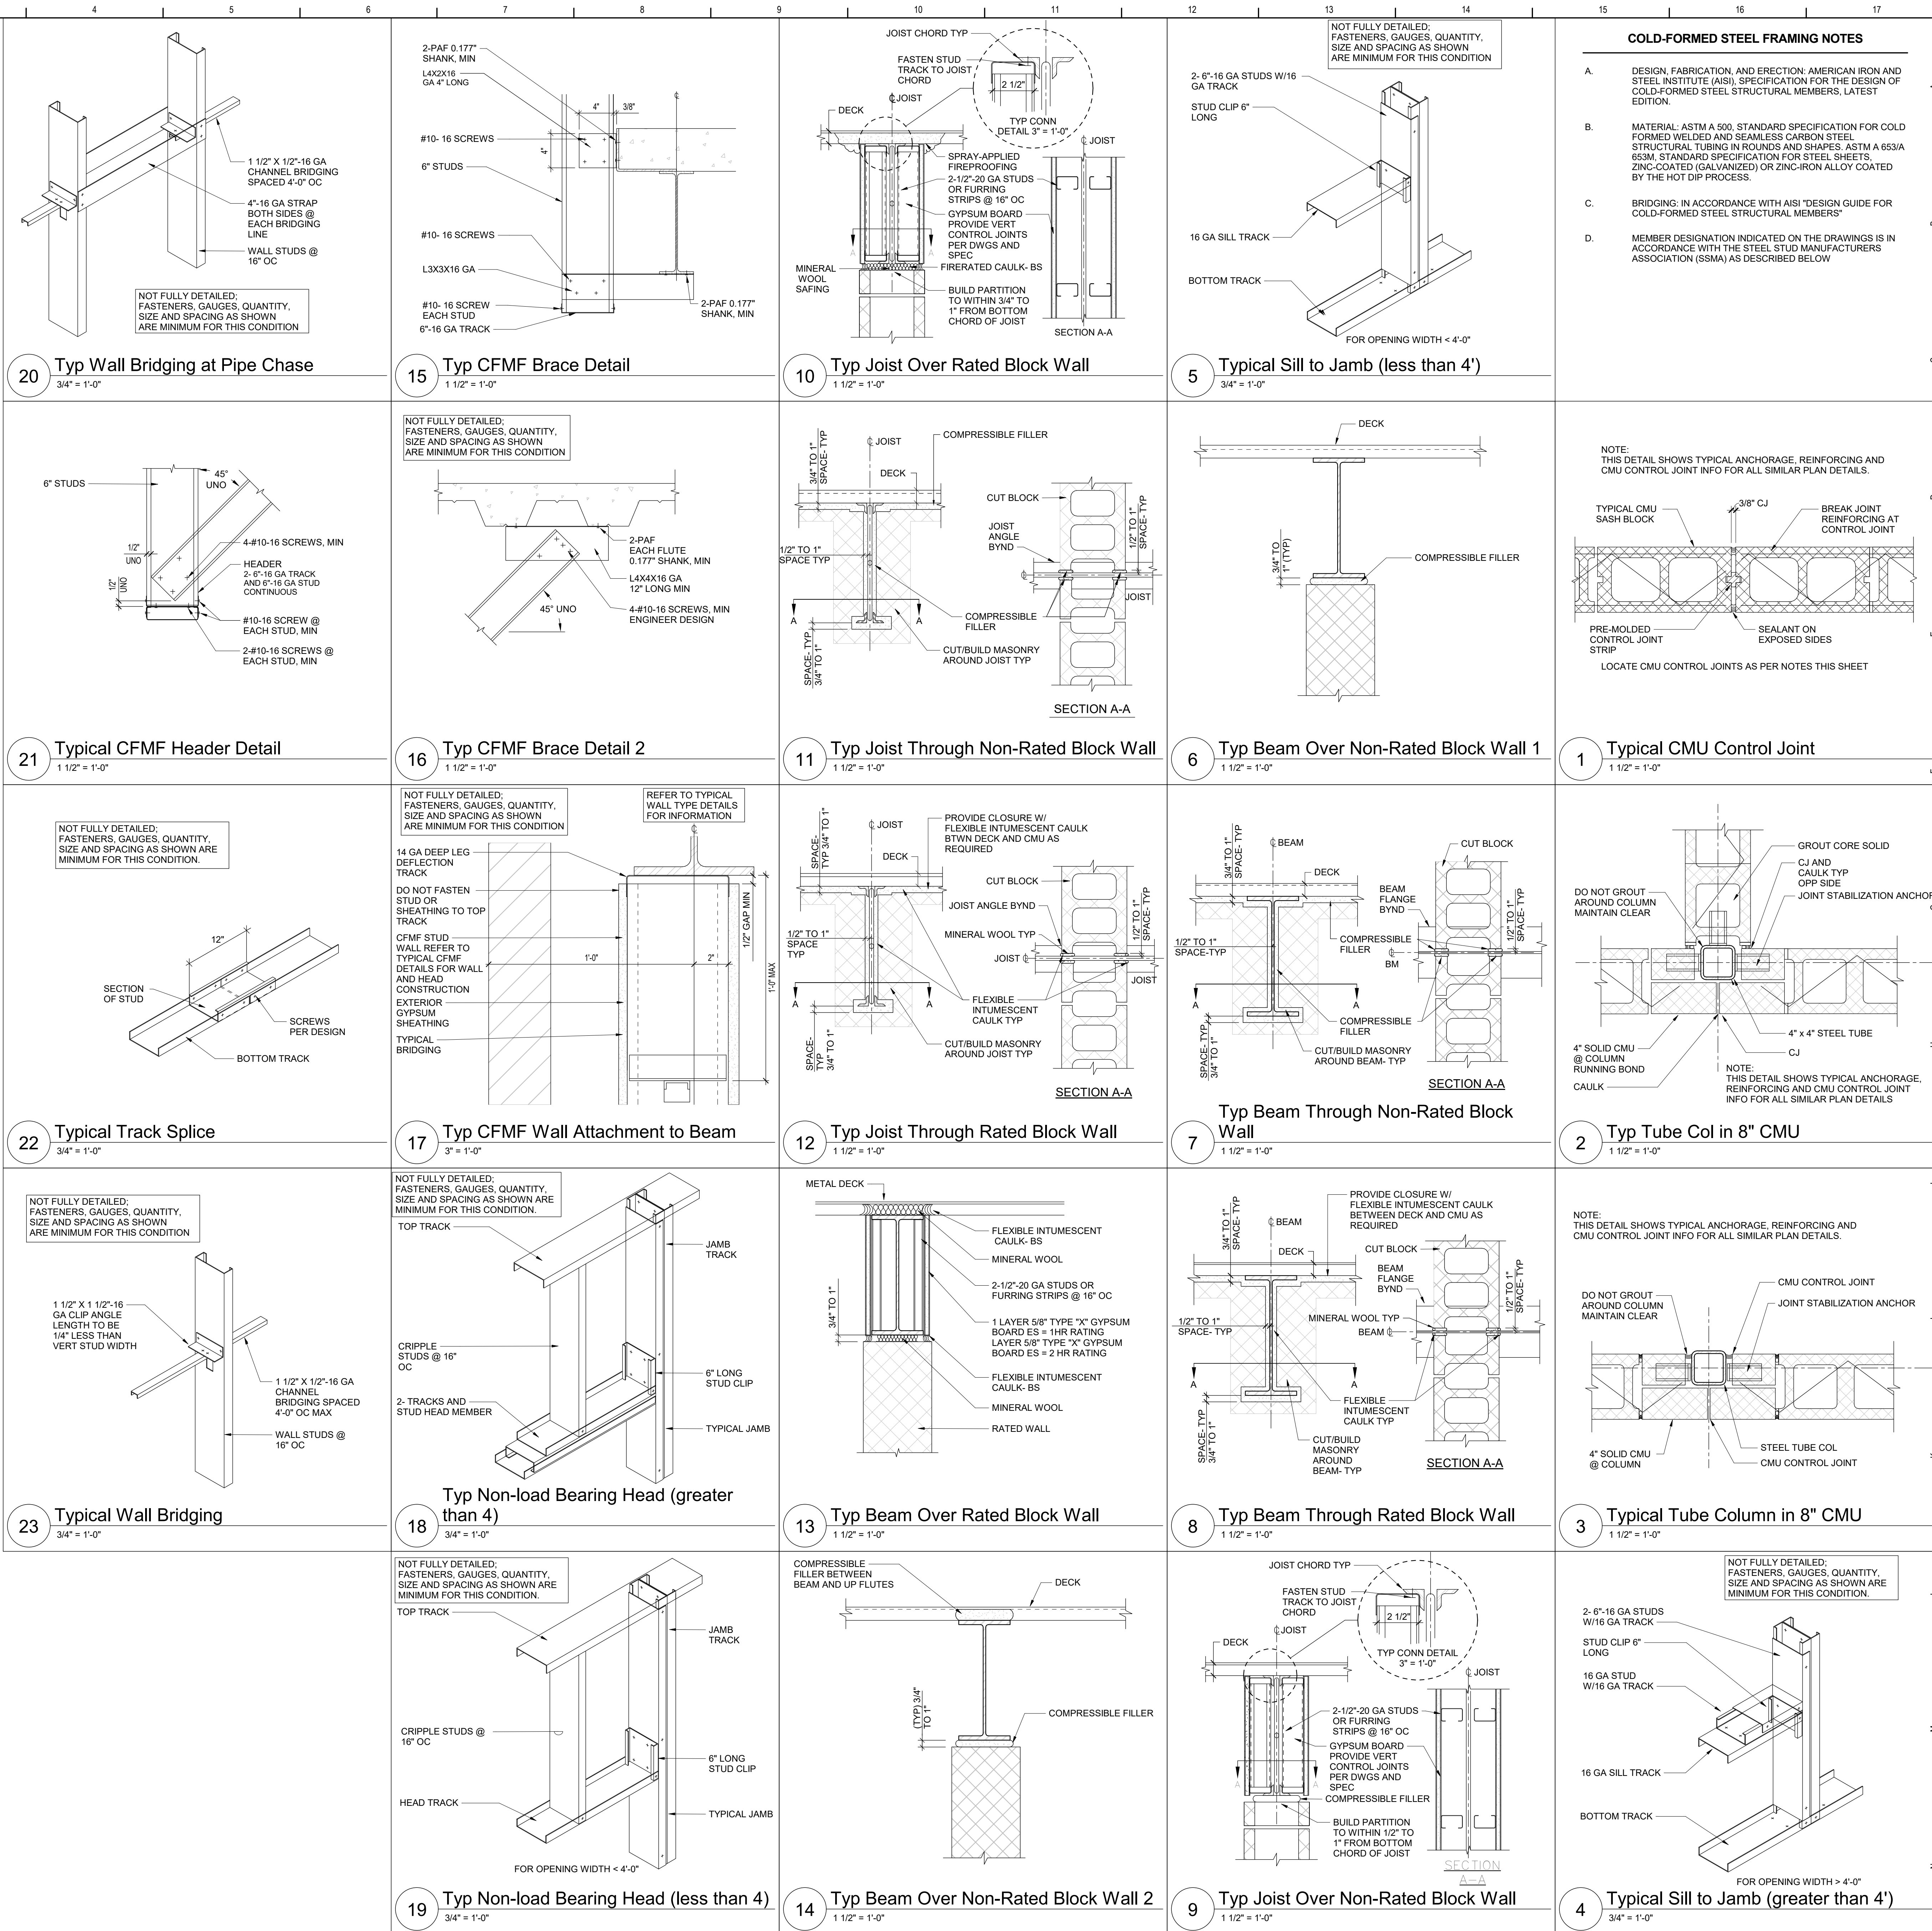
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Waverly, NY

Additions and Alterations to:
Waverly Jr. Sr. High School

Plan Details

Drawn By: Author	Date: 05/19/2023	Drawing Number:
Project No.: 339070-22003		AA501



Concrete Masonry Control Joints

VERTICAL CONTROL JOINTS IN CONCRETE MASONRY WALLS ARE INSTALLED AS A METHOD OF RELIEVING STRESSES IN THE CONCRETE BLOCK THAT OCCUR BECAUSE OF DRYING SHRINKAGE. PROVIDE THESE TYPES OF JOINTS AT ALL COLUMN LOCATIONS IN ACCORDANCE WITH THE TYPICAL COLUMN/MASONRY PLAN DETAILS SHOWN ON THIS SHEET AND ELSEWHERE IN THE DRAWINGS. CONTROL JOINTS SHALL BE CONTINUOUS VERTICALLY, ENTIRE HEIGHT OF WALL. ALSO, PROVIDE CONTROL JOINTS AT ALL OF THE FOLLOWING LOCATIONS (REGARDLESS IF DETAILED ON THE DRAWINGS):

- AT ABRUPT CHANGES IN TOP OF WALL HEIGHT.
- AT CHANGES IN WALL THICKNESS, SUCH AS THOSE AT WALL CHASES AND THOSE ADJACENT TO COLUMNS OR PILASTERS. MAXIMUM SPACING OF CONTROL JOINTS SHALL BE 25'-0". IF ADDITIONAL CONTROL JOINTS IN MASONRY ARE REQUIRED TO COMPLY WITH THE MAXIMUM SPACING REQUIREMENT, PROVIDE ADDITIONAL CONTROL JOINTS LOCATED IN ACCORDANCE WITH THE FOLLOWING CRITERIA. COORDINATE WITH ARCHITECT FOR APPROVAL PRIOR TO INSTALLATION.
- ABOVE JOINTS IN FOUNDATIONS AND FLOORS.
- BELOW JOINTS IN ROOFS AND FLOORS THAT BEAR ON WALLS.
- AT A DISTANCE NOT TO EXCEED HALF THE ALLOWABLE JOINT SPACING FROM BONDED INTERSECTIONS OR CORNERS.
- AT EDGE OF DOOR OPENINGS.


Masonry Veneer Expansion Joints

VERTICAL EXPANSION JOINTS IN MASONRY VENEER EXTERIOR WALLS ARE INSTALLED AS A METHOD OF RELIEVING STRESSES IN THE BRICK THAT OCCUR BECAUSE OF THERMAL EXPANSION AND CONTRACTION. CRITERIA FOR LOCATING THESE TYPES OF JOINTS IN MASONRY VENEER WALLS IS SIMILAR TO THAT FOR LOCATING CONTROL JOINTS IN CONCRETE BLOCK WALLS. THE LOCATION OF MASONRY VENEER EXPANSION JOINTS HAS BEEN DETERMINED, AND IS INDICATED ON EXTERIOR BUILDING ELEVATIONS WITH THE DESIGNATION "MJ". THE MAXIMUM SPACING OF MJs IS 30'-0".

Masonry Ties

USE THE FOLLOWING GUIDE FOR THE USE OF TIES BETWEEN THE VARIOUS COMPONENTS THAT COMPRISE, OR OCCUR IN, MASONRY WALLS.

- IN CAVITY WALLS BETWEEN THE EXTERIOR WYTHE AND CONCRETE BLOCK OR METAL STUD BACK-UP. FOLLOW CRITERIA SPECIFIED IN THE SPECIFICATIONS FOR TYPES AND SPACING OF TIES. TIES MUST ALLOW FOR DIFFERENTIAL HORIZONTAL AND VERTICAL MOVEMENT BETWEEN WYTHES WHILE TRANSFERRING LOADS BETWEEN THEM.
- IN CAVITY WALLS BETWEEN EXTERIOR WYTHE AND STEEL BEAMS AND COLUMNS LOCATED IN THE PLANE OF THE BACKUP. TIES ARE REQUIRED IF SPACING OF TIES FALLS ON BEAMS OR COLUMNS. TIES MUST ALLOW THE SAME MOVEMENT AND LOAD TRANSFER CRITERIA THAT IS REQUIRED BETWEEN EXTERIOR WYTHE AND BACKUP. SEE SPECIFICATIONS FOR DESCRIPTION.
- IN CAVITY WALLS BETWEEN EXTERIOR WYTHE AND CONCRETE WALL BACKUP OR CONCRETE COLUMNS. TIES ARE REQUIRED AT REGULAR SPACING. ANCHOR TIES TO THE CONCRETE USING DOVETAILS. SEE SPECIFICATIONS. TIES MUST ALLOW THE SAME MOVEMENT AND LOAD TRANSFER CRITERIA THAT IS REQUIRED BETWEEN EXTERIOR WYTHE AND BACKUP NOTED IN "MASONRY TIES" NOTE "A" ABOVE.
- IN CAVITY WALL BETWEEN CONCRETE BLOCK BACKUP AND STEEL BEAMS AND COLUMNS.
 - VERTICALLY SPANNING WALLS: WIND CLIPS ARE REQUIRED TO SUPPORT THE WALL LATERALLY. FASTEN TO BEAM AT TOP OF WALL.
 - HORIZONTALLY SPANNING WALLS: THE COLUMNS ARE REQUIRED TO PROVIDE THE LATERAL SUPPORT. THE COLUMN-WALL DETAILS ARE INDICATED ON THE DRAWINGS. COORDINATE WITH STRUCTURAL.
- TIES FROM THE WALL TO BEAMS AND COLUMNS ARE NOT REQUIRED.
- BETWEEN INTERIOR BLOCK WALLS AND STEEL BEAMS AND COLUMNS. TIES ARE REQUIRED 16" ON-CENTER VERTICALLY. TIES SHALL ALLOW DIFFERENTIAL MOVEMENT BETWEEN WALL AND STEEL MEMBERS PARALLEL TO THE WALL WHILE PROVIDING LATERAL SUPPORT FOR THE WALL. SEE SPECIFICATIONS FOR TIE DESCRIPTION.

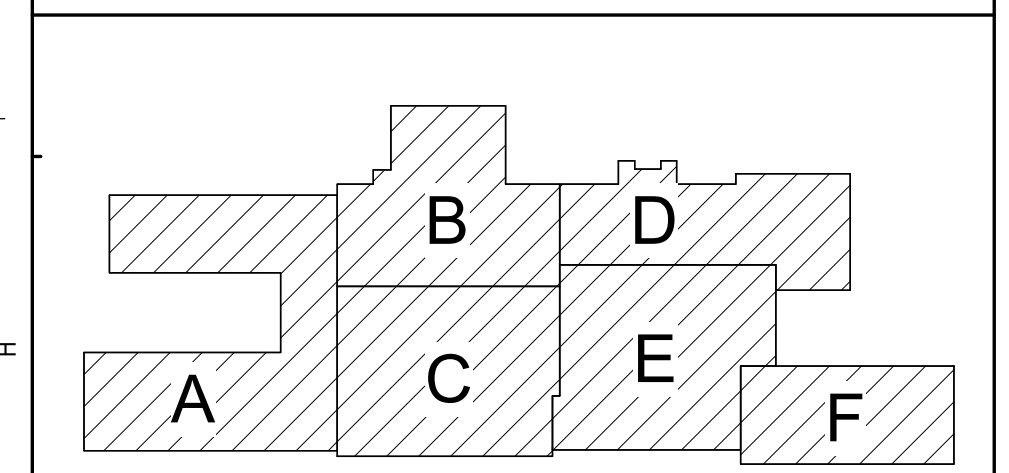

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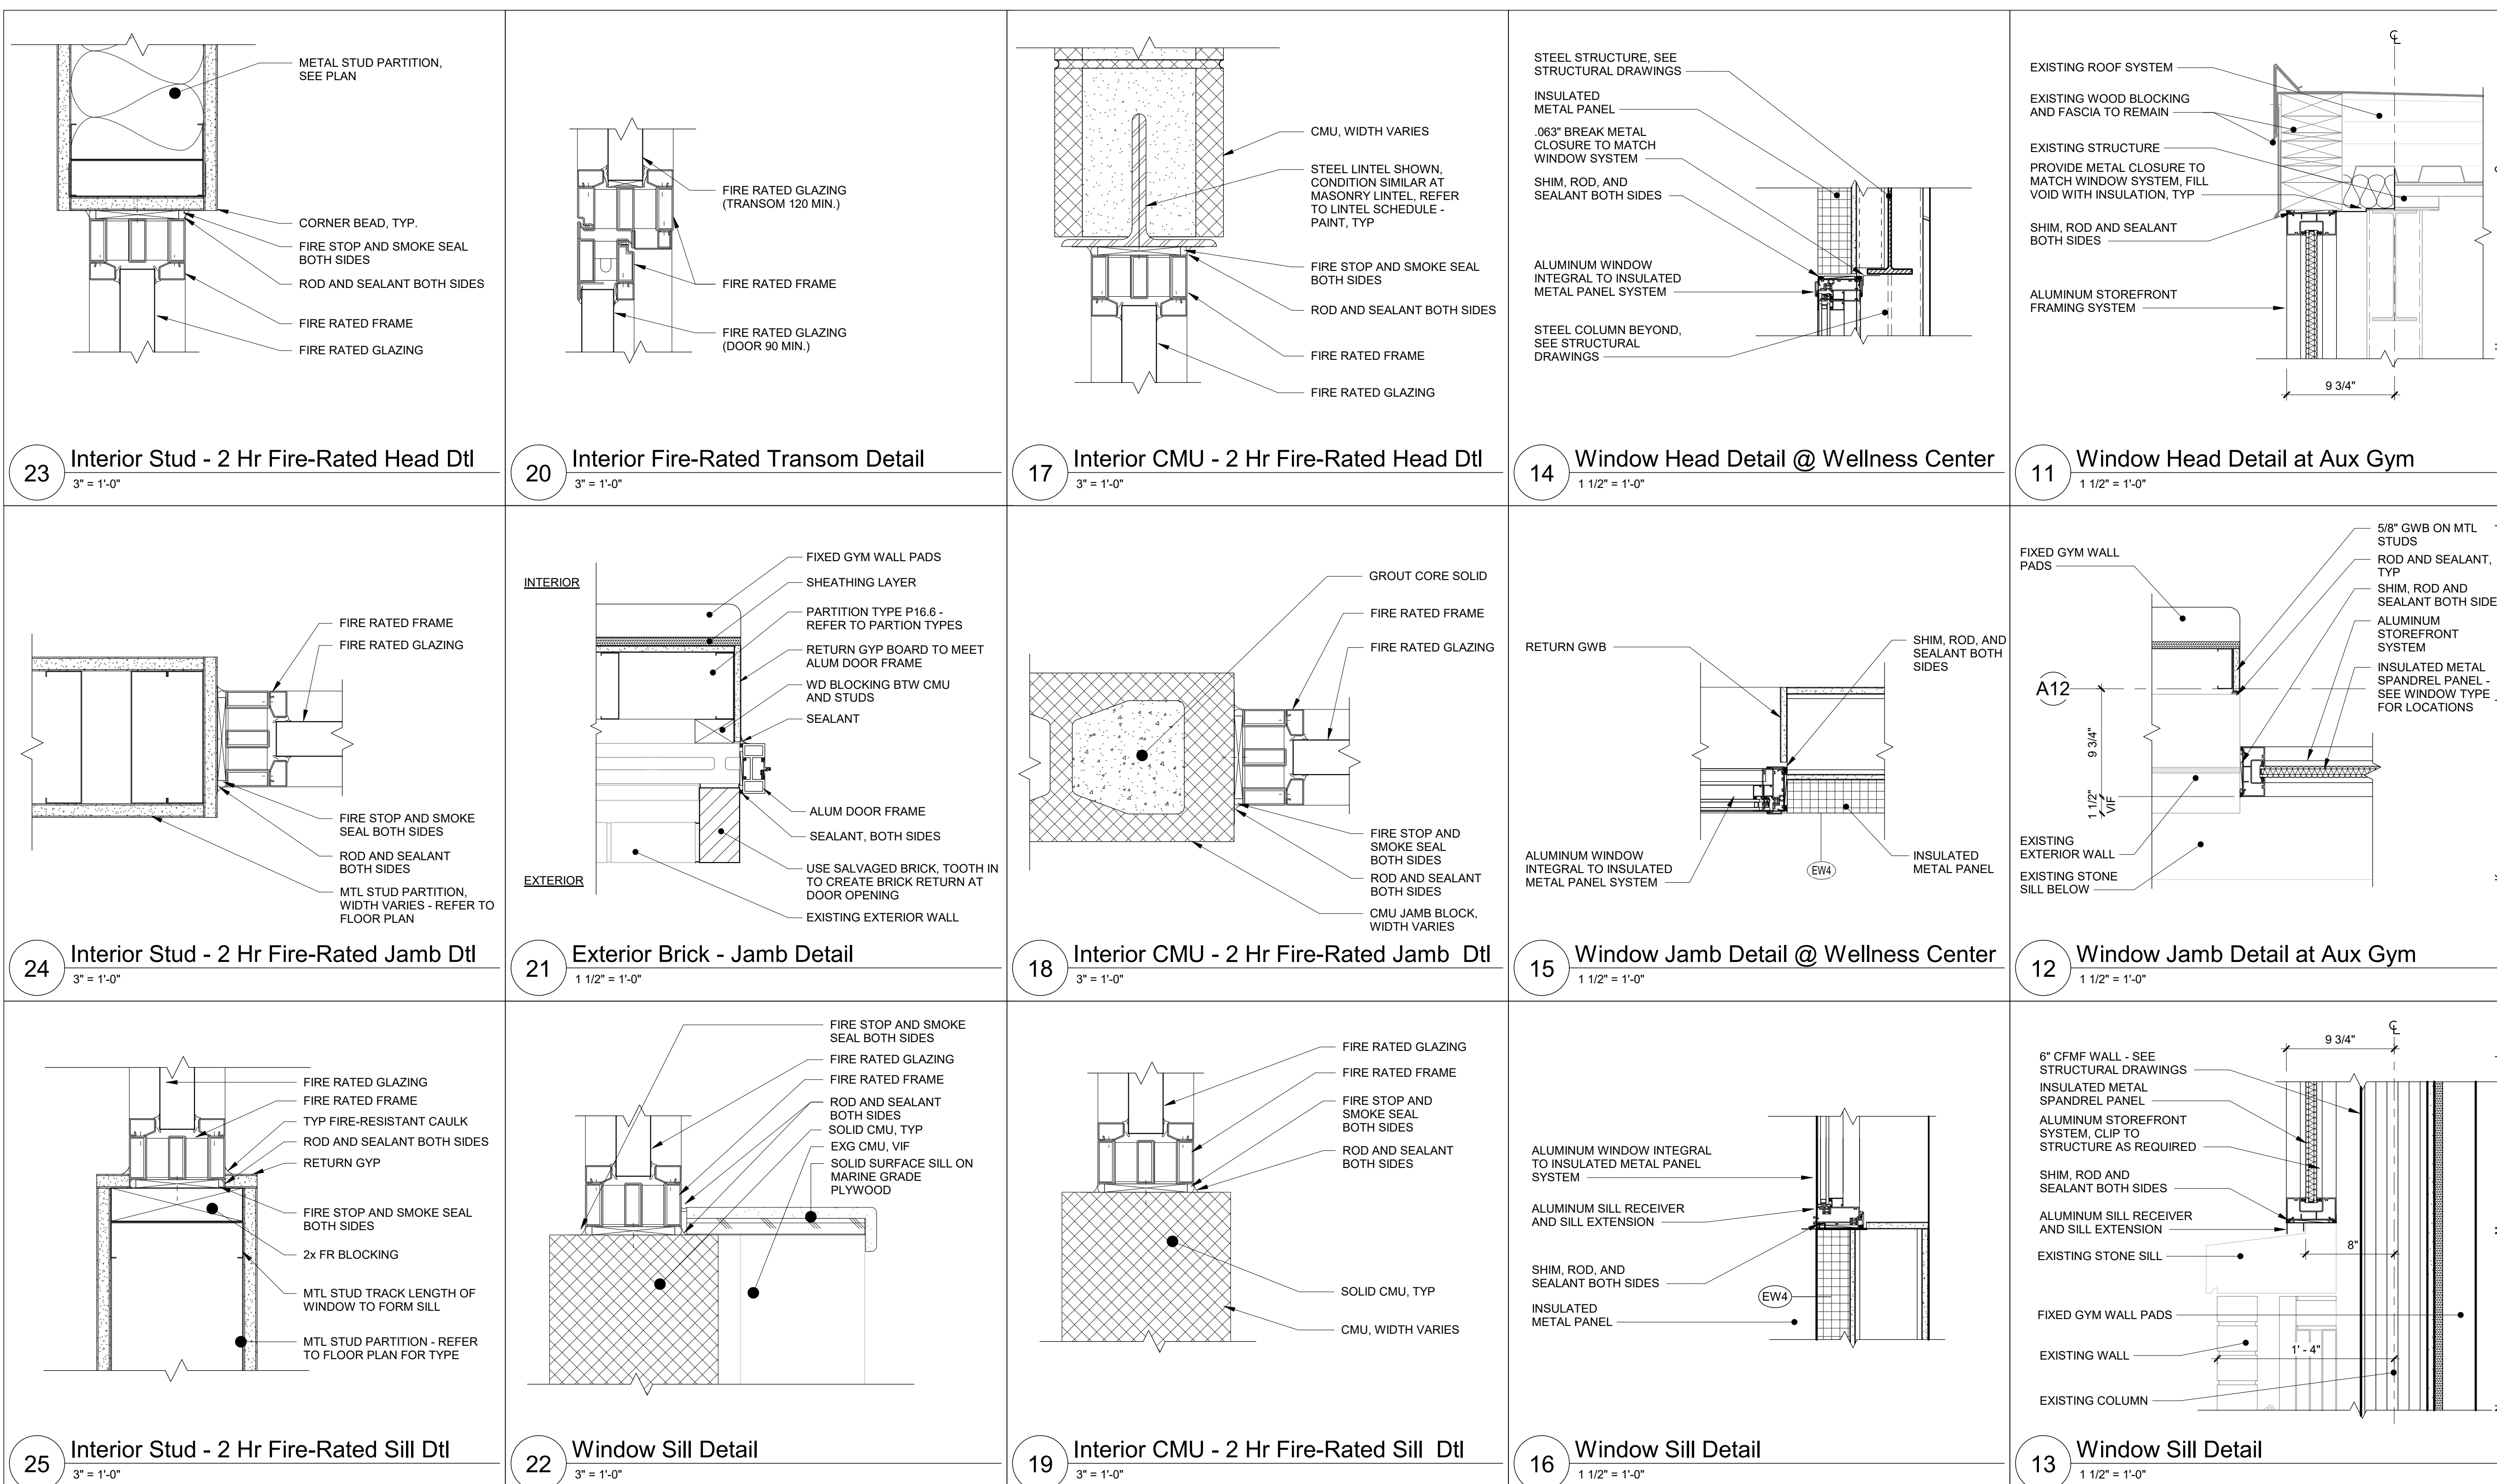
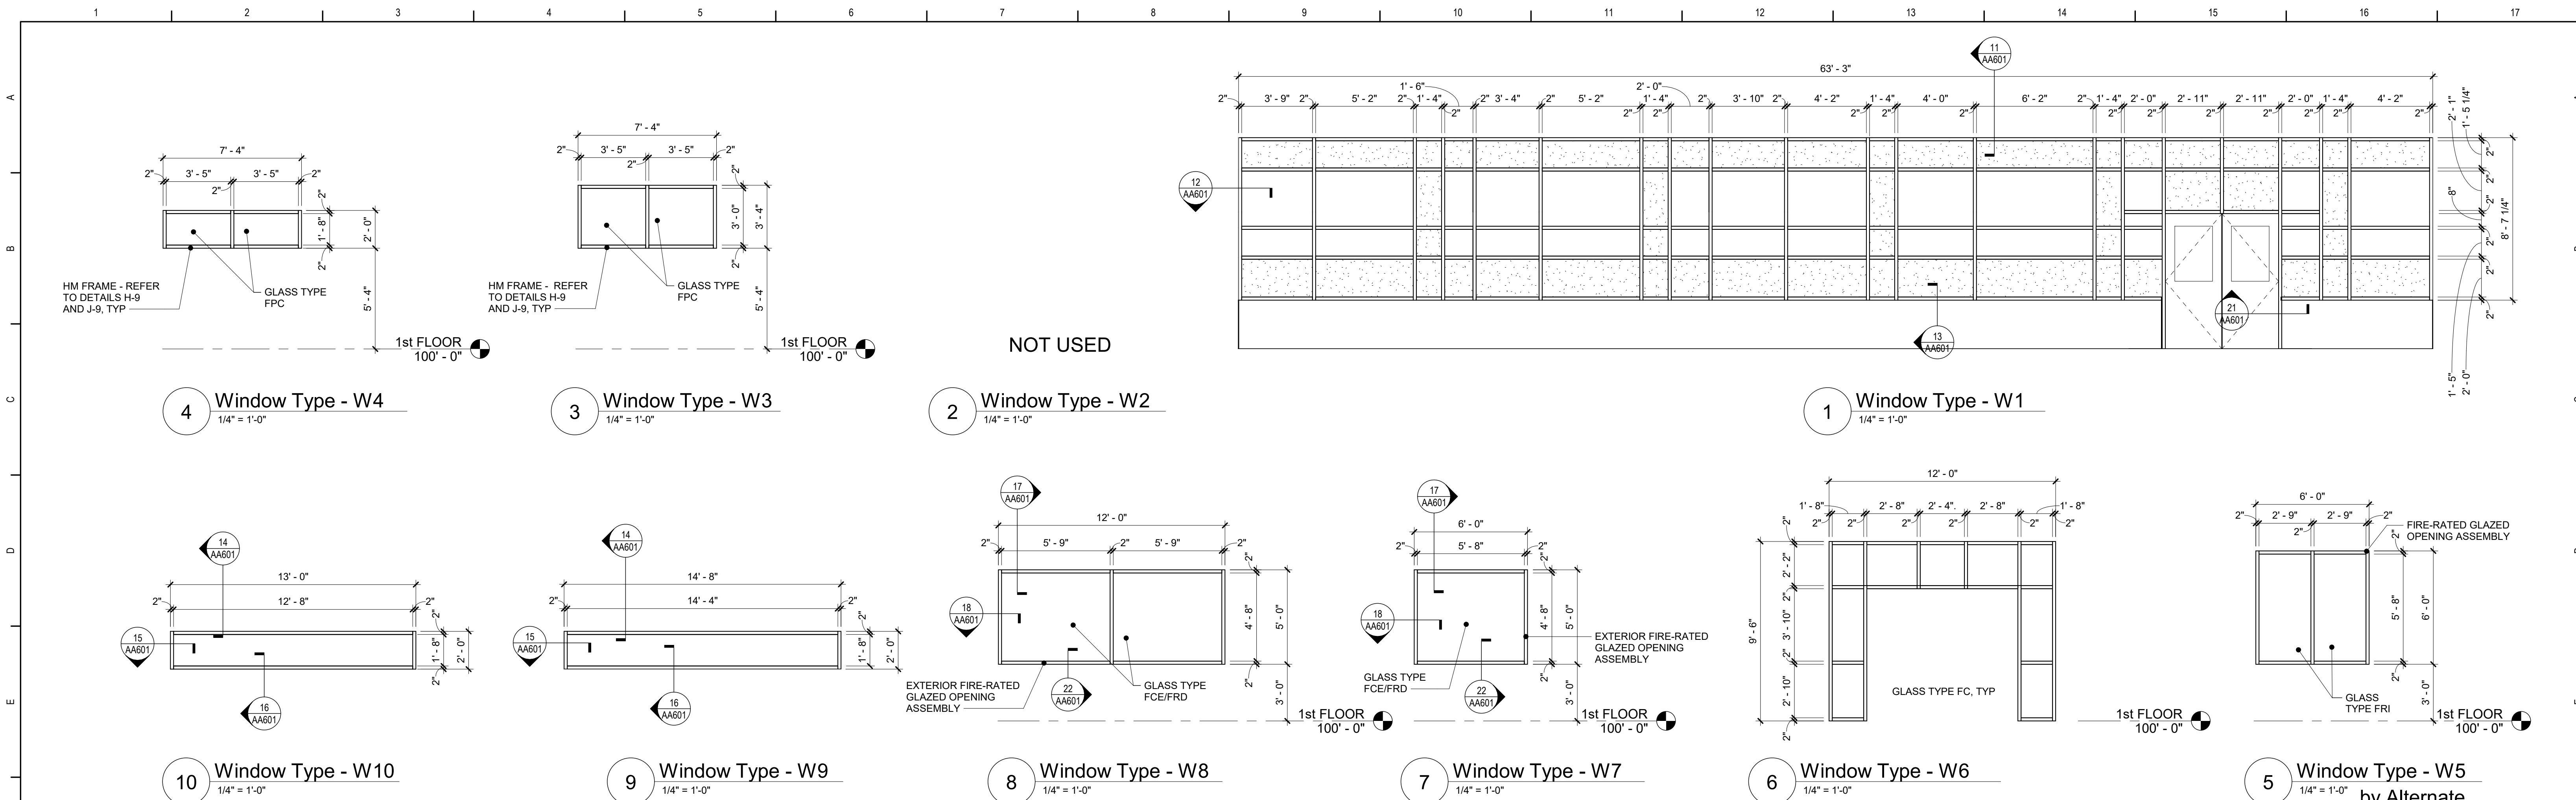
Waverly Central School District
Waverly, NY

Additions and Alterations to:
Waverly Jr. Sr. High School

Typical Masonry Plan Details, CFMF
Details and Notes

Drawn By: KCB	Date: 05/19/2023	Drawing Number:
Project No.: 339070-22003	AA505	

DOOR SCHEDULE LEGEND



General Window Notes

- INSULATING GLASS UNITS SHALL BE TYPE FCE/HCL, TYP UNO.
- PROVIDE ALL ALUMINUM FLASHINGS, RECEIVERS, TRIM AND SILLS REQUIRED FOR A COMPLETE AND FINISHED INSTALLATION REGARDLESS OF IF SHOWN ON DRAWINGS.
- REFER TO WINDOW TREATMENTS AS SHOWN ON DRAWINGS.
- GLAZING SYSTEMS FRAME TYPE KEY:
 - F HOLLOW METAL OR FIRE-RATED GLAZED OPENING ASSEMBLY
 - W ALUMINUM, HOLLOW METAL OR FIRE-RATED GLAZED OPENING ASSEMBLY FRAME TYPES - REFER TO DETAILS
- PROVIDE INTERNAL STEEL REINFORCEMENT TO WINDOW AND STOREFRONT SYSTEMS AS REQUIRED TO COMPLY WITH WIND LOADING OR OTHER DESIGN CRITERIA, OR AS RECOMMENDED BY MANUFACTURER.
- ALUMINUM FRAME EXTRUSIONS ARE INTENDED AS GENERIC GRAPHIC REPRESENTATIONS ONLY.
- FILL ALL VOIDS AT PERIMETER OF WINDOW, STOREFRONT OR CURTAIN WALL FRAMES WITH INSULATION, TYPICAL.

Window Legend

- GLASS TYPE
- INSULATED SPANDREL PANEL
- GLAZING LOUVER

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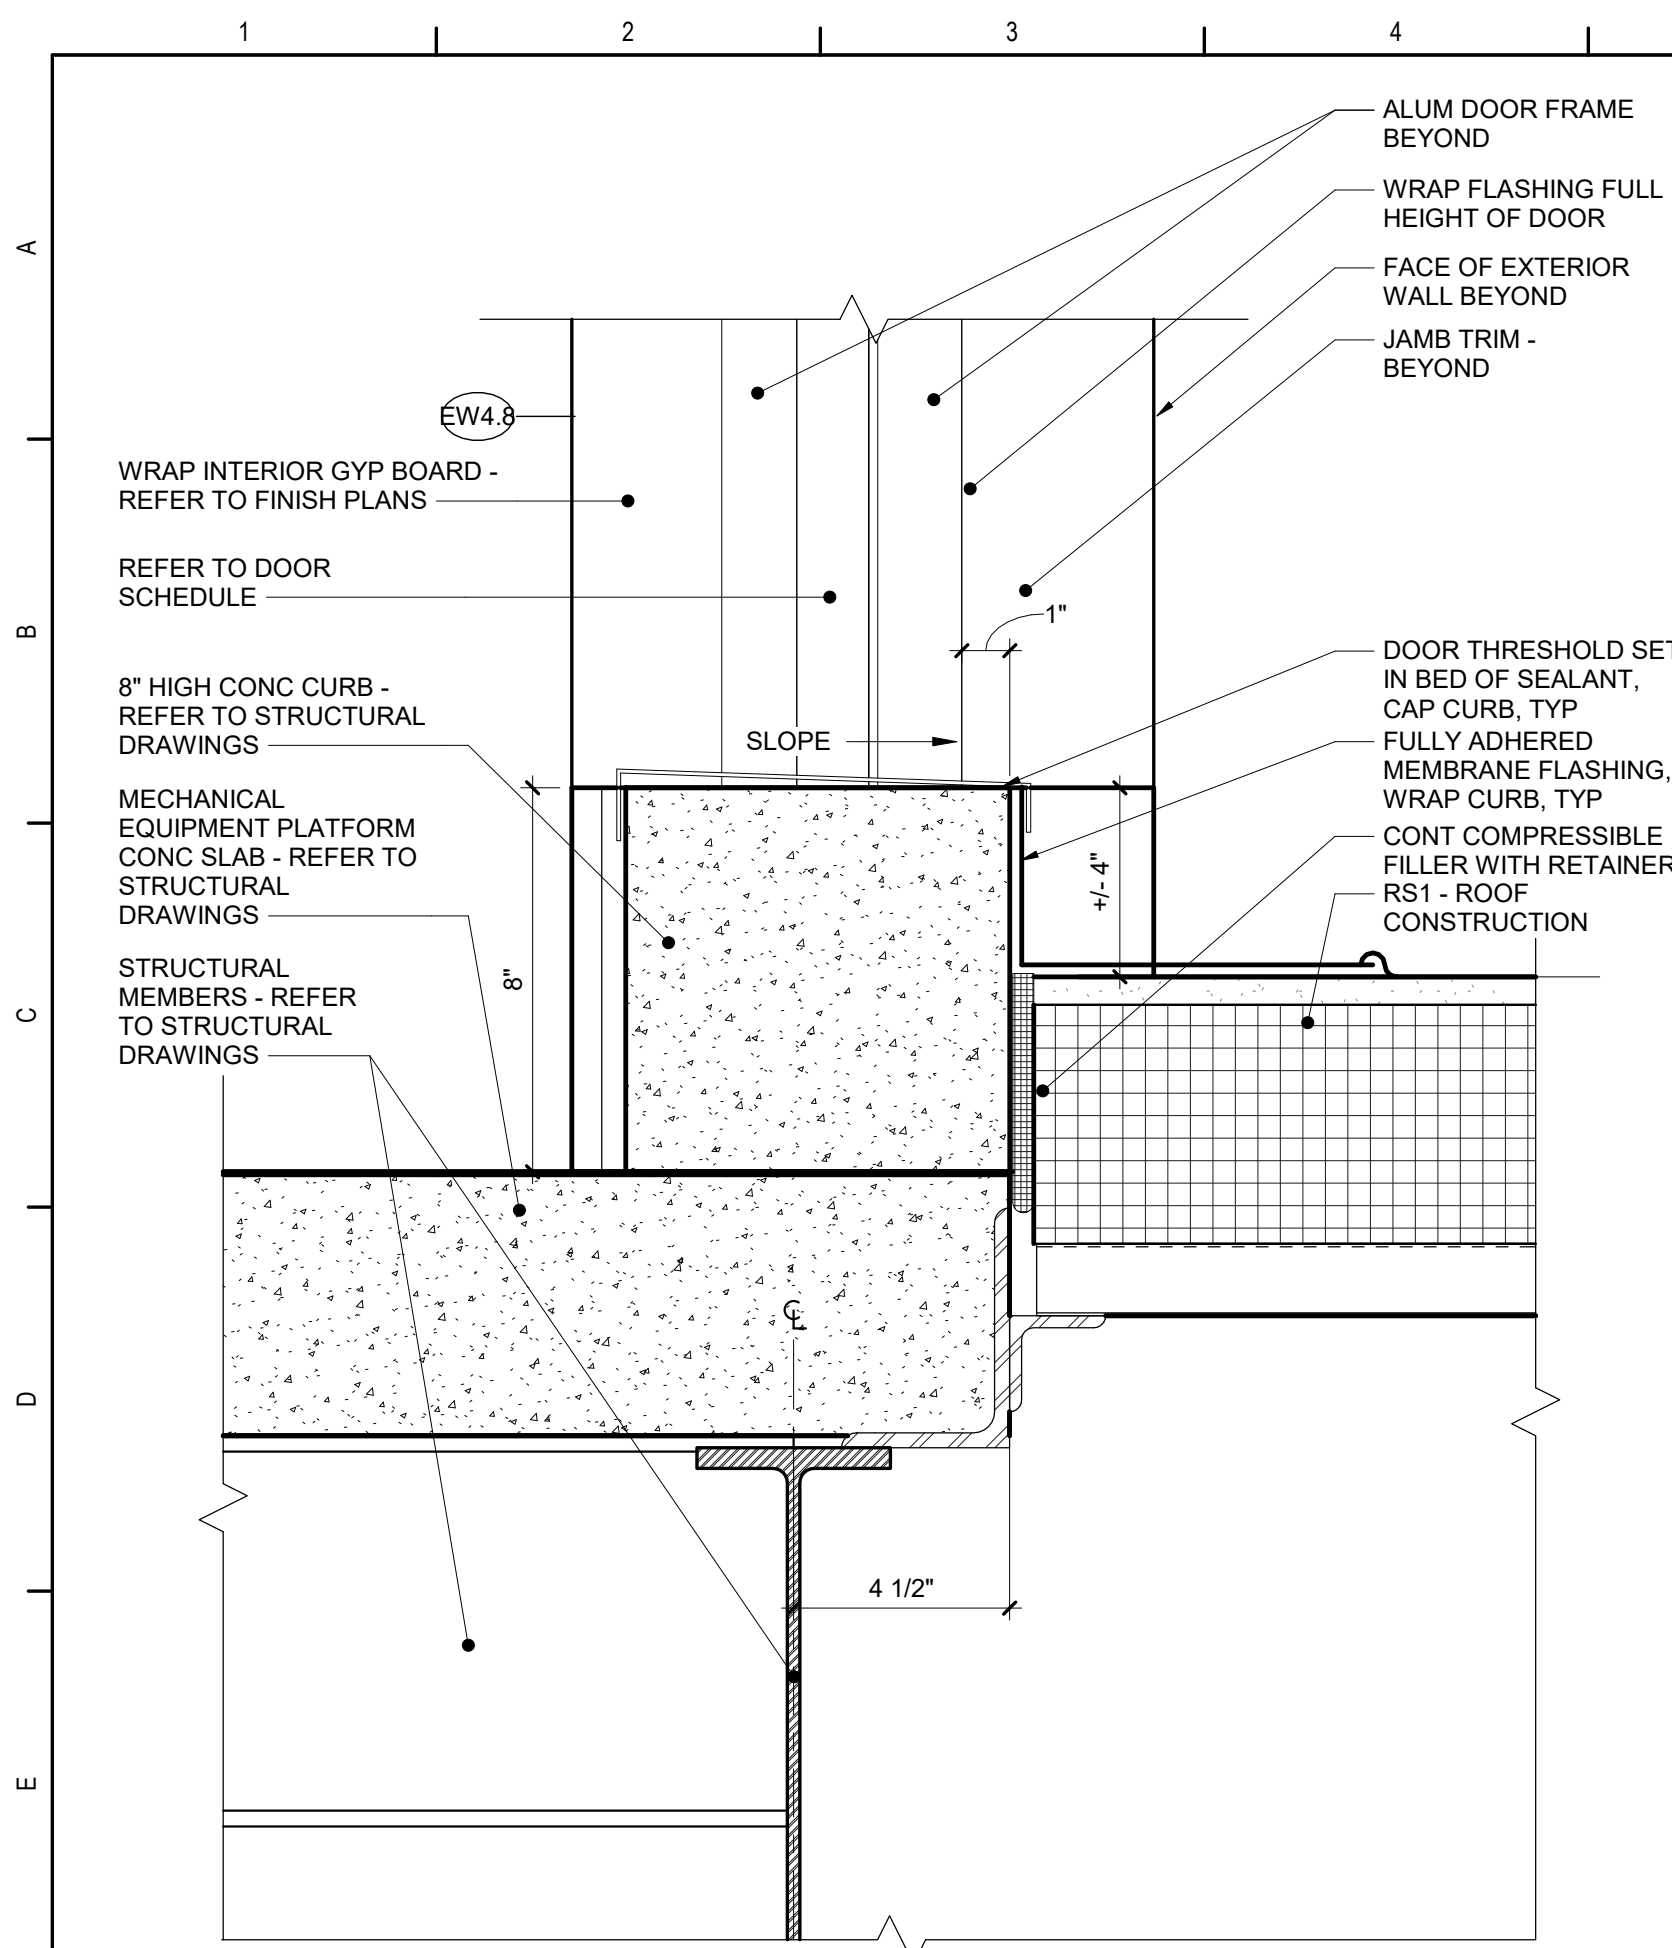
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Waverly Central School District
Waverly, NY



Additions and Alterations to:
Waverly Jr. Sr. High School

Window Types and Details


Drawn By: Author
Date: 05/19/2023
Project No.: 339070-22003
Drawing Number: AA601




13 Threshold at CFMF Exterior Wall
3" = 1'-0"

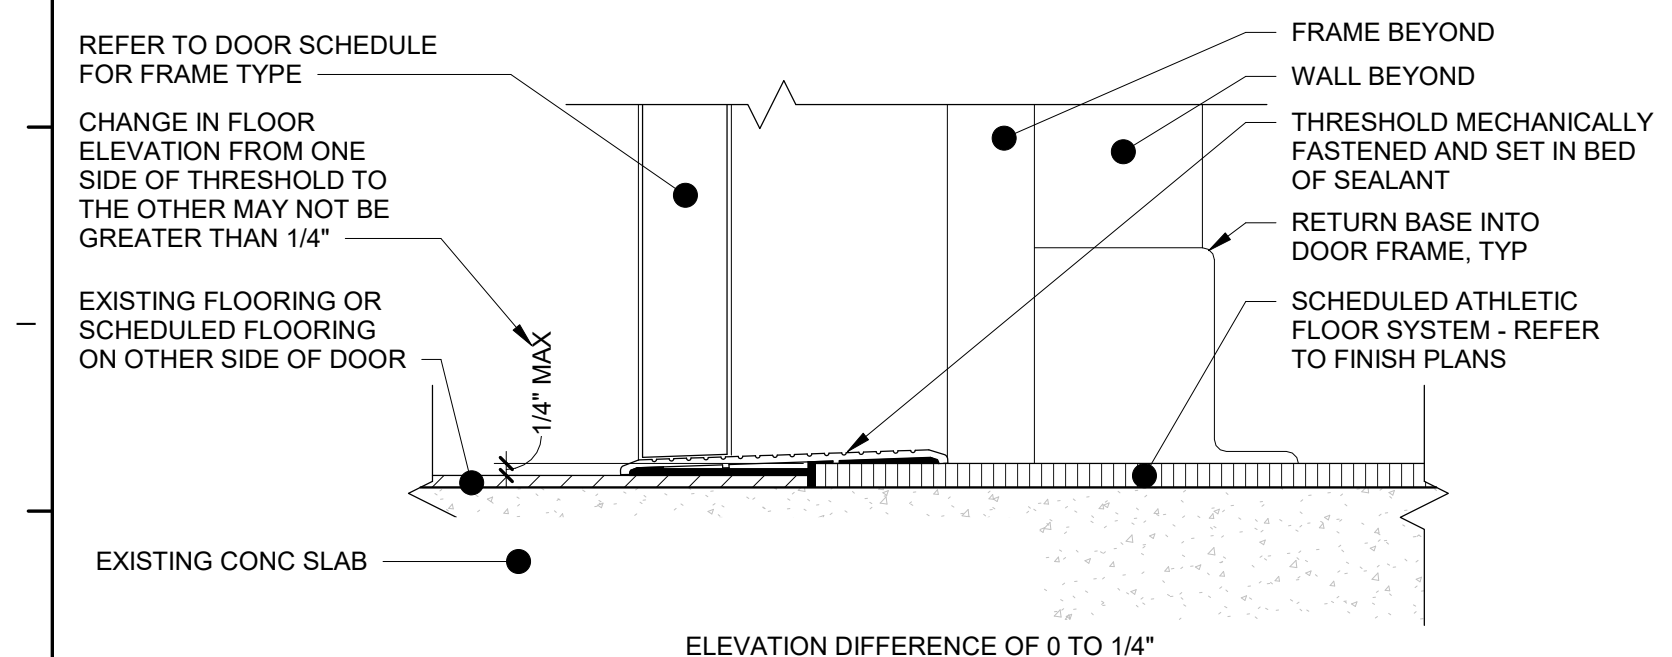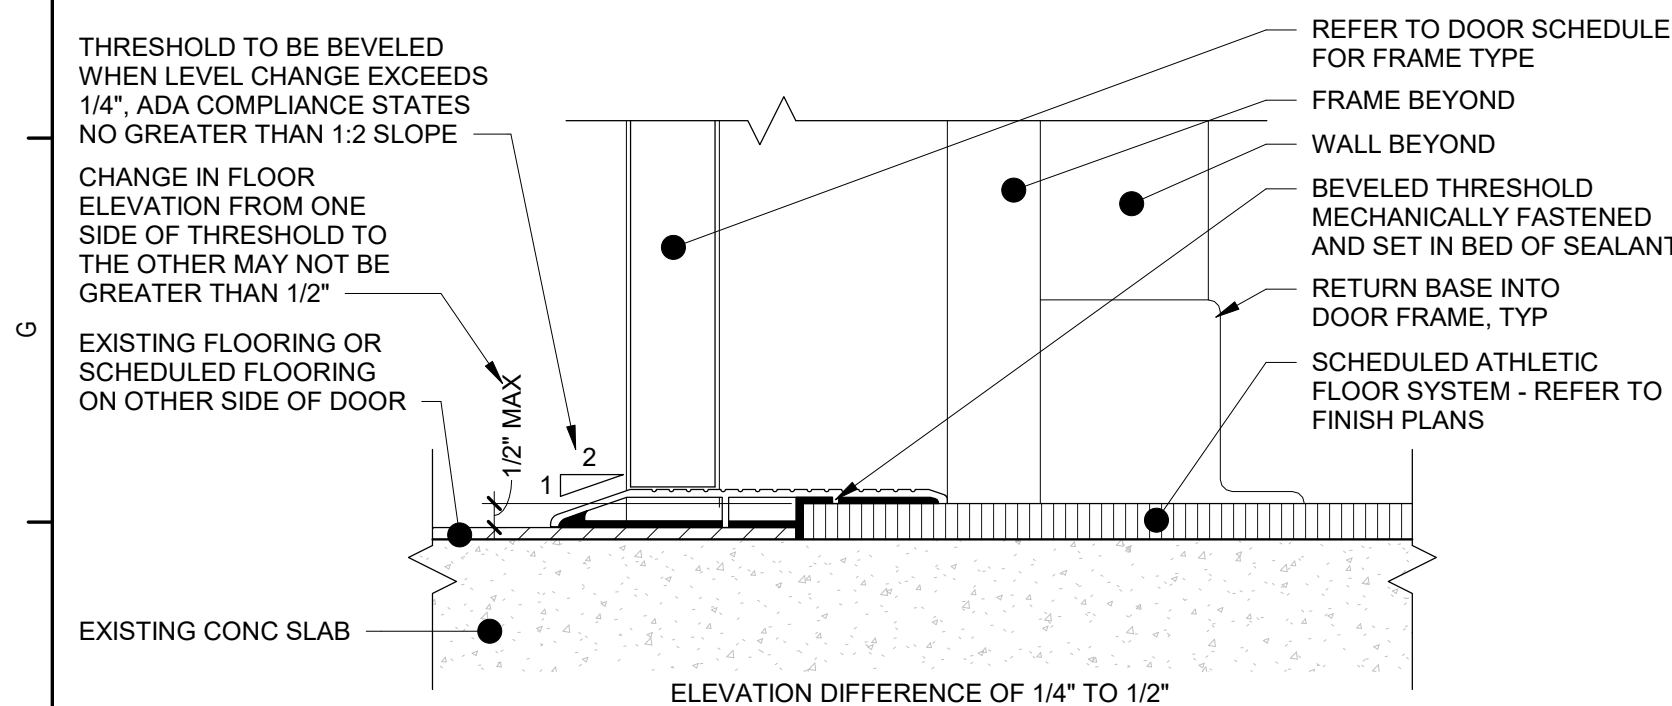


14 Interior Door Threshold At Level Change
3" = 1'-0"

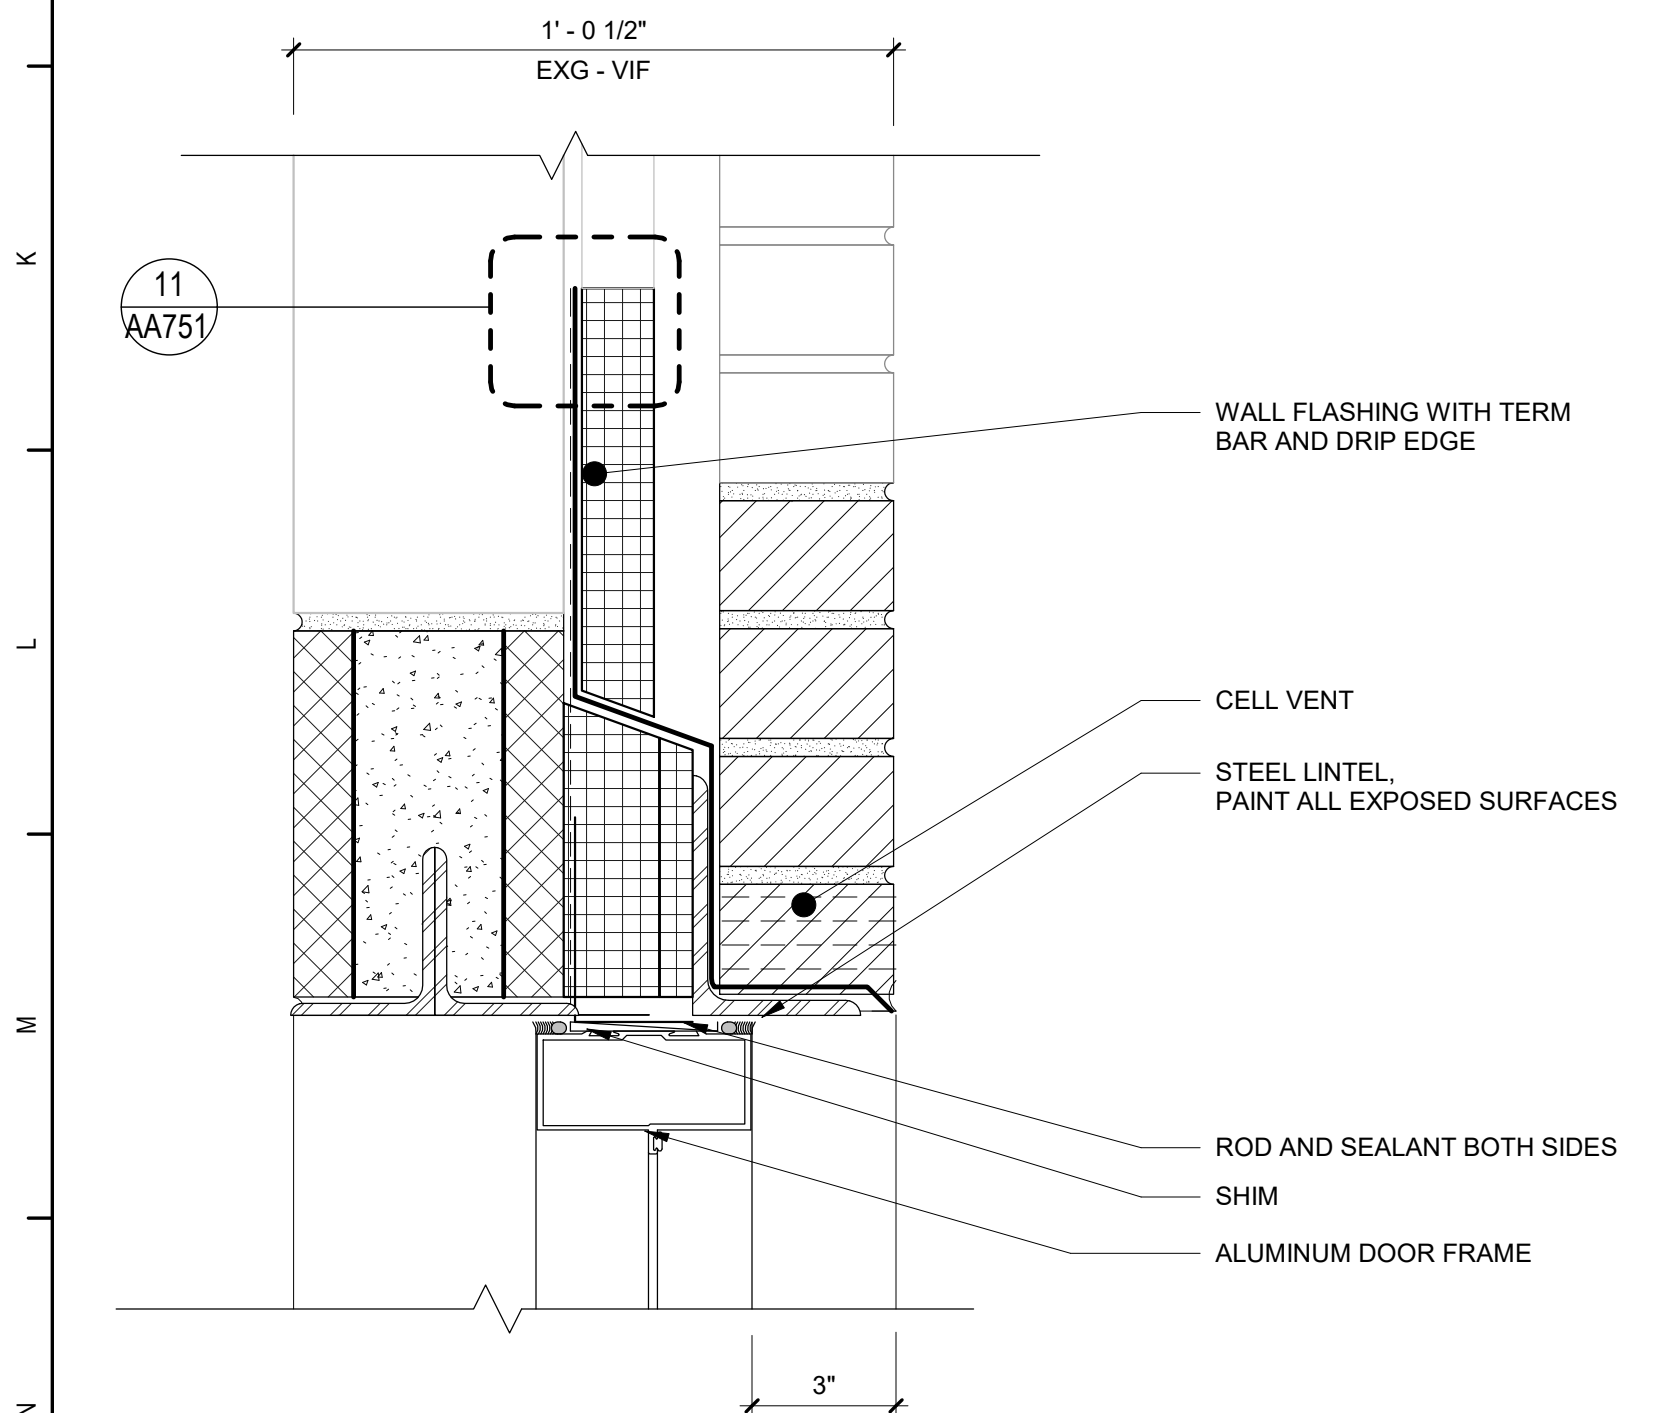


15 Door Head Detail
3" = 1'-0"

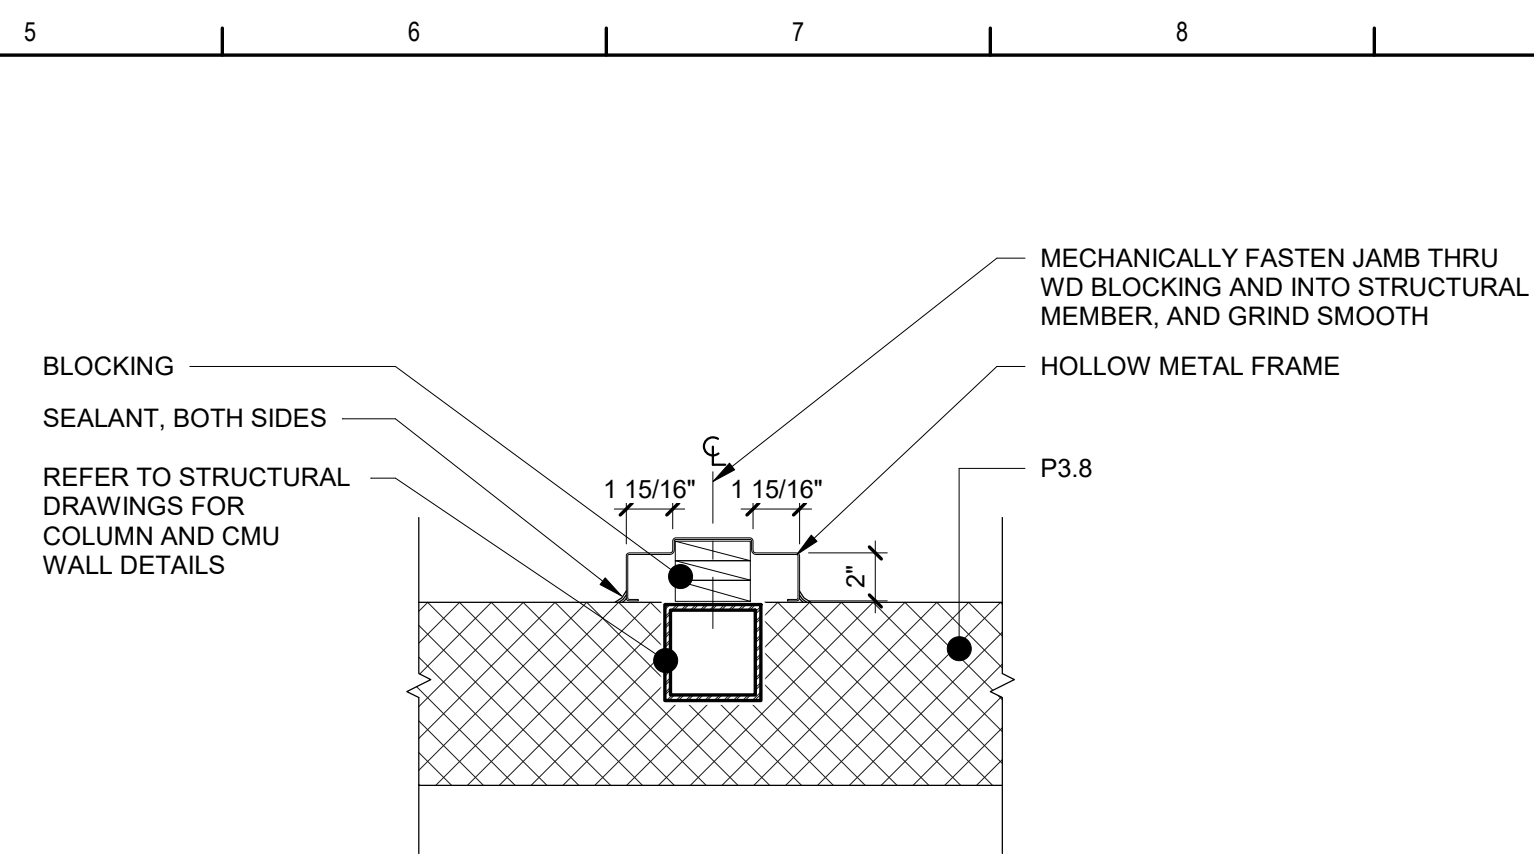


10 Jamb at New Column - P3.8
1 1/2" = 1'-0"

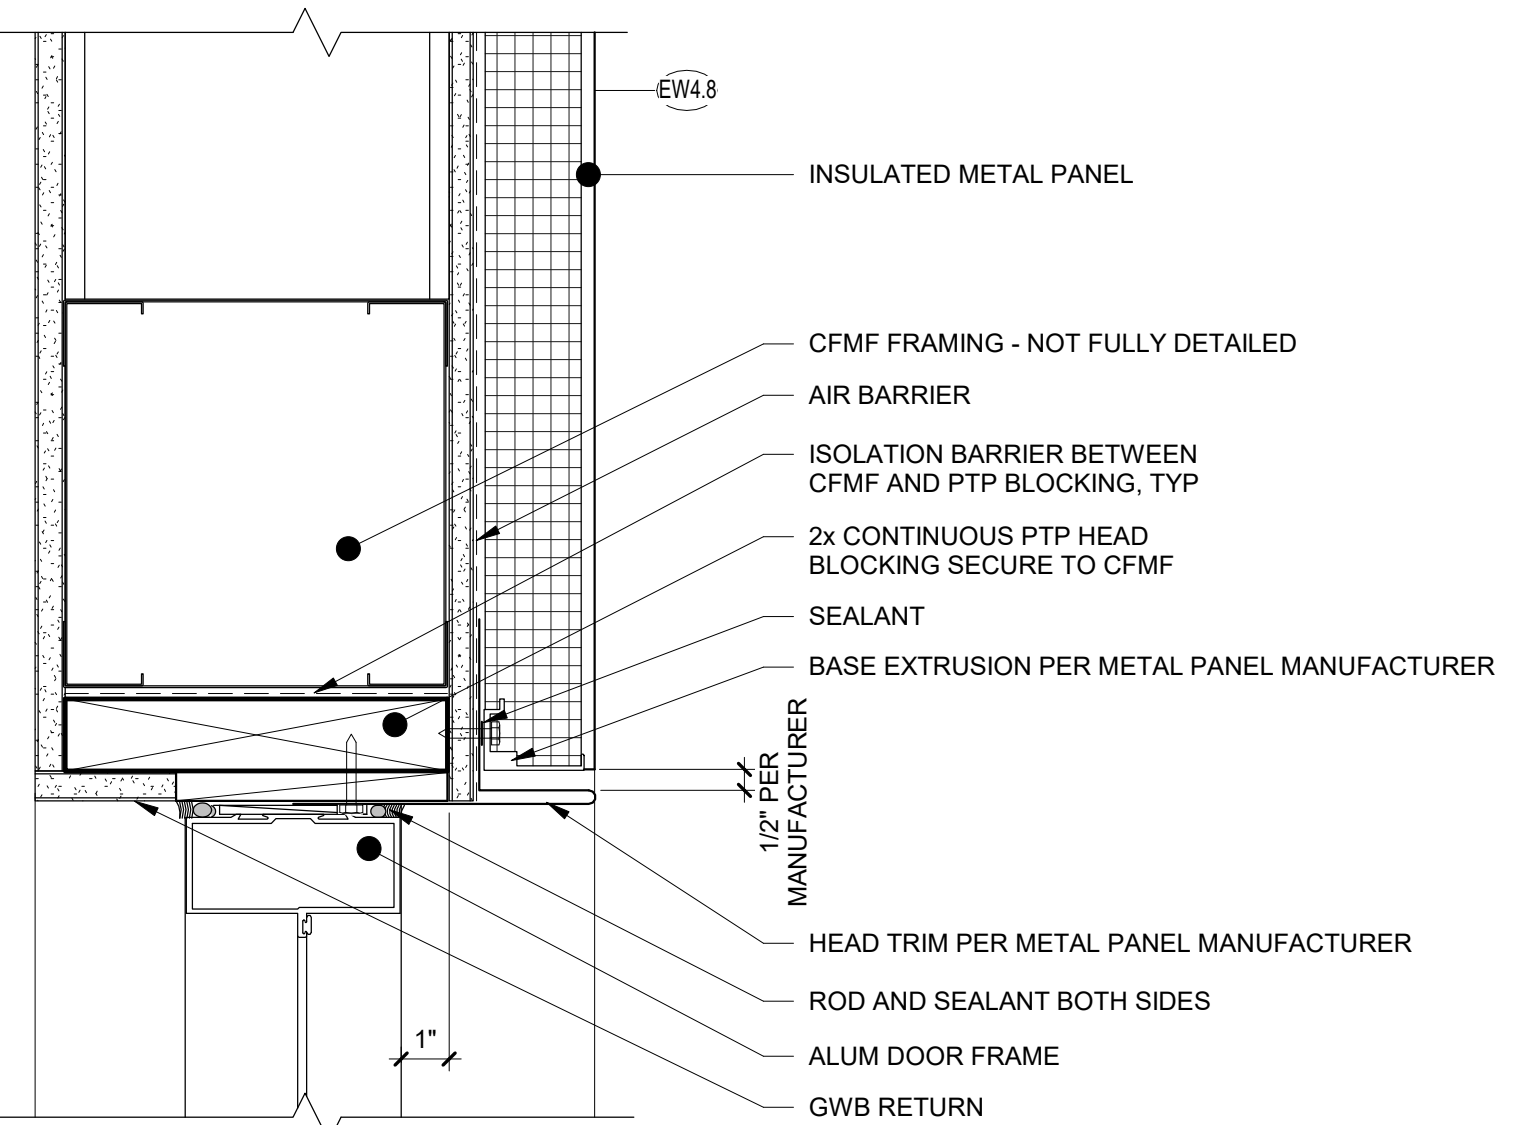


11 Head at CFMF Exterior Wall
3" = 1'-0"

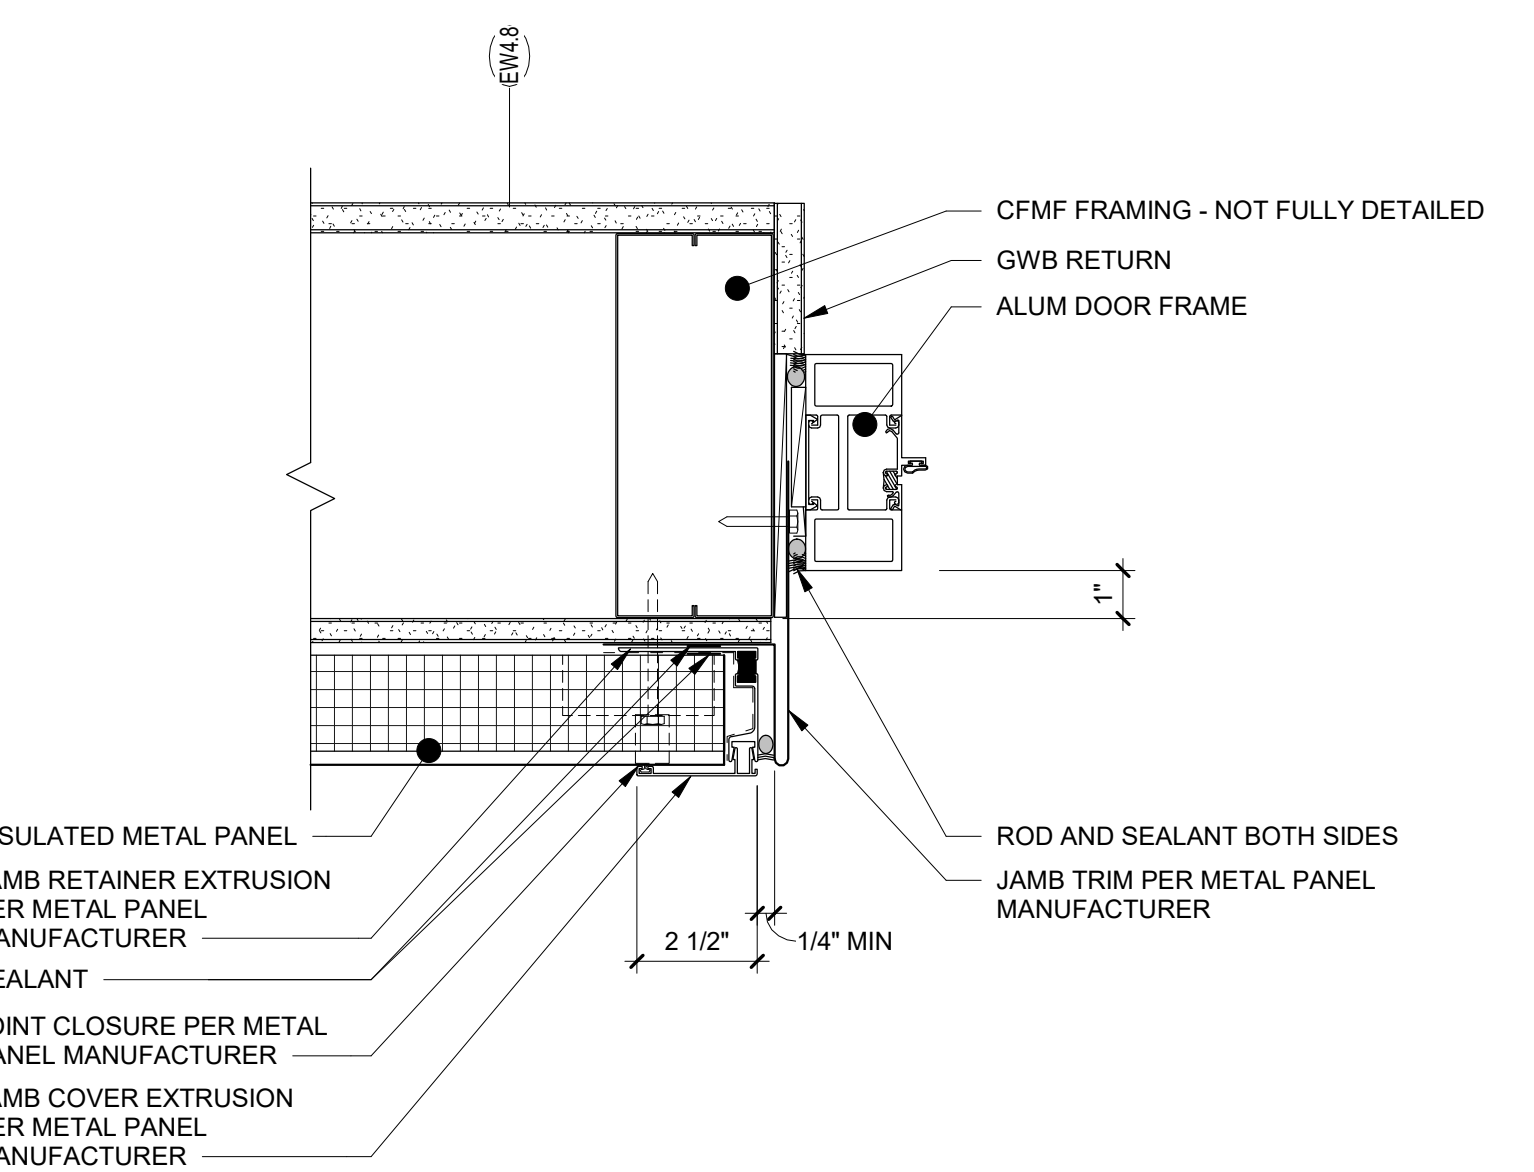


12 Jamb at CFMF Exterior Wall
3" = 1'-0"

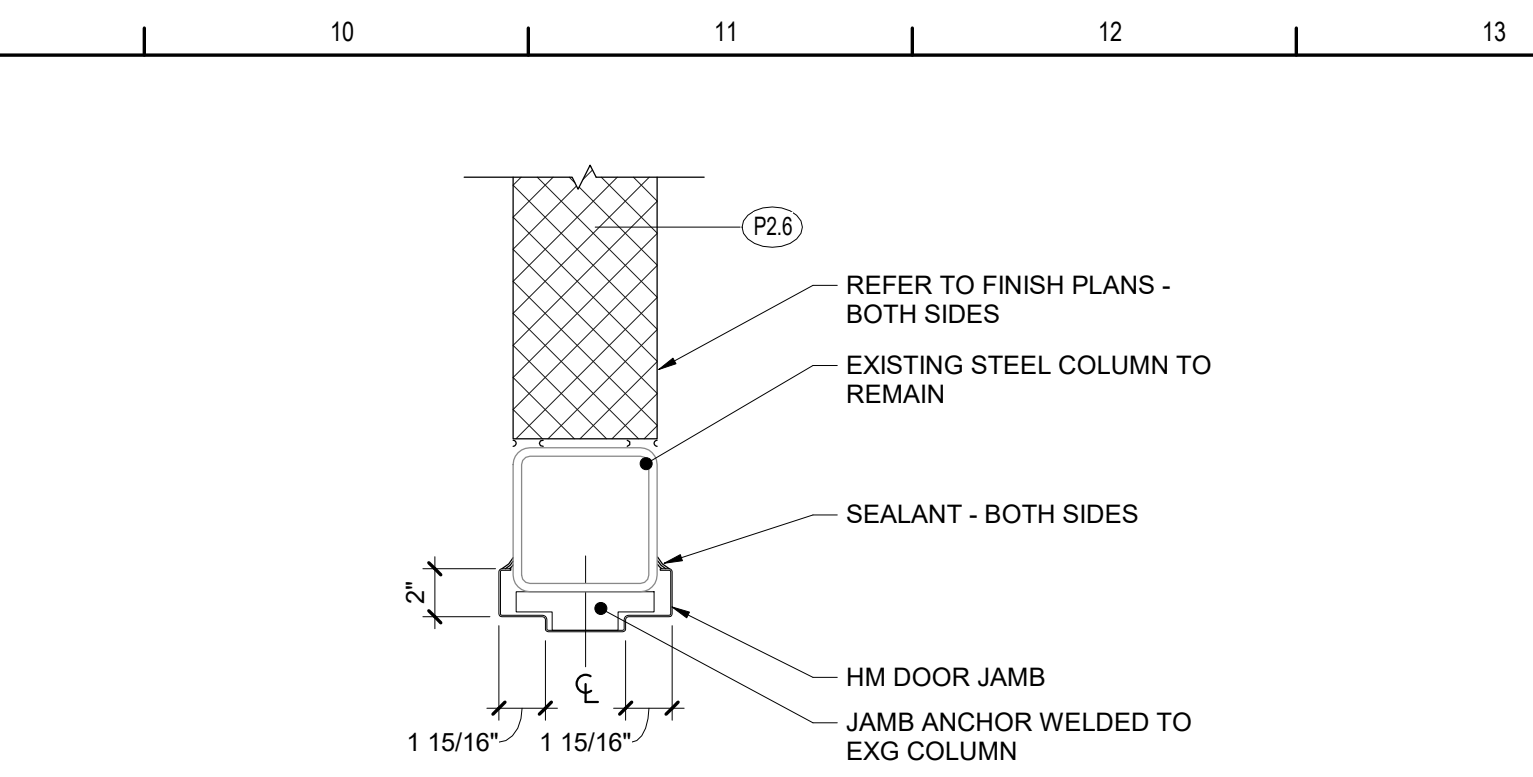


5 Jamb at Column Detail - P2.6
1 1/2" = 1'-0"

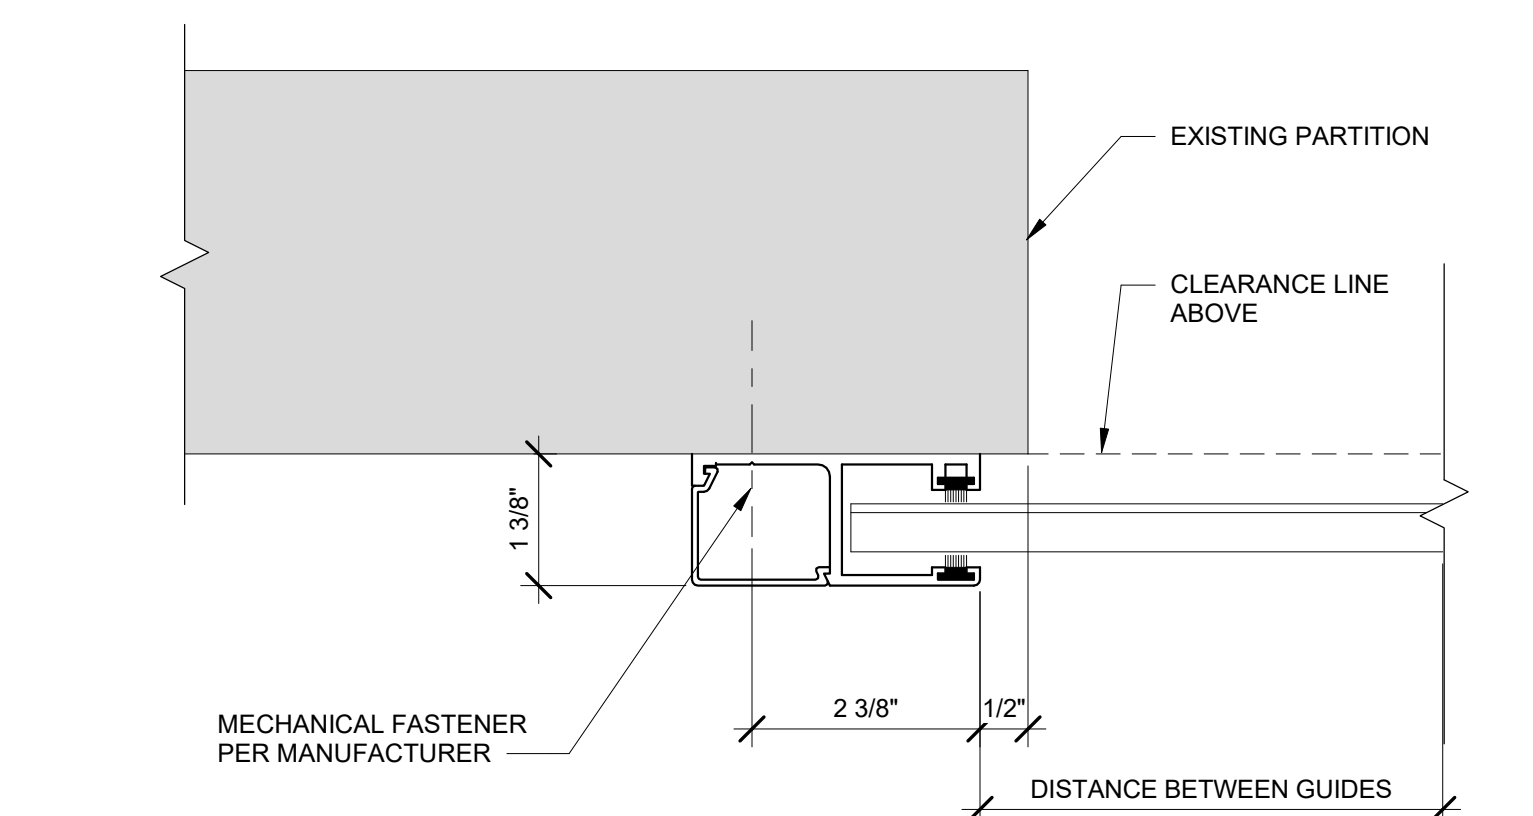


6 Coiling Door Jamb Exg Wall Detail
6" = 1'-0"

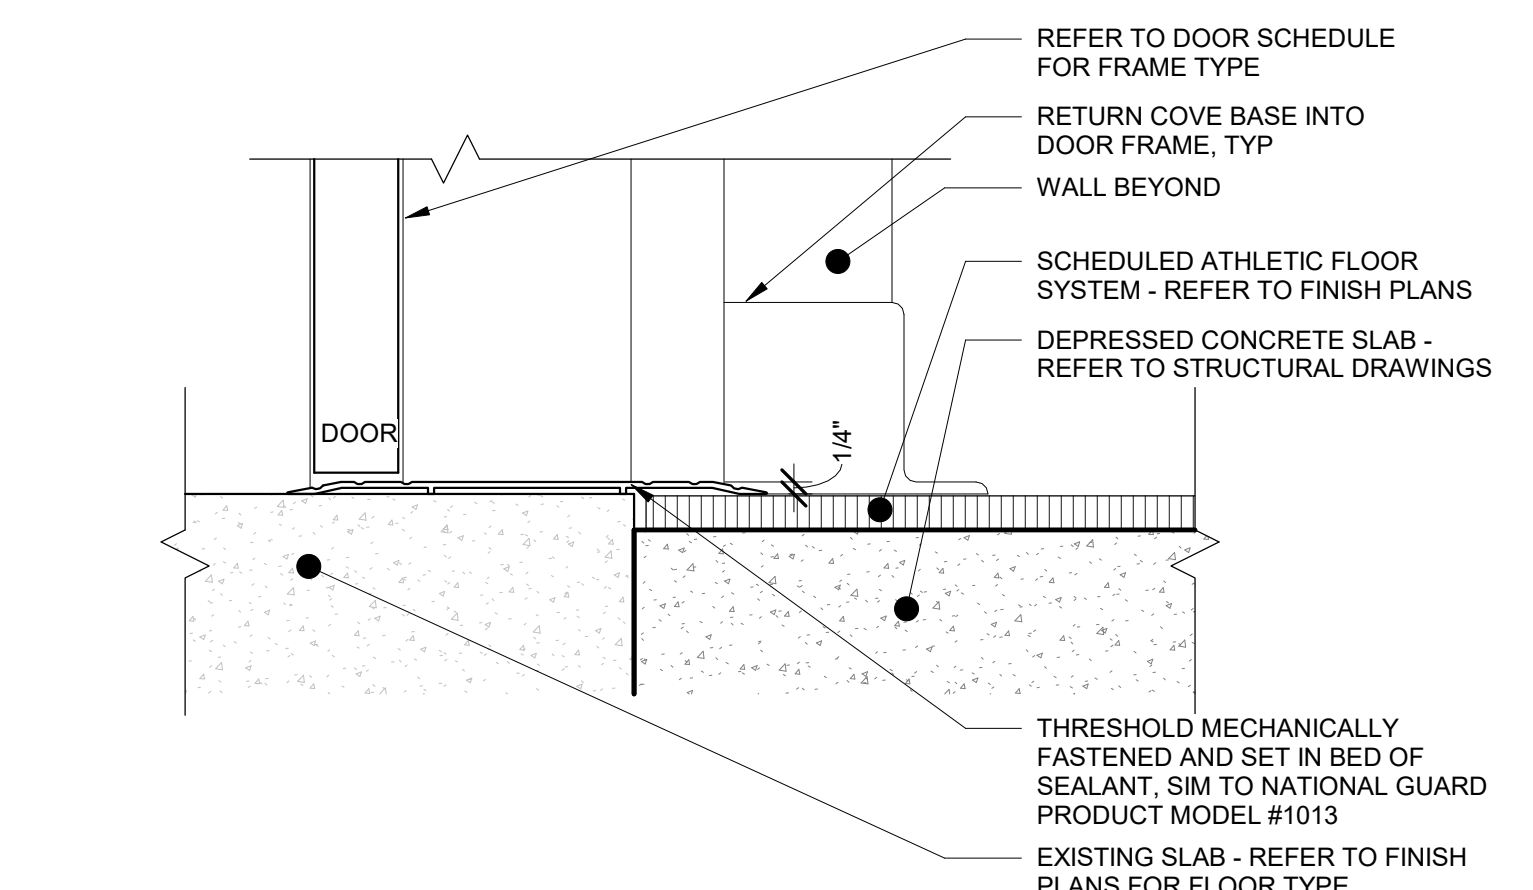


7 Interior Door Threshold At Athletic Floor
3" = 1'-0"

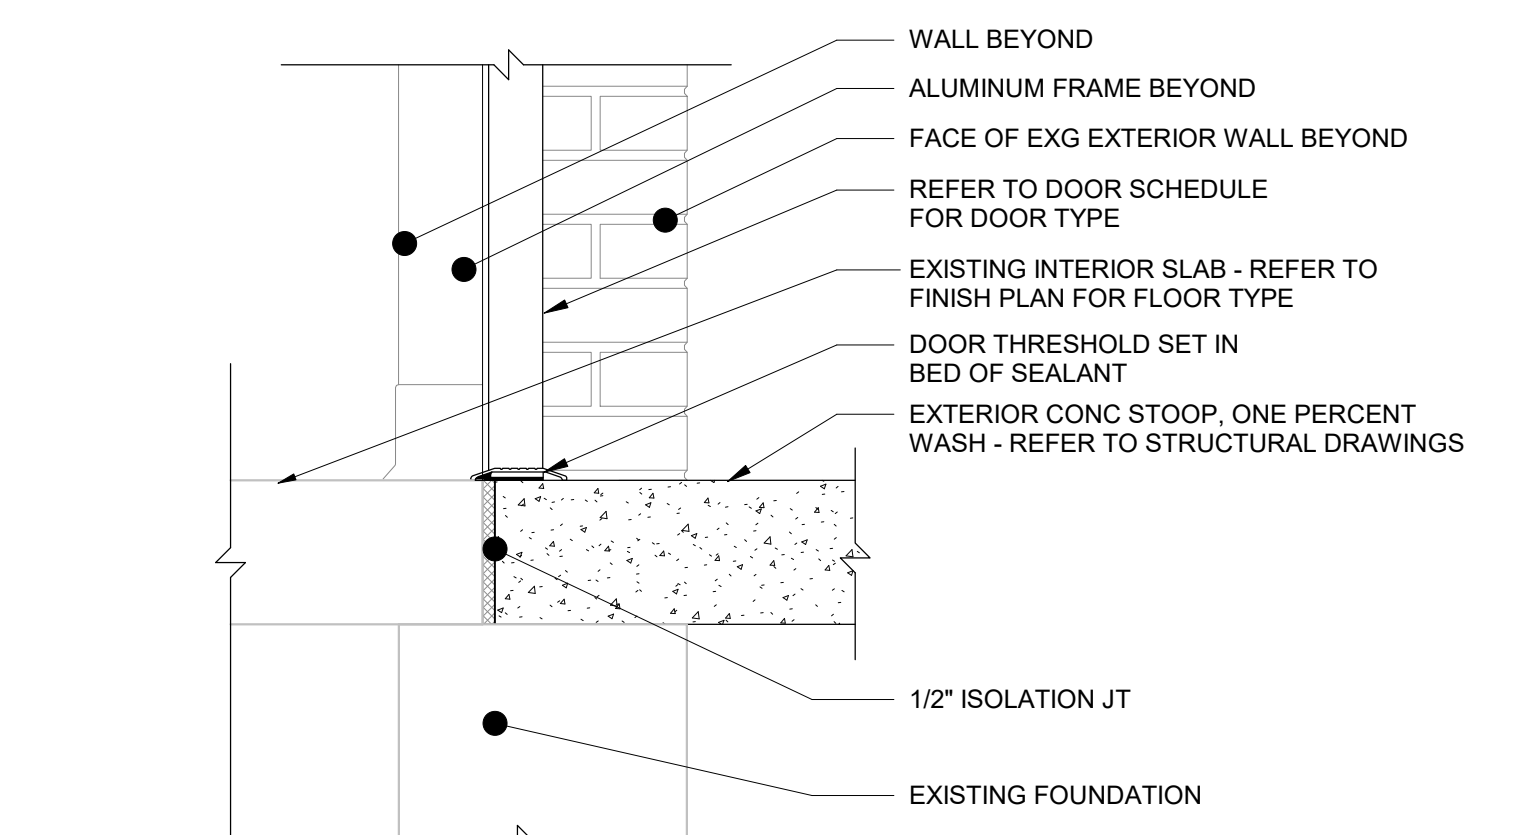


8 Threshold Detail at Exterior
1 1/2" = 1'-0"

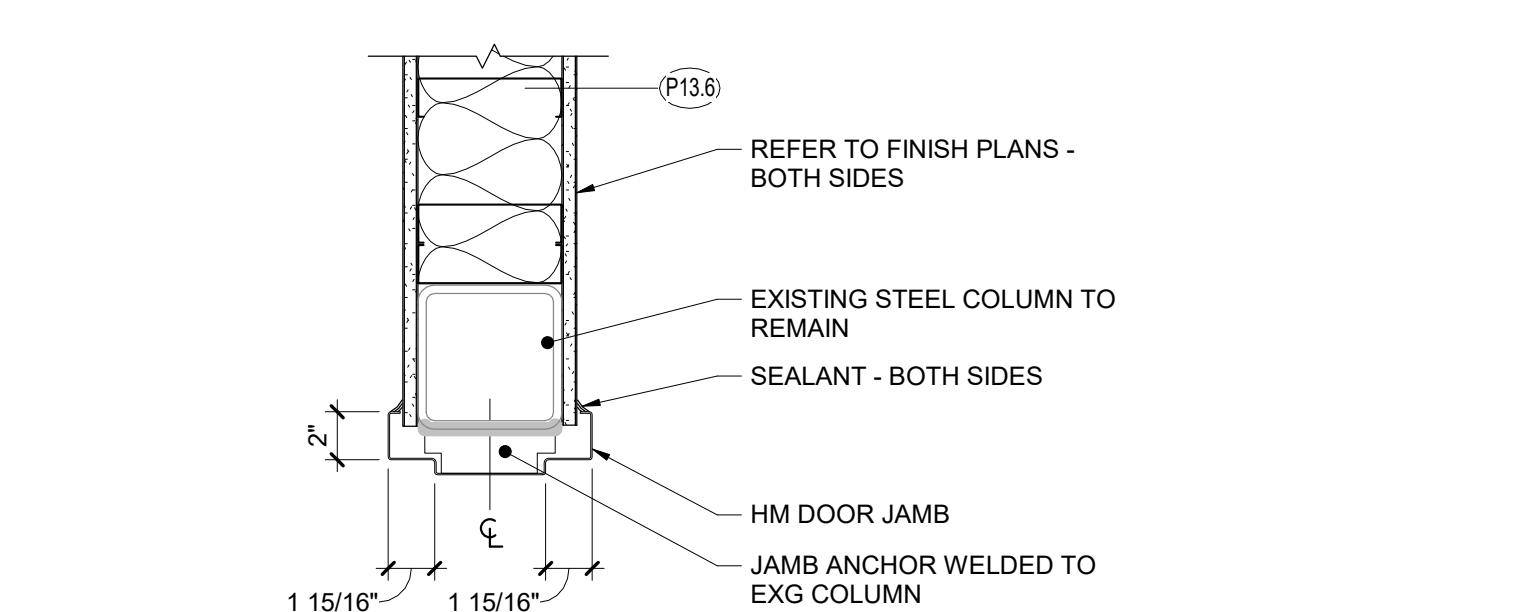


9 Jamb at Column Detail - P13.6
1 1/2" = 1'-0"

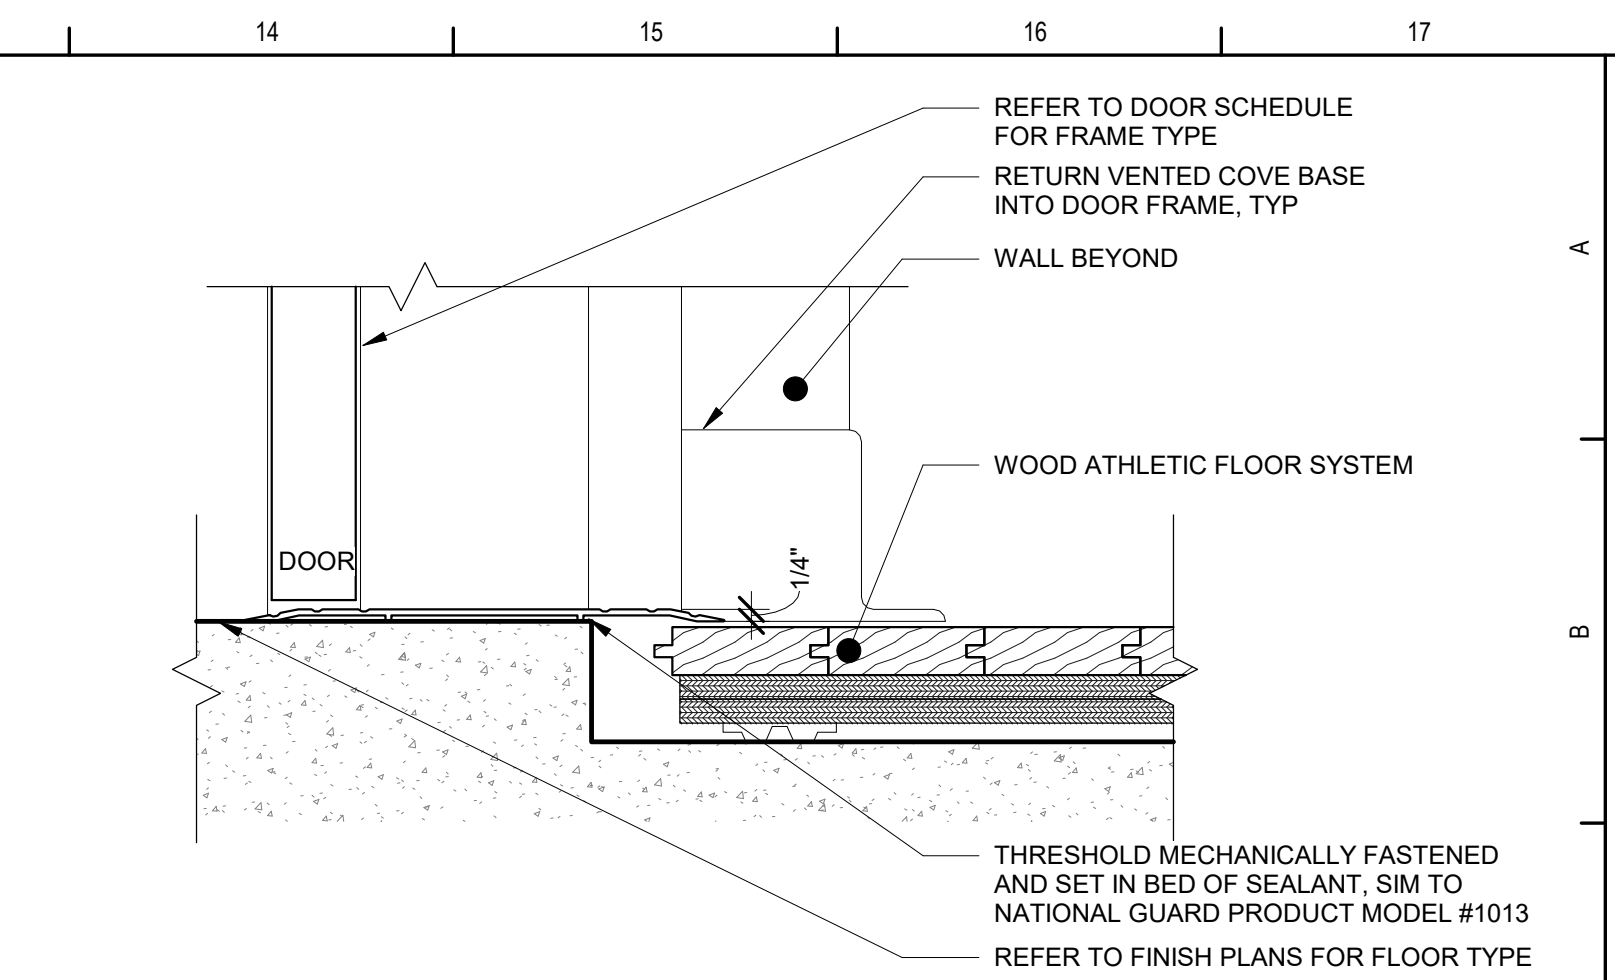


1 Interior Door Threshold At Gymnasium
3" = 1'-0"

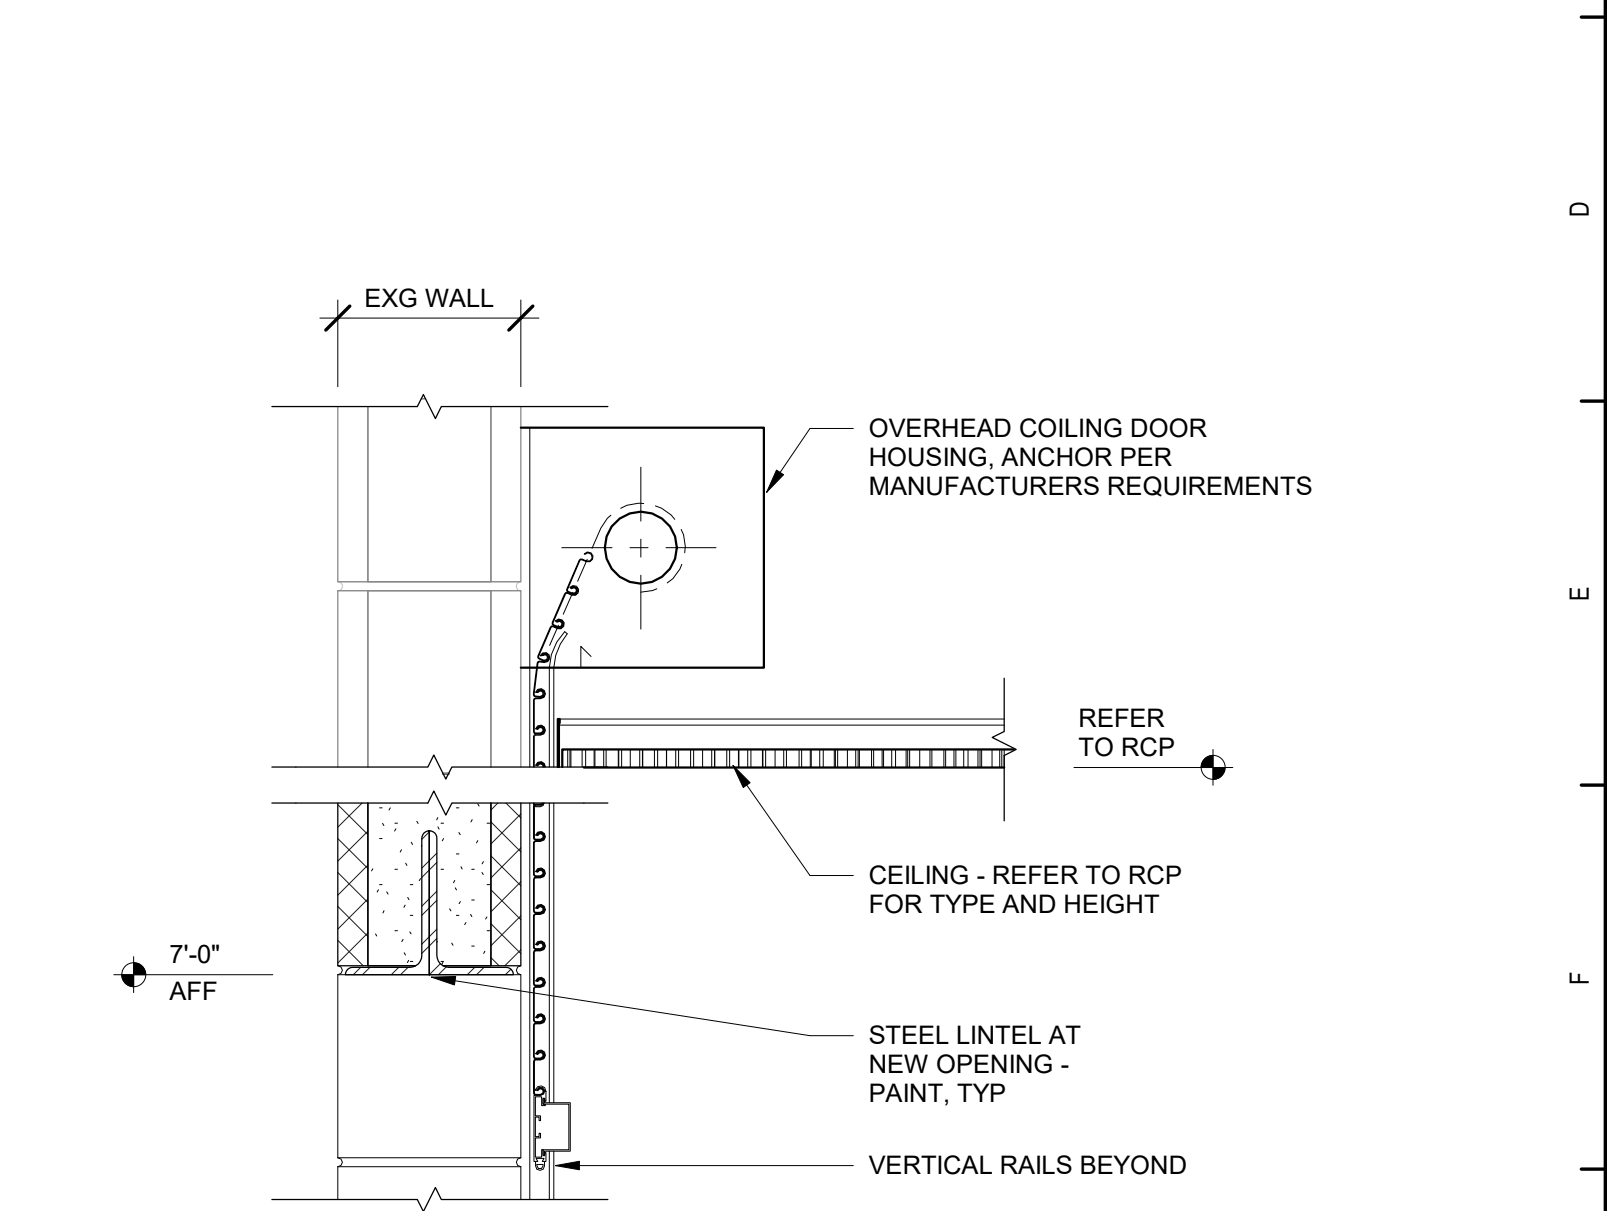


2 Fire Shutter/Coiling Door Head Detail
1 1/2" = 1'-0"

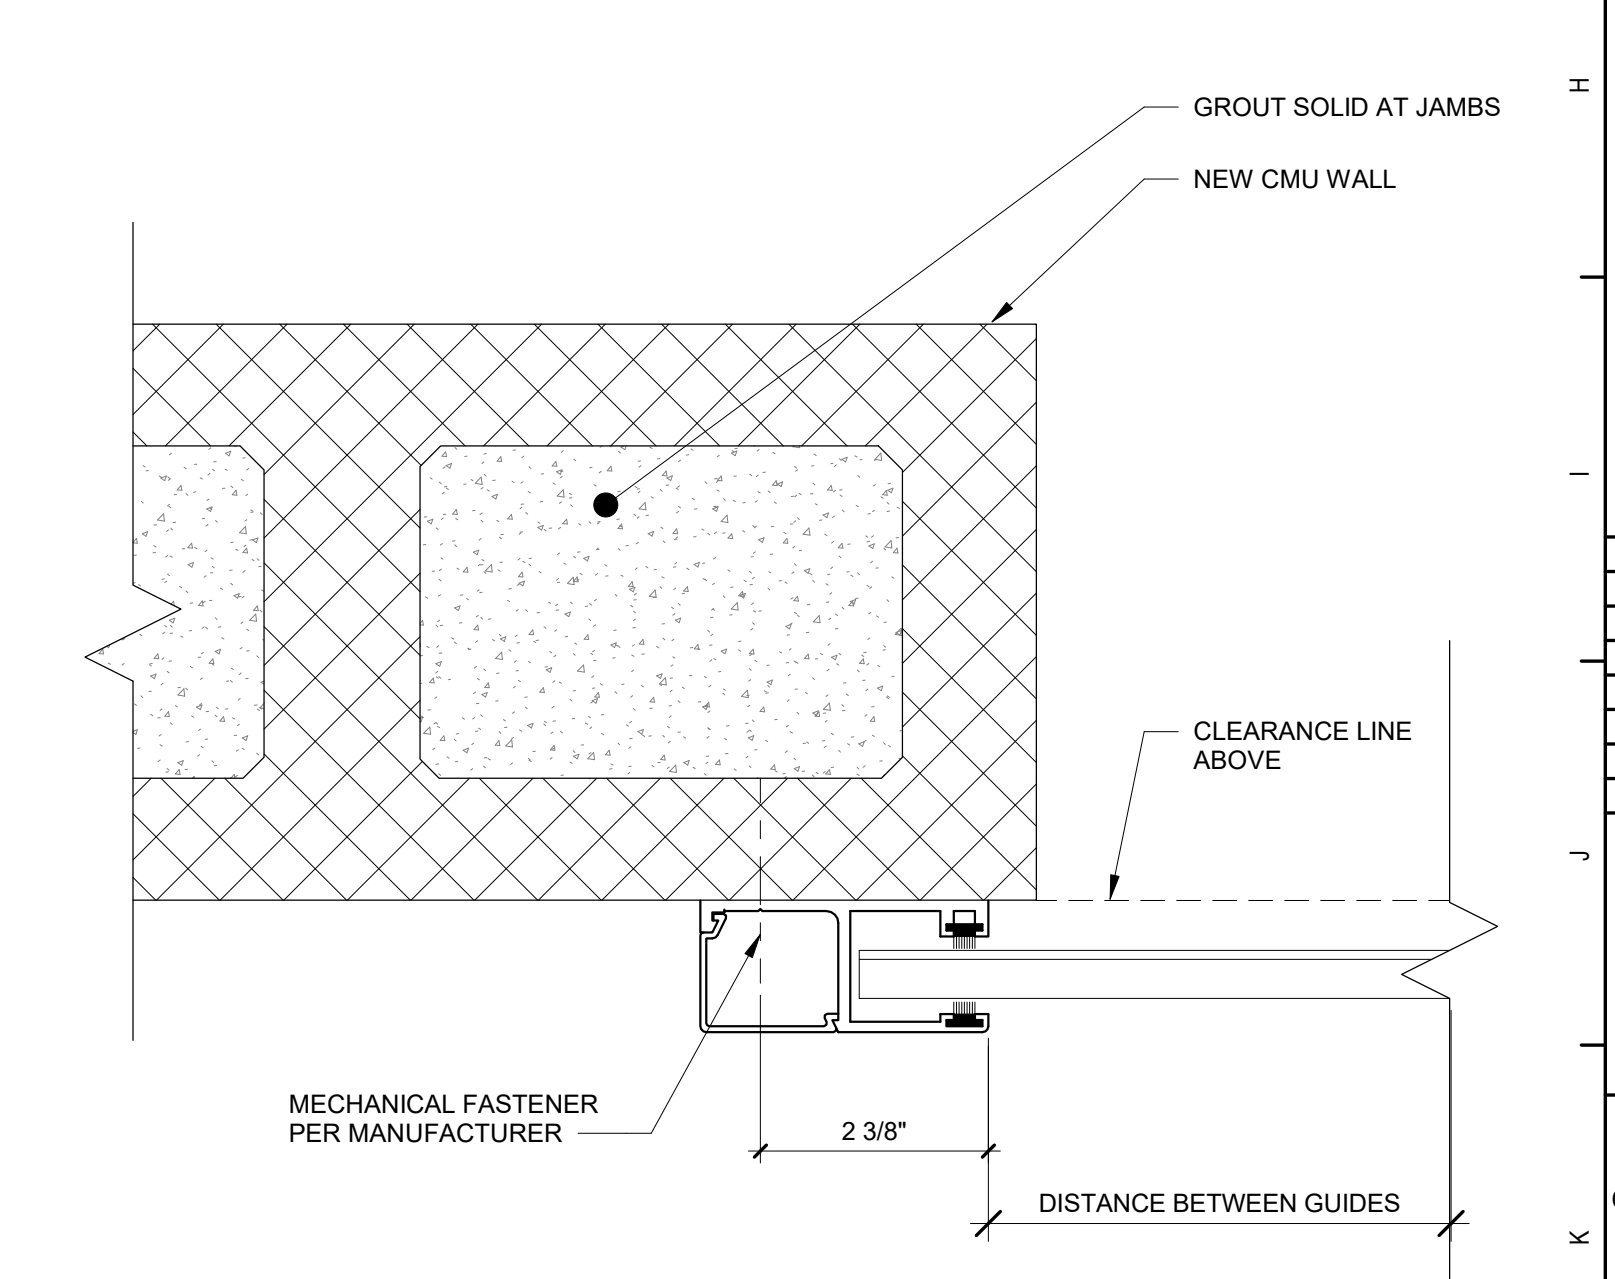

3 Coiling Door Jamb CMU Detail
6" = 1'-0"

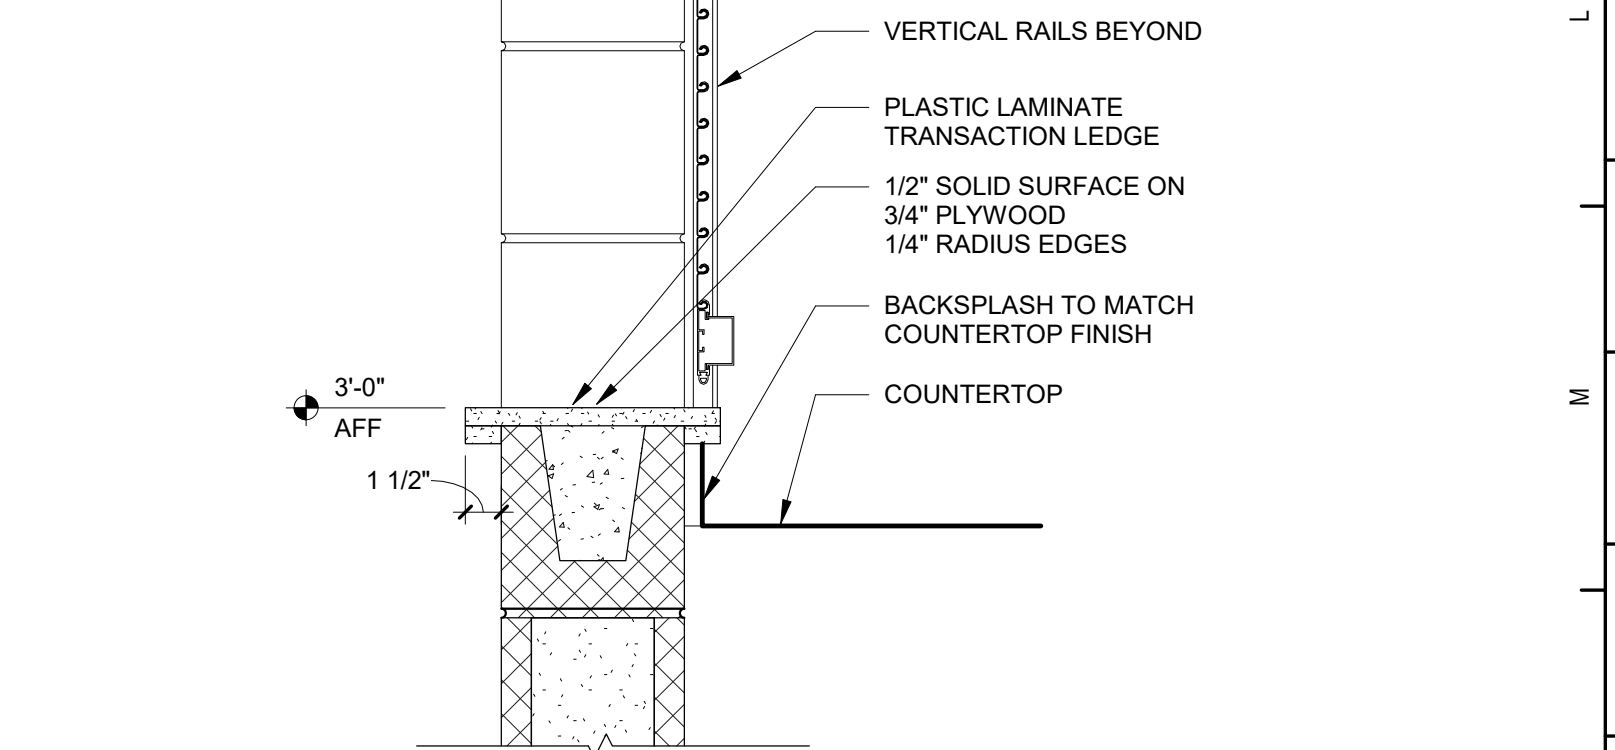

4 Fire Shutter Window Sill Detail
1 1/2" = 1'-0"

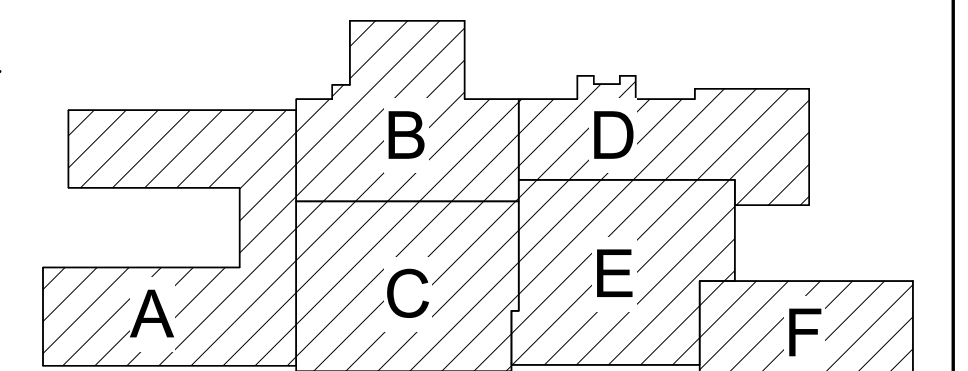

Key Plan
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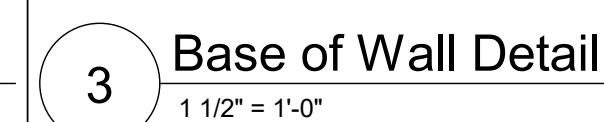
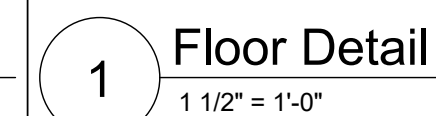
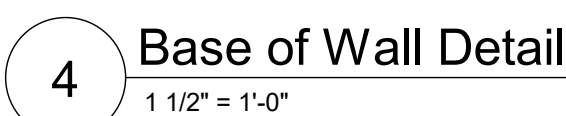
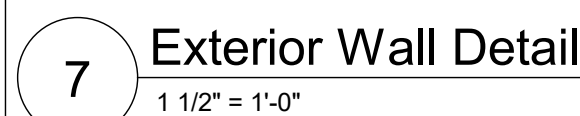
Waverly Central School District
Waverly, NY

Additions and Alterations to:
Waverly Jr. Sr. High School


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Drawn By: KCB Date: 05/19/2023 Drawing Number: 339070-22003

AA602



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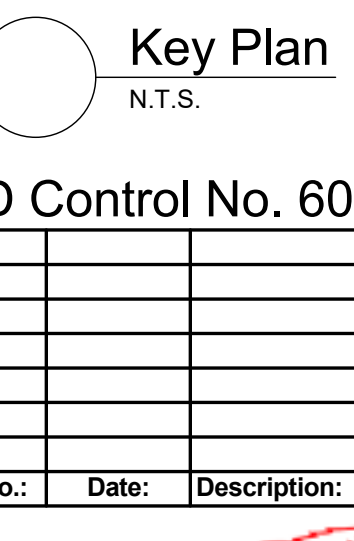



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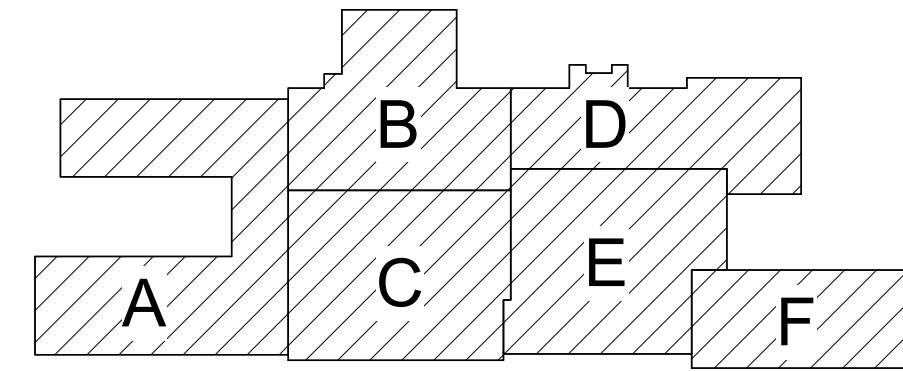
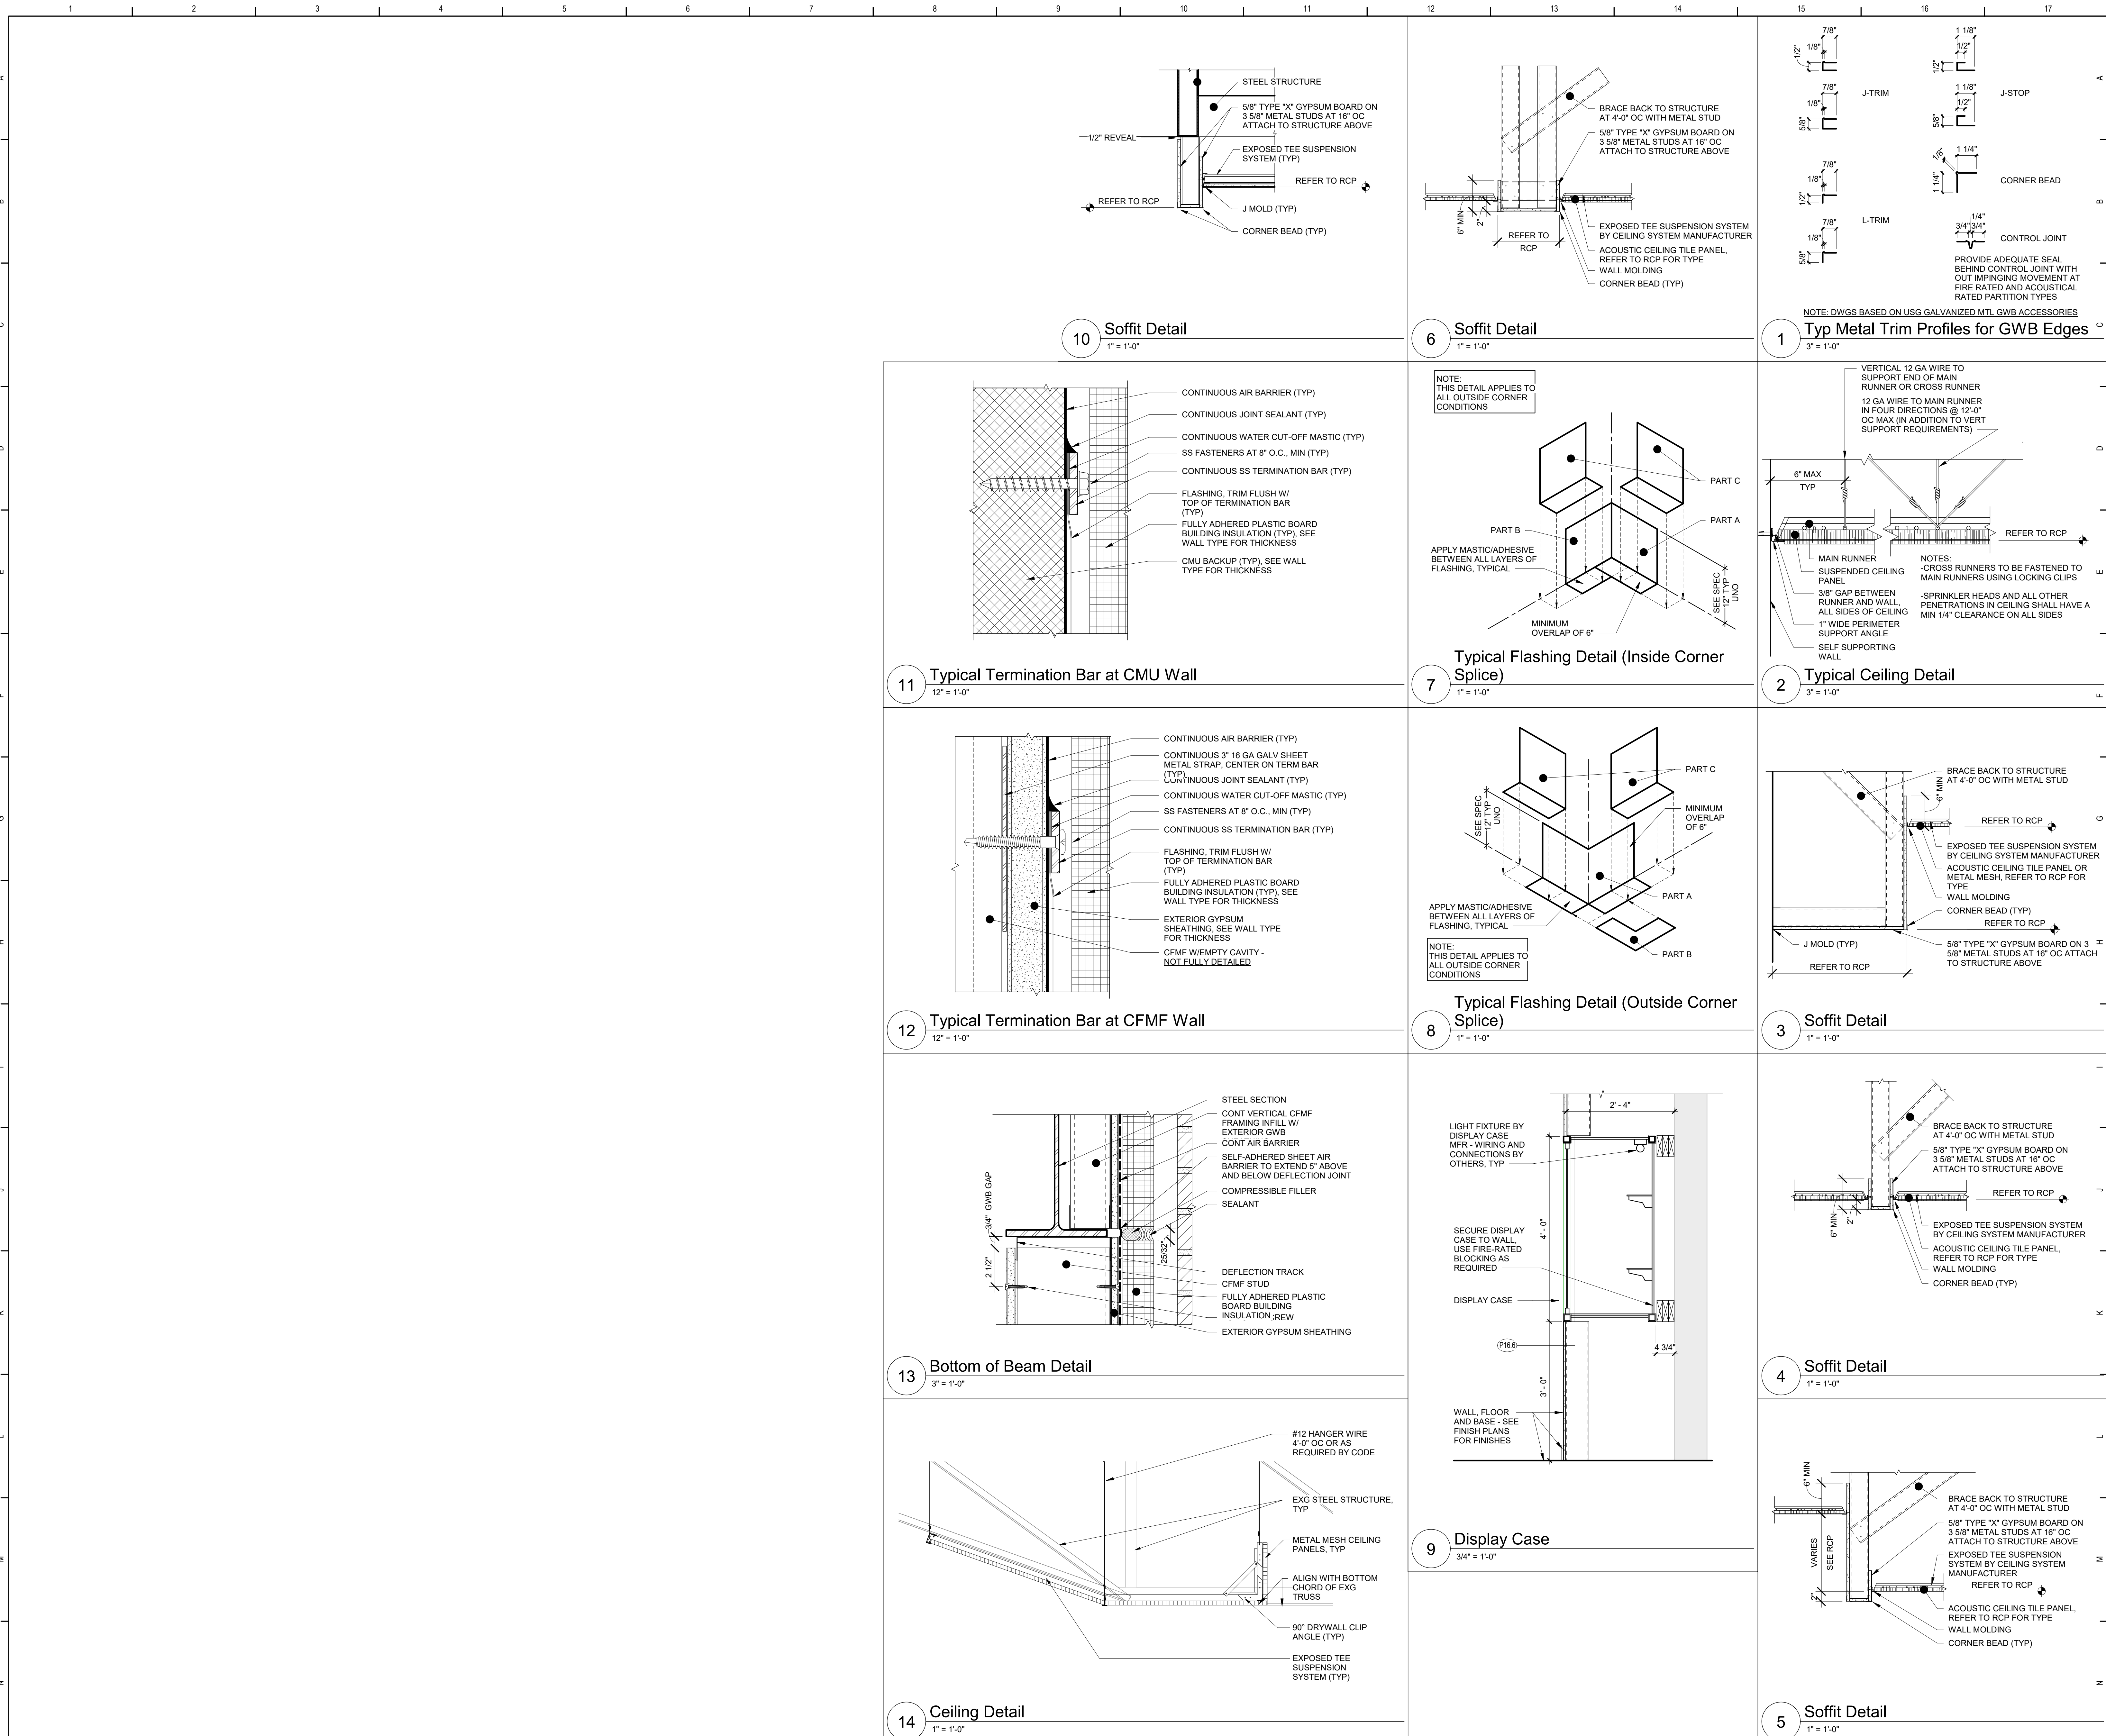


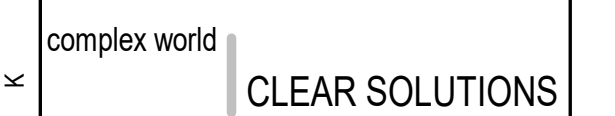M	Additions and Alterations to: Waverly Jr. Sr. High School
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N	Drawn By: KCB	Date: 05/19/2023	Drawing Number:
	Project No.: 339070-22003		AA70

AA701

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Waverly Central School District Waverly, NY		
Additions and Alterations to: Waverly Jr. Sr. High School		
Miscellaneous Details		
Drawn By: KCB	Date: 05/19/2023	Drawing Number: <div style="font-size: 24px; font-weight: bold; text-align: center;">AA750</div>
Project No.: 339070-22003		



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Waverly Central School District
Waverly, NY

Additions and Alterations to:
Waverly Jr. Sr. High School







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KCB

Date:
05/19/2023

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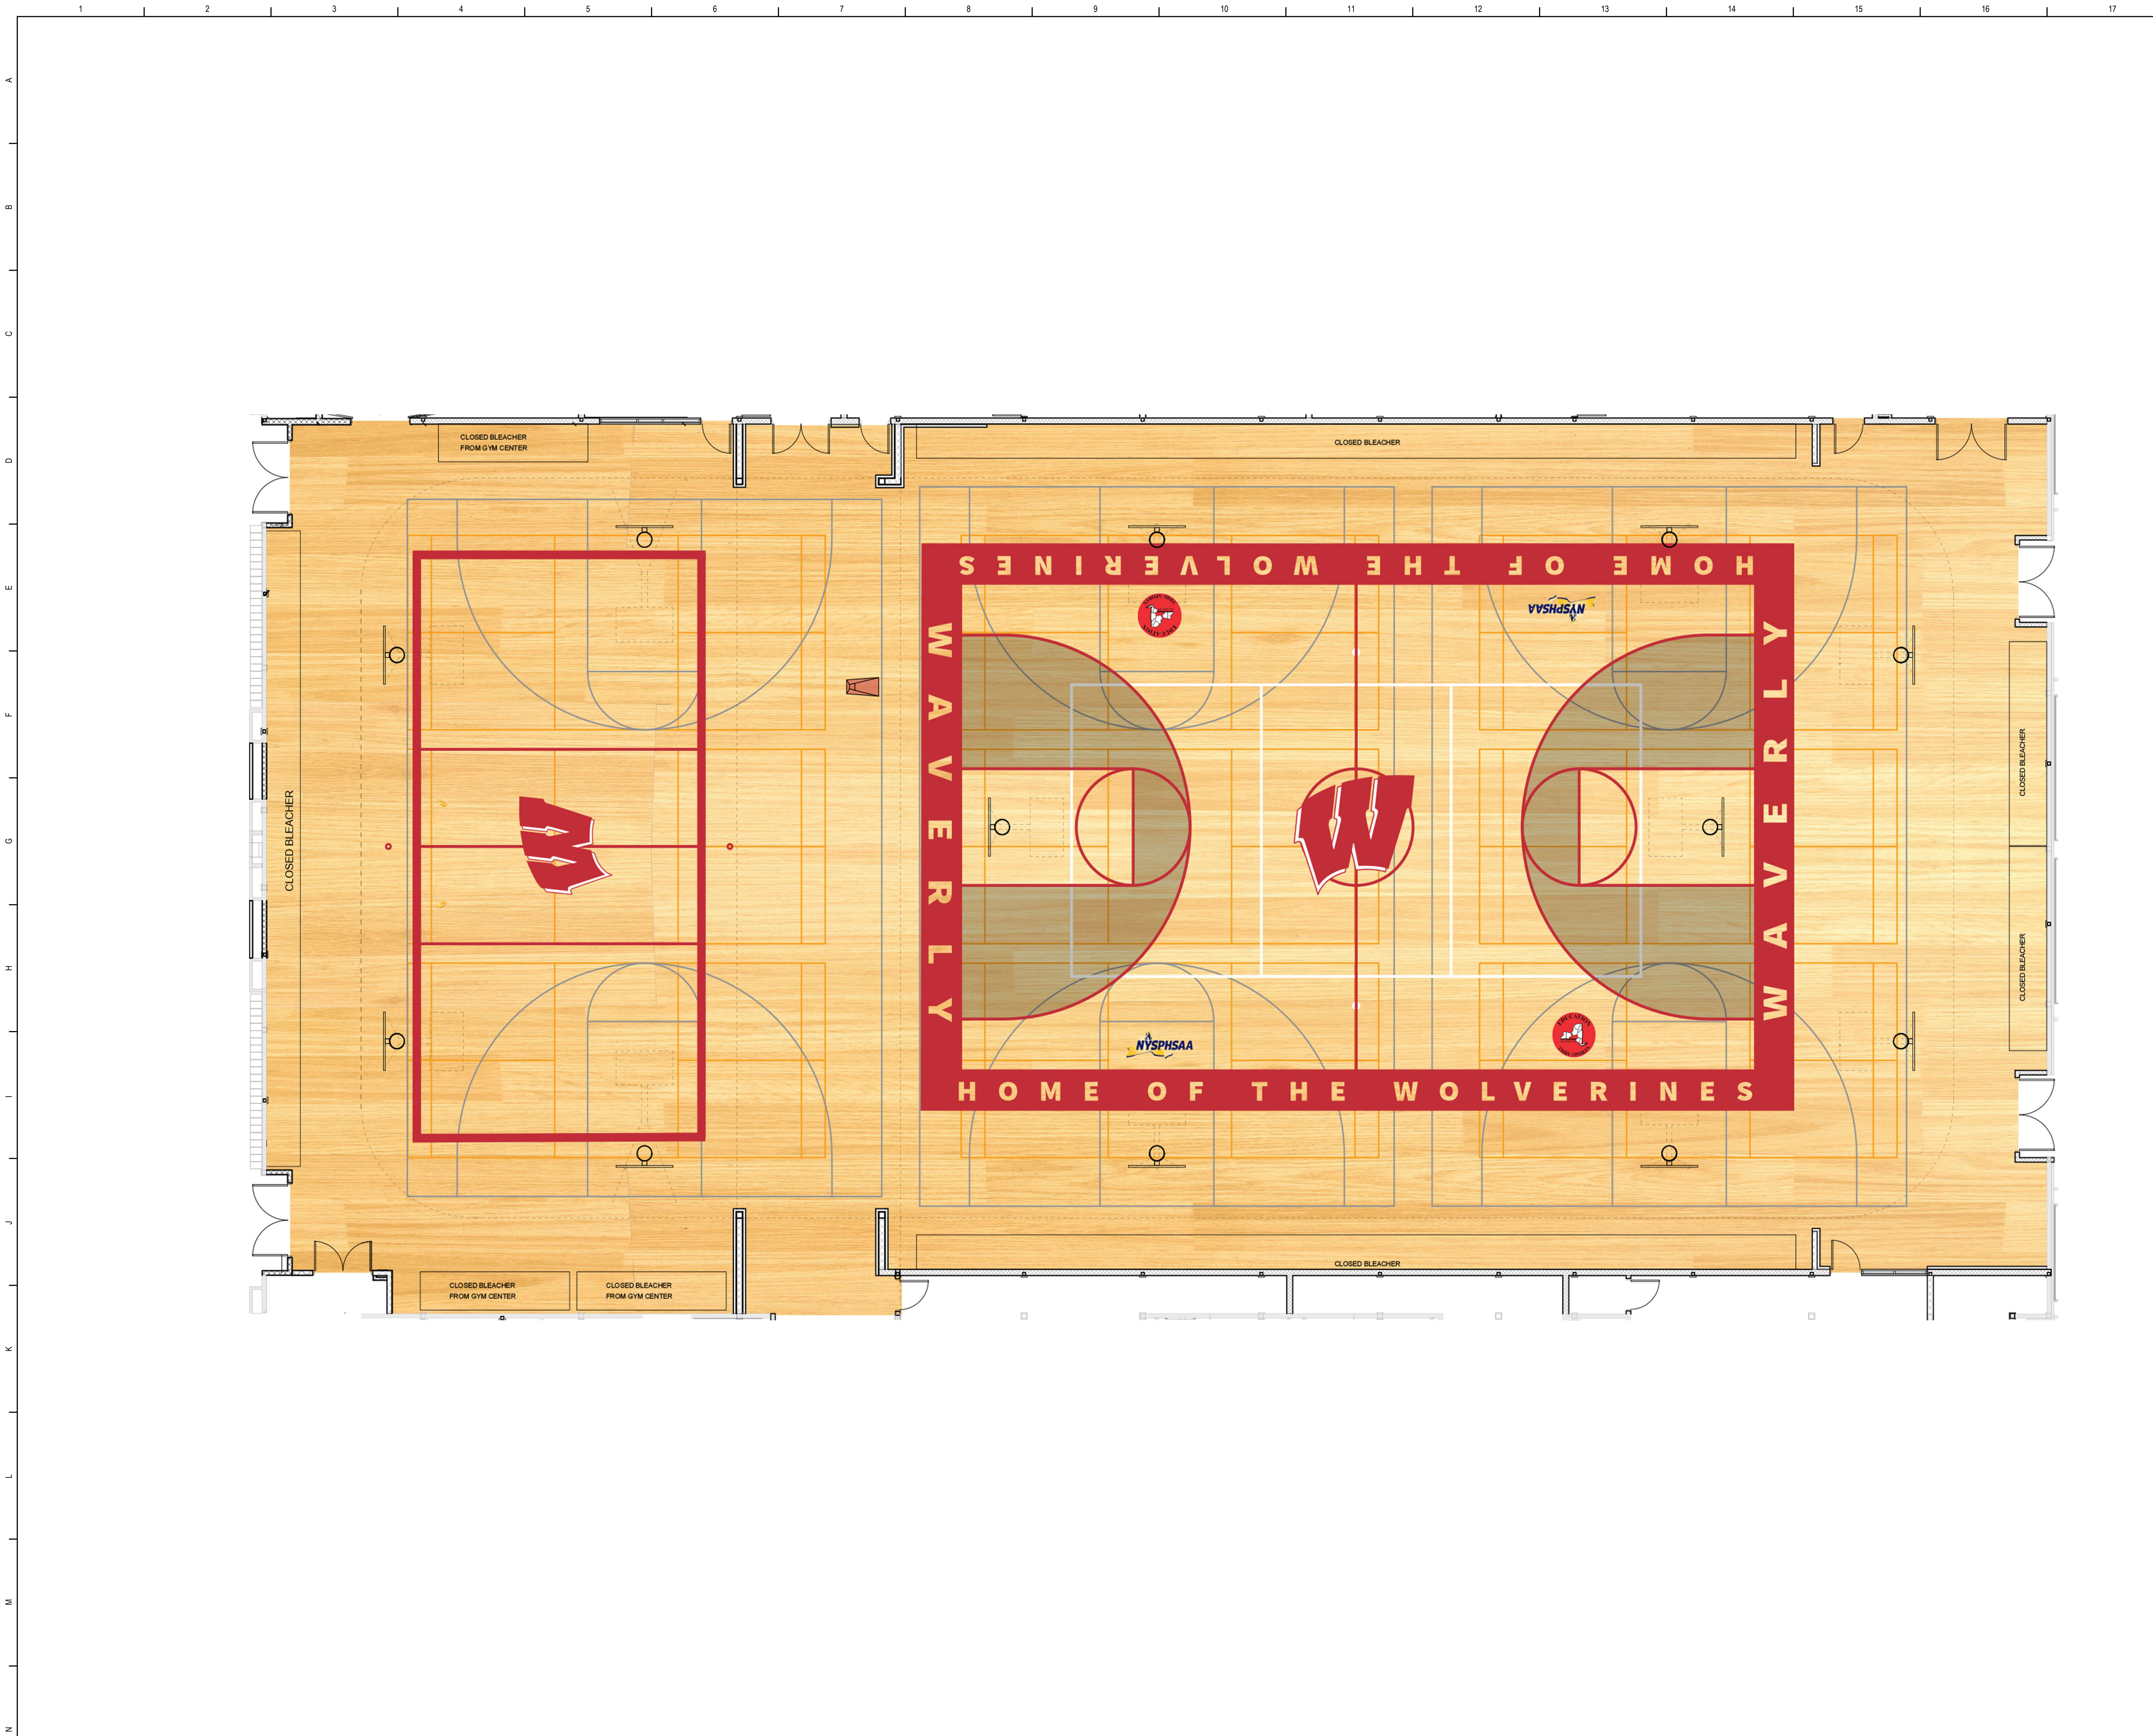
Waverly Central School District
Waverly, NY

Additions and Alterations to:
Waverly Jr. Sr. High School


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Project No.: 339070-22003		

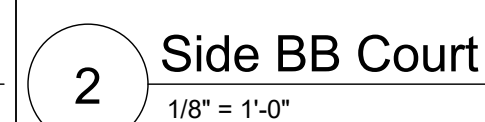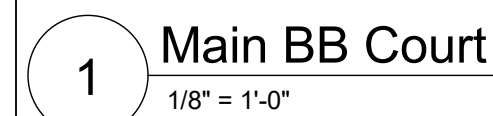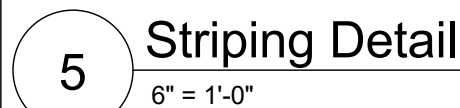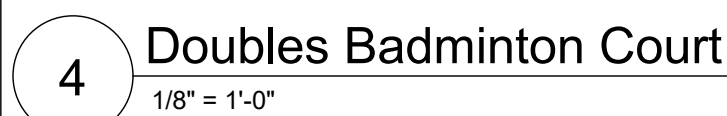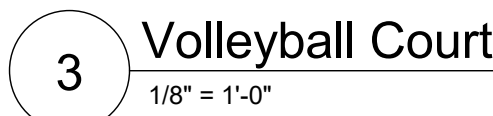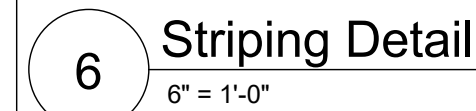AA752



THIS DRAWING IS TO SHOW DESIGN INTENT. LOGOS, FONTS AND COLORS. PLACEMENT OF STRIPING MAY VARY FROM WHAT IS SHOWN. FINAL PLACEMENT AND COLORS TO BE DETERMINED DURING SUBMITTAL AND SHOP DRAWING REVIEW AND APPROVAL.

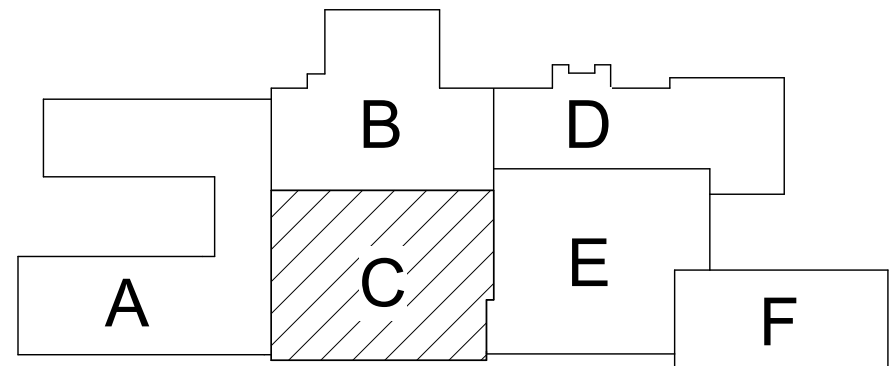

Key Plan
N.T.S.

SED Control No. 60-01-01-06-0-018-023

Rev. No.:	Date:	Description:



complex world
CLEAR SOLUTIONS

Tetra Tech Engineers, Architects
& Landscape Architects, P.C.

BID SET




Waverly Central School District
Waverly, NY

Additions and Alterations to:
Waverly Jr. Sr. High School

Wellness Center Floor Rendering

Drawn By: KCB	Date: 05/19/2023	Drawing Number:
Project No.: 339070-22003	AA753	

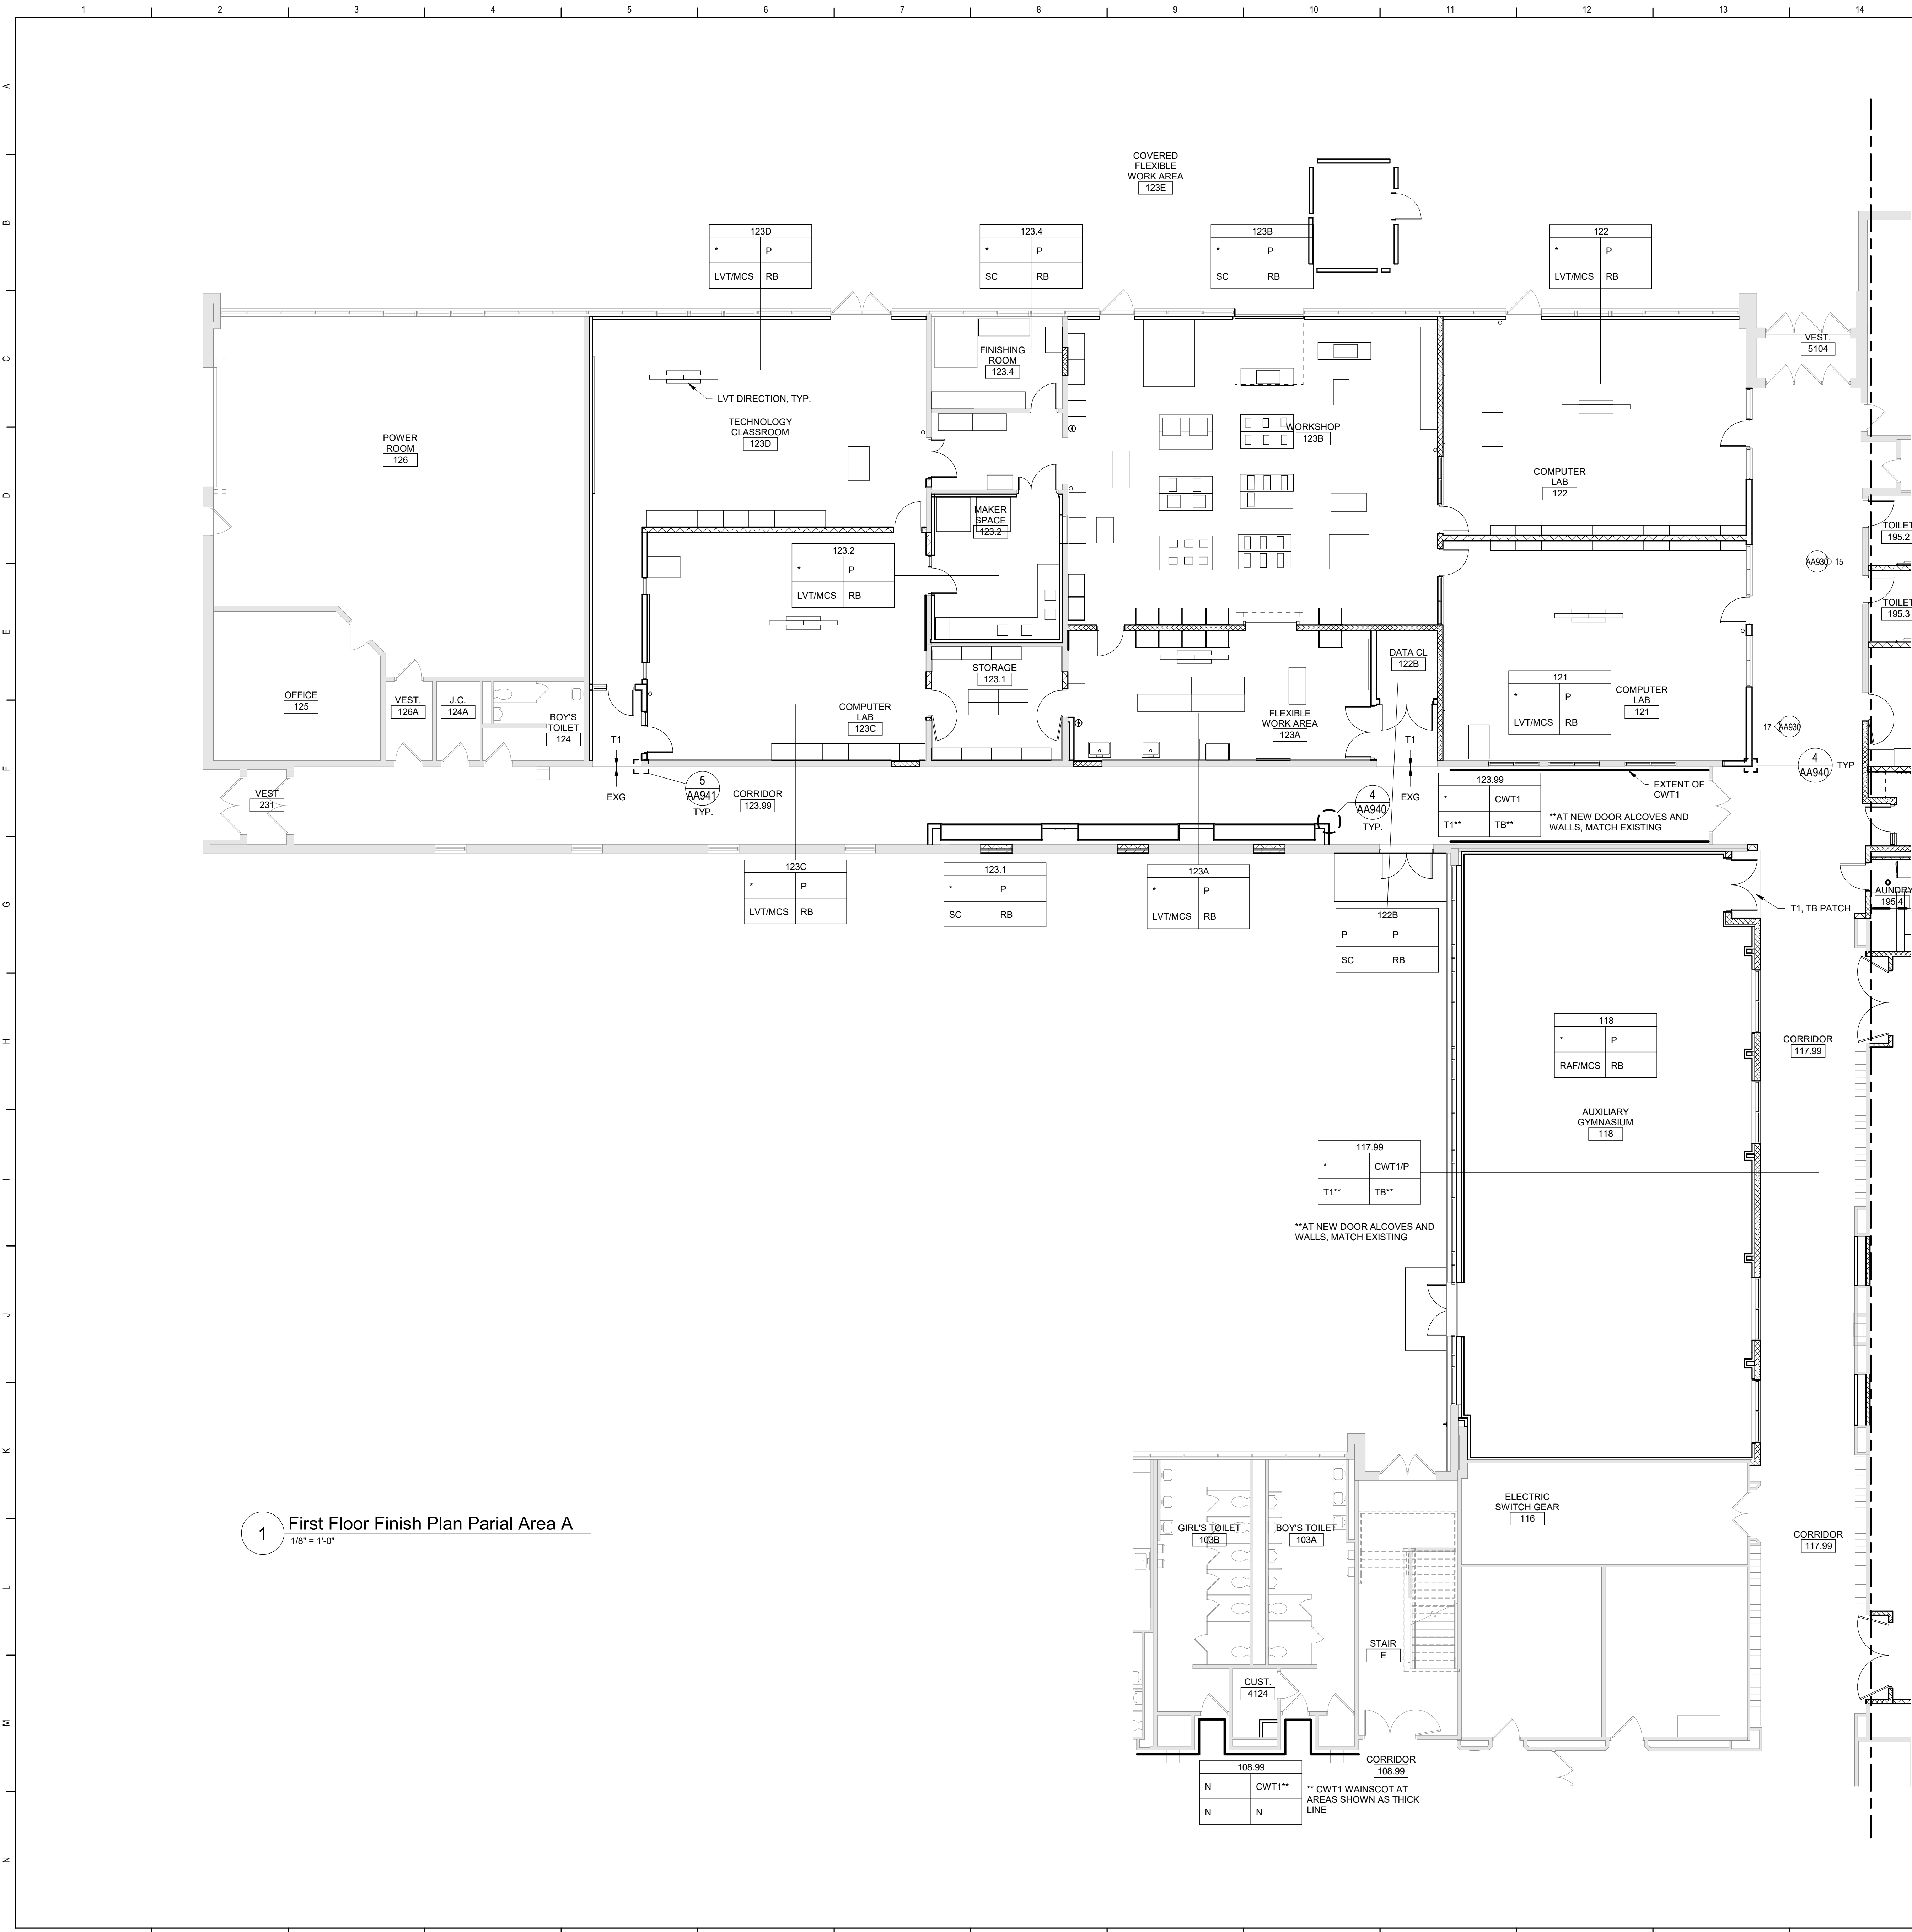

General Finish Notes

- ALL FINISH PRODUCTS ARE TO BE INSTALLED IN ACCORDANCE WITH CONTRACT SPECIFICATION AND MANUFACTURERS INSTRUCTIONS. REFER TO SPECIFICATIONS AND FINISH DETAILS FOR ADDITIONAL INFORMATION ON INSTALLATION OF SPECIFIED MATERIALS.
- A. ALL PAINTS FOR INTERIOR AND EXTERIOR ARE TO BE APPLIED IN ACCORDANCE WITH SPECIFICATION SECTION 09 91 00 AND 09 96 00.
- B. ALL EXPOSED STRUCTURES, INCLUDING BUT NOT LIMITED TO PIPING AND FIREPROOFING, CONDUIT, AND ALL ASSOCIATED EQUIPMENT ARE TO BE PAINTED.
- C. APPLY PAINT TO BOTH NEW AND EXISTING ITEMS IN ALL AREAS INDICATED WITH A FINISH BOX AND/OR NOTES - THESE ITEMS ARE INCLUDING BUT ARE NOT LIMITED TO:
- F.E.C. S, LADDERS, BEAMS, DOOR/FRAMES - BOTH SIDES
- GLAZING FRAMES IN DOOR/WALLS - BOTH SIDES
- ALL EXPOSED STAIR PARTS INCLUDING RAILINGS, HAND AND GUARD RAILS, STRINGERS AND UNDERSIDES OF STAIRS, ALL ITEMS ARE TO BE ACCENT COLORS
- D. PATTERNS FOR FLOORS AND WALLS ARE TO BE ISSUED DURING CONSTRUCTION INCLUDING ALL ACCENT LOCATIONS. SUBMIT SHOP DRAWINGS SHOWING DETAILED LAYOUTS OF EACH AREA, INCLUDING EDGES AND TRANSITIONS. ALL LAYOUTS ARE TO BE CENTERED IN EACH ROOM UNO - TYP ALL DRAWINGS, ABOVE REQUIREMENTS ARE TO INCLUDE BUT NOT LIMITED TO:
- CERAMIC TILE, BOTH WALL AND FLOOR.
- CARPET
- LVT
- E. FIELD AND ACCENT PAINT AS SHOWN ON DRAWINGS
CONTRACTOR IS TO ASSUME ALL FIELD AND ACCENT COLORS ARE DIFFERENT ROOM TO ROOM, AS WELL AS WITHIN EACH ROOM. REQUIREMENTS ARE TO INCLUDE BUT ARE NOT LIMITED TO:
- WALL FIELD COLOR
- WALL ACCENT COLOR
- SOFFITS, ACCENT COLOR
- DOOR AND WINDOW FRAMES, ACCENT COLOR
- EXPOSED COLUMNS, ACCENT COLOR
- GUARDRAILS, ACCENT COLOR
- HANDRAILS, ACCENT COLOR
- EXPOSED DECKS, ACCENT COLOR
- EXPOSED JOISTS, ACCENT COLOR
- EXPOSED DUCTWORK, ACCENT COLOR
- F. PAINT MECHANICAL ROOM FLOOR CURBS CAUTION YELLOW.
- G. PROVIDE PAINT AT ALL NEW SOFFITS, REFER TO REFLECTIVE CEILING PLANS FOR ADDITIONAL LOCATIONS.
- J. CONFIRM WITH OWNER AND ARCHITECT PRIOR TO PAINTING OVER MURALS ON EXISTING SURFACES.
- K. CERAMIC WALL TILE IS TO RUN FLOOR TO CEILING UNO.
- N. NEW CERAMIC TILE WAINSCOT TO MATCH HEIGHT OF EXISTING GLAZED BLOCK WAINSCOT, OR AS OTHERWISE NOTED ON DRAWINGS.
- P. PROVIDE PAINT AND RUBBER BASE AT ALL NEW CHASES, REFER TO NEW WORK PLANS FOR ADDITIONAL LOCATIONS.
- Q. REFER TO STRUCTURAL DRAWINGS FOR LOCATIONS OF SLAB DEPRESSIONS. REFER TO FINISH MATERIAL SPECIFICATION SECTIONS FOR SLAB DEPRESSION DEPTH REQUIREMENTS.
- T. CARPET IS TO RUN WALL TO WALL, UNDER ALL FURNITURE, MOVEABLE EQUIPMENT AND LIBRARY SHELVING UNITS, INCLUDING ALL UNITS AT THE PERIMETER WALLS.
- V. FOR ALL RENOVATED AREAS REQUIRING FINISH WORK REMOVE, PROTECT AND REINSTALL MOVABLE EQUIPMENT INCLUDING BUT NOT LIMITED TO: BOARD UNITS, LOCKERS GYM EQUIPMENT, SHADES/BLINDS, ETC. REINSTALL IN ORIGINAL LOCATION, OR AS NOTED ON DRAWINGS. COORDINATE WITH OWNER. REFER TO SPEC SECTION 01 23 00 ALTERATION PROJECT PROCEDURES FOR MORE INFORMATION.
- X. FIELD VERIFY ALL CONTROL JOINTS LOCATIONS IN CONCRETE SLAB. LOCATE CONTROL JOINTS IN EXG/NEW FLOOR FINISH MATERIAL DIRECTLY ABOVE SLAB JOINTS OR AS RECOMMENDED BY FLOORING MATERIAL MANUFACTURER.
- AT NEW SLABS REFER TO STRUCTURAL DRAWINGS FOR SLAB CONTROL JOINT LOCATIONS
- AT EXISTING SLABS, FIELD VERIFY LOCATIONS OF EXISTING SLAB CONTROL JOINTS
- REFER TO FINISH DRAWINGS AND SPECIFICATIONS FOR NEW FLOOR MATERIALS
- COORDINATE FLOOR PATTERNS WITH CONTROL JOINT PRIOR TO SUBMISSION OF REQUIRED FLOOR PATTERN DRAWINGS.
- Y. INSTALLER IS TO FIELD VERIFY ALL EXG AND NEW FLOOR DRAIN LOCATIONS IN ALL EXG AND NEW SLABS AS PART OF THIS PROJECT.
* REFER TO ARCHITECTURAL DRAWINGS FOR FLOOR DEMO AREAS AND REQUIREMENTS
* REFER TO PLUMBING DRAWINGS FOR EXG AND NEW FLOOR DRAIN LOCATIONS
* REFER TO STRUCTURAL DRAWINGS FOR LOCATIONS OF SLAB DEPRESSIONS
* REFER TO FINISH DRAWINGS FOR LOCATIONS OF NEW FLOOR FINISH MATERIALS AND FLOORING SLOPE
* REFER TO FINISH MATERIAL SPECIFICATION SECTIONS FOR SLAB DEPRESSION DEPTH REQUIREMENTS.
- Z. PROVIDE ALL FINISHES AS INDICATED BY ROOM FINISH BOX AND/OR AS NOTED ON DRAWINGS.

Room Finish Key

- C1 CARPET - TYPE 1
CFT1 CERAMIC FLOOR TILE - TYPE 1
CT CERAMIC TILE COVE BASE
CWT1 CERAMIC WALL TILE - TYPE 1
ES EXPOSED STRUCTURE
HPC HIGH PERFORMANCE COATING
LVT LUXURY VINYL TILE
MCS MOISTURE CONTROL SYSTEM
N NO WORK REQUIRED
P PAINT SURFACE(S) INCLUDING SOFFITS
PS PAINT EXPOSED STRUCTURE/DECK
RA RESILIENT ATHLETIC FLOORING
RB RUBBER BASE
SC SEALED CONCRETE (PER SPEC. SECT. 03 30 00)
T1 TERRAZZO - TYPE 1 - POURED EPOXY
TB TERRAZZO BASE - PRECAST
VCB VENTED COVE BASE
VCT1 VINYL COMPOSITION TILE - TYPE 1
WD1 WOOD FLOORING - GYM


* SEE REFLECTED CEILING PLAN

INDICATED CHANGE IN FLOOR FINISH

NOTE: ALL FINISHES LISTED MAY NOT BE REQUIRED FOR THIS PROJECT

RM#	
CLG*	WALL
FLR	BASE

- FINISHES SHOWN IN ROOM FINISH BOX ARE FOR ALL WALLS AND ENTIRE FLOOR AND CEILING. REFER TO EACH ROOM FOR MORE INFORMATION.

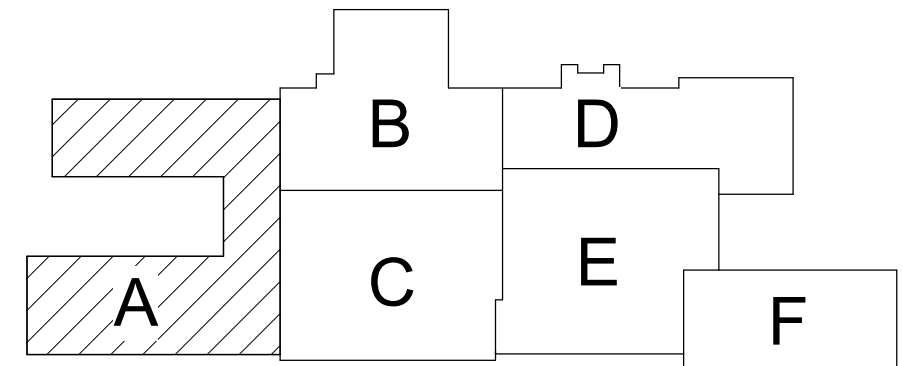

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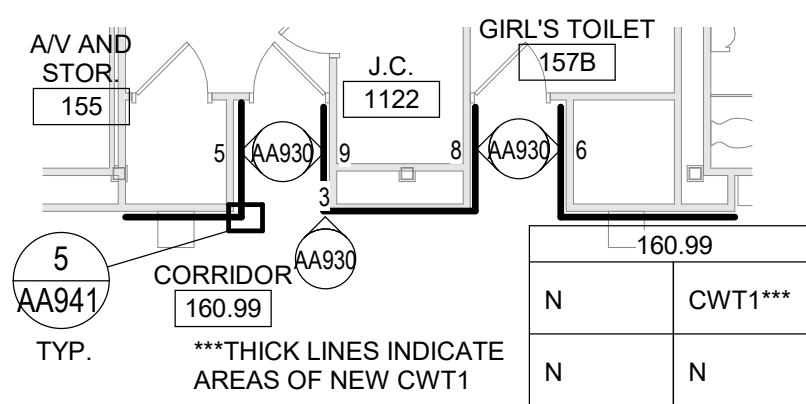


Waverly Central School District
Waverly, NY

Additions and Alterations to:
Waverly Jr. Sr. High School

First Floor Finish Plan - Partial Area A

Drawn By: TRS	Date: 05/19/2023	Drawing Number: AA900
Project No.: 339070-22003		



1 First Floor Area F Plan - Corridor



Room Finish Key


C1	CARPET - TYPE 1
CF1	CERAMIC FLOOR TILE - TYPE 1
CE	CERAMIC TILE COVE BASE
CW1	CERAMIC WALL TILE - TYPE 1
ES	EXPOSED STRUCTURE
HPC	HIGH PERFORMANCE COATING
LVT	LUXURY VINYL TILE
MCS	MOISTURE CONTROL SYSTEM
N	NO WORK REQUIRED
P	PAINT SURFACE(S) INCLUDING SOFFIT
PS	PAINT EXPOSED STRUCTURE/DECK
RAF	RESILIENT ELASTIC FLOORING
RB	RUBBER BASE
SC	SEALED CEILING (PER SPEC. SECT. 03 30 00)
T1	TERRAZZO - TYPE 1, POURED EPOXY
TB	TERRAZZO BASE - PRECAST
VC	VENTED COVE BASE
VCT1	VINYL COMPOSITION TILE - TYPE 1
WD1	WOOD FLOORING - GYM

- * SEE REFLECTED CEILING PLAN
- INDICATED CHANGE IN FLOOR FINISH

NOTE: ALL FINISHES LISTED MAY NOT BE REQUIRED FOR THIS PROJECT

FINISHES SHOWN IN ROOM FINISH BOX ARE FOR ALL WALLS AND ENTIRE FLOOR AND CEILING. REFER TO EACH ROOM FOR MORE INFORMATION.

RM#	
CLG*	WALL
FLR	BASE

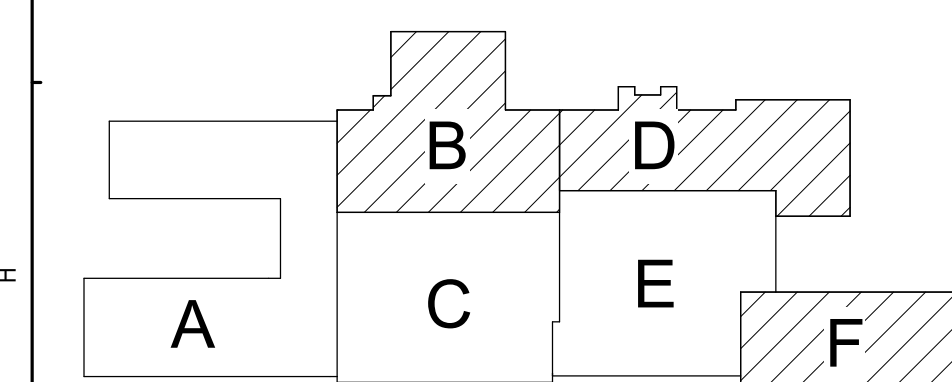

☐ Key Plan
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& Landscape Architects, P.C.



Waverly Central School District
Waverly, NY


W	Additions and Alterations to: Waverly Jr. Sr. High School
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First Floor Finish Plan - Partial Areas B,
D and F


Drawn By: TRS	Date: 05/19/2023	Drawing Number:
Project No.: 339070-22003		AA901



1 First Floor Plan Area C
1/8" = 1'-0"

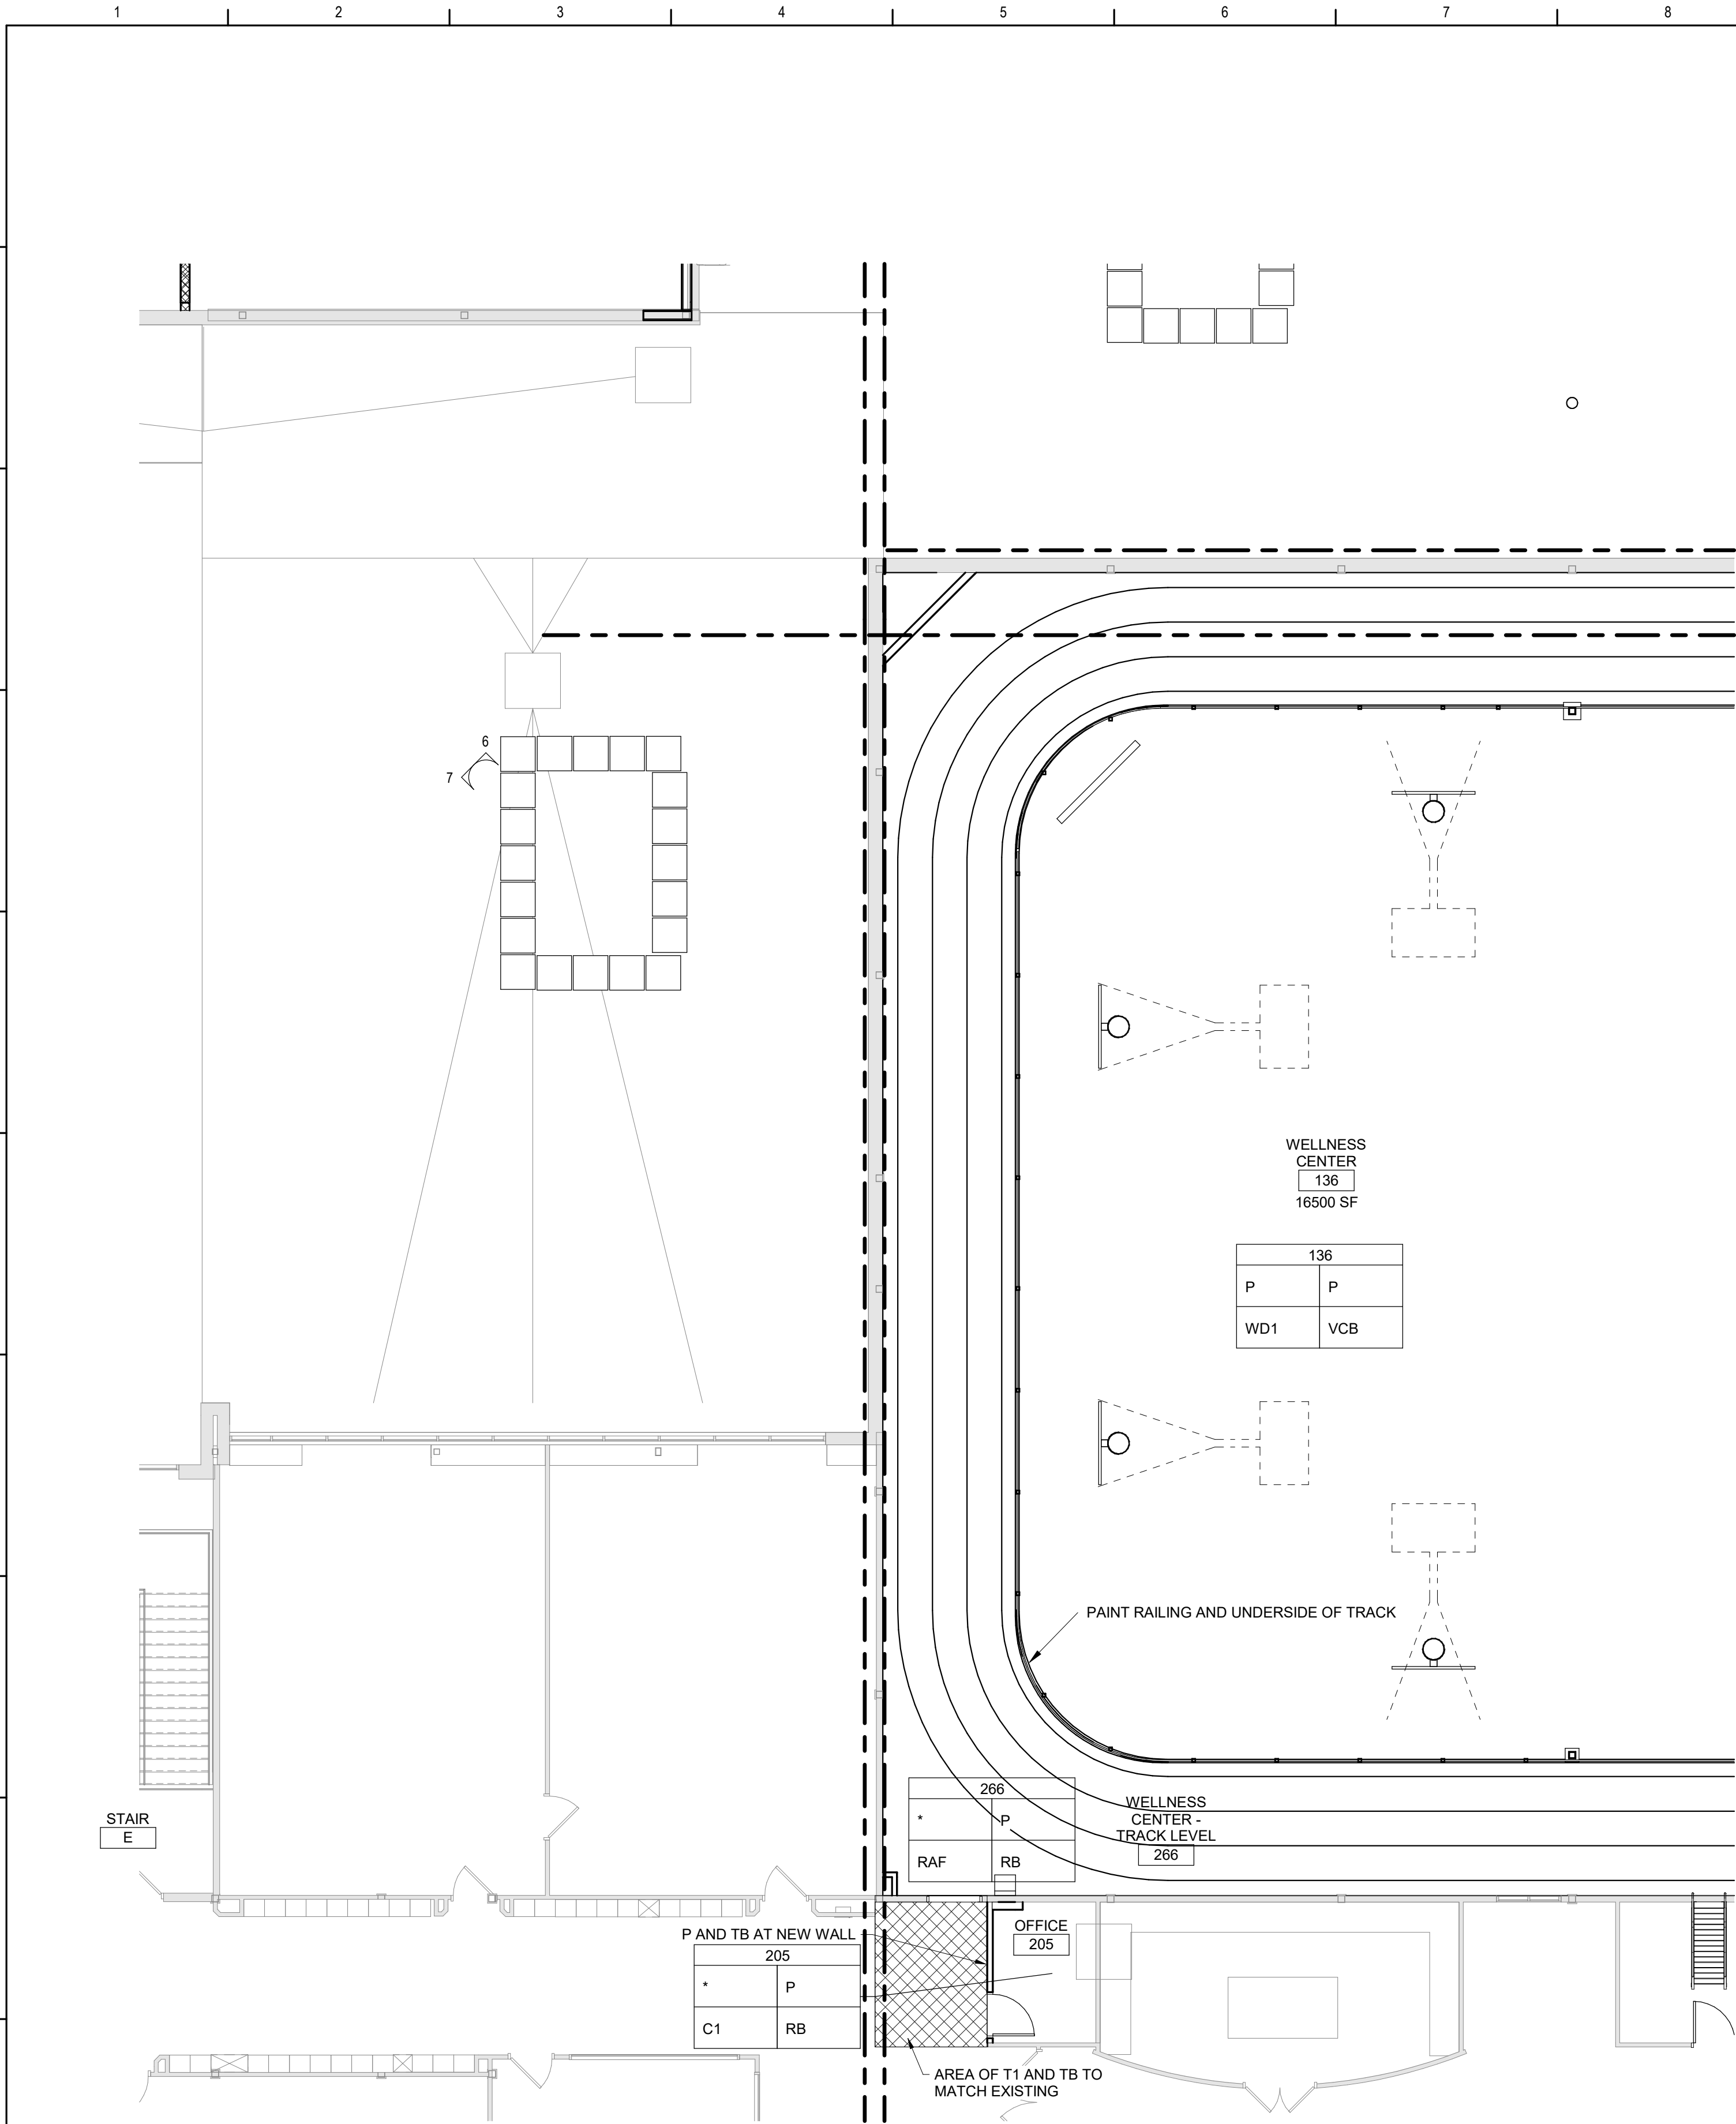

1 Partial Second Floor Plan Area A
1/8" = 1'-0"

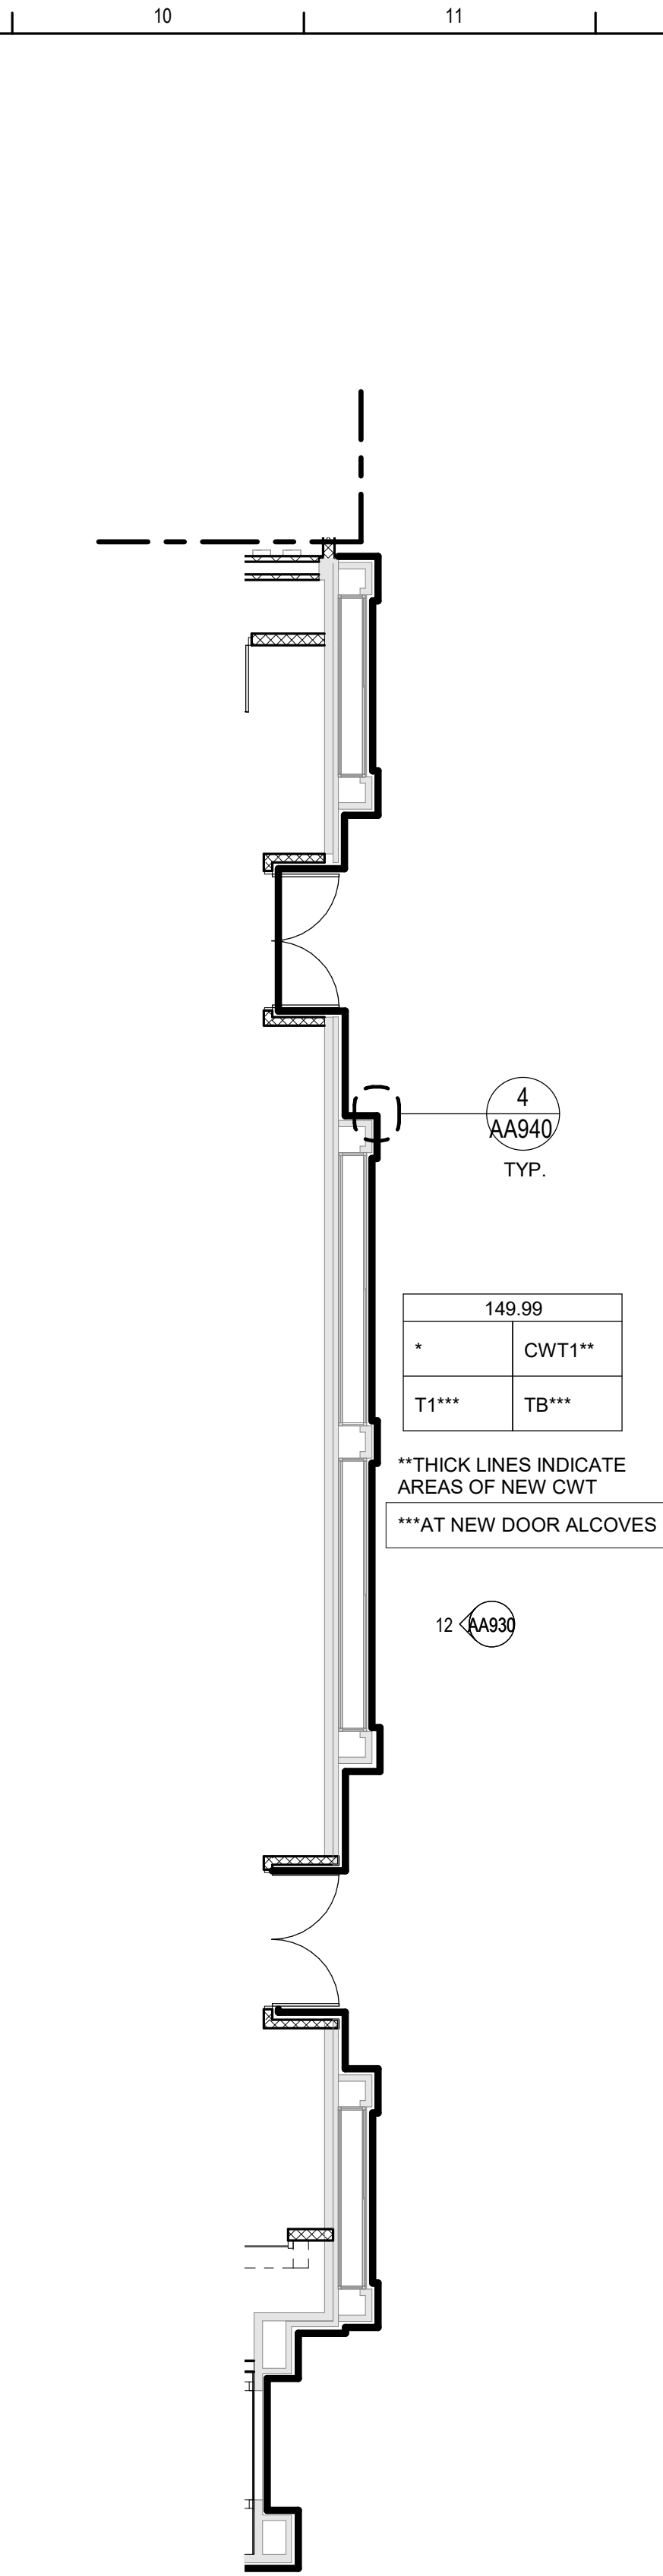

2 Partial Area E - Corridor 149.99
1/8" = 1'-0"



3 Partial Area A Plan - Corridor 212.99
1/8" = 1'-0"

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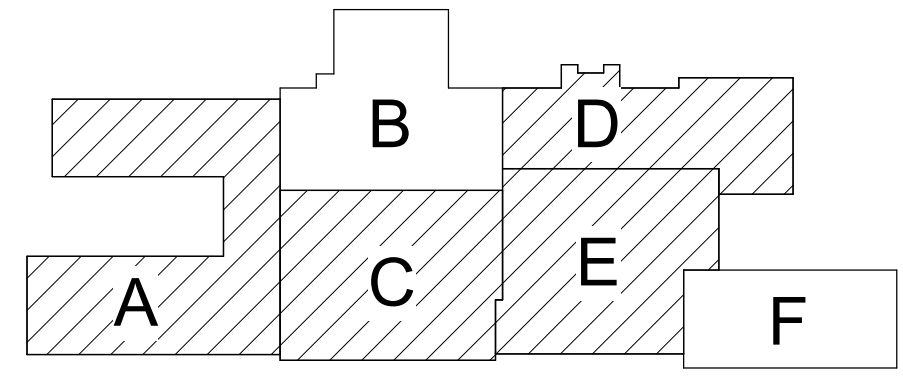
Room Finish Key

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HPC HIGH PERFORMANCE COATING
LVT LUXURY VINYL TILE
MCS MOISTURE CONTROL SYSTEM
N NO WORK REQUIRED
P PAINT SURFACE(S) INCLUDING SOFFITS
PS PAINT EXPOSED STRUCTURE/DECK
RAF RESILIENT ATHLETIC FLOORING
RB RUBBER BASE
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WD1 WOOD FLOORING - GYM
- * SEE REFLECTED CEILING PLAN
- INDICATED CHANGE IN FLOOR FINISH

NOTE: ALL FINISHES LISTED MAY NOT BE REQUIRED FOR THIS PROJECT

RM#	
CLG*	WALL
FLR	BASE

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Key Plan
N.T.S.

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Tetra Tech Engineers, Architects & Landscape Architects, P.C.

BID SET


TETRA TECH
ARCHITECTS & ENGINEERS

Waverly Central School District
Waverly, NY


Additions and Alterations to:
Waverly Jr. Sr. High School

First and Second Floor Finish Plans -
Area A, C, D and E


Drawn By: TRS	Date: 05/19/2023	Drawing Number: AA903
Project No.: 339070-22003		

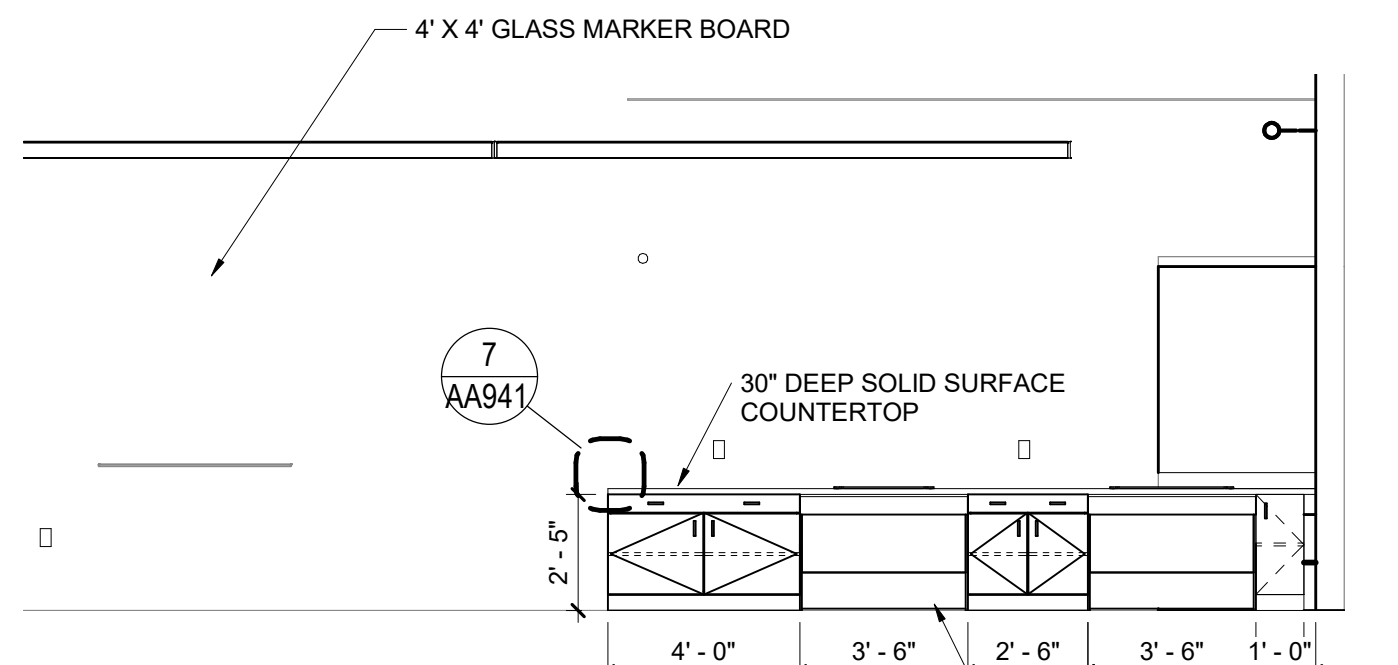


2 Elevation 123A
1/4" = 1'-0"

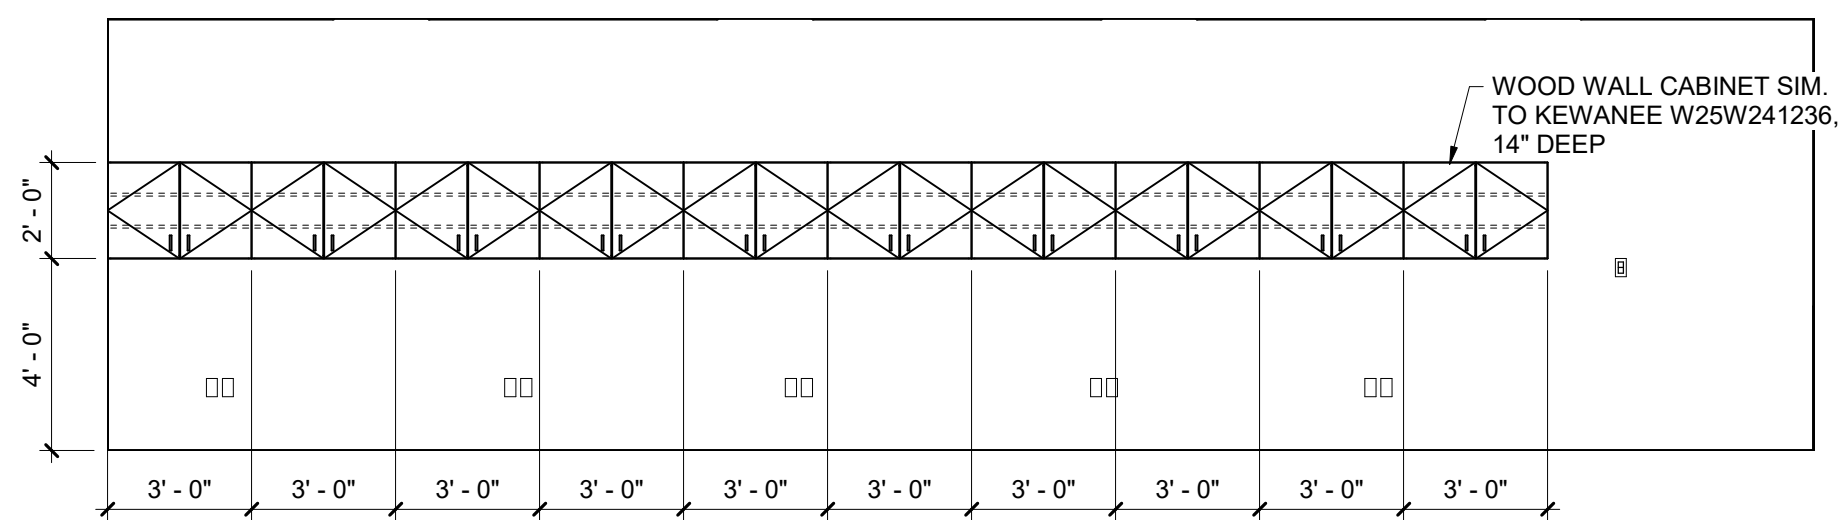


3 Elevation A122
1/4" = 1'-0"

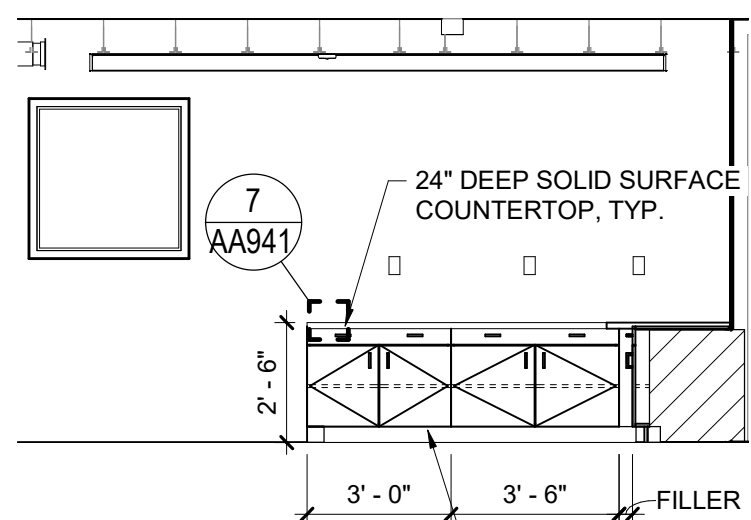


7 Elevation 132.2
1/4" = 1'-0"

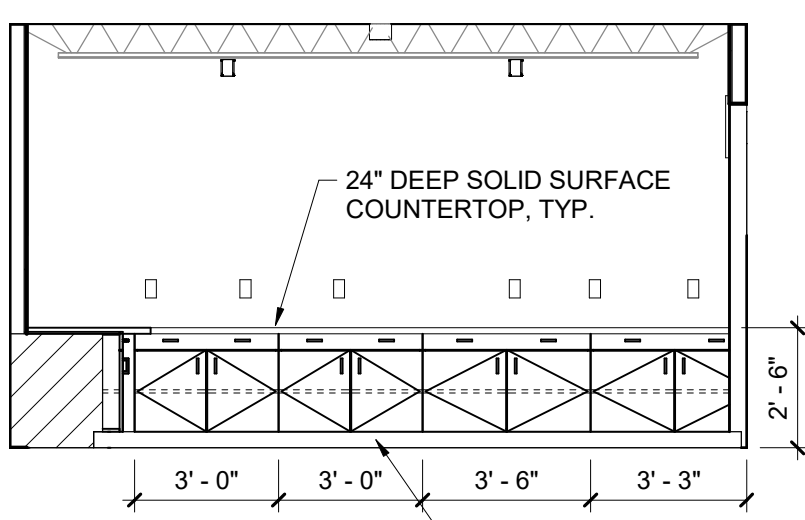


6 Elevation 132.2
1/4" = 1'-0"

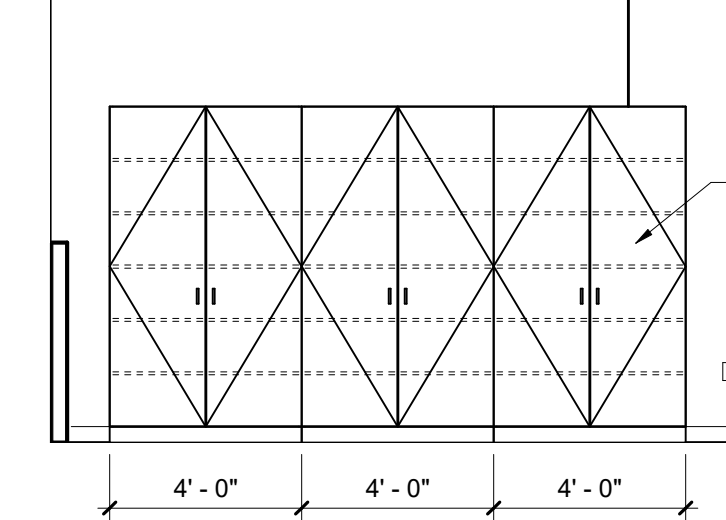

5 Elevation 123B
1/4" = 1'-0"

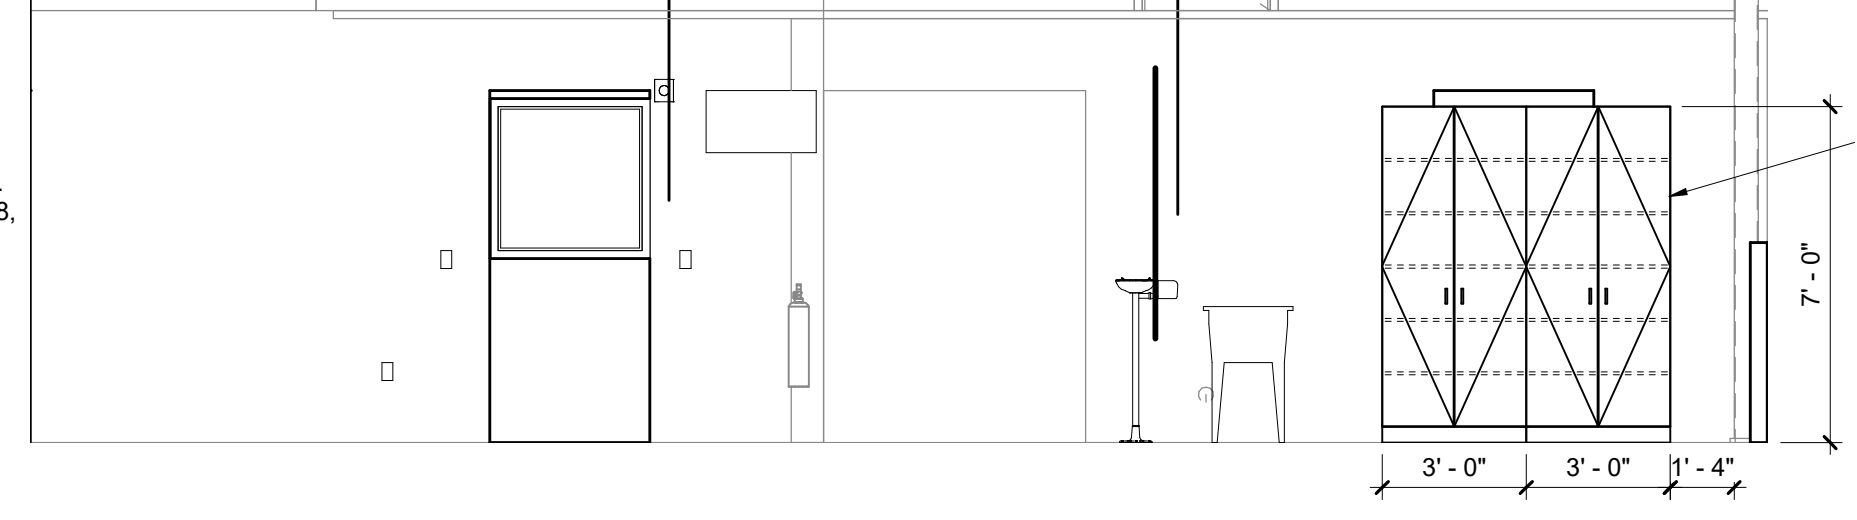


4 Elevation 123B
1/4" = 1'-0"

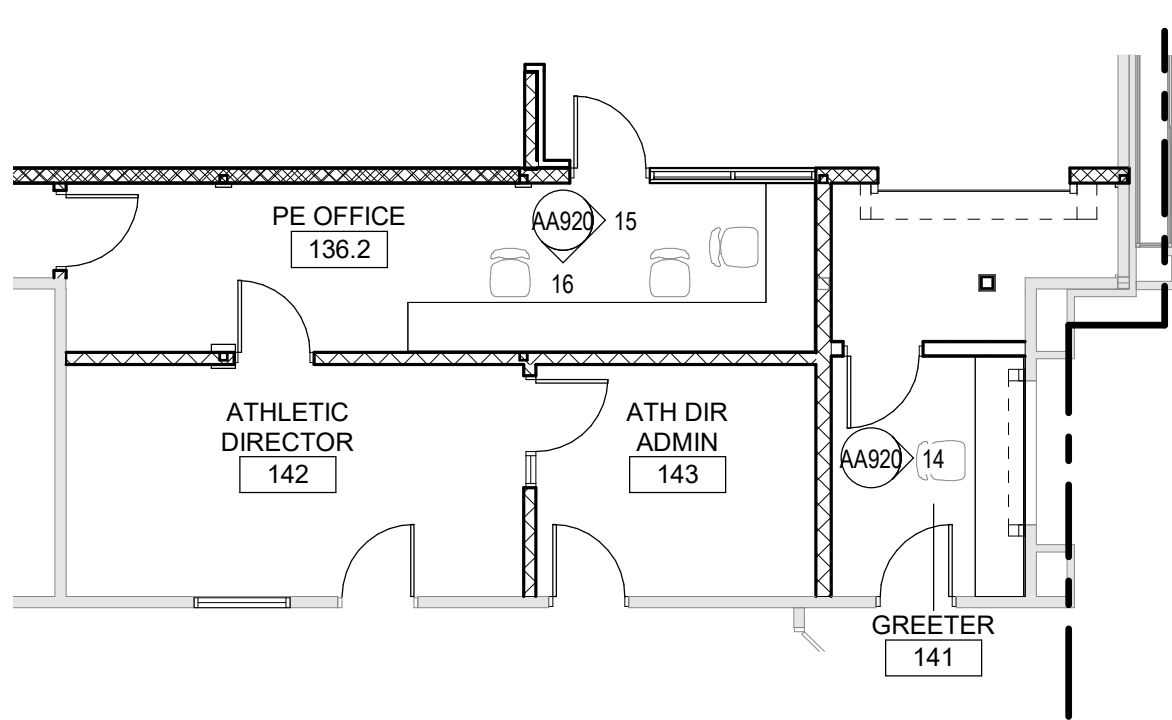

13 Enlarged Plan - Room 136.2 and 141
1/8" = 1'-0"

RE-INSTALLED PLASTIC LAMINATE COUNTERTOP WITH 3MM EDGE CUT ON THE WALL SIDE TO RETAIN FINISHED EDGE ADJACENT TO THE NEW UV

NEW PLASTIC LAMINATE BASE CABINET SIM. TO TMI SYSTEMS B1390 SHELVEING - MODIFY AS REQUIRED DEPENDING ON LOCATION. VIF ALL LOCATIONS PRIOR TO SHOP DRAWING SUBMITTAL. NEW CASEWORK IS TYPICALLY INSTALLED PARTIALLY OVER ASBESTOS CONTAINING FLOOR TILE. PERFORM UV REMOVALS CAREFULLY SO AS NOT TO DISTURB ASBESTOS TILE TO REMAIN.

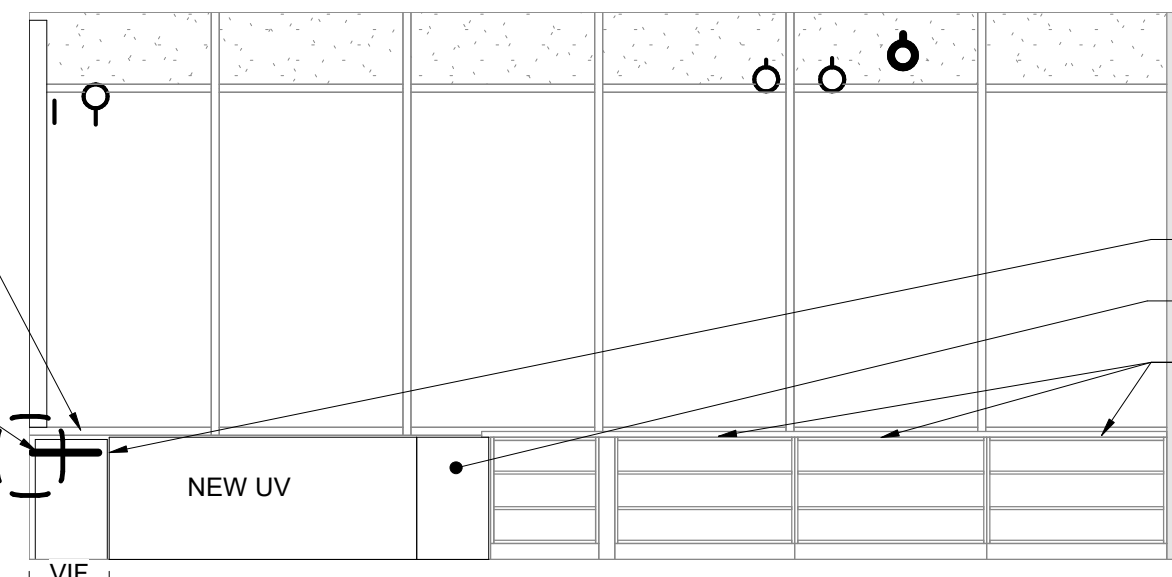


12 Typical UV Elevation
1/4" = 1'-0"


MECHANICAL PIPE SPACE

UV CONTROL BOX


EXISTING BASE CABINETS AND COUNTERTOP TO REMAIN

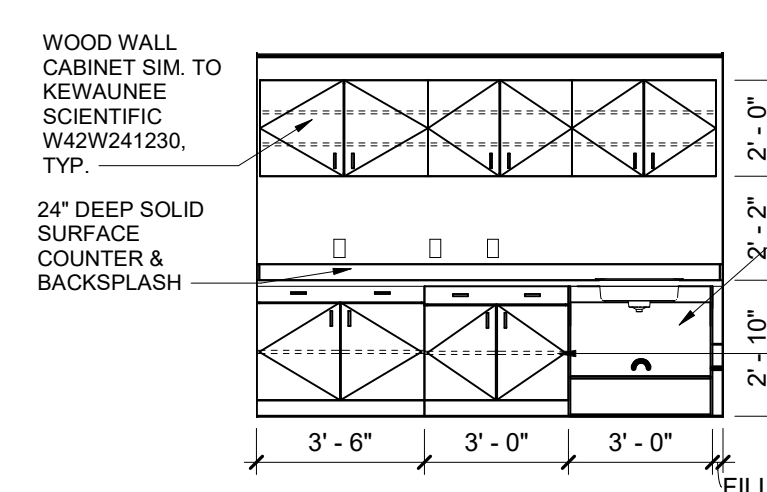


11 Elevation 250
1/4" = 1'-0"

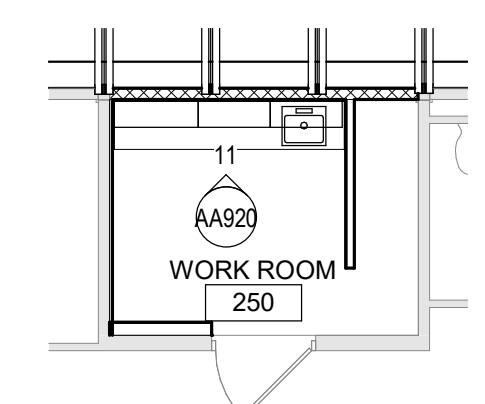


10 Enlarged Plan -Work Room 250
1/8" = 1'-0"

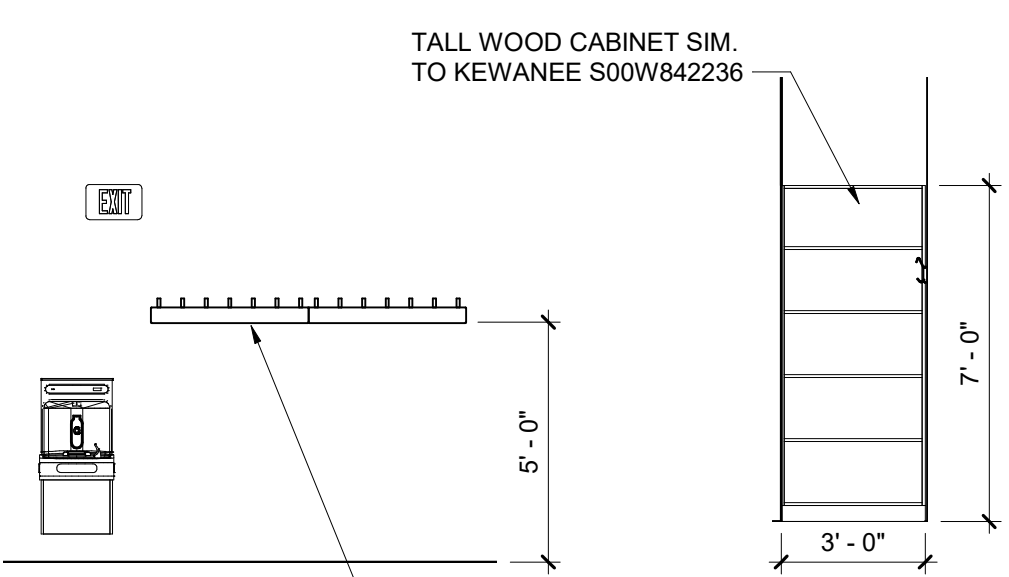


21 Elevation
1/4" = 1'-0"

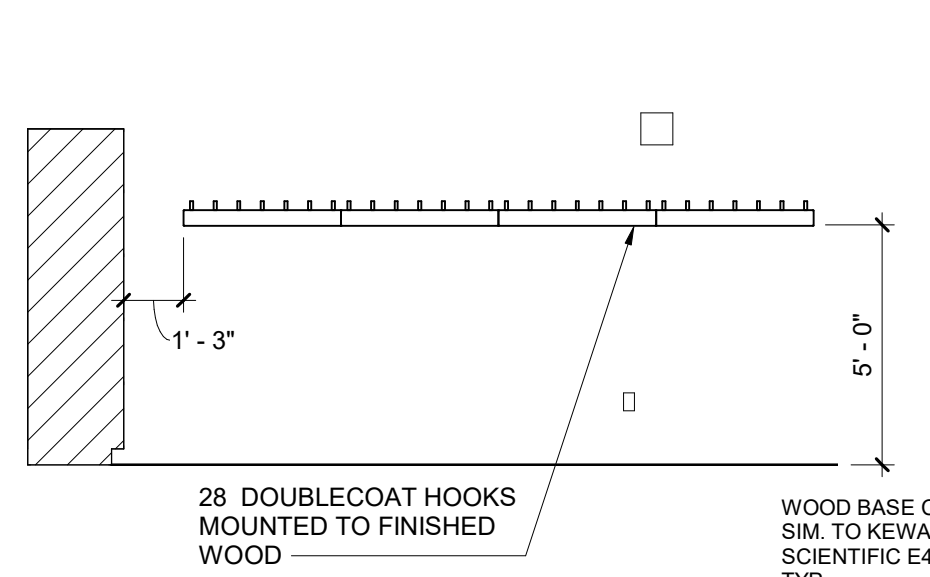


20 Elevation
1/4" = 1'-0"

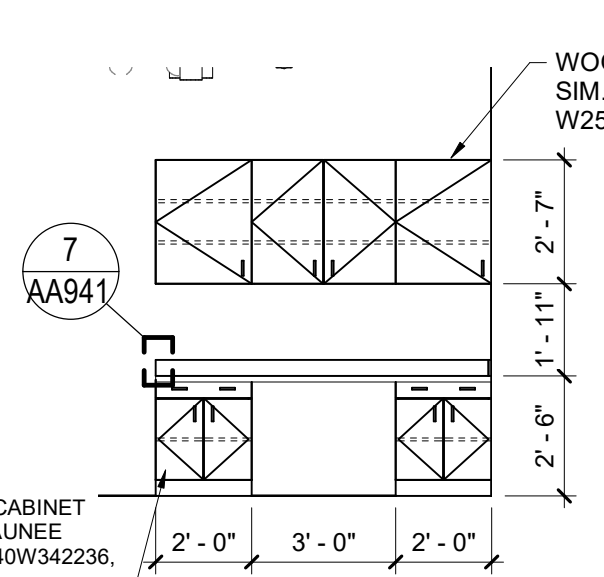


18 Elevation 195.4
1/4" = 1'-0"

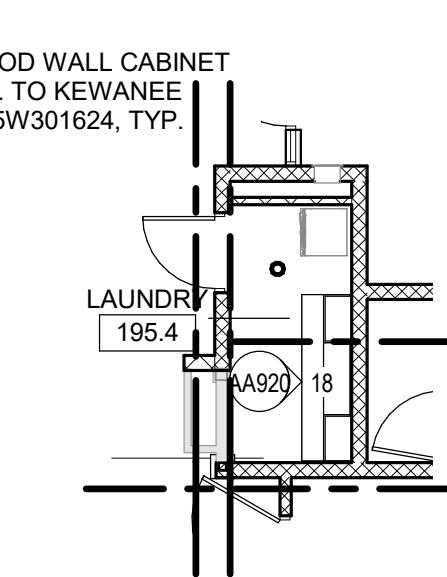


17 First Floor Plan Area B
1/8" = 1'-0"

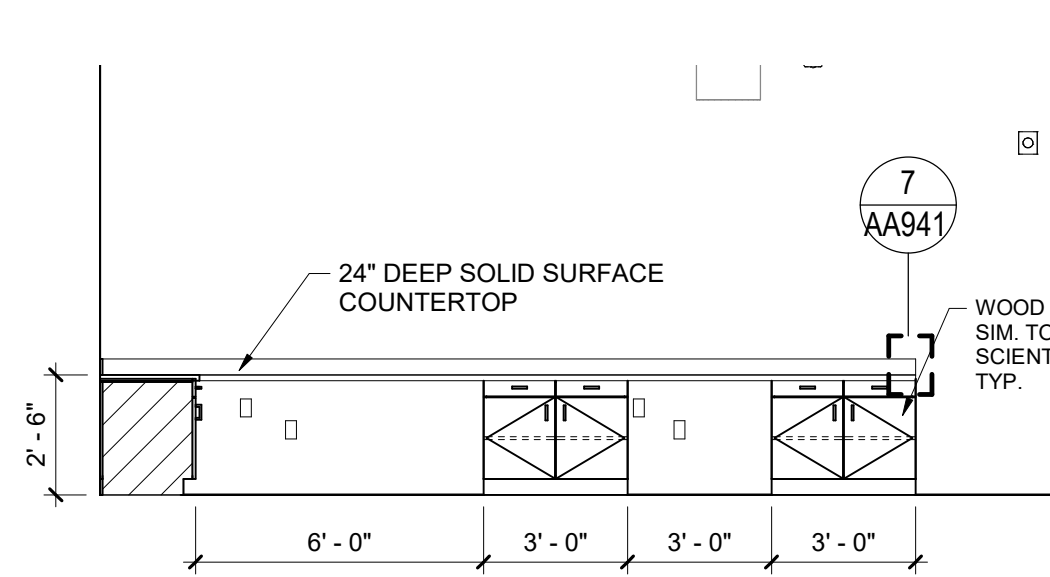

16 Elevation 136.2
1/4" = 1'-0"

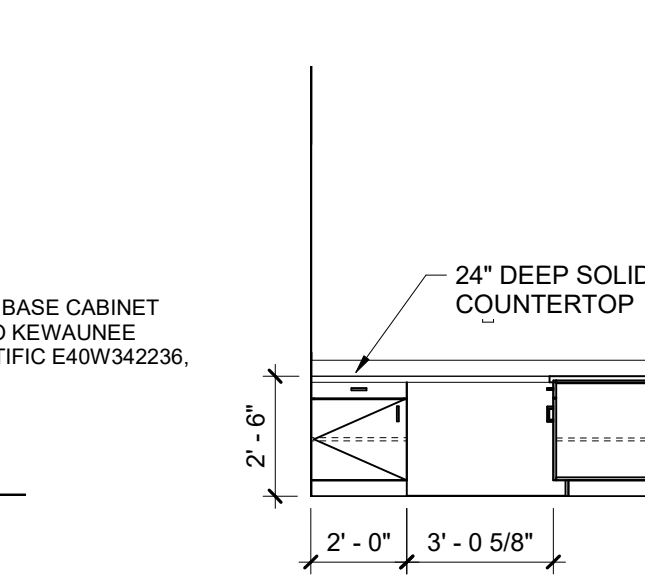


15 Elevation 136.2
1/4" = 1'-0"

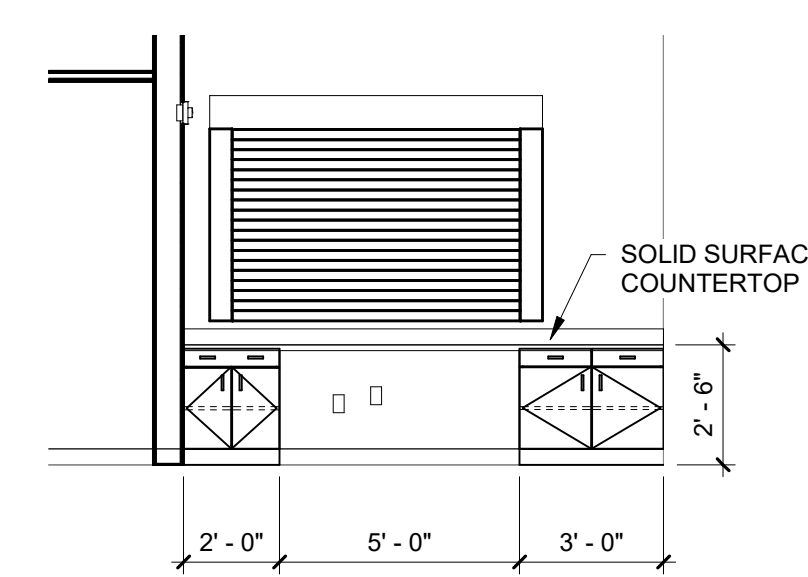


14 Elevation 141
1/4" = 1'-0"

1 First Floor Enlarged Plan Parial Area A
1/8" = 1'-0"

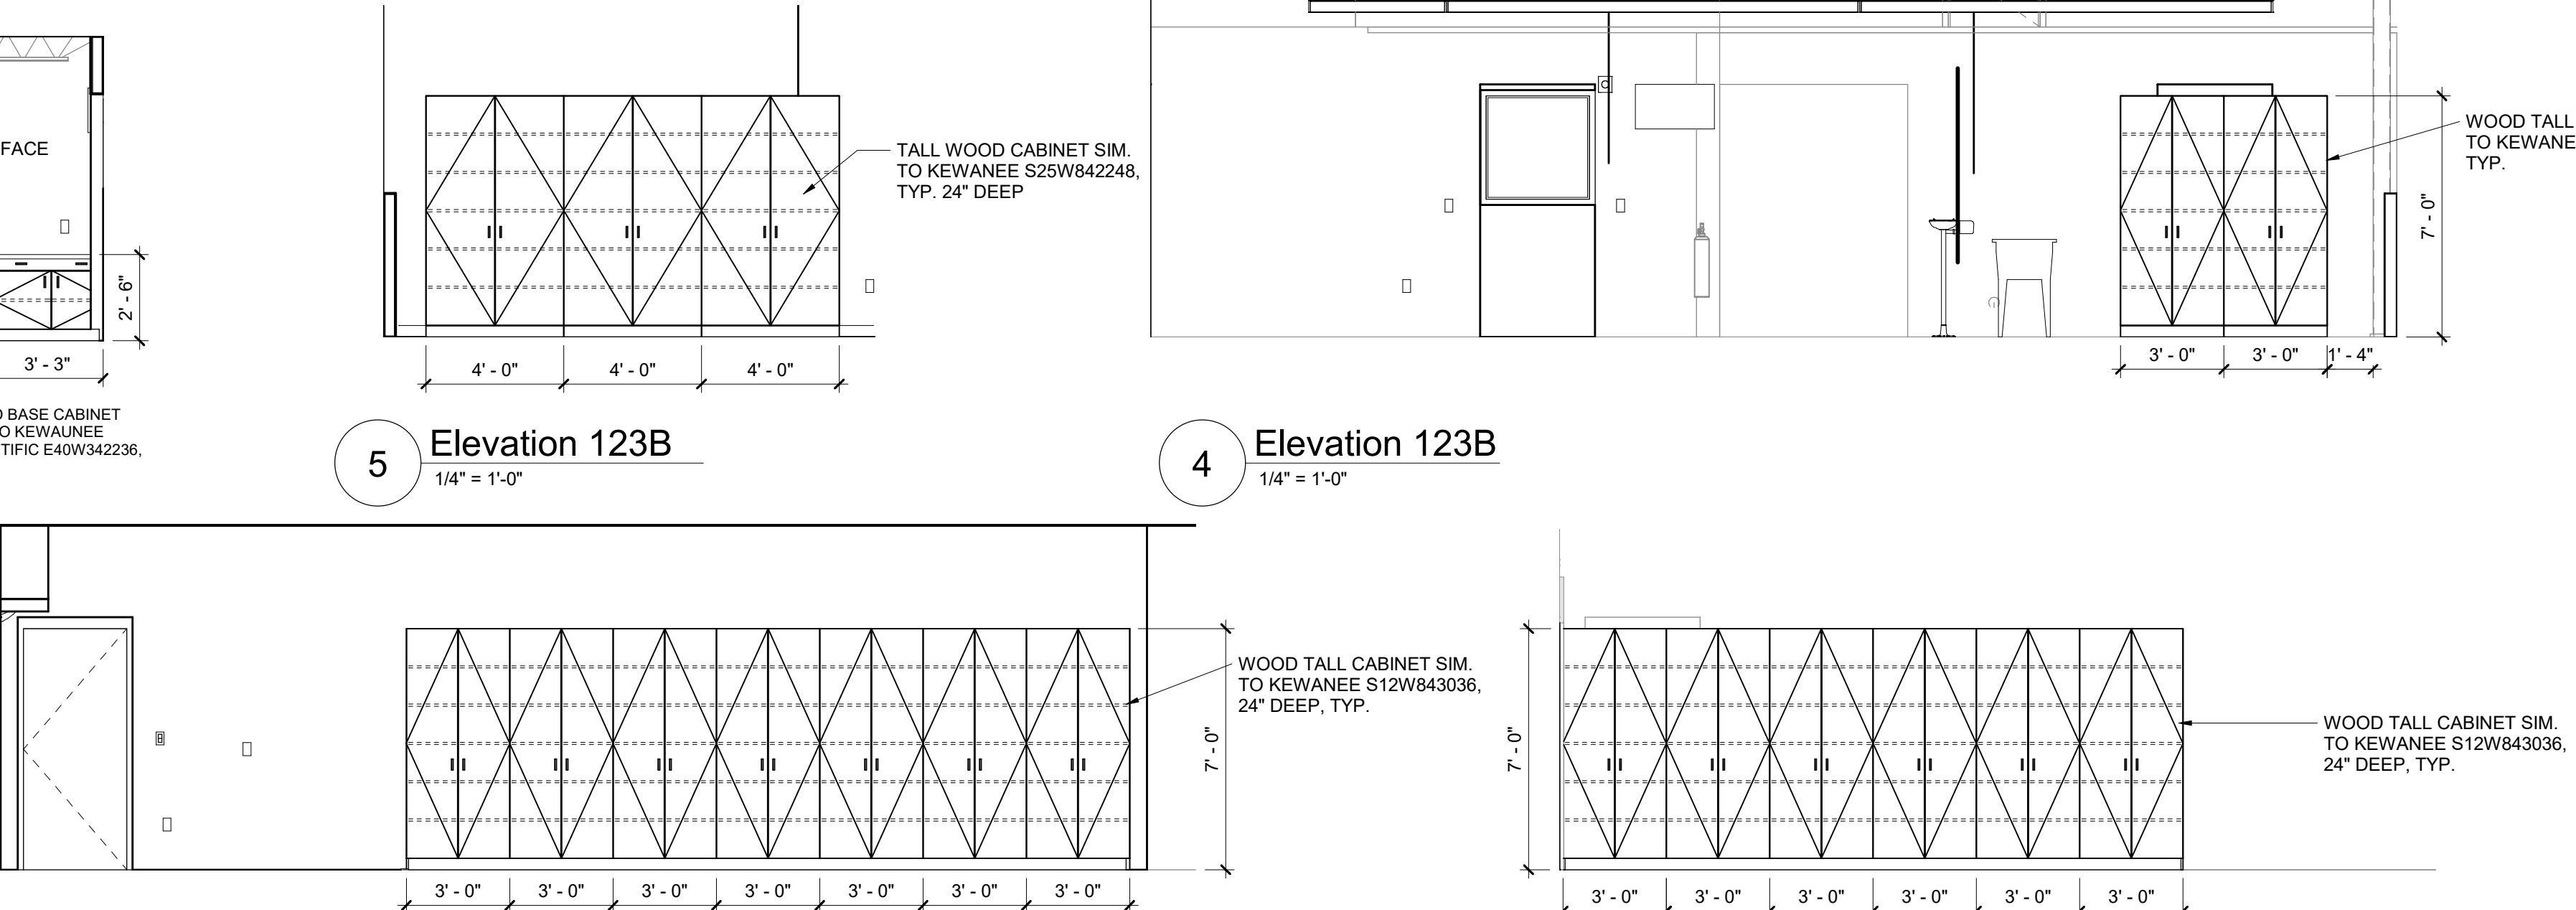


9 Elevation 123C
1/4" = 1'-0"

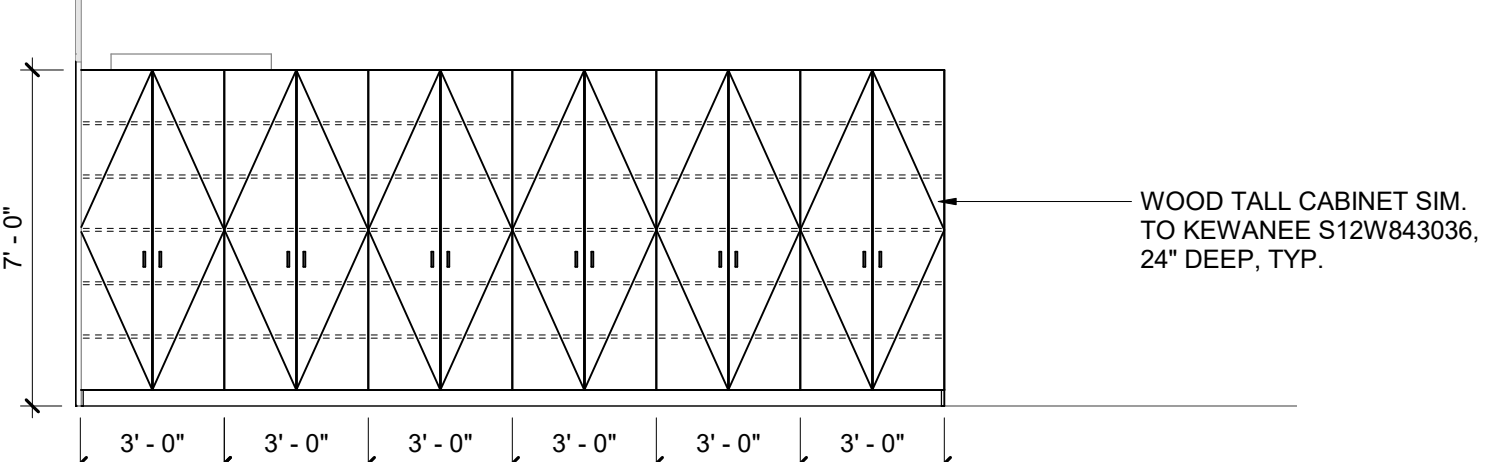

8 Elevation 123B
1/4" = 1'-0"

General Wood Casework Notes

- FOR ALL CONTRACTOR RESPONSIBILITIES REFER TO SPECIFICATION SECTION 01 10 00/01 12 00
- A. THE CASEWORK SHOWN ON THE DRAWINGS IS BASED ON KEWANEES WOOD CASEWORK. REFER TO THE PROJECT MANUAL, SECTION 12 32 13 FOR DETAILED SPECIFICATIONS.
- B. ALL STANDARD CASEWORK DIMENSIONS TO BE MODIFIED TO CORRESPOND WITH THE DIMENSIONS NOTED ON THE DRAWINGS. FIELD VERIFY ALL DIMENSIONS PRIOR TO FABRICATION OF CABINETS.
- C. MODEL NUMBERS LISTED ON DRAWINGS APPLY TO ELEVATIONS SHOWN. PROVIDE OPPOSITE HAND MODELS WHERE SHOWN.
- D. PROVIDE FULL DEPTH SHELVES AT BASE, WALL AND TALL CABINETS, UNLESS NOTED OTHERWISE.
- E. BASE AND TALL CABINETS ARE 24 INCHES DEEP. UNO WALL CABINETS ARE 14 INCHES DEEP. UNO BASE CABINET DEPTH DOES NOT INCLUDE 1" COUNTERTOP OVERHANG, TYP.
- F. PROVIDE FINISHED ENDS, BACK EXTENSIONS, SCRIBES AND FINISHED FILLER PANELS ON ALL CABINETS. FILLER PANELS ARE NOT TO EXCEED 3' WIDE, UNLESS NOTED OTHERWISE. PROVIDE TOP AND BOTTOM FILLER PANELS AT ALL BASE & WALL UNITS. SUBMIT SHOP DRAWINGS SHOWING DETAILS OF THESE CONDITIONS.
- G. ALL COUNTERTOPS TO BE SOLID SURFACE, TYP.
- H. PROVIDE COUNTERTOP CUT-OUTS FOR SINKS, COORDINATE WITH ALL REQUIRED CONTRACTORS.
- I. PROVIDE CUTS AT ALL CONDITIONS THAT INTERFERE WITH COUNTERTOPS/CABINETS. SCRIBE TO FIT.
- J. PROVIDE AT ALL UV SHELVING LOCATIONS-REMOVABLE BACKS IN CABINETS AT PLUMBING AND FIN TUBE VALVE LOCATIONS. VERIFY POSITIONS OF VALVES PRIOR TO SHOP FABRICATION OF ALL CABINETS.
- K. PROVIDE SHOP DRAWINGS SHOWING LOCATIONS AND DETAILS FOR ALL GRILLES, LOUVERS, REMOVABLE PANELS, VALVE LOCATIONS ETC. ASSOCIATED WITH CASEWORK COORDINATE WITH ALL REQUIRED CONTRACTORS.
- L. PROVIDE CABINETS WITH FINISHED SIDES, INCLUDING BUT NOT LIMITED TO, LOCATIONS OF ADJACENT CABINETS OR EQUIPMENT WITH A DEPTH LESS THAN CABINET OR EQUIPMENT.
- M. PROVIDE ALL STANDARD FEATURES OF CASEWORK UNITS AS INDICATED BY MODEL NUMBER OR AS SHOWN ON PLANS, DETAILS AND ELEVATIONS, INCLUDED BUT NOT LIMITED TO: OUTLETS, SWITCHES, LIGHTS ETC.
- N. PROVIDE BLOCKING AT NEW AND EXISTING GYPSUM BOARD WALLS PER MANUFACTURER RECOMMENDATIONS FOR SUPPORT OF WALL/TALL MOUNTED UNITS. REFER TO SPECIFICATION SECTION 06 10 00 FOR WOOD BLOCKING RESPONSIBILITIES.
- O. PROVIDE LOCKS AT ALL CASEWORK DOORS/DRAWERS AND FILE UNITS TYP.
- P. PROVIDE AS NOTED ON DRAWINGS AND DETAILS: 2" GROMMETS AT OPEN BASE COUNTERS 30736" OC, WIRE MANAGEMENT, KEY BOARD TRAYS AND CABLE TRAYS.
- Q. PROVIDE ALL CUTOUTS AS SHOWN ON CASEWORK PLANS AND ELEVATIONS OR AS REQUIRED. CUTOUTS ARE TO INCLUDE BUT NOT LIMITED TO, ALL ELEC BOXES, OUTLETS, AND ASSOCIATED WIRING AND FINAL HOOK-UP.
- R. PROVIDE REMOVABLE BACK PANELS AT ALL SINK BASE CABINETS.
- S. REFER TO BOTH 1/8" AND 1/4" PLANS FOR LAYOUTS.

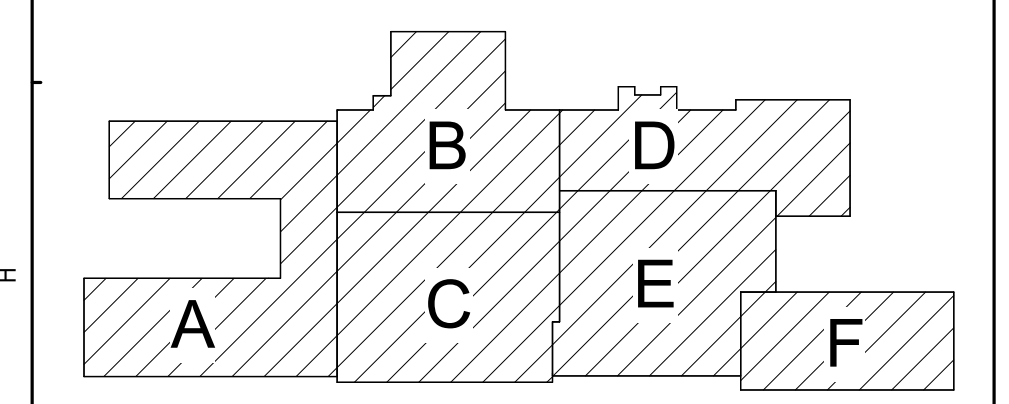

Key Plan
N.T.S.

SED Control No. 60-01-01-06-0-018-023

Rev. No.: Date: Description:



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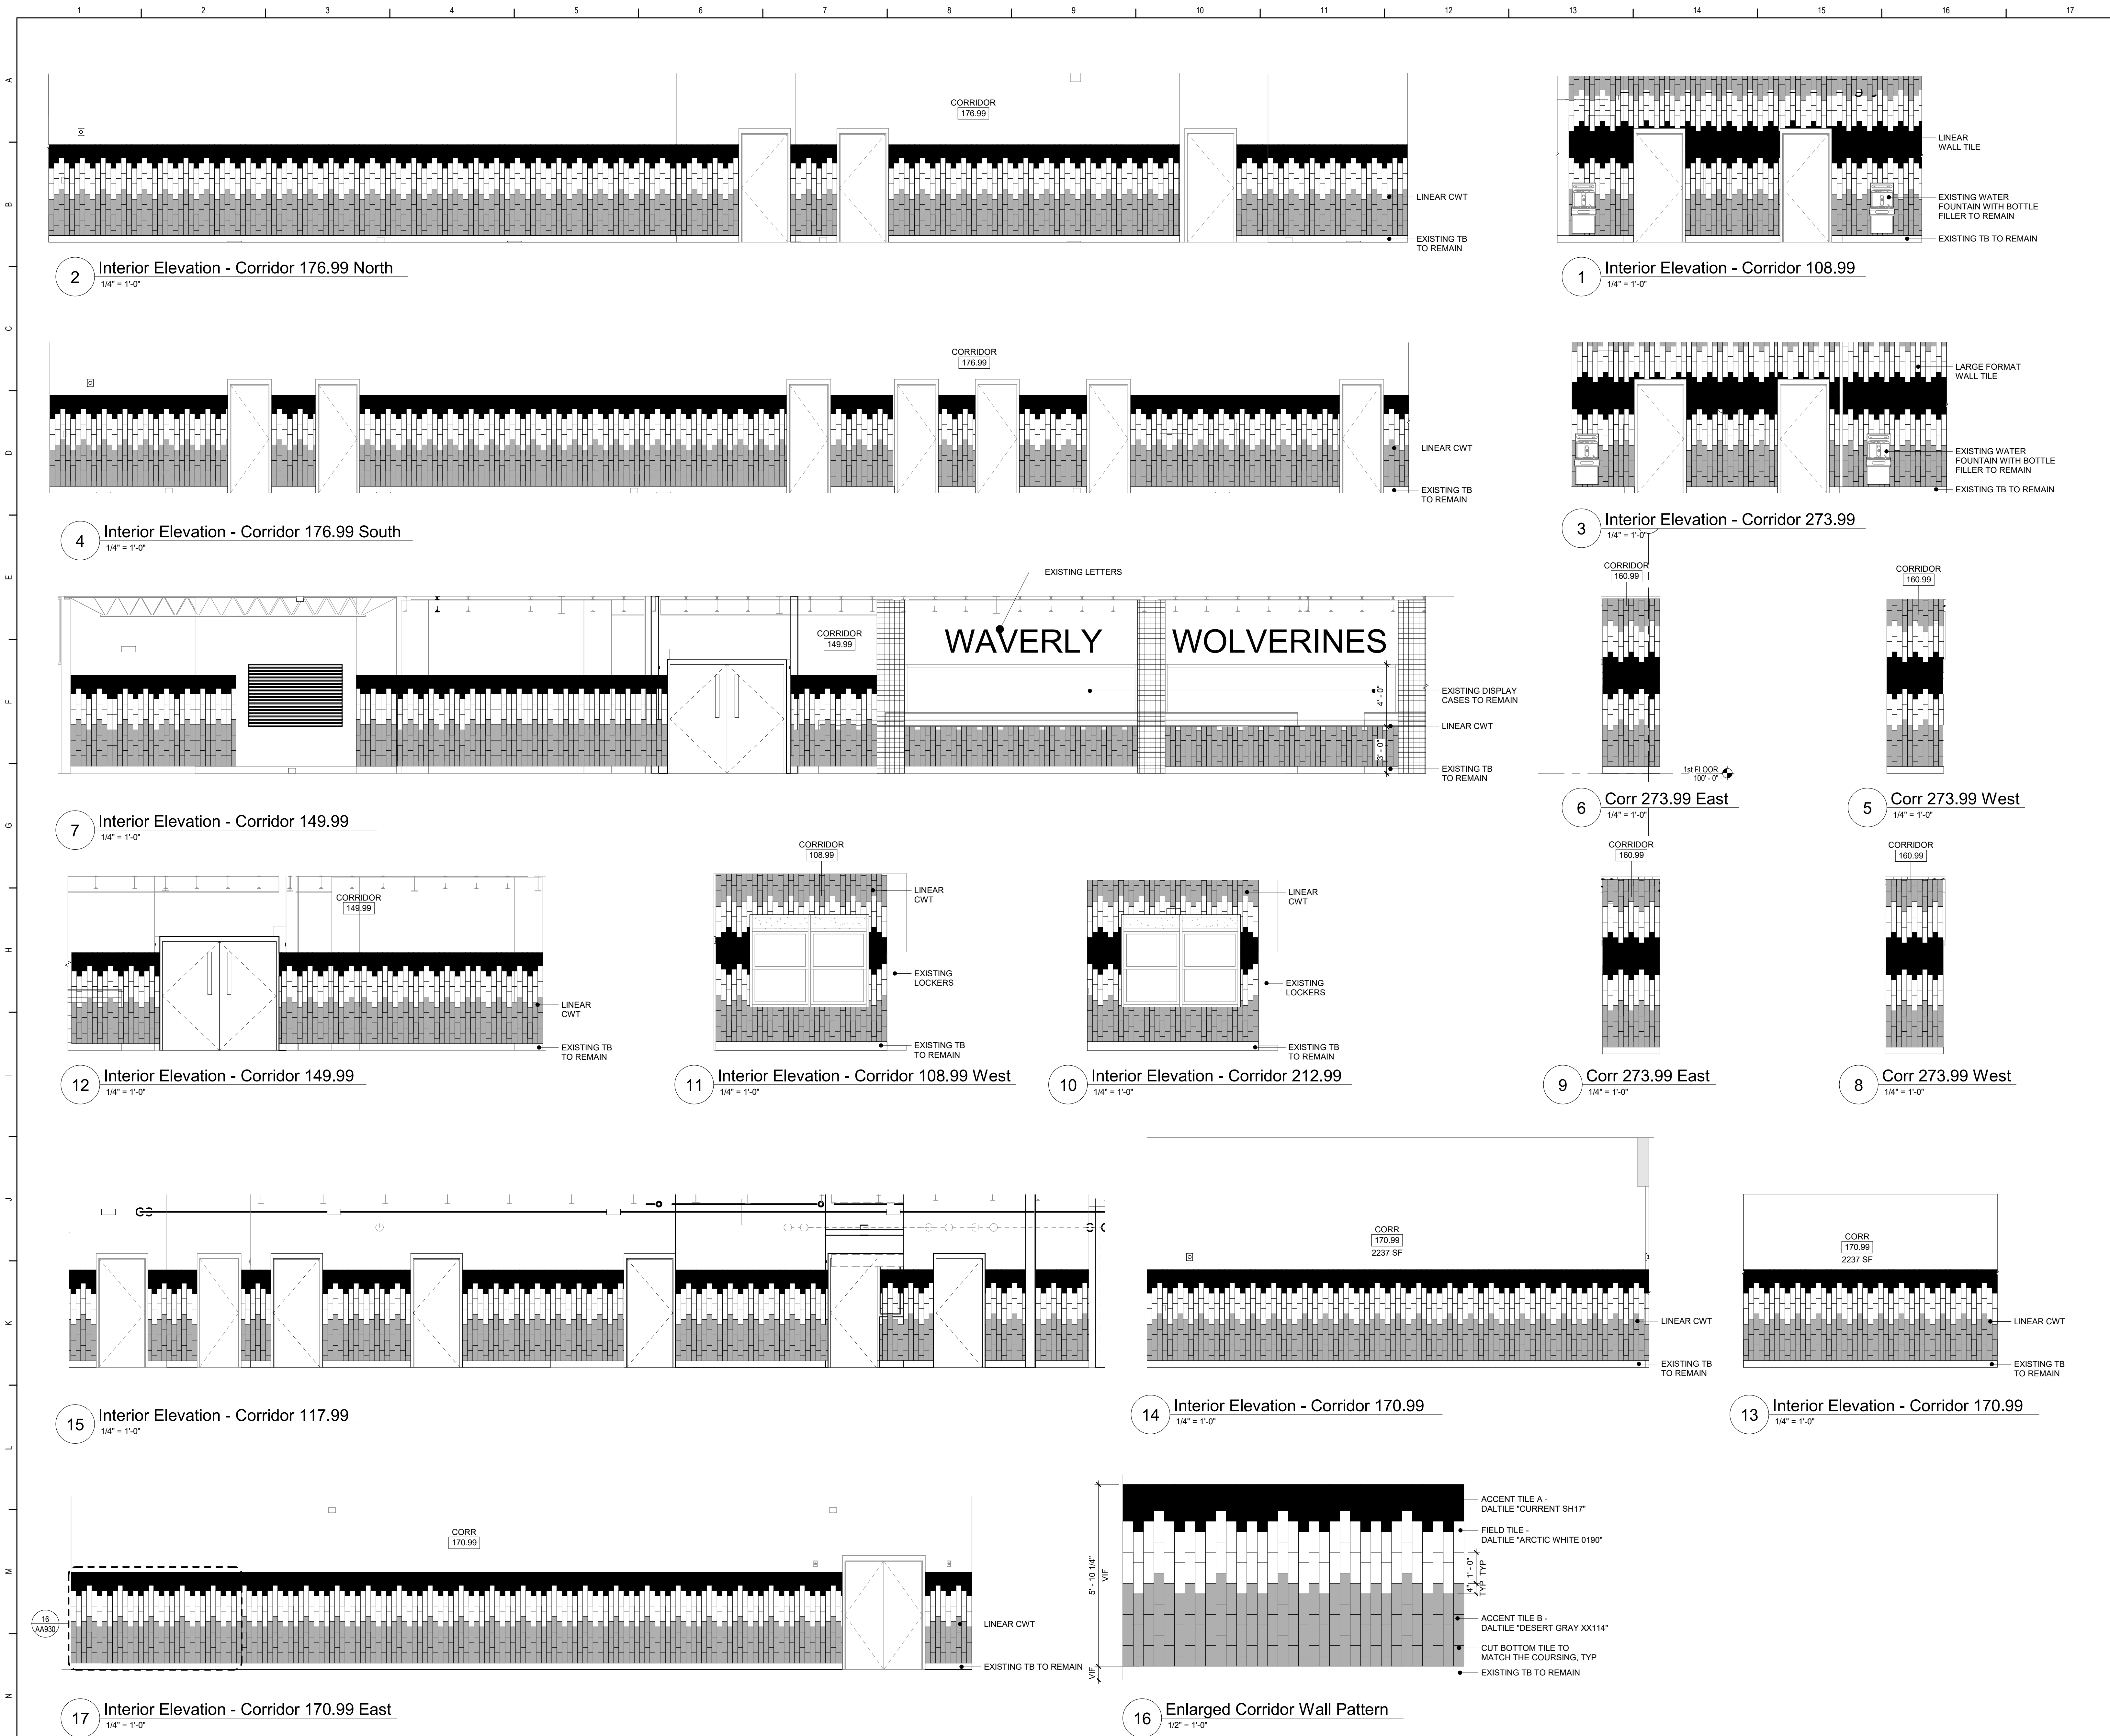


Waverly Central School District
Waverly, NY

Additions and Alterations to:
Waverly Jr. Sr. High School

Enlarged Plans and Elevations

Drawn By: TRS
Date: 05/19/2023
Project No.: 339070-22003
Drawing Number: AA920



Room Finish Key
C1 CARPET - TYPE 1
CFT1 CERAMIC FLOOR TILE - TYPE 1
CT CERAMIC TILE COVE BASE
CWT1 CERAMIC WALL TILE - TYPE 1
ES EXPOSED STRUCTURE
HPC HIGH PERFORMANCE COATING
LVT LUXURY VINYL TILE
MCS MOISTURE CONTROL SYSTEM
N NO WORK REQUIRED
P PAINT SURFACE(S) INCLUDING SOFFITS
PS PAINT EXPOSED STRUCTURE/DECK
RAF RESILIENT ATHLETIC FLOORING
RB RUBBER BASE
SC SEALED CONCRETE (PER SPEC. SECT. 03 30 00)
T1 TERRAZZO - TYPE 1 - POURED EPOXY
TB TERRAZZO BASE - PRECAST
VC1 VINYL COMPOSITION TILE - TYPE 1
WD1 WOOD FLOORING - GYM
* SEE REFLECTED CEILING PLAN
--- INDICATED CHANGE IN FLOOR FINISH
NOTE: ALL FINISHES LISTED MAY NOT BE REQUIRED FOR THIS PROJECT

RM#	
CLG*	WALL
FLR	BASE

Key Plan
N.T.S.

SED Control No. 60-01-01-06-0-018-023

Rev. No.:	Date:	Description:

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BID SET


Tetra Tech Engineers, Architects
& Landscape Architects, P.C.

Waverly Central School District
Waverly, NY

Additions and Alterations to:
Waverly Jr. Sr. High School

Elevations

Drawn By: TRS	Date: 05/19/2023	Drawing Number: AA930
Project No.: 339070-22003		

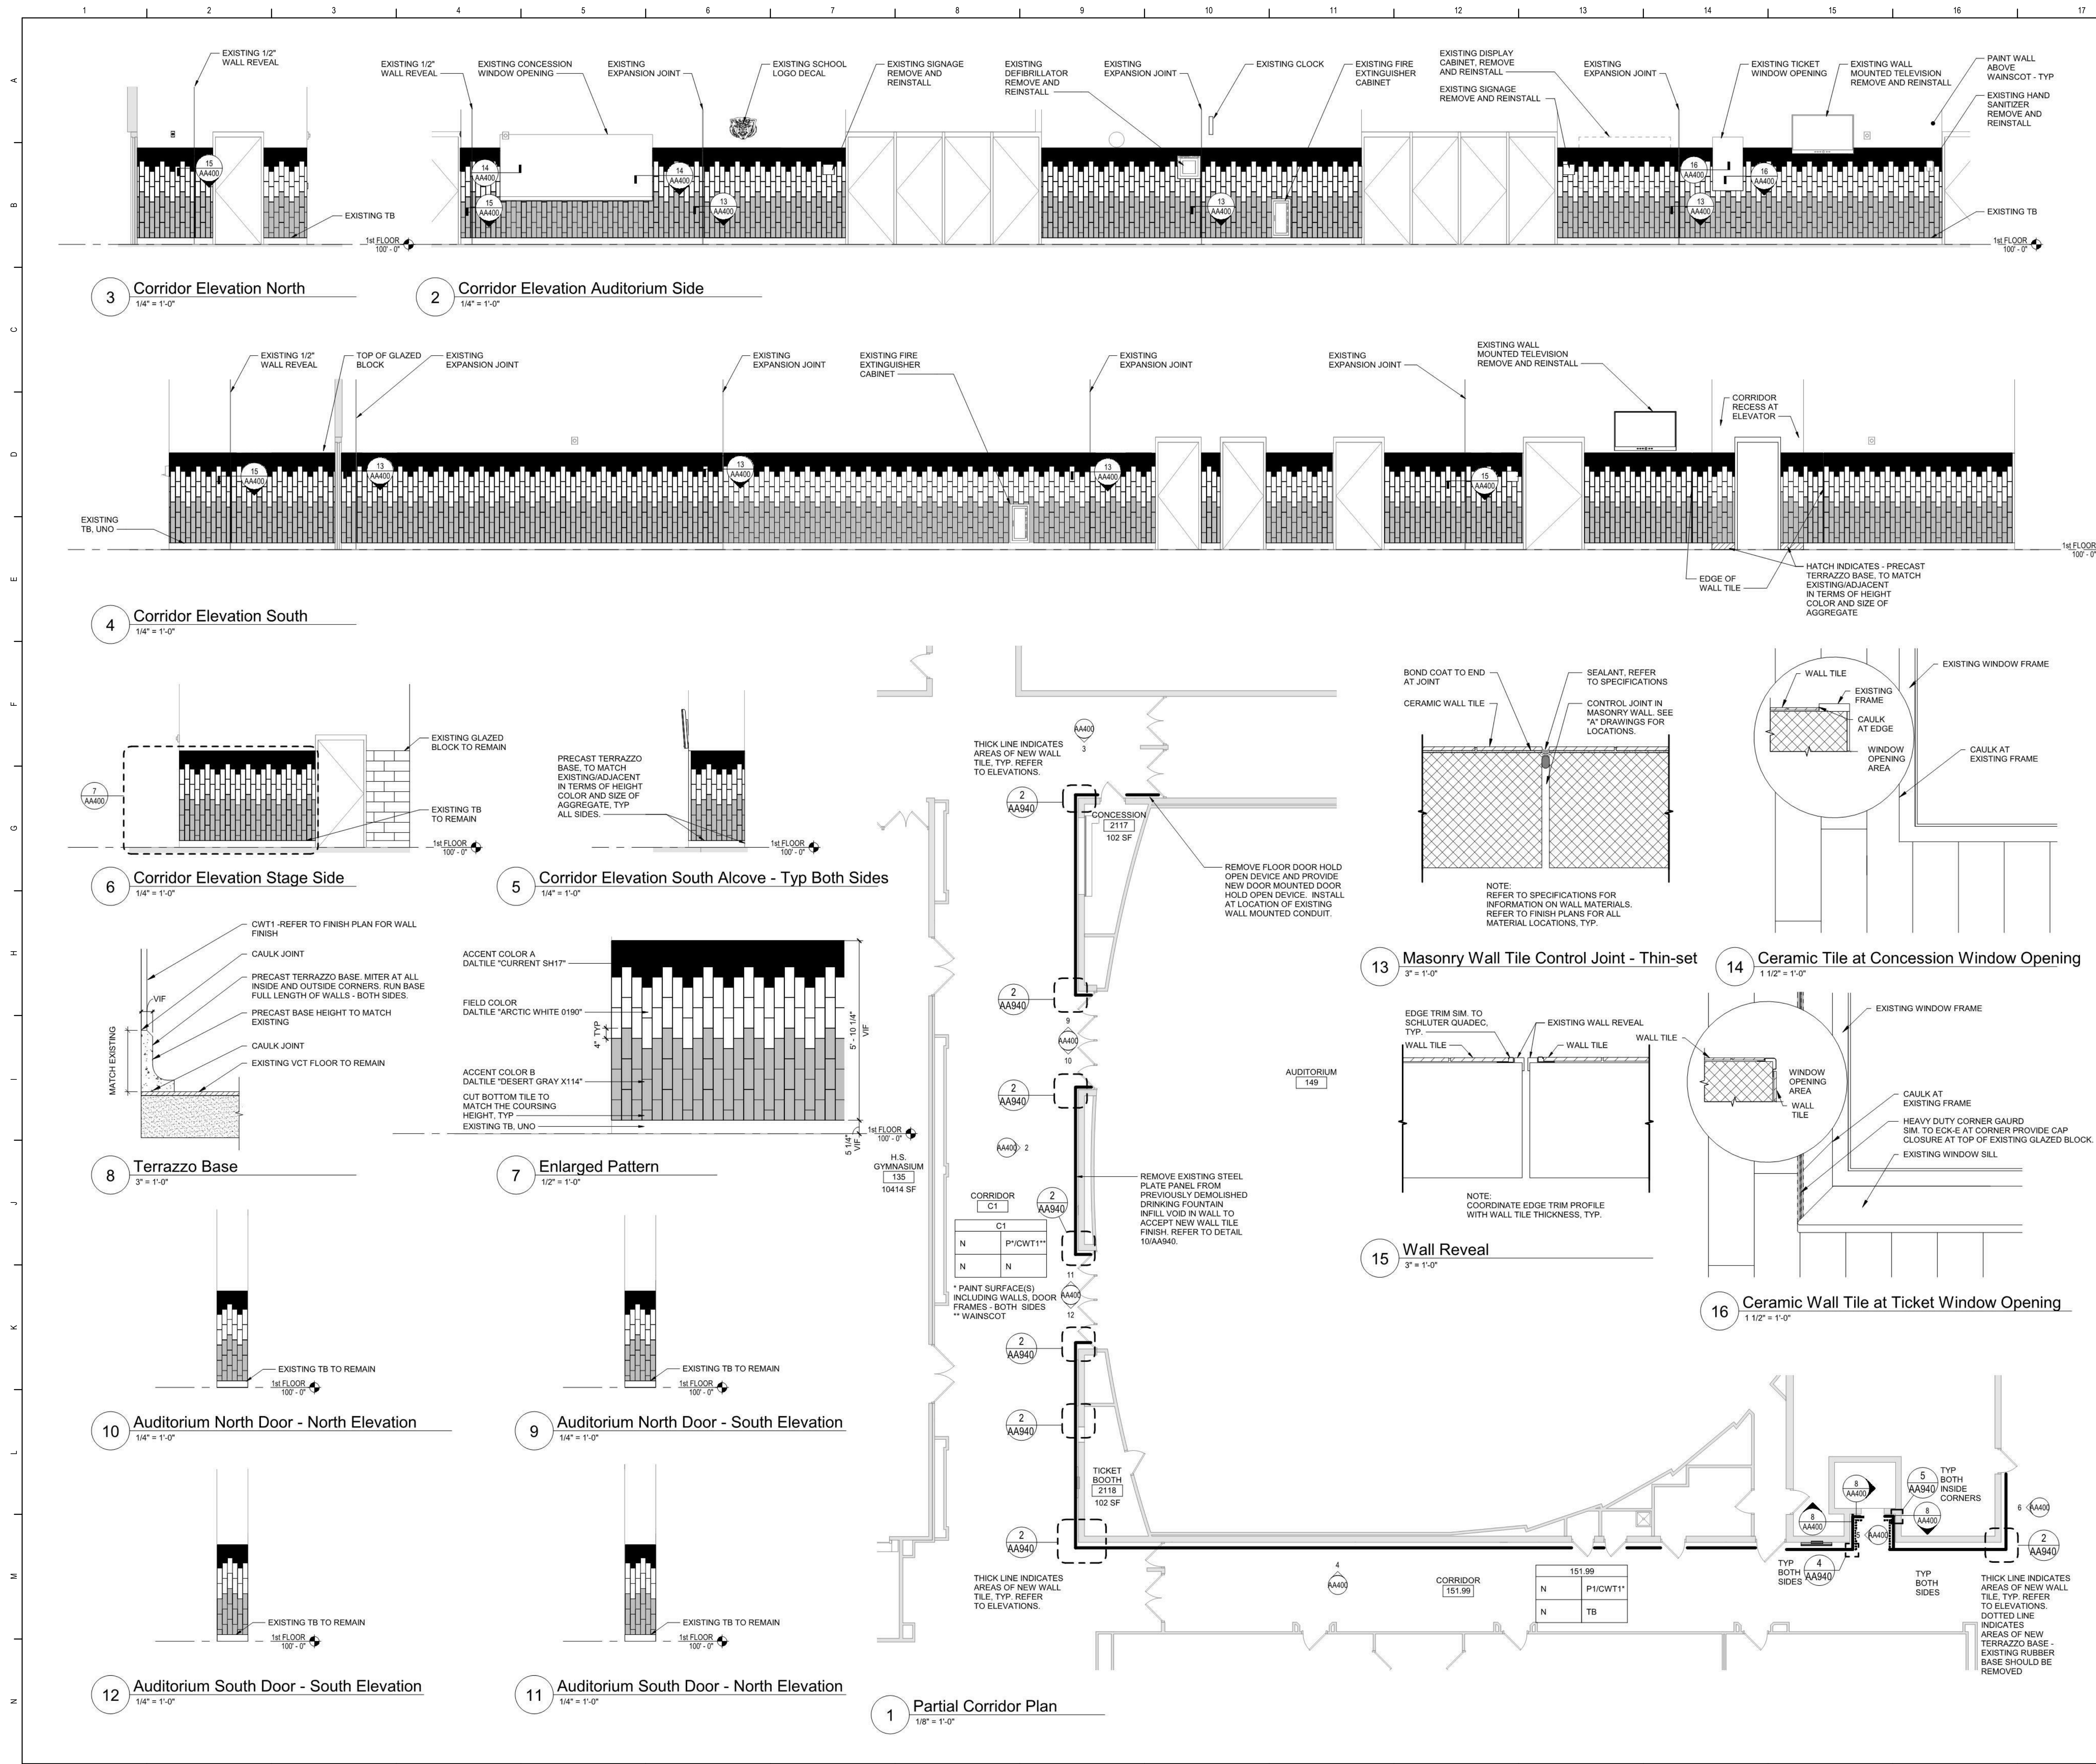

Room Finish Key

C1	CARPET - TYPE 1
CT	CERAMIC FLOOR TILE - TYPE 1
CTT	CERAMIC TILE COVE BASE
CWT1	CERAMIC WALL TILE - TYPE 1
ES	EXPOSED STRUCTURE
HPC	HIGH PERFORMANCE COATING
LVT	LUXURY VINYL TILE
MCS	MOISTURE CONTROL SYSTEM
N	NO WORK REQUIRED
P	PAINT SURFACE(S) INCLUDING SOFFITS
PS	PAINT EXPOSED STRUCTURE/DECK
RAF	RESILIENT ATHLETIC FLOORING
RB	RUBBER BASE
SC	SEALED CONCRETE (PER SPEC. SECT. 03 30 00)
T1	TERRAZZO - TYPE 1 - POURED EPOXY
TB	TERRAZZO BASE - PRECAST
VCB	VENTED COVE BASE
VCT1	VINYL COMPOSITION TILE - TYPE 1
WD1	WOOD FLOORING - GYM

SEE REFLECTED CEILING PLAN

INDICATED CHANGE IN FLOOR FINISH

NOTE: ALL FINISHES LISTED MAY NOT BE REQUIRED FOR THIS PROJECT

RMF	
CLG*	WALL
FLR	BASE

FINISHES SHOWN IN ROOM FINISH BOX ARE FOR ALL WALLS AND ENTIRE FLOOR AND CEILING. REFER TO EACH ROOM FOR MORE INFORMATION.

Key Plan
N.T.S.

SED Control No. 60-01-01-06-0-018-023

Rev. No.	Date	Description

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BID SET

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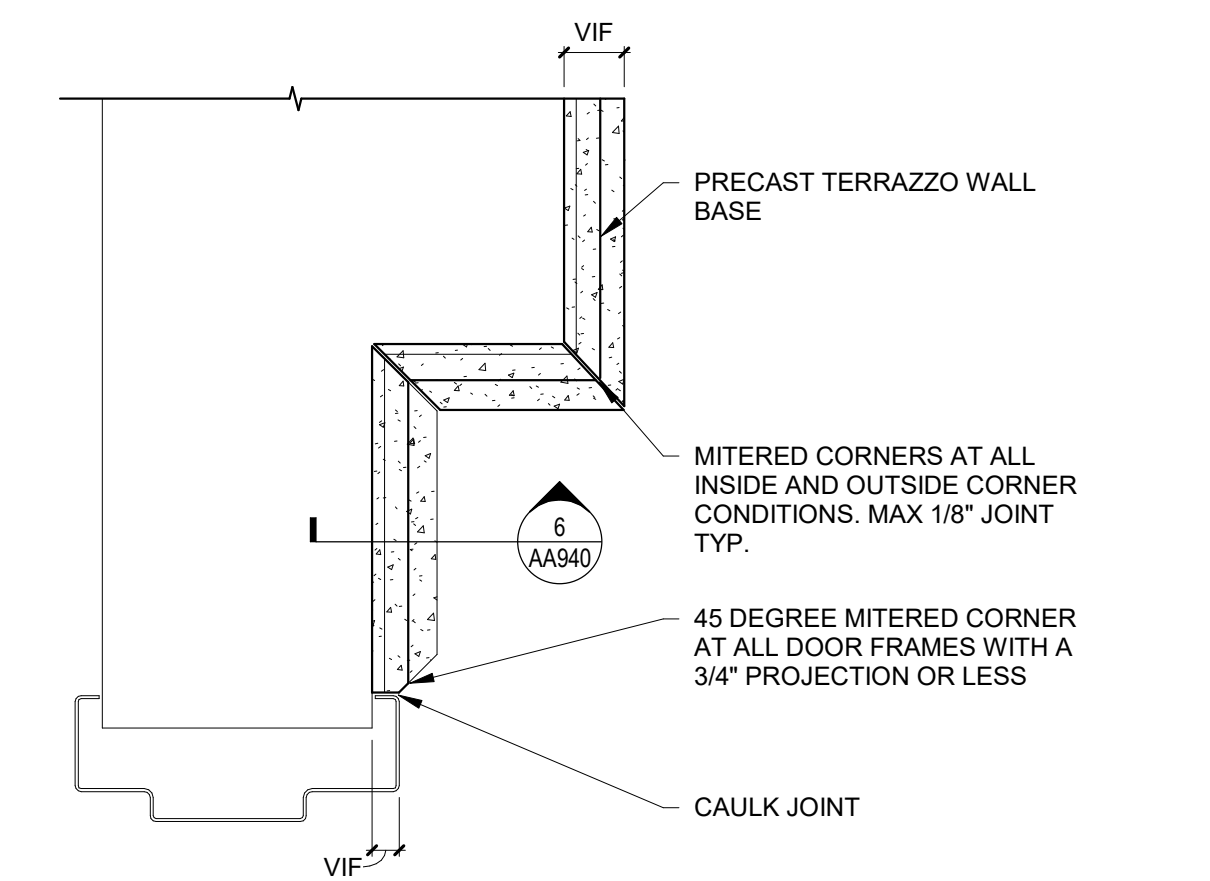
Waverly Central School District
Waverly, NY

Additions and Alterations to:
Waverly Jr. Sr. High School


Enlarged Plans and Elevations

Drawn By: TRS	Date: 05/19/2023	Drawing Number:
Project No.: 339070-22003		AA931


4 Square Outside Corner Detail
3" = 1'-0"




3 Masonry Wall Tile Control Joint - Thin-set
3" = 1'-0"

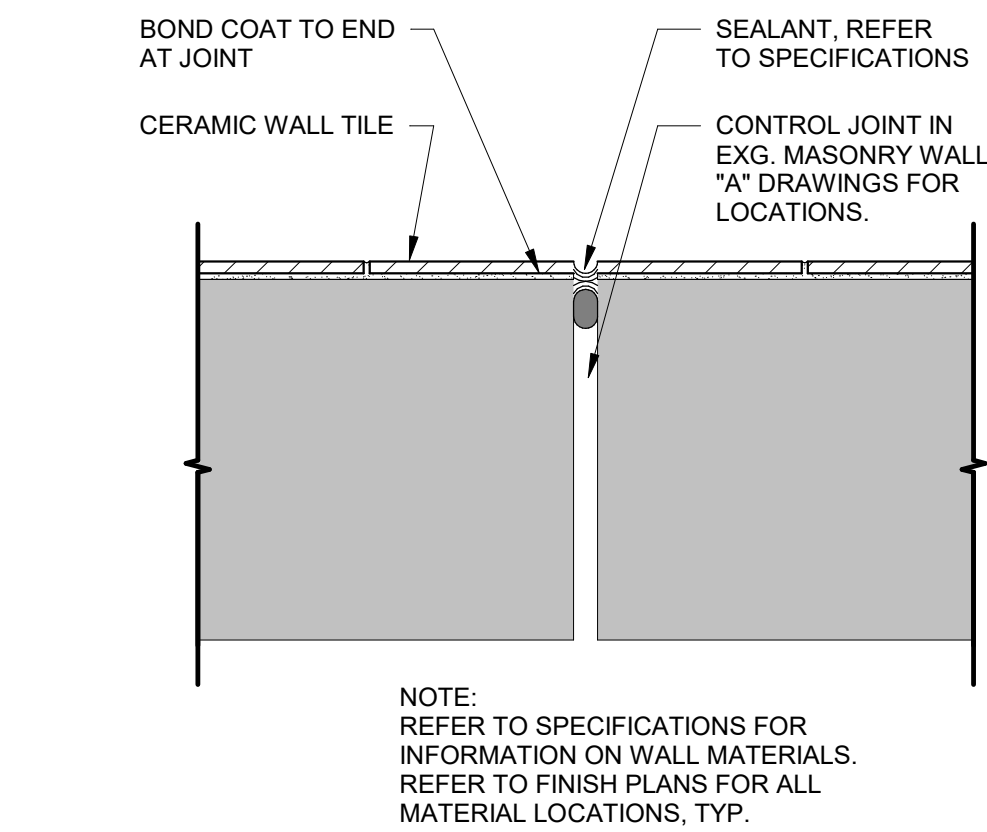


2 Corner Guard
3" = 1'-0"

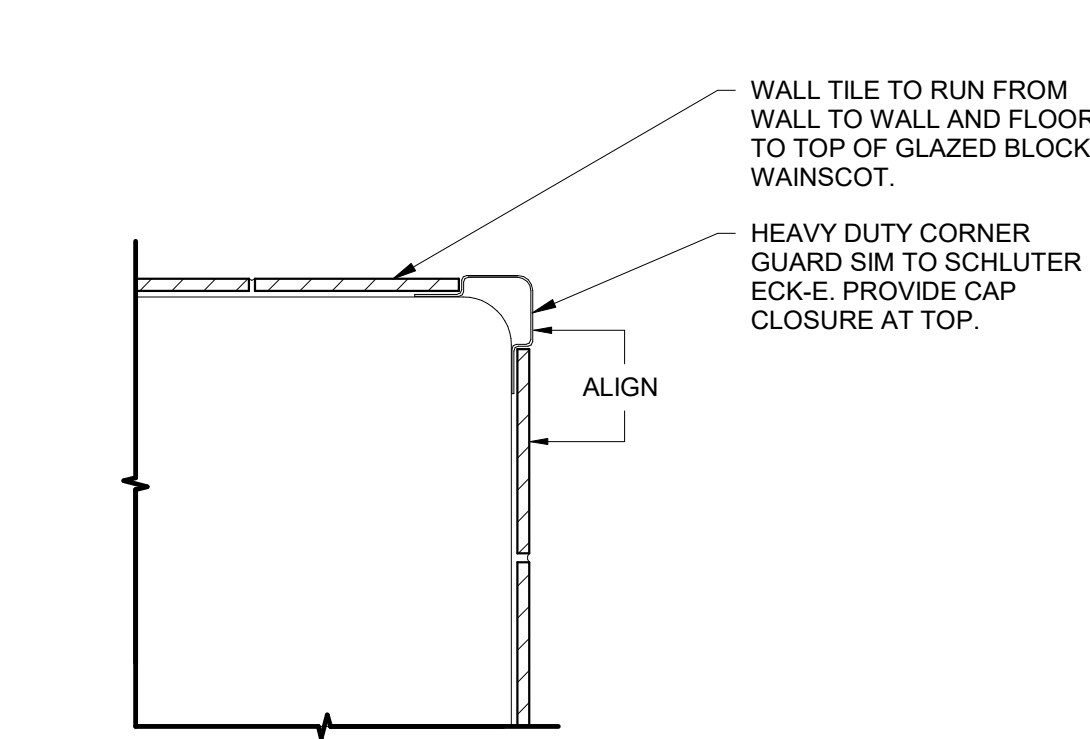


1 Ceramic Wall Tile at Window Opening
1 1/2" = 1'-0"

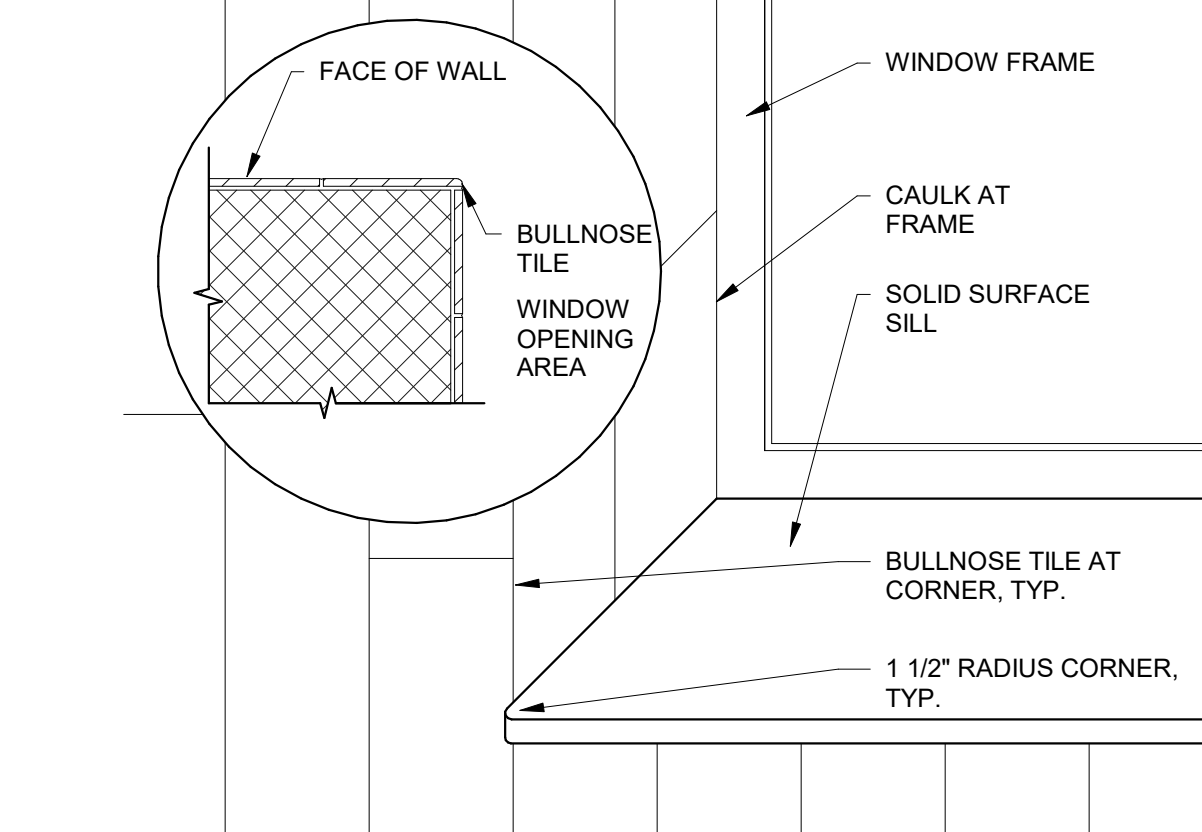


8 Terrazzo Base w/ Mitered Corner
3" = 1'-0"

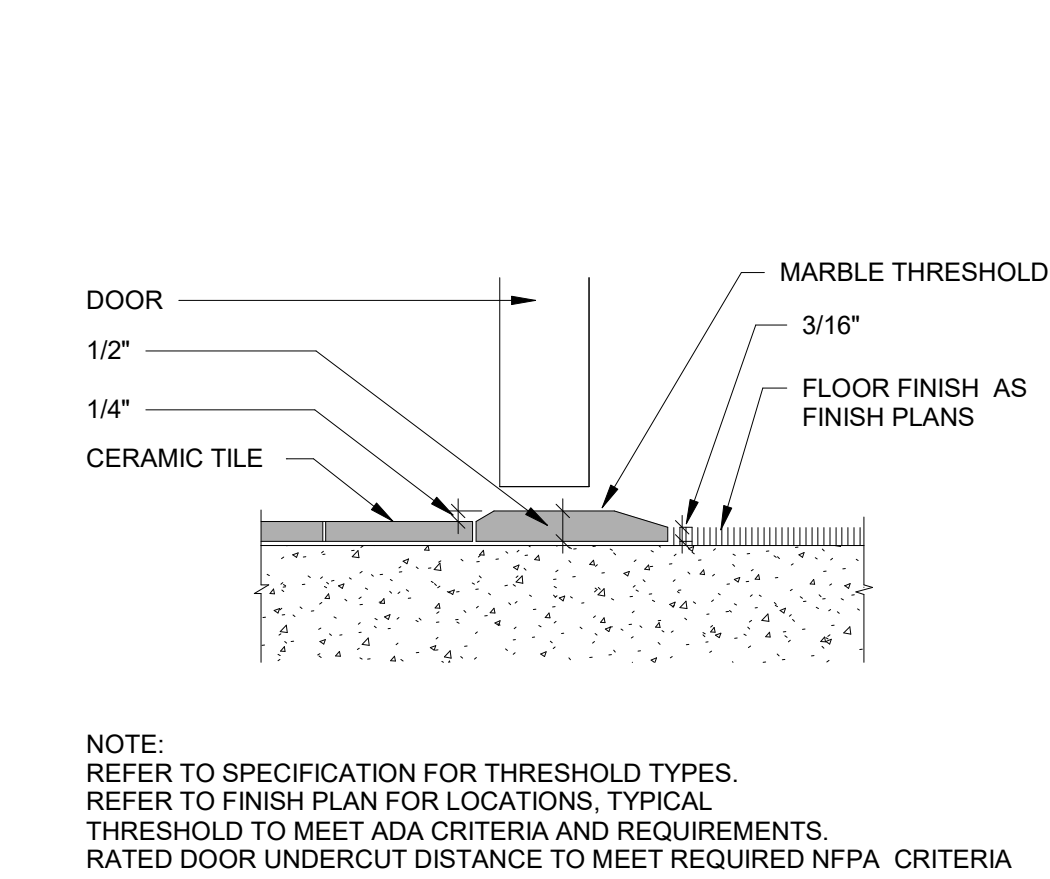


7 Terrazzo Base at HM Frame
3" = 1'-0"

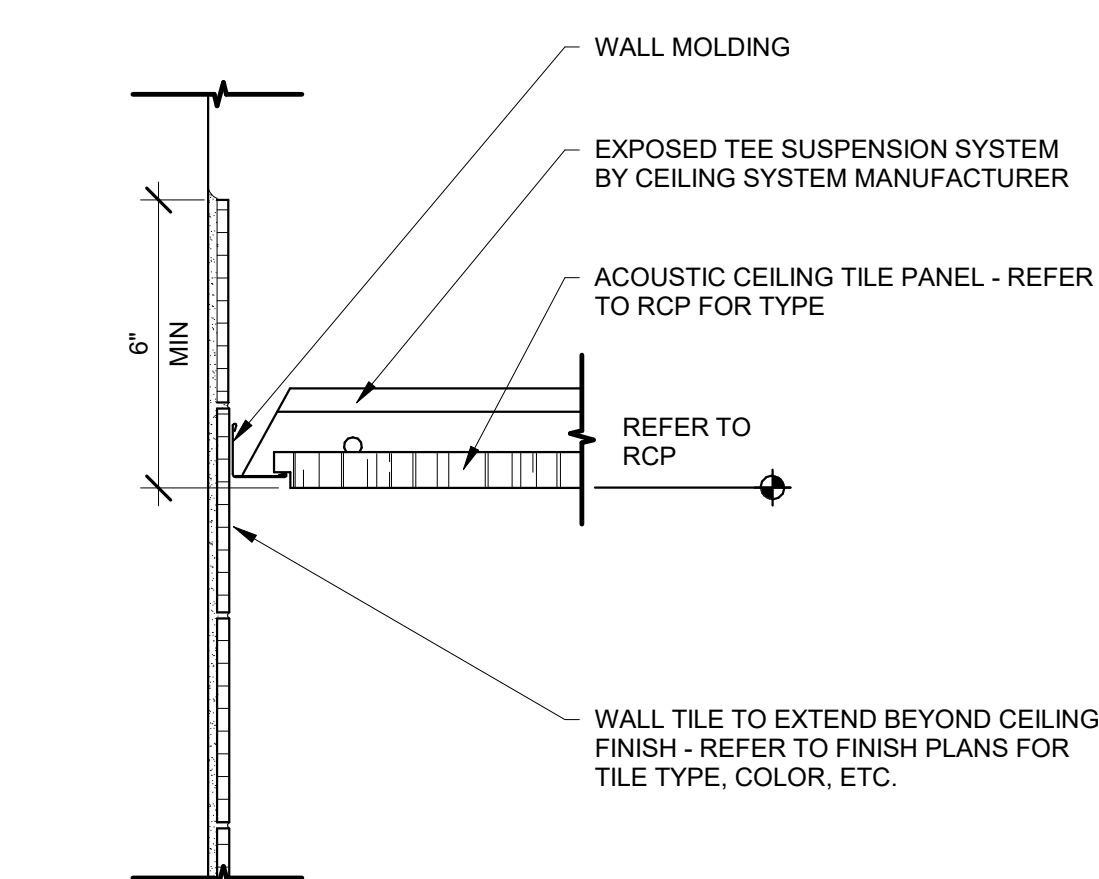

6 Terrazzo Base
3" = 1'-0"

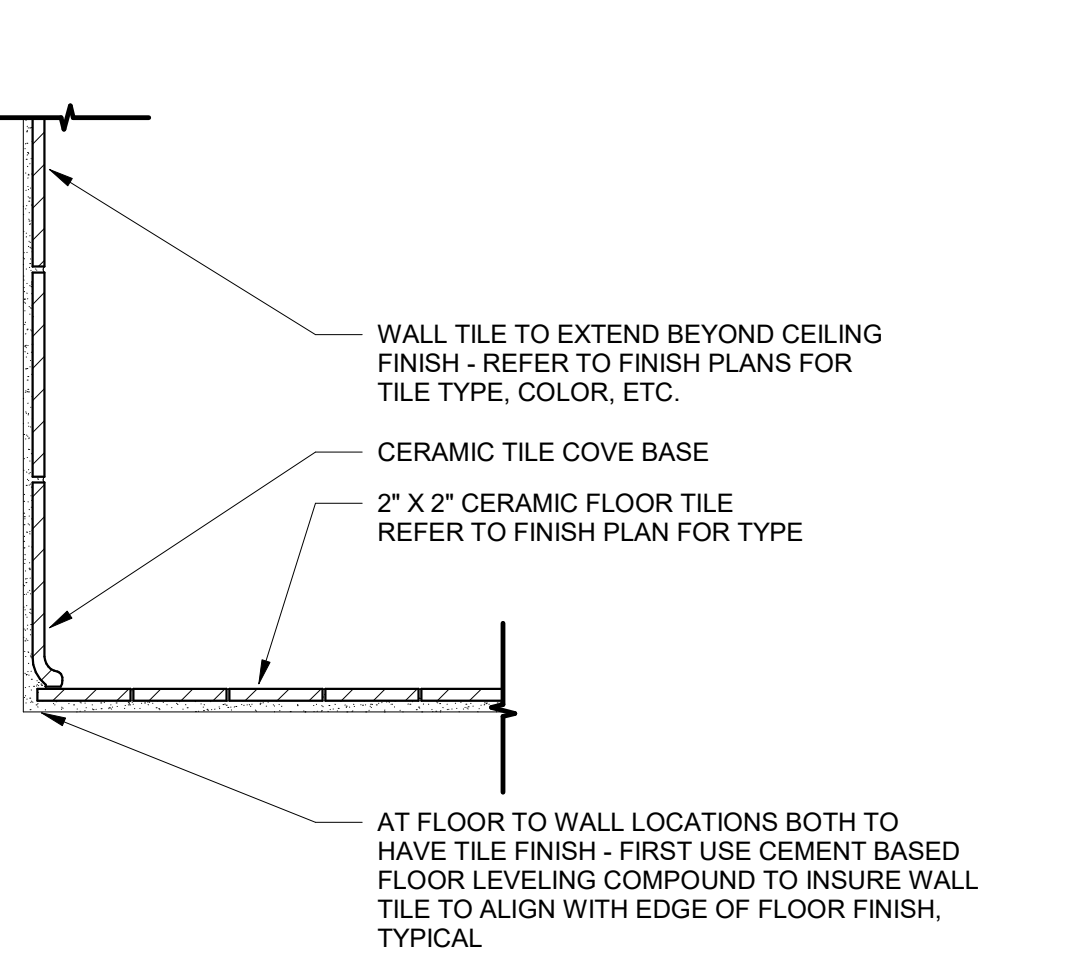


5 Inside/Outside Corner Detail Profile
3" = 1'-0"

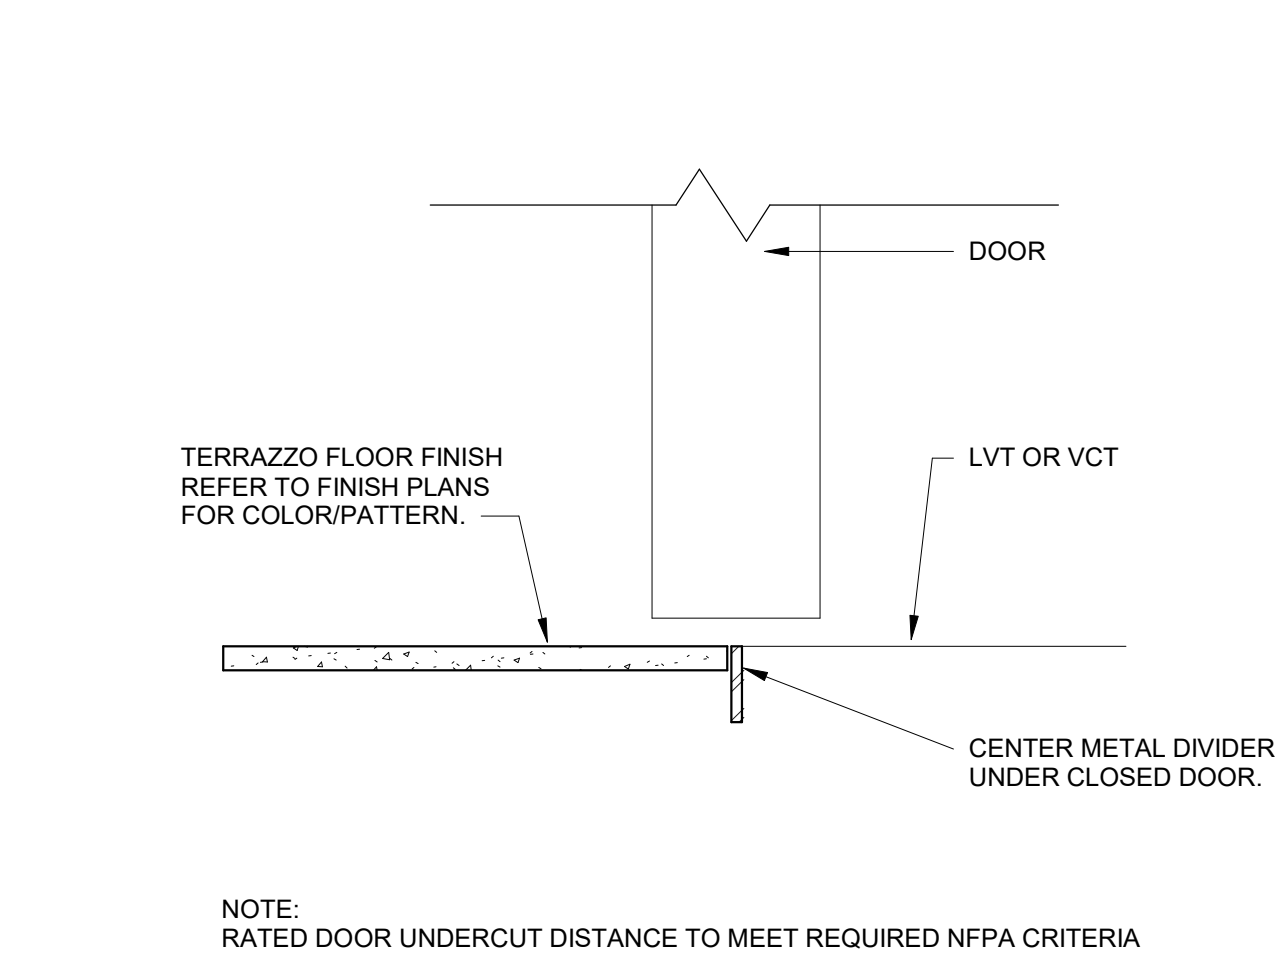


12 ADA Marble Threshold Detail
1/2\"/>




11 Ceramic Wall Tile at Acoustic Ceiling
3" = 1'-0"

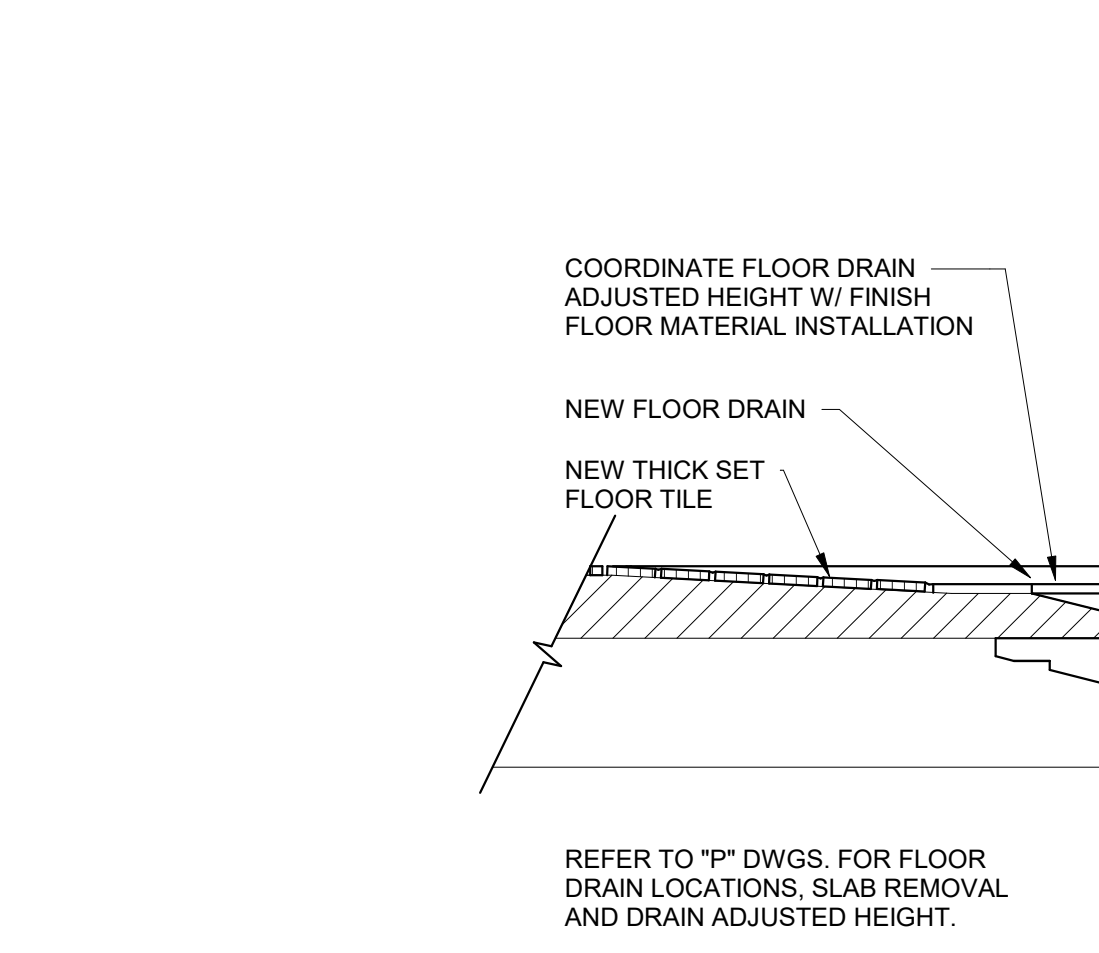

10 Ceramic Tile Base at Ceramic Floor With Wall Tile
3" = 1'-0"

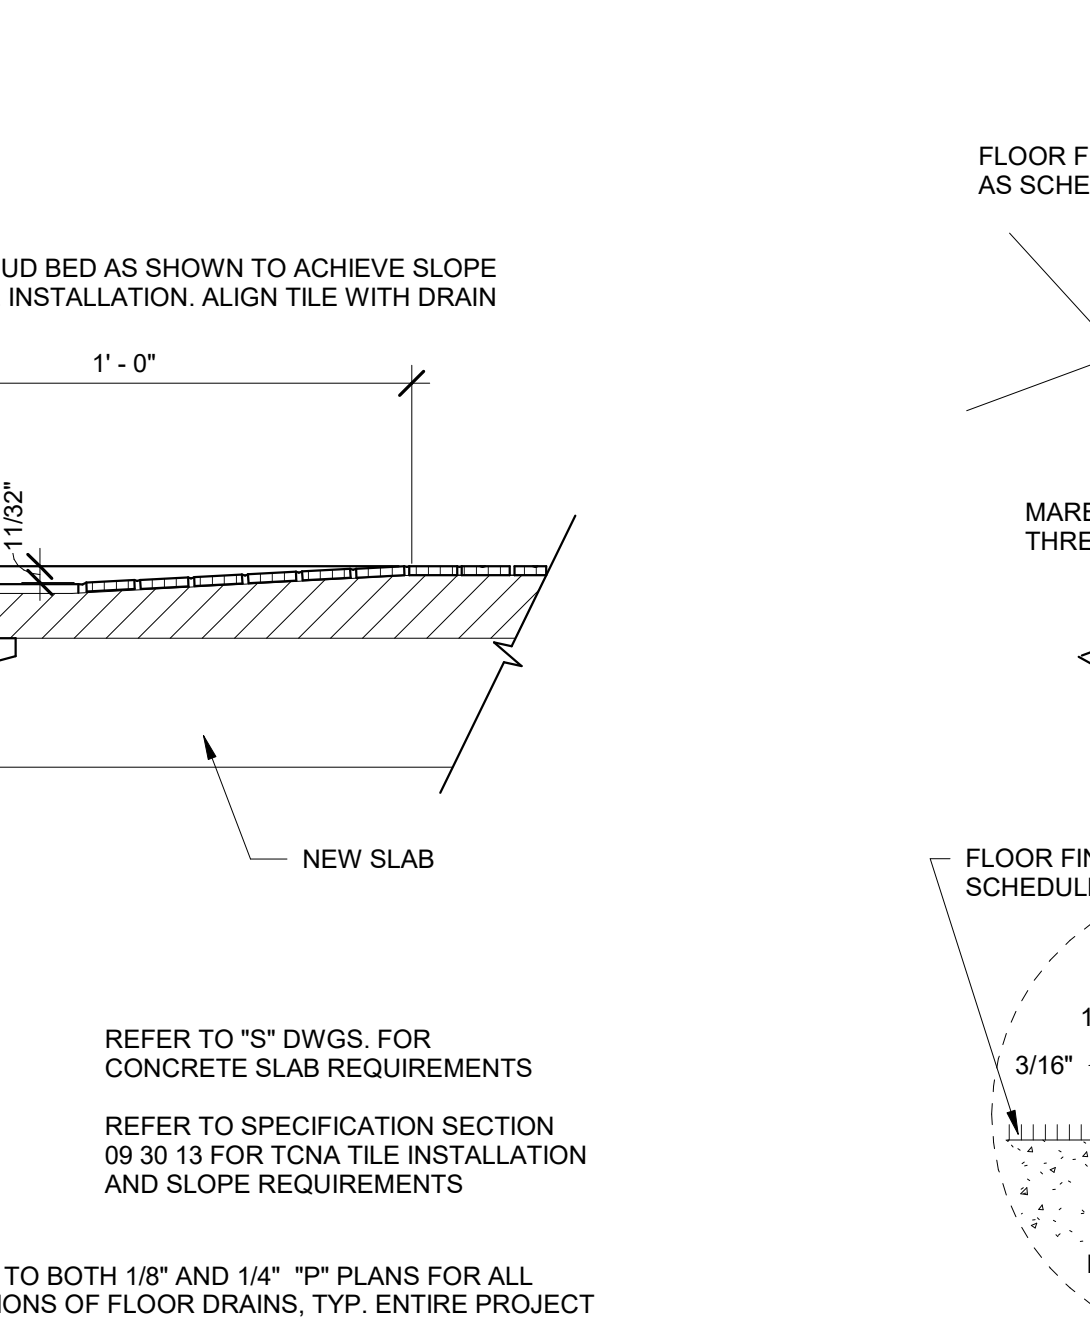

9 Threshold Detail
6\"/>

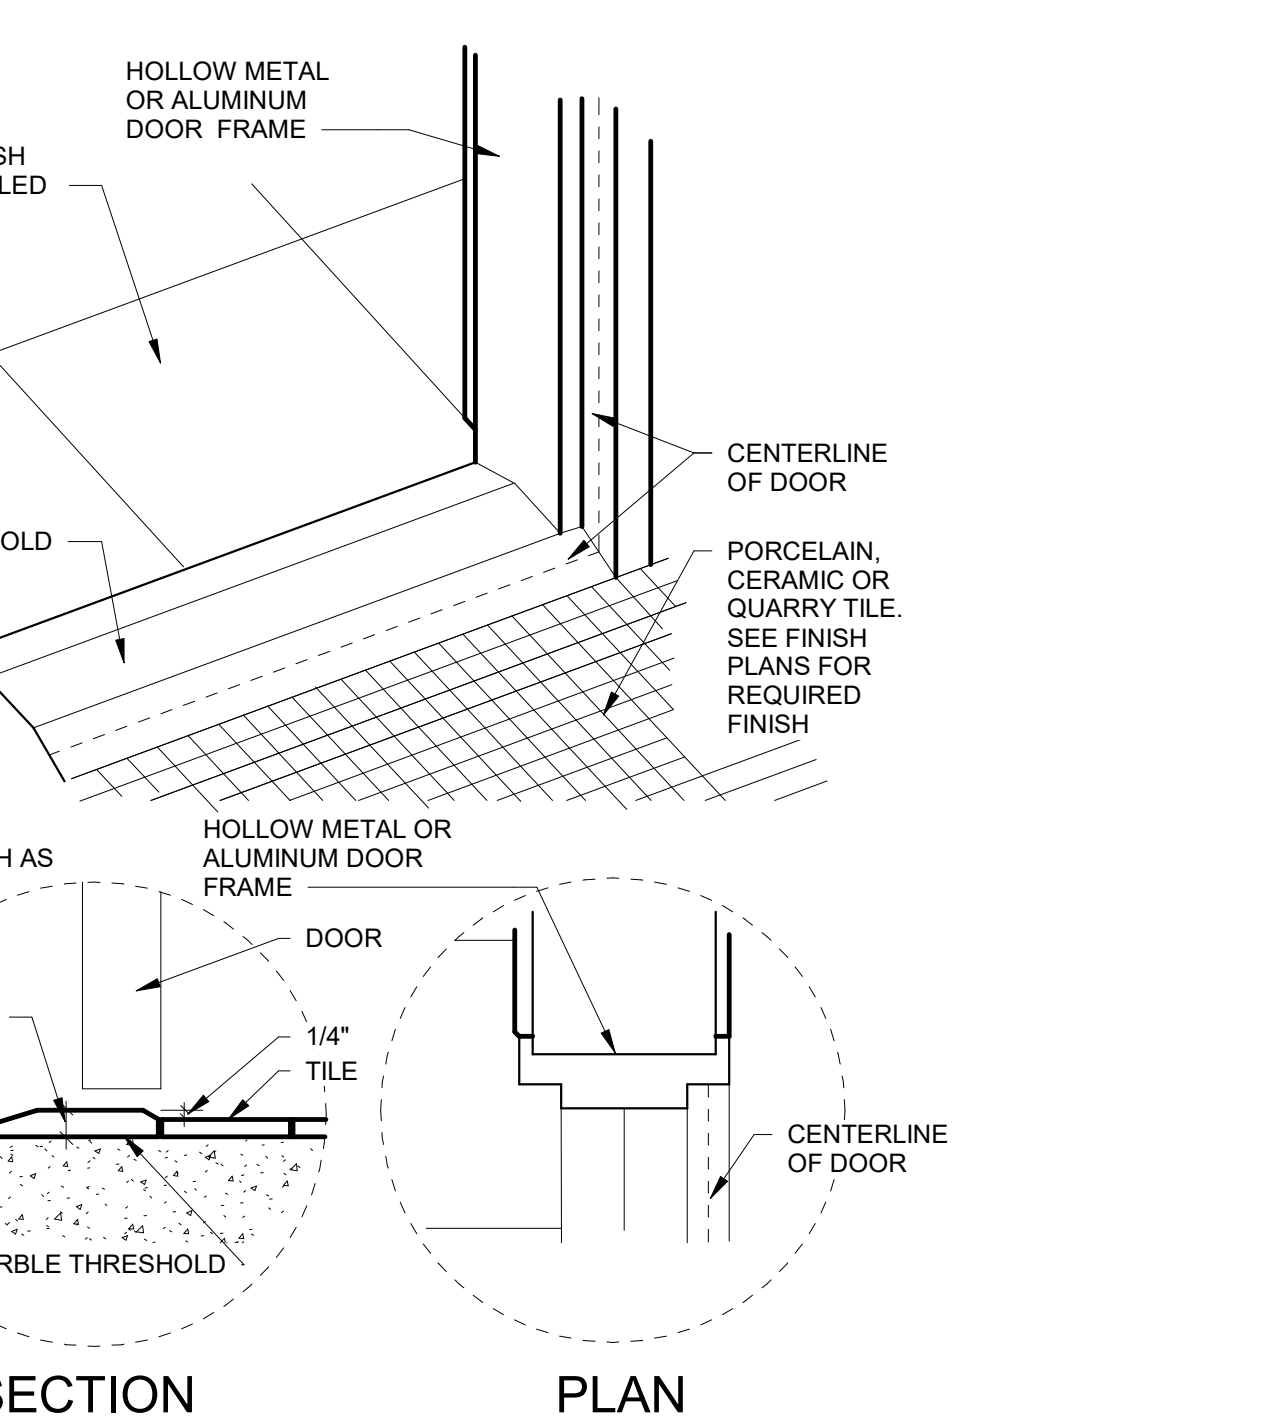

14 Floor Tile w/ New Drain - Thickset
3" = 1'-0"

13 ADA Marble Threshold Detail
1 1/2\"/>

General Finish Notes


- ALL FINISH PRODUCTS ARE TO BE INSTALLED IN ACCORDANCE WITH CONTRACT SPECIFICATION AND MANUFACTURES INSTRUCTIONS. REFER TO SPECIFICATIONS AND FINISH DETAILS FOR ADDITIONAL INFORMATION ON INSTALLATION OF SPECIFIED MATERIALS.
- A. ALL PAINTS FOR INTERIOR AND EXTERIOR ARE TO BE APPLIED IN ACCORDANCE WITH SPECIFICATION SECTION 09 91 00 AND 09 96 00.
- B. ALL EXPOSED STRUCTURES, INCLUDING BUT NOT LIMITED TO PIPING AND FIREPROOFING, CONDUIT, AND ALL ASSOCIATED EQUIPMENT ARE TO BE PAINTED.
- C. APPLY PAINT TO BOTH NEW AND EXISTING ITEMS IN ALL AREAS INDICATED WITH A FINISH BOX AND/OR NOTES - THESE ITEMS ARE INCLUDING BUT ARE NOT LIMITED TO:
- FEC 'S, LADDERS, BEAMS, DOOR/FRAMES - BOTH SIDES
 - GLAZING FRAMES IN DOOR/WALLS - BOTH SIDES
 - ALL EXPOSED STAIR PARTS INCLUDING RAILINGS, HAND AND GUARD RAILS, STRINGERS AND UNDERSIDES OF STAIRS, ALL ITEMS ARE TO BE ACCENT COLORS
- D. PATTERNS FOR FLOORS AND WALLS ARE TO BE ISSUED DURING CONSTRUCTION INCLUDING ALL ACCENT LOCATIONS. SUBMIT SHOP DRAWINGS SHOWING DETAILED LAYOUTS OF EACH AREA, INCLUDING EDGES AND TRANSITIONS. ALL LAYOUTS ARE TO BE CENTERED IN EACH ROOM. UNO - TYP ALL DRAWINGS. ABOVE REQUIREMENTS ARE TO INCLUDE BUT NOT LIMITED TO:
- CERAMIC TILE, BOTH WALL AND FLOOR.
 - CARPET
 - LVT
- E. FIELD AND ACCENT PAINT AS SHOWN ON DRAWINGS. CONTRACTOR IS TO ASSUME ALL FIELD AND ACCENT COLORS ARE DIFFERENT ROOM TO ROOM. AS WELL AS WITHIN EACH ROOM. REQUIREMENTS ARE TO INCLUDE BUT ARE NOT LIMITED TO:
- WALL, FIELD COLOR
 - WALL, ACCENT COLOR
 - SOFFITS, ACCENT COLOR
 - DOOR AND WINDOW FRAMES, ACCENT COLOR
 - EXPOSED COLUMNS, ACCENT COLOR
 - GUARDRAILS, ACCENT COLOR
 - HANDRAILS, ACCENT COLOR
 - EXPOSED DECKS, ACCENT COLOR
 - EXPOSED JOISTS, ACCENT COLOR
 - EXPOSED DUCTWORK, ACCENT COLOR
- F. PAINT MECHANICAL ROOM FLOOR CURBS CAUTION YELLOW.
- G. PROVIDE PAINT AT ALL NEW SOFFITS. REFER TO REFLECTIVE CEILING PLANS FOR ADDITIONAL LOCATIONS.
- J. CONFIRM WITH OWNER AND ARCHITECT PRIOR TO PAINTING OVER MURALS ON EXISTING SURFACES.
- K. CERAMIC WALL TILE IS TO RUN FLOOR TO CEILING UNO.
- N. NEW CERAMIC TILE WAINSCOT TO MATCH HEIGHT OF EXISTING GLAZED BLOCK WAINSCOT, OR AS OTHERWISE NOTED ON DRAWINGS.
- P. PROVIDE PAINT AND RUBBER BASE AT ALL NEW CHASES. REFER TO NEW WORK PLANS FOR ADDITIONAL LOCATIONS.
- Q. REFER TO STRUCTURAL DRAWINGS FOR LOCATIONS OF SLAB DEPRESSIONS. REFER TO FINISH MATERIAL SPECIFICATION SECTIONS FOR SLAB DEPRESSION DEPTH REQUIREMENTS.
- T. CARPET IS TO RUN WALL TO WALL UNDER ALL FURNITURE, MOVEABLE EQUIPMENT AND LIBRARY SHELVING UNITS, INCLUDING ALL UNITS AT THE PERIMETER WALLS.
- V. FOR ALL RENOVATED AREAS REQUIRING FINISH WORK REMOVE, PROTECT AND REINSTALL MOVEABLE EQUIPMENT INCLUDING BUT NOT LIMITED TO: BOARD UNITS, LOCKERS OYM EQUIPMENT, SHADES/BLINDS, ETC. REINSTALL IN ORIGINAL LOCATION, OR AS NOTED ON DRAWINGS. COORDINATE WITH - OWNER. REFER TO SPEC SECTION 01 23 00 ALTERATION PROJECT PROCEDURES FOR MORE INFORMATION.
- X. FIELD VERIFY ALL CONTROL JOINTS LOCATIONS IN CONCRETE SLAB. LOCATE CONTROL JOINTS IN EXG/NEW FLOOR FINISH MATERIAL DIRECTLY ABOVE SLAB JOINTS OR AS RECOMMENDED BY FLOORING MATERIAL MANUFACTURER.
- AT NEW SLABS REFER TO STRUCTURAL DRAWINGS FOR SLAB CONTROL JOINT LOCATIONS.
 - AT EXISTING SLABS, FIELD VERIFY LOCATIONS OF EXISTING SLAB CONTROL JOINTS.
- Y. INSTALLER IS TO FIELD VERIFY ALL EXG AND NEW FLOOR DRAIN LOCATIONS IN ALL EXG AND NEW SLABS AS PART OF THIS PROJECT.
- REFER TO ARCHITECTURAL DRAWINGS FOR FLOOR DEMO AREAS AND REQUIREMENTS.
 - REFER TO PLUMBING DRAWINGS FOR EXG AND NEW FLOOR DRAIN LOCATIONS.
 - REFER TO STRUCTURAL DRAWINGS FOR LOCATIONS OF SLAB DEPRESSIONS.
 - REFER TO FINISH DRAWINGS FOR LOCATIONS OF NEW FLOOR FINISH MATERIALS AND FLOORING SLOPE.
 - REFER TO FINISH MATERIAL SPECIFICATION SECTIONS FOR SLAB DEPRESSION DEPTH REQUIREMENTS.
- Z. PROVIDE ALL FINISHES AS INDICATED BY ROOM FINISH BOX AND/OR AS NOTED ON DRAWINGS.

Room Finish Key

- C1 CARPET - TYPE 1
CFT1 CERAMIC FLOOR TILE - TYPE 1
CT CERAMIC TILE COVE BASE
CWT1 CERAMIC WALL TILE - TYPE 1
ES EXPOSED STRUCTURE
HPC HIGH PERFORMANCE COATING
LVT LUXURY VINYL TILE
MCS MOISTURE CONTROL SYSTEM
N NO WORK REQUIRED
P PAINT SURFACE(S) INCLUDING SOFFITS
PS PAINT EXPOSED STRUCTURE/DECK
RAP RESILIENT ATHLETIC FLOORING
RB RUBBER BASE
SC SEALED CONCRETE (PER SPEC. SECT. 03 30 00)
T1 TERRAZZO - TYPE 1 - POURED EPOXY
TB TERRAZZO BASE - PRECAST
VB VENTED COVE BASE
VCT1 VINYL COMPOSITION TILE - TYPE 1
WD1 WOOD FLOORING - GYM
- * SEE REFLECTED CEILING PLAN
 - + INDICATED CHANGE IN FLOOR FINISH

NOTE: ALL FINISHES LISTED MAY NOT BE REQUIRED FOR THIS PROJECT

FINISHES SHOWN IN ROOM FINISH BOX ARE FOR ALL WALLS AND ENTIRE FLOOR AND CEILING. REFER TO EACH ROOM FOR MORE INFORMATION.			RM#
CLG*	WALL		
FLR	BASE		

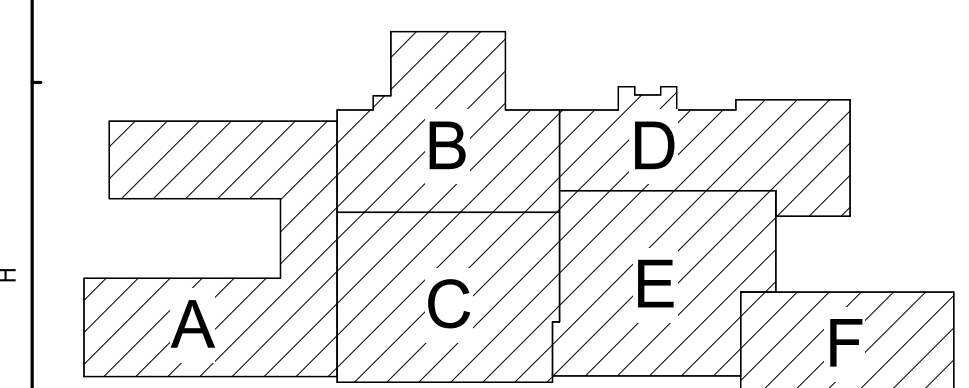

Key Plan
N.T.S.

SED Control No. 60-01-01-06-0-018-023

Rev. No.: Date: Description:



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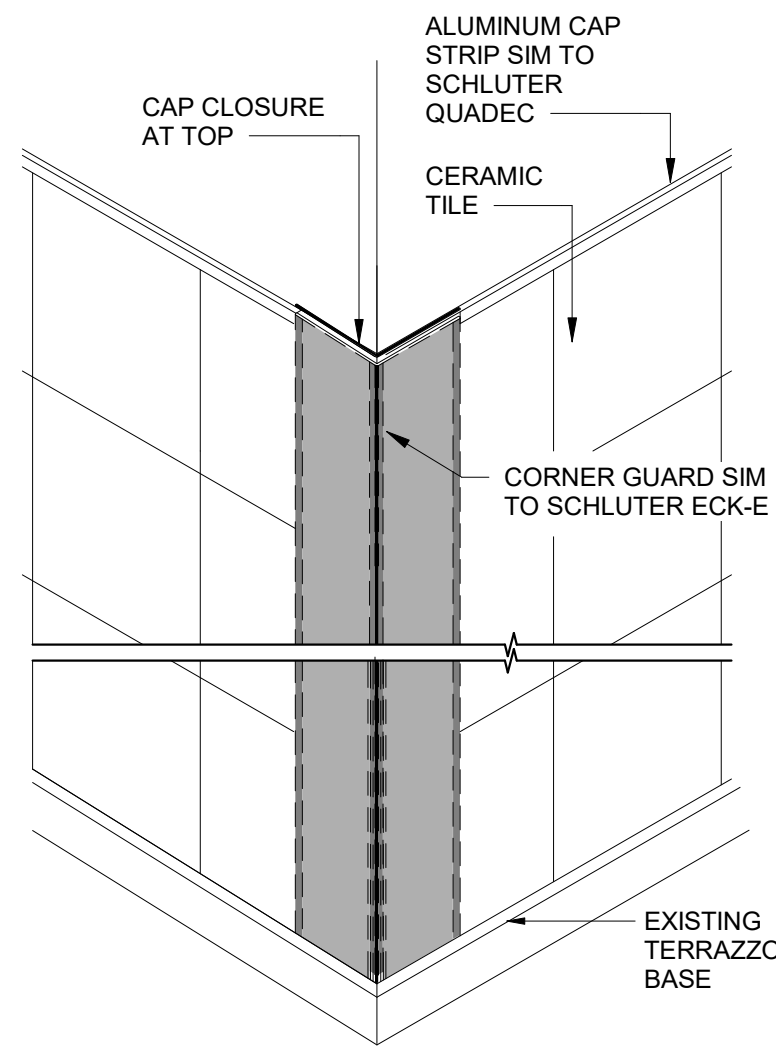
TETRA TECH
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Waverly Central School District
Waverly, NY


Additions and Alterations to:
Waverly Jr. Sr. High School

Details


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Date: 05/19/2023
Project No.: 339070-22003
Drawing Number: AA940




5 Corner Guard with Edge Cap
3" = 1'-0"

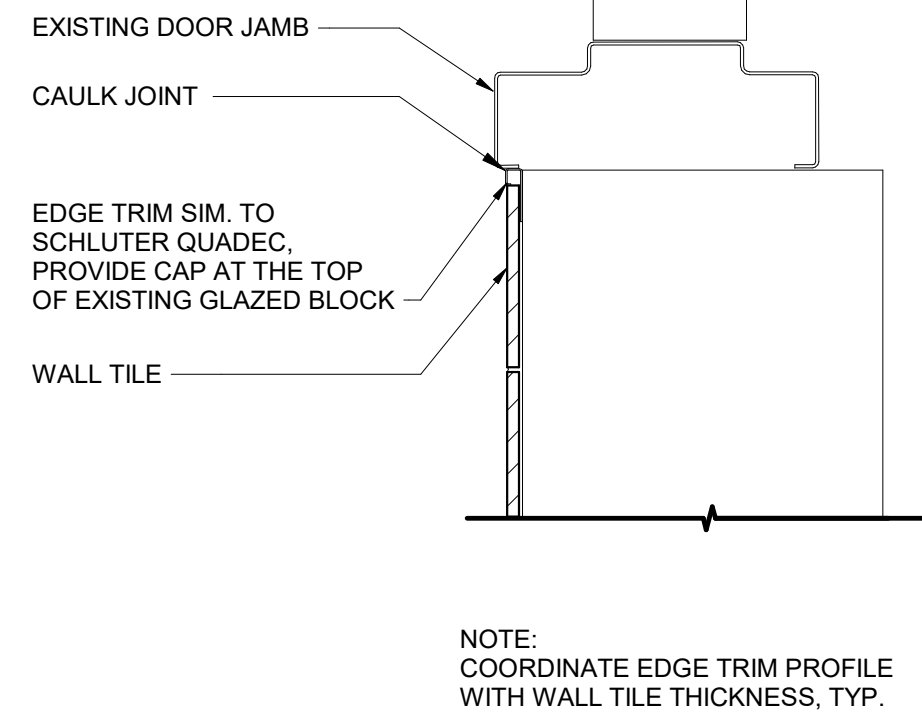


4 Ceramic Tile Bullnose
3" = 1'-0"

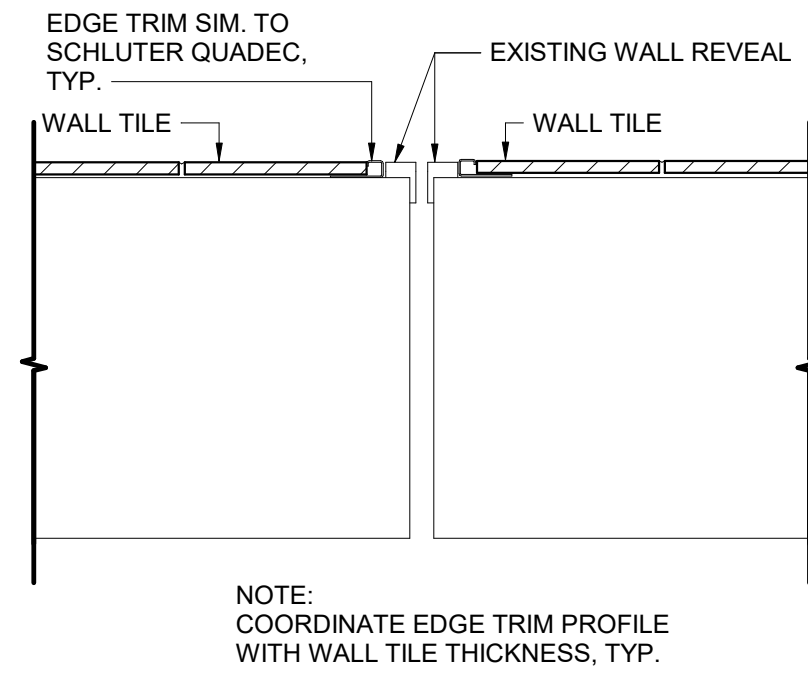


2 Ceramic Tile at Existing Wall Reveal
3" = 1'-0"

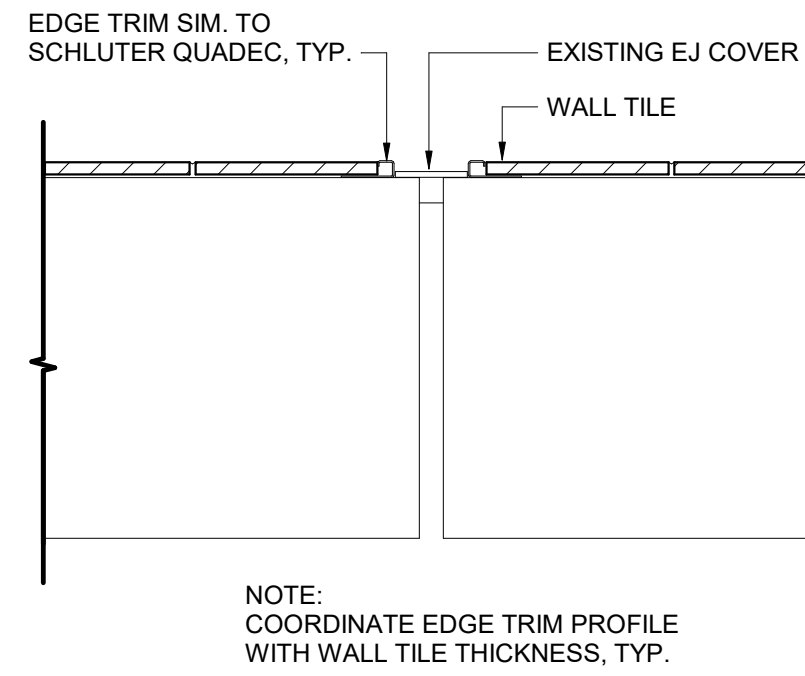


1 Ceramic Tile at Existing Expansion Joint
3" = 1'-0"

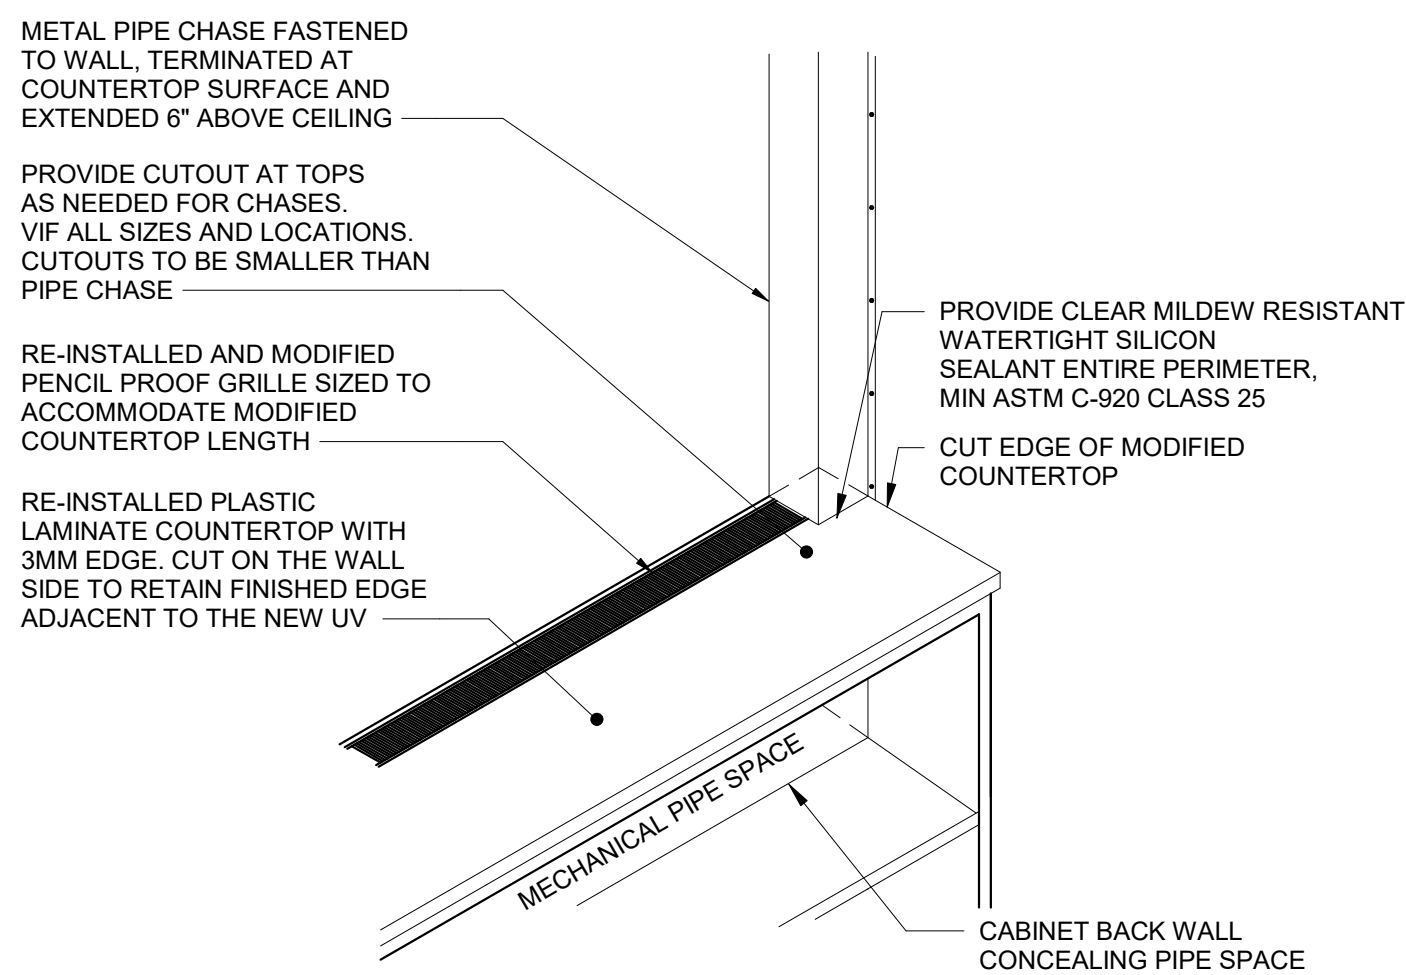


9 Chase at UV Replacement Detail
3/4" = 1'-0"

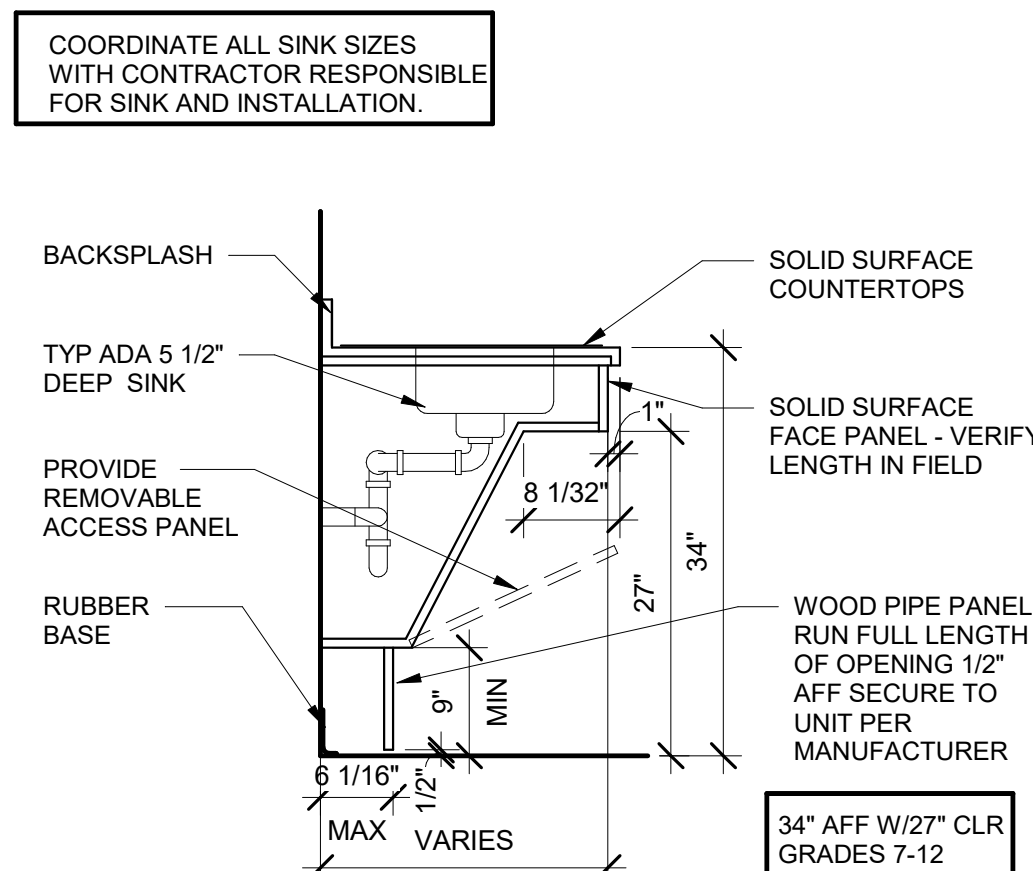


8 ADA Sink Base - Double Sink
3/4" = 1'-0"

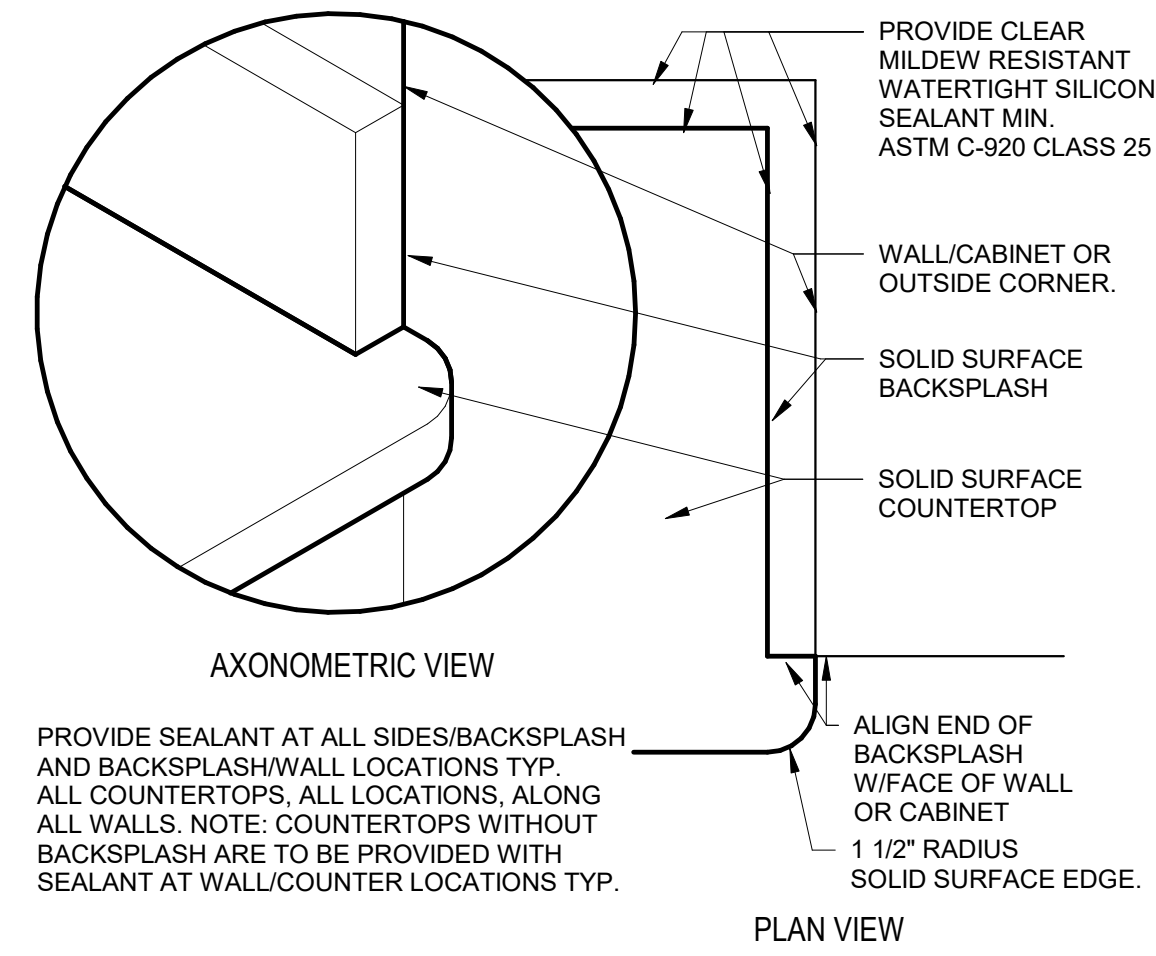


7 Solid Surface Countertop Edge Detail
3" = 1'-0"

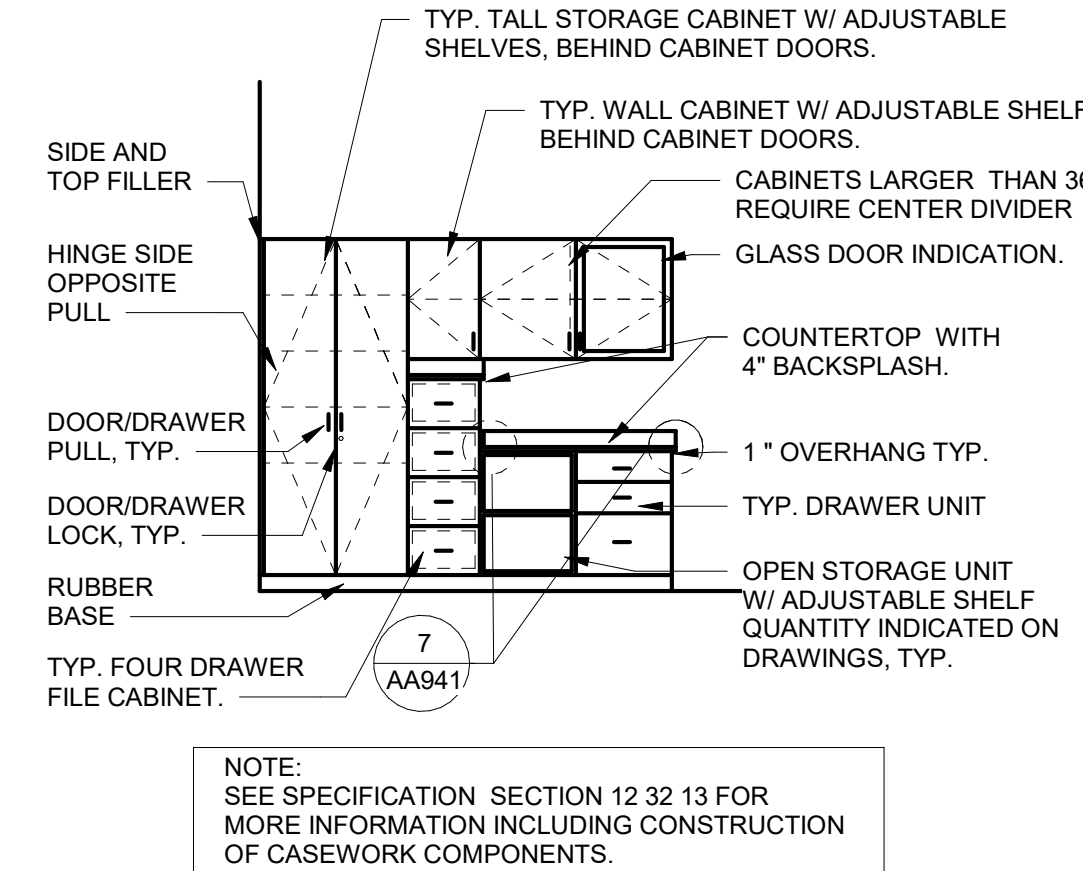


6 Typical Casework Designs
1/4" = 1'-0"

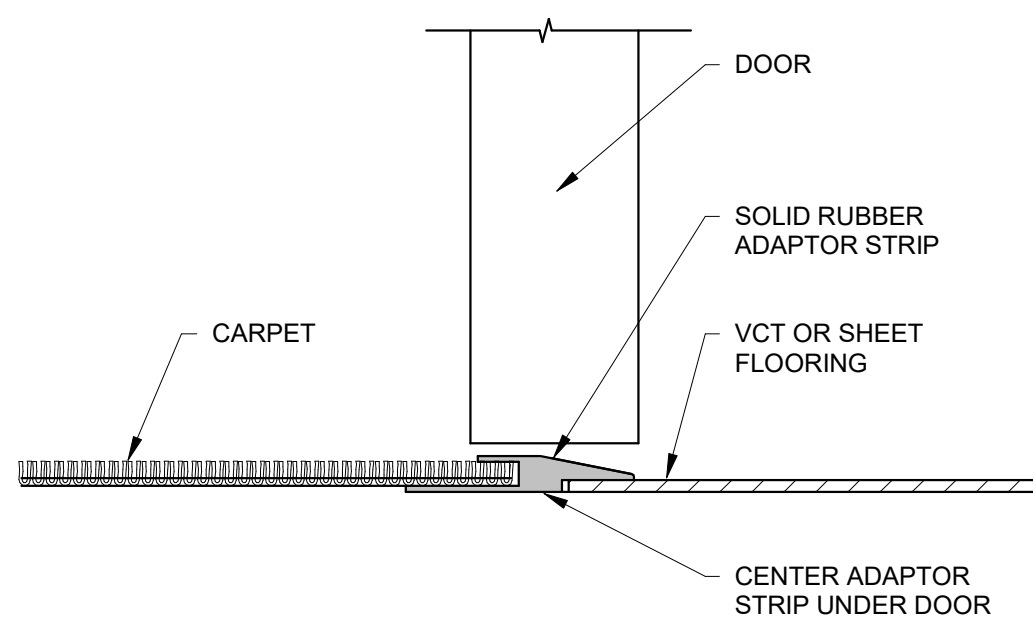


13 Threshold Detail
6" = 1'-0"

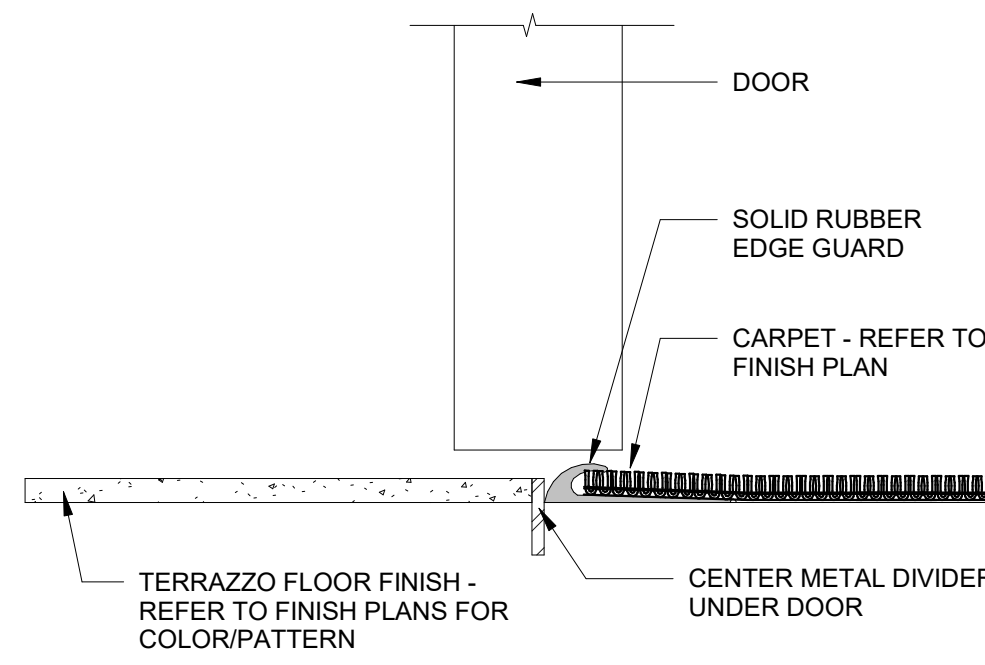


12 Threshold Detail
6" = 1'-0"

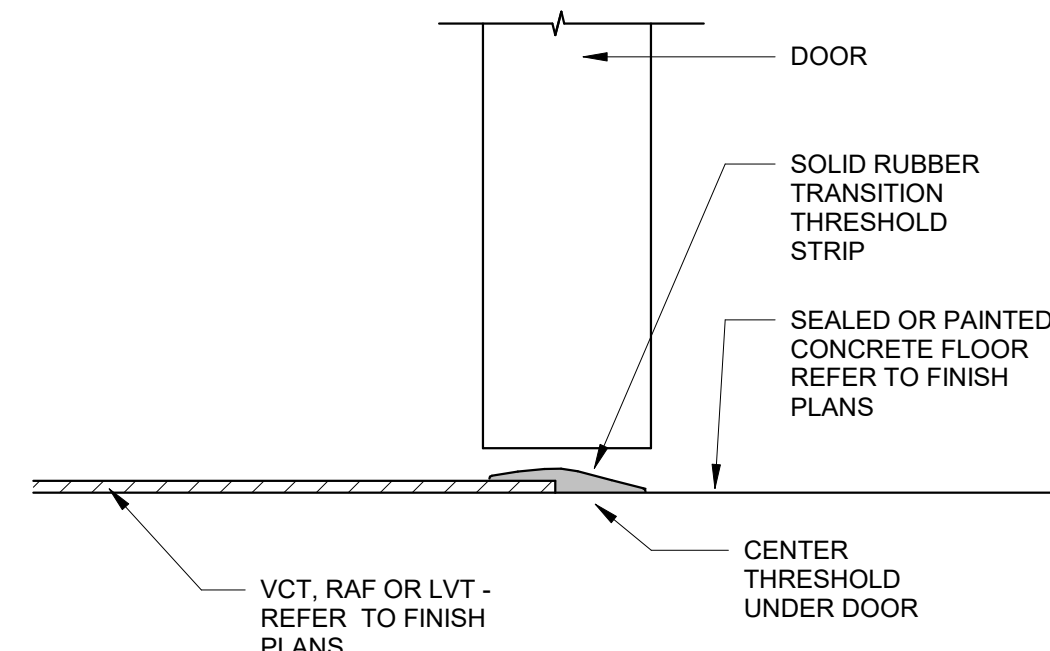

11 Threshold Detail
6" = 1'-0"

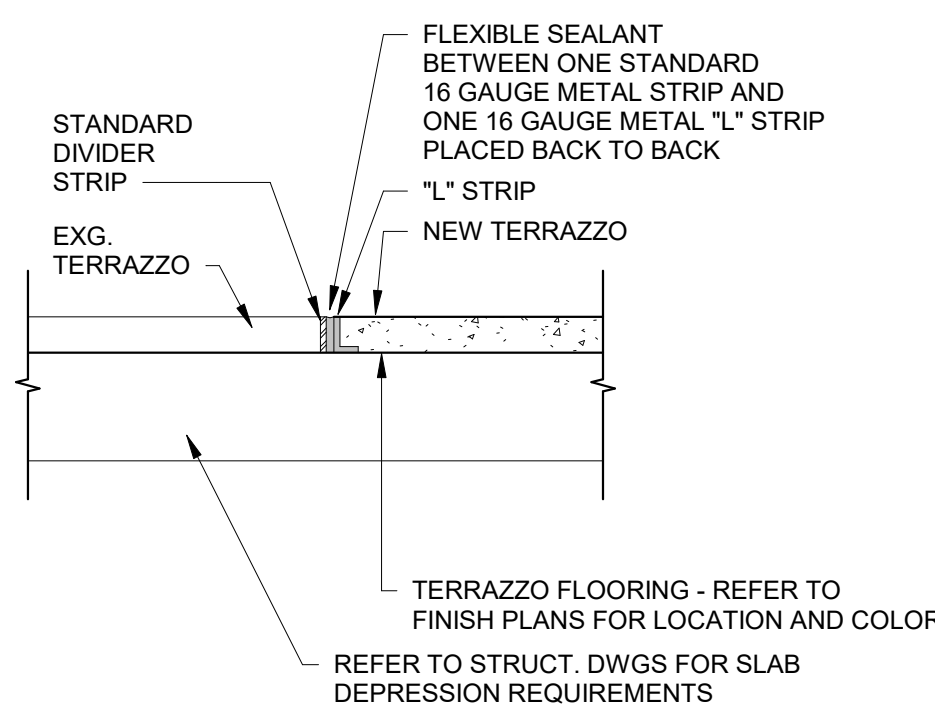



15 New to Existing Terrazzo
3" = 1'-0"

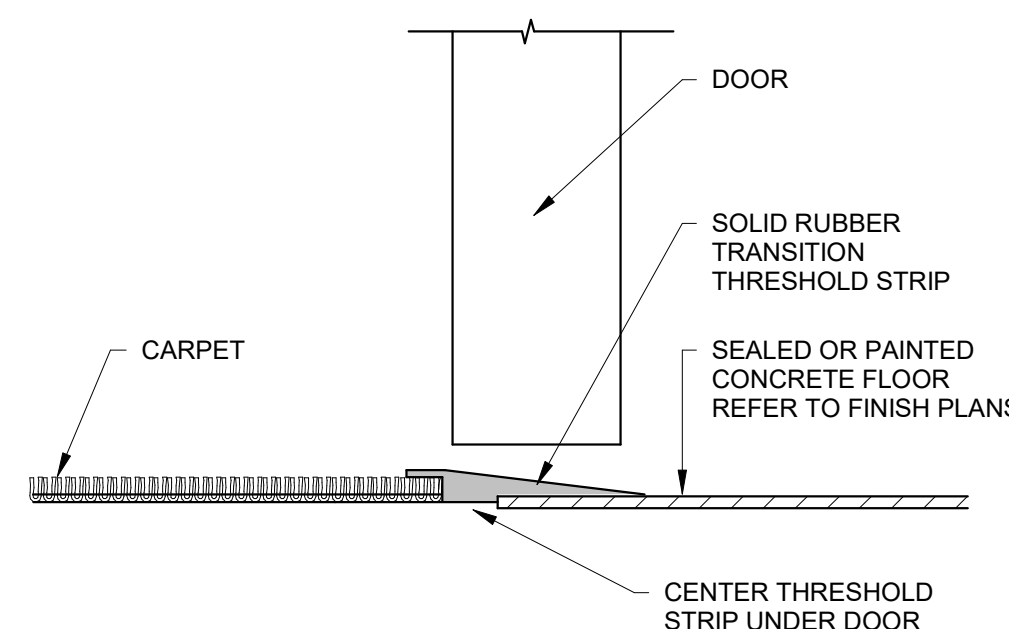

14 Threshold Detail
6" = 1'-0"

General P-Lam Casework Notes

- FOR ALL CONTRACTOR RESPONSIBILITIES REFER TO SPECIFICATION SECTION 01 10 00/01 12 00.
- THE CASEWORK SHOWN ON THE DRAWINGS IS BASED ON TMI SYSTEMS DESIGN CORPORATION.
 - ALL STANDARD CASEWORK DIMENSIONS ARE TO BE MODIFIED TO CORRESPOND WITH THE DIMENSIONS NOTED ON THE DRAWINGS. FIELD VERIFY ALL DIMENSIONS PRIOR TO FABRICATION OF CABINETS.
 - MODEL NUMBERS LISTED ON DRAWINGS APPLY TO ELEVATIONS SHOWN. PROVIDE OPPOSITE HAND MODELS WHERE NECESSARY.
 - PROVIDE FULL DEPTH SHELVES AT BASE, WALL AND TALL CABINETS TYP UNLESS NOTED OTHERWISE.
 - BASE AND TALL CABINETS ARE 24 INCHES DEEP. UNO WALL CABINETS ARE 14 INCHES DEEP. UNO BASE CABINET DEPTH DOES NOT INCLUDE 1" COUNTERTOP OVERHANG, TYP.
 - PROVIDE FINISHED ENDS, BACK EXTENSIONS, SCRIBES, AND FINISHED FILLER PANELS ON ALL CABINETS. FILLER PANELS ARE NOT TO EXCEED 2" WIDE, UNLESS NOTED OTHERWISE. PROVIDE TOP AND BOTTOM FILLER PANELS AT ALL BASE, WALL @ TALL CABINETS. SUBMIT SHOP DRAWINGS SHOWING DETAILS OF THESE CONDITIONS.
 - ALL COUNTERTOPS TO BE 1-1/4" SOLID SURFACE.
 - PROVIDE 4" HIGH BACKSPLASHES AT ALL LOCATIONS. UNO DO NOT PROVIDE BACKSPLASHES AT UV (WINDOW) WALL UNO PROVIDE CAULK AT ALL JOINTS.
 - PROVIDE AT ALL P-LAM UV SHELVING LOCATIONS-REMOVABLE BACKS IN CABINETS AT PLUMBING AND FIN TUBE VALVE LOCATIONS. VERIFY POSITIONS OF VALVES PRIOR TO SHOP FABRICATION OF ALL CABINETS.
 - PROVIDE SHOP DRAWINGS SHOWING LOCATIONS AND DETAILS FOR ALL GRILLES, LOUVERS, REMOVABLE PANELS, VALVE LOCATIONS, ETC ASSOCIATED WITH CASEWORK. COORDINATE WITH ALL REQUIRED CONTRACTORS.
 - PROVIDE CABINETS WITH FINISHED SIDES, INCLUDING BUT NOT LIMITED TO, LOCATIONS OF ADJACENT CABINETS OR EQUIPMENT WITH A DEPTH LESS THAN CABINET OR EQUIPMENT.
 - PROVIDE REMOVABLE BACK PANELS AT ALL SINK BASE CABINETS.
 - COUNTERTOP EDGES AT OPEN ENDS AND AT ENDS MEETING TALL SHELVING UNITS WITH A DEPTH LESS THAN COUNTERTOP DEPTH TO BE AS SHOWN. REFER TO DETAIL 7/A4641.
 - PROVIDE SEALANT AT ALL COUNTERTOP SINK CUTOUT LOCATIONS. REFER TO SPEC SECTION 07 92 00.
 - PROVIDE CUTS AT ALL CONDITIONS THAT INTERFERE WITH COUNTERTOPS/CABINETS - SCRIBE TO FIT.
 - PROVIDE ALL CUTOUTS AS SHOWN ON CASEWORK PLANS AND ELEVATIONS OR AS REQUIRED. CUTOUTS ARE TO INCLUDE BUT NOT LIMITED TO: ALL ELEC BOXES, OUTLETS, AND ASSOCIATED WIRING AND FINAL HOOK-UP.
 - PROVIDE AS NOTED ON DRAWINGS AND DETAILS: 2" GROMMETS AT OPEN BASE COUNTERS 30/36" OC, WIRE MANAGEMENT, KEY BOARD TRAYS AND CABLE TRAYS.
 - PROVIDE BLOCKING AT NEW AND EXISTING GYPSUM BOARD WALLS PER MANUFACTURER RECOMMENDATIONS FOR SUPPORT OF WALL /TALL MOUNTED UNITS.
 - PROVIDE LOCKS AT ALL NEW CASEWORK DOORS/DRAWERS.
 - PROVIDE COUNTERTOP CUT-OUTS FOR SINK, FAUCETS COORDINATE WITH ALL REQUIRED CONTRACTORS.
 - REFER TO BOTH 1/8" AND 1/4" PLANS FOR LAYOUTS.

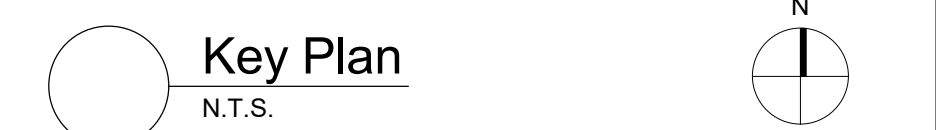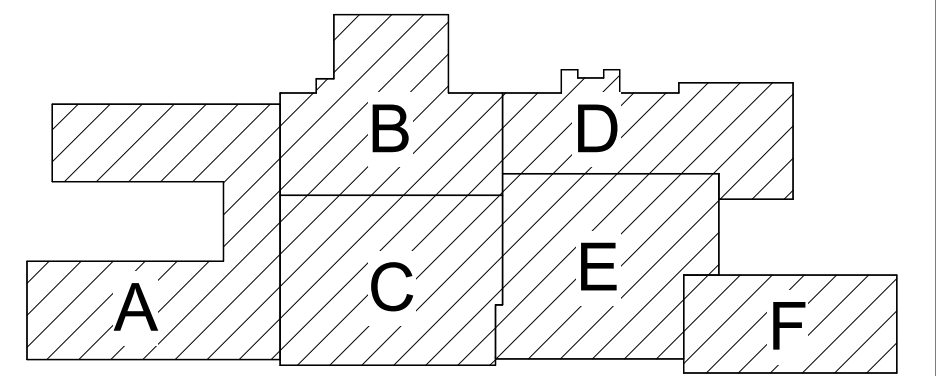

SED Control No. 60-01-01-06-0-018-023

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Waverly Central School District
Waverly, NY

Additions and Alterations to:
Waverly Jr. Sr. High School


Details

Drawn By: TRS Date: 05/19/2023 Drawing Number: 339070-22003

AA941

NON-GLARE SURFACE:
*TYPICAL FOR ENTIRE SIGN


TACTILE CHARACTERS:
*5/8" MINIMUM CAP LETTER HEIGHT
*1" MINIMUM NUMBER HEIGHT
*RAISED 1/32" MINIMUM
*FULL CAPS
*SAN SERIF TYPE STYLE
*CHARACTERS MUST CONTRAST WITH BACKGROUND

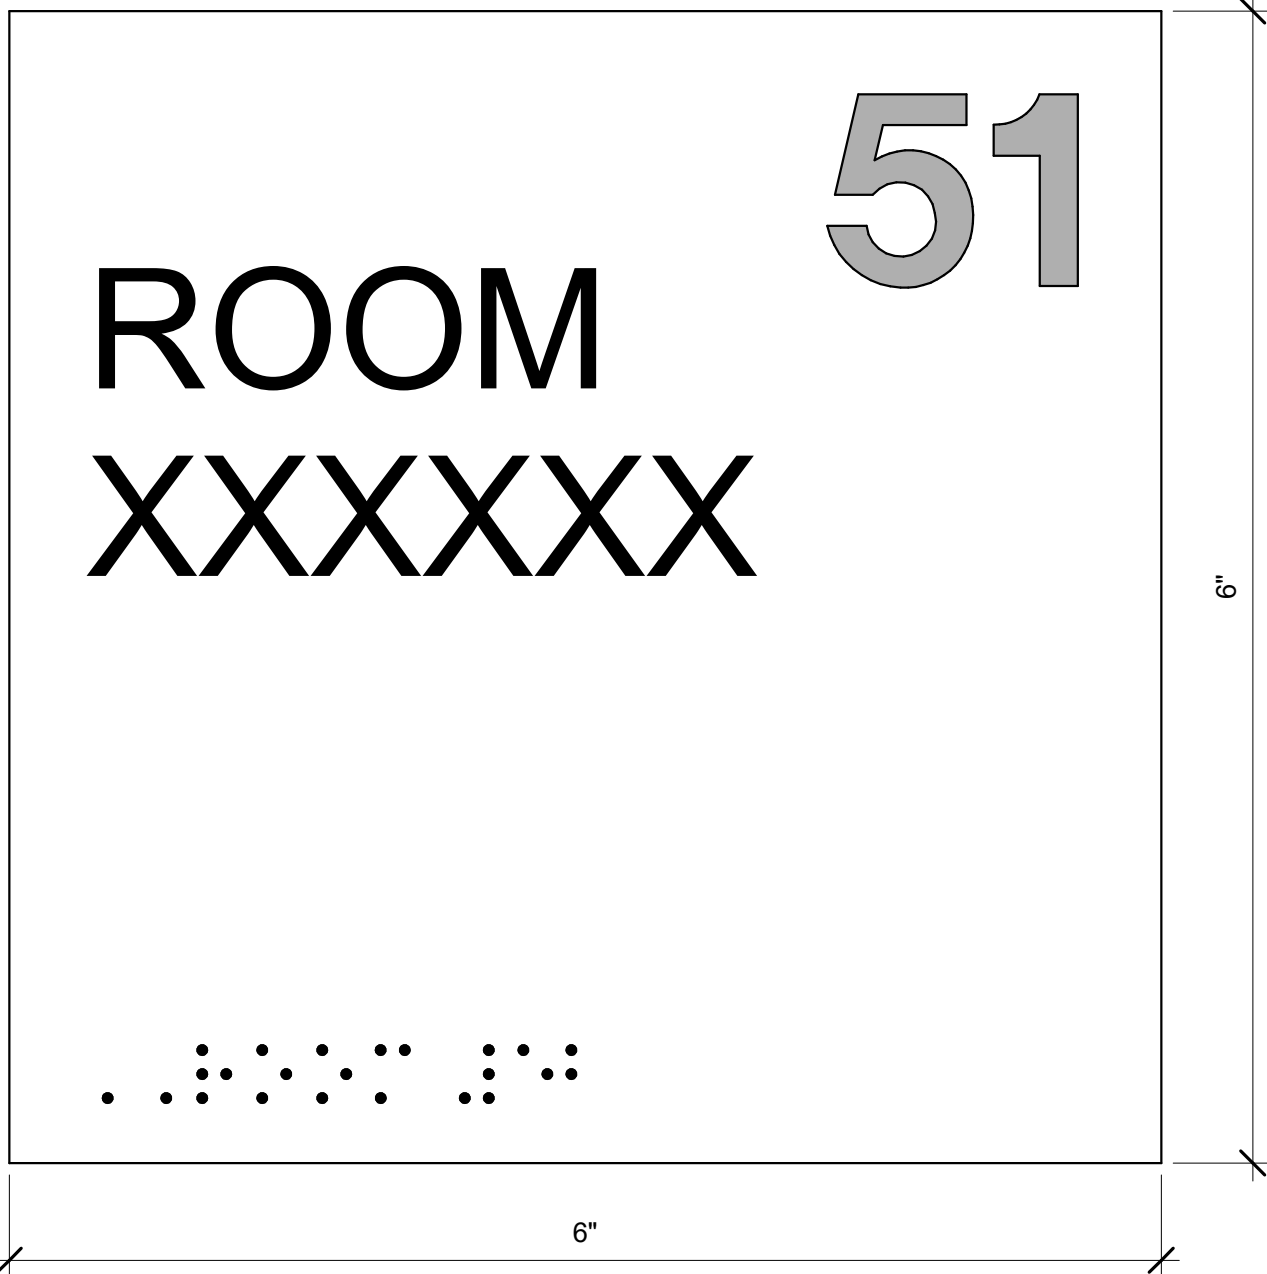

TYPE 5 - Typical Permanent Room Plaque

NON-GLARE SURFACE:
*TYPICAL FOR ENTIRE SIGN


TACTILE CHARACTERS:
*3/4" MINIMUM CAP LETTER HEIGHT
*2" MINIMUM NUMBER HEIGHT
*RAISED 1/32" MINIMUM
*FULL CAPS
*SAN SERIF TYPE STYLE
*CHARACTERS MUST CONTRAST WITH BACKGROUND

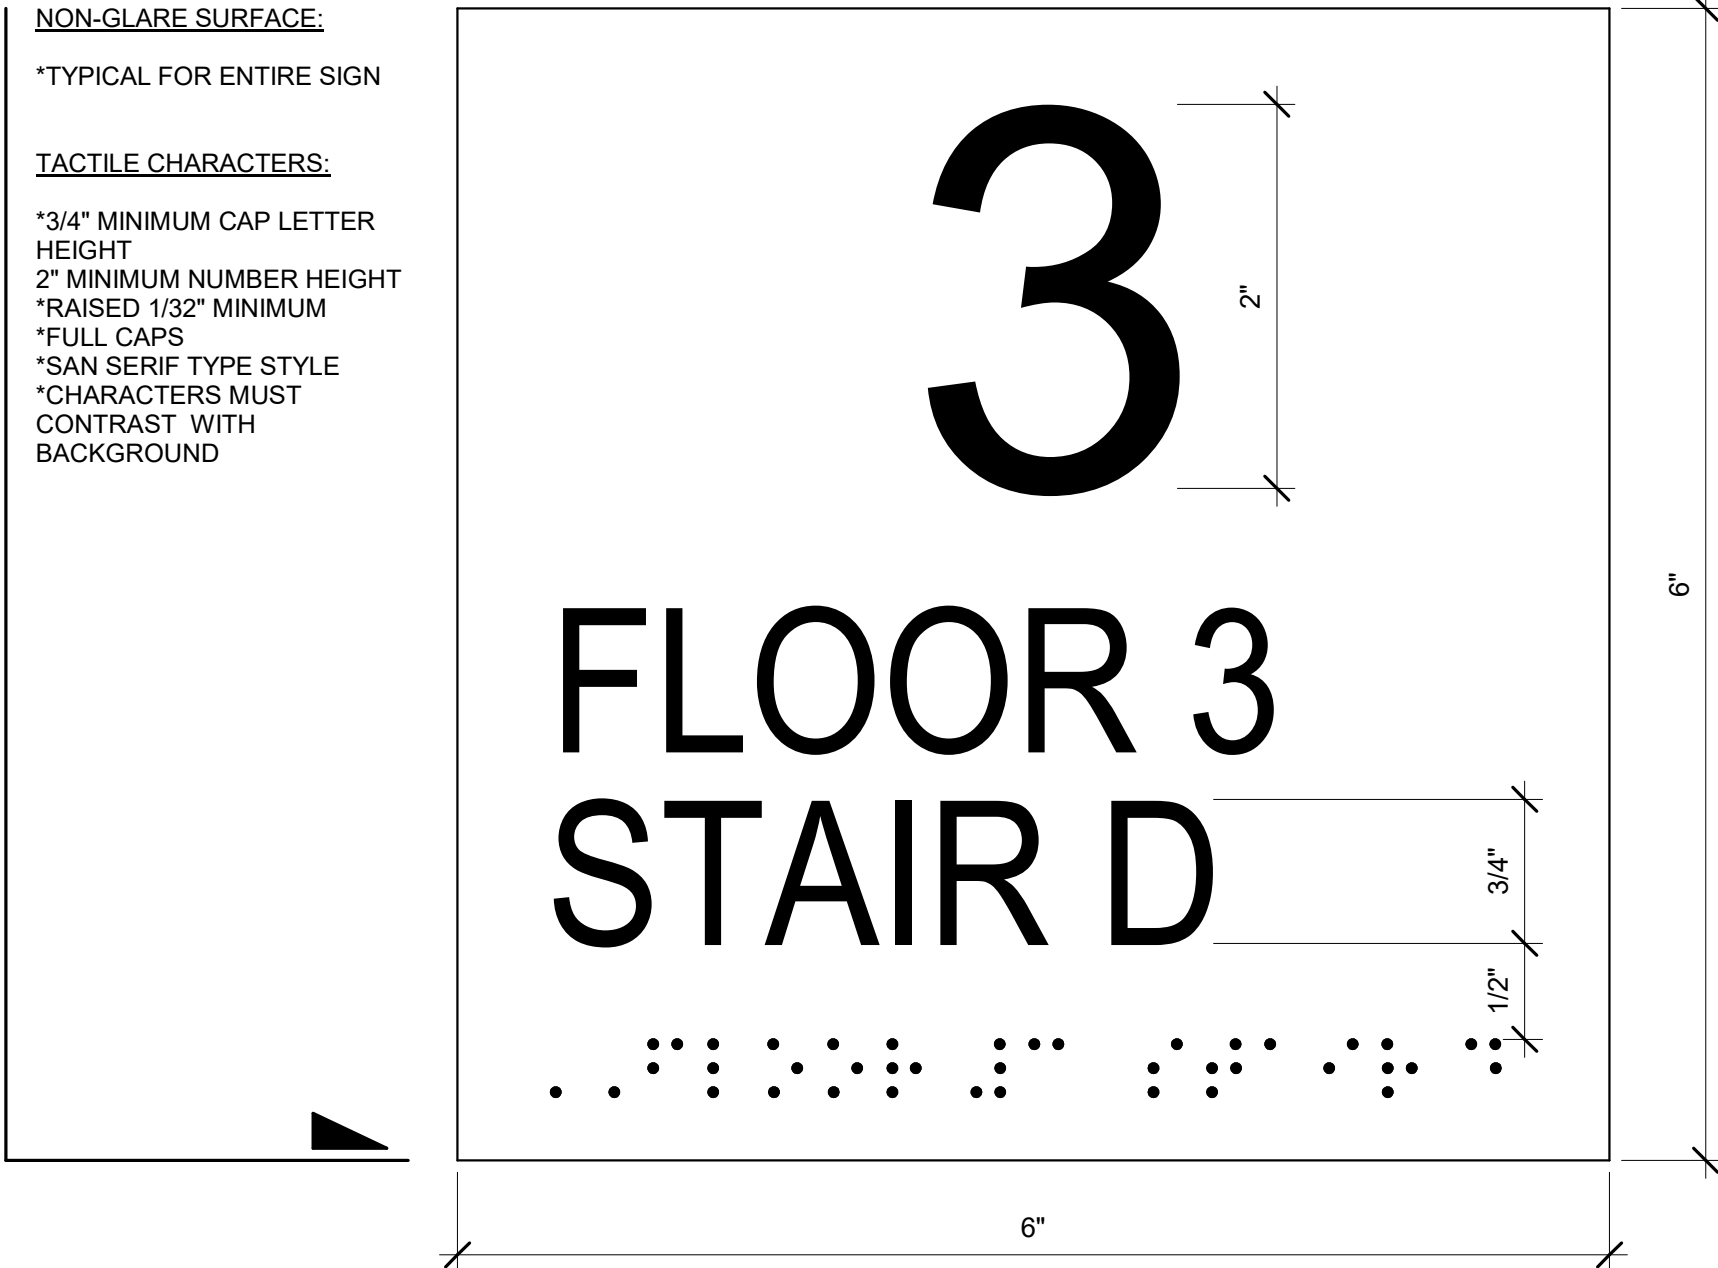

TYPE 4 - Typical Stair Plaque

REFLECTIVE SURFACE:
*TYPICAL FOR ENTIRE SIGN

DESIGNATIONS:
* 'II' - ROMAN ALPHANUMERIC CONSTRUCTION
* 'P' - FLOOR FRAMING, INCLUDING GIRDERS AND BEAMS
* 'R' - ROOF FRAMING
* 'FR' - FLOOR AND ROOF FRAMING

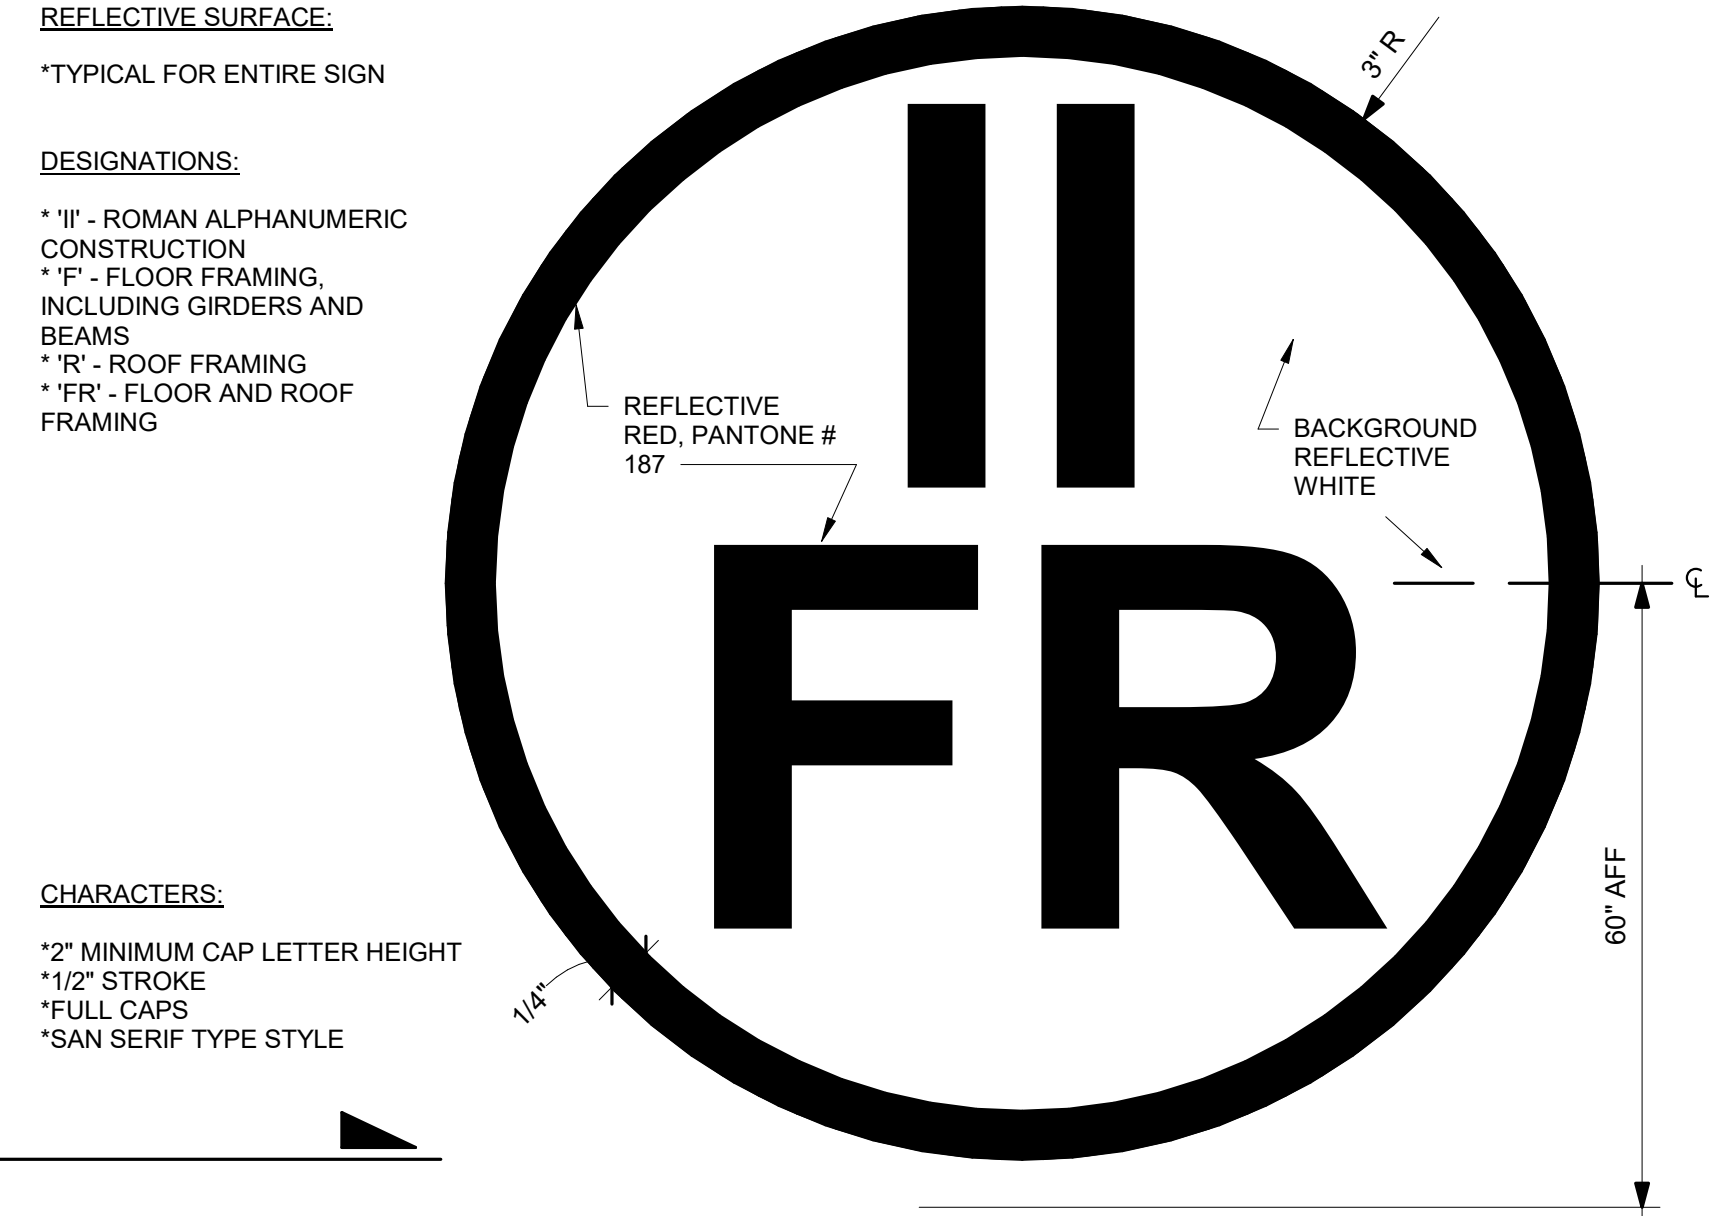

TYPE 11 - Truss Type Construction Identification Sign
TYPE 11a - Truss Type Construction Identification Decal

1 Typical Permanent Room Plaque
12" = 1'-0"


2 Typical Stair Plaque
12" = 1'-0"

7 Truss Type Construction Identification Sign
12" = 1'-0"

NON-GLARE SURFACE:
*TYPICAL FOR ENTIRE SIGN
*WHITE BACKGROUND

TACTILE CHARACTERS:
*RAISED 1/32" MINIMUM
*FULL CAPS
*SAN SERIF TYPE STYLE
*CHARACTERS MUST BE RED

LOCATIONS:
*AUDITORIUM & EACH BALCONY
*GYMNASIUM
*LARGE GROUP INSTRUCTION
*CAFETERIA
*MUSIC ROOMS
*POOL

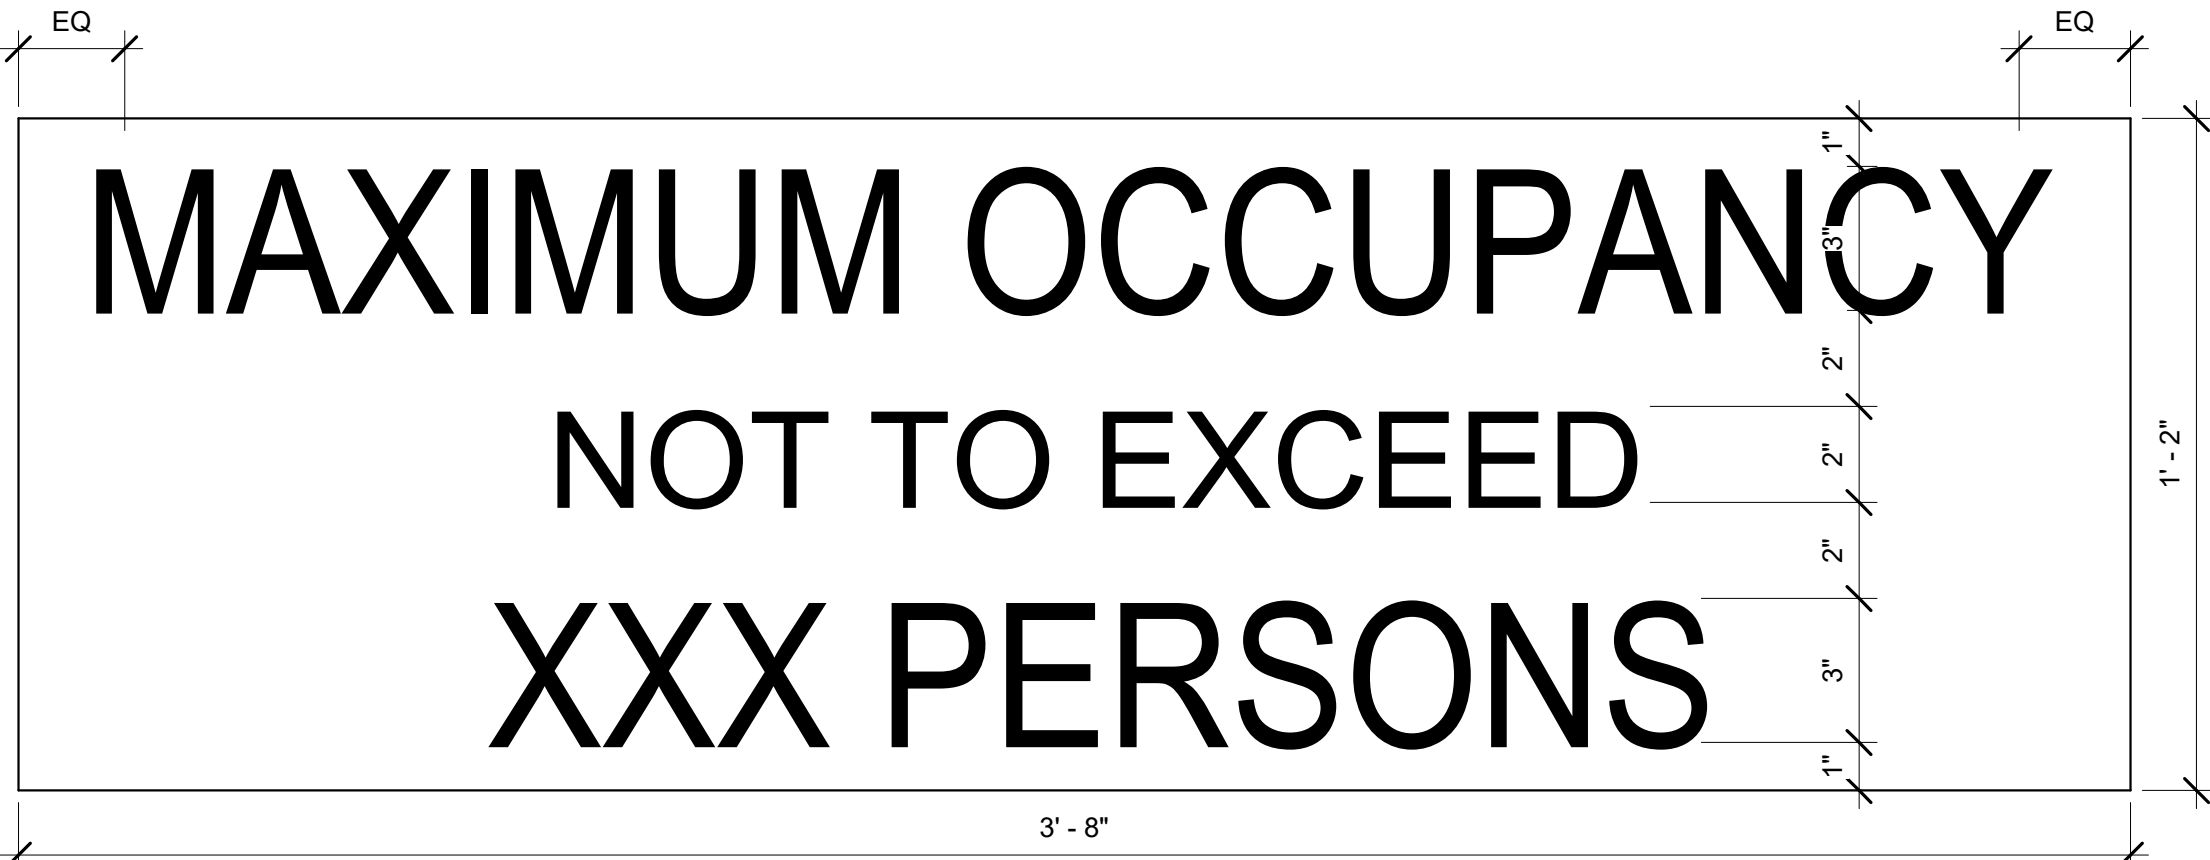


TYPE 1 - Typical Maximum Occupancy Plaque
TYPE 1a - Typical Maximum Occupancy Plaque for Courtyard

3 Typical Maximum Occupancy Plaque
3" = 1'-0"


NON-GLARE SURFACE:
*TYPICAL FOR ENTIRE SIGN

PICTOGRAM:
*APPEARS ON MINIMUM 6"x6" CLEAR FIELD
*PICTOGRAM NOT REQUIRED TO BE RAISED
*PICTOGRAM MUST CONTRAST WITH BACKGROUND

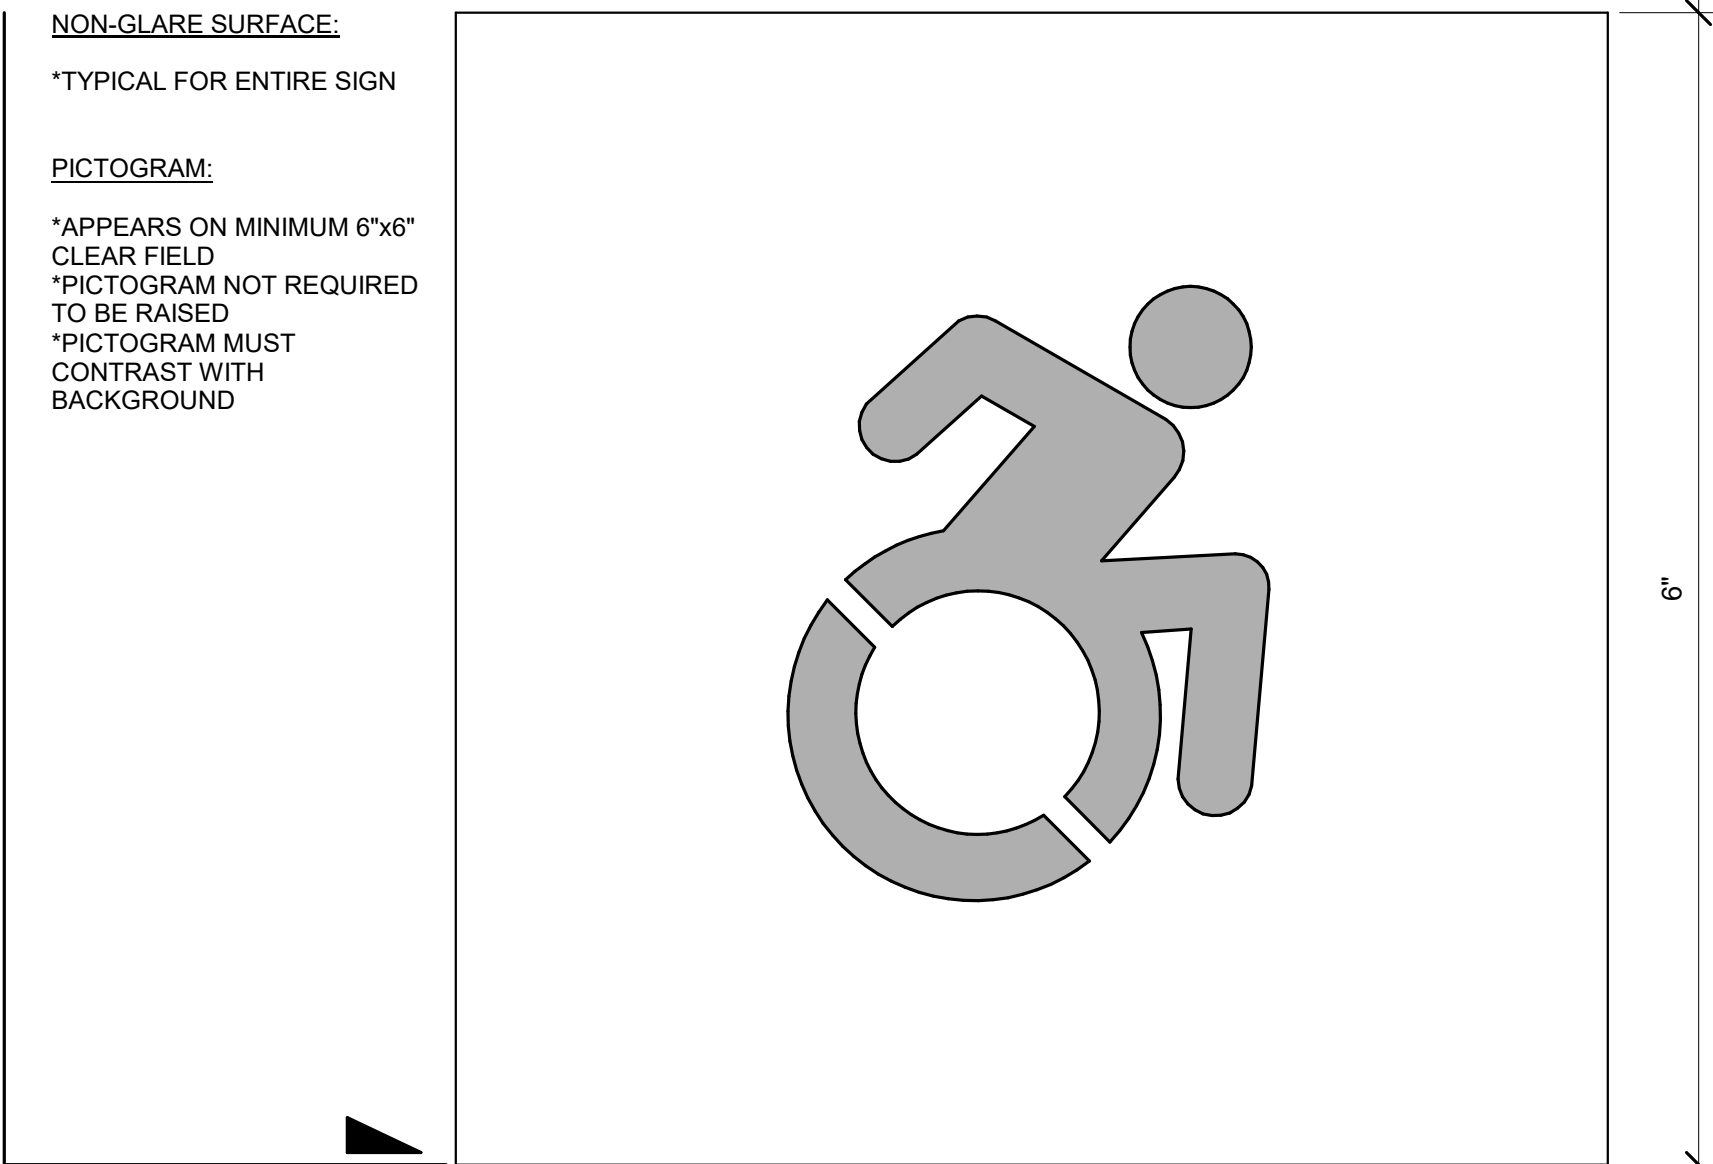

TYPE 10a - Unisex Accessible Plaque

TACTILE CHARACTERS:
*5/8" MINIMUM CAP LETTER HEIGHT
*RAISED 1/32" MINIMUM
*FULL CAPS
*SAN SERIF TYPE STYLE
*CHARACTERS MUST CONTRAST WITH BACKGROUND

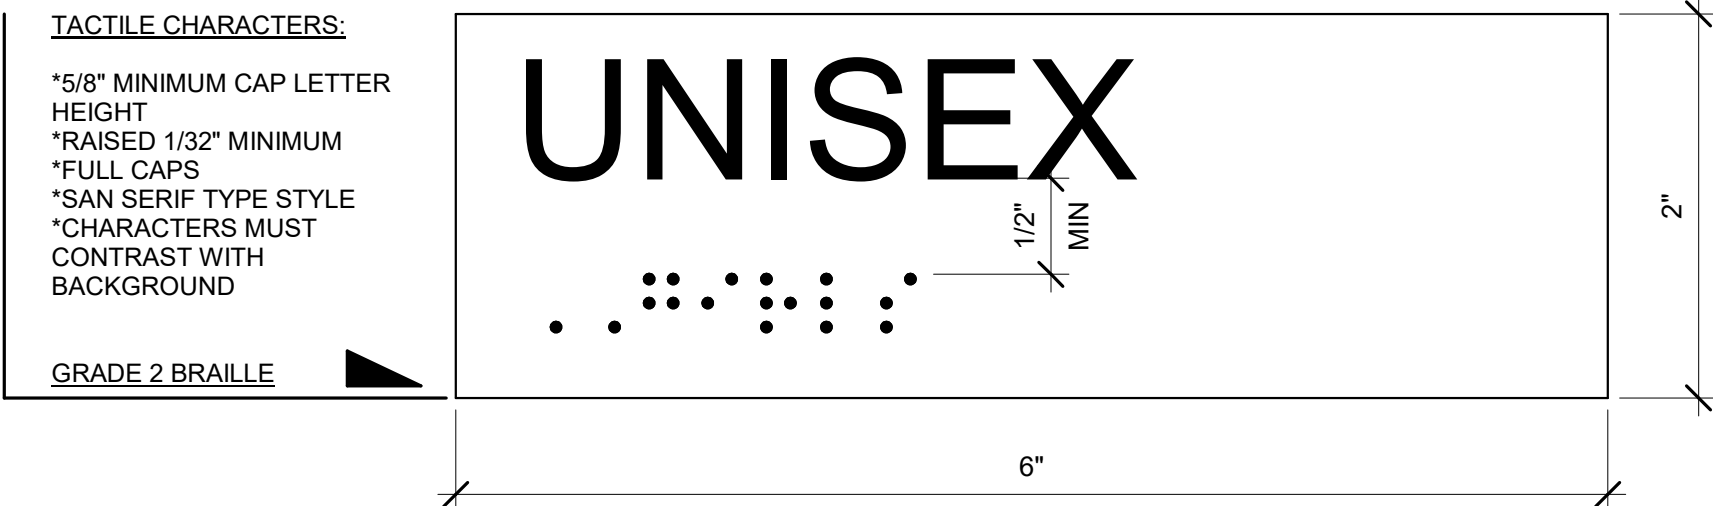


TYPE 7a - Typical Room Name Plaque

5 Restroom Plaque- Unisex/Gender Neutral
12" = 1'-0"


NON-GLARE SURFACE:
*TYPICAL FOR ENTIRE SIGN

PICTOGRAM:
*APPEARS ON MINIMUM 6"x6" CLEAR FIELD
*PICTOGRAM NOT REQUIRED TO BE RAISED
*PICTOGRAM MUST CONTRAST WITH BACKGROUND

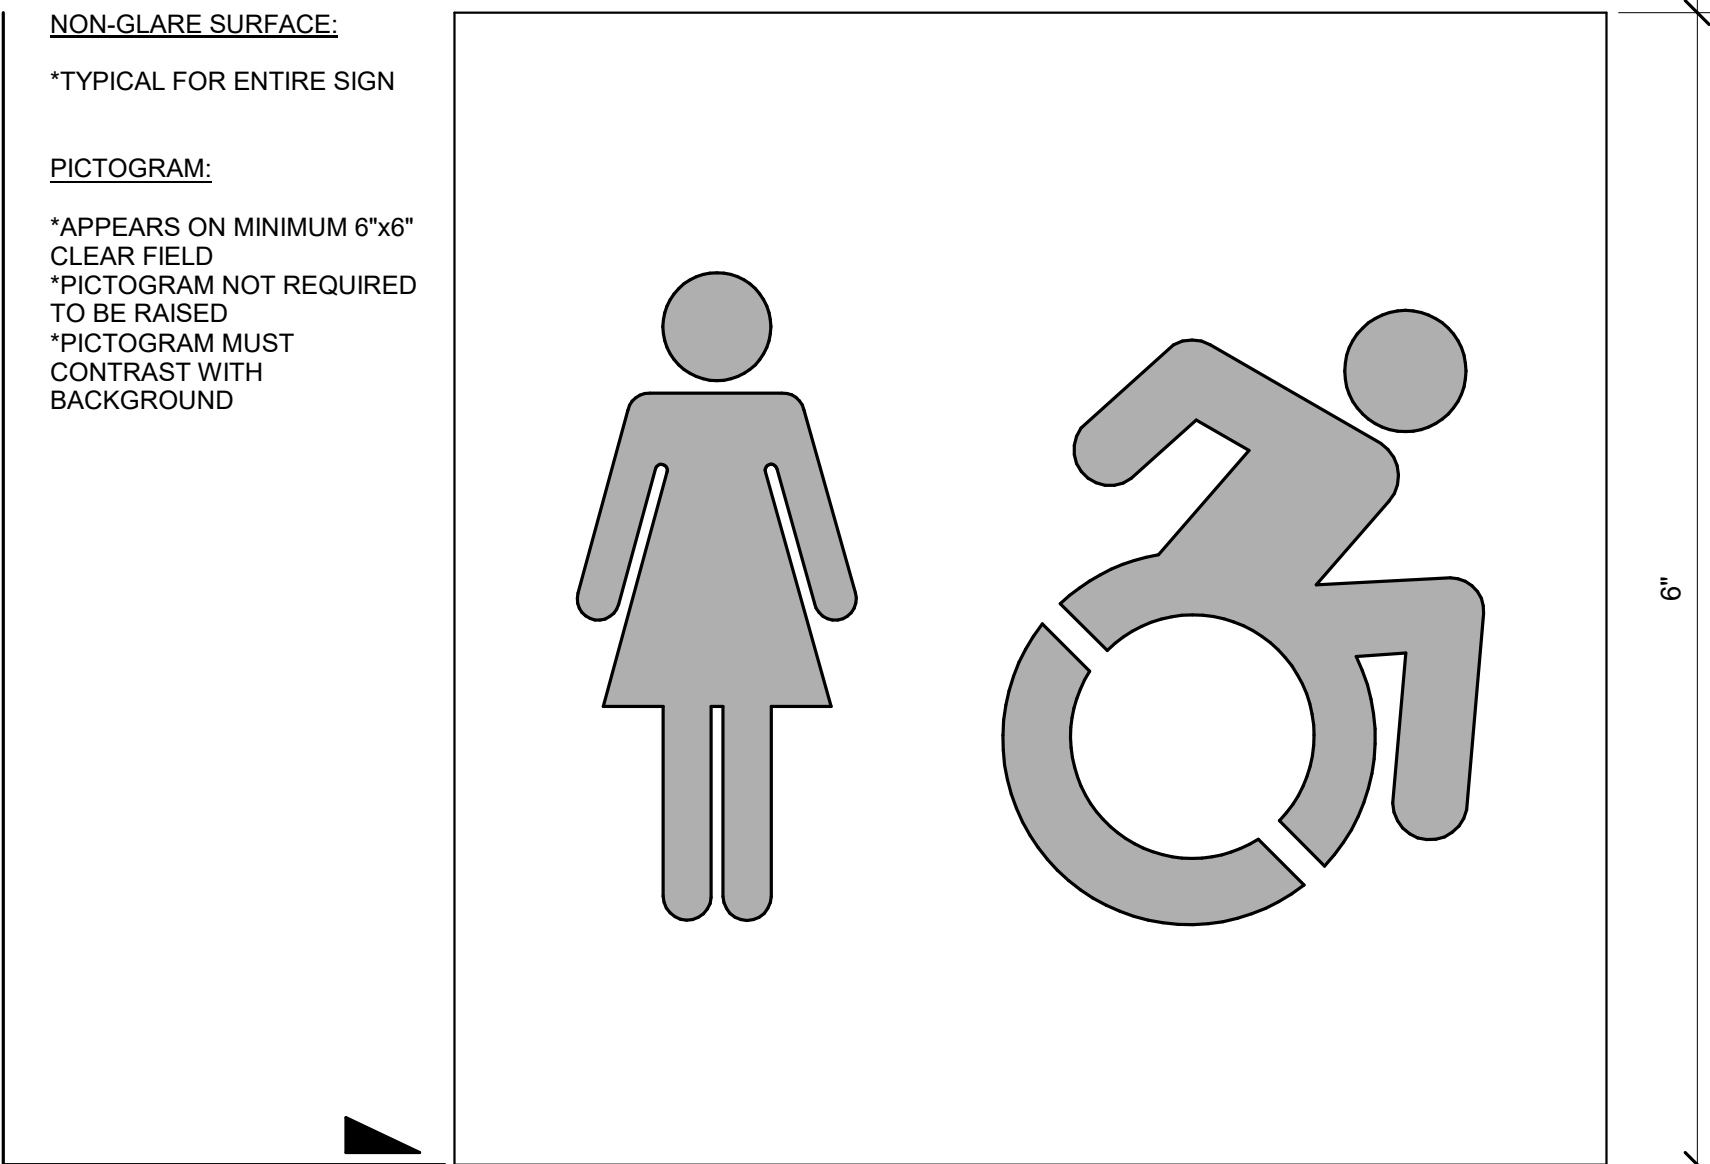

TYPE 8 - Girls'/Women's Restroom Plaque
TYPE 9 - Boys'/Men's Restroom Plaque (SIM)
TYPE 10 - Unisex Accessible Plaque (SIM)

TACTILE CHARACTERS:
*5/8" MINIMUM CAP LETTER HEIGHT
*RAISED 1/32" MINIMUM
*FULL CAPS
*SAN SERIF TYPE STYLE
*CHARACTERS MUST CONTRAST WITH BACKGROUND

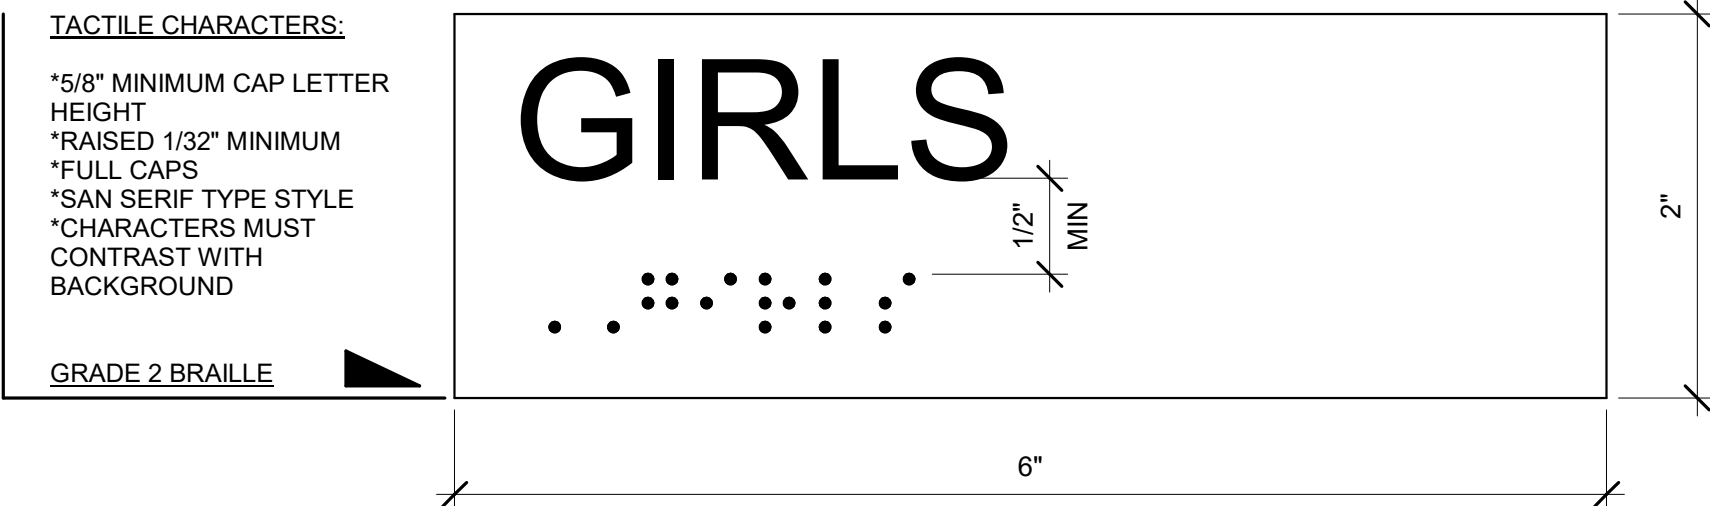


TYPE 7 - Typical Room Name Plaque

4 Restroom Plaque
12" = 1'-0"

Signage Notes


- ALL ROOM NAMES AND NUMBERS ARE SUBJECT TO CHANGE, SUPPLIER TO VERIFY WITH SCHOOL DISTRICT DURING CONSTRUCTION PHASE, PRIOR TO SUBMITTAL PHASE, FOR FINAL ROOM NAMES AND NUMBERS.
- ALL PERMANENT ROOMS TO RECEIVE ROOM IDENTIFICATION SYSTEM CONTAINING BOTH TEXT AND ROOM NUMBERS.
- PROVIDE BARRIER-FREE AND TACTILE SIGNAGE AT ALL LOCATIONS REQUIRED BY CODE AND AS SHOWN ON THE ARCHITECTURAL DRAWINGS.
- COORDINATE MOUNTING HEIGHTS AS PER CABO/ANSI A117.1 AND AS PER MANUFACTURER'S RECOMMENDATIONS.
- ALL COLORS TO BE ISSUED DURING CONSTRUCTION.
- PROVIDE SIGNS AS PER SIGNAGE SCHEDULE AS REQUIRED BY CODE AND SIGNAGE DRAWING.
- REFER TO SPECIFICATIONS SECTION 10 14 00 FOR MORE INFORMATION.

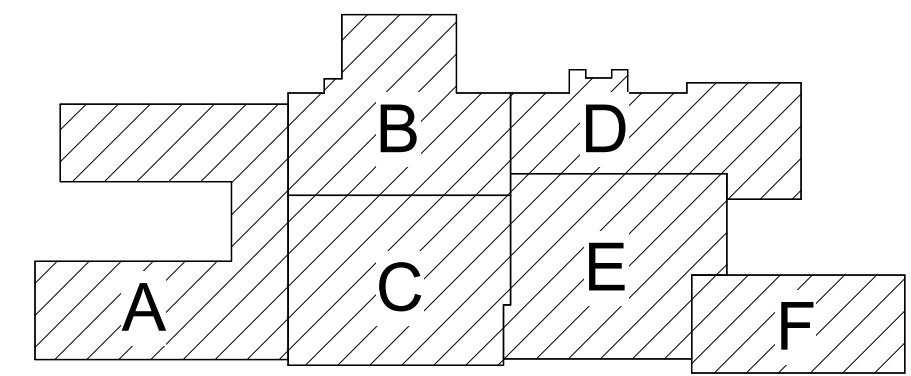

Key Plan
N.T.S.

SED Control No. 60-01-01-06-0-018-023

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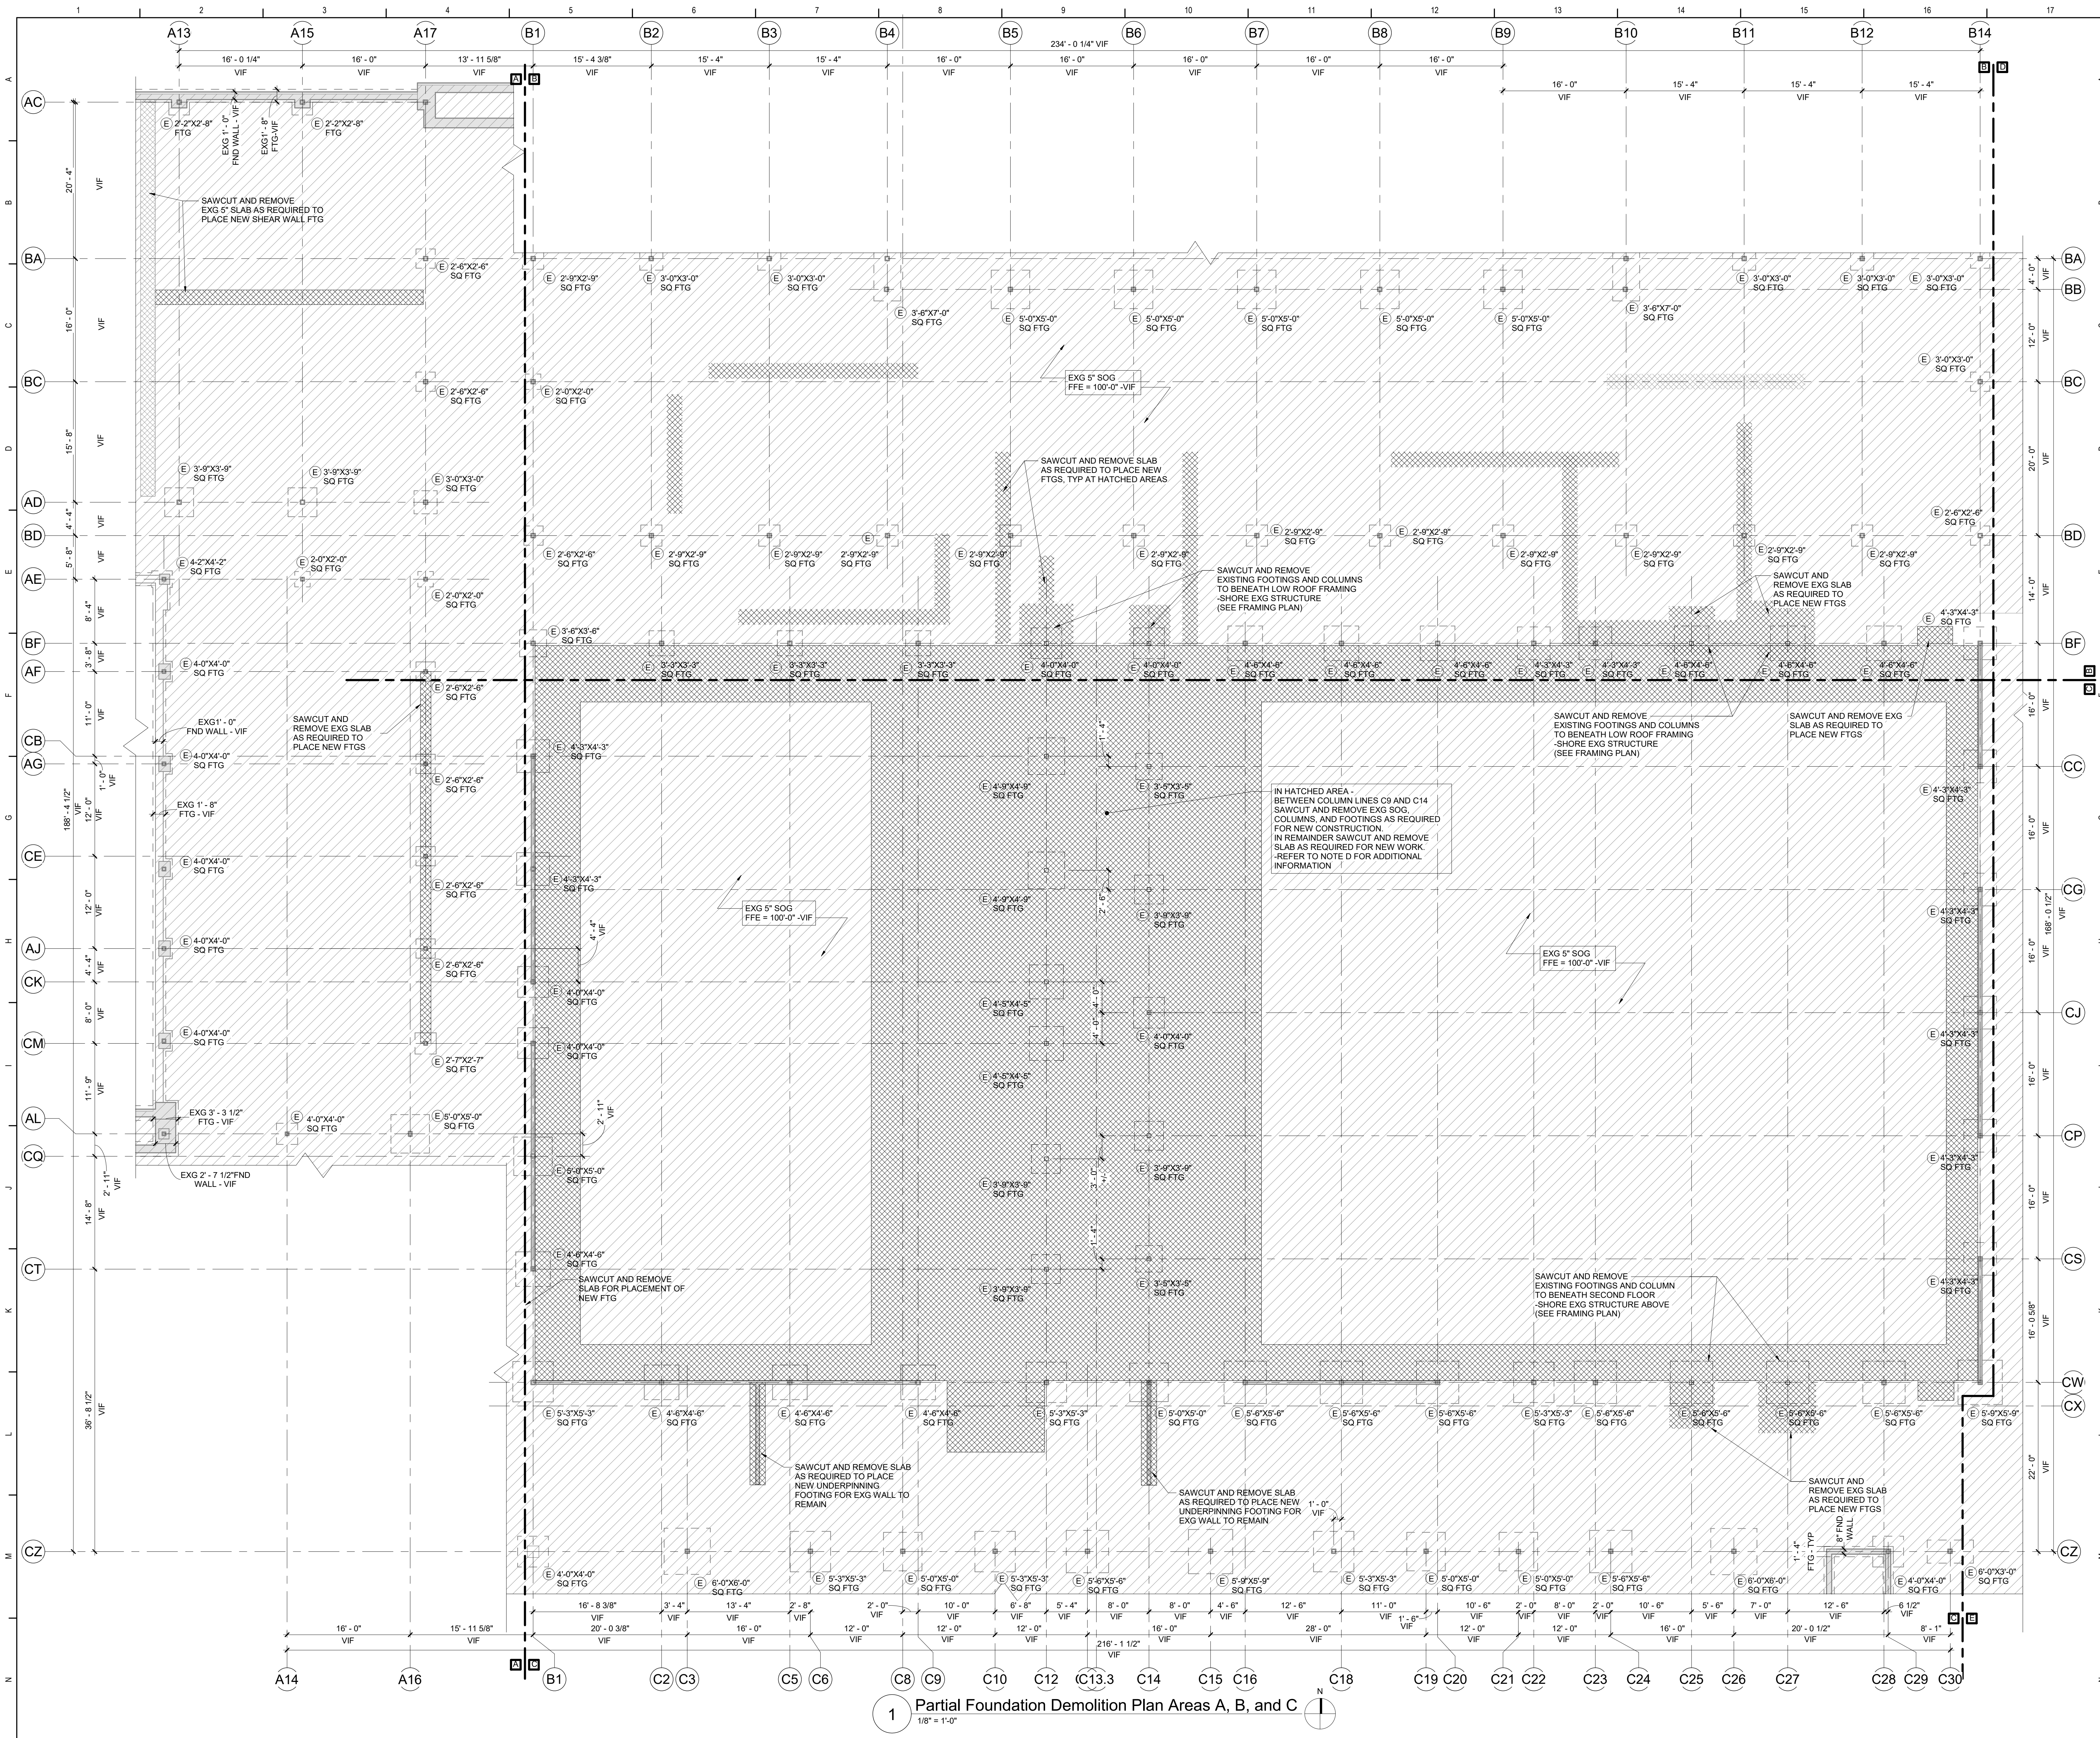
TETRA TECH
ARCHITECTS & ENGINEERS

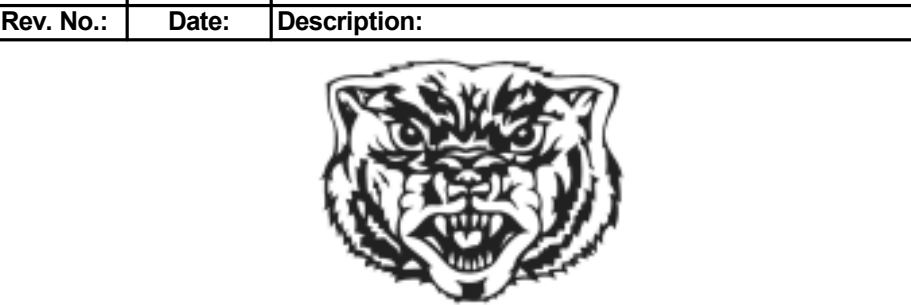Waverly Central School District
Waverly, NY

Additions and Alterations to:
Waverly Jr. Sr. High School

Signage

Drawn By: TTAE	Date: 05/19/2023	Drawing Number:
Project No.: 339070-22003	AA960	




General Notes:

- COORDINATE ALL DEMOLITION WORK W/ A- SERIES DEMOLITION DRAWINGS, ABATEMENTS DRAWINGS, AND WITH NEW STRUCTURAL WORK (REFER TO STRUCTURAL PLANS AND DETAILS.)
- COORDINATE ALL DEMOLITION WORK WITH SPEC SECT 01 12 50.
- CONTRACTOR TO VERIFY ALL EXISTING INFORMATION AND CONDITIONS. NOTIFY A/E OF ANY DISCREPANCIES PRIOR TO COMMENCING WORK.
- FOUNDATIONS TO BE DEMOLISHED INCLUDE FOUNDATIONS ALONG LISTED COLUMN LINES:
C12: BF, CB-CT
C14: BF, CC-CS
C25: BF, CW
C27: BF, CW

Asbestos Awareness – CMU Wall Paint:

- CMU WALL PAINT IS ASBESTOS CONTAINING AND IS PRESENT IN AREAS OF SCHEDULED WORK. ASBESTOS PAINT IS LIMITED TO CMU WALLS.
- PERFORM WORK SUCH THAT NO PAINTED CMU WALL SURFACES ARE DISTURBED. DISTURBANCE INCLUDES, BUT IS NOT LIMITED TO DETACHMENT OF EXISTING ITEMS FROM THE WALL.
- ATTACHMENT OF NEW ITEMS TO THE WALL.
- ADDITIONAL ASBESTOS CONTAINING ITEMS ARE PRESENT AND INDICATED ELSEWHERE WITHIN THE FACILITIES. REFER TO ON-SITE ASBESTOS DOCUMENTATION FOR FURTHER INFORMATION. SHOULD ANY PAINTED CMU WALL SURFACE BE REQUIRED TO BE IMPACTED OR DISTURBED, CONSULT THE OWNER'S ENVIRONMENTAL CONSULTANT.

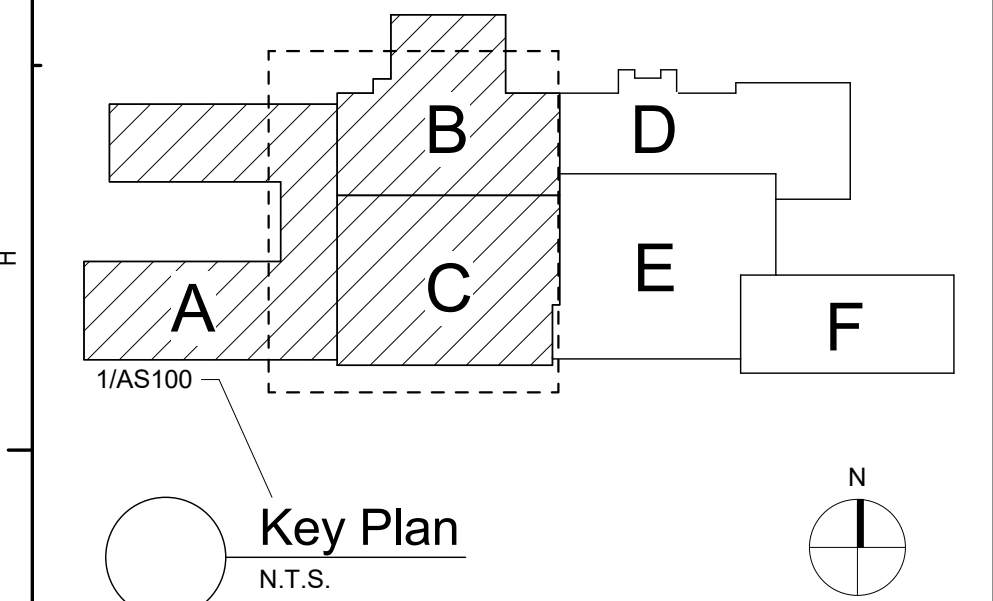

SED Control No. 60-01-01-06-0-018-023

Rev. No.: Date: Description:



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Waverly Central School District
Waverly, NY

Additions and Alterations to:
Waverly Jr. Sr. High School

Partial Foundation Demolition Plan
Areas A, B, and C

Drawn By: NDC/kjr Date: 05/19/2023 Drawing Number:

Project No.: 339070-22003 AS100





4. CMU WALL PAINT IS ASBESTOS CONTAINING AND IS PRESENT IN AREAS OF SCHEDULED WORK. ASBESTOS PAINT IS LIMITED TO CMU WALLS.

5. PERFORMANCE WORK SUCH THAT NO PAINTED CMU WALL SURFACES ARE DISTURBED. DISTURBANCE INCLUDES, BUT IS NOT LIMITED TO DETACHMENT OF EXISTING ITEMS FROM THE WALL, ATTACHMENT OF NEW ITEMS TO THE WALL.

6. ADDITIONAL ASBESTOS CONTAINING ITEMS ARE PRESENT AND INDICATED ELSEWHERE WITHIN THE FACILITIES. REFER TO ON-SITE ASBESTOS DOCUMENTATION FOR FURTHER INFORMATION.

7. SHOULD ANY PAINTED CMU WALL SURFACE BE REQUIRED TO BE REMOVED OR DISTURBED, THE OWNER SHALL CONSULT THE OWNER'S ENVIRONMENTAL CONSULTANT.

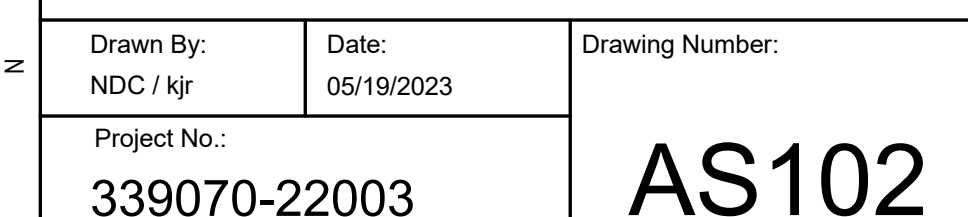

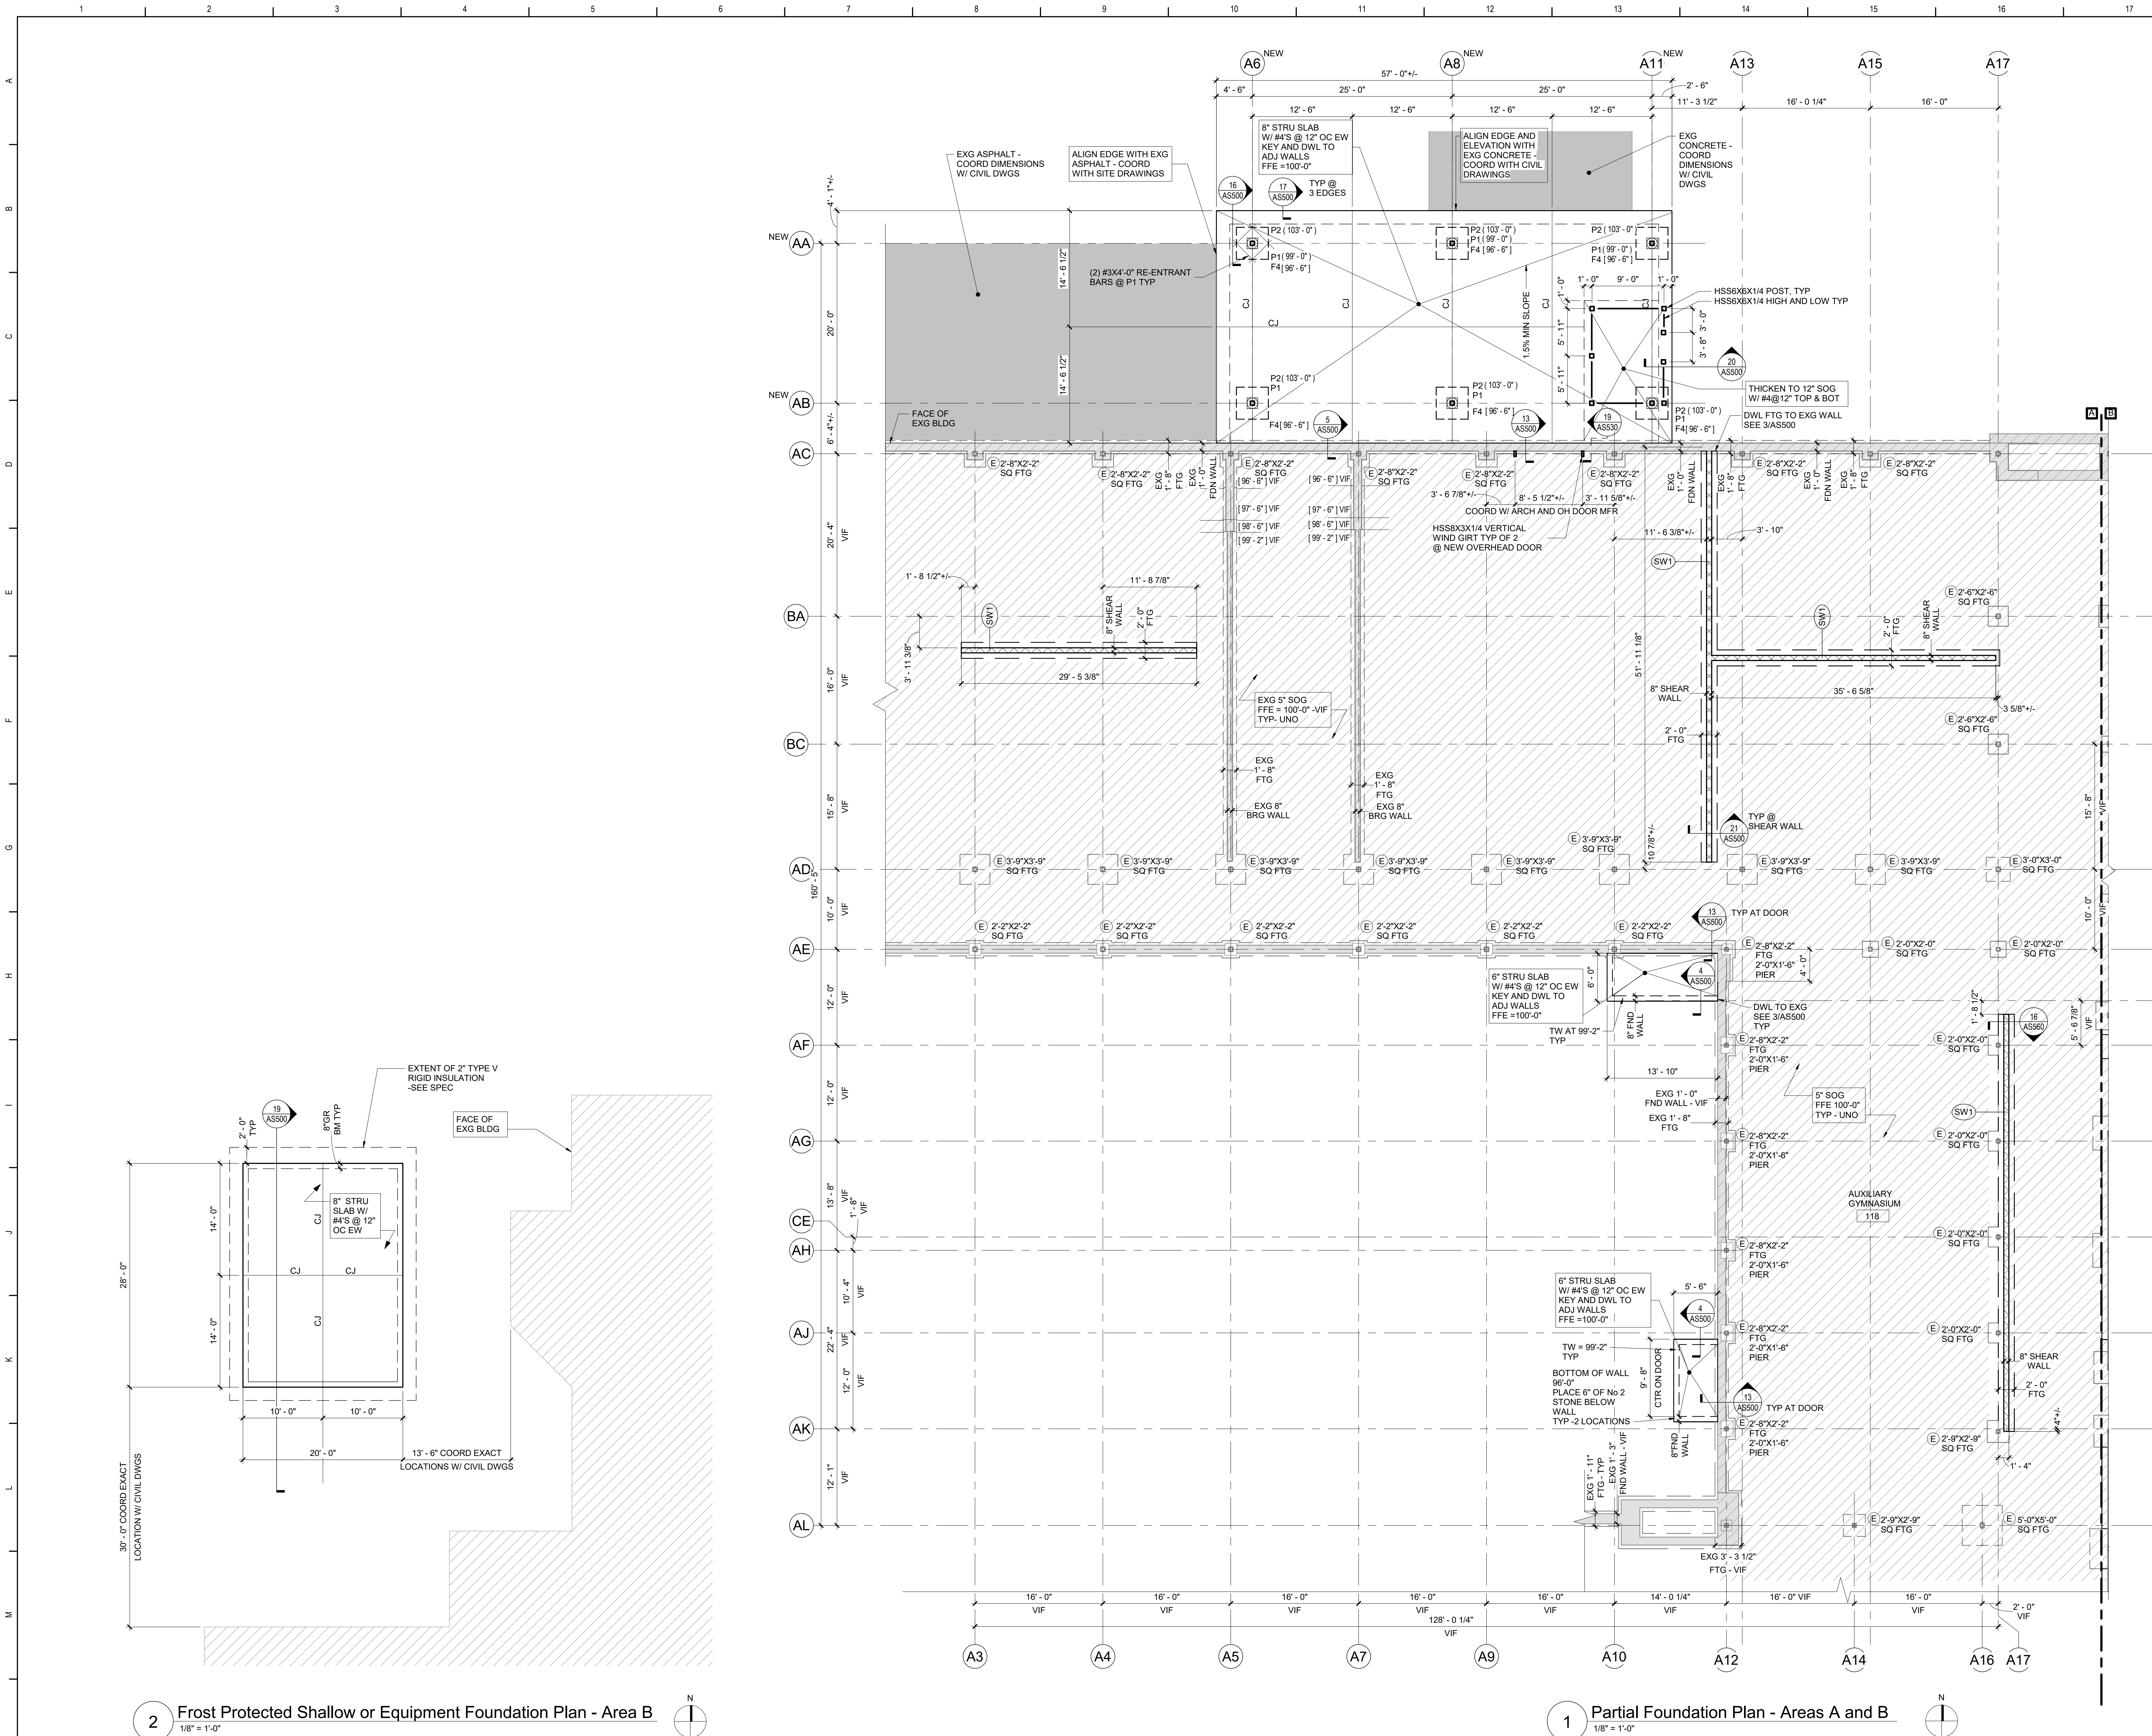

General Notes:

- A. DIMENSIONS AND ELEVATIONS SHOWN ON PLAN AS PLUS/MINUS (+/-) AND VIF ARE TO BE CONSIDERED APPROXIMATE. EXACT VALUES FOR ALL (+/-) AND VIF DIMENSIONS ARE TO BE DETERMINED BY THE CONTRACTOR IN THE FIELD THROUGH A PRELIMINARY BUILDING LAYOUT CONTRACTOR TO VERIFY EXISTING DIMENSIONS, ELEVATIONS AND CONDITIONS AND NOTIFY A/E OF ANY DISCREPANCIES PRIOR TO COMMENCING WORK. COORDINATE INFORMATION WITH OTHER TRADES.
- B. ALL UNDERGROUND UTILITIES WITHIN THE NEW CANOPY FOOTPRINT ARE TO BE REMOVED PRIOR TO BEGINNING FOUNDATION WORK IN THAT AREA (UNLESS NOTED OTHERWISE). REFER TO SITE DWGS FOR REMOVAL.
- C. BOTTOM OF NEW FOOTING ELEVATIONS ARE TO MATCH THE BOTTOM OF ADJACENT EXISTING FOOTING ELEVATIONS UNLESS NOTED OTHERWISE.
- D. TOP OF EXTERIOR FOOTING ELEVATION IS [96'-6"] UNLESS INDICATED AS [XXX-XX] ON PLAN.
- E. TOP OF INTERIOR FOOTING ELEVATION IS [99'-2"] UNLESS INDICATED AS [XXX-XX] ON PLAN.
- F. ALL CONTINUOUS FOOTINGS ARE 2'-0" WIDE UNLESS OTHERWISE NOTED.
- G. REFER TO SHEET AS600 FOR GENERAL NOTES, PIER, FOOTING ELEVATION AND DETAILS.
- H. REFER TO SHEET AS500 FOR TYPICAL SHEAR WALL (SW).
- I. TOP OF FOUNDATION WALL ELEVATION IS EQUAL TO DATUM ELEVATION 100'-0" UNO.
- J. TOP OF PIER ELEVATION IS [8"] FROM DATUM ELEVATION 100'-0", UNLESS INDICATED AS [XXX-XX] ON PLAN.
- K. REFER TO SHEETS AS500 FOR TYPICAL FOUNDATION WALL AND SLAB DETAILS.
- L. CONTROL JOINTS ARE SHOWN IN THE SLAB ON GRADE FOR: CERTAIN EXPOSED SLAB AREAS. DIAMOND ISOLATION JOINT AROUND COLUMNS ARE NOT SHOWN ON PLAN FOR CLARITY. JOINTS IN OTHER AREAS ARE NOT SHOWN. INSTALL PER SPEC AND DETAILS. SEE TYPICAL DETAILS ON SHEET AS500.
- M. FINISHED FLOOR DATUM ELEVATION OF 100'-0", AS SHOWN ON ARCHITECTURAL AND STRUCTURAL DRAWINGS, CORRESPONDS TO ELEVATION 860.8', AS SHOWN ON SITE AND SURVEY DRAWINGS.
- N. ALL GRID LINES ARE EXG. UNO.

Asbestos Awareness – CMU Wall Paint:

- A. CMU WALLS.
- B. PERFORM WORK SUCH THAT NO PAINTED CMU WALL SURFACES ARE DISTURBED. DISTURBANCE INCLUDES, BUT IS NOT LIMITED TO DETACHMENT OF EXISTING ITEMS FROM THE WALL, ATTACHMENT OF NEW ITEMS TO THE WALL.
- C. ADDITIONAL ASBESTOS CONTAMINATING ITEMS ARE PRESENT AND INDICATED ELSEWHERE WITHIN THE FACILITIES. REFER TO ON-SITE ASBESTOS DOCUMENTATION FOR FURTHER INFORMATION.
- D. SHOULD ANY PAINTED CMU WALL SURFACE BE REQUIRED TO BE IMPACTED OR DISTURBED, CONSULT THE OWNER'S ENVIRONMENTAL CONSULTANT.

Key Plan
N.T.S.

SED Control No. 60-01-01-06-0-018-023

Rev. No.	Date	Description

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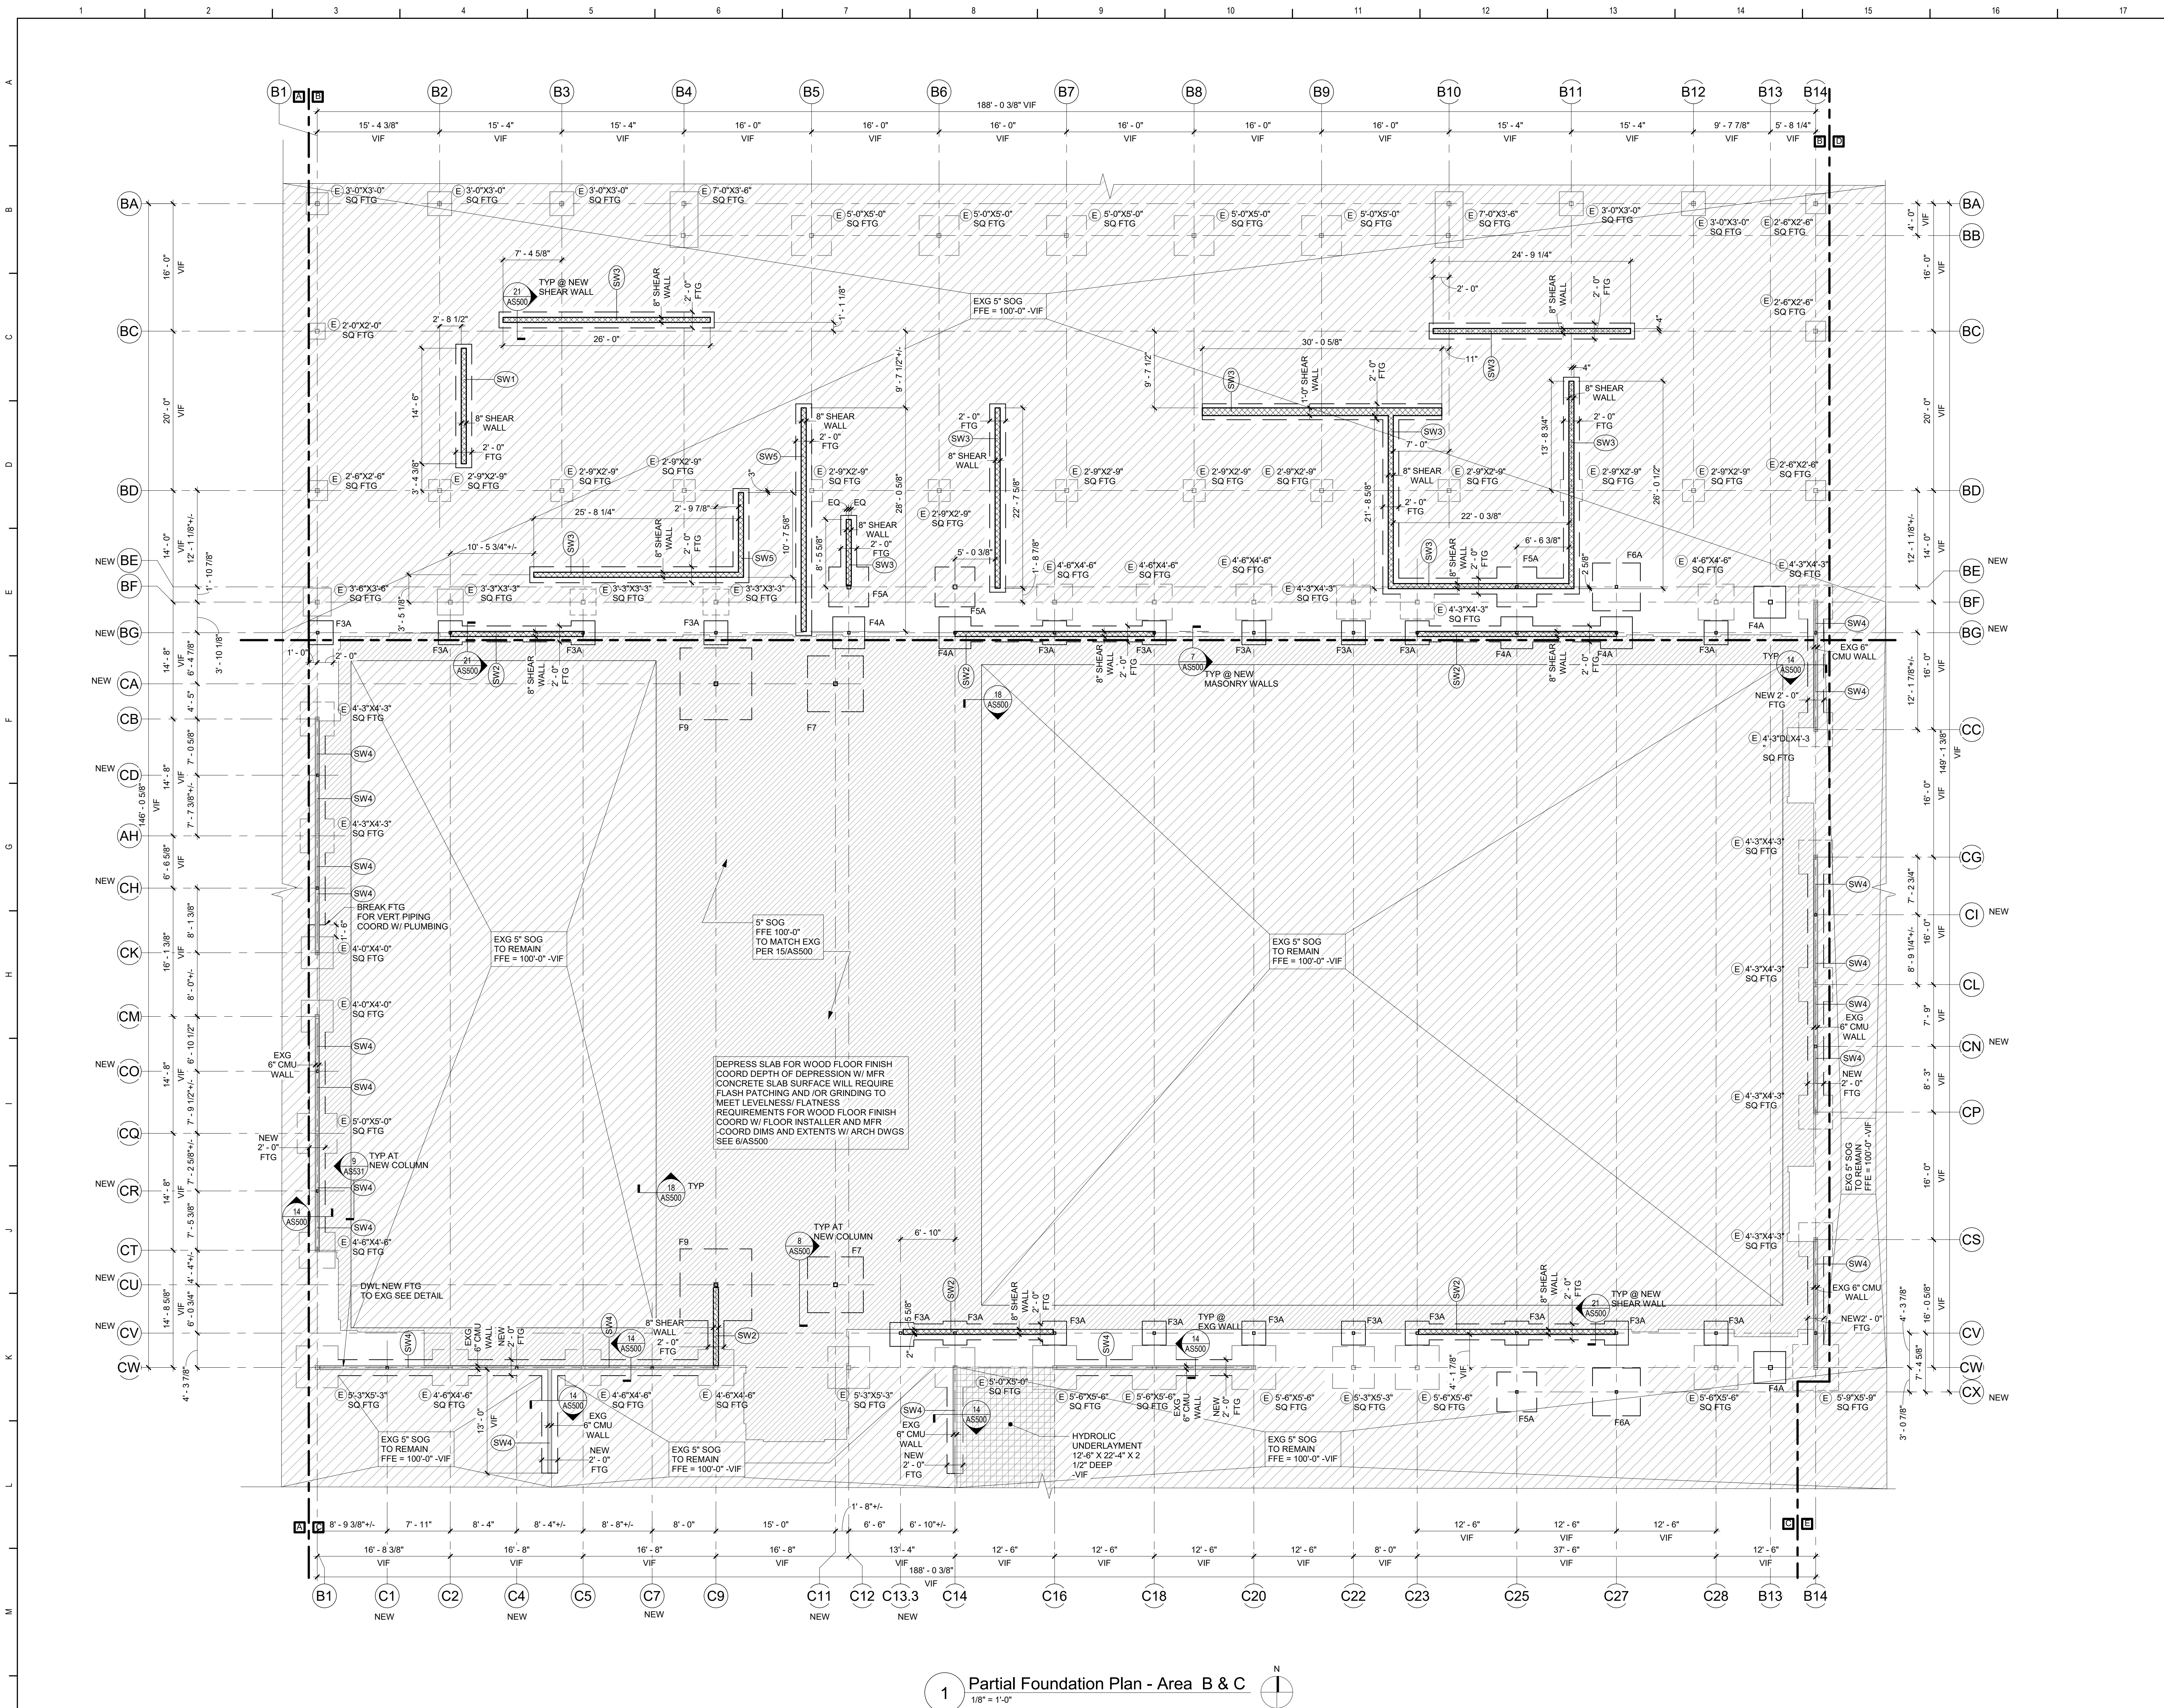
TETRA TECH
ARCHITECTS & ENGINEERS

Waverly Central School District
Waverly, NY

Additions and Alterations to:
Waverly Jr. Sr. High School

Partial Foundation Plans - Areas A and B

Drawn By: NDC/vmm	Date: 05/19/2023	Drawing Number:
Project No.: 339070-22003		AS130



General Notes:

- A. DIMENSIONS AND ELEVATIONS SHOWN ON PLAN AS PLUS/MINUS (+/-) AND VIF ARE TO BE CONSIDERED APPROXIMATE. EXACT VALUES FOR ALL (+/-) AND VIF DIMENSIONS ARE TO BE DETERMINED BY THE CONTRACTOR IN THE FIELD THROUGH A PRELIMINARY BUILDING LAYOUT CONTRACTOR TO VERIFY EXISTING DIMENSIONS, ELEVATIONS AND CONDITIONS AND NOTIFY A/E OF ANY DISCREPANCIES PRIOR TO COMMENCING WORK. COORDINATE INFORMATION WITH OTHER TRADES.
- B. BOTTOM OF NEW FOOTING ELEVATIONS ARE TO MATCH THE BOTTOM OF ADJACENT EXISTING FOOTING ELEVATIONS UNLESS NOTED OTHERWISE.
- C. TOP OF INTERIOR FOOTING ELEVATION IS [99'-2"], UNLESS INDICATED AS [XX'-XX"] ON PLAN.
- D. ALL CONTINUOUS FOOTINGS ARE 2'-0" WIDE UNLESS OTHERWISE NOTED.
- E. REFER TO SHEET AS800 FOR GENERAL NOTES, PIER, FOOTING AND COLUMN SCHEDULES.
- F. REFER TO ARCHITECTURAL DRAWINGS FOR EXACT LOCATION OF MASONRY OPENINGS AT DOORS IN EXTERIOR WALLS FOR RECESS IN TOP OF FOUNDATION WALL.
- G. REFER TO SHEET AS880 FOR TYPICAL SHEAR WALL (SW) ELEVATION AND DETAILS.
- H. TOP OF FOUNDATION WALL ELEVATION IS EQUAL TO DATUM ELEVATION 100'-0" UNO.
- I. REFER TO SHEETS AS500 FOR TYPICAL FOUNDATION WALL AND SLAB DETAILS.
- J. SEE ARCHITECTURAL DRAWINGS FOR EXACT LOCATION AND DEPTH OF SLAB DEPRESSIONS AND RECESSES.
- K. FINISHED FLOOR DATUM ELEVATION OF 100'-0", AS SHOWN ON ARCHITECTURAL AND STRUCTURAL DRAWINGS, CORRESPONDS TO ELEVATION 860.8', AS SHOWN ON SITE AND SURVEY DRAWINGS.
- L. ALL SLABS ON GRADE ARE TO BE 5" THICK, 3500 PSI FIBER REINFORCED CONCRETE UNLESS NOTED OTHERWISE ON PLANS.
- M. ALL GRID LINES ARE EXG. UNO.

Asbestos Awareness – CMU Wall Paint:

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- B. PERFORM WORK SUCH THAT NO PAINTED CMU WALL SURFACES ARE DISTURBED. DISTURBANCE INCLUDES, BUT IS NOT LIMITED TO DETACHMENT OF EXISTING ITEMS FROM THE WALL.
- C. ATTACHMENT OF NEW ITEMS TO THE WALL.
- D. ADDITIONAL ASBESTOS CONTAINING ITEMS ARE PRESENT AND INDICATED ELSEWHERE WITHIN THE FACILITIES. REFER TO ON-SITE ASBESTOS DOCUMENTATION FOR FURTHER INFORMATION. SHOULD ANY PAINTED CMU WALL SURFACE BE REQUIRED TO BE IMPACTED OR DISTURBED, CONSULT THE OWNER'S ENVIRONMENTAL CONSULTANT.

Key Plan
N.T.S.

SED Control No. 60-01-01-06-0-018-023

Rev. No.	Date	Description

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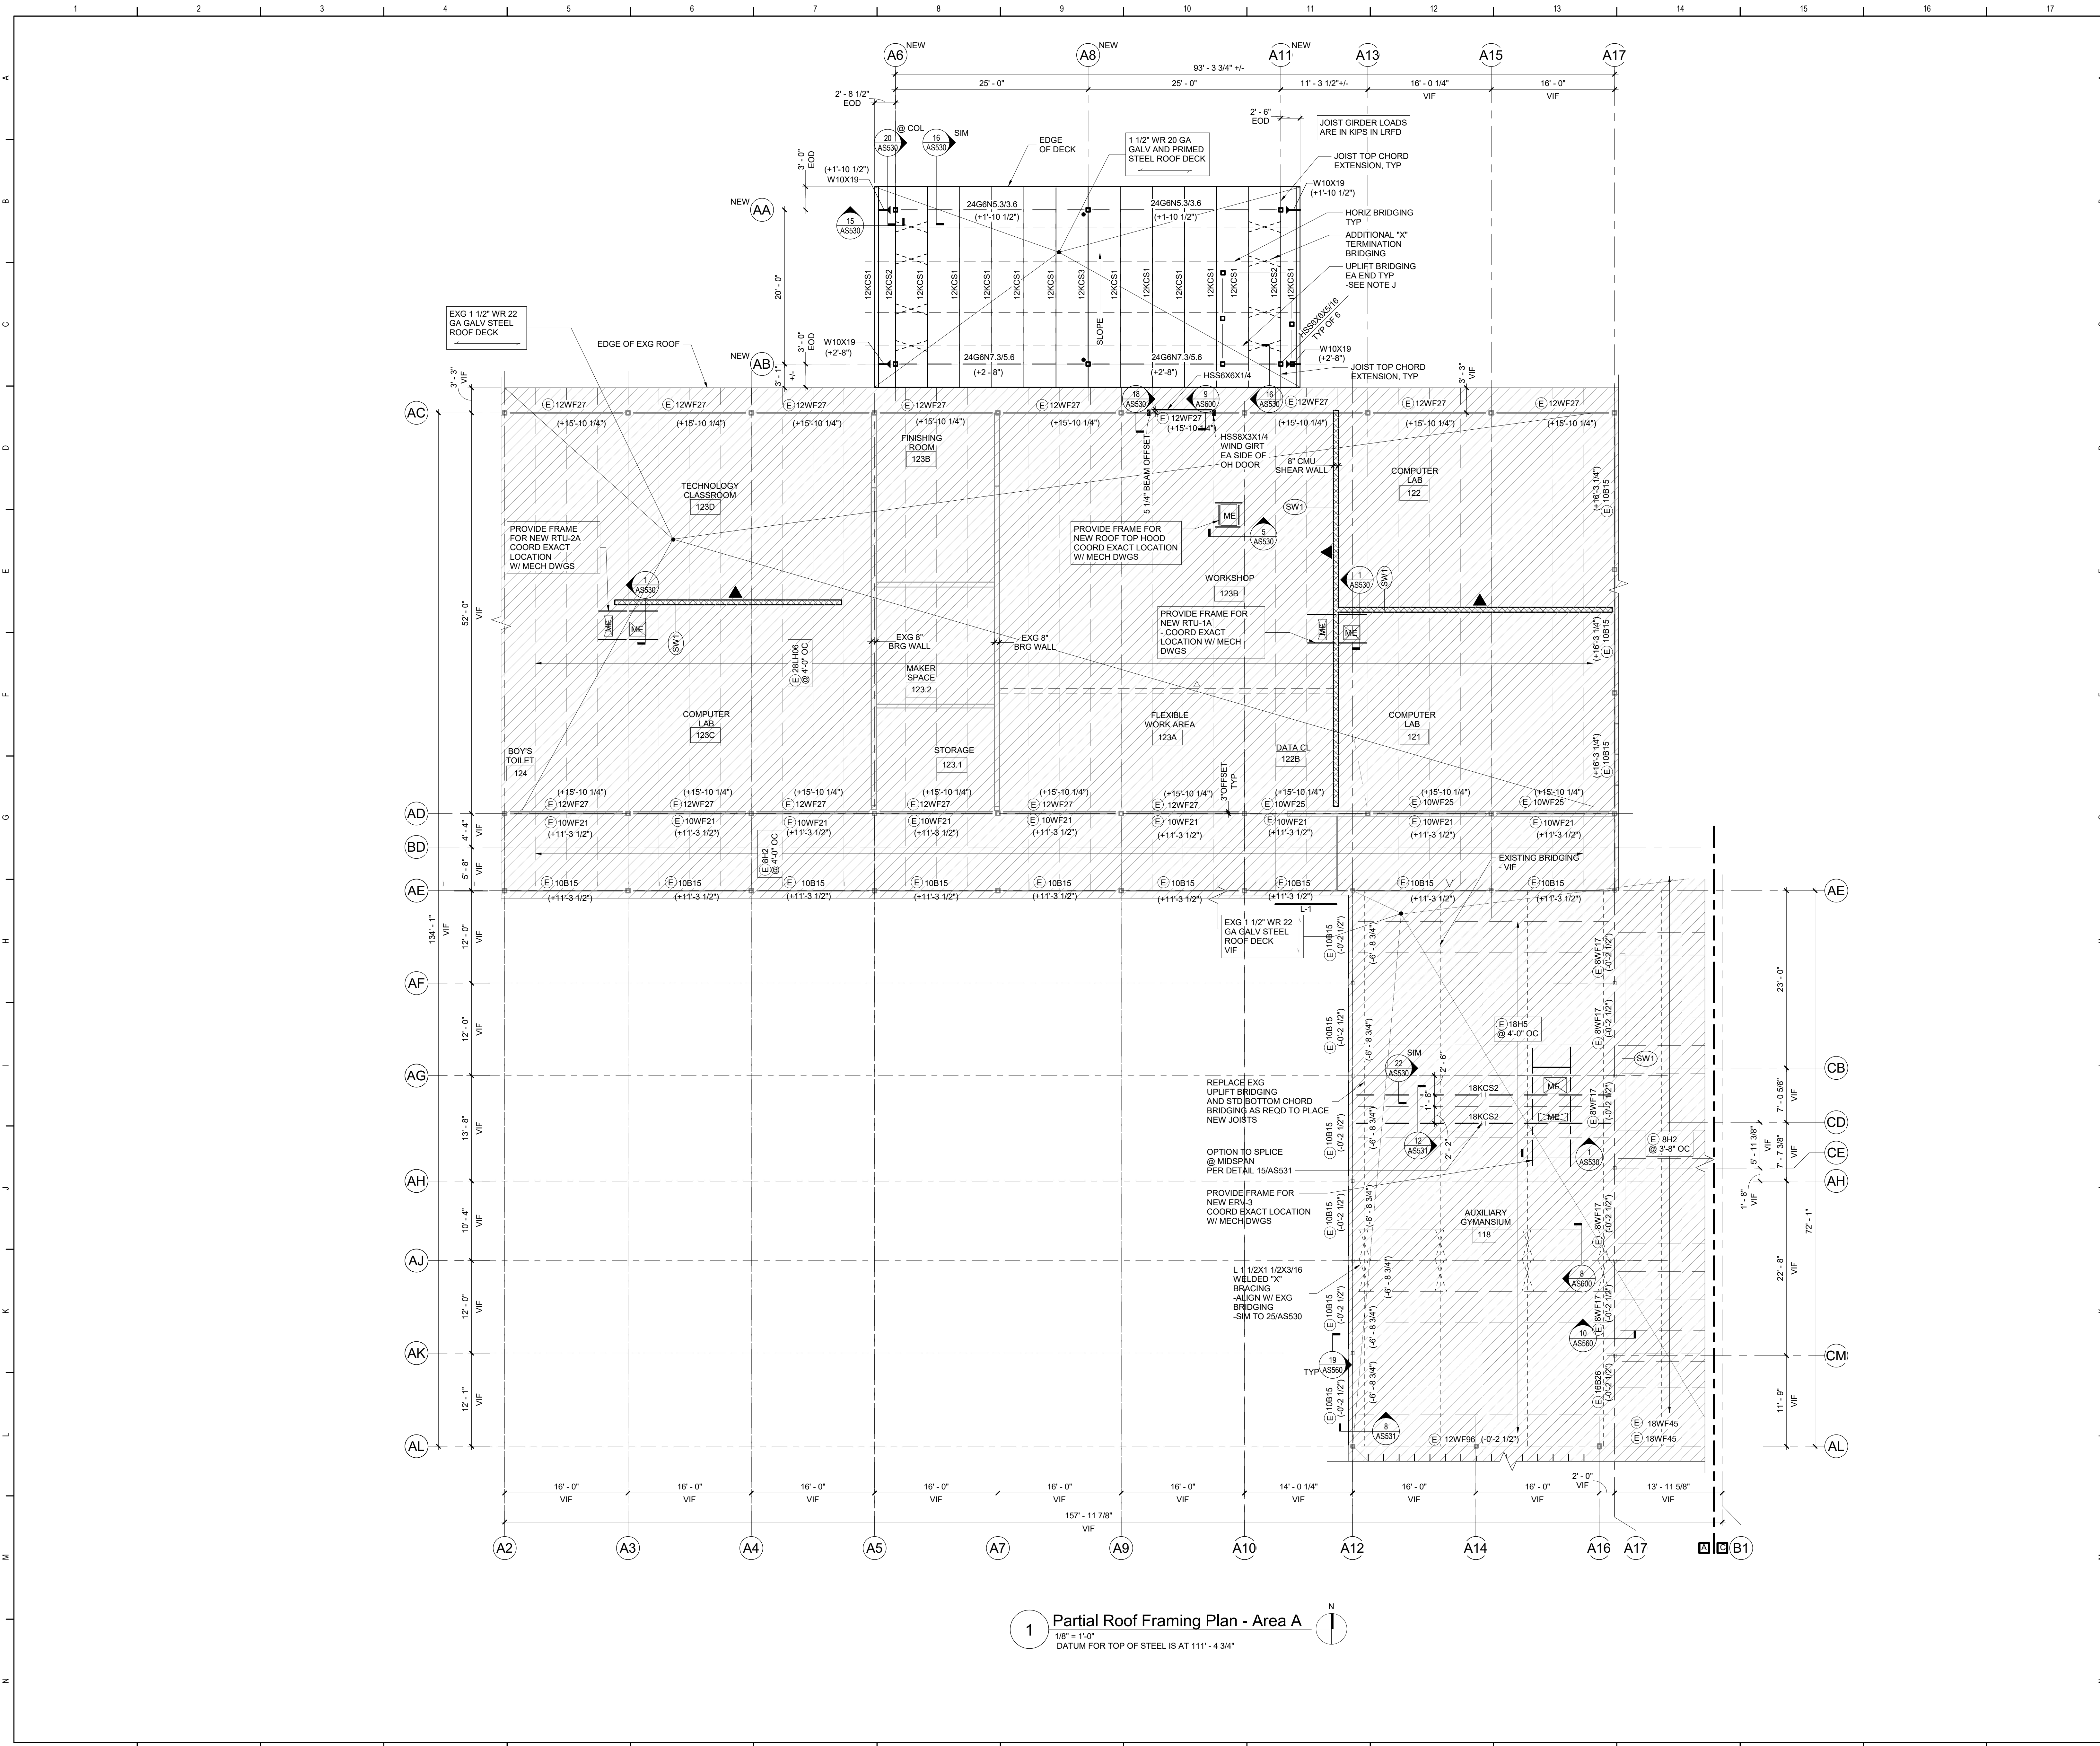
Waverly Central School District
Waverly, NY

Additions and Alterations to:
Waverly Jr. Sr. High School

Partial Foundation Plan - Areas B & C

Drawn By: NDC/vmm	Date: 05/19/2023	Drawing Number:
Project No.: 339070-22003	AS131	

1 Partial Foundation Plan - Area B & C
1/8" = 1'-0"




General Notes:

- A. DIMENSIONS AND ELEVATIONS SHOWN ON PLAN AS PLUS/MINUS (+/-) AND VIF ARE TO BE CONSIDERED APPROXIMATE. EXACT VALUES FOR ALL (+/-) AND VIF DIMENSIONS ARE TO BE DETERMINED BY THE CONTRACTOR IN THE FIELD THROUGH A PRELIMINARY BUILDING LAYOUT. CONTRACTOR TO VERIFY EXISTING DIMENSIONS, ELEVATIONS AND CONDITIONS AND NOTIFY A/E OF ANY DISCREPANCIES PRIOR TO COMMENCING WORK. COORDINATE INFORMATION WITH OTHER TRADES.
- B. REFER TO SHEET AS600 FOR GENERAL NOTES, LINTEL SCHEDULE AND SPECIFIC LINTEL DETAILS.
- C. REFER TO SHEET AS600 FOR COLUMN SCHEDULE.
- D. REFER TO SHEET AS530 FOR TYPICAL DETAILS.
- E. REFER TO SHEET AS560 FOR TYPICAL SHEAR WALL (SW) ELEVATION AND DETAILS.
- F. REFER TO SHEET AS600 FOR BEAM CONNECTION SCHEDULE.
- G. ROOF DECK TO BE GALVANIZED 1 1/2" WIDE RIBBED 20 GAUGE CORRUGATED STEEL UNLESS OTHERWISE NOTED.
- H. ALL BEAM/JOIST ARE SPACED EQUALLY BETWEEN COLUMN LINE UNO.
- I. ALL GRID LINES ARE EXG. UNO.

Asbestos Awareness – CMU Wall Paint:

- A. CMU WALL PAINT IS ASBESTOS CONTAINING AND IS PRESENT IN AREAS OF SCHEDULED WORK. ASBESTOS PAINT IS LIMITED TO CMU WALLS.
- B. PERFORM WORK SUCH THAT NO PAINTED CMU WALL SURFACES ARE DISTURBED. DISTURBANCE INCLUDES, BUT IS NOT LIMITED TO DETACHMENT OF EXISTING ITEMS FROM THE WALL, ATTACHMENT OF NEW ITEMS TO THE WALL.
- C. ADDITIONAL ASBESTOS CONTAINING ITEMS ARE PRESENT AND INDICATED ELSEWHERE WITHIN THE FACILITIES. REFER TO ON-SITE ASBESTOS DOCUMENTATION FOR FURTHER INFORMATION.
- D. SHOULD ANY PAINTED CMU WALL SURFACE BE REQUIRED TO BE IMPACTED OR DISTURBED, CONSULT THE OWNER'S ENVIRONMENTAL CONSULTANT.

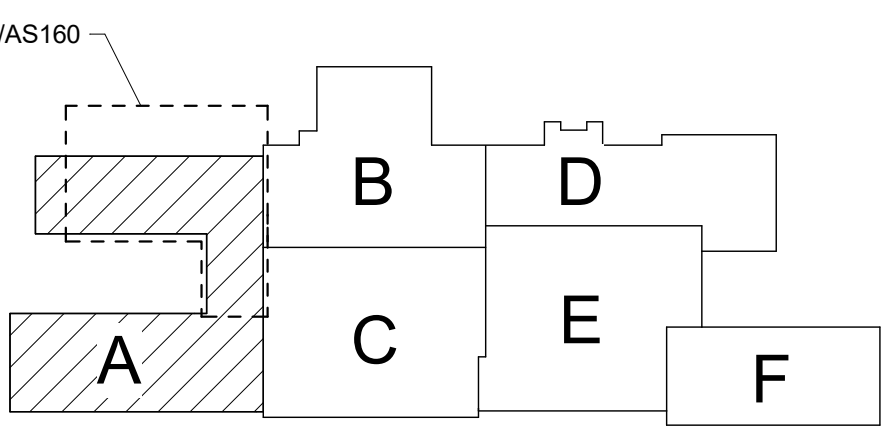

Key Plan
N.T.S.

SED Control No. 60-01-01-06-0-018-023

Rev. No.: Date: Description:



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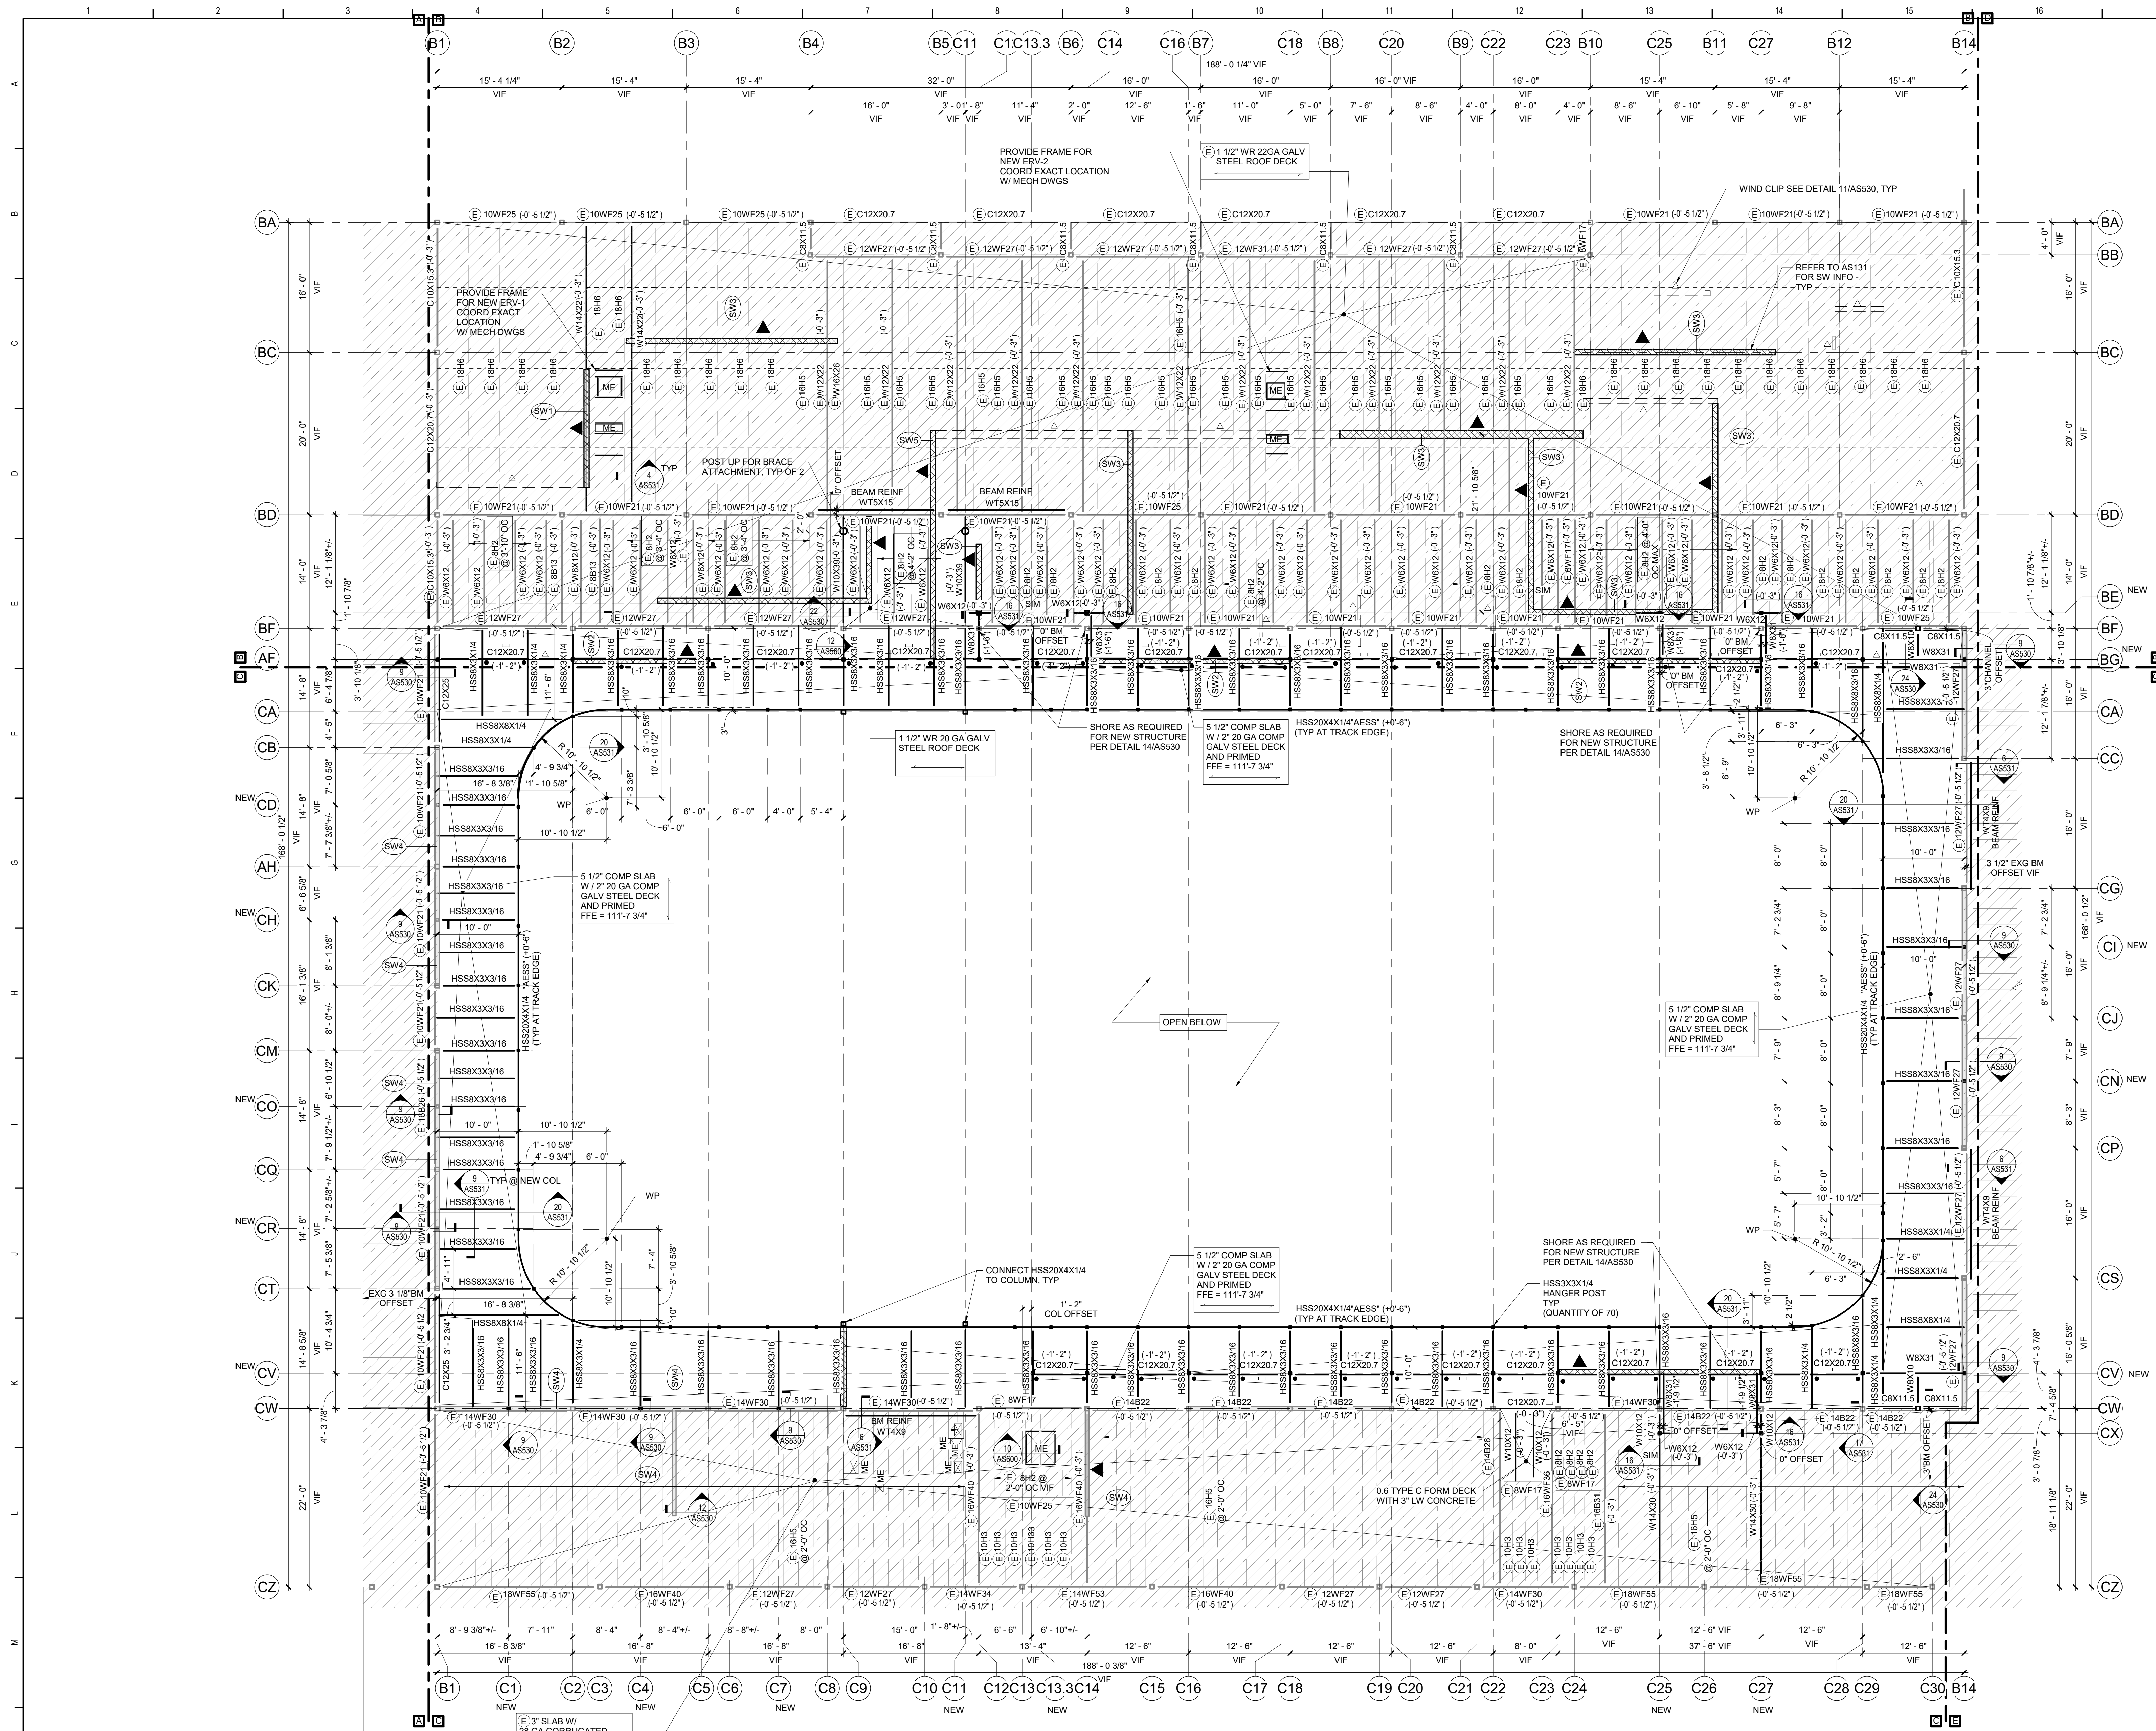
TETRA TECH
ARCHITECTS & ENGINEERS

Waverly Central School District
Waverly, NY

Additions and Alterations to:
Waverly Jr. Sr. High School


Partial Roof Framing Plans - Area A

Drawn By: NDC/vmm Date: 05/19/2023 Drawing Number:
Project No.: 339070-22003 **AS160**



- General Notes:**
- A. DIMENSIONS AND ELEVATIONS SHOWN ON PLAN AS PLUS/MINUS (+/-) AND VIF ARE TO BE CONSIDERED APPROXIMATE. EXACT VALUES FOR ALL (+/-) AND VIF DIMENSIONS ARE TO BE DETERMINED BY THE CONTRACTOR IN THE FIELD THROUGH A PRELIMINARY BUILDING LAYOUT. CONTRACTOR TO VERIFY EXISTING DIMENSIONS, ELEVATIONS AND CONDITIONS AND NOTIFY A/E OF ANY DISCREPANCIES PRIOR TO COMMENCING WORK. COORDINATE INFORMATION WITH OTHER TRADES.
 - B. REFER TO SHEET AS600 FOR GENERAL NOTES, LINTEL SCHEDULE AND SPECIFIC LINTEL DETAILS.
 - C. REFER TO SHEET AS600 FOR COLUMN SCHEDULE.
 - D. REFER TO SHEET AS530 FOR TYPICAL DETAILS.
 - E. REFER TO SHEET AS600 FOR BEAM CONNECTION SCHEDULE (SW) ELEVATION AND DETAILS.
 - F. REFER TO SHEET AS600 FOR BEAM CONNECTION SCHEDULE.
 - G. ROOF DECK TO BE GALVANIZED 1 1/2" WIDE RIBBED 20 GAUGE CORRUGATED STEEL UNLESS OTHERWISE NOTED.
 - H. ALL BEAM/JOIST ARE SPACED EQUALLY BETWEEN COLUMN LINE UNO.
 - I. ALL GRID LINES ARE EXG. UNO.

- Asbestos Awareness – CMU Wall Paint:**
- A. CMU WALL PAINT IS ASBESTOS CONTAINING AND IS PRESENT IN AREAS OF SCHEDULED WORK. ASBESTOS PAINT IS LIMITED TO CMU WALLS.
 - B. PERFORM WORK SUCH THAT NO PAINTED CMU WALL SURFACES ARE DISTURBED. DISTURBANCE INCLUDES, BUT IS NOT LIMITED TO DETACHMENT OF EXISTING ITEMS FROM THE WALL, ATTACHMENT OF NEW ITEMS TO THE WALL.
 - C. ADDITIONAL ASBESTOS CONTAINING ITEMS ARE PRESENT AND INDICATED ELSEWHERE WITHIN THE FACILITIES. REFER TO ON-SITE ASBESTOS DOCUMENTATION FOR FURTHER INFORMATION.
 - D. SHOULD ANY PAINTED CMU WALL SURFACE BE REQUIRED TO BE IMPACTED OR DISTURBED, CONSULT THE OWNER'S ENVIRONMENTAL CONSULTANT.

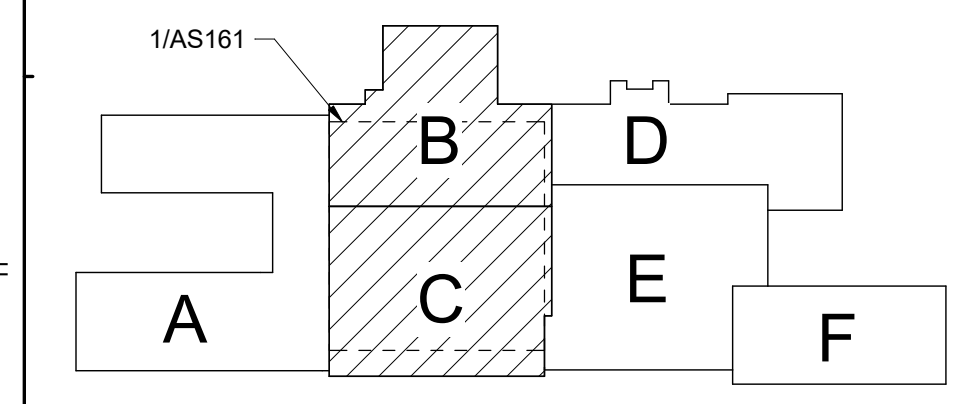

Key Plan
N.T.S.

SED Control No. 60-01-01-06-0-018-023

Rev. No.	Date	Description



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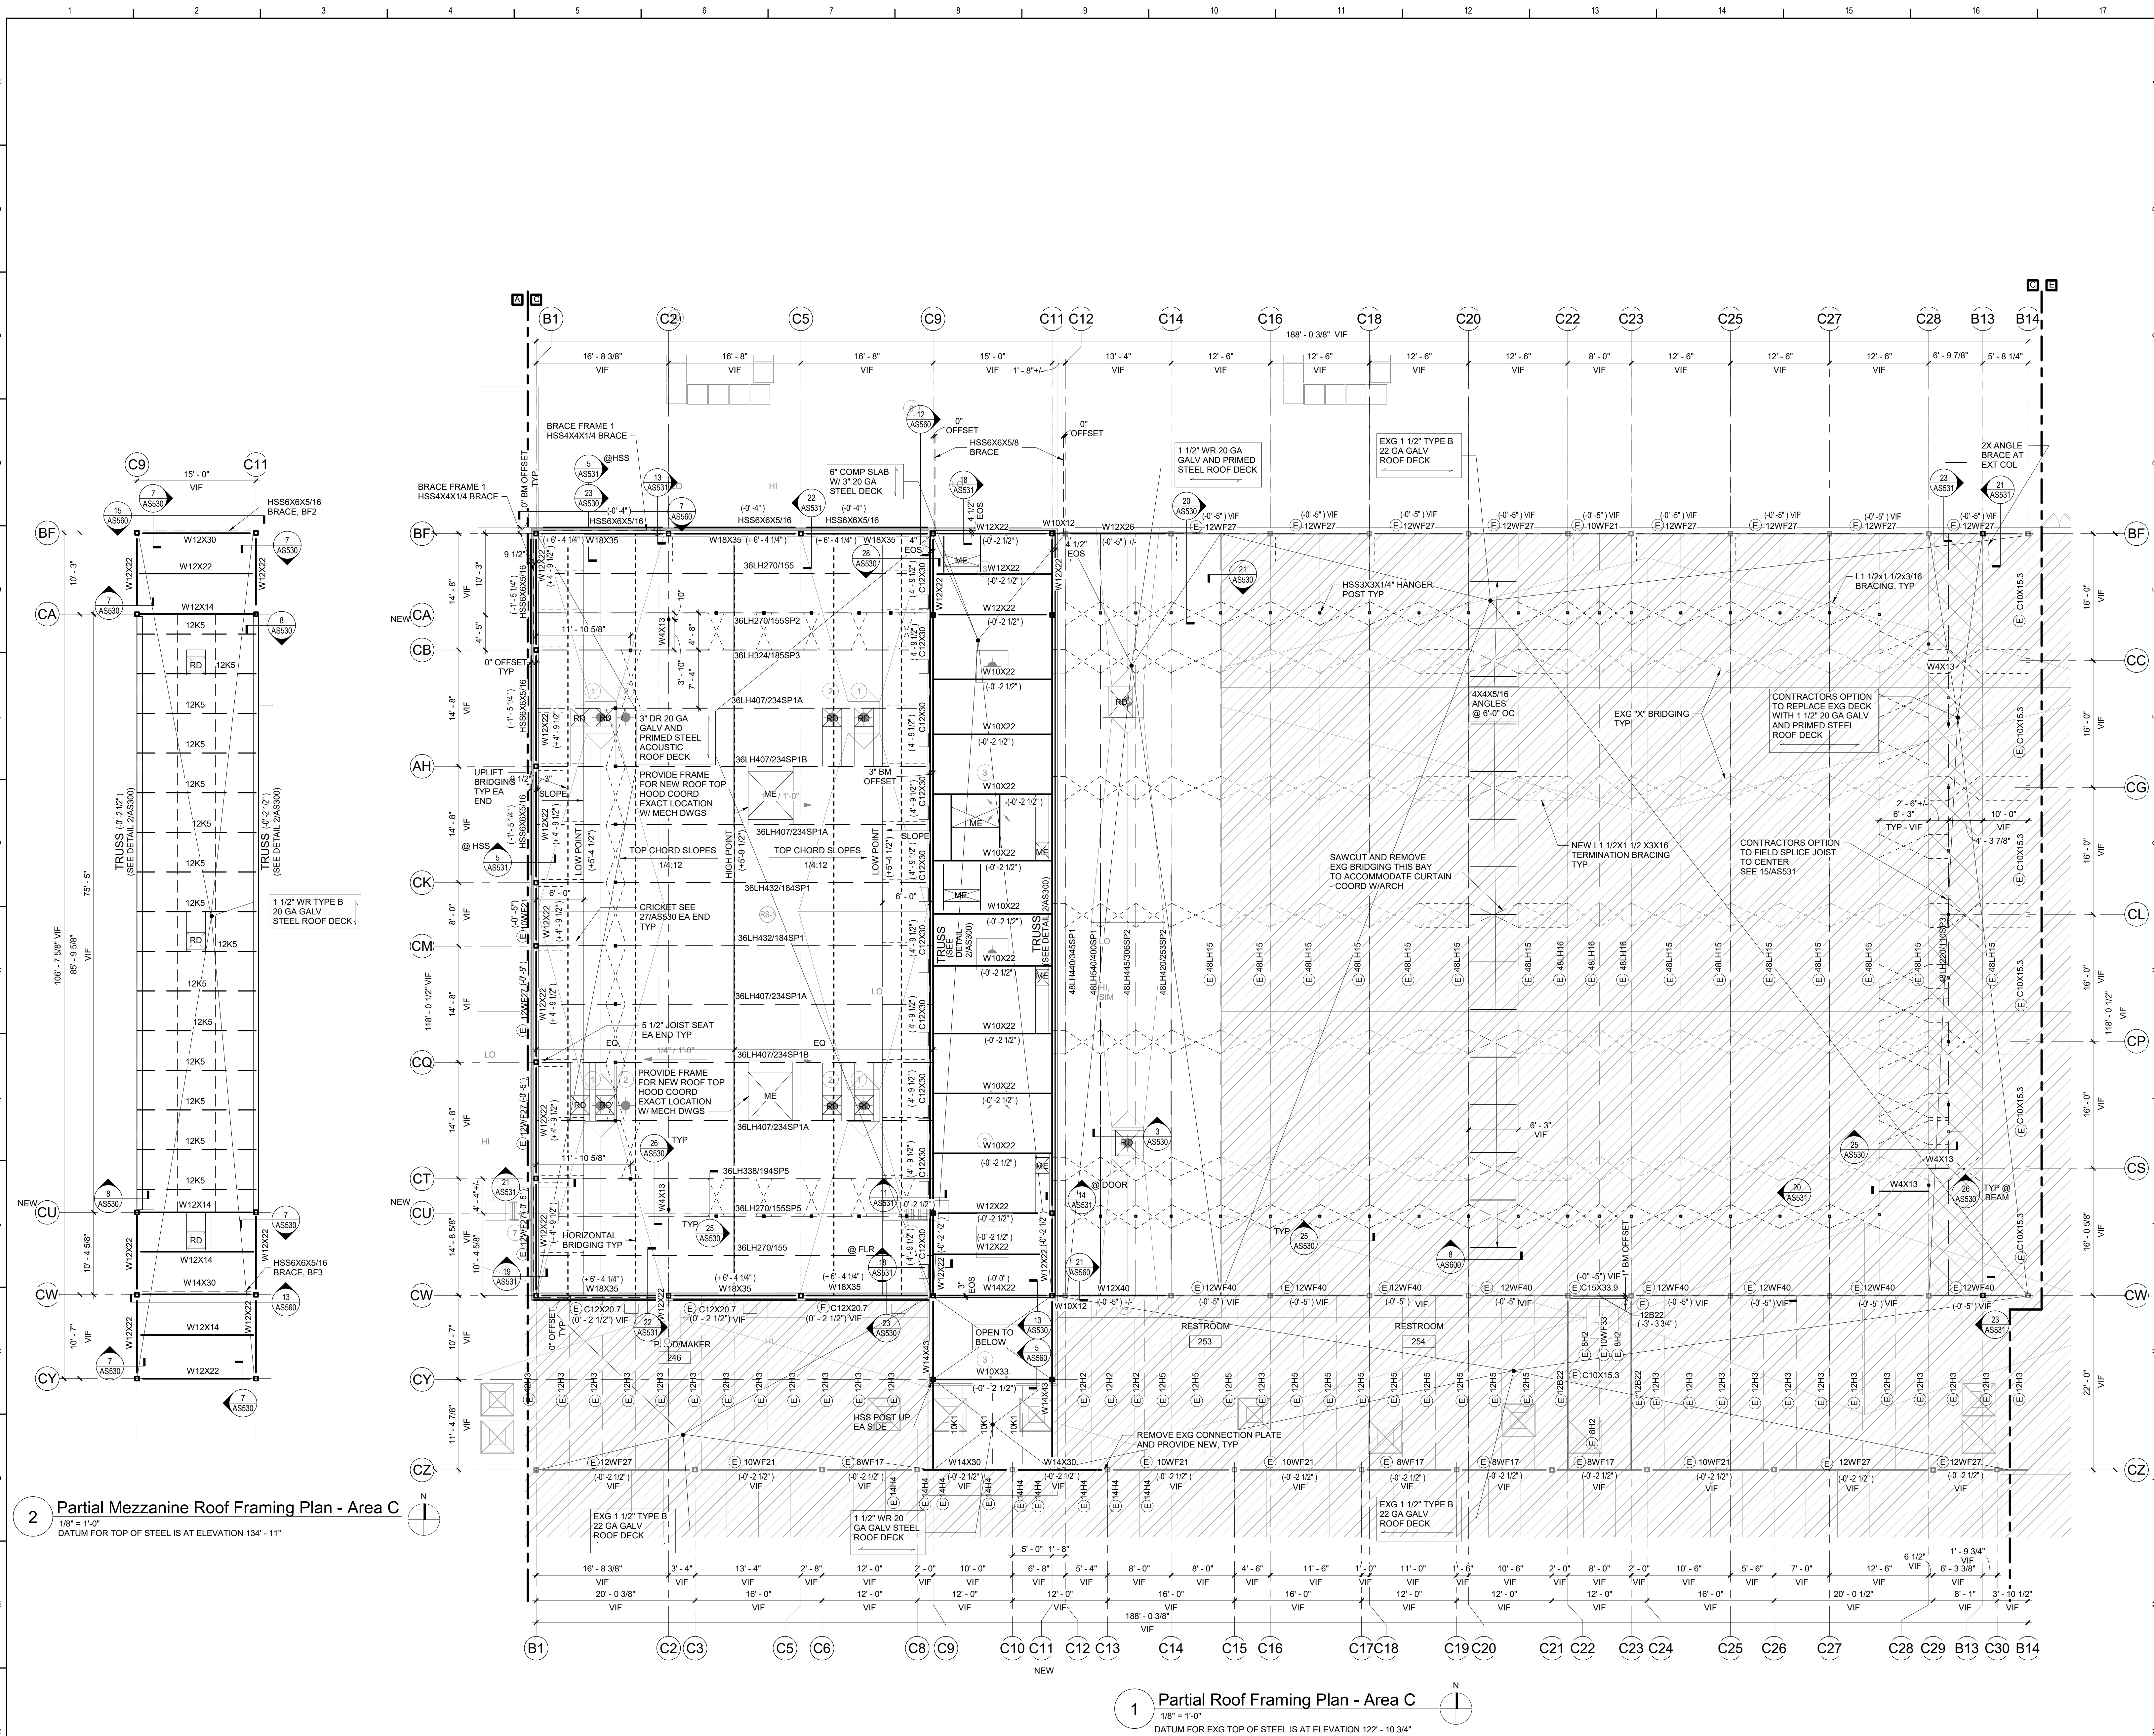
Waverly Central School District
Waverly, NY


Additions and Alterations to:
Waverly Jr. Sr. High School

Low Roof and Second Floor Framing Plan - Areas B and C


Drawn By: NDC/vmm	Date: 05/19/2023	Drawing Number:
Project No.: 339070-22003	AS161	

1 Low Roof and Second Floor Framing Plan - Areas B and C
1/8" = 1'-0"
DATUM FOR TOP OF STEEL IS AT FINISHED FLOOR ELEVATION 111'-7 3/4"
ALL NEW BEAMS AT (-6") UNLESS NOTED OTHERWISE



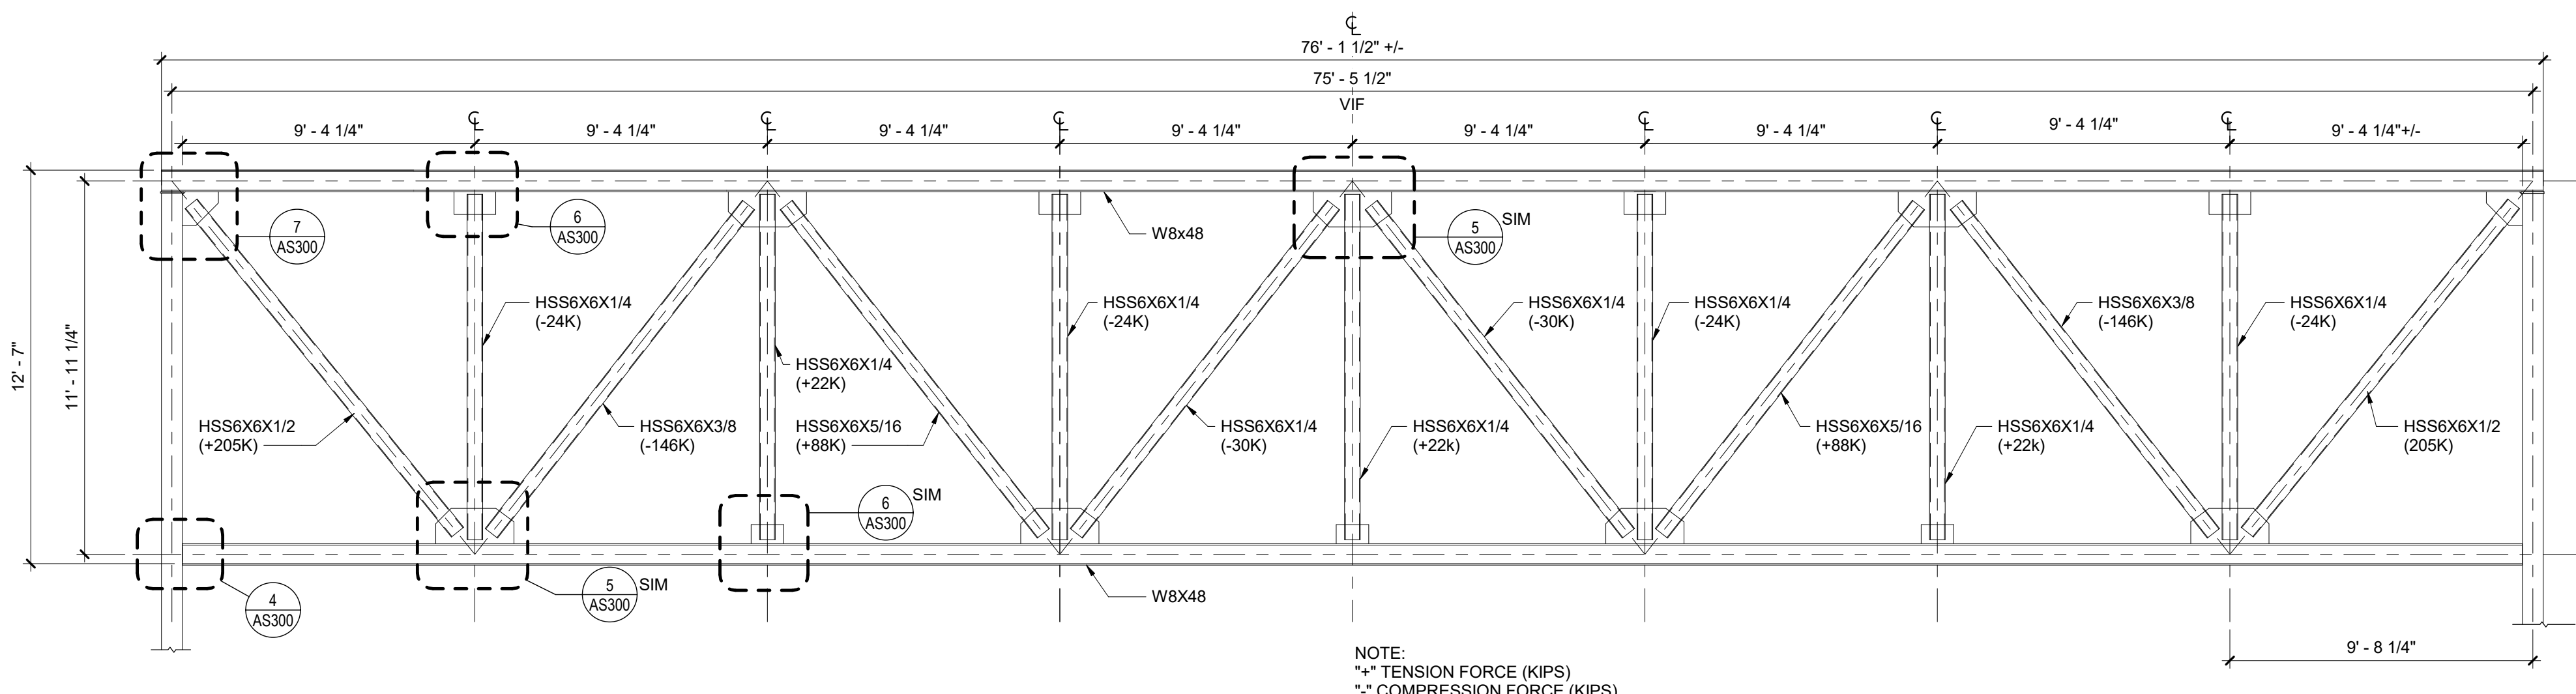


2 Mezzanine Truss Profile
 1/4" = 1'-0"

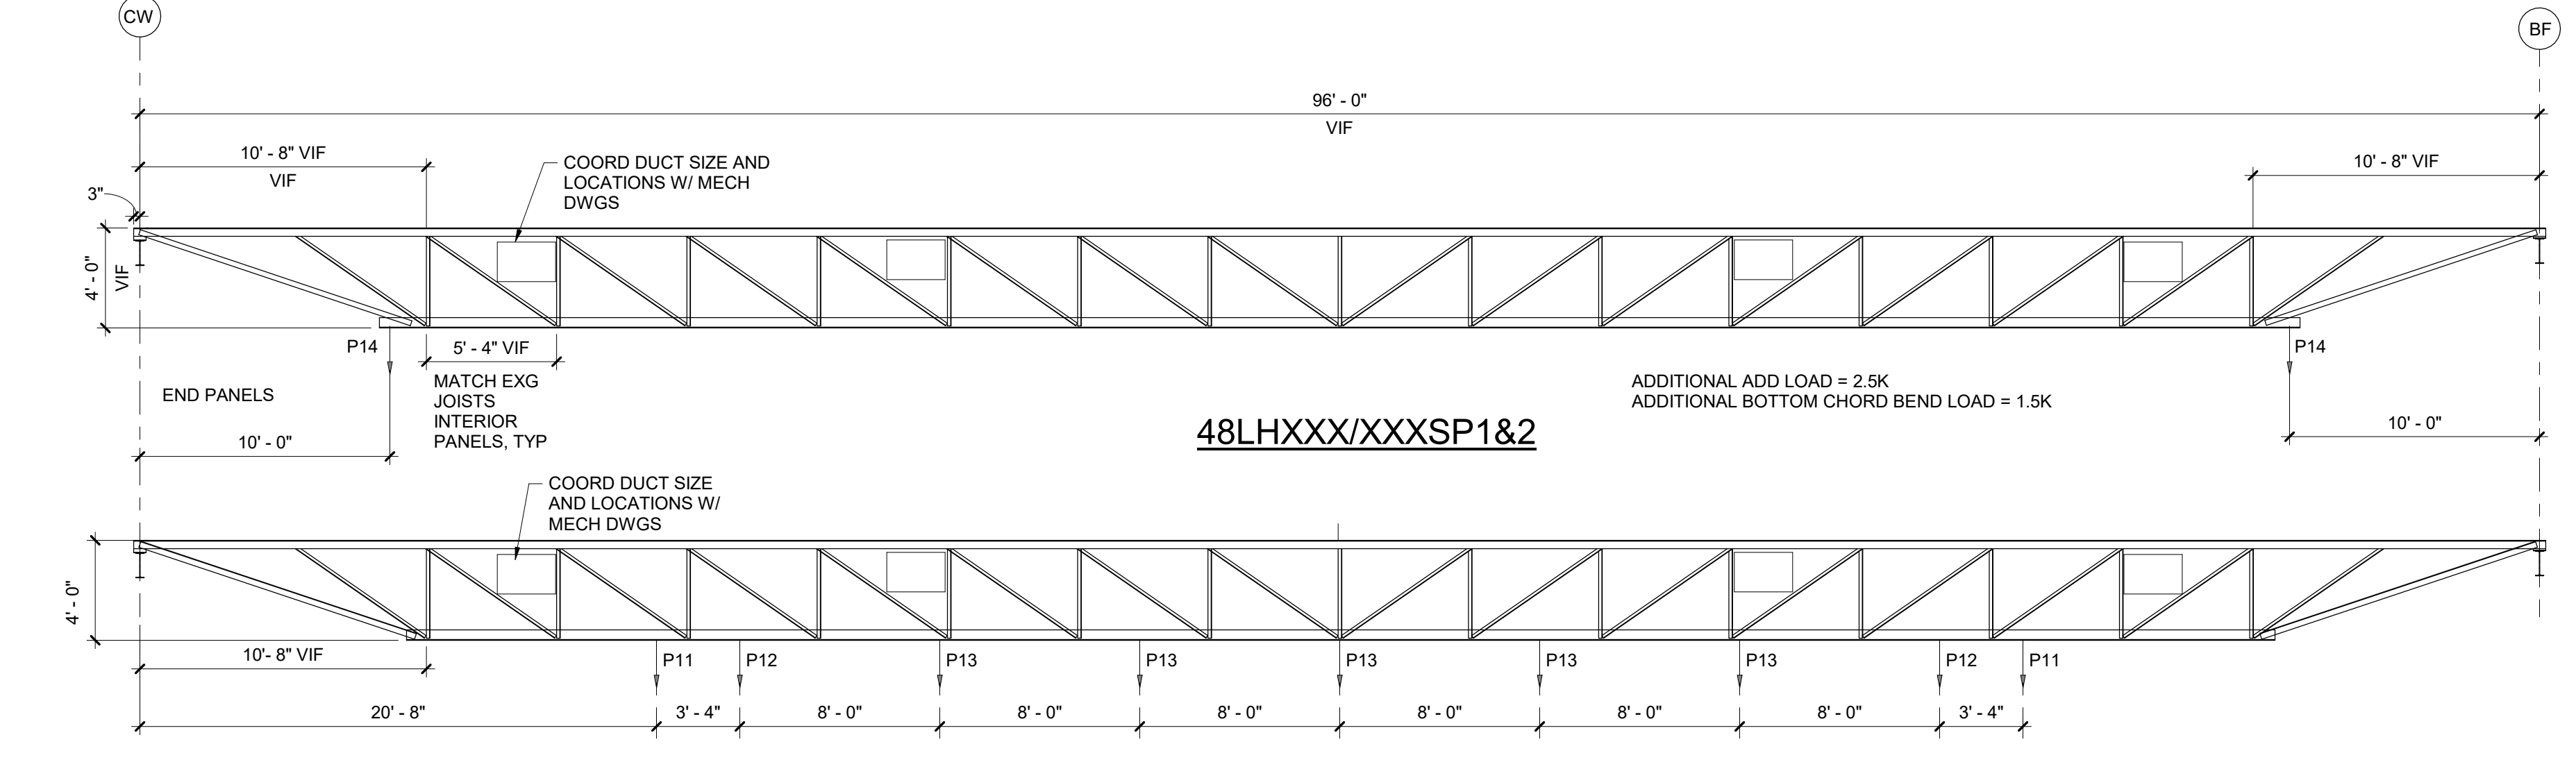

NOTES:
 1. ALL LOADS ARE IN ADDITION TO LOADS IN UNIFORM LOAD SPECIFIED IN JOIST DESIGNATION.
 2. ALL LOADS ARE UNFACTORED
 3. JOIST TO BE DESIGNED TO LIVE LOAD DEFLECTION LIMIT L/360
 4. JOIST DIAGRAMS ARE DIAGRAMMATIC. JOISTS TO MATCH EXG JOIST PANEL LAYOUT W/ MODIFIED ENDS
 5. 48LH220/110SP3 - MIN LEFT - 4700IN⁴
 6. CAMBER TO MATCH EXG

LOAD	DL (KIPS)	LL (KIPS)
P11	4.3	5.0
P12	2.9	3.4
P13	3.4	4.0
P14	2.6	3.0


3 48LHSP Profile And Loading Diagram
 3/16" = 1'-0"

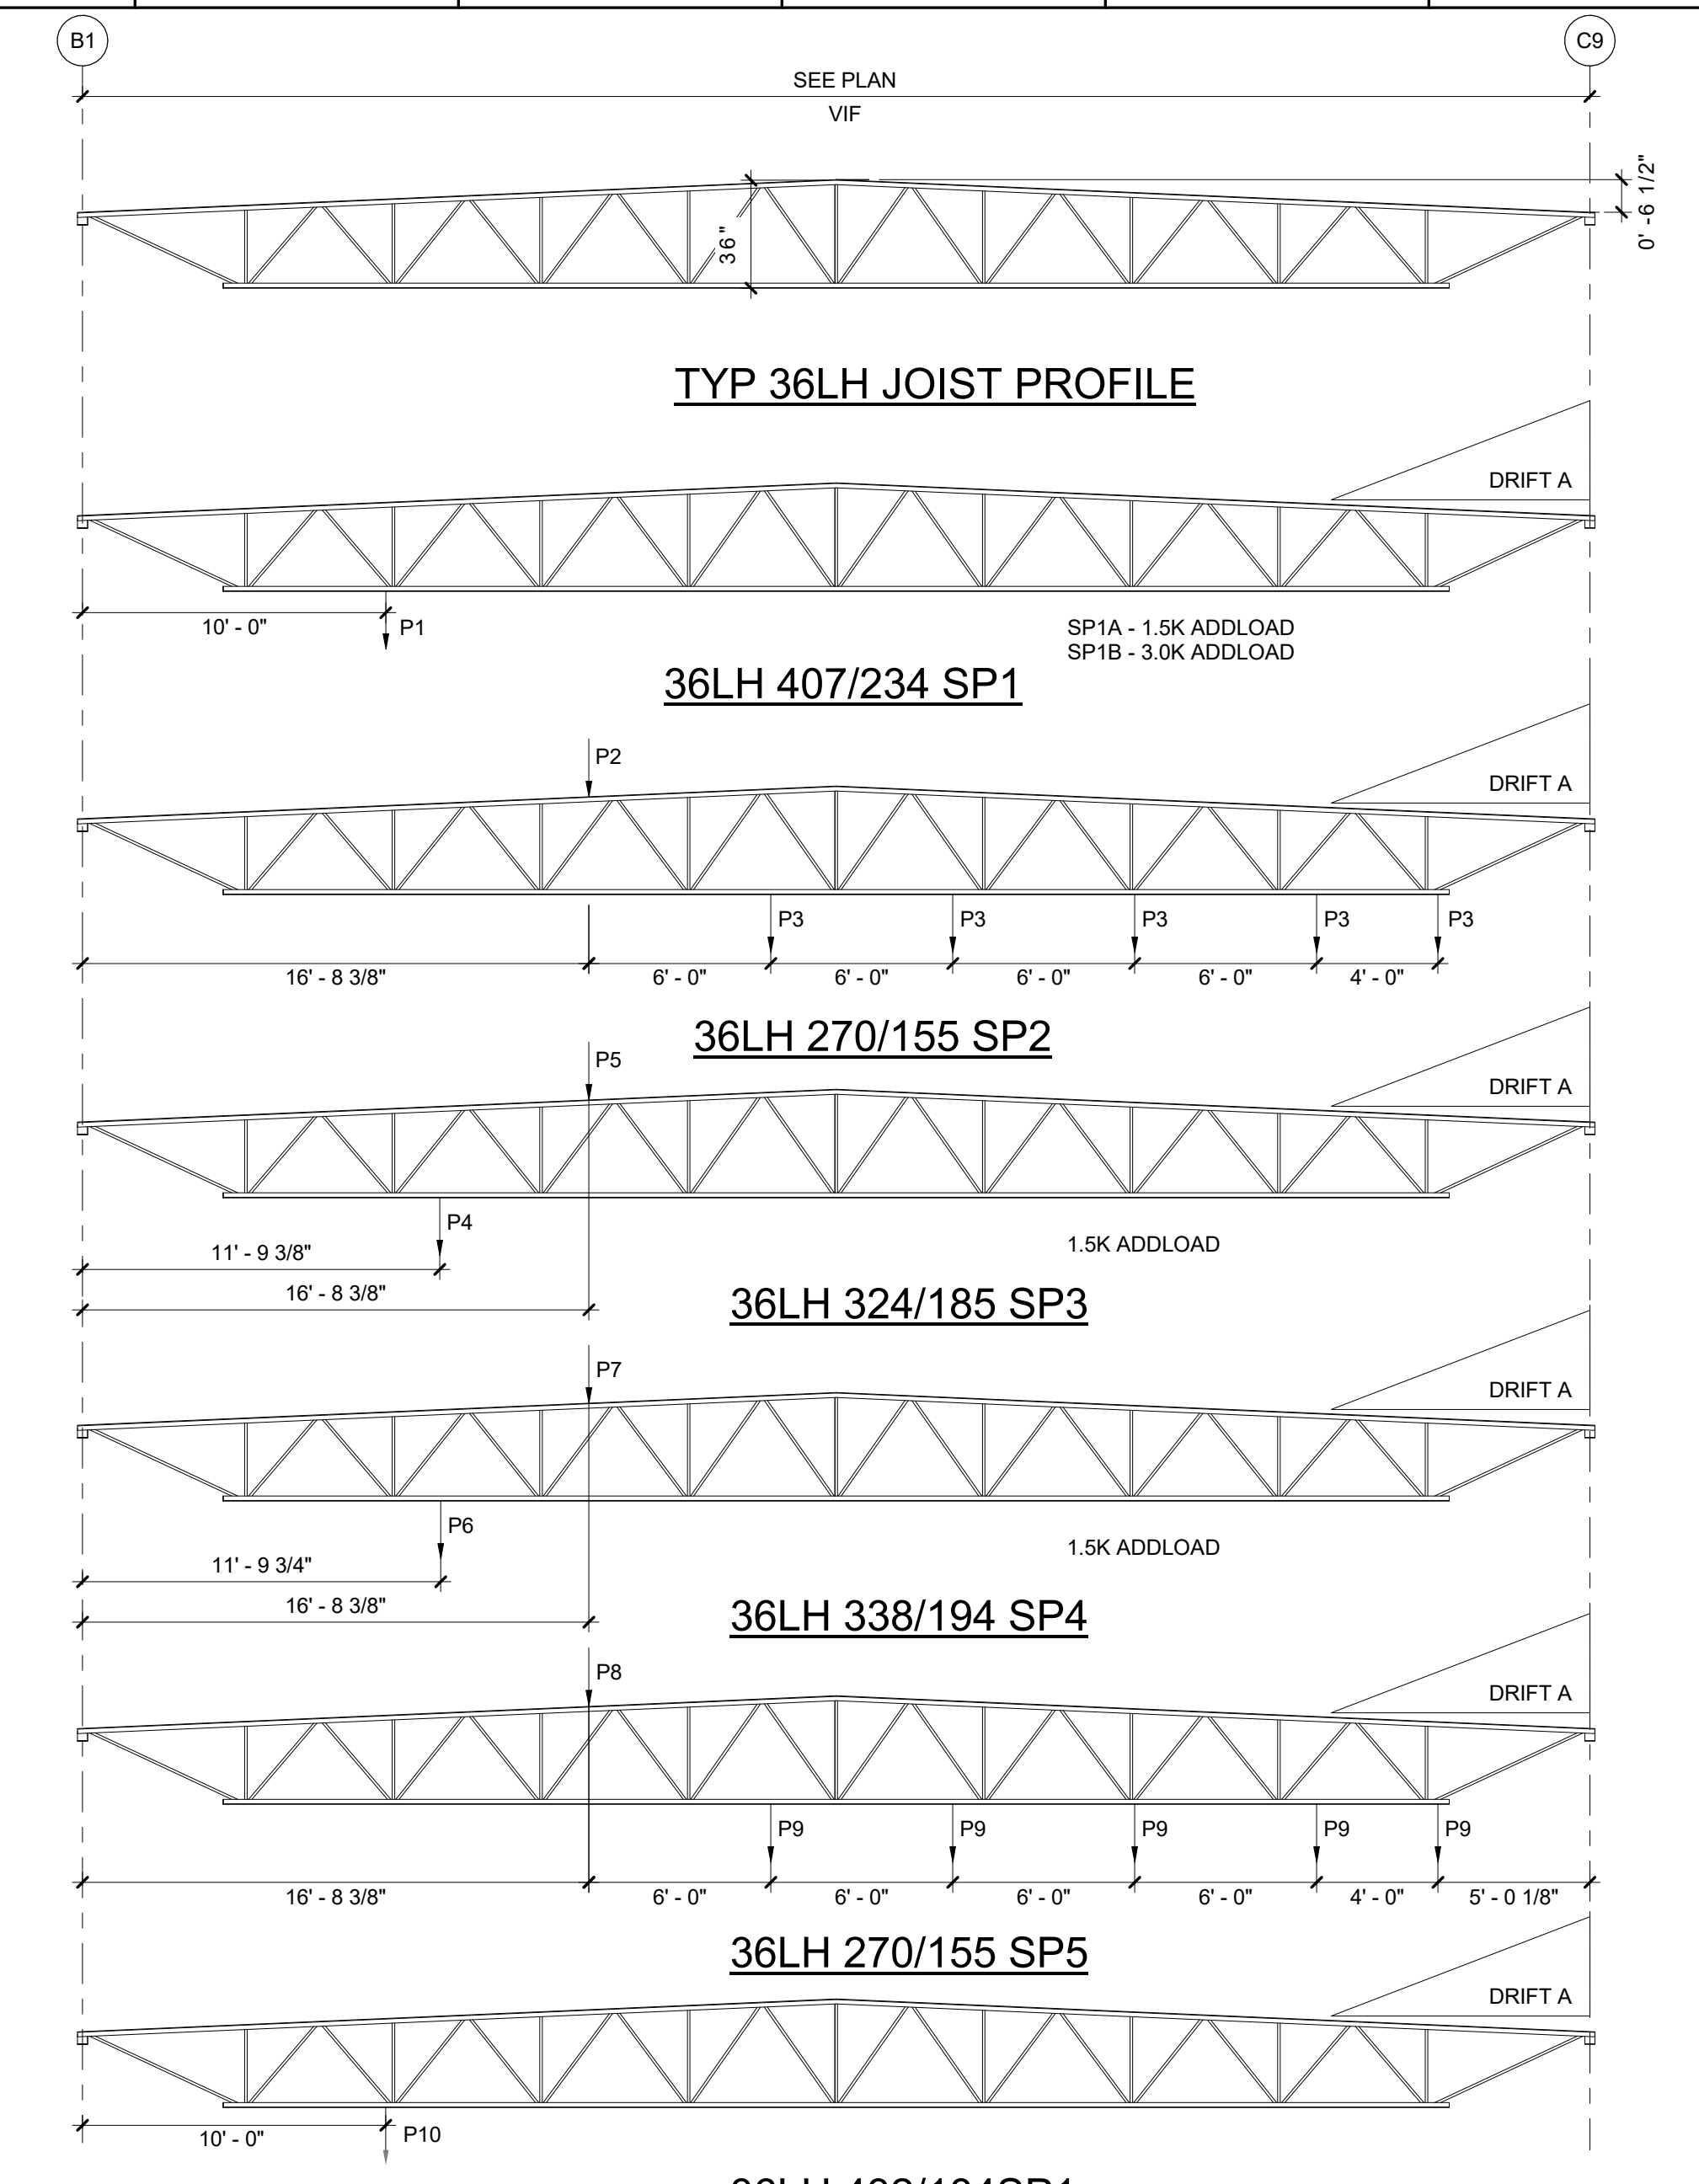


LOAD	DL (KIPS)	LL (KIPS)
P1	3.11	3.67
P2	4.90	5.70
P3	2.55	3.0
P4	2.64	3.1
P5	1.04	1.21
P6	2.50	2.94
P7	1.24	1.46
P8	5.35	6.30
P9	2.55	3.0
P10	4.0	4.5

NOTES:
 1. ALL LOADS ARE IN ADDITION TO LOADS IN UNIFORM LOAD SPECIFIED IN JOIST DESIGNATION.
 2. ALL LOADS ARE UNFACTORED
 3. JOIST TO BE DESIGNED TO LIVE LOAD DEFLECTION LIMIT L/360
 4. JOIST DIAGRAMS ARE DIAGRAMMATIC. FINAL WEB LAYOUT TO BE DETERMINED BY THE JOIST MANUFACTURER.
 5. FOR POINT LOADS NOT NOTED SPECIFICLY GREATER THAN 100LBS NOT OCCURRING AT A PANEL POINT PROVIDE ADDITIONAL WEB PER DETAIL 6/AS330
 6. MIN TOP AND BOTTOM CHORD SIZE FOR 36LH270/155SP5 = (2) L5X5X1/2
 7. DRIFT LOADING
 DRIFT SURCHARGE, P_d 301 PLF
 DRIFT WIDTH, w 8.53 FT


1 36LHXXX/XXXSP Joist Profiles And Loading Diagrams
 3/16" = 1'-0"

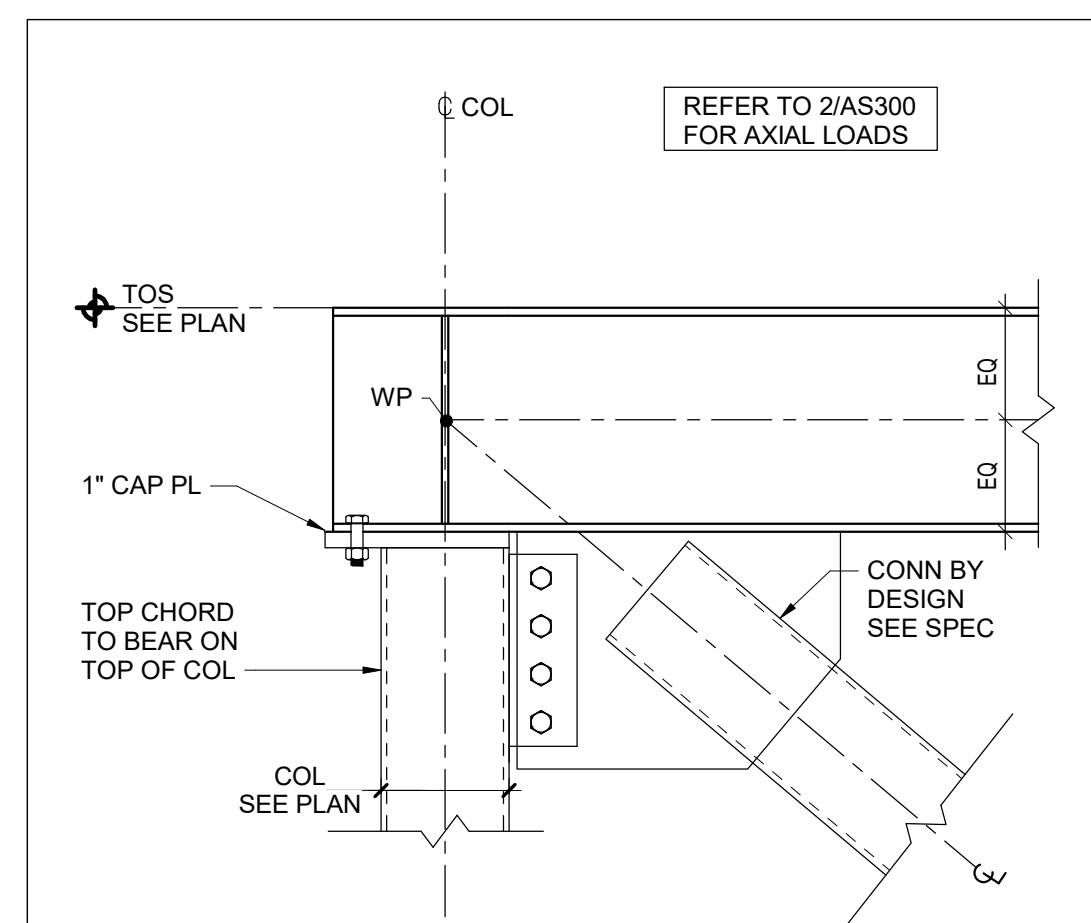


7 Typical Truss End Connection
 1" = 1'-0"

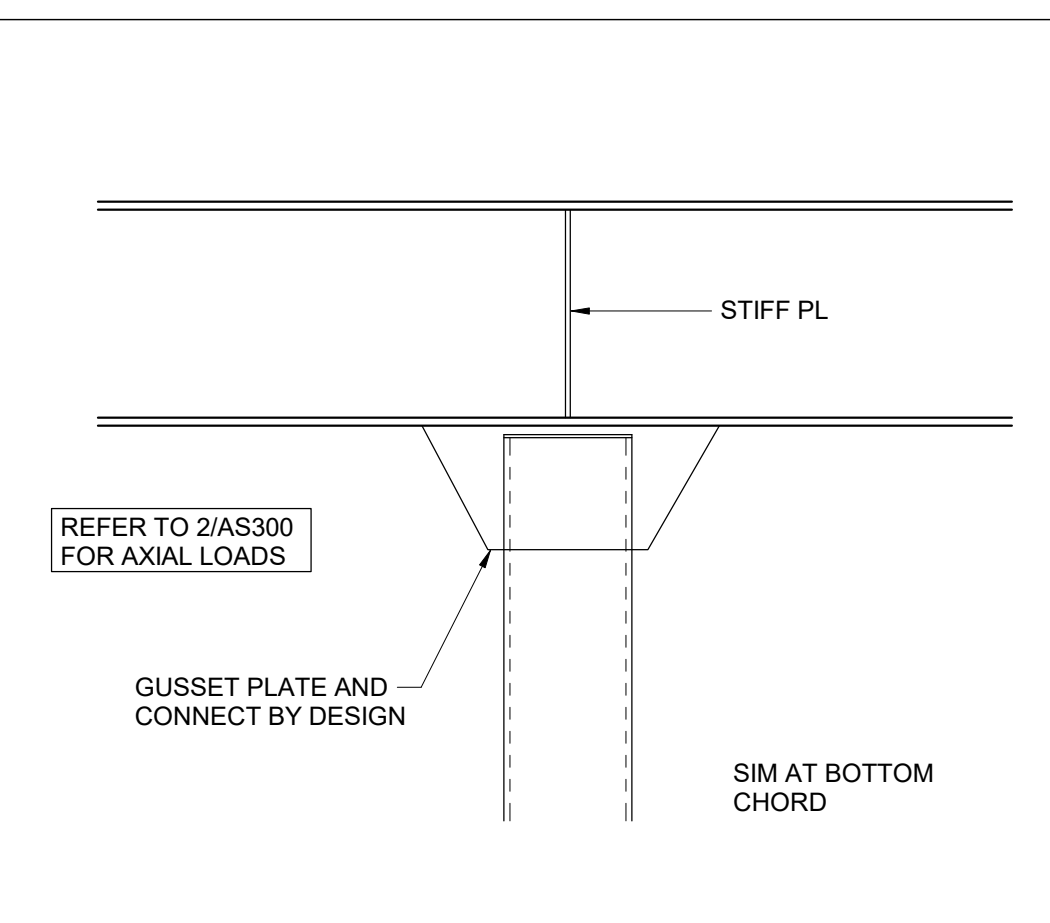

6 Typical Vertical Web Truss Connection
 1" = 1'-0"

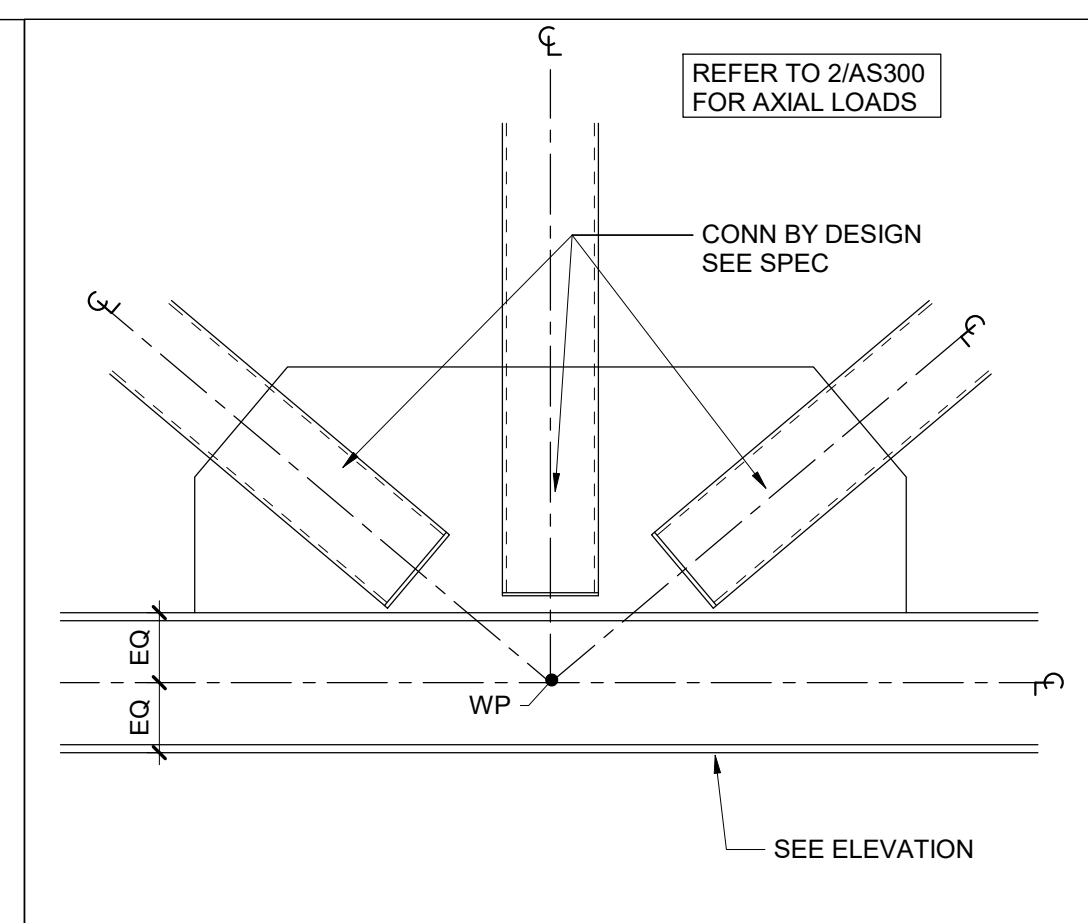


5 Typical Truss Connection
 1" = 1'-0"

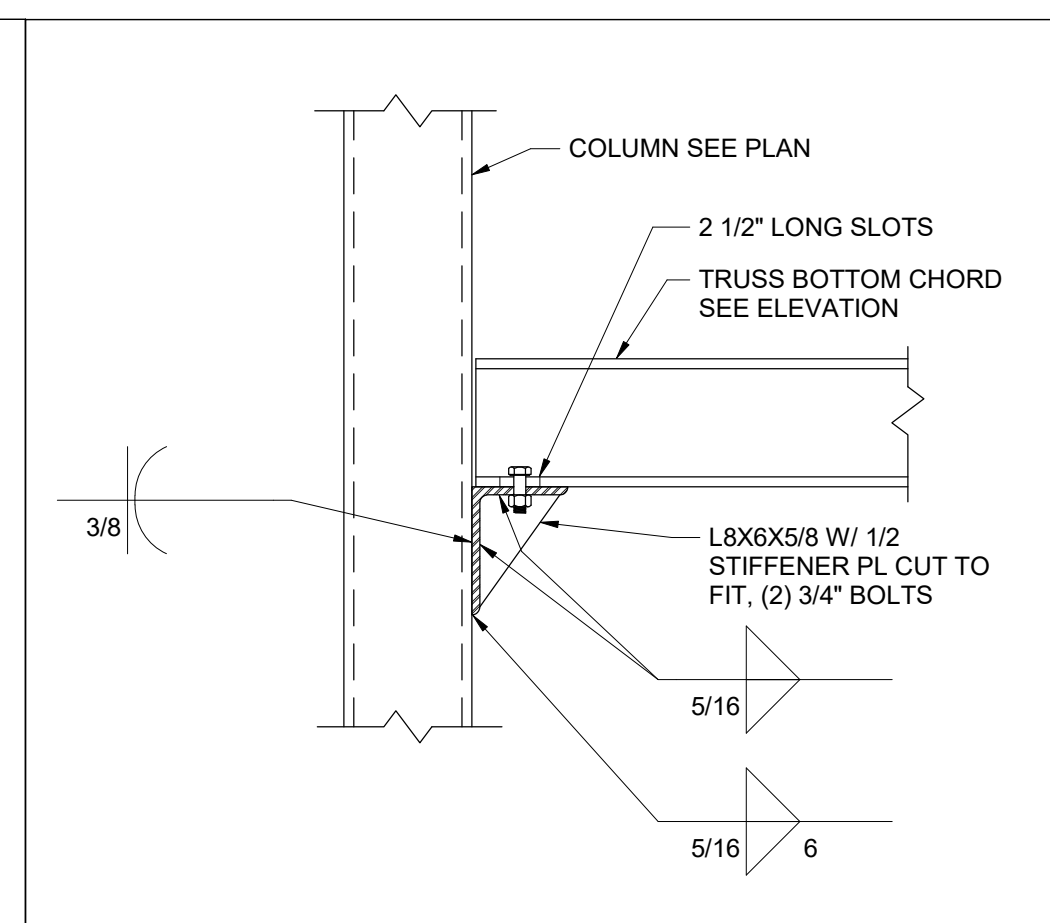

4 Truss Connection
 1" = 1'-0"

Asbestos Awareness – CMU Wall Paint:

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- ADDITIONAL ASBESTOS CONTAINING ITEMS ARE PRESENT AND INDICATED ELSEWHERE WITHIN THE FACILITIES. REFER TO ON-SITE ASBESTOS DOCUMENTATION FOR FURTHER INFORMATION.
- SHOULD ANY PAINTED CMU WALL SURFACE BE REQUIRED TO BE IMPACTED OR DISTURBED, CONSULT THE OWNER'S ENVIRONMENTAL CONSULTANT.

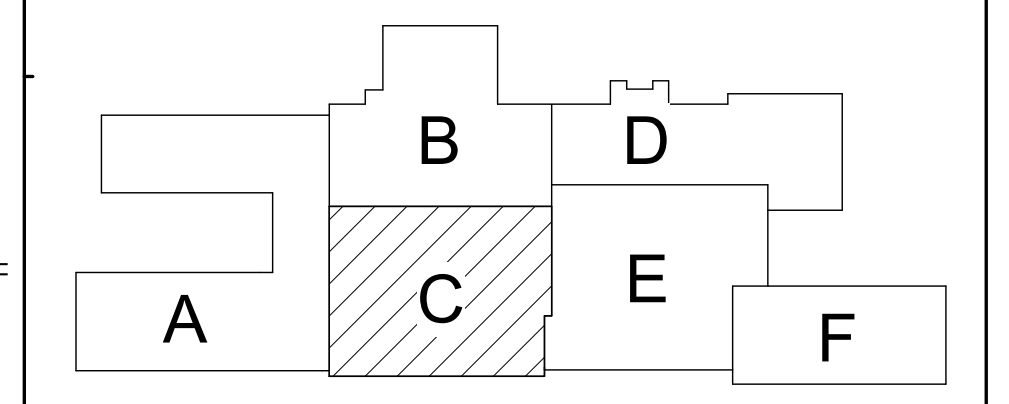

Key Plan
 N.T.S.

SED Control No. 60-01-01-06-0-018-023

Rev. No.:	Date:	Description:



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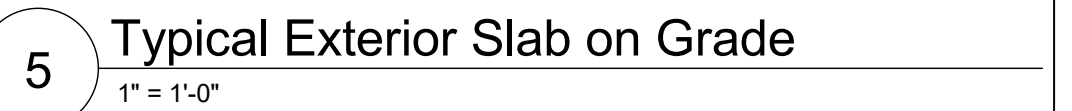
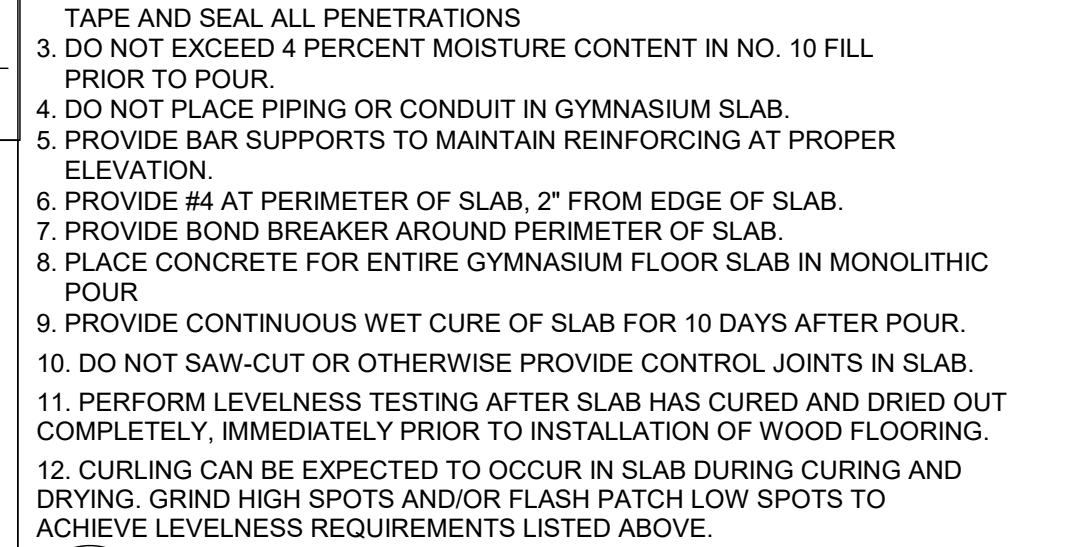
Waverly Central School District
 Waverly, NY

Additions and Alterations to:
 Waverly Jr. Sr. High School

Truss and Joist Sections and Elevations

Drawn By: NDC.kjr Date: 05/19/2023 Drawing Number: 339070-22003
AS300


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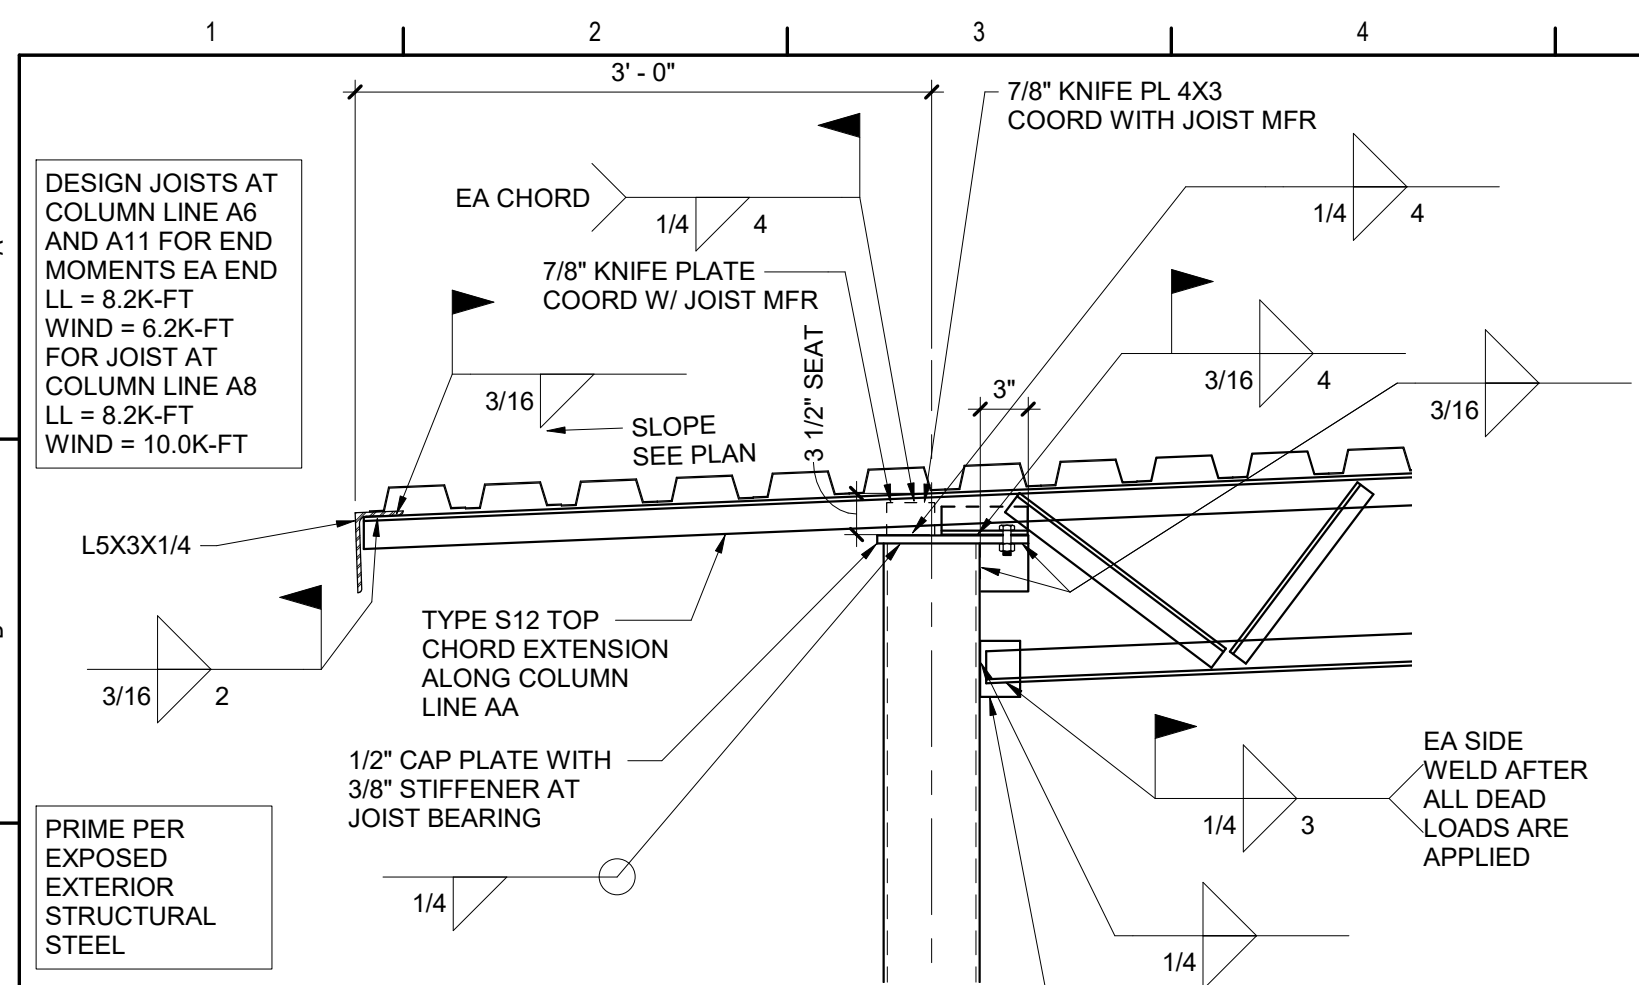


TOP AND BOTTOM
BARS SEE
SECTION


No. 2 CRUSHED

C. ADDITIONAL ASBESTOS CONTAINING ITEMS ARE PRESENT AND INDICATED ELSEWHERE WITHIN THE FACILITIES. REFER TO ON-




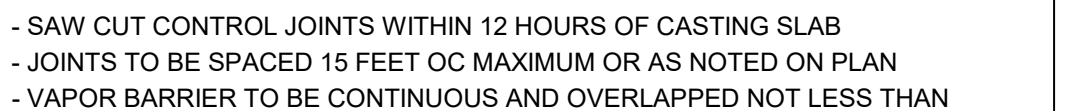


20 Joist Connection at Column

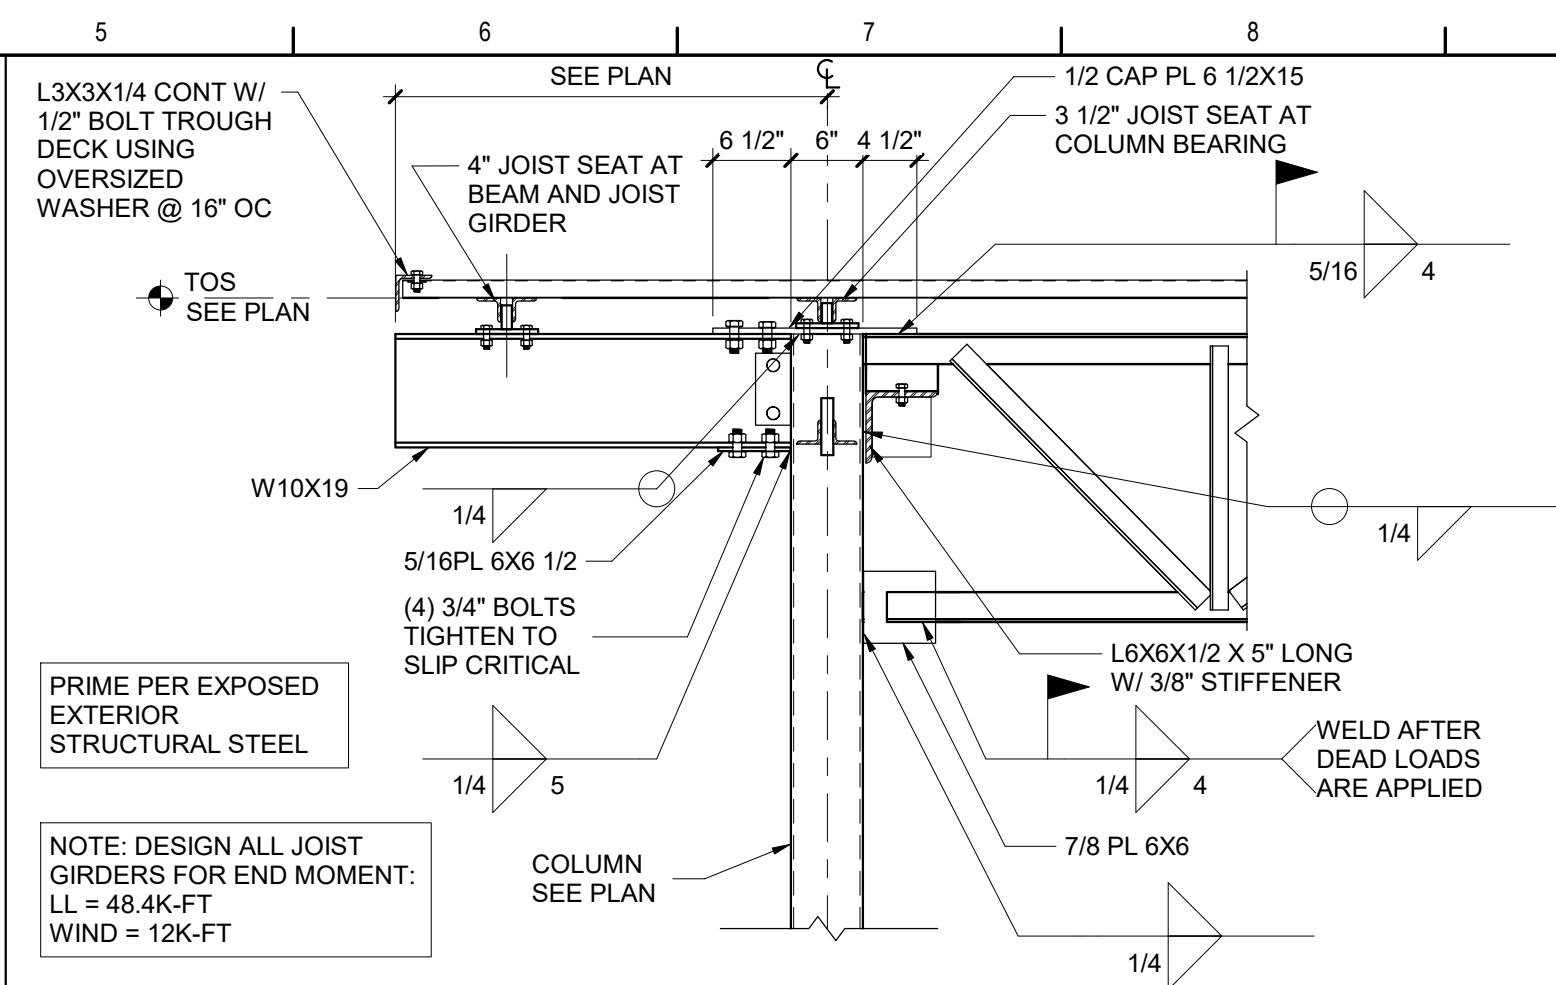


15 Section at Girder Bearing at Column

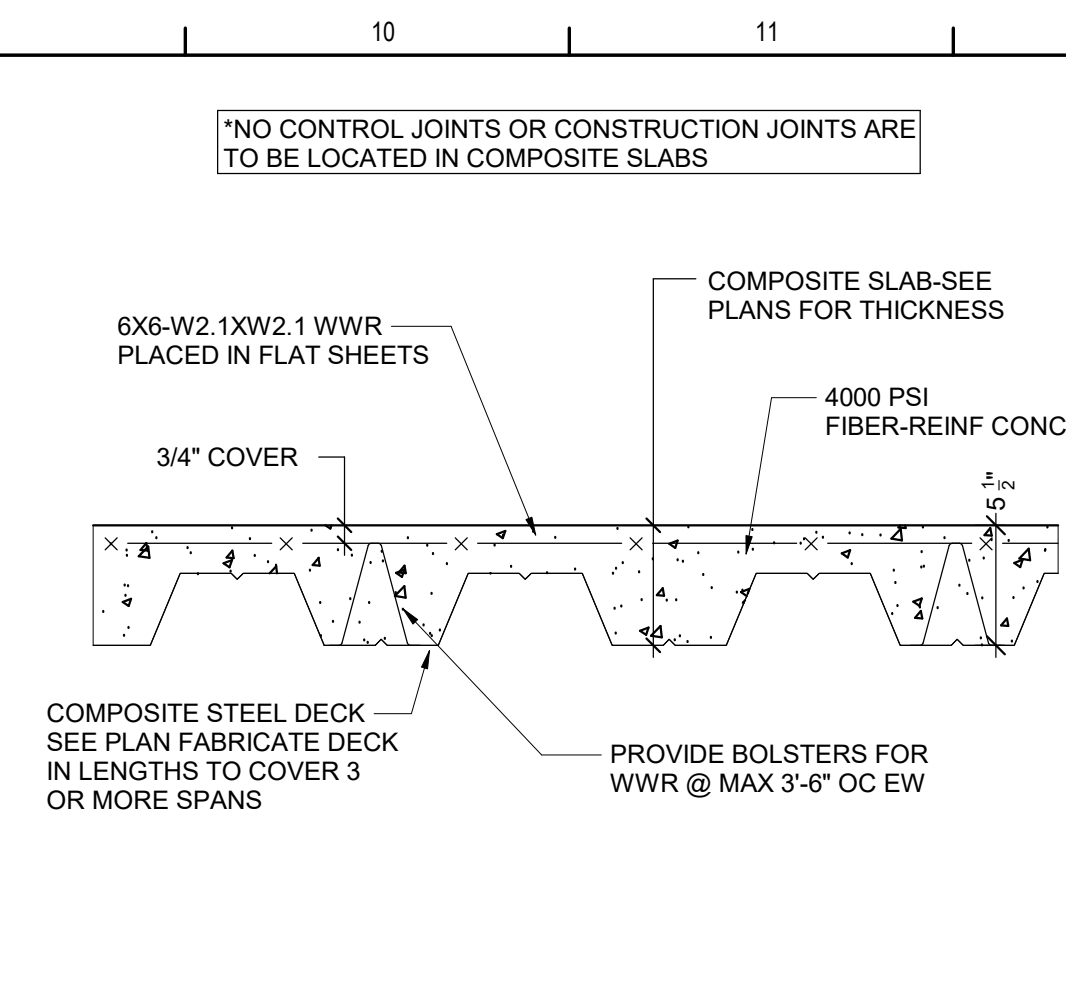


10 Typ Composite Slab Detail

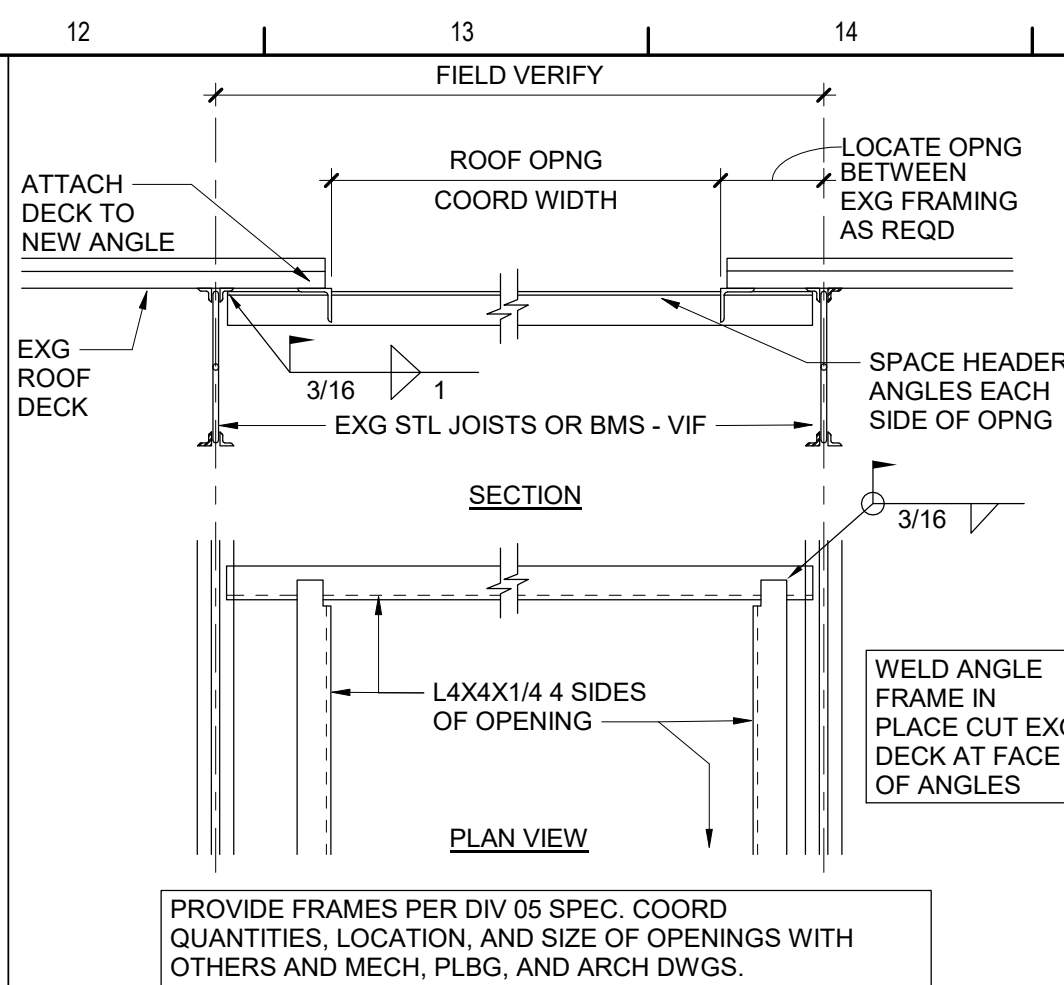


5 Typ Frame For New Opng @ Exg

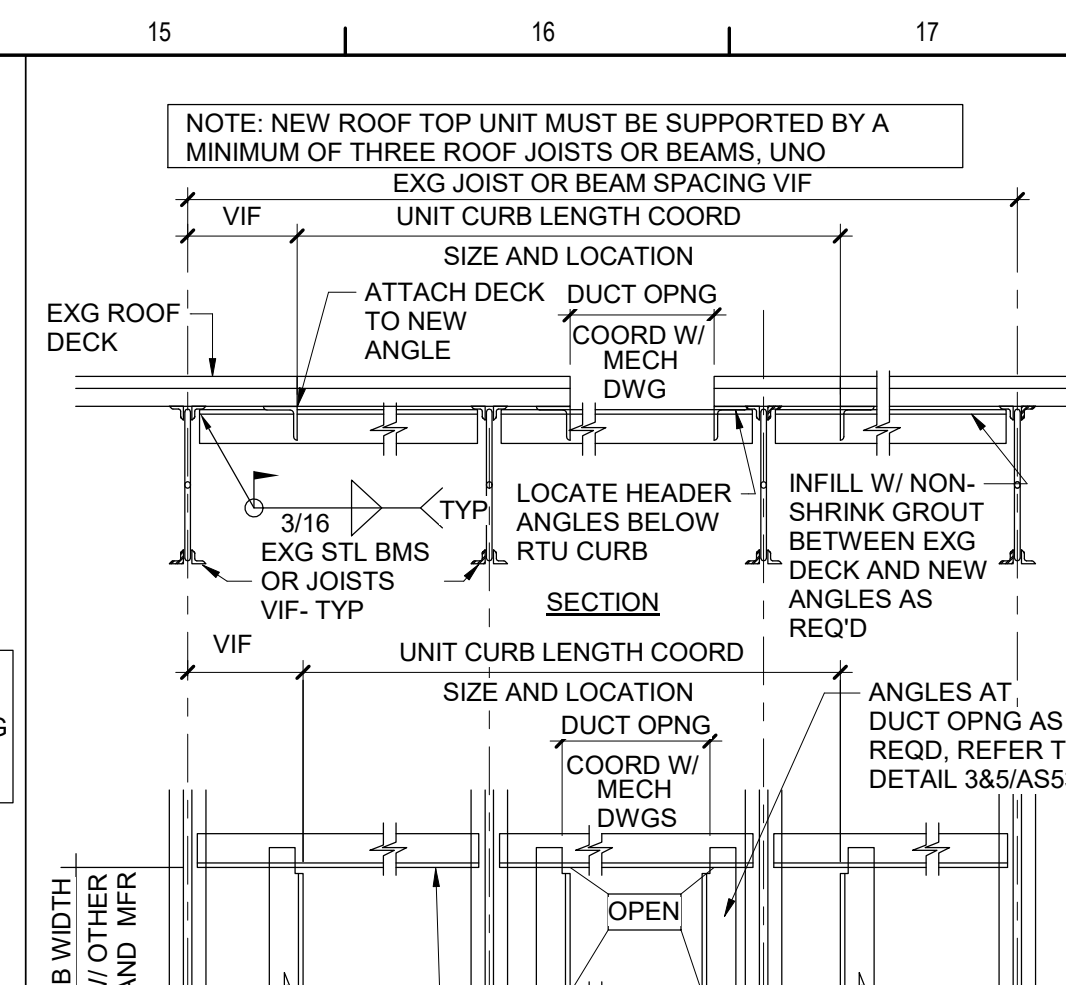


1 Typ Roof Frame at New RTUs

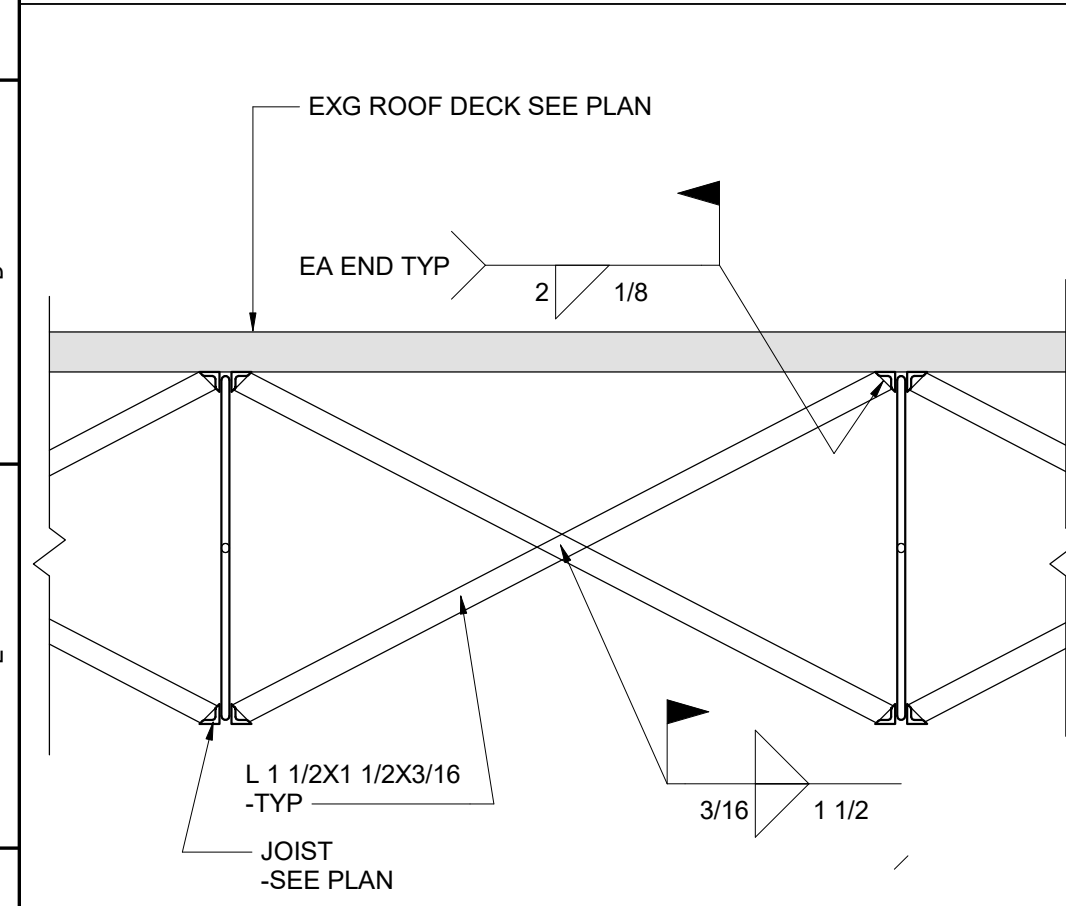


25 Joist Bracing

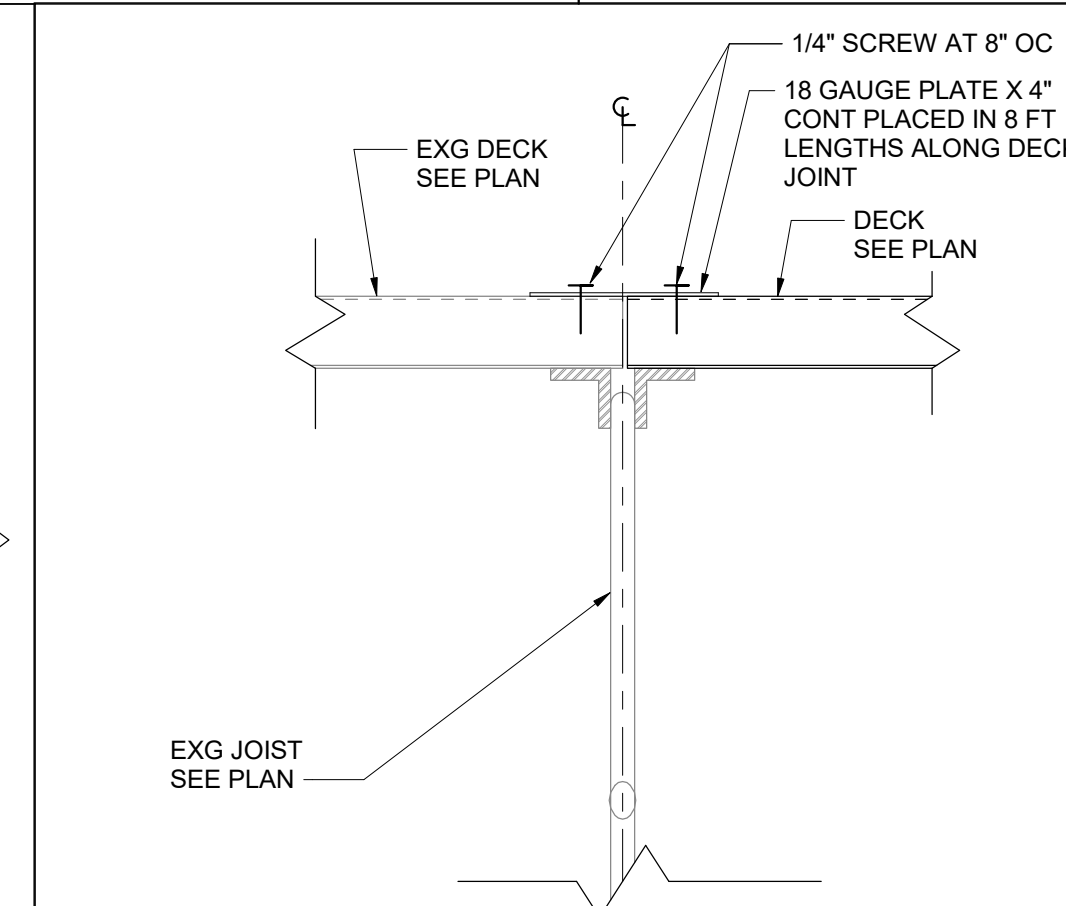


21 New Deck at Exg

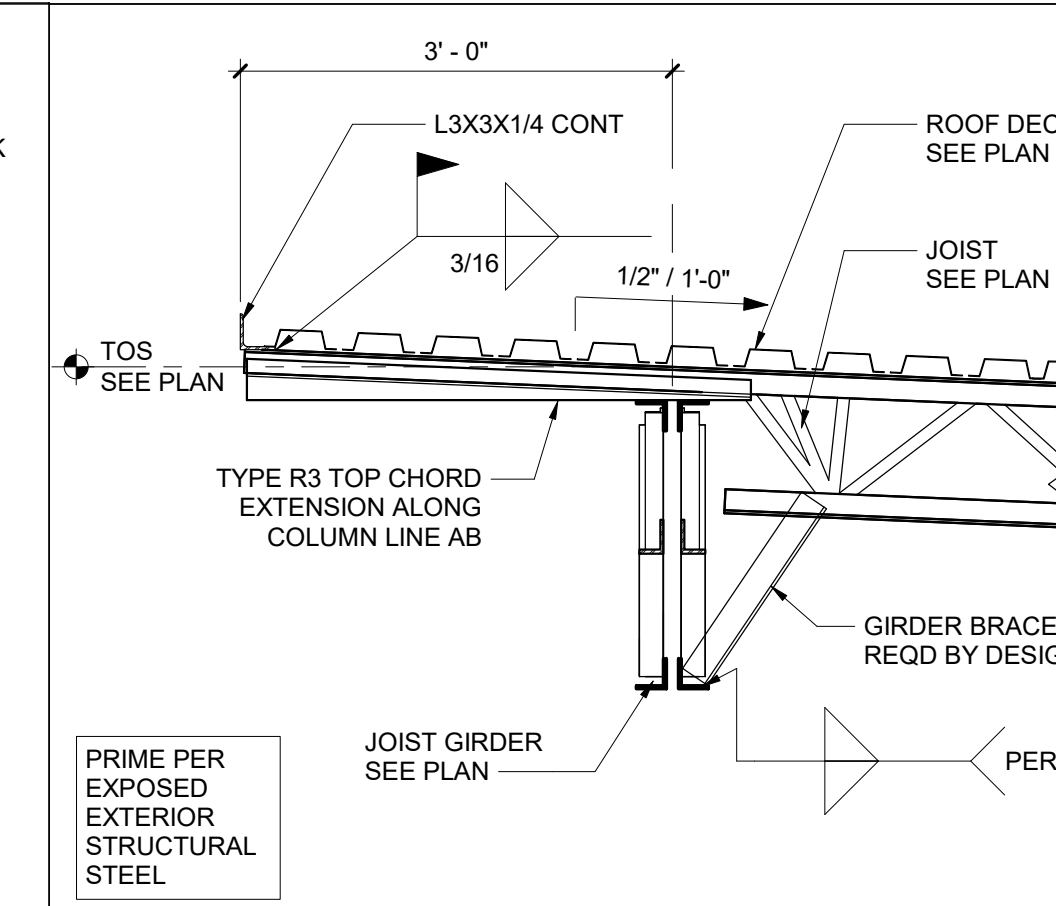


16 Section Bearing on Joist

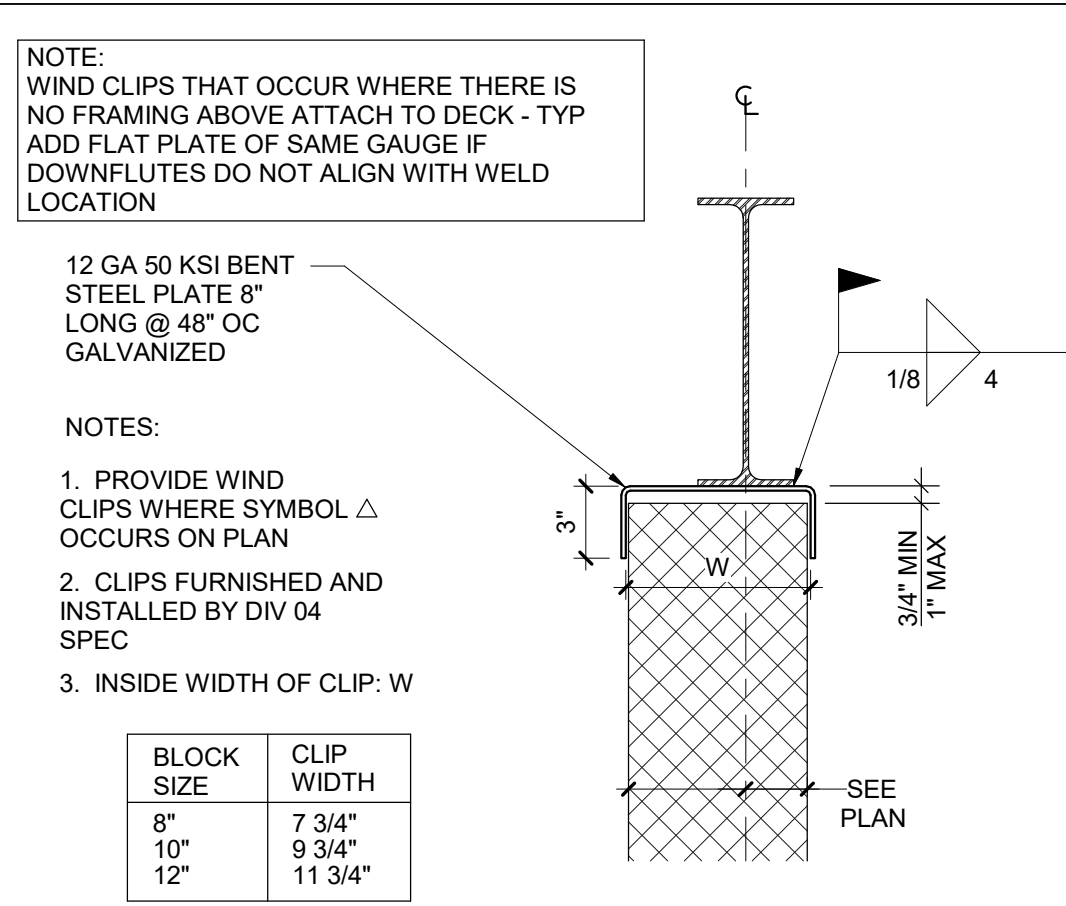


11 Typ Top of Wall Wind Clip

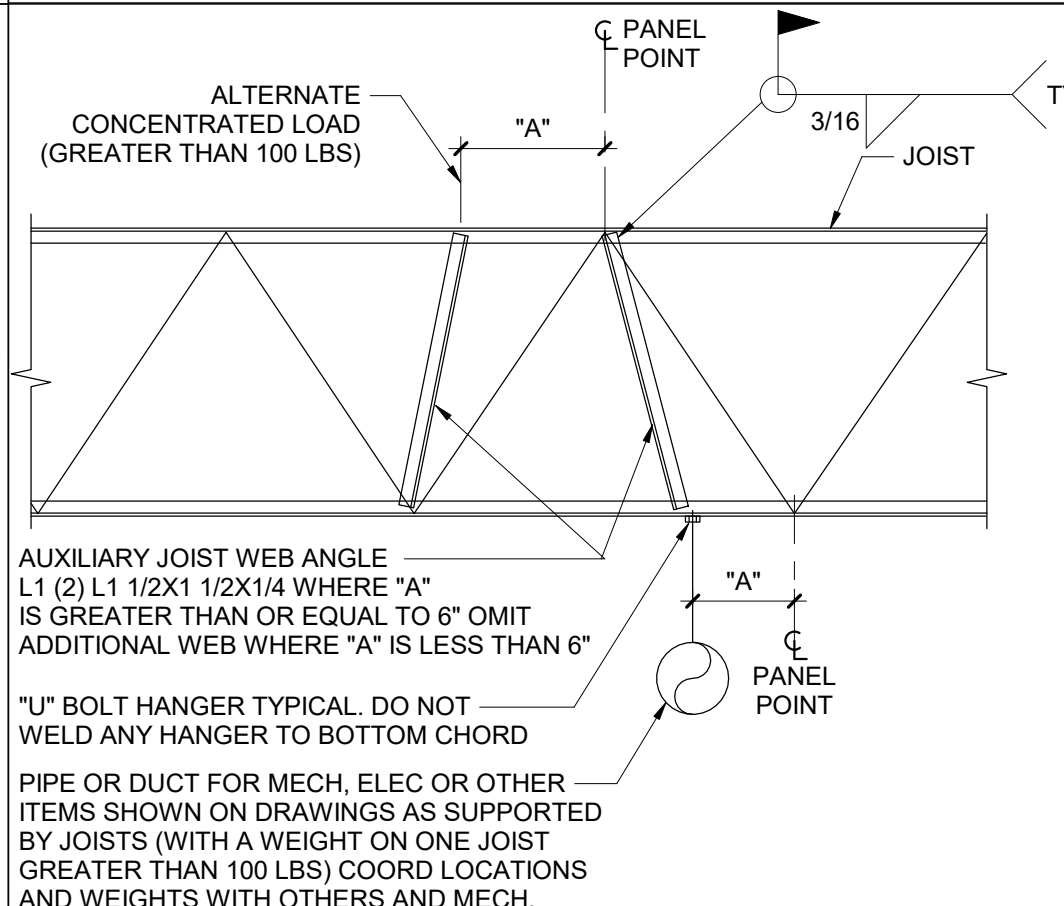


6 Typ Auxiliary Joist Web Member

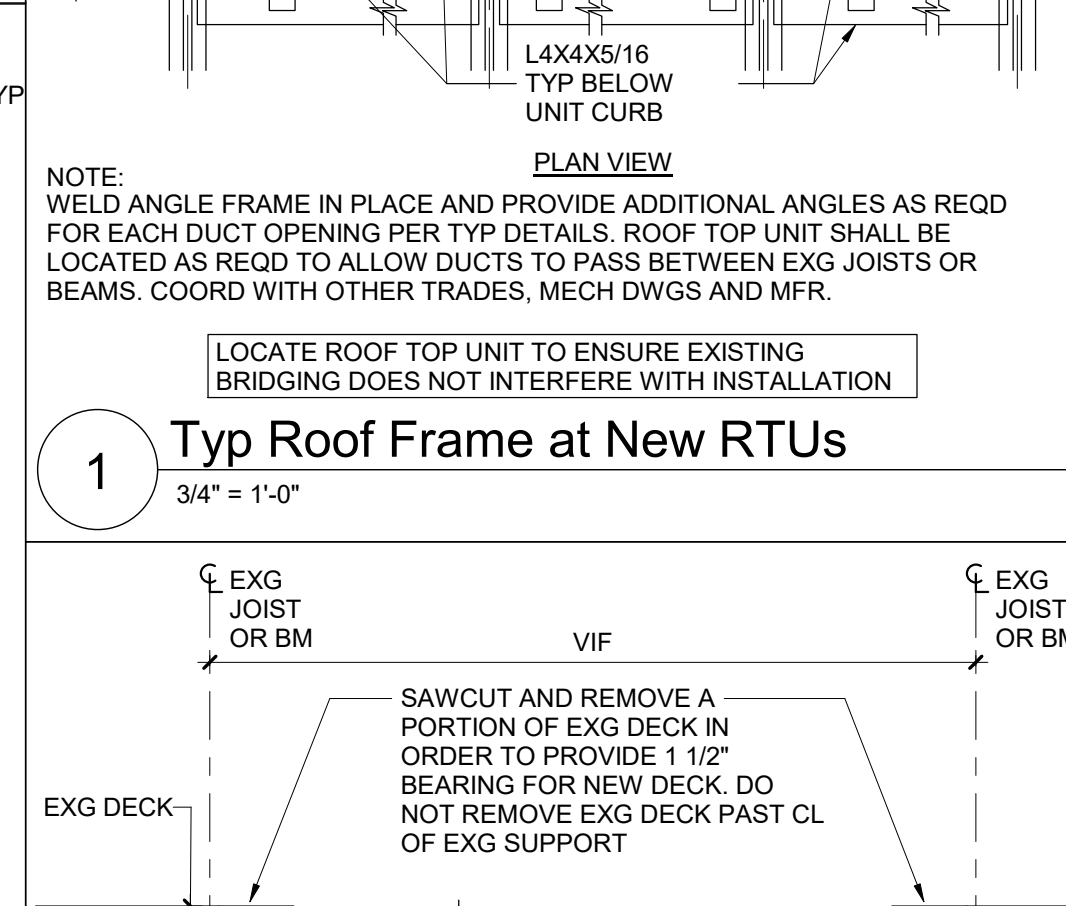


2 Typ Deck Infill at Exg Opening

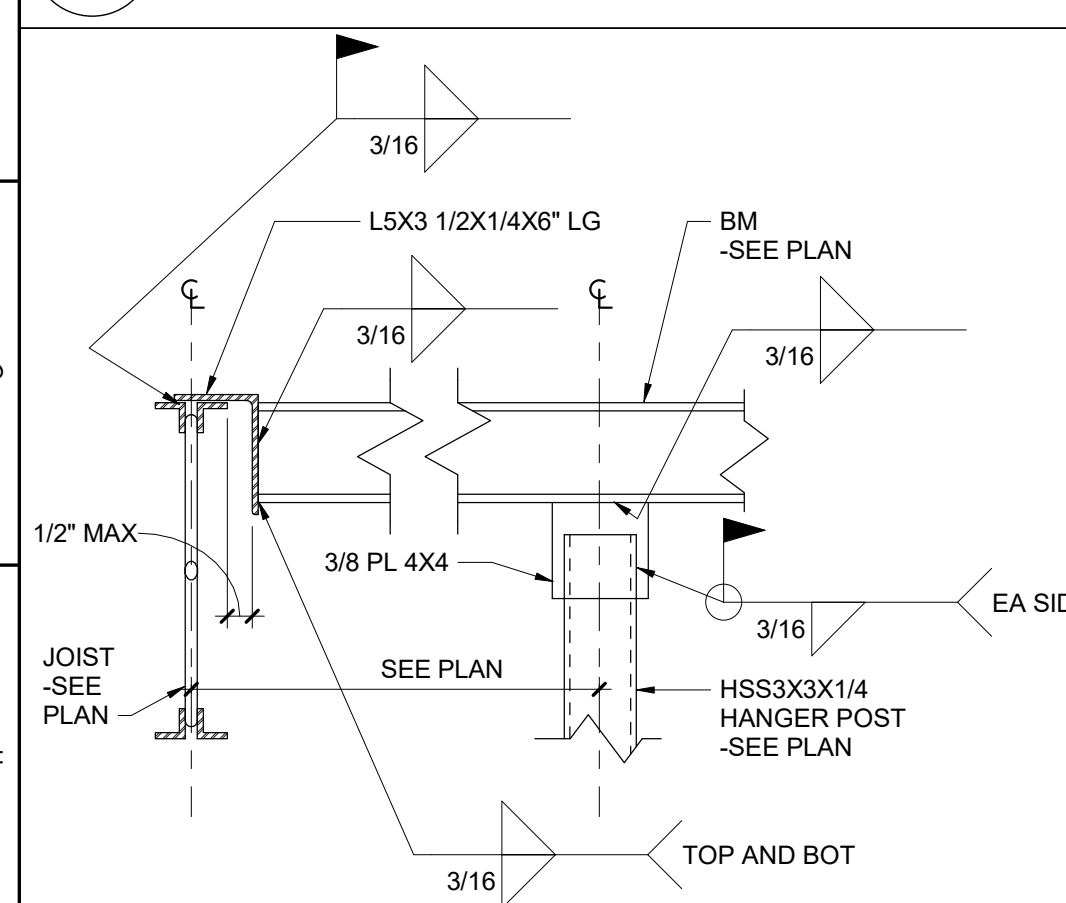


26 Track Hanger Conn at Bm

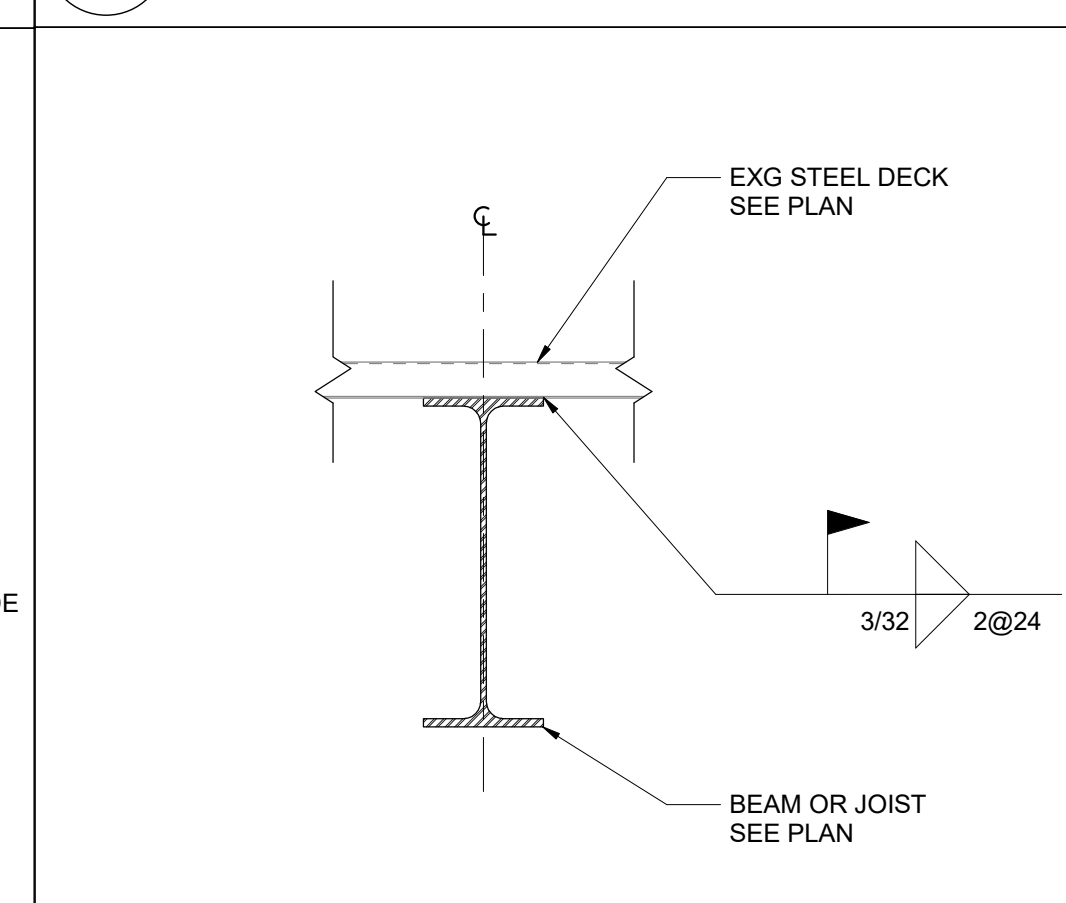


22 Typ New Bm or Joist Attachment @ Exg Deck

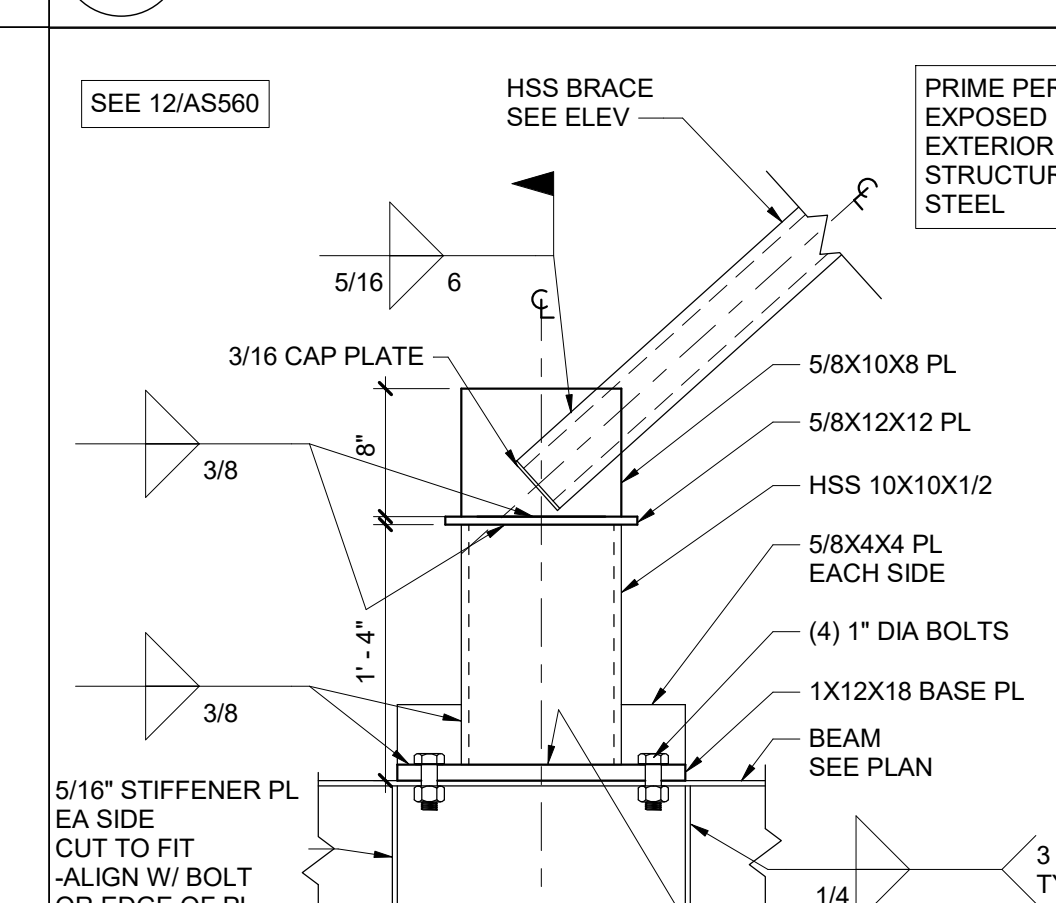


17 Exterior Brace Detail

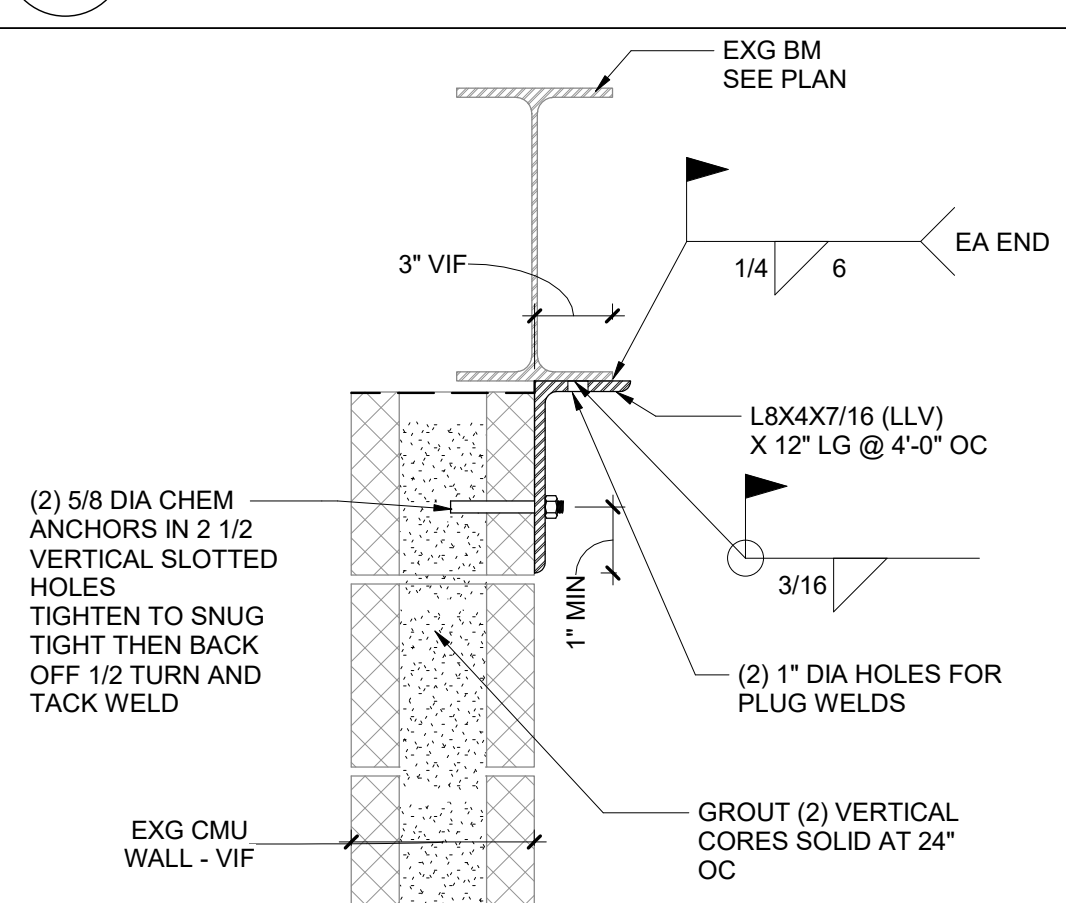


12 Shear Wall Attachment @ Exg CMU Wall

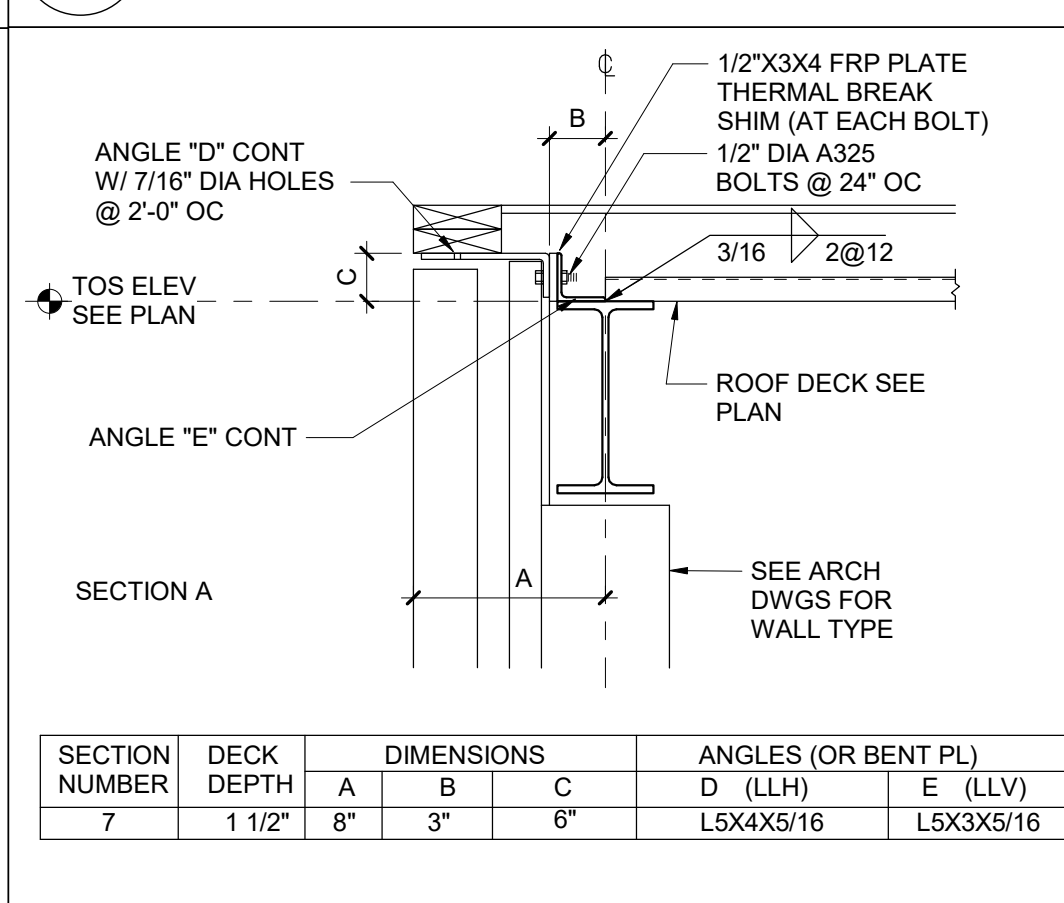


7 Typical Fascia Detail

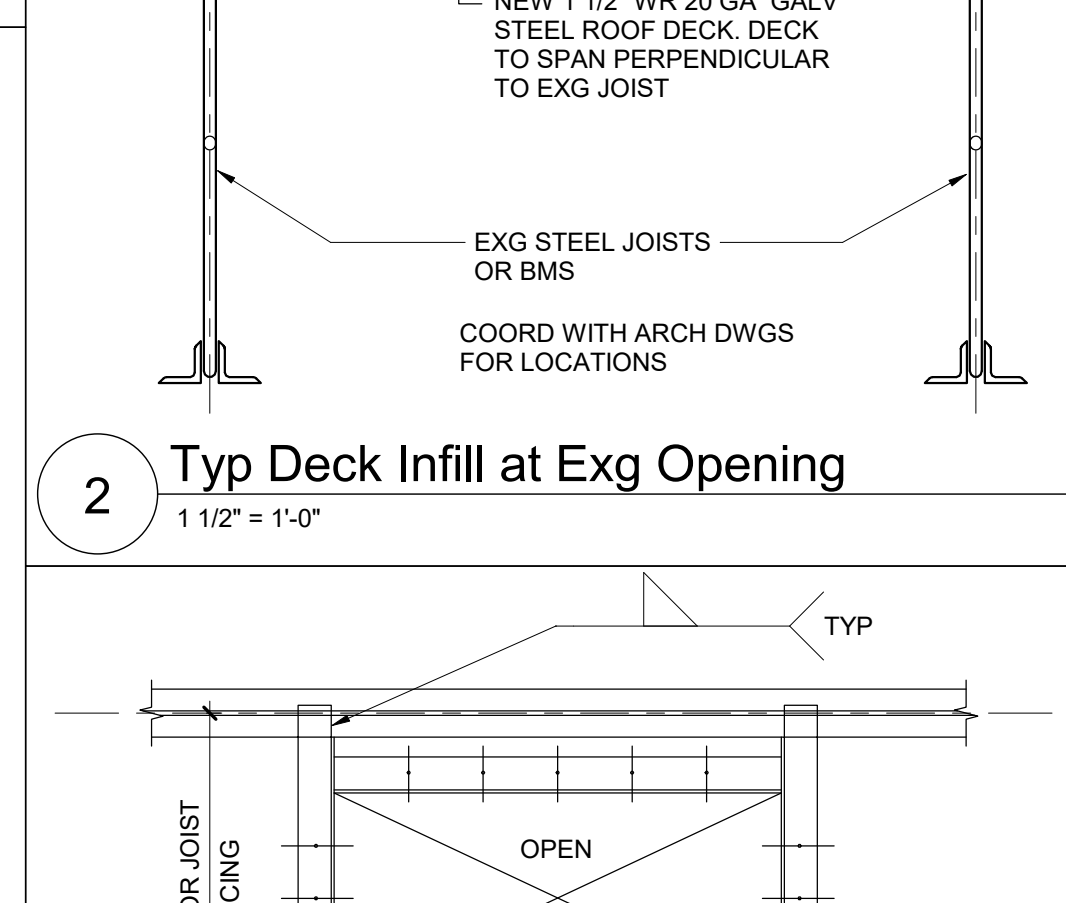


3 Typical Roof Opening Frame

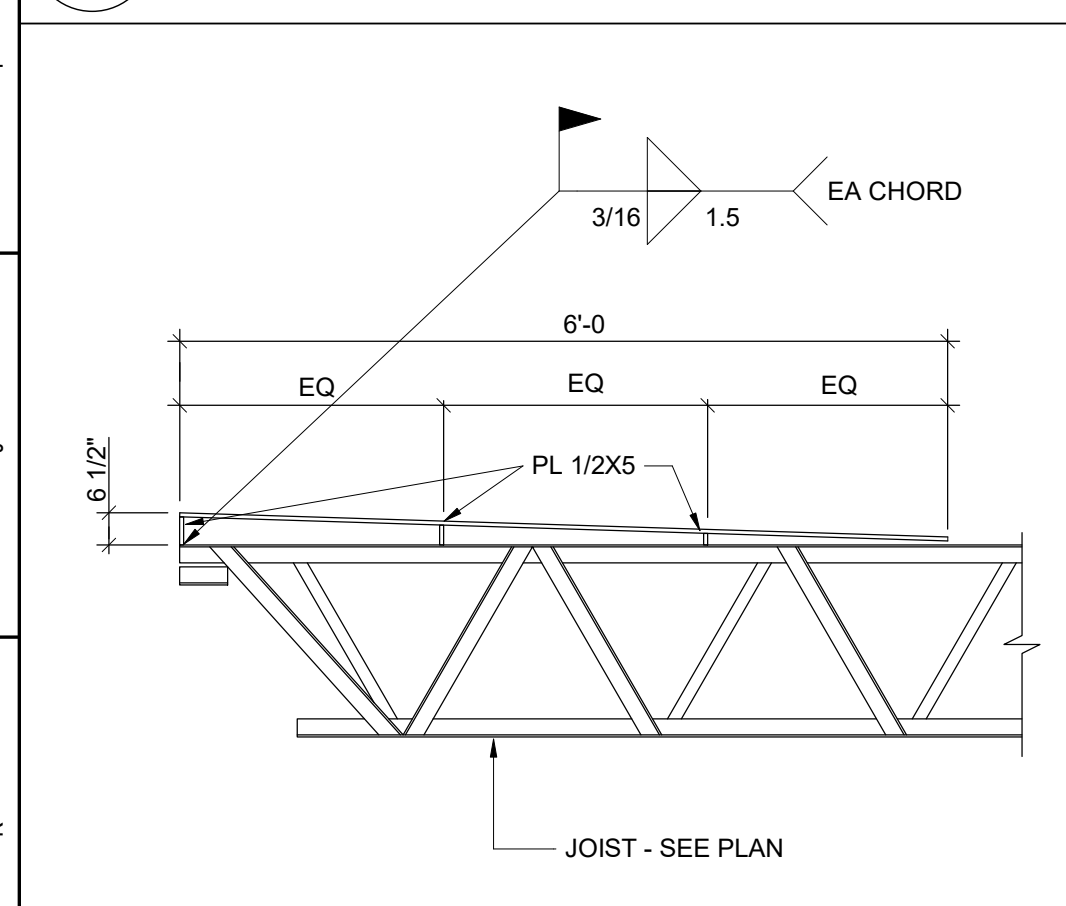


27 Typical Cricket Detail at Roof Edge

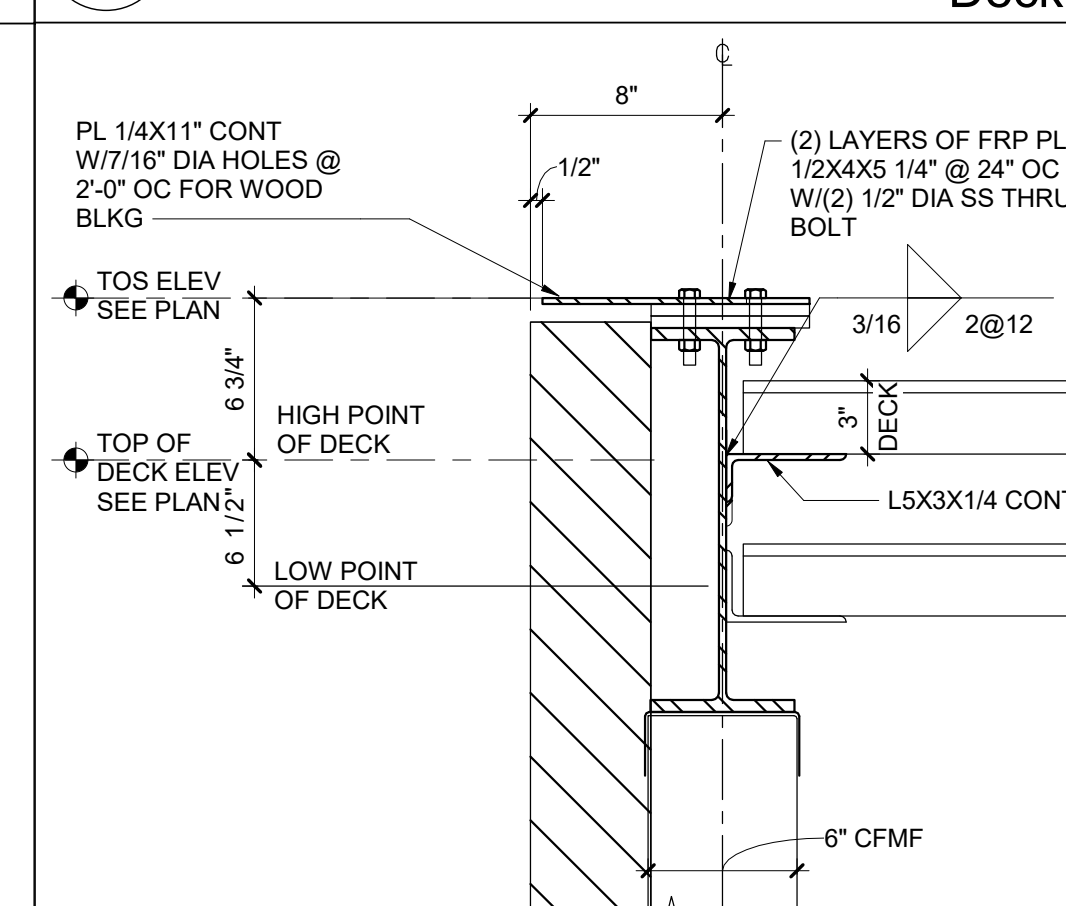


23 Typical Fascia

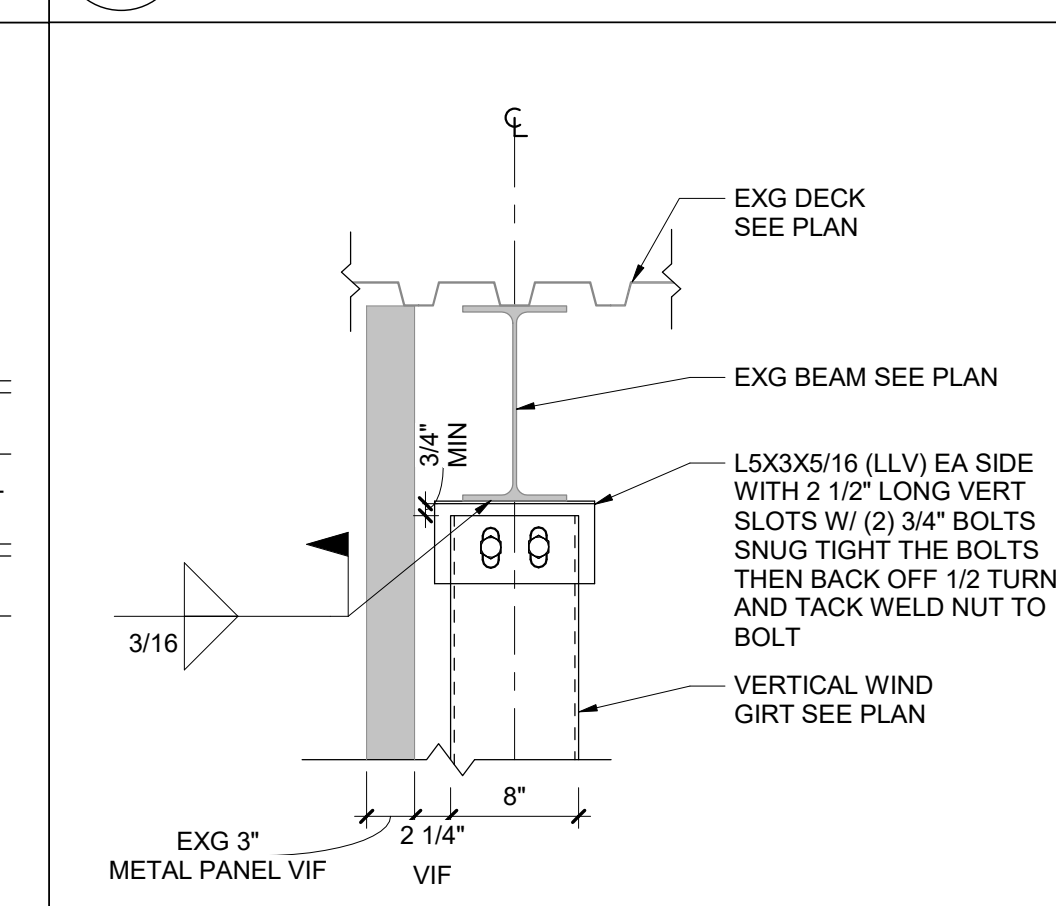


18 Vertical Wind Girt Connection at Top

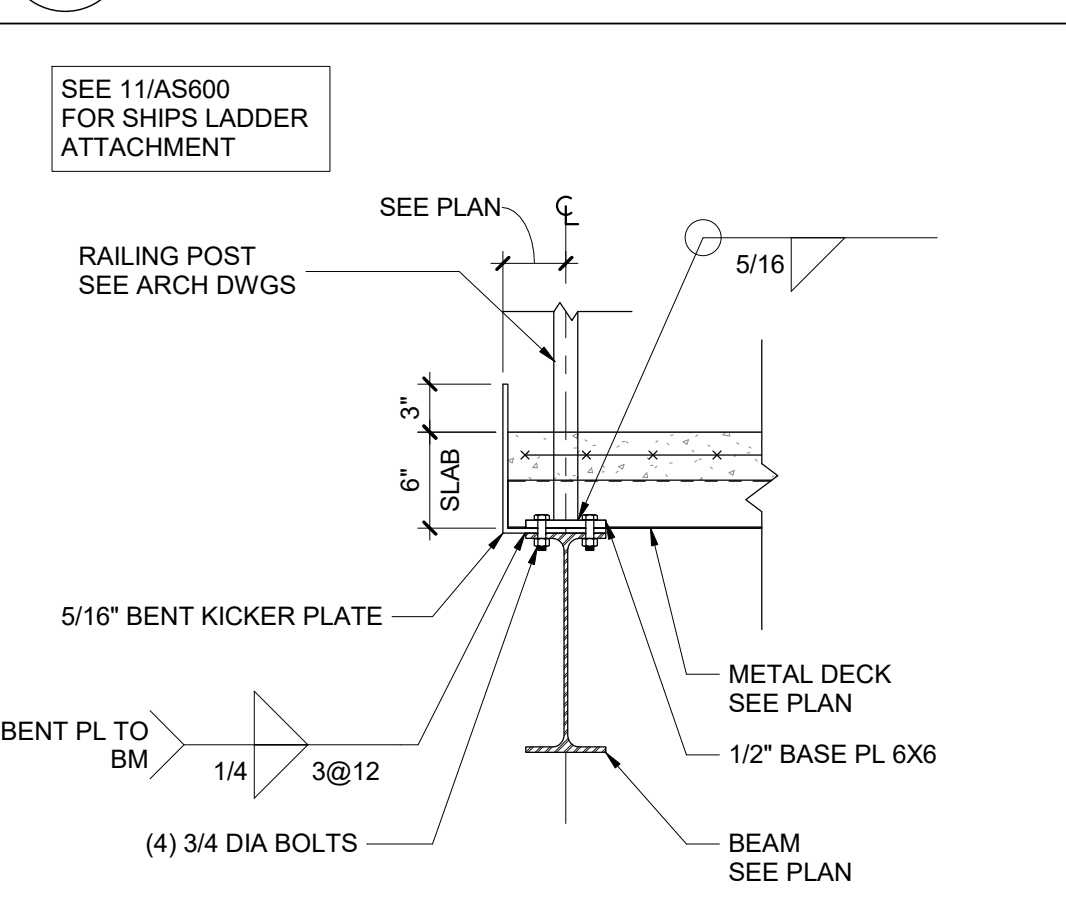


13 Mezzanine Railing Connection

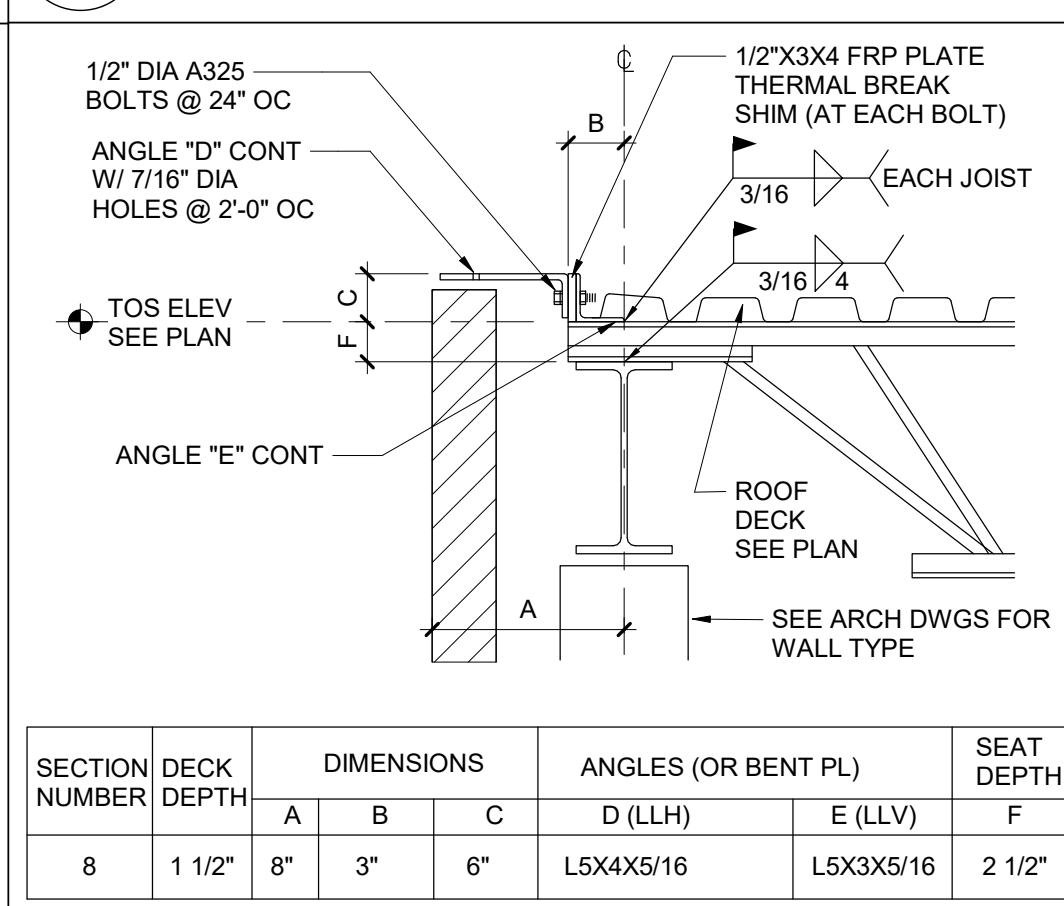


8 Typ Fascia Detail at Joist

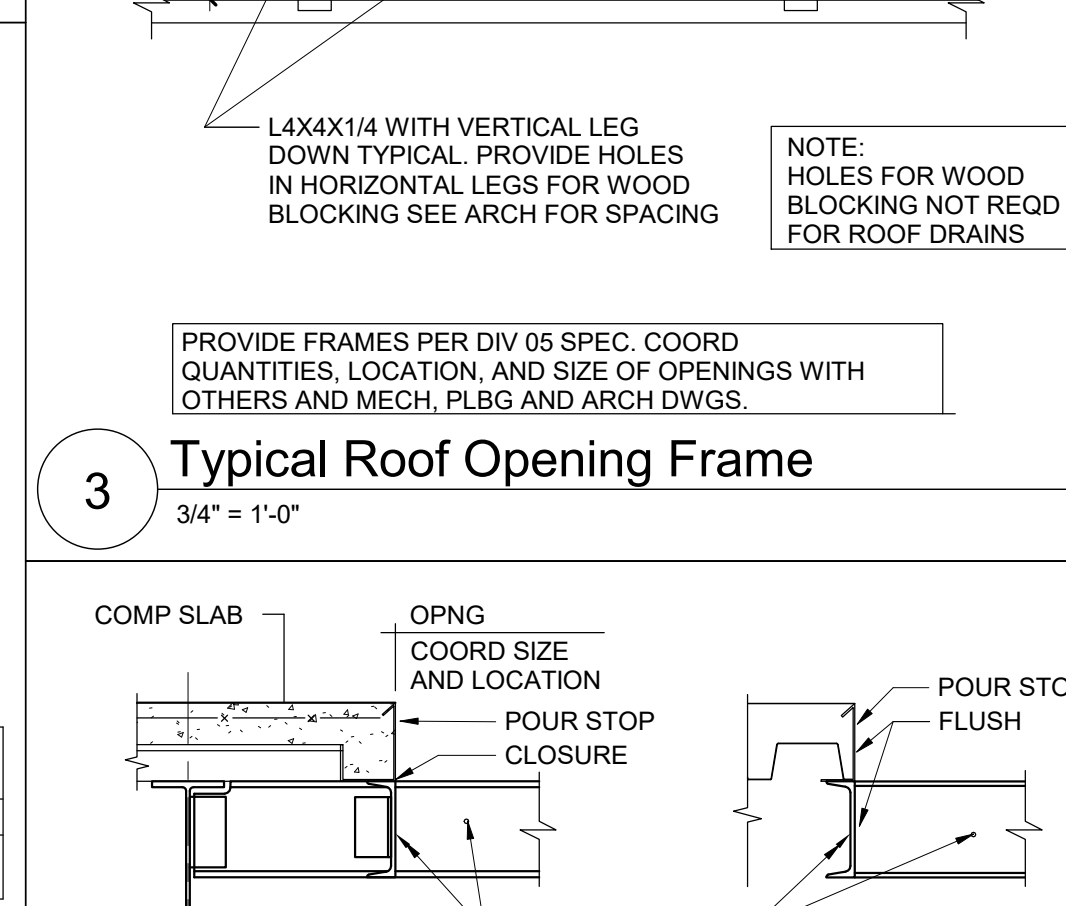


4 Typ Floor Opening Frame

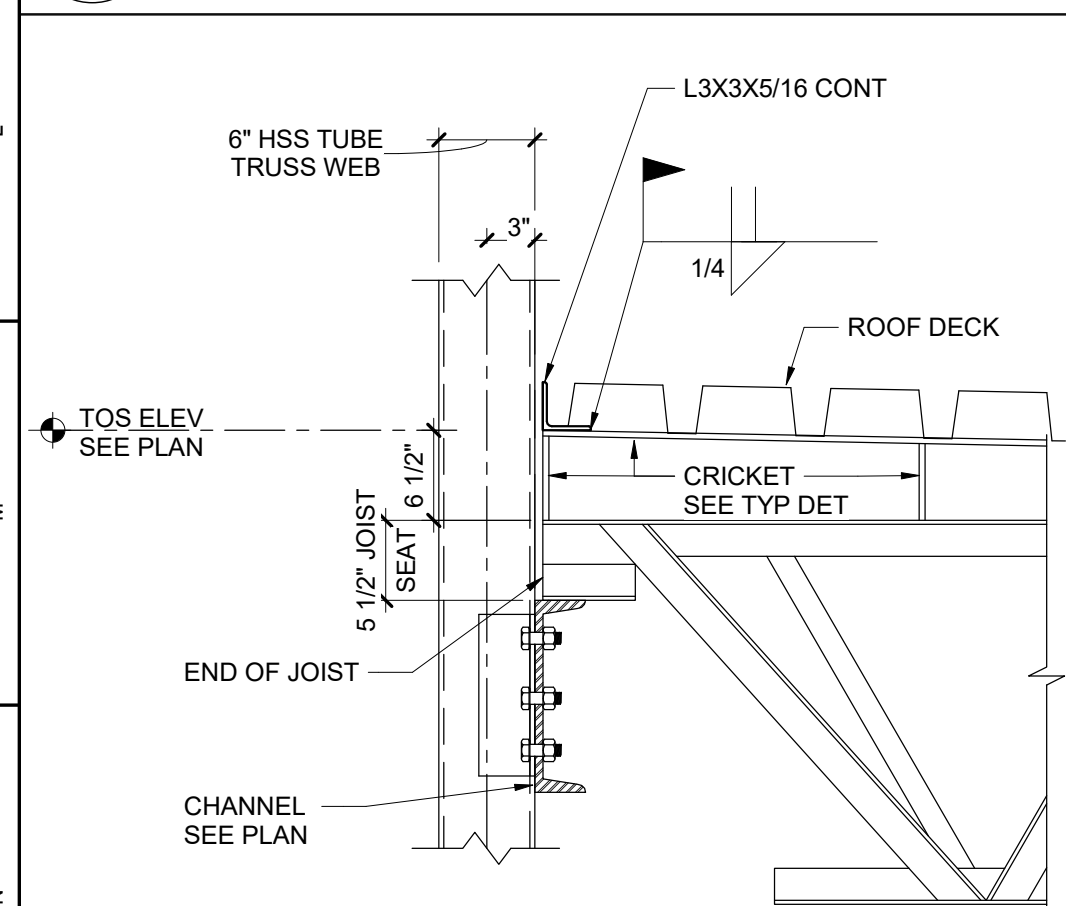


28 Gym High Roof Support At Channel

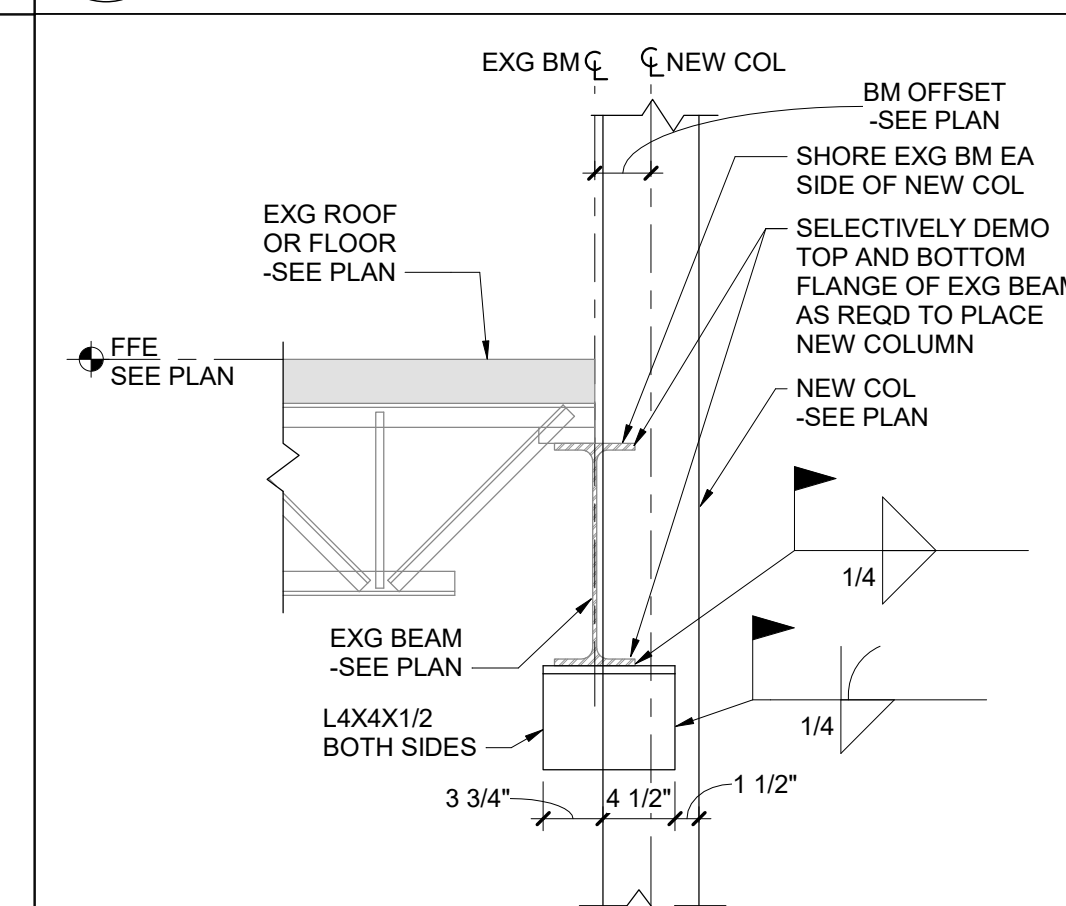


24 New Col at Second Floor Bm

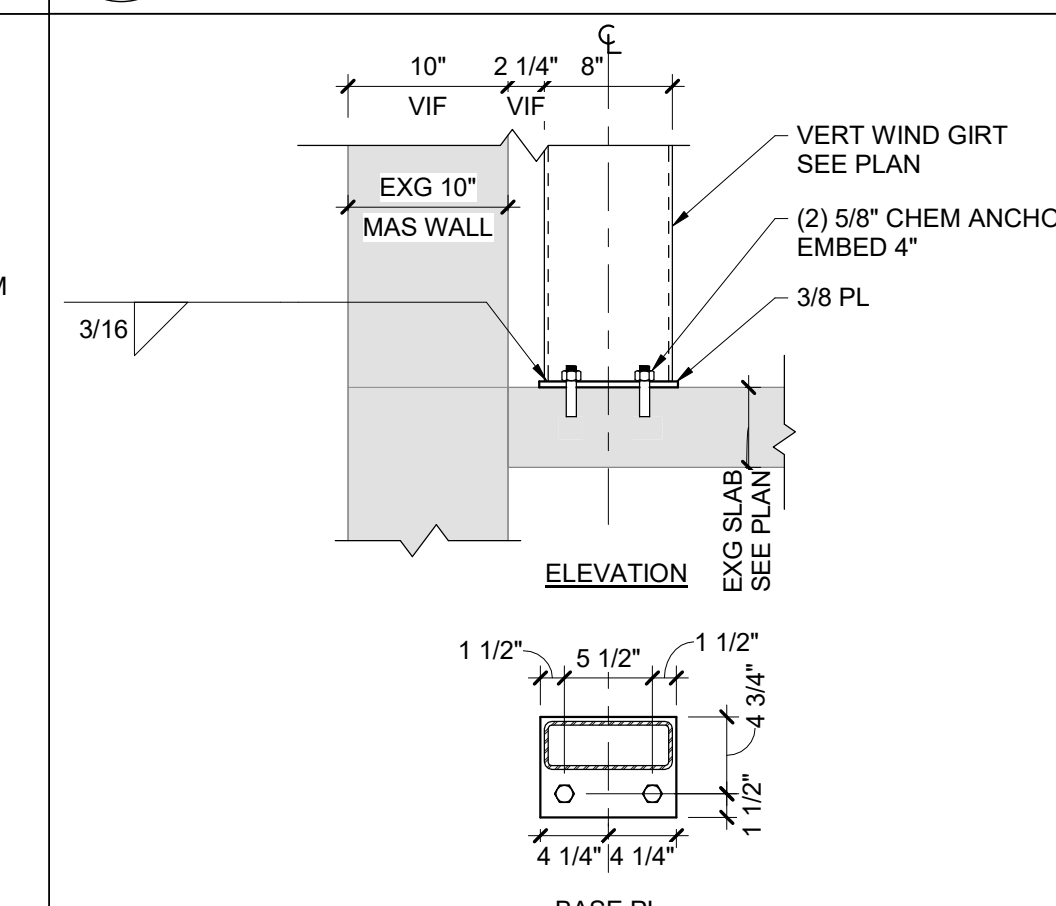

19 Vertical Wind Girt Connection @ Bot

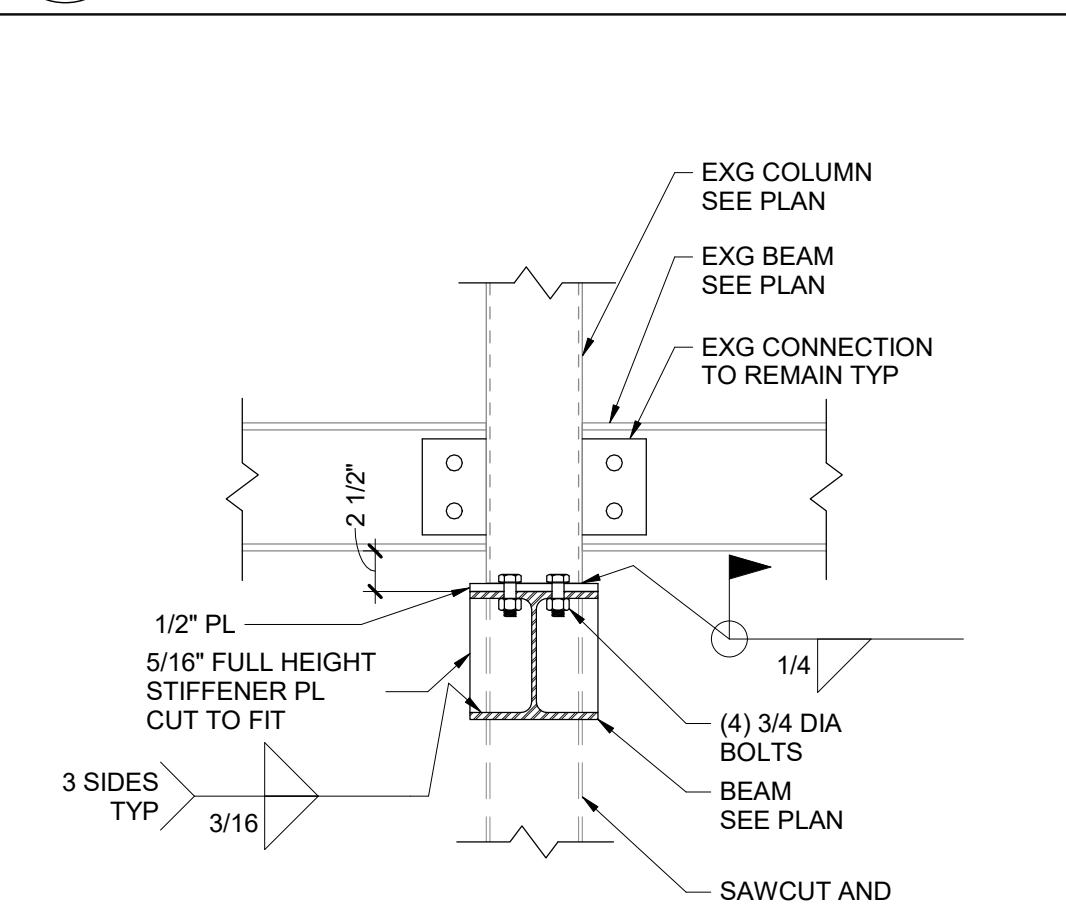

14 Partial Column Demo

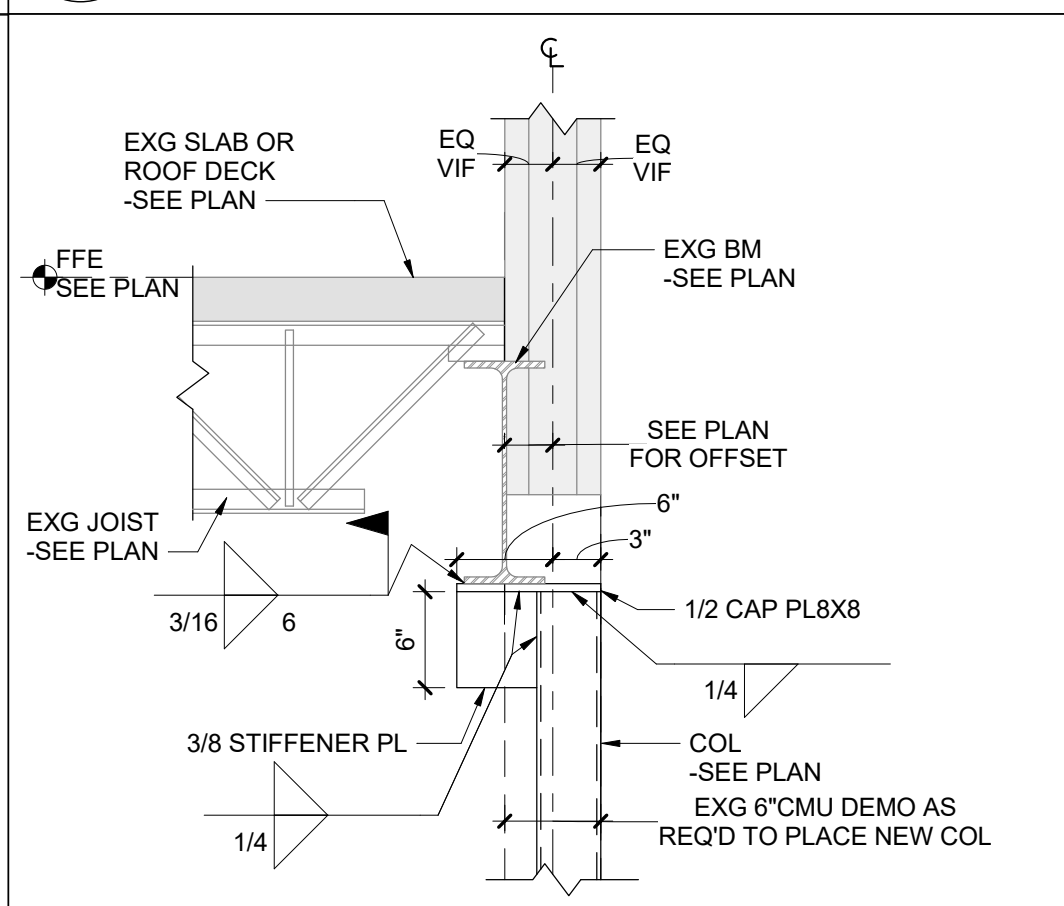

9 New Col at Exg 2nd Floor/Low Rf Bm

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Key Plan
N.T.S.

SED Control No. 60-01-01-06-0-018-023

Rev. No.	Date	Description



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Waverly Central School District
Waverly, NY


Additions and Alterations to:
Waverly Jr. Sr. High School

Framing Details

Drawn By: NDC/vmm
Date: 05/19/2023
Project No.: 339070-22003


Drawing Number:
AS530

BID SET

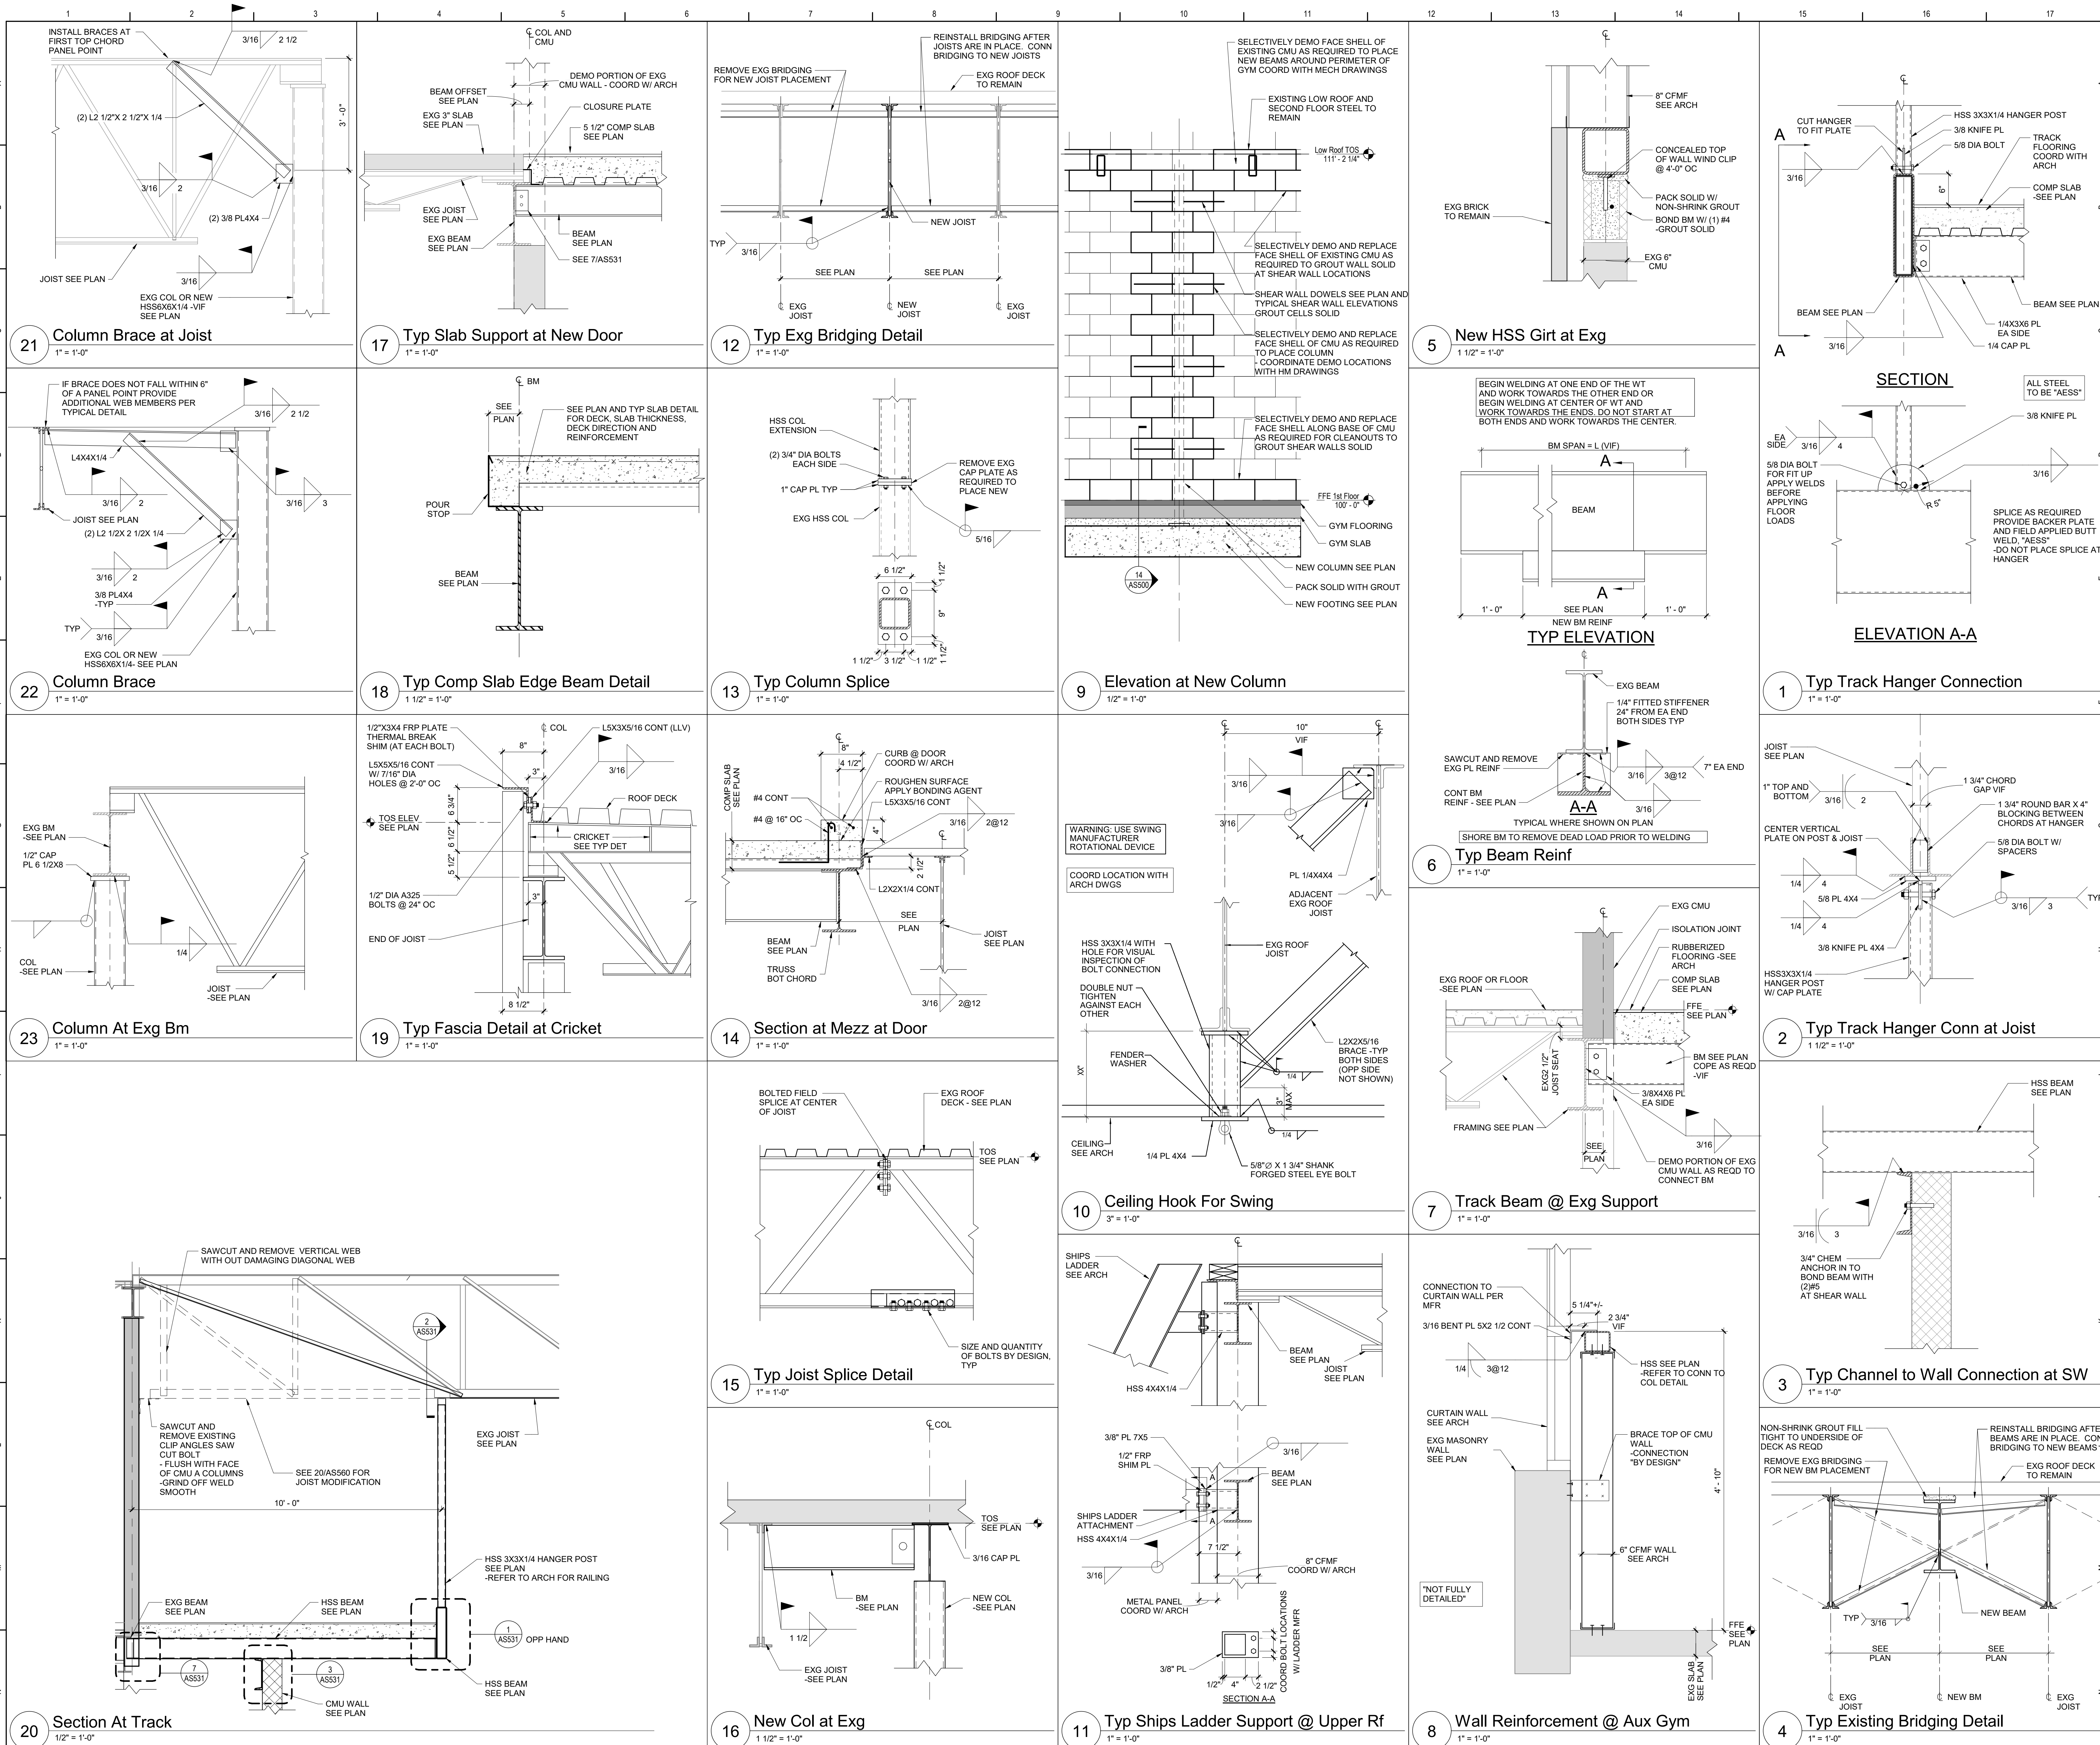

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Rev. No.: Date: Description:

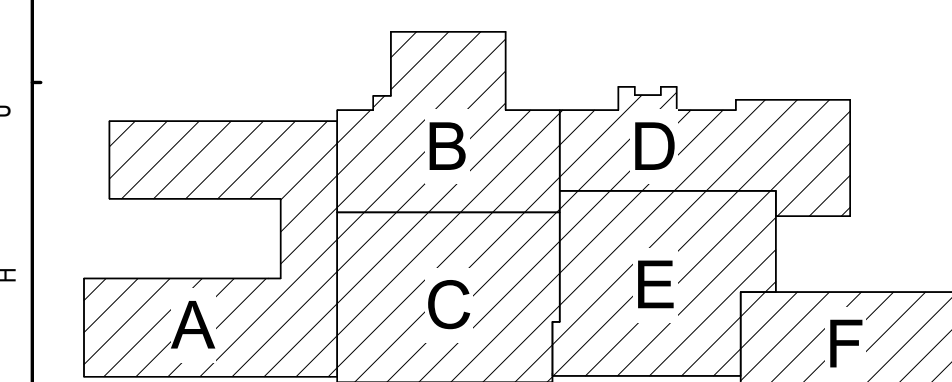

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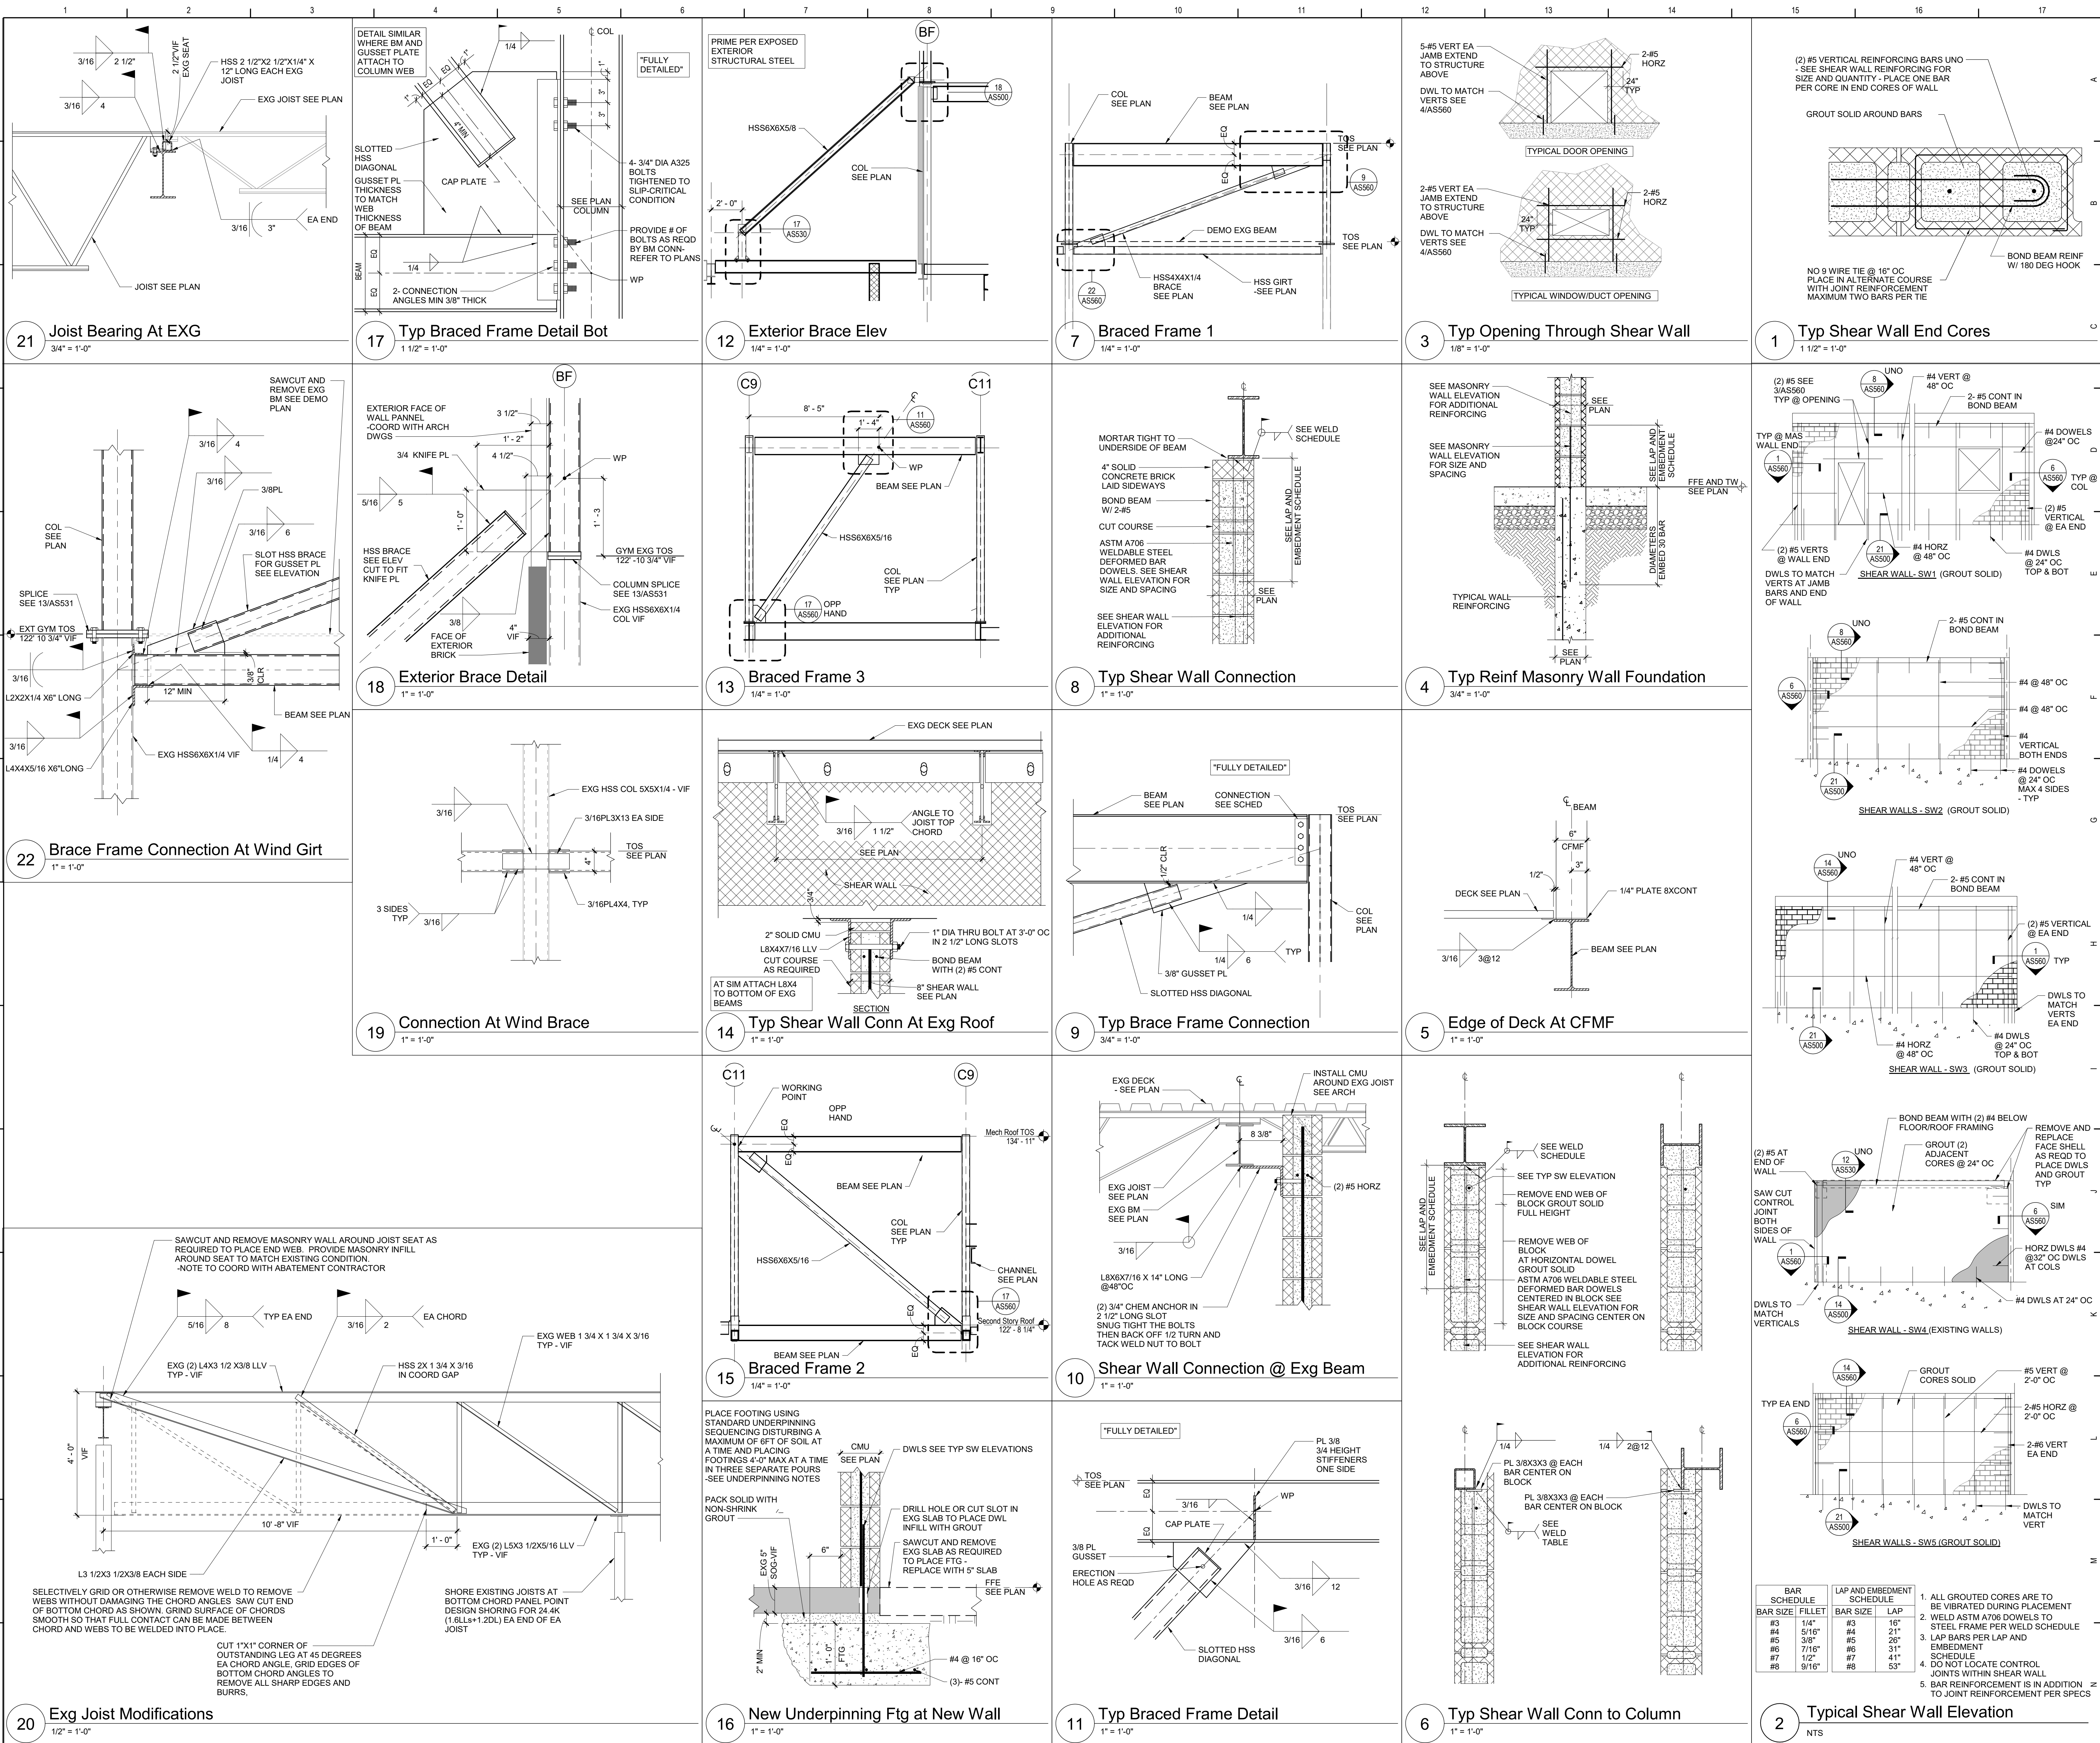
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Waverly Central School District
Waverly, NY

Additions and Alterations to:
Waverly Jr. Sr. High School


Framing Details

Drawn By: NDC/vmm Date: 05/19/2023 Drawing Number:
Project No.: 339070-22003 **AS531**



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Key Plan
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SED Control No. 60-01-01-06-0-018-023

Rev. No.	Date	Description

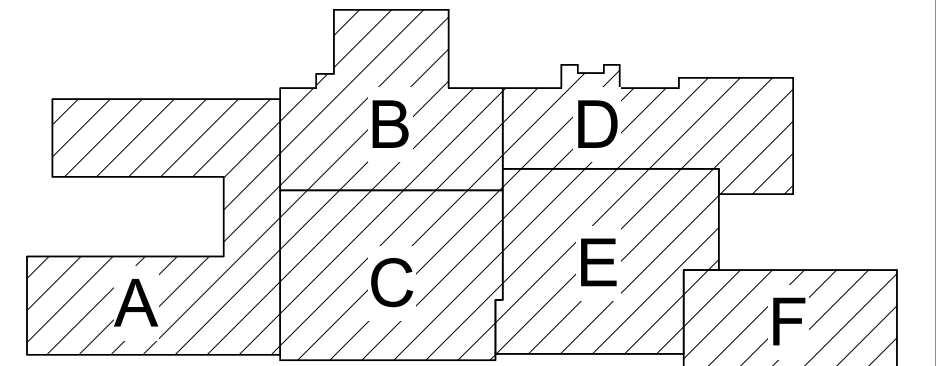

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Waverly Central School District
Waverly, NY

Additions and Alterations to:
Waverly Jr. Sr. High School

Lateral Details and Elevations

Drawn By:
NDC/vmm
Date:
05/19/2023
Drawing Number:
339070-22003
AS560

	1	2	3	4	5	6	7	8	9	10	11	12	13	14	15	16	17
A																	
B																	
C																	
D																	
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V																	
W																	
X																	
Y																	
Z																	

COMPONENTS & CLADDING WIND PRESSURE (PSF)													
MEAN ROOF HEIGHT, "h" (FT)	EFFECTIVE WIND AREA (SQ FT)	ROOF											
		ZONE 1			ZONE 1/1'			ZONE 2			ZONE 3		
		MIDDLE INTERIOR	INTERIOR	OVERHANG	EDGE	OVERHANG	CORNER	OVERHANG	INTERIOR	CORNER	INTERIOR	CORNER	CORNER
35.00	≤ 10	-33.2	16.0	-57.8	16.0	-52.3	-76.2	33.2	-70.7	-76.2	33.2	-70.7	-36.0
	25	-33.2	16.0	-54.0	16.0	-51.3	-71.3	31.7	-64.2	-71.3	31.7	-64.2	-34.0
	50	-33.2	16.0	-48.9	16.0	-50.1	-64.9	29.8	-55.5	-64.9	29.8	-55.5	-32.6
	100	-33.2	16.0	-45.1	16.0	-49.2	-60.0	28.3	-49.0	-60.0	28.3	-49.0	-31.1
	≥ 500	-22.5	16.0	-36.3	16.0	-33.8	-48.6	24.9	-33.8	-48.6	24.9	-33.8	-27.7
NOTES:													
1. MEAN ROOF HEIGHT IS MEASURED ABOVE DATUM FFE, ELEVATION = 100'-0".													
2. REFER TO ASCE 7-16 FOR DEFINITION OF TERMS. FOR THE DIMENSIONS OF EACH ZONE, REFERENCE FIGURE 30.4-1 IN ASCE 7-16 AND USE "h" FROM ABOVE TABLE TO DETERMINE 0.6h AND 0.2h.													
3. THESE TABLES ARE TO BE USED FOR WIND LOAD CONTRIBUTION TO TOTAL LOAD ACTING ON ANY COMPONENT OR CLADDING MEMBER WHICH IS PART OF A ROOF OR EXTERIOR WALL ASSEMBLY. EXAMPLES OF COMPONENTS AND CLADDING INCLUDE, BUT ARE NOT LIMITED TO ROOF JOISTS, WALL STUDS, ROOF DECK FASTENERS, VENEER TIES, WINDOWS, AND THEIR ATTACHMENTS.													
4. FOR EFFECTIVE WIND AREA VALUES LISTED IN THE TABLE ABOVE, PRESSURE VALUES MAY INTERPOLATED; OTHERWISE USE THE VALUE ASSOCIATED WITH THE LOWER EFFECTIVE WIND AREA.													
5. POSITIVE PRESSURES (+) ACT TOWARDS THE BUILDING. NEGATIVE PRESSURES (-) ACT AWAY FROM THE BUILDING. POSITIVE AND NEGATIVE PRESSURES DO NOT ACT SIMULTANEOUSLY. PRESSURES ARE APPLIED TO THE SURFACE OF THE COMPONENT OR CLADDING.													
6. DESIGN VALUES SHOWN IN THIS TABLE ARE ULTIMATE VALUES FOR USE WITH LRFD DESIGN. VALUES MAY BE MULTIPLIED BY 0.6 FOR USE WITH SERVICE LEVEL OR ASD DESIGN. REFER TO THE BUILDING CODE FOR APPLICABLE LOAD COMBINATIONS.													

FTG MARK	FOOTING SIZE	THICKNESS	MAT BARS EACH WAY		
			QUANTITY OF BARS	BAR SIZE	SPACING c/c (in)
F3	3'-0" X 3'-0"	12"	4	#4	10.0
F3A	3'-0" X 3'-0"	16"	4	#4	10.0
F3.5	3'-6" X 3'-6"	12"	5	#4	9.0
F3.5A	3'-6" X 3'-6"	16"	5	#4	9.0
F4	4'-0" X 4'-0"	12"	6	#4	8.4
F4A	4'-0" X 4'-0"	16"	6	#4	8.4
F4.5	4'-6" X 4'-6"	12"	6	#4	9.6
F4.5A	4'-6" X 4'-6"	16"	6	#4	9.6
F5	5'-0" X 5'-0"	12"	7	#4	9.0
F5A	5'-0" X 5'-0"	16"	7	#4	9.0
F5.5	5'-6" X 5'-6"	13"	6	#5	12.0
F5.5A	5'-6" X 5'-6"	16"	6	#5	12.0
F6	6'-0" X 6'-0"	14"	7	#5	11.0
F6A	6'-0" X 6'-0"	16"	7	#5	11.0
F6X3	6'-0" X 3'-0"	16"	6	#6	14.4
F6.5	6'-6" X 6'-6"	16"	6	#6	14.4
F7	7'-0" X 7'-0"	17"	6	#6	15.6
F7.5	7'-6" X 7'-6"	18"	7	#6	14.0
F8	8'-0" X 8'-0"	19"	6	#7	16.0
F8.5	8'-6" X 8'-6"	20"	7	#7	16.0
F9	9'-0" X 9'-0"	21"	10	#6	11.3

REFER TO TYPICAL SPREAD FOOTING DETAIL FOR BAR CONFIGURATION.
3000 PSF BEARING PRESSURE

1. FOR 4" THICK WALLS	MASONRY OPENING UP TO 6'-4"	INTEL ANGLE MT 6X5.9
2. FOR 6" THICK WALLS	MASONRY OPENING (6")	INTEL ANGLE
3. FOR 8", 12", AND 16" THICK WALLS	MASONRY OPENING (8")	INTEL ANGLE
4. ALL OPENINGS 1'-0" AND OVER REQUIRE LINTELS.		
5. THIS SCHEDULE IS TYPICAL FOR ALL MASONRY OPENINGS IN NON-LOAD BEARING WALLS UNLESS OTHERWISE NOTED.		
6. ALL LINTELS TO HAVE MINIMUM 8" BEARING BOTH ENDS.		
7. BACK TO BACK ANGLES ARE TO BE STITCH WELDED TOGETHER BEFORE PLACEMENT.		
8. ALL LINTELS ARE TO HAVE BOTH ENDS BEAR ON SOLID MASONRY OR SOLIDLY GROUTED HOLLOW MASONRY.		
9. WHERE MINIMUM 8" BEARING LENGTH CANNOT BE PROVIDED DUE TO COLUMN INTERFERENCE, PROVIDE CONNECTION OF LINTEL TO COLUMN.		
10. THIS LINTEL SCHEDULE IS APPLICABLE FOR USE IN EXISTING BUILDING. SHORE EXISTING STRUCTURE AND WALL AS REQD FOR INSTALLATION OF NEW MAS AND LINTEL. SEE ARCHITECTURAL AND MECHANICAL DRAWINGS FOR SIZE AND LOCATION OF OPENINGS.		

5	Typ Spread Footing Reinforcement	12" = 1'-0"
3	Lintel Schedule	12" = 1'-0"
6	Typ Chemical Anchors	3" = 1'-0"
4	Pier Schedule	1/2" = 1'-0"
1	Beam Connection Schedule	1/2" = 1'-0"


12	Typical Lintel Detail	1" = 1'-0"
10	TYP Opening At Exg Floor Framing	1 1/2" = 1'-0"
8	TYP Divider Curtain Attachment At Joist	1" = 1'-0"
7	Typical Stiffener Detail	1" = 1'-0"
11	Ships Ladder @ Mech Room Floor	1" = 1'-0"
9	HSS Support At Overhead Door	1" = 1'-0"

2	Base Plates	1 1/2" = 1'-0"
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Structural Loads:		
A. FLOOR LIVE LOADS PER BCNYS 1607		
OCCUPANCY OR USE	UNIFORM	CONCENTRATED
CLASSROOMS	40 PSF	1000 LBS
OFFICES	50 PSF	2000 LBS
CORRIDORS ABOVE FIRST FLOOR	60 PSF	1000 LBS
FIRST FLOOR CORRIDORS	100 PSF	1000 LBS
LOCKER ROOMS	60 PSF	
TOILET ROOMS	60 PSF	
MECHANICAL ROOMS	100 PSF	
STAIRS	100 PSF	300 LBS
REDUCTION IN LIVE LOADS HAS BEEN APPLIED WHERE PERMITTED PER 1607.11		
B. ROOF LIVE LOADS PER BCNYS 1607.13	20 PSF	
C. RAIN LOADS PER BCNYS 1611	2.58 IN/HR	
RAIN SURCHARGE LOAD HAS BEEN APPLIED TO AREAS WHERE PONDING OCCURS IN ACCORDANCE WITH BCNYS 1611.1.		
D. SNOW LOADS PER BCNYS 1608	40 PSF	
GROUND SNOW, P _g (FIGURE 1608.2)	30.8 PSF	
FLAT ROOF SNOW LOAD, P _f (ASCE 7)	1.0	
SNOW EXPOSURE FACTOR, C _e	1.0	
THERMAL FACTOR, C _t	1.0	
SLOPE FACTOR, C _s	1.1	
SNOW LOAD IMPORTANCE FACTOR, I _s		
ADDITIONAL SNOW LOADS HAVE BEEN APPLIED TO AREAS WHERE DRIFTING OCCURS IN ACCORDANCE WITH BCNYS 1608.		
E. WIND LOAD DESIGN CRITERIA PER BCNYS 1609	118 MPH	
BASIC DESIGN WIND SPEED (3 SECOND GUST), V	91.4 MPH	
ALLOWABLE STRESS DESIGN WIND SPEED, V _{allow}	III	
RISK CATEGORY	C	
EXPOSURE CATEGORY	4: 0.18	
INTERNAL PRESSURE COEFFICIENT, GCP		
F. SEISMIC DESIGN CRITERIA PER BCNYS 1613	III	
RISK CATEGORY	1.25	
SEISMIC IMPORTANCE FACTOR, I _s	10.9 %g	
MAPPED SPECTRAL RESPONSE ACCELERATION AT SHORT PERIODS, S _s	4.3 %g	
AT 1 SECOND PERIODS, S ₁	D	
SITE CLASS	11.6 %g	
DESIGN SPECTRAL RESPONSE ACCELERATION AT SHORT PERIODS, S _{ds}	6.9 %g	
AT 1 SECOND PERIODS, S _{1d}	B	
SEISMIC DESIGN CATEGORY		
BASIC SEISMIC-FORCE RESISTING SYSTEM		
(WITH CORRESPONDING RESPONSE MODIFICATION FACTOR, R AND SEISMIC RESPONSE COEFFICIENT, C _s)		
1. STEEL SYSTEM NOT SPECIFICALLY DETAILED FOR SEISMIC RESISTANCE, EXCLUDING CANTILEVERED COLUMN SYSTEMS	R = 3, C _s = 4.8%	
DESIGN BASE SHEAR AREAS A, B, & C, V: 380 KIPS		
ANALYSIS PROCEDURE: EQUIVALENT LATERAL FORCE		
G. SPECIAL LOADS PER BCNYS 1603.1.8		
MECHANICAL EQUIPMENT DEAD LOADS	1191 LB	
RTU-1A	1149 LB	
RTU-2A	2187 LB	
ERV-1	964 LB	
ERV-2	2187 LB	
ERV-3	1899 LB	
RCU-1	757 LB	
RCU-2	1756 LB	
RCU-3	674 LB	
RCU-4	757 LB	
RCU-5	1899 LB	
RCU-6	757 LB	
RCU-7		

Foundation Notes:	
A. MATERIAL	
1. DESIGN BEARING PRESSURE IS ASSUMED TO BE 3,000 PSF. IF OWNERS GEOTECHNICAL ENGINEER DETERMINES THAT INSUFFICIENT BEARING IS ENCOUNTERED, BACKFILL WILL BE PLACED IN MAXIMUM 6" LOOSE LAYERS (MAXIMUM 4" LOOSE LAYERS FOR HAND OPERATED COMPACTION EQUIPMENT) AND COMPACTED TO A DRY DENSITY EQUAL TO 95 PERCENT OF THE MATERIAL DRY DENSITY AS DEFINED BY THE MODIFIED PROCTOR COMPACTION TEST (ASTM D1557). STRUCTURAL FILL AND STONE ARE TO BE IMPORTED FROM OFF SITE. REFER TO PROJECT MANUAL FOR OTHER FILL MATERIAL TYPES.	
2. DO NOT PLACE FILL UNTIL SUBMITTAL FOR FILL MATERIAL IS APPROVED BY ARCHITECT.	
3. INTERIOR BACKFILL IS TO CONSIST OF STRUCTURAL FILL TO BE WITHIN 6" OF BOTTOM SLAB. THE NEXT 6" LAYER ABOVE THIS WILL BE NO. 2 CRUSHED STONE UNLESS NOTED OTHERWISE. PROVIDE A VAPOR BARRIER BETWEEN THE NO. 2 CRUSHED STONE AND THE SLAB FOR ALL INTERIOR SLABS UNLESS NOTED OTHERWISE. BACKFILL WILL BE PLACED IN MAXIMUM 6" LOOSE LAYERS (MAXIMUM 4" LOOSE LAYERS FOR HAND OPERATED COMPACTION EQUIPMENT) AND COMPACTED TO A DRY DENSITY EQUAL TO 95 PERCENT OF THE MATERIAL DRY DENSITY AS DEFINED BY THE MODIFIED PROCTOR COMPACTION TEST (ASTM D1557). STRUCTURAL FILL AND STONE ARE TO BE IMPORTED FROM OFF SITE. REFER TO PROJECT MANUAL FOR OTHER FILL MATERIAL TYPES.	
B. INSTALLATION	
1. AFTER TOPSOIL IS STRIPPED, ALL AREAS WITHIN THE CANOPY FOOTPRINT ARE TO BE PROOF ROLLED WITH A SELF-PROPELLED, SMOOTH DRUM, VIBRATORY COMPACTOR WITH A MINIMUM STATIC WEIGHT OF TEN TONS. PROOF ROLLING WILL BE PERFORMED BY COMPLETING A MINIMUM OF SIX PASSES WITH THE ROLLER OPERATING IN ITS VIBRATORY MODE OVER ALL SUBGRADE AREA. SOFT OR LOOSE SOILS IDENTIFIED DURING THIS ROLLING SHOULD BE EXCAVATED AND REPLACED WITH STRUCTURAL FILL AS DIRECTED BY THE ARCHITECT. SUCH ADDITIONAL EXCAVATION AND BACKFILL WILL BE MEASURED AS DIRECTED BY THE ARCHITECT AND PAID FOR BY THE OWNER AS A CHANGE IN THE WORK. PROOF ROLLING OPERATIONS ARE TO BE PERFORMED UNDER THE SUPERVISION OF THE OWNERS GEOTECHNICAL ENGINEER.	
2. AFTER TRENCHING EXCAVATION, BACKFILL WITH ACCEPTABLE FILL (SEE SPEC) TO WITHIN 1'-0" OF FINISH GRADE / FLOOR. ALL TRENCHING WORK WITHIN THE BUILDING FOOTPRINT IS TO BE COORDINATED. THE CONTRACTOR RESPONSIBLE FOR THE SLAB ON GRADE, MUST ACCEPT IN WRITING THE QUALITY OF THE TRENCH BACKFILL AS PERFORMED BY OTHERS BEFORE BEGINNING HIS WORK OVER TOP OF THE TRENCH.	
3. FOOTINGS ARE TO BEAR AT THE ELEVATIONS SHOWN ON THE PLANS. BEARING TO BE ON VIRGIN SOIL OR COMPACTED STRUCTURAL FILL.	
4. THE ON SITE SOILS ARE SUSCEPTIBLE TO LOSS OF STRENGTH DUE TO WATER AND EXCESSIVE TRAFFIC BY WORKERS AND EQUIPMENT. EXCAVATION AND BACKFILL OPERATIONS ARE TO BE MAINTAINED IN A DRY CONDITION. SURFACE AND INFILTRATING WATER ARE TO BE REMOVED BY SITE GRADING AND PUMPING FROM SUMPS AS REQUIRED. THE REMOVAL AND REPLACEMENT OF SOILS RENDERED UNSTABLE DUE TO EXCESSIVE TRAFFIC OR LACK OF DEWATERING PROCEDURES ARE TO BE PAID FOR BY THE CONTRACTOR.	

Asbestos Awareness – CMU Wall Paint:	
A. CMU WALL PAINT IS ASBESTOS CONTAINING AND IS PRESENT IN AREAS OF SCHEDULED WORK. ASBESTOS PAINT IS LIMITED TO CMU WALLS.	
B. PERFORM WORK SUCH THAT NO PAINTED CMU WALL SURFACES ARE DISTURBED. DISTURBANCE INCLUDES, BUT IS NOT LIMITED TO DETACHMENT OF EXISTING ITEMS FROM THE WALL, ATTACHMENT OF NEW ITEMS TO THE WALL.	
C. ADDITIONAL ASBESTOS CONTAINING ITEMS ARE PRESENT AND INDICATED ELSEWHERE WITHIN THE FACILITIES. REFER TO ON-SITE ASBESTOS DOCUMENTATION FOR FURTHER INFORMATION.	
D. SHOULD ANY PAINTED CMU WALL SURFACE BE REQUIRED TO BE IMPACTED OR DISTURBED, CONSULT THE OWNER'S ENVIRONMENTAL CONSULTANT.	

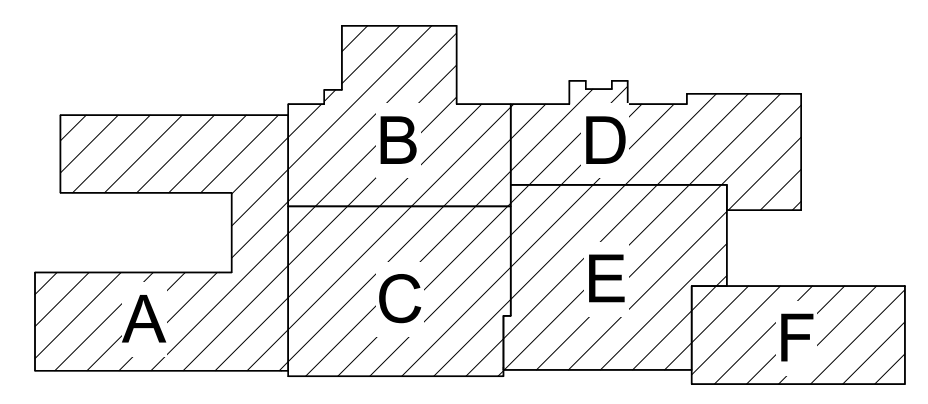

Key Plan	
N.T.S.	
SED Control No. 60-01-01-06-0-018-023	
Rev. No.:	Date:
Description:	



complex world
CLEAR SOLUTIONS

Tetra Tech Engineers, Architects & Landscape Architects, P.C.



Waverly Central School District
Waverly, NY

Additions and Alterations to:
Waverly Jr. Sr. High School

Notes and Schedules

Drawn By: NDC/vmm	Date: 05/19/2023	Drawing Number: AS600
Project No.: 339070-22003		