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DRAWING LIST

GENERAL INFORMATION DRAWINGS

HS-G000 COVER SHEET
HS-G100 GROUND AND FIRST FLOOR OVERALL BUILDING PLANS
AND CODE INFORMATION

HS-G101 SECOND FLOOR OVERALL BUILDING PLAN AND CODE INFORMATION

HS-G102 THIRD AND FOURTH FLOOR OVERALL BUILDING PLANS AND CODE INFORMATION

CIVIL DRAWINGS

HS-C100 SITE PLANS HS-C510 SITE DETAILS HS-C530 EROSION CONTROL DETAILS

ARCHITECTURAL DRAWINGS

HS-A100 ARCH AND GYM ENTRANCE ELEVATIONS

STRUCTURAL DRAWINGS

HS-S100 STRUCTURAL ELEVATION DETAILS AND NOTES


MECHANICAL DRAWINGS

HS-M100 BOILER ROOM PLAN

ELECTRICAL DRAWINGS

HS-E000 ABBREVIATIONS, GENERAL NOTES, AND LEGENDS HS-E100 ELECTRICAL SITE PLAN AND DETIALS HS-E101 BOILER ROOM PLAN

LOCATION MAP:

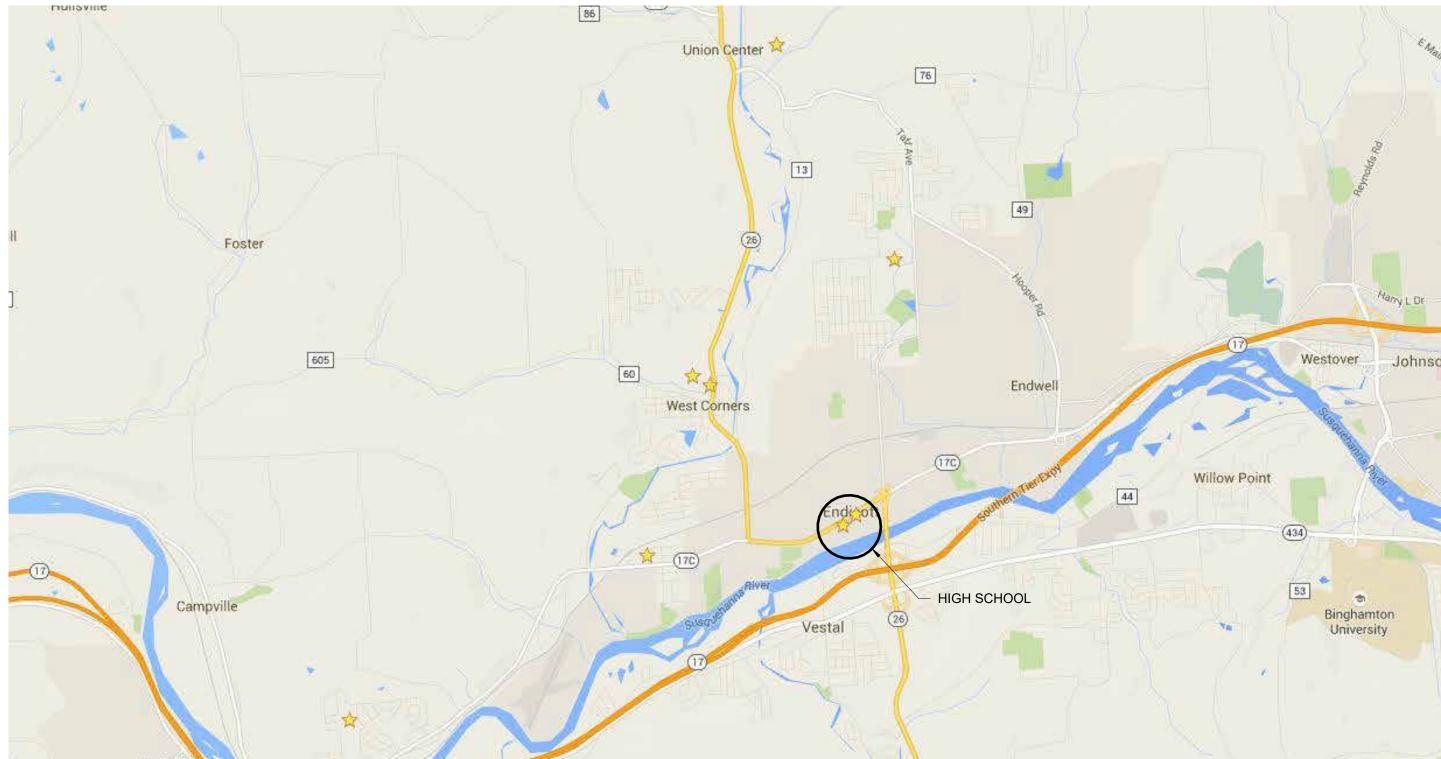

AERIAL PHOTO:



2023 CAPITAL IMPROVEMENTS - PHASE 3 UNION-ENDICOTT CENTRAL SCHOOL DISTRICT

SENIOR HIGH SCHOOL

1200 EAST MAIN STREET ENDICOTT, NY 13760 ARCADIS PROJECT NO: 143846 SED PROJECT NOS: SENIOR HIGH SCHOOL

03-15-01-06-0-011-

3 CAPITAL IMPROVEMENTS - PHASE 3 N-ENDICOTT CENTRAL SCHOOL DISTRICT

EXPIRATION DATE: 02-28-2027

NIOR HIGH SCHOOL

DATE: 2025-10-01

PROJECT NO: 143846

143846


CLIENT PROJECT NO:
03-15-01-06-0-011-049


PRIME CONSULTANT


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DRAWING SET





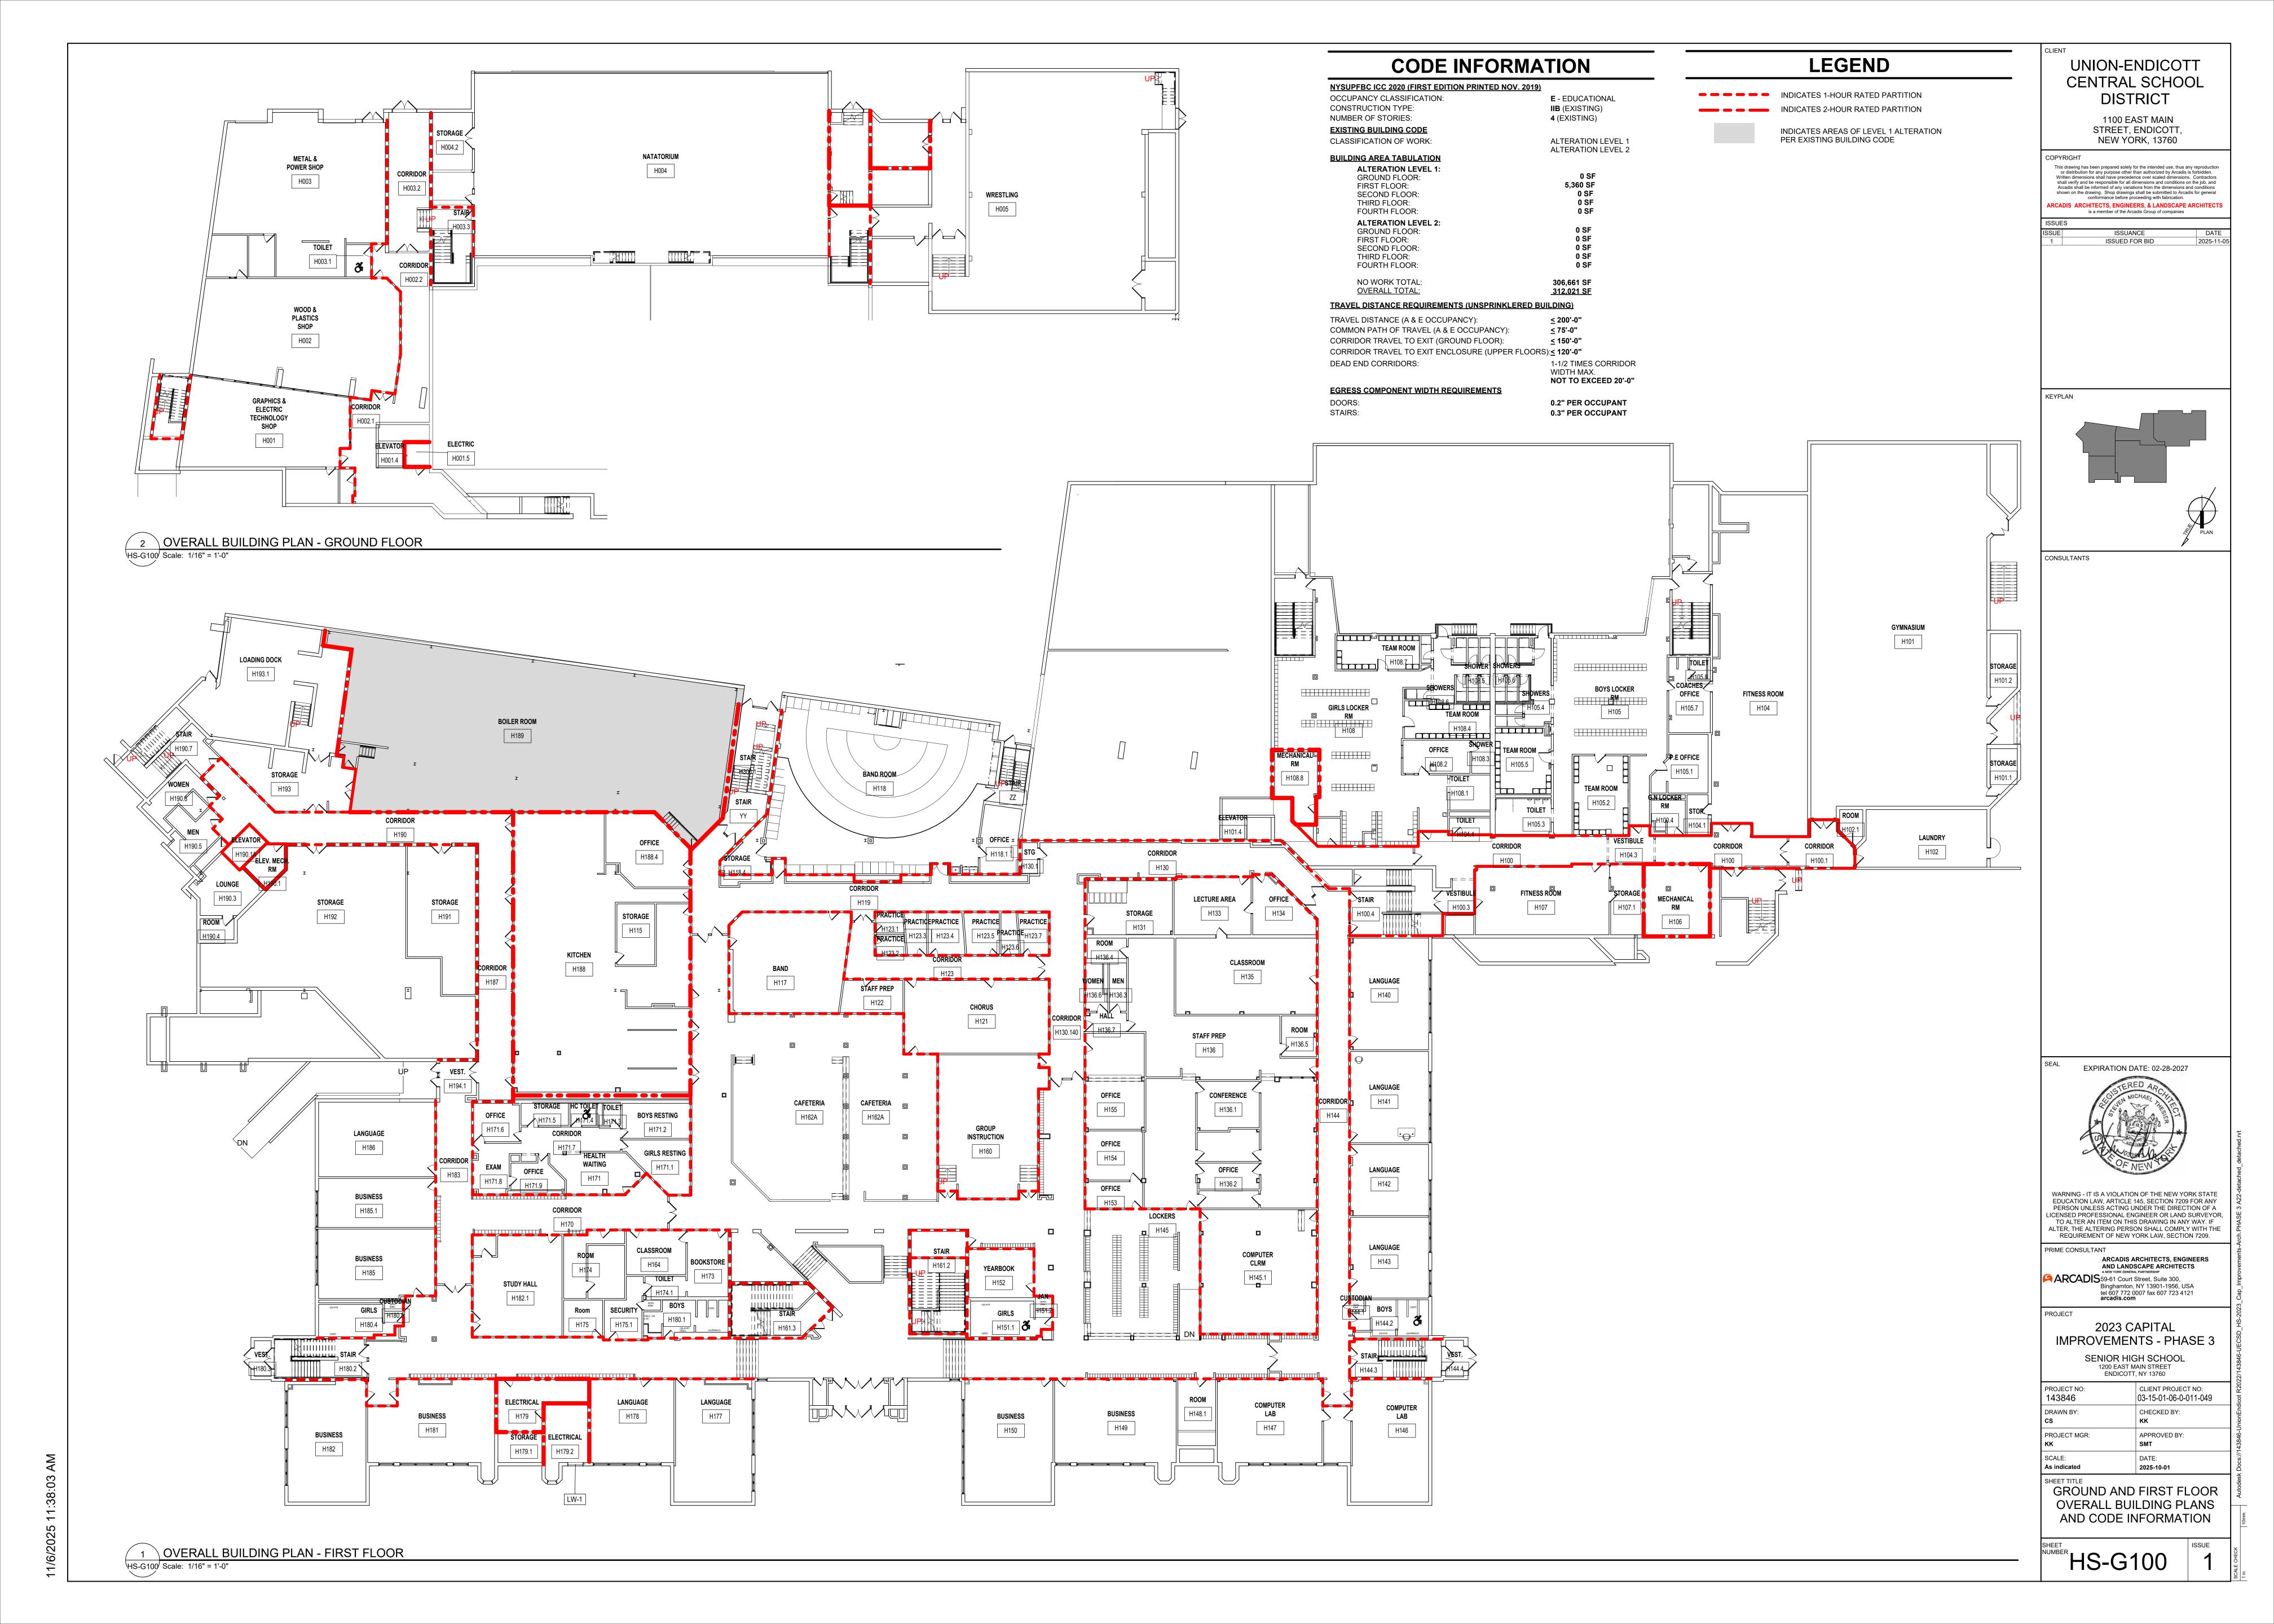

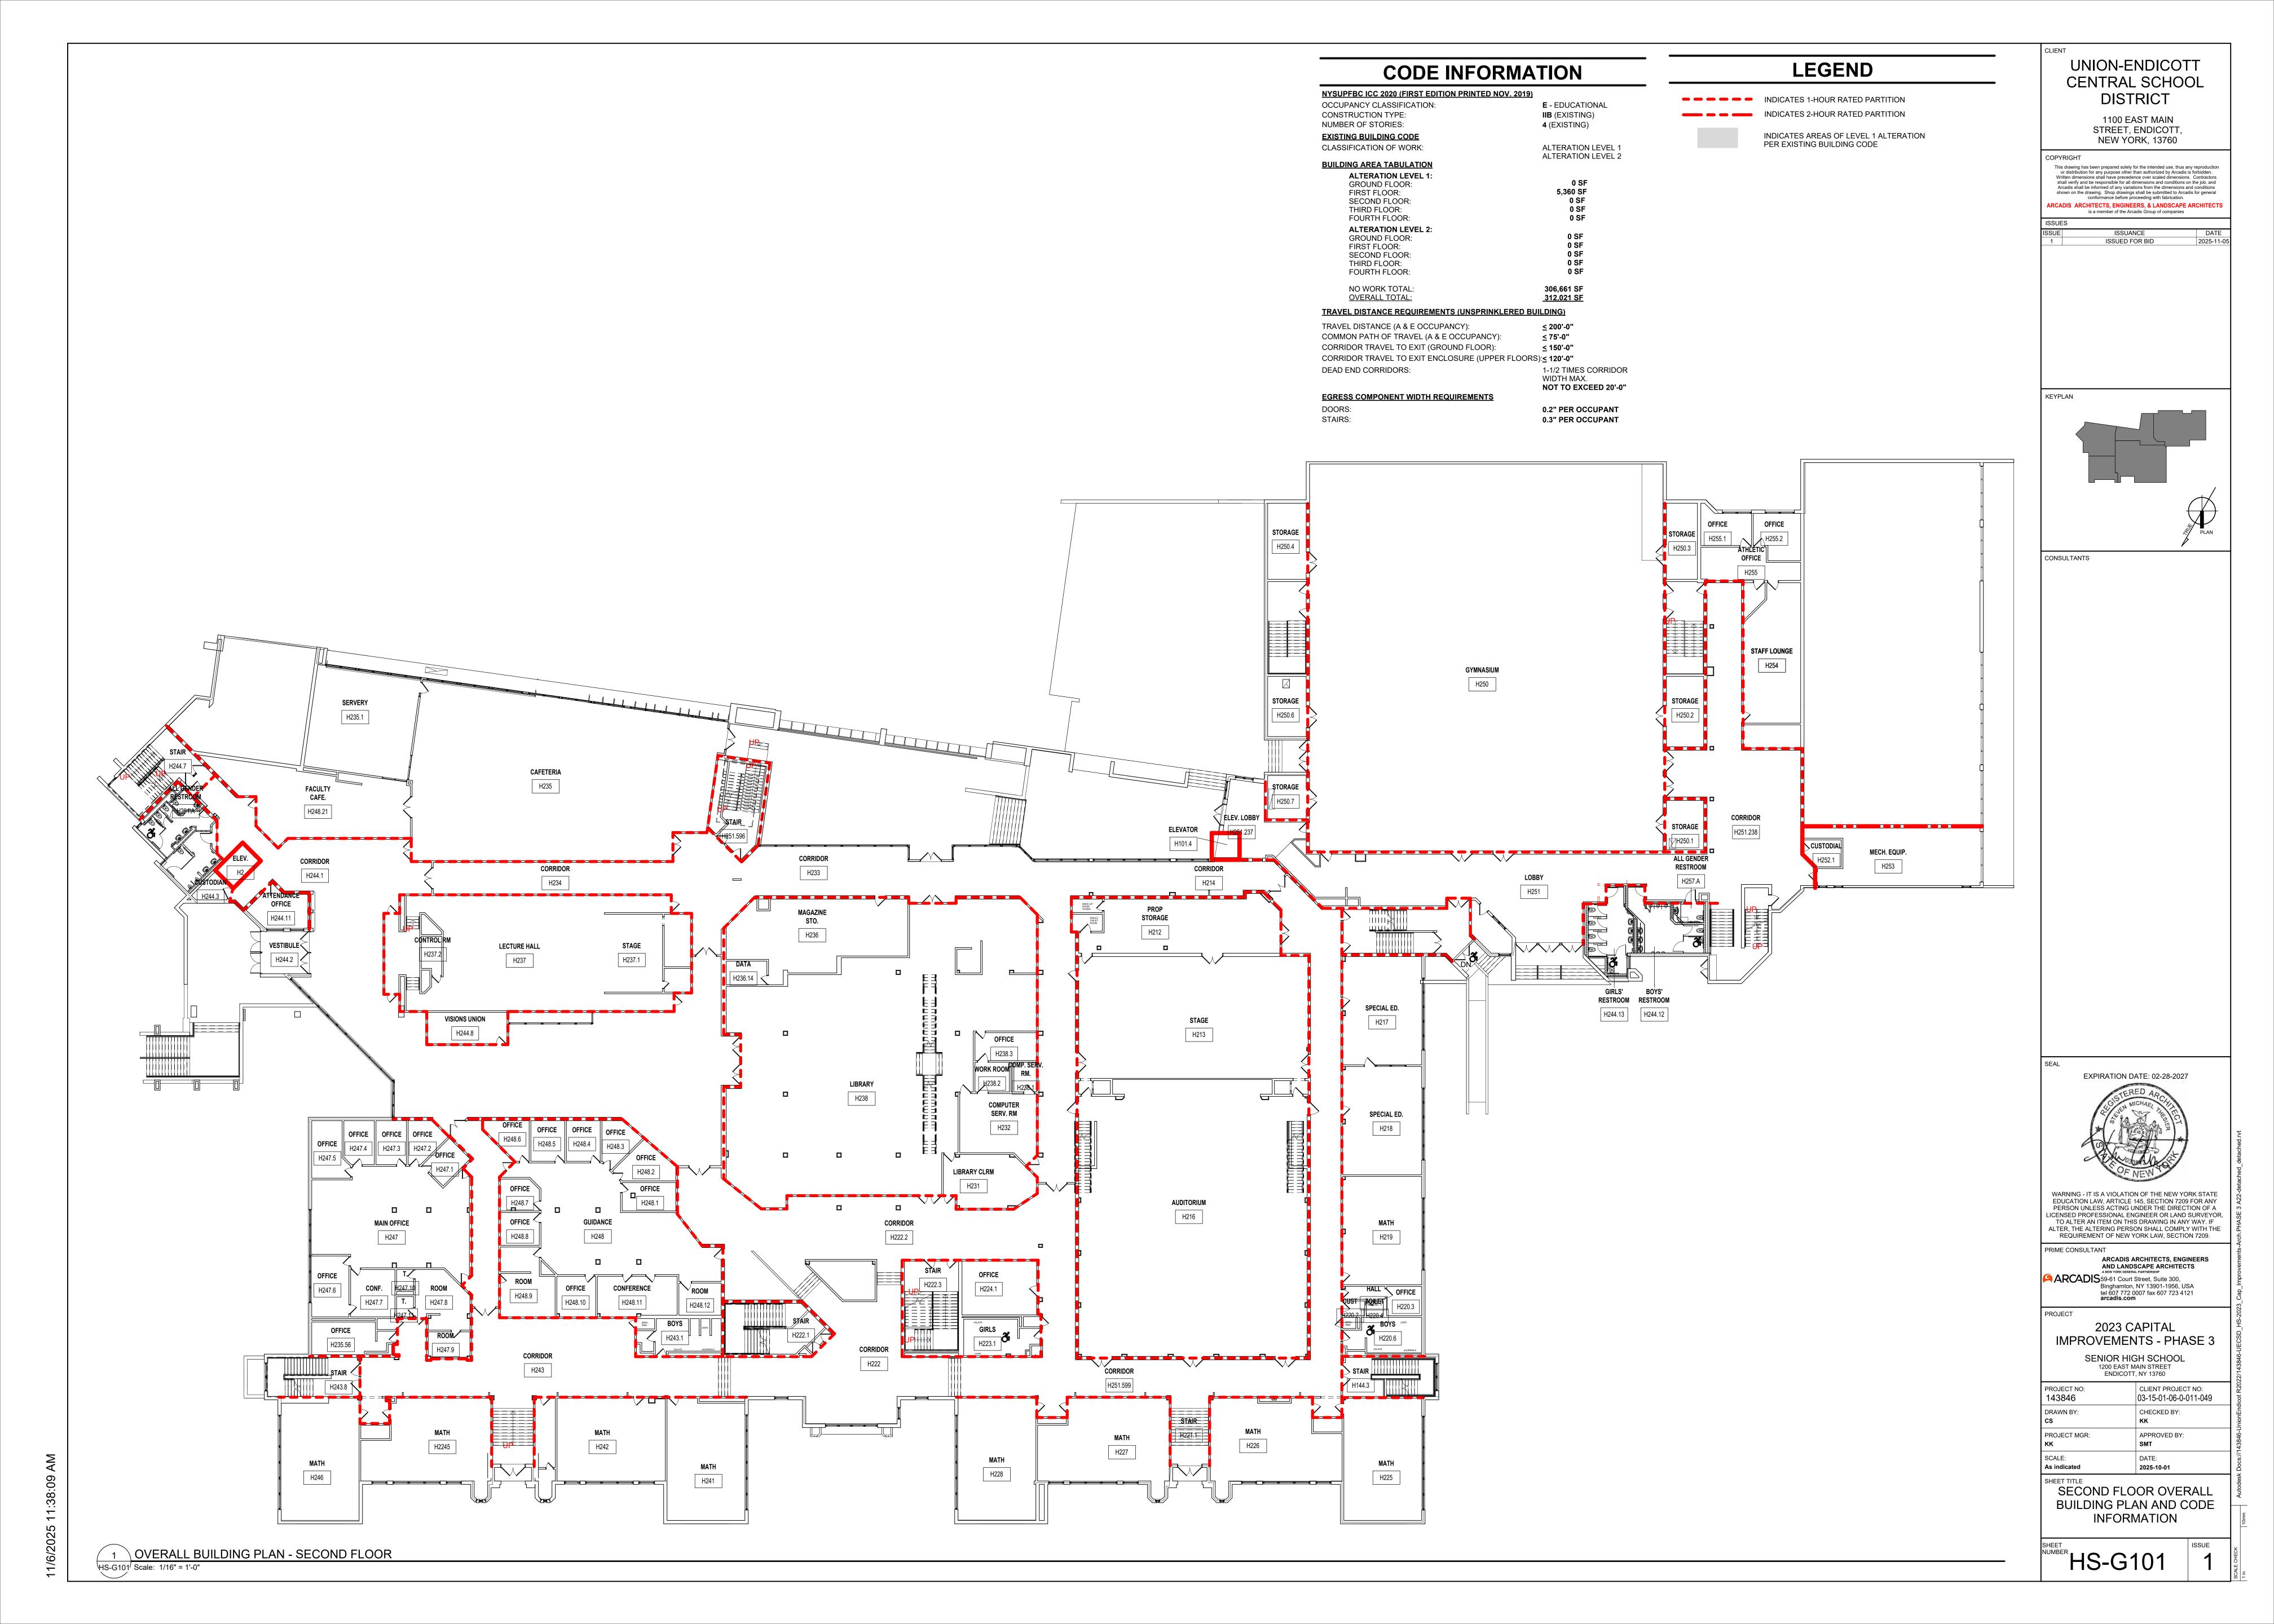UNION-ENDICOTT CENTRAL SCHOOL DISTRICT
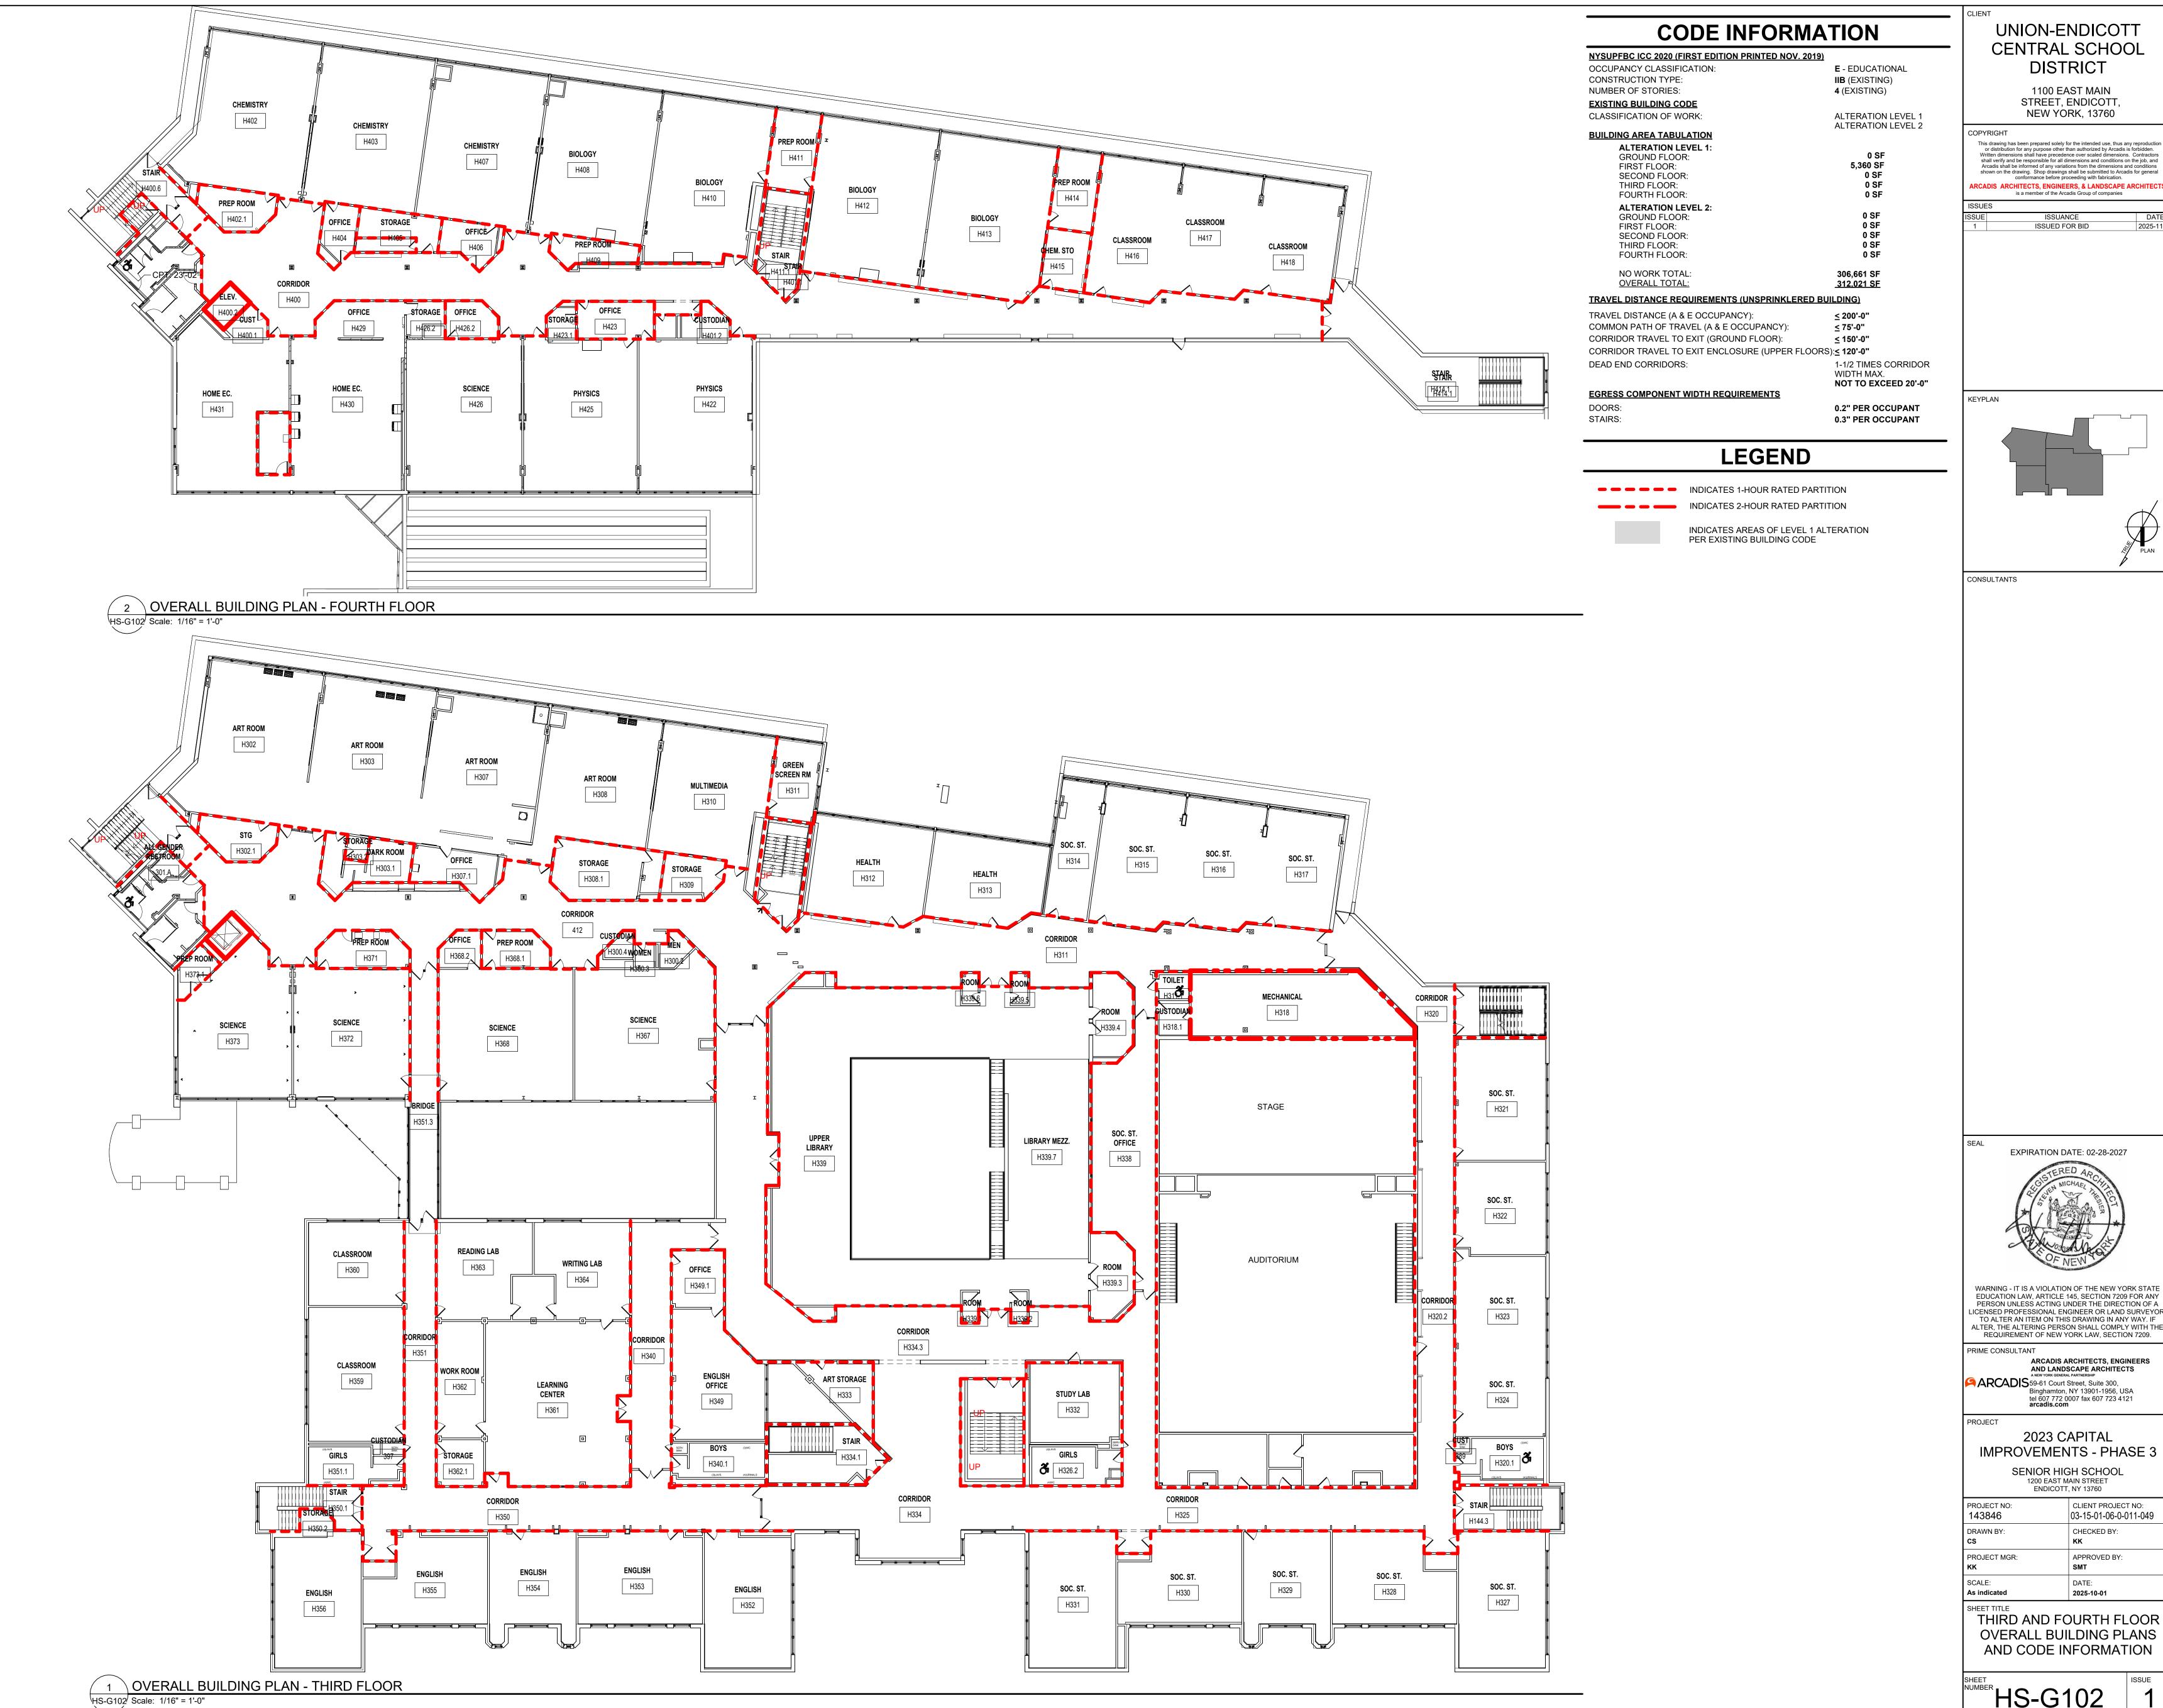
> 1100 EAST MAIN STREET, ENDICOTT, NEW YORK, 13760

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EXPIRATION DATE: 02-28-2027

EDUCATION LAW, ARTICLE 145, SECTION 7209 FOR ANY PERSON UNLESS ACTING UNDER THE DIRECTION OF A LICENSED PROFESSIONAL ENGINEER OR LAND SURVEYOR, TO ALTER AN ITEM ON THIS DRAWING IN ANY WAY. IF ALTER, THE ALTERING PERSON SHALL COMPLY WITH THE REQUIREMENT OF NEW YORK LAW, SECTION 7209.

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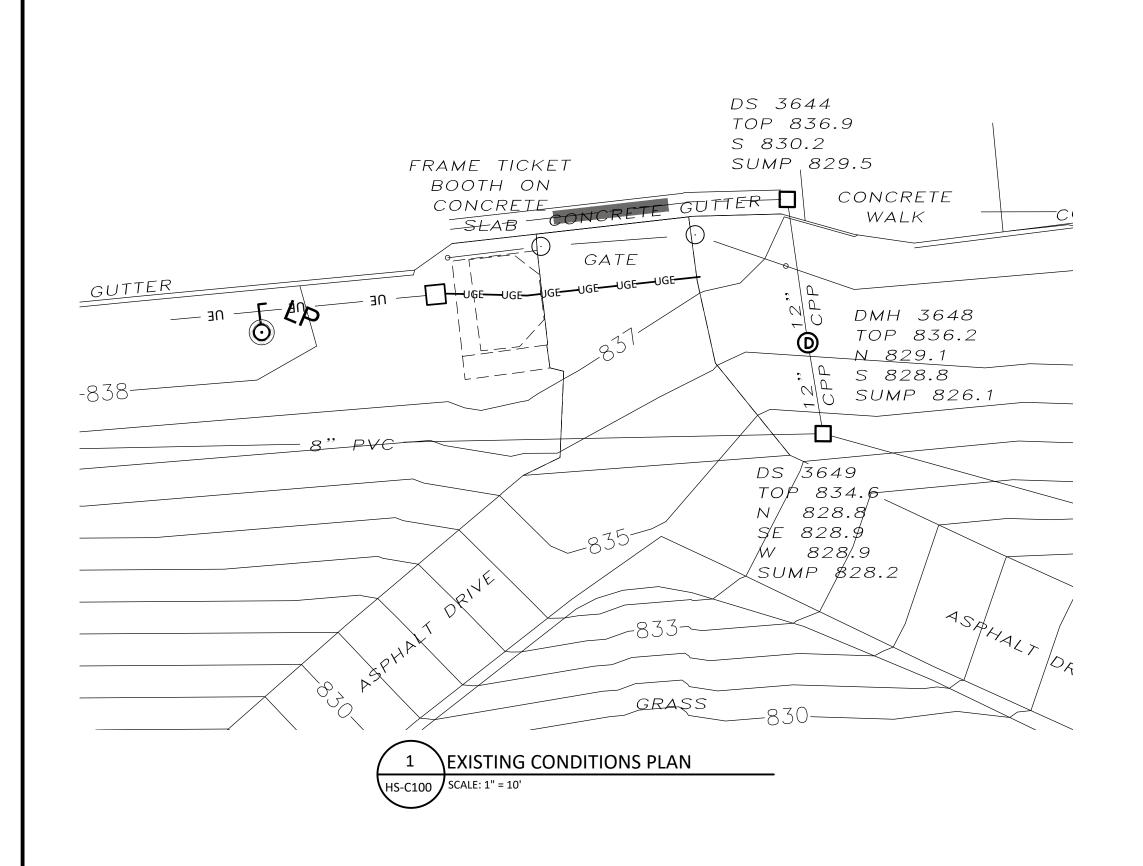
2023 CAPITAL **IMPROVEMENTS - PHASE 3**

CLIENT PROJECT NO: 03-15-01-06-0-011-049 APPROVED BY:

2025-10-01

THIRD AND FOURTH FLOOR OVERALL BUILDING PLANS AND CODE INFORMATION

HS-G102




NOTES: 1. NORTH ORIENTATION IS PER NAD83 NYS PLANE GRIS CENTRAL. 2. VERTICAL DATUM IS PER NAVD88. 3. THE SURVEY COMPLETED BY WILLIAMS AND EDSALL LAND SURVEYING, AND WAS PREPARED WITHOUT THE BENEFIT OF AN ABSTRACT OR UP TO DATE TITLE REPORT AND IS THEREFORE SUBJECT TO ANY EASEMENTS, RESTRICTIONS, COVENANTS OR ANY STATEMENT OF FACTS THAT SUCH DOCUMENTS MAY DISCLOSE. 4. UNDERGROUND FACILITIES, STRUCTURES AND UTILITIES HAVE BEEN PLOTTED FROM DATA OBTAINED BY FIELD SURVEY, PREVIOUS MAPS AND RECORDS, AND FROM PAROLE TESTIMONY MADE BY SCHOOL DISTRICT AND UTILITY COMPANY PERSONNEL. THERE MAY BE OTHER

UNDERGROUND UTILITIES, THE EXISTENCE OF WHICH ARE NOT KNOWN TO

WILLIAMS AND EDSALL LAND SUVEYORS. SIZE AND LOCATION OF ALL


APPROPRIATE AUTHORITIES PRIOR TO ANY CONSTRUCTION.

UNDERGROUND UTILITIES AND STRUCTURES MUST BE VERIFIED BY THE

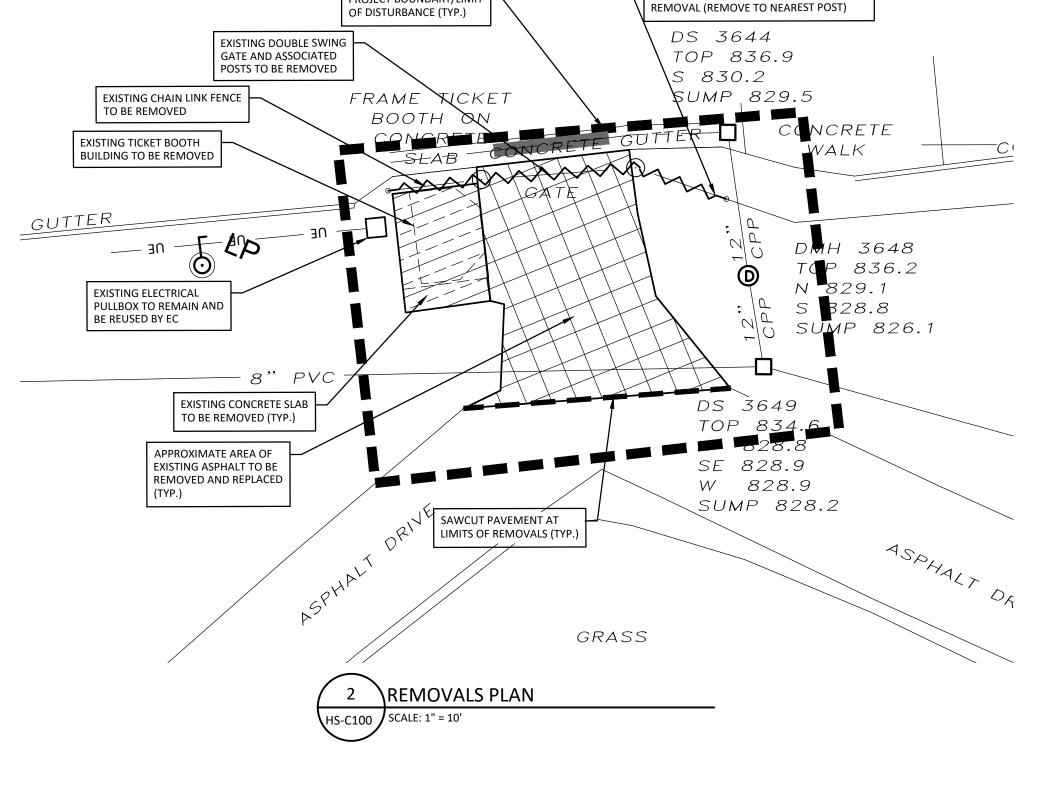

PROJECT BOUNDARY/LIMIT

APPROXIMATE LIMITS OF CHAINLINK FENCE

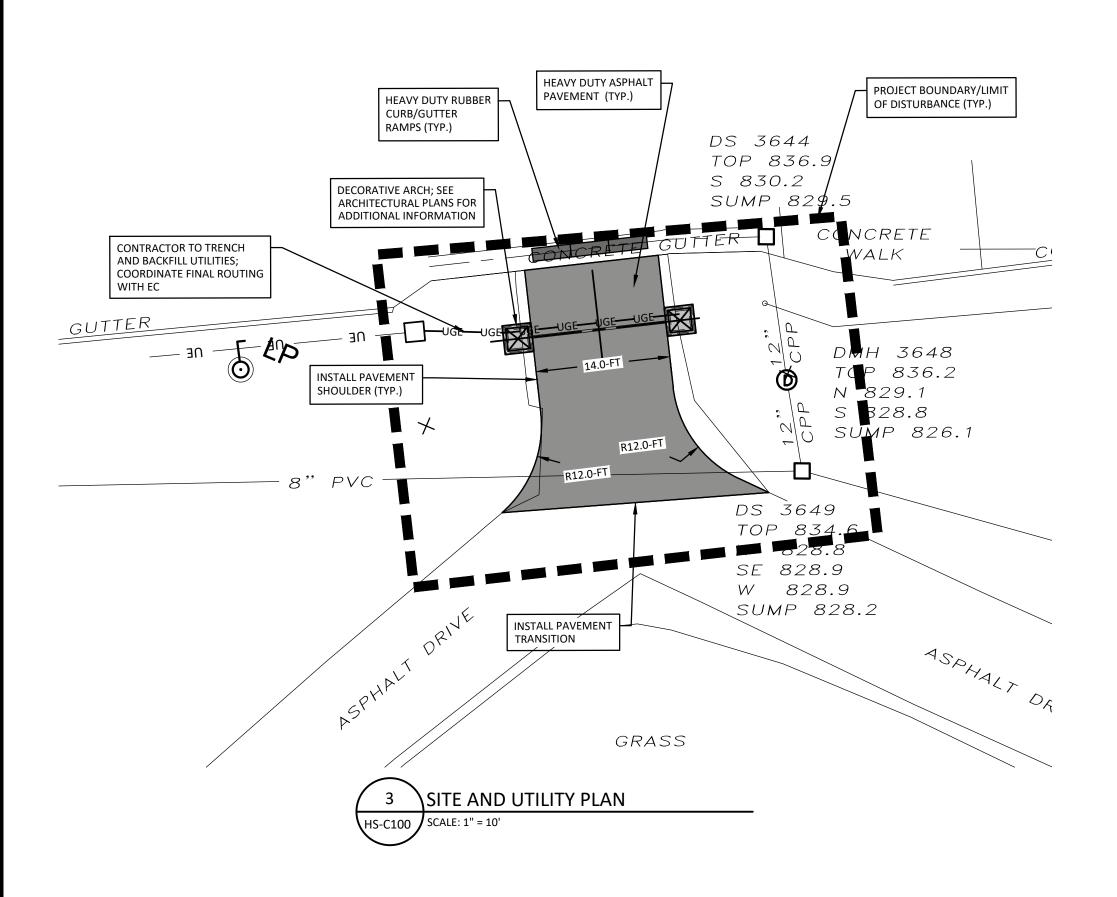


GENERAL NOTES FOR SITEWORK

- 1. ALL CONSTRUCTION ACTIVITIES SHALL BE RESTRICTED TO THE CONSTRUCTION LIMITS. ANY AREA OUTSIDE THE CONSTRUCTION LIMITS THAT IS DISTURBED BY THE CONTRACTOR SHALL BE RESTORED AT THE EXPENSE OF THE CONTRACTOR.
- 2. ALL CONSTRUCTION STAKEOUT SHALL BE THE RESPONSIBILITY OF THE CONTRACTOR AND SHOULD BE INCLUDED AS PART OF THE BASE BID.
- 3. THE CONTRACTOR SHALL MAINTAIN SAFE AND CONTINUOUS ACCESS FOR INGRESS AND EGRESS TRAFFIC AT ADJACENT DRIVEWAYS, PARKING SPACES, SERVICE ROADS, AND PUBLIC STREETS THROUGHOUT THE CONSTRUCTION PERIOD. SHOULD THE CONTRACTOR HAVE ANY CONCERNS OR NOTICE CONFLICTS ASSOCIATED WITH ACCESS TO ANY AREA OUTSIDE THE LIMITS OF CONSTRUCTION, THE CONTRACTOR SHALL BE RESPONSIBLE FOR NOTIFYING THE PROJECT REPRESENTATIVE PRIOR TO PROCEEDING WITH THE PROJECT WORK.
- LOCATIONS OF THE PROPOSED ARCH SHOWN ARE APPROXIMATE. CONTRACTOR SHALL MARK INTENDED AREAS AND HAVE THESE AREAS CONFIRMED BY THE OWNERS REPRESENTATIVE PRIOR TO PROCEEDING WITH INSTALLATION OF THE STRUCTURE.

GENERAL NOTES FOR UTILITY WORK

- 1. THERE SHALL BE NO INTERRUPTION OF ANY UTILITY SERVICE, UNLESS WRITTEN APPROVAL TO DO SO IS OBTAINED FROM THE UTILITY OWNER.
- ALL UTILITIES SHALL BE CONSTRUCTED IN ACCORDANCE WITH ALL FEDERAL, STATE, AND LOCAL LAWS.
- 3. THE CONTRACTOR SHALL EXPOSE EXISTING UTILITIES AHEAD OF TRENCHING SO THAT ADJUSTMENTS CAN BE MADE IN ELEVATION AND OR ALIGNMENT TO PREVENT CONFLICTS, IF REQUIRED
- 4. IF SHEETING OR SHORING IS REQUIRED, THE CONTRACTOR SHALL BE RESPONSIBLE FOR ITS DESIGN (BY A NYS LICENSED ENGINEER), INSTALLATION, AND REMOVAL, AS PART OF THE BASE BID.
- ALL EXISTING ON-SITE OR OFF-SITE PAVEMENTS TO BE CROSSED BY UTILITY INSTALLATIONS SHALL BE SAW CUT AT OR BEYOND THE REQUIRED LIMIT OF TRENCHING AND RESURFACED TO THE EDGE OF THE EXISTING PAVEMENT. INSTALLATION OF UTILITIES UNDER NEW PROJECT PAVEMENTS SHALL NOT BE PERMITTED UNLESS THE CONTRACTOR RESURFACES THE ENTIRE AREA.
- ALL EXISTING UTILITIES TO BE CROSSED AND UTILITY POLES NEAR EXCAVATIONS SHALL BE PROTECTED, PRESERVED, AND SUPPORTED AS NECESSARY BY THE CONTRACTOR AS PART OF THE BASE BID.
- 7. ANY EXISTING STORM DRAINAGE PIPES NOT DESIGNATED TO BE REMOVED, THAT ARE DAMAGED BY THE CONTRACTOR SHALL BE REPLACED WITH SMOOTH INTERIOR CORRUGATED POLYETHYLENE PIPE WHICH CONFORMS TO AASHTO SPEC. M294 TYPE 2, ASTM SPEC D3350, NYSDOT ENGINEERING INSTRUCTION 90-36, AND NYSDOT STANDARD SPECIFICATION SUBSECTION 706-14.

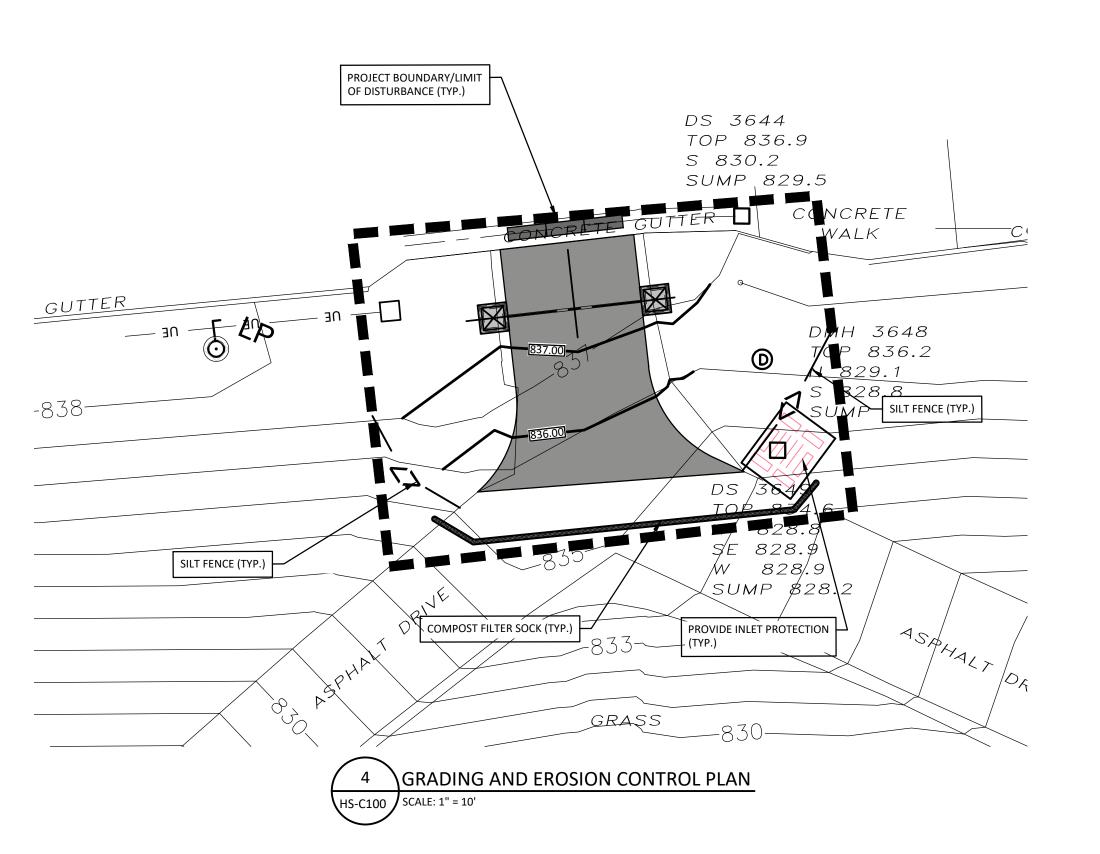

GENERAL NOTES FOR DEMOLITION/REMOVAL WORK

- 1. PRIOR TO ANY DEMOLITION/REMOVAL WORK, THE CONTRACTOR SHALL TAKE PRE-CONSTRUCTION PHOTOGRAPHS OF THE EXISTING CONDITIONS WITHIN THE AREAS TO BE AFFECTED BY THE PROPOSED PROJECT WORK AND THOSE AREAS IMMEDIATELY ADJACENT TO THE PROPOSED PROJECT WORK. THE CONTRACTOR SHALL SUBMIT ELECTRONIC COPIES OF THESE PHOTOGRAPHS TO THE PROJECT REPRESENTATIVE PRIOR TO PROCEEDING WITH ANY ACTIVITIES THAT WILL DISTURB THE EXISTING SITE CONDITIONS.
- 2. THE CONTRACTOR SHALL BE RESPONSIBLE FOR PROTECTING FROM DAMAGE ALL ITEMS NOT DESIGNATED ON THESE PLANS TO BE REMOVED. ALL REMOVAL WORK SHALL BE CONDUCTED IN A MANNER THAT WILL PROTECT ABUTTING FEATURES NOTED TO REMAIN.
- 3. THE CONTRACTOR SHALL BE RESPONSIBLE FOR PROVIDING SUFFICIENT BARRIERS NECESSARY TO PREVENT UNAUTHORIZED ACCESS TO THE WORK ZONE. CONTRACTOR SHALL ALSO BE RESPONSIBLE FOR THE SECURITY OF ANY MATERIALS OR EQUIPMENT STORED WITHIN THE WORK ZONE.
- 4. PRIOR TO COMMENCING ANY REMOVALS OR DEMOLITION ACTIVITIES, THE CONTRACTOR SHALL COORDINATE THE SCHEDULE WITH THE OWNER TO MINIMIZE IMPACTS TO THE FACILITY OPERATIONS.
- 5. ALL PAVEMENTS TO BE REMOVED SHALL BE DISPOSED OF OFF-SITE.
 DEPTHS OF REMOVAL SHALL BE OF SUFFICIENT THICKNESS TO
 ACCOMMODATE PROPOSED PAVEMENT SECTIONS. EXISTING GRAVEL
 SUBBASES MAY REMAIN IN PLACE, AS LONG AS IT WILL NOT CONFLICT
 WITH THE CONSTRUCTION OF THE PROPOSED IMPROVEMENTS.
 GRANULAR MATERIALS REMAINING WITHIN THE LIMITS OF PROPOSED
 PAVEMENTS SHALL BE COMPACTED IN ACCORDANCE WITH THE
 PROJECT SPECIFICATIONS PRIOR TO PLACEMENT OF THE GEOTEXTILE
 FABRIC AND PROPOSED PAVEMENT SECTION. IN LAWN AREAS,
 GRANULAR MATERIAL SHALL BE REMOVED TO A MINIMUM DEPTH OF
 12- IN. AND REPLACED WITH TOPSOIL. ANY GRANULAR MATERIAL
 GREATER THAN 12-IN. BELOW FINISHED GRADE CAN REMAIN AS LONG
 AS IT IS FIRST SCARIFIED TO A DEPTH OF 4-IN. PRIOR TO BEING
 COVERED BY TOPSOIL.
- 6. ANY PAVEMENTS DESIGNATED TO REMAIN THAT ARE DAMAGED BY THE CONTRACTOR SHALL BE REPLACED IN KIND AT THE EXPENSE OF THE CONTRACTOR.
- 7. LIMITS OF REMOVALS SHOWN ON THIS PLAN ARE APPROXIMATE.
 CONTRACTOR SHALL PLAN ON REMOVING/AND REPLACING ENOUGH
 MATERIAL TO ALLOW FOR SAFE WORKING CONDITIONS WITHIN THE
 EXCAVATIONS AT EACH STRUCTURE.

GENERAL NOTES FOR LAND GRADING WORK

- 1. ALL CONSTRUCTION ACTIVITIES WITH THE POTENTIAL TO DISPLACE SOIL FROM THE PROJECT SITE SHALL BE CONDUCTED IN ACCORDANCE WITH THE NEW YORK STATE STATE POLLUTION DISCHARGE ELIMINATION SYSTEM (SPDES) PERMIT, AND THE NEW YORK STATE STANDARDS AND SPECIFICATIONS FOR EROSION AND SEDIMENT CONTROL (BLUE BOOK). SEE SHEET C-510 FOR ADDITIONAL EROSION AND SEDIMENT CONTROL NOTES.
- 2. PROPOSED CONTOURS PRESENTED ON THESE PLANS INDICATE FINISHED GRADE.
- 3. ANY AREA THAT IS TO RECEIVE FILL MATERIALS SHALL BE CLEARED OF ALL TOPSOIL, ORGANIC MATERIALS, AND POTENTIALLY OBJECTIONABLE MATERIALS PRIOR TO PLACEMENT OF FILL. OBJECTIONABLE MATERIALS THAT MAY CONFLICT WITH PROPER COMPACTION OF THE MATERIAL. SHALL INCLUDE BRUSH, RUBBISH, ROCKS, LOGS, STUMPS, BUILDING DEBRIS, AND ANY OTHER MATERIAL DEEMED INAPPROPRIATE BY THE ON-SITE PROJECT REPRESENTATIVE
- 4. ALL FILL MATERIALS SHALL BE PLACED IN LIFTS OF A MAXIMUM OF 6-IN.
 IN THICKNESS AND COMPACTED IN ACCORDANCE WITH THE PROJECT
 SPECIFICATIONS.
- 5. FILL MATERIALS SHALL NOT BE PLACED UPON FROZEN SUBGRADE, NOR SHALL FROZEN FILL MATERIALS BE PLACED ON SITE.
- 6. THE COST OF IMPORTING AND PLACEMENT OF ANY REQUIRED FILL MATERIAL SHALL BE INCLUDED IN THE CONTRACTOR'S BASE BID. IN ADDITION, THE COST OF EXPORTING AND DISPOSING OF ANY EXCESS MATERIAL SHALL ALSO BE INCLUDED IN THE CONTRACTOR'S BASE BID.
- 7. ALL AREAS TO BE PAVED, INLCUDING EACH PLACED LIFT OF THE PAVEMENT SECTION, SHALL BE GRADED TO ACHIEVE POSITIVE DRAINAGE THROUGHOUT THE DURATION OF CONSTRUCTION. THE FINISHED GRADE ON ALL AREAS OF CONSTRUCTION SHALL BE GRADED TO ACHIEVE POSITIVE DRAINAGE. ANY RESULTING DEPREESIONS NOT SPECIFIED ON THE CONTRACT DOCUMENTS SHALL BE CORRECTED BY THE CONTRACTOR AT NO ADDITIONAL EXPENSE TO THE OWNER.
- 8. ANY SEEPS OR SPRINGS ENCOUNTERED DURING CONSTRUCTION SHALL BE HANDLED IN ACCORDANCE WITH THE NYS STANDARDS AND SPECIFICATIONS FOR EROSION AND SEDIMENT CONTROL.
- ALL OPEN EXCAVATIONS AND OTHER HAZARDS SHALL BE SURROUNDED WITH TEMPORARY CONSTRUCTION FENCE. FENCE SHALL BE A MINIMUM 48-IN TALL, MOUNTED ON RIGID POSTS SPACED NO GREATER THAN 48-IN. APART, AND SHALL CONSIST OF HIGH VISIBILITY ORANGE FENCING MARKED WITH WORK ZONE CAUTION SIGNS. FENCE AND POSTS SHALL REMAIN IN PLACE UNTIL EXCAVATION HAS BEEN BACKFILLED OR HAZARDOUS CONDITION HAS BEEN REMOVED. FENCES MAY BE TEMPORARILY MOVED TO ACCOMMODATE EARTHWORK DURING CONSTRUCTION HOURS. UPON COMPLETION OF PROJECT, ALL FENCING, POSTS, AND CAUTION SIGNS SHALL BE REMOVED FROM THE PROJECT SITE
- ALL DISTURBED LAWN AREAS SHALL BE RESTORED WITH A MINIMUM 6-IN. OF TOPSOIL, SEED, AND MULCH. IF CONTRACTOR SO CHOOSES, SOD MAY BE INSTALLED IN LIEU OF SEED AND MULCH.

UNION-ENDICOTT CENTRAL SCHOOL DISTRICT

1100 EAST MAIN STREET ENDICOTT, NEW YORK 13760

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1 ISSUED FOR BID 2025-1

ARCADIS ARCHITECTS, ENGINEERS, & LANDSCAPE ARCHITECTS

KEYPLAN

0 10 20

REMOVALS LEGEND

— — — — LIMITS OF DISTURBANCE

AREA OF ASPHALT TO BE

REMOVED AND REPLACED

AREA OF CONCRETE TO BE

REMOVED

SITE LEGEND

— — — LIMITS OF DISTURBANCE

AREA OF PROPOSED CONCRETE
CURB

AREA OF PROPOSED ASPHALT PAVEMENT

GRADING LEGEND

— · · — · · LIMITS OF DISTURBANCE

--- 1232.0 --- EXISTING CONTOUR LINE

PROPOSED CONTOUR LINE

-⇔—-⇔— SILT FENCE

TREE PROTECTION FENCE

INLET PROTECTION

1232.2 SPOT ELEVATION

Jnauthorized alteration or addition to engineering technical

documents bearing a licensed professional engineer's seal

MATCH EXISTING PAVEMENT

is a violation of Chapter 16, Title VIII, Article 145 § 7209.2 of the New York State Education Law.



PRIME CONSULTANT

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2023 CAPITAL
IMPROVEMENTS - PHASE 3

SENIOR HIGH SCHOOL

1200 EAST MAIN STREET,
ENDICOTT, NY 13760

IBI PROJECT NO:
CLIENT PROJECT NO:
03-15-01-06-0-011-049

DRAWN BY:
CHECKED BY:
RIV

DRAWN BY:
RJY

PROJECT MGR:
SMT

SCALE:
AS INDICATED

CHECKED BY:
RJY


APPROVED BY:
SMT

DATE:
2025-10-01

SHEET TITLE

SITE PLANS

HS-C100

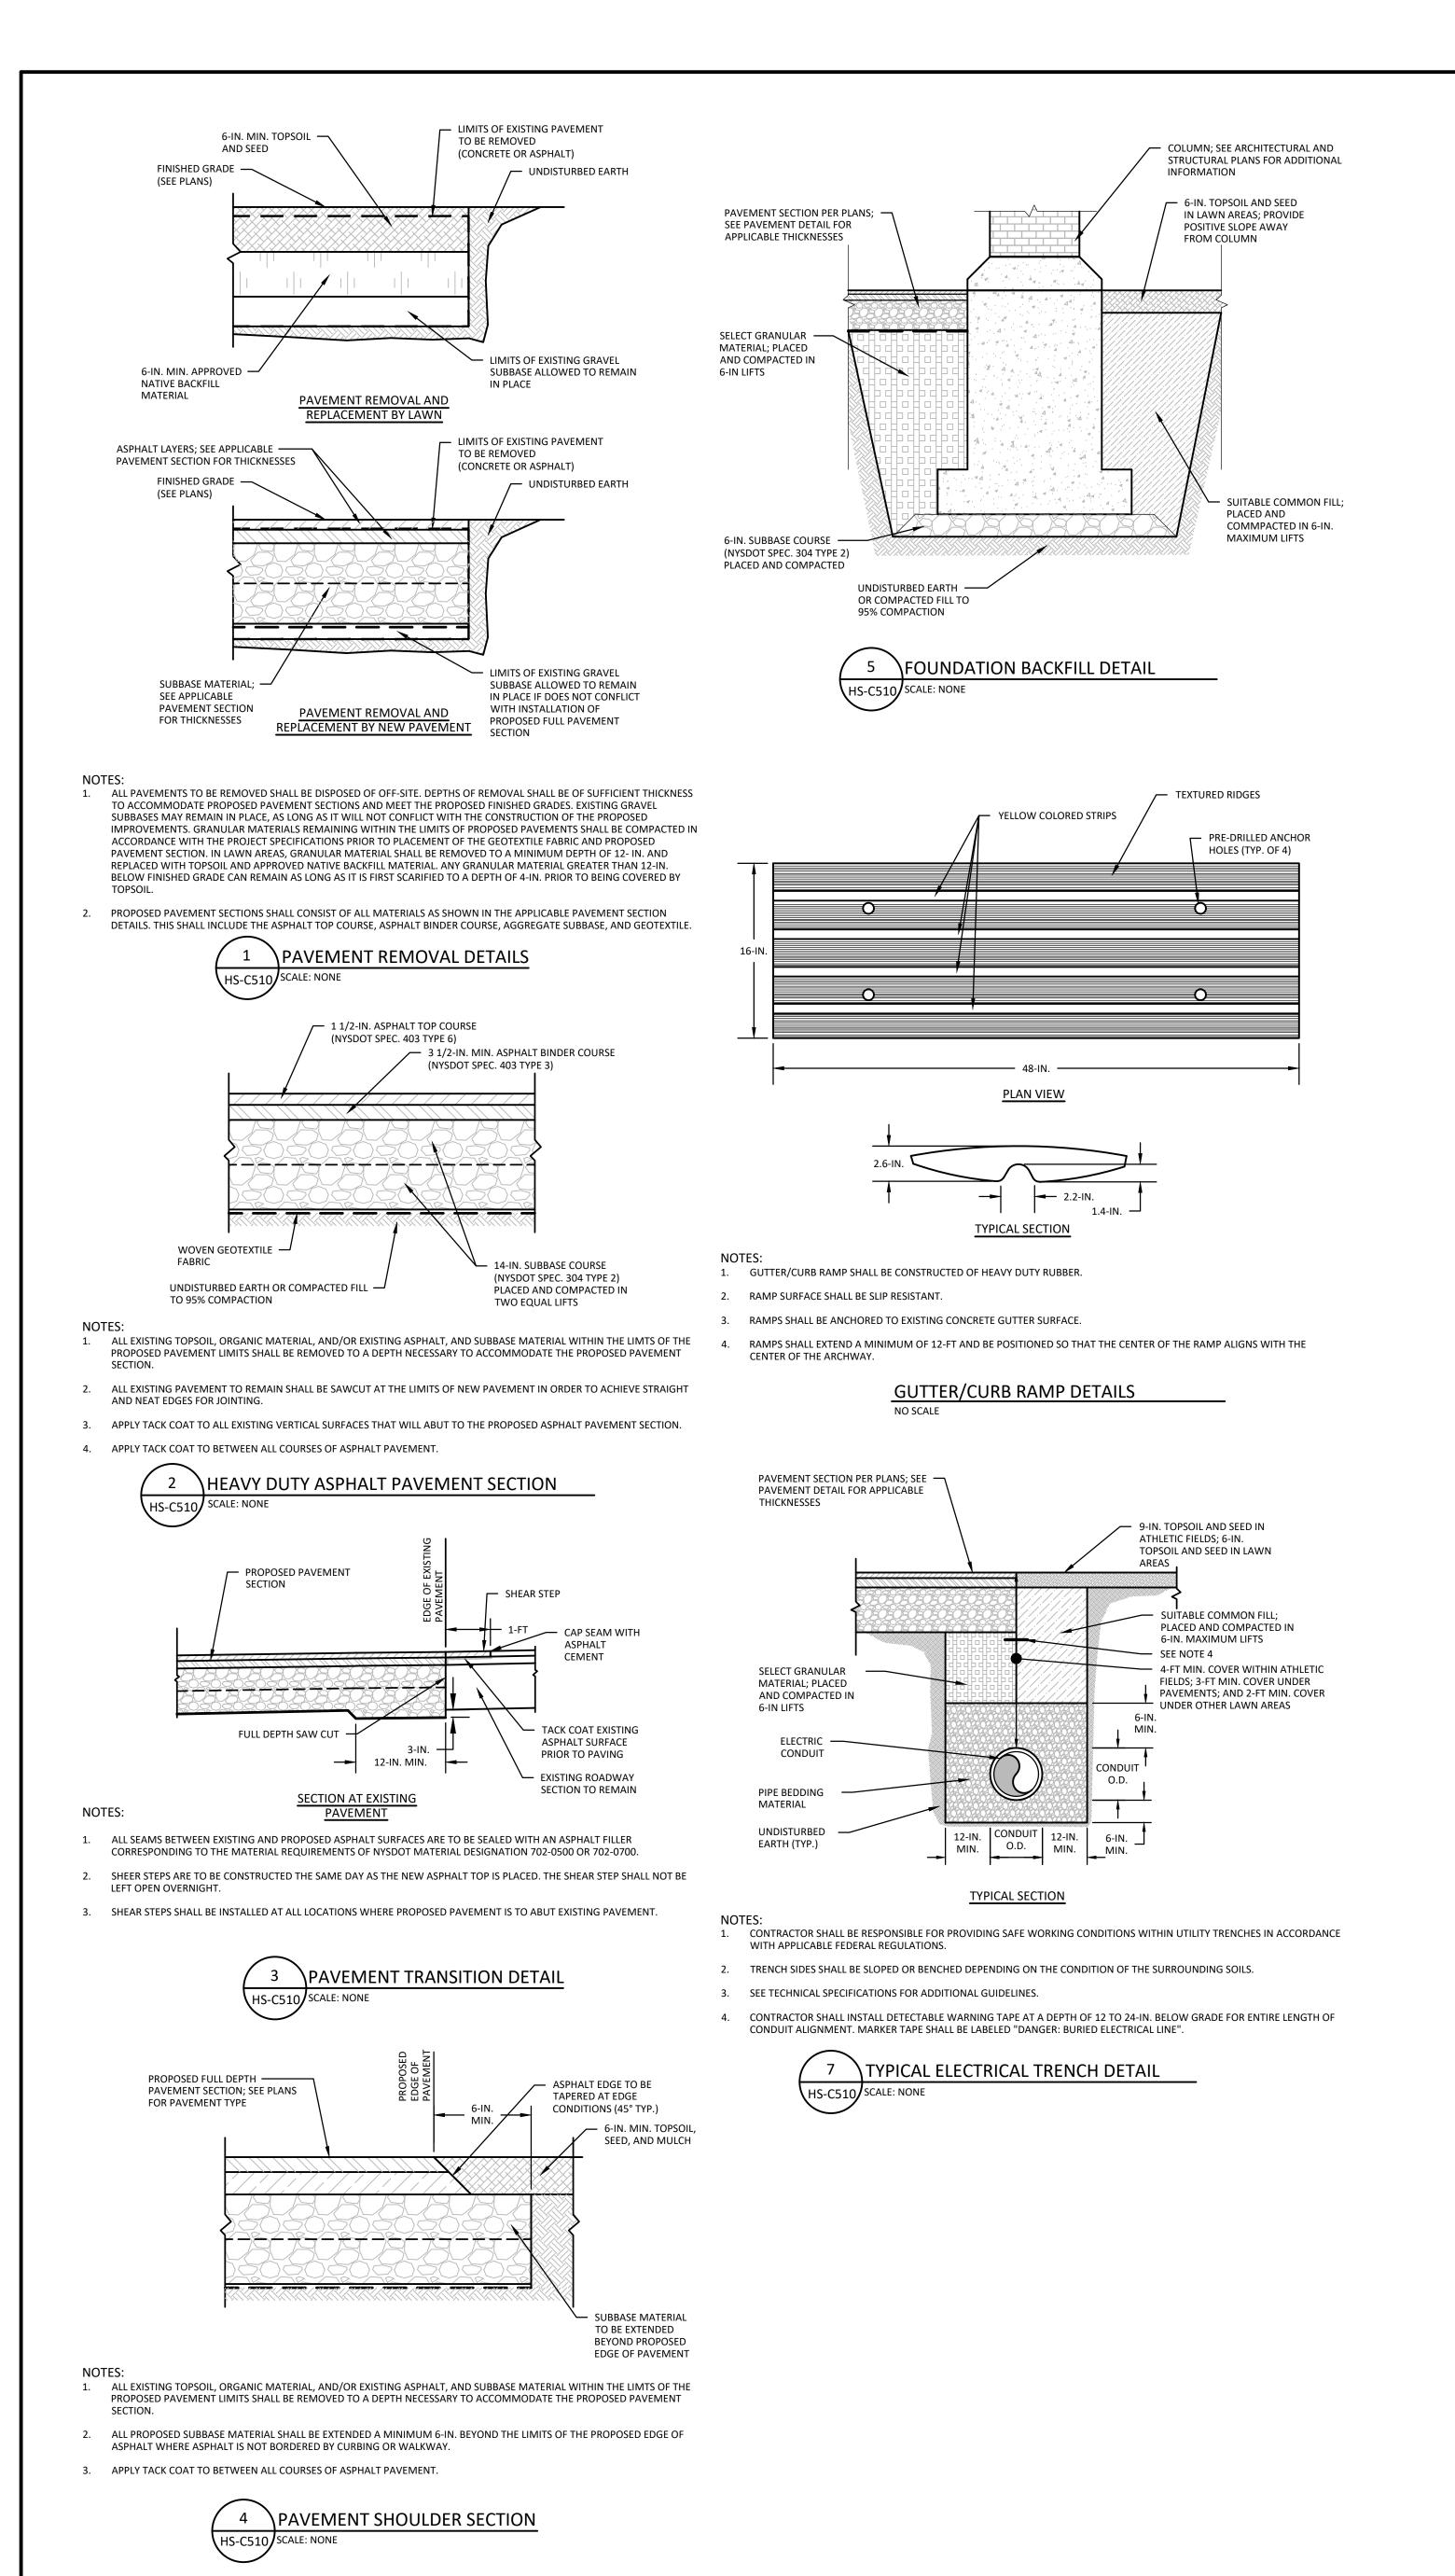

UNION-ENDICOTT CENTRAL SCHOOL DISTRICT 1100 EAST MAIN STREET ENDICOTT, NEW YORK 13760 This drawing has been prepared solely for the intended use, thus any reproduction or distribution for any purpose other than authorized by Arcadis is forbidden. Written dimensions shall have precedence over scaled dimensions. Contractors shall verify and be responsible for all dimensions and conditions on the job, and Arcadis shall be informed of any variations from the dimensions and conditions shown on the drawing. Shop drawings shall be submitted to Arcadis for general conformance before proceeding with fabrication. ARCADIS ARCHITECTS, ENGINEERS, & LANDSCAPE ARCHITECTS is a member of the Arcadis Group of companies ISSUED FOR BID KEYPLAN Unauthorized alteration or addition to engineering technical documents bearing a licensed professional engineer's seal is a violation of Chapter 16, Title VIII, Article 145 § 7209.2 of the New York State Education Law.

PRIME CONSULTANT

PROJECT

IBI PROJECT NO:

PROJECT MGR:

SHEET TITLE

143846

DRAWN BY:

SCALE: AS INDICATED

ARCADIS ARCHITECTS, ENGINEERS

AND LANDSCAPE ARCHITECTS

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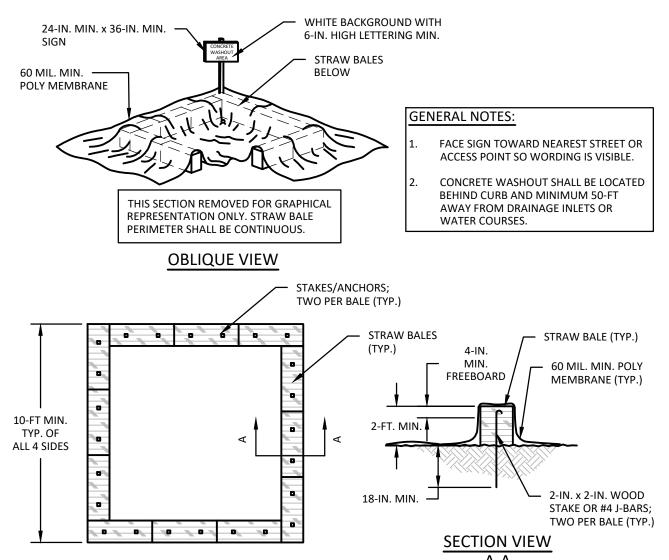
2023 CAPITAL IMPROVEMENTS - PHASE 3

SENIOR HIGH SCHOOL 1200 EAST MAIN STREET, ENDICOTT, NY 13760

SITE DETAILS

HS-C510

ARCADIS 59-61 Court Street, Suite 300,



APPLICATION NOTES:


WASHOUT FACILITES SHALL BE PROVIDED FOR EVERY PROJECT WHERE CONCRETE WILL BE POURED OR OTHERWISE FORMED ON SITE. THIS FACILITY WILL RECEIVE HIGHLY ALKALINE WASH WATER FROM THE CLEANING OF CHUTES, MIXERS, HOPPERS, VIBRATORS, PLACING EQUIPMENT, TROWELS, AND SCREEDS. UNDER NO CIRCUMSTANCES WILL WASH WATER FROM THESE OPERATIONS BE ALLOWED TO INFILTRATE INTO THE SOIL OR ENTER SURFACE WATERS.

CONSTRUCTION SPECIFICATIONS:

PLAN VIEW

- CAPACITY: THE CONTRACTOR SHALL SIZE THE WASHOUT FACILITY TO CONTAIN SOLIDS, WASH WATER, AND RAINFALL. FACILITY SHALL BE SIZED TO ALLOW FOR THE EVAPORATION OF WASH WATER AND RAINFALL. WASH WATER SHALL BE ESTIMATED AT 7 GALLONS PER CHUTE AND 50 GALLONS PER HOPPER OF THE CONCRETE PUMP TRUCK AND/OR DISCHARGING DRUM. THE MINIMUM SIZE SHALL BE 10-FT x 10-FT AT THE BOTTOM AND 2-FT DEEP WITH A MINIMUM 4-IN. FREEBOARD. IF EXCAVATED, THE SIDE SLOPES SHALL BE 2 HORIZONTAL TO 1 VERTICAL.
- LOCATION: THE CONTRACTOR SHALL COORDINATE THE LOCATION OF THE WASH FACILITY WITH THE PROPERTY OWNER AND CONSTRUCTION MANAGER PRIOR TO STARTING CONSTRUCTION. THE FACILITY SHALL BE LOCATED A MINIMUM OF 100-FT FROM

 3. DRAINAGE SWALES, STORM DRAIN INLETS, WETLANDS, STREAMS, AND OTHER SURFACE WATERS. PREVENT SURFACE WATERS FROM ENTERING THE STRUCTURE EXCEPT FROM THE ACCESS ROAD. PROVIDE APPROPRIATE ACCESS WITH A GRAVEL ACCESS ROAD SLOPED DOWN TO THE STRUCTURE. SIGNS SHALL BE PLACED TO DIRECTING DRIVERS TO THE FACILITY AFTER THEIR LOAD IS DISCHARGED.
- 3. LINER: ALL WASHOUT FACILITIES WILL NEED TO BE LINED TO PREVENT LEACHING OF LIQUIDS INTO THE GROUND. THE LINER SHALL BE PLASTIC SHEETING WITH A MINIMUM THICKNESS OF 60 MILS WITH NO HOLES OR TEARS, AND ANCHORED BEYOND THE TOP OF THE PIT WITH AN EARTHEN BERM, SAND BAGS, STONE, OR OTHER STRUCTURAL MEANS.
- 1. ALL CONCRETE WASHOUT FACILITIES SHALL BE INSPECTED DAILY. DAMAGED OR LEAKING FACILITIES SHALL BE DEACTIVATED AND REPAIRED OR REPLACED IMMEDIATELY. EXCESS RAINWATER THAT HAS ACCUMULATED OVER HARDENED CONCRETE SHOULD BE PUMPED TO A STABILIZED AREA, SUCH AS A GRASS FILTER STRIP.
- 2. ACCUMULATED HARDENED MATERIAL SHALL BE REMOVED WHEN 75% OF THE STORAGE CAPACITY OF THE STRUCTURE IS FILLED. ANY EXCESS WASHWATER SHALL BE PUMPED INTO A CONTAINMENT VESSEL AND PROPERLY DISPOSED OF OFF SITE.
- . DISPOSE OF HARDENED MATERIAL OFF SITE AT AN APPROVED CONSTRUCTION/DEMOLITION LAND FILL
- 4. THE PLASTIC LINER SHALL BE REPLACED WITH EACH CLEANOUT OF THE WASHOUT FACILITY.
- INSPECT THE PROJECT SITE FREQUENTLY TO ENSURE THAT NO CONCRETE DISCHARGES ARE TAKING PLACE IN NON-DESIGNATED

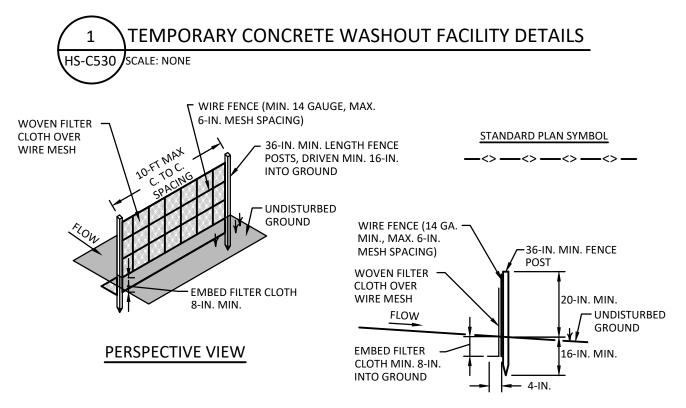

APPLICATION NOTES

- 1. SILT FENCE SHALL BE USED IN SMALL AREAS WITH SHEET FLOW RUNOFF TO INTERCEPT SEDIMENT AND REDUCE RUNOFF
- 2. SILT FENCE SHALL BE PLACED ALONG THE CONTOUR LINES. DO NOT ALLOW CHANNELIZED FLOW ON UPHILL SIDE OF SILT FENCE. MAXIMUM SLOPE LENGTH CONTRIBUTING TO SILT FENCE ARE:
- FOR 2:1 SLOPES = 25 FT MAX LENGTH FOR 3:1 SLOPES = 50 FT MAX LENGTH FOR 4:1 SLOPES = 75 FT MAX LENGTH
- FOR 5:1 OR FLATTER SLOPES = 100 FT MAX LENGTH

NYSDOT LIST OF APPROVED MATERIALS.


4. MAXIMUM DRAINAGE AREA TO SILT FENCE SHALL NOT EXCEED 1/4 ACRE PER 100-FT OF FENCE.

MAINTENANCE NOTES

- WHEN TWO SECTIONS OF FILTER CLOTH ADJOIN EACH OTHER THEY SHALL BE OVERLAPPED BY SIX INCHES, FOLDED AND STAPLED TO PREVENT SEDIMENT BYPASS.
- 2. POSTS SHALL BE A MINIMUM 36-IN. LONG AND SHALL BE TYPE T OR U STEEL WEIGHING NOT LESS THAN 1.0 LBS PER SQ.FT.; OR 5. HARDWOOD WITH A MINIMUM CROSS SECTIONAL AREA OF 3.0 SQUARE INCHES.
- 3. WOVEN FILTER CLOTH SHALL BE GEOTEX 315ST, WINFAB 315W, MIRAFI 600X, OR APPROVED EQUAL AS CONFORMING TO THE
- 4. WIRE FENCE SHALL BE FASTENED SECURELY TO FENCE POSTS WITH WIRE TIES OR STAPLES.
- 5. WOVEN FILTER CLOTH TO BE FASTENED SECURELY TO WIRE FENCE WITH TIES SPACED EVERY 24-IN. AT TOP AND MID SECTION. FENCE SHALL BE WIRE, 14 GAUGE, 6-IN. MAXIMUM MESH SPACING.

6. PREFABRICATED UNITS SHALL BE ENVIROFENCE OR APPROVED EQUAL.

- 1. INSPECT SILT FENCE ONCE A WEEK AND AFTER RAINFALLS, REMOVE AND REPLACE THE FABRIC WHEN BULGES DEVELOP IN THE
- MAINTENANCE SHALL BE PERFORMED AS NEEDED, REPLACE ALL SILT FENCE EVERY 9-MONTHS OR AS DIRECTED BY THE PROJECT
- 3. UPON STABILIZATION OF THE SITE REMOVE SILT FENCE SO AS NOT TO BLOCK STORM FLOW OR DRAINAGE.

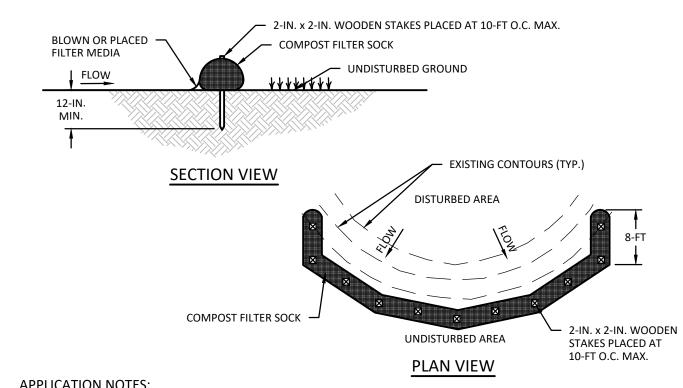

APPLICATION NOTES

- COMPOST FILTER SOCKS SHALL BE USED IN SMALL AREAS WITH SHEET FLOW RUNOFF TO INTERCEPT SEDIMENT AND REDUCE
- 2. COMPOST FILTER SOCKS SHALL BE PLACED ALONG THE CONTOUR LINES WITH BOTH TERMINAL ENDS OF THE SOCK EXTENDED 8-FT UPSLOPE AT A 45 DEGREE ANGLE TO PREVENT BYPASS FLOW. DO NOT ALLOW CHANNELIZED FLOW ON UPHILL SIDE OF THE
- 3. MAXIMUM SLOPE LENGTH CONTRIBUTING TO 12-IN. DIA. COMPOST FILTER SOCKS ARE: FOR 2% SLOPES = 250 FT MAX LENGTH FOR 5% SLOPES = 225 FT MAX LENGTH
- 4. MAXIMUM DRAINAGE AREA TO SILT FENCE SHALL NOT EXCEED 1/4 ACRE PER 100-FT OF FENCE.

CONSTRUCTION SPECIFICATIONS:

FOR 10% SLOPES = 125 FT MAX LENGTH

FOR 20% SLOPES = 65 FT MAX LENGTH

- 1. COMPOST INFILL SHALL BE WELL DECOMPOSED (MATURED AT LEAST 3-MONTHS), WEED FREE, ORGANIC MATTER. IT SHALL BE AEROBICALLY COMPOSTED, POSSESS NO OBJECTIONABLE ODORS, AND CONTAIN LESS THAN 1%, BY DRY WEIGHT, OF MANMADE FOREIGN MATTER. THE PHYSICAL PARAMETERS OF THE COMPOST SHALL BE: ORGANIC MATTER - 25 TO 100% (DRY WEIGHT); ORGANIC PORTION - FIBROUS AND ELONGATED; pH - 6.0 TO 8.0, MOISTURE CONTENT - 30 TO 60%; PARTICLE SIZE - 100% PASSING 1-IN. SCREEN AND 10 TO 50% PASSING A 3/8-IN. SCREEN; SOLUBLE SALT CONCENTRATION - 5.0 dS/m (mmhos/cm) MAXIMUM. (NOTE: ALL BIOSOLIDS COMPOST PRODUCED IN NEW YORK STATE OR APPROVED FOR IMPORTATION MUST MEET NYS DEC'S 6 NYSRR PART 360 (SOLID WASTE MANAGEMENT FACILITIES) REQUIREMENTS. THE PART 360 REQUIREMENTS ARE EQUAL TO OR MORE STRINGENT THAN 40 CFR PART 503 WHICH ENSURE SAFE STANDARDS FOR PATHOGEN REDUCTION AND HEAVY METALS CONTENT. WHEN USING COMPOST FILTER SOCKS ADJACENT TO SURFACE WATER, THE COMPOST SHAOULD HAVE A LOW NUTRIENT VALUE.)
- THE COMPOST FILTER SOCK MATERIAL SHALL MEET THE FOLLOWING MINIMUM PARAMETERS: MATERIAL CHARACTERISTICS -PHOTODEGRADABLE; SOCK DIAMETER - 12-IN.; MESH OPENING - 3/8-IN.; TENSILE STRENGTH - 26 PSI; ULTRAVIOLET STABILITY % ORIGINAL STRENGTH - 23% AT 1,000 HR; MINIMUM FUNCTIONAL LONGEVITY - 9 MONTHS.

COMPOST FILTER SOCKS SHALL BE ANCHORED WITH 2-IN. x 2-IN. WOODEN STAKES DRIVEN 12-IN. MINIMUM INTO THE SOIL AT 10-FT CENTERS MINIMUM ON THE CENTERLINE OF THE SOCK. ON UNEVEN TERRAIN, EFFECTIVE GROUND CONTACT CAN BE ENHANCED BY PLACING OF A FILLET OF FILTER MEDIA ON THE DISTURBED AREA SIDE OF THE COMPOST SOCK.


MAINTENANCE NOTES:

TRAFFIC SHALL NOT BE PERMITTED TO CROSS FILTER SOCKS.

REPLACED ACCORDING TO MANUFACTURER'S RECOMMENDATIONS.

- ACCUMULATED SEDIMENT SHALL BE REMOVED WHEN IT REACHES HALF OF THE ABOVE GROUND HEIGHT OF THE SOCK AND DISPOSED OF IN ACCORDANCE WITH ALL LOCAL, STATE, AND FEDERAL STANDARDS.
- 3. INSPECT FILTER SOCK ONCE A WEEK AND AFTER EACH RAINFALL EVENT. DAMAGED SOCKS SHALL BE REPAIRED IN ACCORDANCE WITH MANUFACTURER RECOMMENDATIONS, OR REPLACED WITHIN 24-HR OF THE INSPECTION.
- MAINTENANCE SHALL BE PERFORMED AS NEEDED, BIODEGRADABLE FILTER SOCKS SHALL BE REPLACED WITHIN 6-MONTHS OF INSTALLATION, PHOTODEGRADABLE FILTER SOCKS SHALL BE REPLACED AFTER 1 YEAR, AND POLYPROPYLENE SOCKS SHALL BE
- 5. UPON STABILIZATION OF THE SITE REMOVE THE FILTER SOCK AND STAKES SO AS NOT TO BLOCK STORM FLOW OR DRAINAGE.



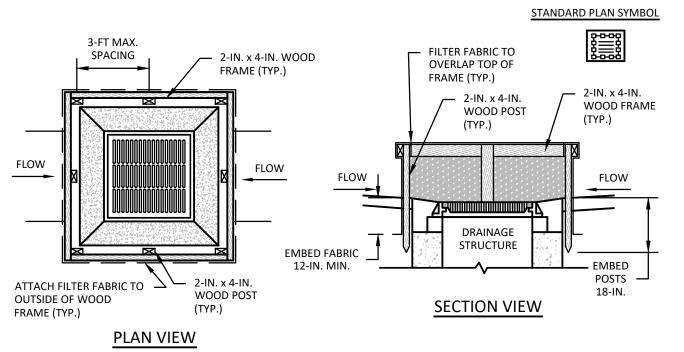


APPLICATION NOTES:

- 1. THE PRIMARY PURPOSE OF DRAINAGE STRUCTURE INLET PROTECTION IS TO PREVENT SEDIMENT FROM ENTERING A DRAINAGE SYSTEM BY PONDING WATER WHICH ALLOWS SEDIMENT TO FALL OUT OF SUSPENSION. THE CONTRACTOR MAY SELECT ANY OF
- THE DEVICES SHOWN HEREON FOR USE. THE TOP OF THE INLET PROTECTION SHALL BE SET AT THE MAXIMUM DESIRED WATER LEVEL BASED ON FIELD LOCATION AND **CONSTRUCTION SPECIFICATIONS:**
- APPROVED FILTER FABRIC GEOTEXTILES ARE LISTED ON THE NYSDOT APPROVED LIST. FILTER FABRIC GEOTEXTILE SHALL BE A SINGLE CONTINUOUS PIECE TO ELIMINATE JOINTS. IF JOINTS ARE NEEDED, FABRIC MUST BE OVERLAPPED MINIMUM OF 24-IN.
- AND SECURED TO NEAREST POST. 2. POST MATERIALS SHALL BE STANDARD 2-IN. x 4-IN. WOOD OR EQUIVALENT.
- 3. SPACE WOOD POSTS EVENLY AROUND INLET WITH A MAXIMUM SPACING OF 24-INCHES. DRIVE POSTS A MINIMUM OF 18-INCHES INTO GROUND. WIRE MESH MAY BE REQUIRED BEHIND GEOTEXTILE TO PROVIDE SUPPORT.
- 4. FILTER FABRIC GEOTEXTILE SHALL BE EMBEDDED A MINIMUM OF 12-INCHES AND BACKFILLED. GEOTEXTILE SHALL BE SECURELY FASTENED TO POSTS AND FRAME.
- SECURE THE ENDS OF THE APRON FOR THE PREFABRICATED DRAINAGE STRUCTURE INLET PROTECTION WITH STAPLES AS DETAILED IN THE PLAN VIEW OR AS RECOMMENDED BY THE MANUFACTURER'S LITERATURE.

- THE FABRIC BARRIER SHOULD BE INSPECTED AFTER EACH RAIN EVENT AND REPAIRS MADE WHERE NEEDED.
- REMOVE SEDIMENT AS NECESSARY TO PROVIDE FOR ACCURATE STORAGE VOLUME FOR SUBSEQUENT RAINS. 3. UPON STABILIZATION OF SURROUNDING AREA, REMOVE ALL MATERIALS AND ANY UNSUITABLE SOIL AND DISPOSE OF IN ACCORDANCE WITH APPLICABLE REGULATIONS.



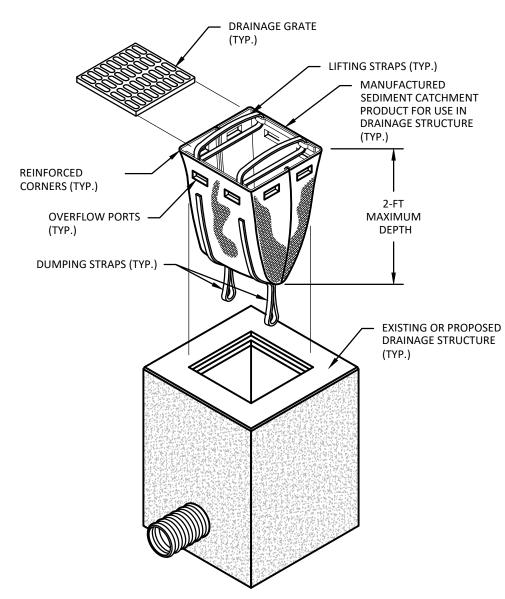

OBLIQUE VIEW

CONSTRUCTION SPECIFICATIONS:

- THE PRIMARY PURPOSE OF DRAINAGE STRUCTURE INLET PROTECTION IS TO PREVENT SEDIMENT FROM ENTERING A DRAINAGE SYSTEM BY PONDING WATER WHICH ALLOWS SEDIMENT TO FALL OUT OF SUSPENSION. THE CONTRACTOR MAY SELECT ANY OF THE DEVICES SHOWN HEREON FOR USE.
- THE USE OF SEDIMENT CATCHING DEVICES INSIDE DRAINAGE STRUCTURES SHALL BE LIMITED TO ONLY THOSE STRUCTURES LOCATED WITHIN HIGH TRAFFIC AREAS WHERE THE APPLICATION OF ALTERNATE EROSION CONTROL MEASURES WOULD RESULT IN HAZARDOUS CONDITIONS.
- INLET PROTECTION DEVICES MUST BE CONSTRUCTED WITH INTEGRAL STRAPS/SUPPORTS THAT WILL CONNECT TO EITHER THE DRAINAGE STRUCTURE GRATE OR CONNECT TO SEPARATE STEEL RODS OR REBAR CAPABLE OF PREVENTING THE EROSION CONTROL DEVICE FROM COLLAPSING OR OTHERWISE DROPPING OR SPILLING SEDIMENT INTO THE DRAINAGE STRUCTURE.
- APPROVED FILTER FABRIC GEOTEXTILES SHALL MEET THE FOLLOWING MINIMUM REQUIREMENTS: GRAB TENSILE STRENGTH -167 X 345 LBS; GRAB ELONGATION - 10 x 15%; CBR PUNCTURE - 900 LBS; TRAPEZOID TEAR STRENGTH - 65 x 90 LBS; UV
- RESISTANCE @ 500 HOURS 96 %; AOS 30 US SIEVE; FLOW RATE 65 GPM; PERMITTIVITY 0.860 SEC-1. 3. ACCEPTABLE MANUFACTURERS INCLUDE ACF ENVIRONMENTAL; DANDY PRODUCTS; TERRAFIX; OR APPROVED EQUIVALENT.
- 1. THE FABRIC CATCHMENT DEVICE SHOULD BE INSPECTED AFTER EACH RAIN EVENT AND REPAIRS MADE WHERE NEEDED.
- REMOVE SEDIMENT AS NECESSARY TO PROVIDE FOR ACCURATE STORAGE VOLUME FOR SUBSEQUENT RAINS. SEDIMENT SHALL BE DISPOSED OF IN ACCORDANCE WITH NYSDEC REGULATIONS.
- 3. UPON STABILIZATION OF SURROUNDING AREA, REMOVE ALL MATERIALS AND ANY UNSUITABLE SOIL AND DISPOSE OF IN ACCORDANCE WITH APPLICABLE REGULATIONS.



STORM WATER POLLUTION PREVENTION PLAN (SWPPP) CONSTRUCTION NOTES:

- STORM WATER DISCHARGES AUTHORIZED BY THE PERMIT SHALL NOT CAUSE OR CONTRIBUTE TO A VIOLATION OF WATER QUALITY STANDARDS INCLUDING BUT NOT LIMITED TO THESE PROVISIONS:
- A. THERE SHALL BE NO INCREASE IN TURBIDITY THAT WILL CAUSE A SUBSTANTIAL VISIBLE CONTRAST TO NATURAL
- B. THERE SHALL BE NO SUSPENDED OR SETTLEABLE SOLIDS THAT WILL CAUSE DEPOSITION OR IMPAIR THE RECEIVING WATERS FOR THEIR BEST USES.
- THERE SHALL BE NO DISCHARGE OF RESIDUES FROM PETROLEUM PRODUCTS, CHEMICAL PRODUCTS, OR FLOATING
- EARTH WORK SHALL BE PERFORMED ONLY WHEN WEATHER AND SOIL CONDITIONS ARE SUITABLE. THE CONTRACTOR SHALL BE RESPONSIBLE FOR REVIEWING THE EXISTING WEATHER CONDITIONS AND THE WEATHER FORECAST TO DETERMINE IF THE CONDITIONS AT HAND ARE SUITABLE PRIOR TO THE COMMENCEMENT OF WORK EACH DAY. NO EARTHWORK SHALL BE PERMITTED DURING PERIODS OF HEAVY PRECIPITATION.
- CLEARING AND GRADING SHALL BE PERFORMED TO MINIMIZE DISTURBANCE OF GROUND COVER, ONLY THE SMALLEST AREA THAT IS PRACTICAL SHALL BE DISTURBED AT ANY ONE TIME.
- 4. THE CONTRACTOR SHALL BE RESPONSIBLE FOR CONTROLLING DUST ORIGINATING FROM ITS CONSTRUCTION OPERATIONS TO THE SATISFACTION OF THE OWNER AND OWNER'S REPRESENTATIVE. THE CONTRACTOR SHALL SUPPLY THE NECESSARY EQUIPMENT AND MATERIALS TO ACCOMPLISH ADEQUATE DUST CONTROL.
- 5. THESE PLANS, AND SUPPORTING DOCUMENTS PREPARED BY THE OWNER AND INCORPORATED HEREIN, THE SPDES PERMIT, AND THE "NEW YORK STANDARDS AND SPECIFICATIONS FOR EROSION AND SEDIMENT CONTROL" ARE THE MINIMUM ANTICIPATED EROSION AND SEDIMENT CONTROL MEASURES REQUIRED FOR THE DEVELOPMENT AS PROPOSED. ADDITIONAL MEASURES DEEMED NECESSARY DURING CONSTRUCTION BY THE NYSDEC, MUNICIPALITIES, OR THE QUALIFIED PROFESSIONAL,

SHALL BE CONSTRUCTED AND MAINTAINED BY THE CONTRACTOR, AT NO EXTRA COST.

- 6. IN AREAS WHERE FINAL GRADING CREATES RUN-OFF CONCENTRATIONS THAT RETARD STABILIZATION, "JUTE-MESH", SOD, OR ENERGY DISSIPATION, AS APPROVED BY THE QUALIFIED PROFESSIONAL, SHALL BE PROVIDED AND INSTALLED BY THE CONTRACTOR TO ACHIEVE FINAL STABILIZATION. THE CONTRACTOR SHALL INCLUDE THIS SERVICE AT NO EXTRA COST.
- 7. ALL DISTURBED AREAS SHALL BE STABILIZED WITH EITHER TEMPORARY OR PERMANENT SEED MIXES AND MULCHED, AS SOON AS CONSTRUCTION PRACTICES AND WEATHER PERMITS. DISTURBED AREAS, INCLUDING TOPSOIL STOCKPILES, SHALL NOT REMAIN UNSTABLE FOR MORE THAN 7 CONSECUTIVE DAYS AFTER CONSTRUCTION DISTURBANCE ACTIVITIES IN THE AREA HAVE TEMPORARILY OR PERMANENTLY CEASED, UNLESS CONSTRUCTION IS SCHEDULED TO RESUME WITHIN 14 DAYS.
- 8. THE CONTRACTOR SHALL BE RESPONSIBLE FOR ENSURING THAT THE STORM WATER CONTROL DEVICES REMAIN IN PLACE AND FUNCTIONAL BY CLEANING, REPAIRING, AND, OR REPLACING THEM WHENEVER NECESSARY OR AS DIRECTED BY THE QUALIFIED PROFESSIONAL, UNTIL FINAL STABILIZATION IS ACHIEVED. THIS MAINTENANCE OF THE PRACTICES SHALL BE INCLUDED AT NO
- 9. THE CONTRACTOR SHALL BE RESPONSIBLE FOR REMOVING ALL EROSION AND SEDIMENT CONTROL DEVICES WHEN SPECIFIED BY THE QUALIFIED PROFESSIONAL AT NO EXTRA COST.
- 10. FINAL STABILIZATION SHALL MEAN THAT ALL SOIL-DISTURBING ACTIVITIES AT THE SITE HAVE BEEN COMPLETED, A UNIFORM PERENNIAL VEGETATIVE COVER WITH A DENSITY OF 80 PERCENT HAS BEEN ESTABLISHED OR EQUIVALENT STABILIZATION MEASURES HAVE BEEN EMPLOYED ON ALL PERVIOUS AREAS, AND ALL IMPERVIOUS COVERS HAVE BEEN INSTALLED.
- 11. THE CONTRACTOR SHALL NOTIFY THE OWNER WHEN CONSTRUCTION IS COMPLETE AND WHEN FINAL STABILIZATION OF THE AREAS TO BE DISTURBED IS COMPLETE.

UNION-ENDICOTT **CENTRAL SCHOOL**

1100 EAST MAIN STREET ENDICOTT, NEW YORK 13760

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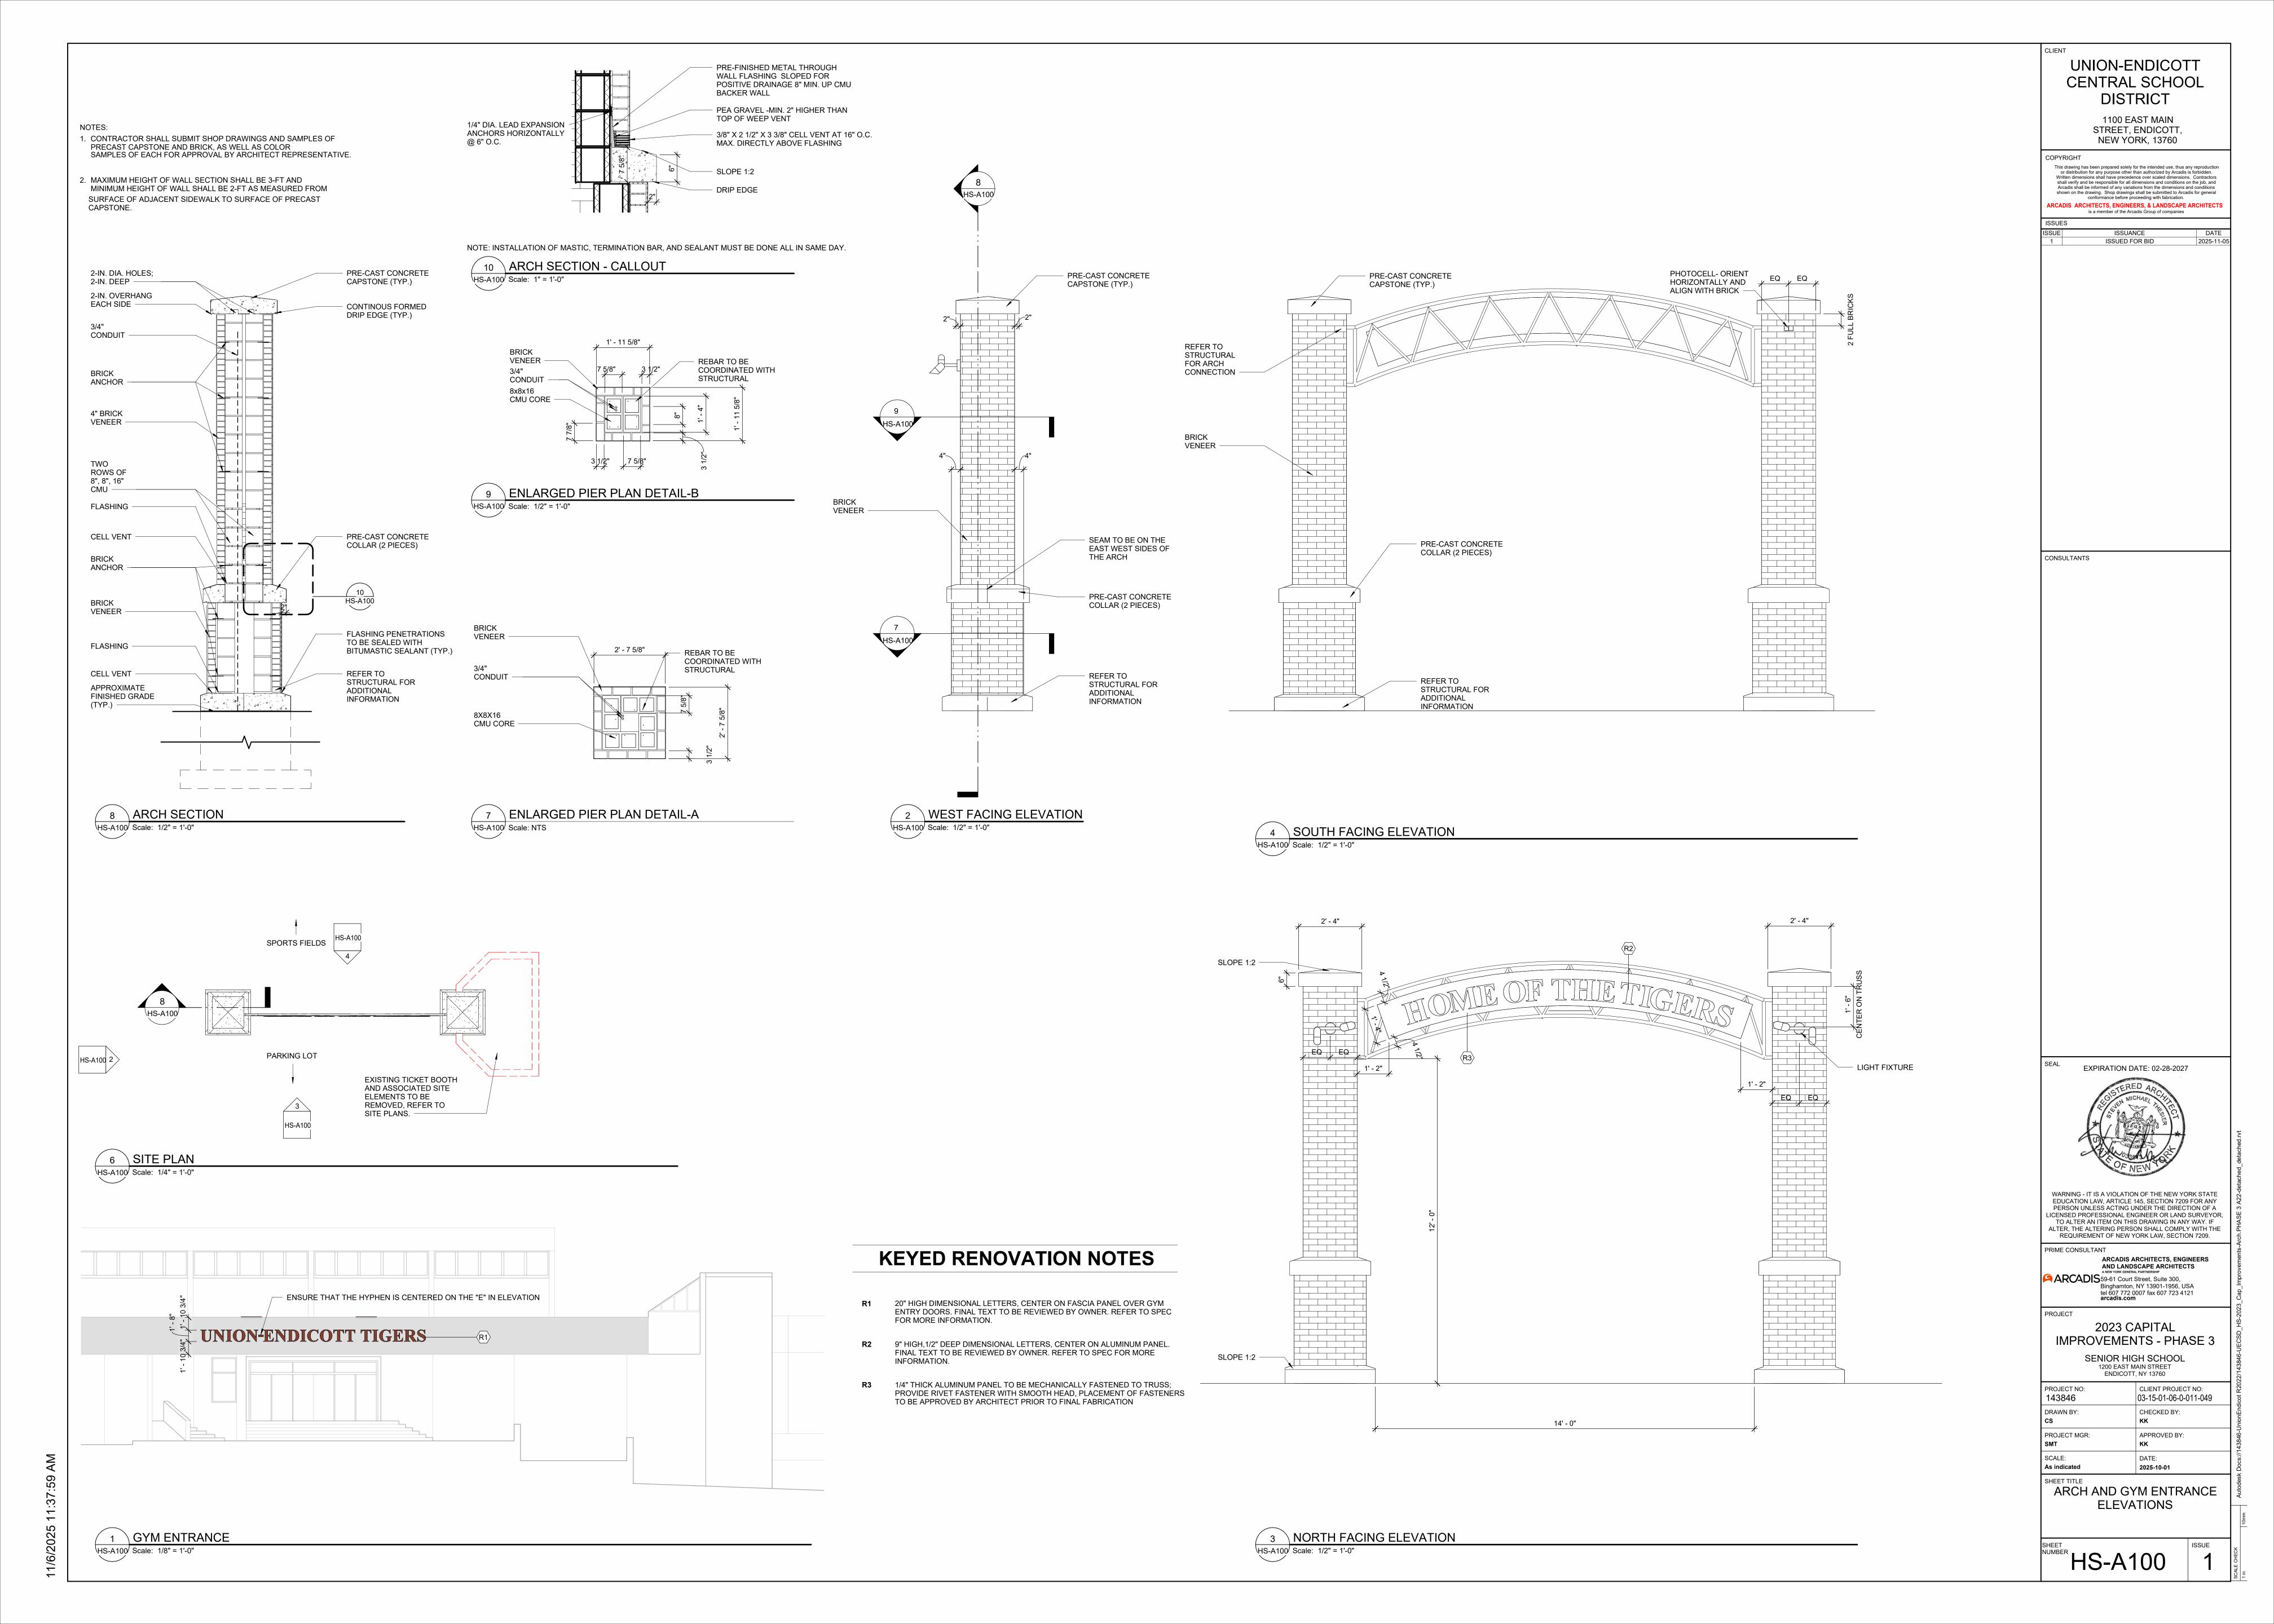
PROJECT 2023 CAPITAL **IMPROVEMENTS - PHASE 3** SENIOR HIGH SCHOOL 1200 EAST MAIN STREET,


CLIENT PROJECT NO: IBI PROJECT NO: 143846 03-15-01-06-0-011-049 DRAWN BY: APPROVED BY: PROJECT MGR: AS INDICATED 2025-10-01


ENDICOTT, NY 13760

SHEET TITLE **EROSION CONTROL DETAILS**

HS-C530




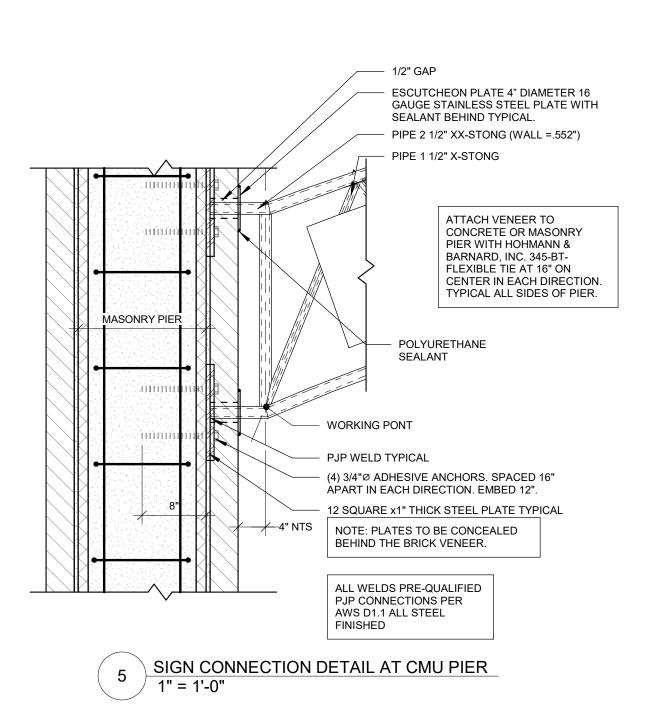


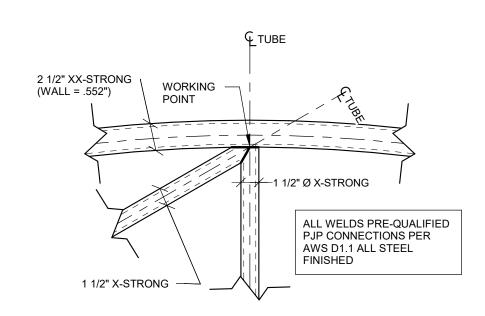


ALL EXPOSED EXTERIOR STEEL HOT-DIPPED GALVANIZED

ALL EXPOSED STEEL TO BE TREATED AS ARCHITECTURAL EXPOSED STRUCTURAL STEEL "AESS" AND FINISH TO STANDARD AESS 3 IN ACCORDANCE WITH AISC 303

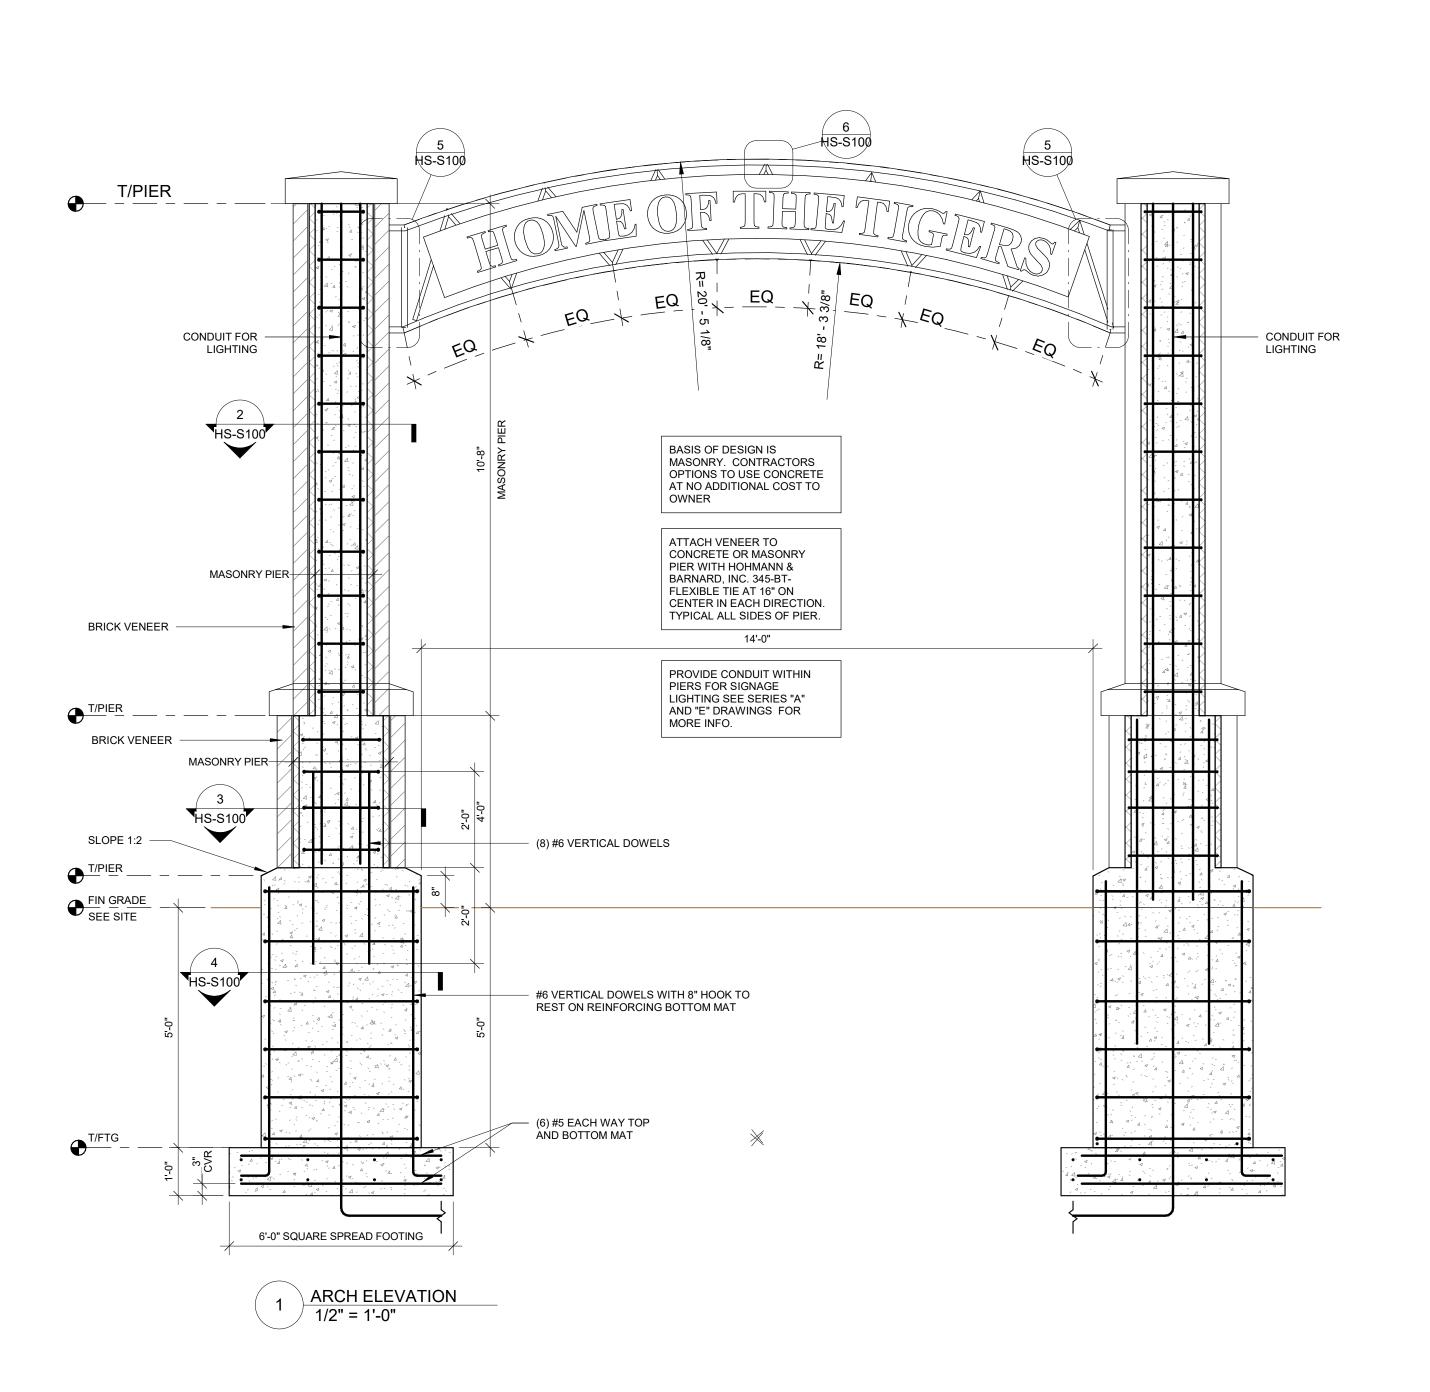

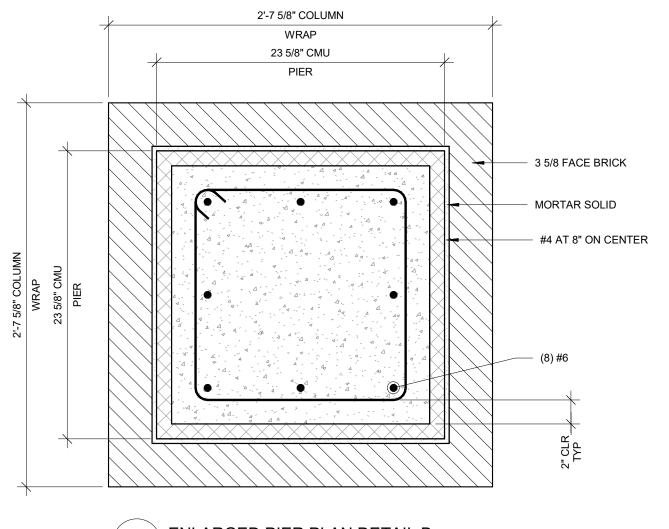

3 ENLARGED PIER PLAN DETAIL B
1 1/2" = 1'-0"

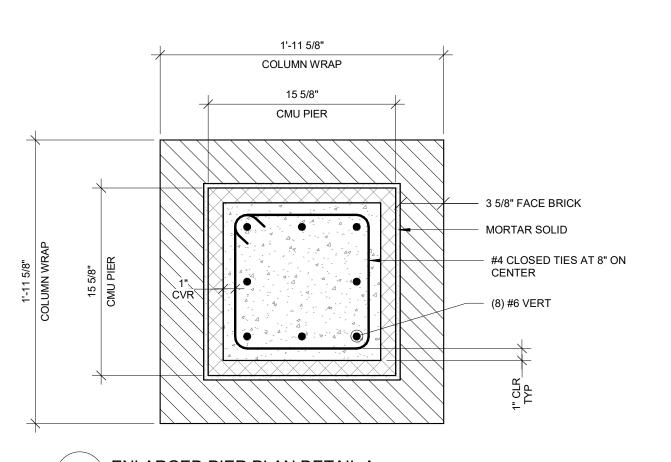

2 ENLARGED PIER PLAN DETAIL A 1 1/2" = 1'-0"

GENERAL NOTES

- 1. CONTRACTOR SHALL VERIFY ALL CONDITIONS, DIMENSIONS, AND ELEVATIONS SHOWN AND IMMEDIATELY REPORT ANY DISCREPANCIES OR OMISSIONS TO THE ARCHITECT PRIOR TO CONSTRUCTION O FABRICATION.
- 2. SECTIONS AND DETAILS ARE CONTINUOUS AND TYPICAL UNLESS NOTED OTHERWISE.
- 3. CONTRACTOR SHALL DETERMINE EXACT LOCATION OF EXISTING UTILITIES BEFORE COMMENCING WORK. CONTRACTOR AGREES TO BE FULLY RESPONSIBLE FOR DAMAGES WHICH MIGHT BE OCCASIONED BY FAILURE TO EXACTLY LOCATED AND PRESERVE
- 4. PROVIDE BARRICADES, WARNING SIGNALS, WARNING LIGHTS AND SIMILAR ITEMS AS REQUIRED AND MAINTAIN THROUGHOUT CONSTRUCTION. CONTRACTOR IS SOLELY RESPONSIBLE FOR JOB SITE SAFETY AND PROTECTION.
- 5. CONTRACTOR SHALL COORDINATE ALL CONCRETE, EARTHWORK, AND CONCRETE MASONRY WORK WITH THE INSPECTION AND TESTING AGENCY RETAINED BY THE OWNER.

BUILDING DESIGN LOADS

MINIMUM DESIGN LOADS PER 2020 NYS BUILDING CODE. LOAD COMBINATIONS.....NYSBC 1605.2 OR 1605.3

ROOF SNOW LOAD (1608): GROUND SNOW LOAD Pg. FLAT-ROOF SNOW LOAD Pf. SNOW EXOSURE FACTOR Ce. SNOW IMPORTANCE FACTOR Is. THERMAL FACTOR Ct. SLOPE ROOF FACTOR SNOW DRIFT LOAD UNBALANCED SNOW LOADS	40 PSF 37 PSF 1.0 1.0 1.2 1.0 PER ASCE 7-10
WIND LOAD (1609): BASIC DESIGN WIND SPEED. BUILDING CATEGORY (ASCE 1-1)	120 MPH II B +/-0.18

ROOF	SURFACE PRESSURE (PSF)									
AREA	10 SF	50 SF	100 SF							
NEGATIVE ZONE 1	-26.7	-21.7	-18.2 -30.1							
NEGATIVE ZONE 2	-41.9	-34.9								
NEGATIVE ZONE 3	-41.9	-34.9	-30.1							
POSITIVE ALL ZONES	16.0	16.0	16.0							
PARAPET	SOLID PARAPET PRESSURE (PSF)									
AREA	10 SF	100 SF	500 SF							
CASE A: INTERIOR ZONE	54.7	45.1	37.6							
CORNER ZONE	54.7	45.1	37.6							
CASE B: INTERIOR ZONE	-30.8	-26.5	-22.2							
CORNER ZONE	-46.1	-36.7	-27.3							
WALL	SURFACE PRESSURE (PSF)									
AREA	10 SF	100 SF	500 SF							
NEGATIVE ZONE 4	-18.2	-16.6	-16.0							
NEGATIVE ZONE 5	-33.5	-26.7	-19.9							
POSITIVE ZONES 4 & 5	18.2	16.0	16.0							

1. CONCRETE SHALL BE AS FOLLOWS FOOTING AND FOUNDATION WALLS 2. ALL CONCRETE TO CONTAIN WATER REDUCING ADMIXTURE.

- 3. CEMENT TO BE TYPE 1 PORTLAND CEMENT. FLY ASH OR BLAST FURNACE SLAG SHALL BE USED IN COMBINATION WITH PORTLAND.
- 4. SEE SPECIFICATION FOR ADDITIONAL INFORMATION.
- 5. REINFORCING STEEL SHALL CONFORM TO ASTM A-615-60 GRADE. WELDED WIRE FABRIC SHALL CONFORM TO ASTM A-185.
- 6. ALL REINFORCING STEEL SHALL HAVE CONCRETE COVER AS FOLLOWS: - FOOTINGS. - 3" - SLABS - 1.5" MIN
- 7. SEE REBAR LAP LENGTH SCHEDULE FOR BAR LAP LENGTHS.
- 8. CURE ALL EXPOSED CONCRETE USING SUPERVISED WET CURE OR AN APPROVED CURING COMPOUND. IF A CURING COMPOUND IS USED, PROVIDE CERTIFICATION THAT THE CURING COMPOUND IS COMPATIBLE WITH FLOOR COVERINGS AND
- 9. EXTERIOR ENTRY SLABS TO RECEIVE A LIGHT BROOM FINISH. TEXTURE TO BE APPROVED BY THE ARCHITECT OR OWNER'S REPRESENTATIVE.
- 10. PROVIDE ALL TIE BARS, SPACER BARS, CHAIRS AND ACCESSORIES.
- 11. VERIFY SIZE AND LOCATION OF ALL OPENINGS IN CONCRETE FOUNDATION WALLS
- 12. ALL PENETRATIONS THROUGH STRUCTURAL SLABS, WALLS, AND FOOTINGS SHALL BE SLEEVED OR CHASED. CORE-DRILLING OF SLABS, WALLS, AND FOOTINGS IS

STRUCTURAL STEEL NOTES

- 1. THE STRUCTURAL STEEL FRAME AS DESIGNED IS A NON-SELF-SUPPORTING STEEL FRAME. COORDINATE THE ERECTION WITH THE INSTALLATION OF OTHER BUILDING ELEMENTS REQUIRED FOR THE STRUCTURE'S STABILITY. THESE ELEMENTS INCLUDE SLABS, METAL DECK, MASONRY WALLS, AND CONCRETE WALLS. PROVIDE AND MAINTAIN TEMPORARY SHORING AND BRACING UNTIL THESE OTHER BUILDING ELEMENTS ARE COMPLETELY INSTALLED AND CURED.
- 2. STRUCTURAL STEEL WIDE-FLANGE SECTIONS SHALL COMPLY WITH ASTM A572 OR ASTM A992 (Fy=50 KSI).
- 3. STRUCTURAL STEEL TUBE SECTIONS SHALL COMPLY WITH ASTM A500, (Fy= 46
- 4. ALL OTHER STRUCTURAL SHAPES SHALL COMPLY WITH ASTM A 36 (Fy=36

5. SHOP CONNECTIONS SHALL BE 3/4" DIAMETER A325 OR A490 HIGH STRENGTH

- BOLTED OR WELDED. (UNLESS OTHERWISED NOTED) 6. FIELD CONNECTIONS SHALL BE 3/4" DIAMETER A325 OR A490 HIGH STRENGTH BOLTED OR WELDED UNLESS OTHERWISE NOTED. FIELD BOLTED
 CONNECTIONS SHALL BE SHEAR/BEARING CONNECTIONS UNLESS OTHERWISE
 NOTED ON THE DRAWINGS. SHEAR BEARING CONNECTIONS SHALL BE
- 7. PROVIDE ANGLE FRAMES AROUND ALL FLOOR AND ROOF OPENINGS WITH A DIMENSION OF 1'-0" IN ANY DIRECTION ON ROOF AREAS FRAMED IN STEEL.

COORDINATE SIZE AND LOCATION WITH MECHANICAL CONTRACTOR.

INSTALLED TO THE SNUG TIGHT CONDITION.

- 8. STEEL FLOOR AND ROOF DECK SHALL BE MANUFACTURED TO THE SPECIFICATIONS OF THE STEEL DECK INSTITUTE. SEE THE PROJECT MANUAL FOR ADDITIONAL REQUIREMENTS. PROVIDE A COMPLETE STEEL DECK SYSTEM WITH ALL POUR STOPS, END CLOSURE STRIPS AND OTHER ACCESSORIES. DO NOT SUBMIT STEEL ROOF AND FLOOR DECK DRAWINGS FOR REVIEW UNTIL
- STEEL ERECTION PLANS HAVE BEEN SUBMITTED AND APPROVED. 9. THE ANCHOR BOLT PLANS AND STRUCTURAL STEEL ERECTION DRAWINGS SHALL BE SUBMITTED AND REVIEWED PRIOR TO SUBMITTING FABRICATION
- DETAIL DRAWINGS, JOIST DRAWINGS OR DECK DRAWINGS. 10. SEE DRAWINGS AND SPECIFICATIONS FOR STEEL FINISH REQUIREMENTS.

UNION-ENDICOTT CENTRAL SCHOOL DISTRICT


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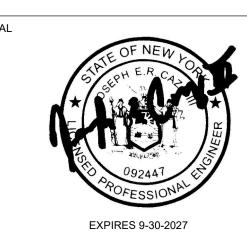
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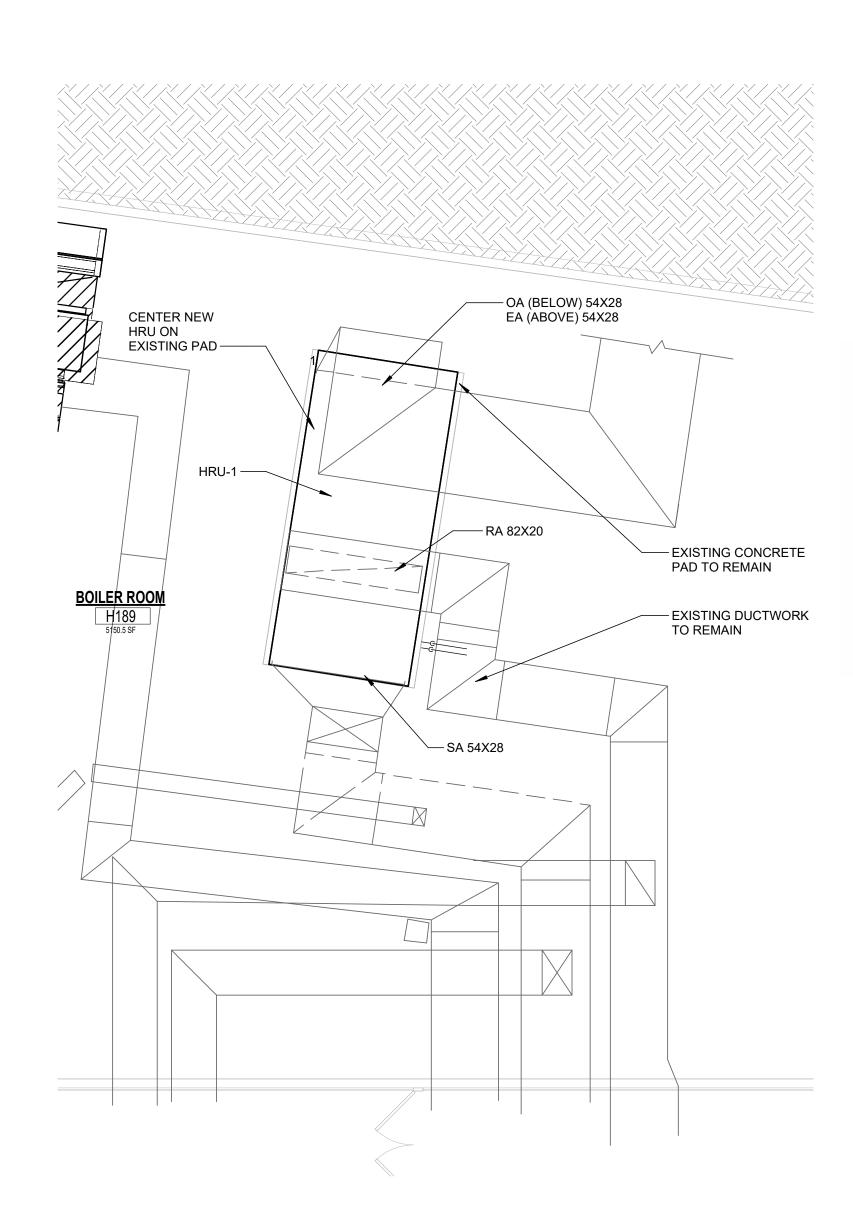
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2023 CAPITAL **IMPROVEMENTS-PHASE 3**

SENIOR HIGH SCHOOL 1200 EAST MAIN STREET ENDICOTT, NY 13760 CLIENT PROJECT NO: PROJECT NO: 143846 03-15-01-06-0-011-049 DRAWN BY: PROJECT MGR:

2025-10-01 STRUCTURAL ELEVATION, **DETAILS & NOTES**

HS-S100

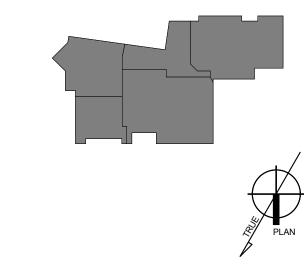

MECHANICAL GENERAL RENOVATION NOTES

- 1 ATTACH EXISTING SA, OA, RA, AND EA DUCTWORK TO NEW UNIT WITH NEW FLEXIBLE CONNECTORS AND TRANSITIONS AS REQUIRED.
- 2 PIPE EXISTING HEAT PUMP LOOP FROM EXISTING ISOLATION VALVES TO NEW UNIT CONNECTIONS.
- 3 REINSULATE ALL DUCTWORK AND PIPING AS SPECIFIED.

LINIT	IT LOCATION OA CFM SA CFM EA CFM GPM			FACEM CDM W	CEM CDM	M CDM	СРМ	CDM	WPD	ENERGY WI	ERGY WHEEL HEATING HEAT PUMP HEATING ENERGY WHEEL COOLING HEAT PUMP COOLING								но	T GAS REHE	AT	SA F	AN I	EAI		LECTRICAL							
ONII	LOCATION	OACFM	SA CFM	EAGFM	GFM	(ft hd)	75						TOTAL		EAT	LAT	EAT	LAT			TOTAL				NOM	SAF	AN	EAI	FAN				CONN
	×						EAT (DB/WB)	LAT (DB/WB)	EAT	LAT	EWT	LWT	(MBH)	COP	db/wb	db/wb	db/wb	db/wb	EWT	LWT	(MBH)	EER	EAT	LAT	(MBH)	HP	ESP	HP	ESP	VOLTS/PHASE	MCA	MOP	PTS
HRU-1	Boiler Room	12,400	12,400	10,840	99	15	-2/-3	49/42	49	65.7	40	37.2	322	6	82/69	75.1/63.3	75.1/63.3	55/53.1	80	89.2	494	15.9	55	71.5	222	2@7.5	1.5	<u>2@5</u>	0.75	460/3	143.6	200	1

Based on 15% Capacity:

> Winter Outdoor Indoor 72

BOILER ROOM MECH - RENOVATION PLAN

MECHANICAL DEMOLITION NOTES


- DISCONNECT EXISTING DUCTWORK FROM UNIT INCLUDING ANY FLEX CONNECTOR.
- DISCONNECT AND REMOVE S & R WATER PIPING BACK TO ISOLATION VALVES. REMOVE EXISTING HRU UNIT IN ITS ENTIRITY AND PREP FOR NEW UNIT INSTALLATION.

UNION ENDICOTT CENTRAL SCHOOL DISTRICT

> 1100 EAST MAIN STREET, ENDICOTT, NEW YORK, 13760

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EXPIRATION DATE: 02-28-2027

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AND LANDSCAPE ARCHITECTS
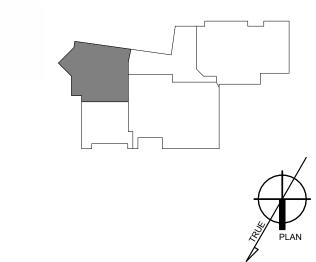
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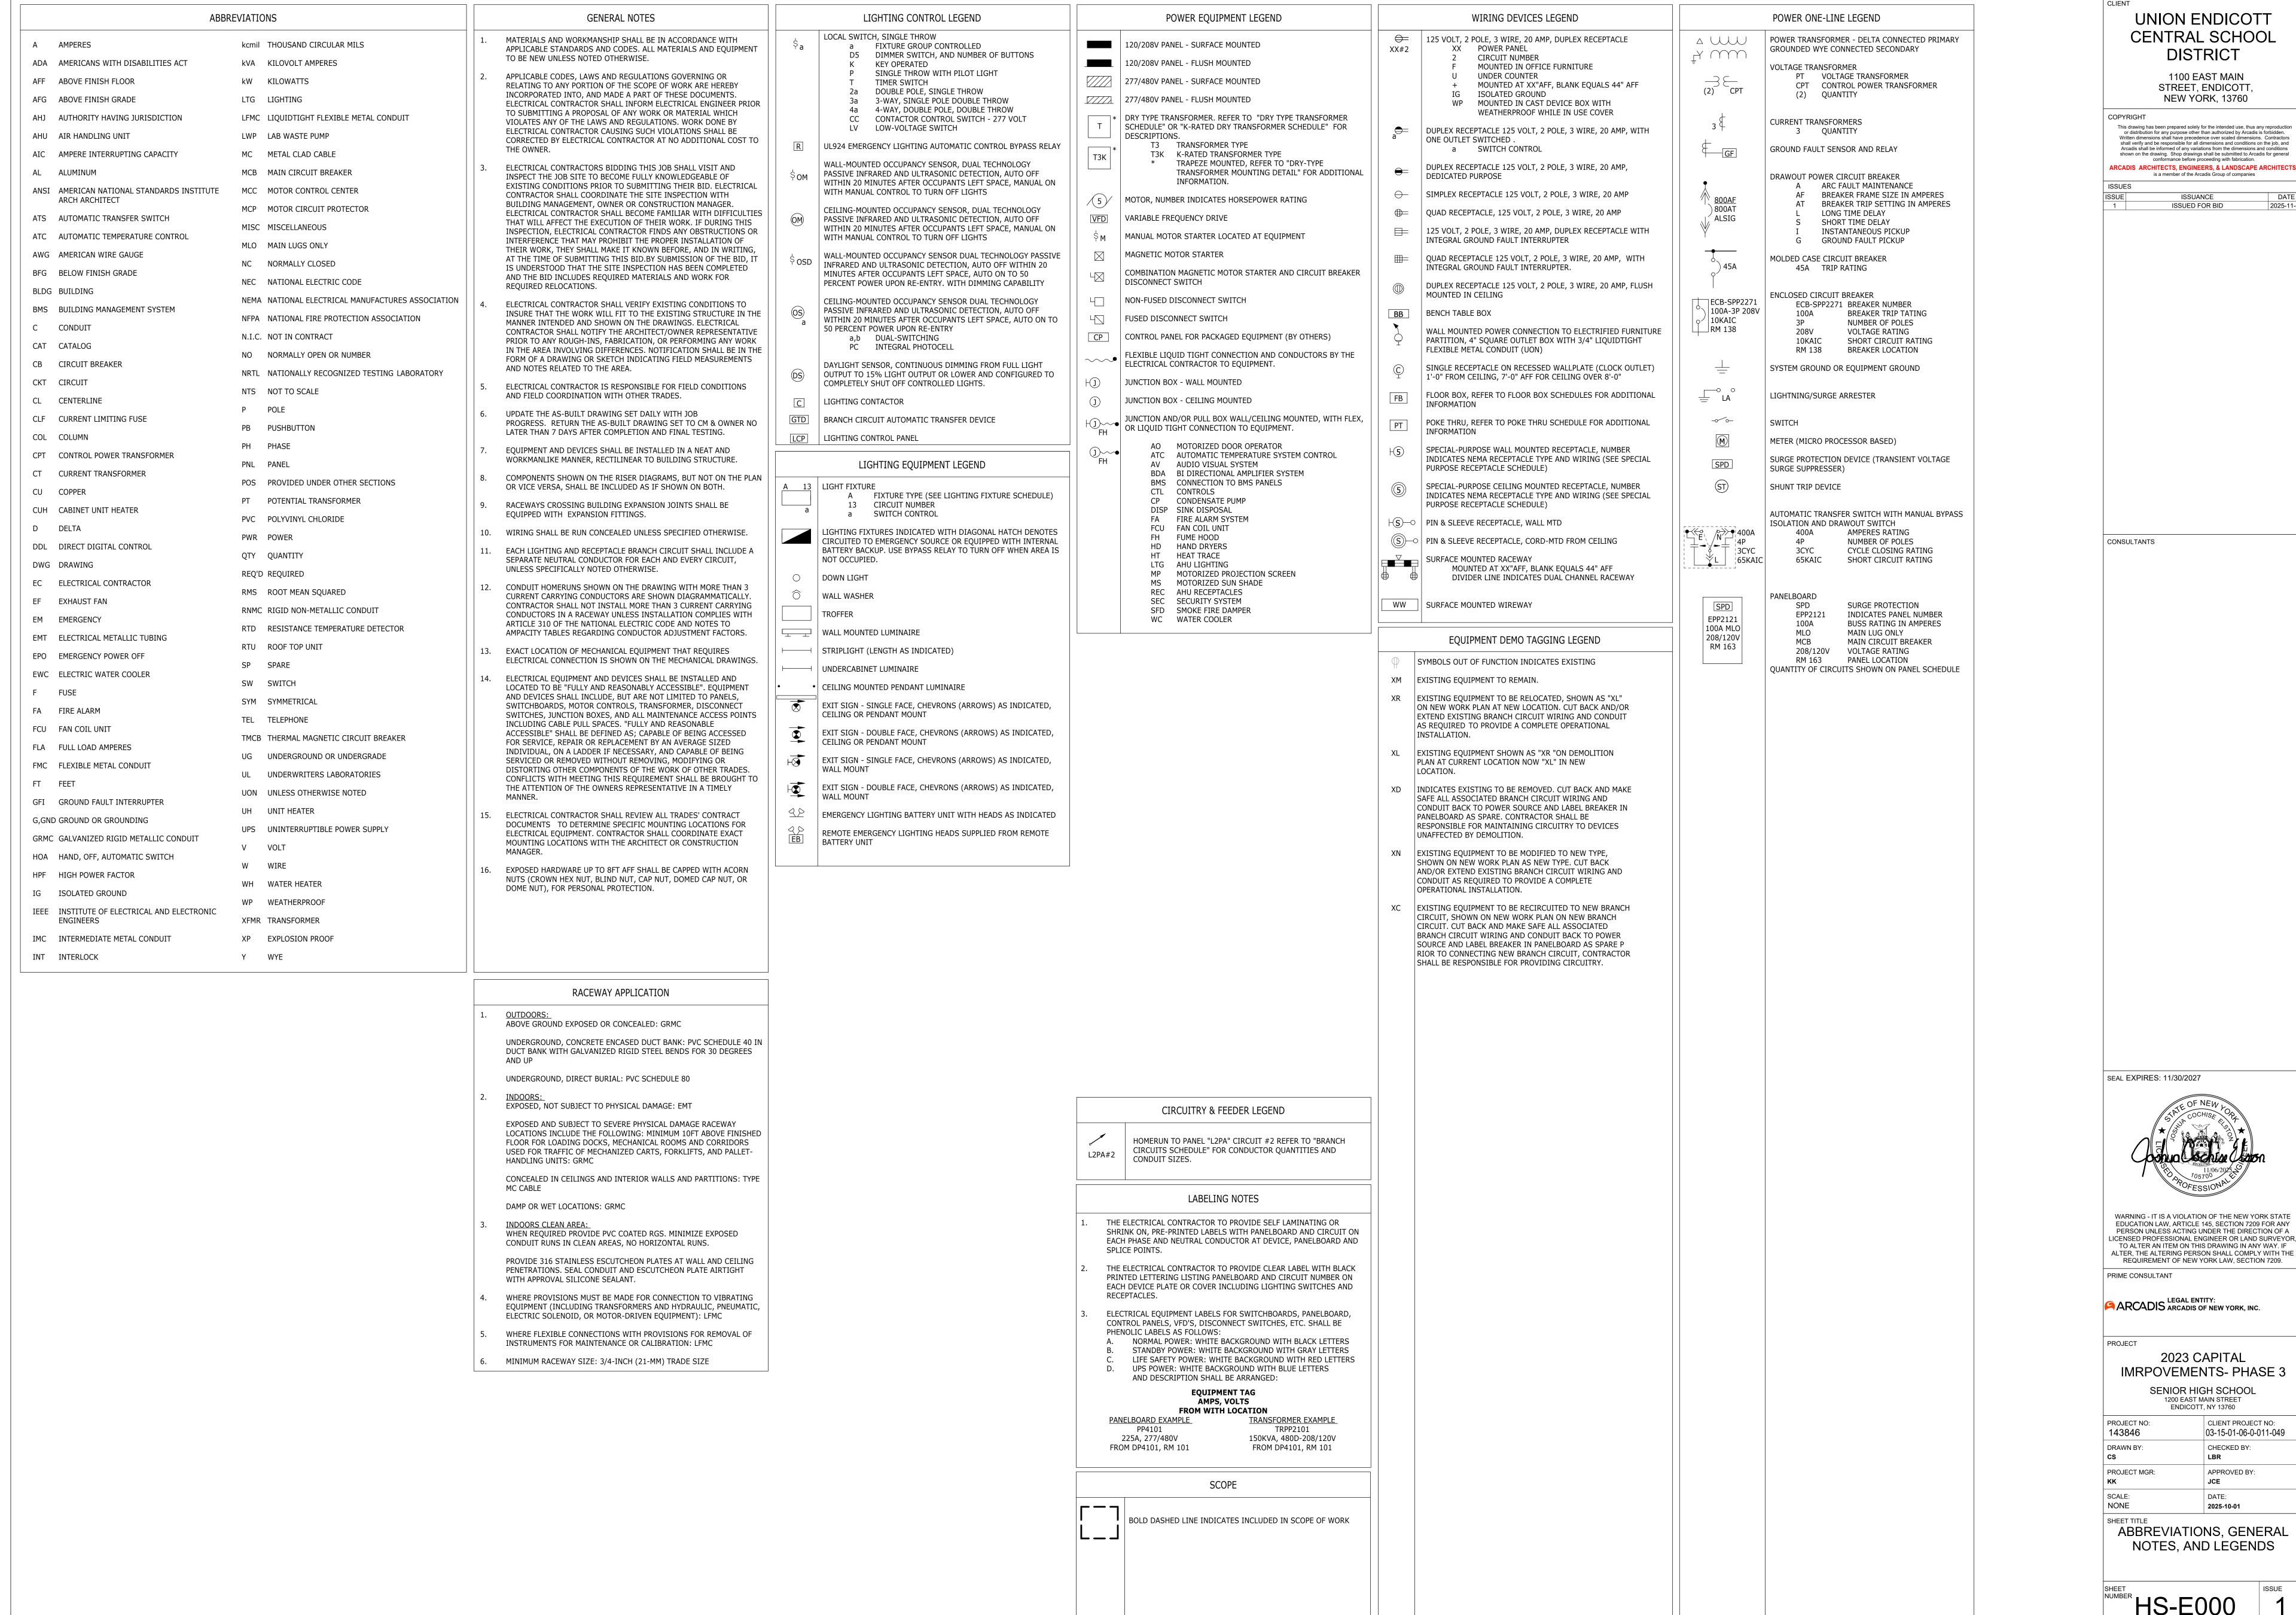
2023 CAPITAL IMRPOVEMENTS- PHASE 3

SENIOR HIGH SCHOOL 1200 EAST MAIN STREET ENDICOTT, NY 13760

	PROJECT NO: 143846	CLIENT PROJECT NO: 03-15-01-06-0-011-049							
	DRAWN BY: CS	CHECKED BY:							
	PROJECT MGR: KK	APPROVED BY:							
	SCALE: As indicated	DATE: 2025-10-01							

BOILER ROOM PLAN

BOILER ROOM MECH - DEMO PLAN



KEYED NOTES

- DISCONNECT 120V AND 208V CIRCUITS (FED FROM PANEL DPB-3 IN DISTRICT OFFICE BUILDING) FOR TICKET BOOTH TO ALLOW FOR REMOVAL OF TICKET BOOTH. TERMINATE 208V CIRCUIT IN HANDHOLE. INTERCEPT 120V, 20A BRANCH CIRCUIT AND EXTEND WITH (2) #12 + 1 #12G. IN 3/4"C. TO JUNCTION BOX IN DECORATIVE ARCH. REFER TO DETAILS ON THIS SHEET FOR ADDITIONAL INFORMATION.
- UPDATE CIRCUIT BREAKER LABELS AND PANELBOARD DIRECTORY IN PANEL DPB-3.
- PROVIDE (2) #12 + 1 #12G. IN 3/4"C. BETWEEN JUNCTION BOXES IN DECORATIVE ARCHES. TRENCHING AND BACKFILLING TO BE DONE BY GENERAL CONTRACTOR (GC), AND WIRING AND CONDUIT TO BE DONE BY ELECTRICAL CONTRACTOR (EC). REFER TO DETAILS ON THIS SHEET FOR ADDITIONAL INFORMATION.

— PHOTOELECTRIC CONTROL TORK 3010, OR AS

ARCH COLUMN

APPROVED


ARCH COLUMN

—— (2)#12 + (1)#12G IN 3/4" SCH. 80 PVC CONDUIT, TYPICAL

- CENTRAL SCHOOL DISTRICT 1100 EAST MAIN
 - STREET, ENDICOTT, NEW YORK, 13760

UNION ENDICOTT

- This drawing has been prepared solely for the intended use, thus any reproduction or distribution for any purpose other than authorized by Arcadis is forbidden. Written dimensions shall have precedence over scaled dimensions. Contractors shall verify and be responsible for all dimensions and conditions on the job, and Arcadis shall be informed of any variations from the dimensions and conditions shown on the drawing. Shop drawings shall be submitted to Arcadis for general conformance before proceeding with fabrication.
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CONSULTANTS

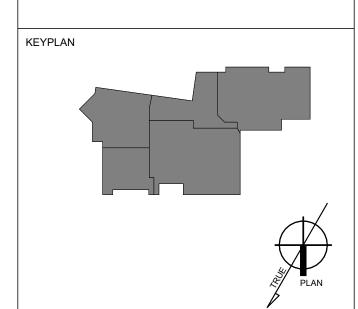SEAL EXPIRES: 11/30/2027



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2023 CAPITAL IMRPOVEMENTS- PHASE 3 SENIOR HIGH SCHOOL 1200 EAST MAIN STREET ENDICOTT, NY 13760

	PROJECT NO: 143846	CLIENT PROJECT NO: 03-15-01-06-0-011-049							
	DRAWN BY: CS	CHECKED BY: LRB							
·	PROJECT MGR: SMT	APPROVED BY: JCE							
	SCALE: As indicated	DATE: 2025-10-01							

ELECTRICAL SITE PLAN AND DETIALS

TERMINATE

EXISTING HANDHOLE DISCONNECT AND

REMOVE CONDUIT

& WIRING FROM EXISTING HANDHOLE

TO TICKET BOOTH

TICKET

LIGHTS & OUTLETS

BOOTH HEATER

─ TICKET BOOTH

SPLICE


2P-20A


1P-20A

PANEL DPB-3

DISTRICT OFFICE

BUILDING MECH/ELEC RM.

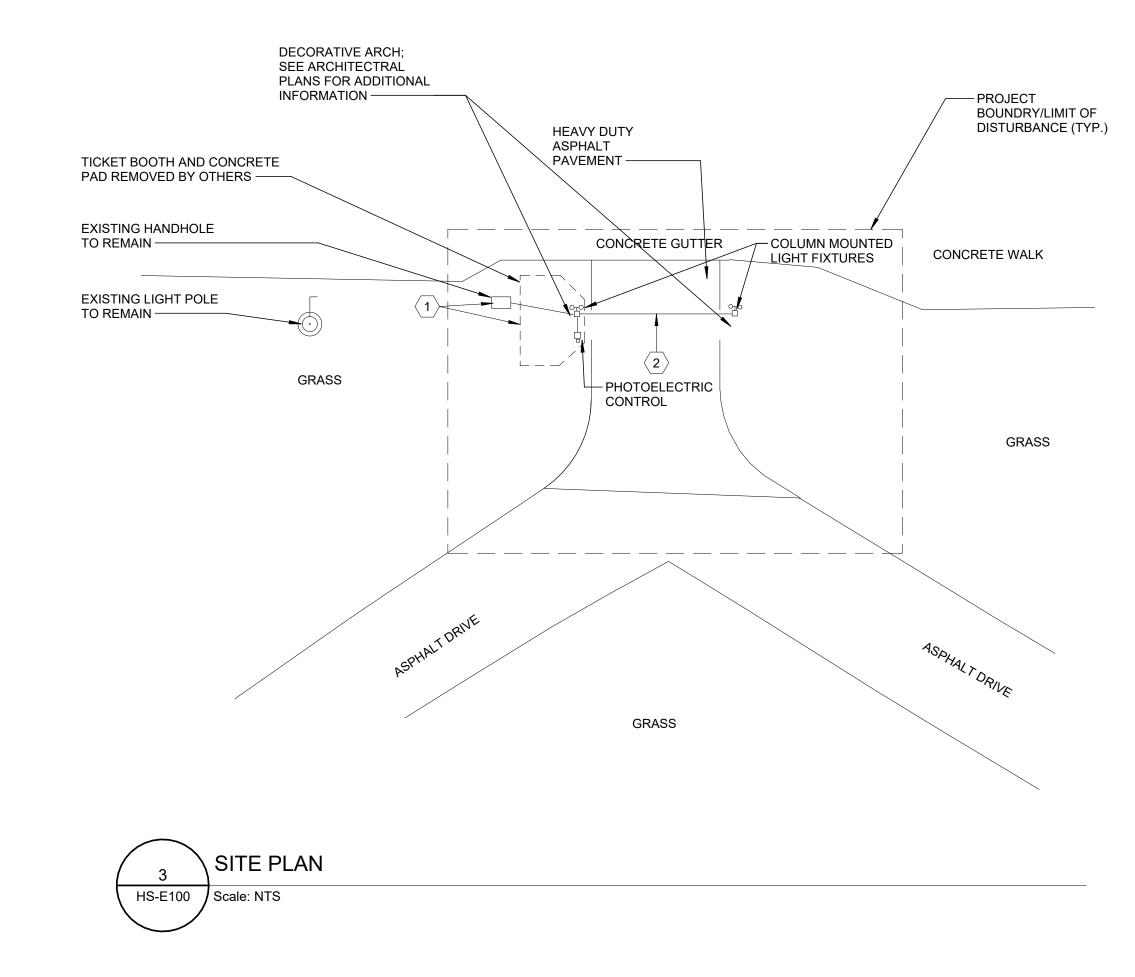

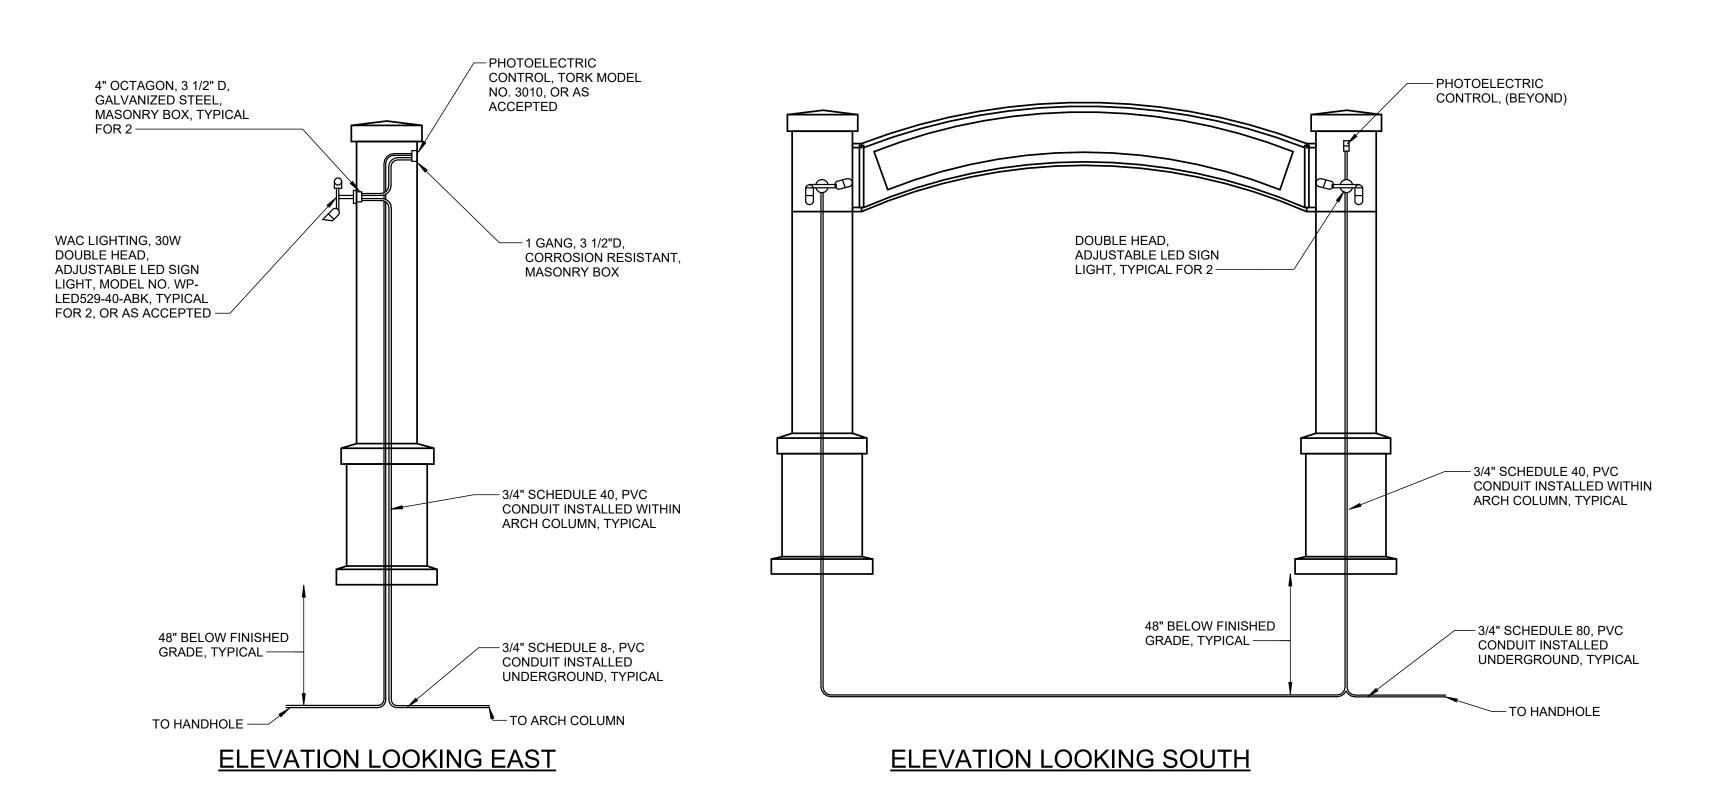






KEYED DEMOLITION NOTES

- D1 EXISTING MDP (XD) TO BE REMOVED UNDER SEPARATE CONTRACT. COORDINATE WORK IN THIS CONTRACT WITH ELCTRICAL CONTRACTOR FOR SEPARATE CONTRACT.
- D2 REMOVE EXISTING FEEDER. COORDINATE WITH ELECTRICAL CONTRACTOR FOR SEPARATE CONTRACT.
- D3 REMOVE EXISTING PANEL MDP5 AND SAFELY STORE FOR RE-INSTALLATION.
- D4 REMOVE EXISTING BRANCH CIRCUIT BREAKER.
- D5 REMOVE EXISTING CONDUIT AND WIRING FEEDING
- EXISTING HRU-1. D6 REMOVE EXISTING DISCONNECT SWITCH.
- D8 EXISTING JUNCTION BOX TO REMAIN. PROVIDE BLOCK-OFF

D7 HRU-1 TO BE REMOVED BY MECHANICAL CONTRACTOR.

PLATES FOR REMOVED CONDUIT PENETRATIONS.

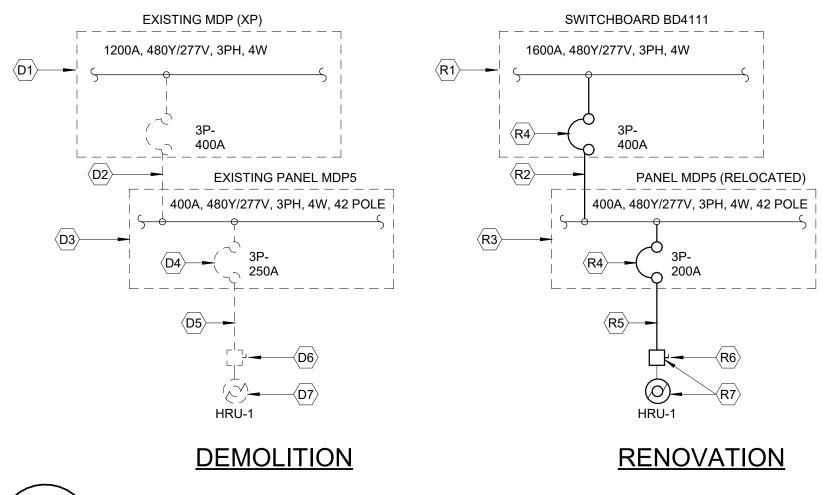

PARTIAL POWER DISTRIBUTION DIAGRAMS

Scale: NTS HS-E101

KEYED RENOVATION NOTES

- R1 SWITCHBOARD BD4111 TO BE INSTALLED UNDER SEPARATE CONTRACT. COORDINATE WORK IN THIS CONTRACT WITH ELCTRICAL CONTRACTOR FOR SEPARATE CONTRACT.
- R2 PROVIDE 2 SETS 4 #3/0,1 #2G. IN 2 1/2" C. TO PANEL MDP5.
- R3 RE-INSTALL EXISTING PANEL MDP5 AT LOCATION SHOWN IN PLAN.
- R4 PROVIDE CIRCUIT BREAKER OF SAME MANUFACTURER AND KAIC RATING EQUIVALENT TO PANELS SCCR.
- R5 PROVIDE 4 #3/0, 1 #6G. IN 2 1/2" C. TO HRU-1.
- R6 DISCONNECT SWITCH FOR HRU-1 PROVIDED WITH UNIT.
- R7 HRU-1 TO BE INSTALLED BY MECHANICAL CONTRACTOR.

UNION ENDICOTT CENTRAL SCHOOL DISTRICT

> 1100 EAST MAIN STREET, ENDICOTT, NEW YORK, 13760


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ISSUANCE

ISSUED FOR BID

2025-11-05



CONSULTANTS

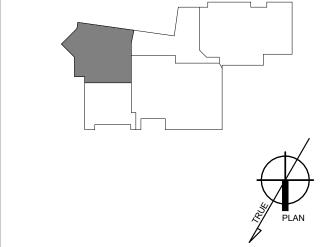SEAL EXPIRES: 11/30/2027

PRIME CONSULTANT

PROJECT NO: 143846

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SCALE: As indicated

PROJECT MGR:

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REQUIREMENT OF NEW YORK LAW, SECTION 7209.

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> SENIOR HIGH SCHOOL 1200 EAST MAIN STREET ENDICOTT, NY 13760

> > CLIENT PROJECT NO:


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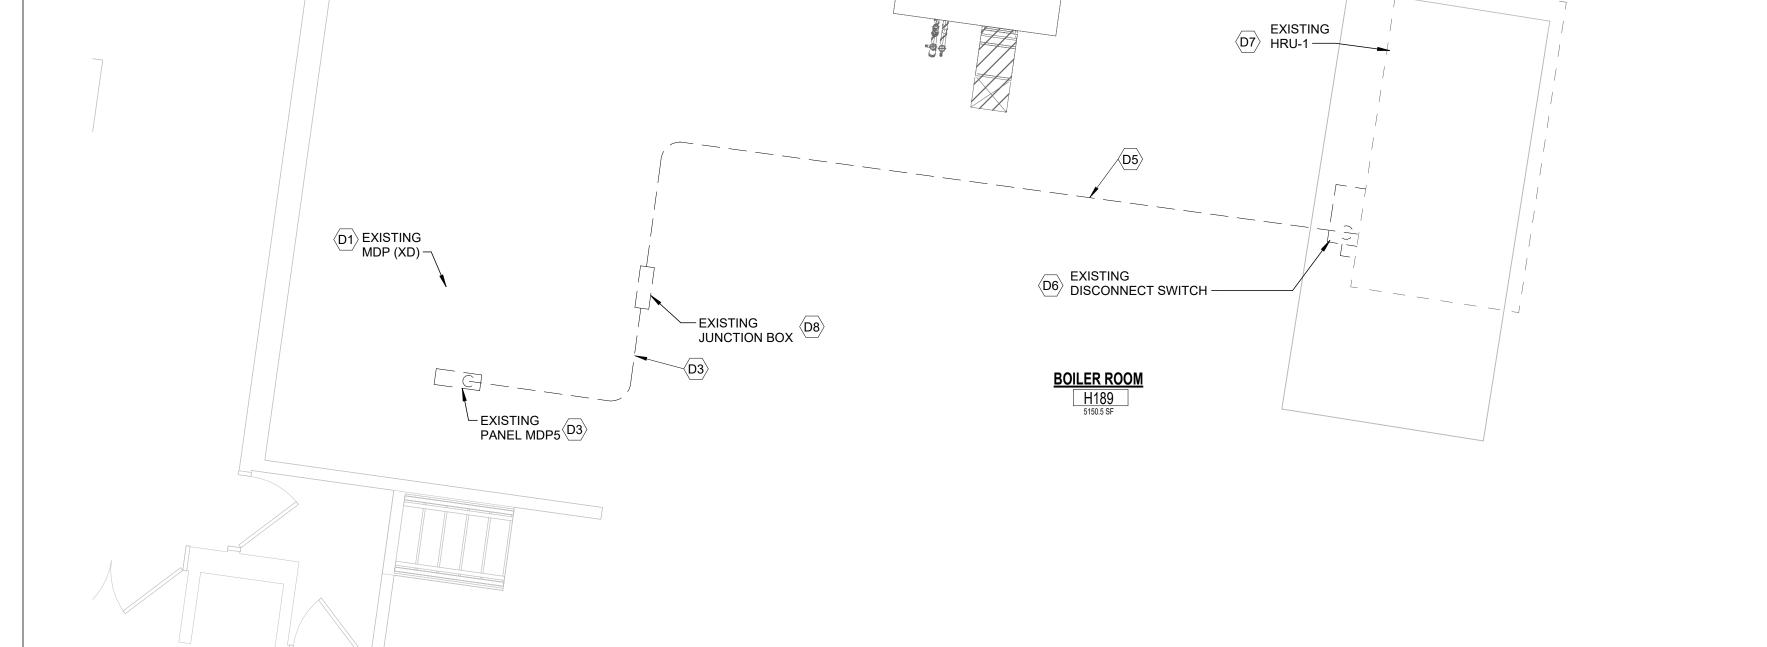
2025-10-01

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ARCADIS ARCADIS OF NEW YORK, INC.



BOILER ROOM PLAN - POWER

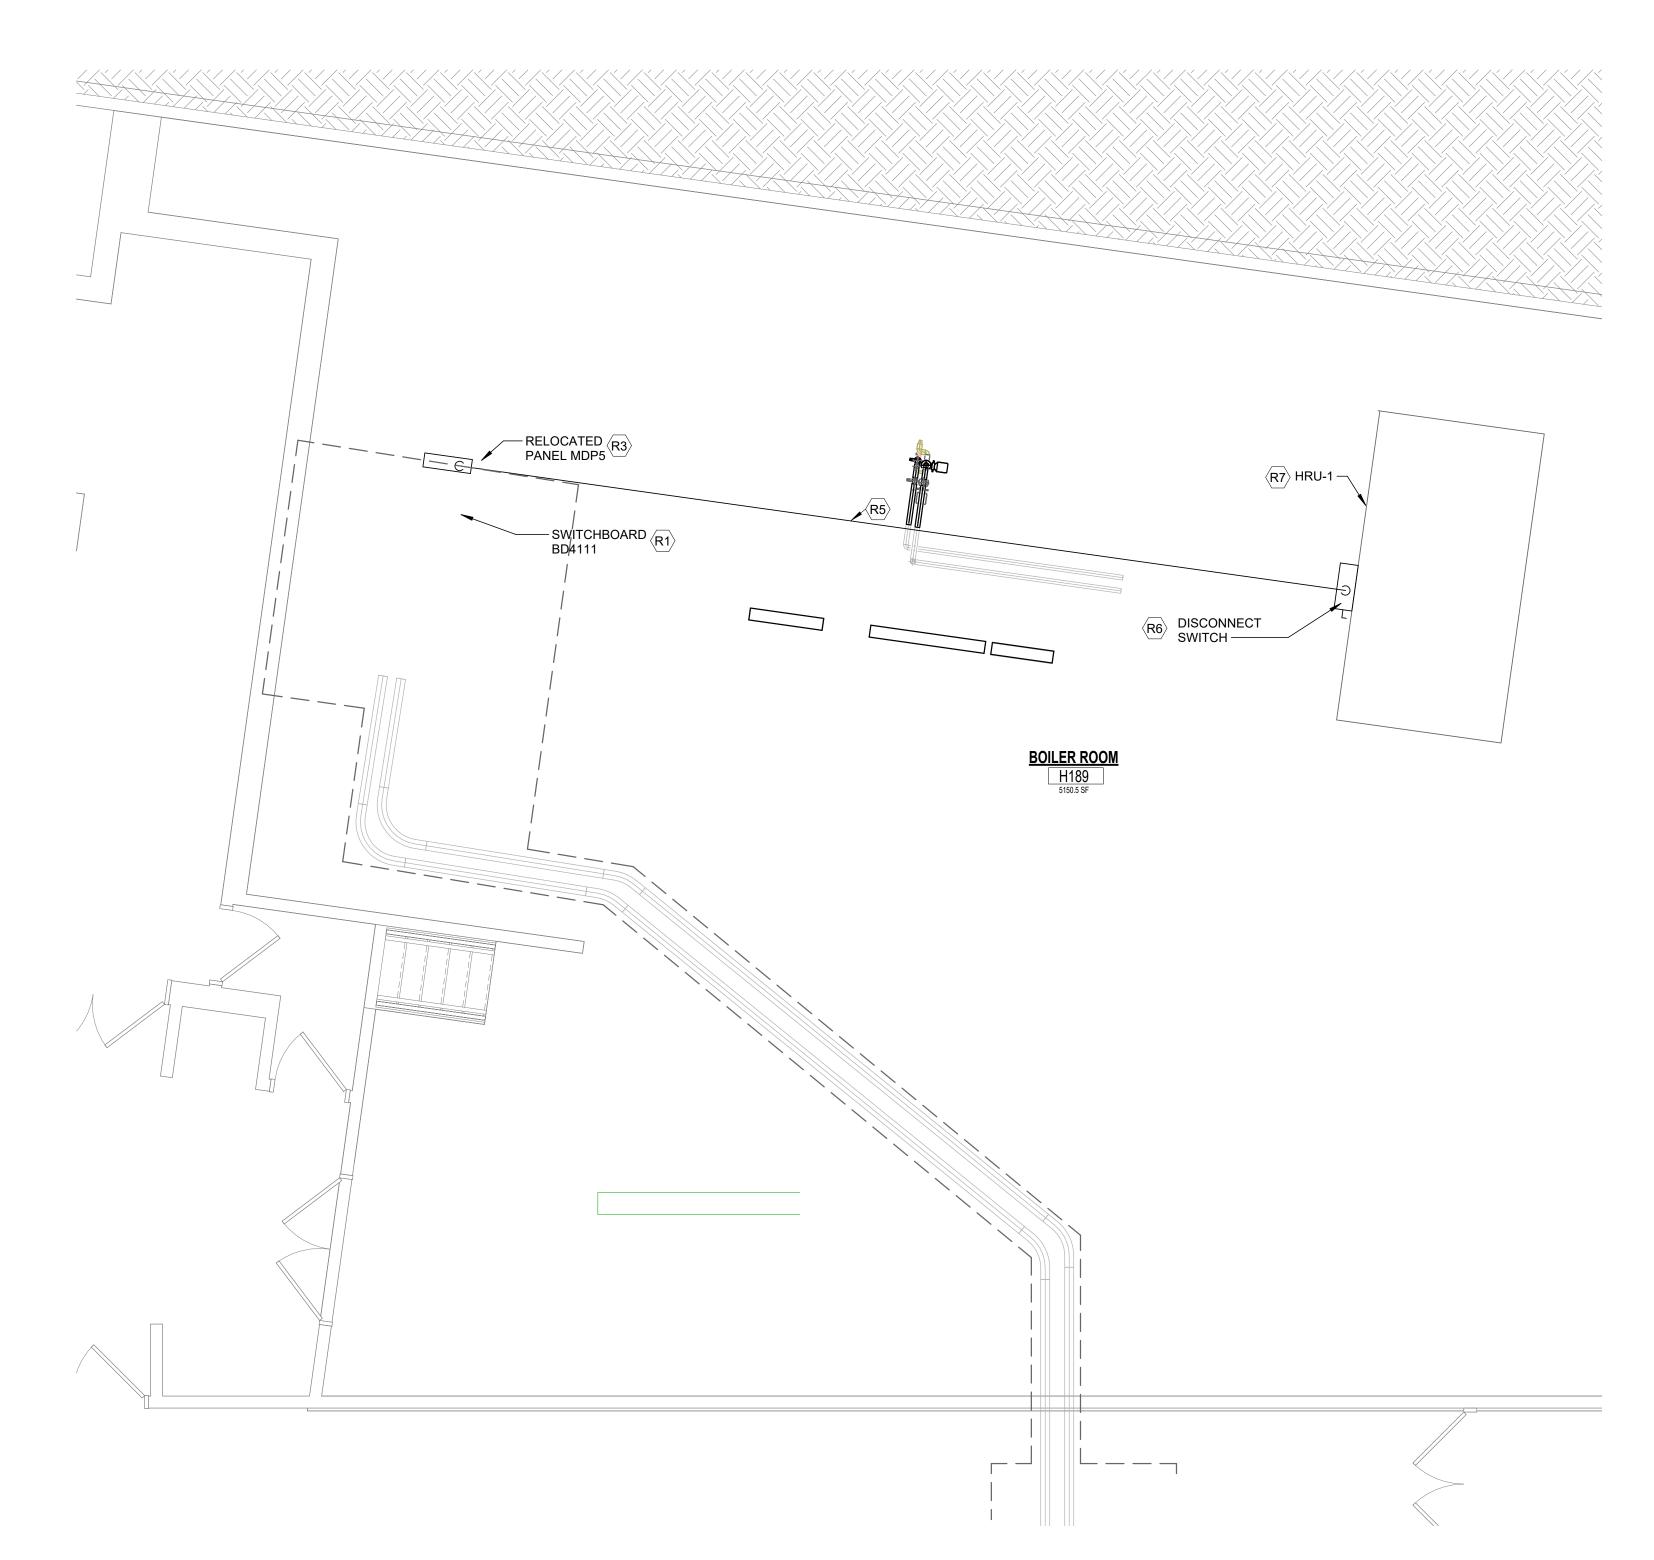

BOILER ROOM DEMOLITION PLAN

HS-E101

BOILER ROOM PLAN