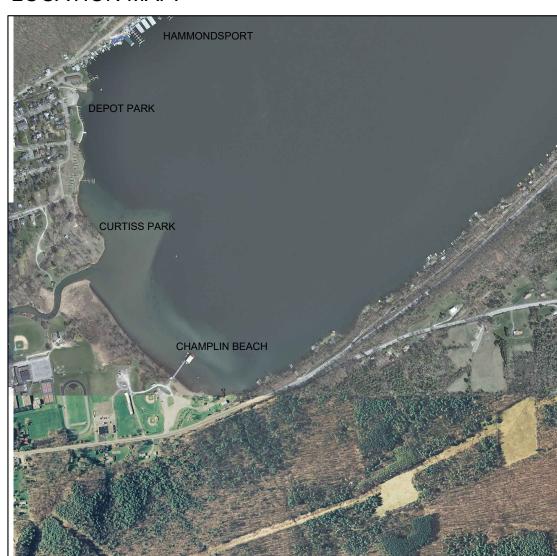


# CHAMPLIN BEACH PIER PROJECT

# TOWN OF URBANA

8014 PLEASANT VALLEY RD. BATH, NY 14840

## LOCATION MAP:



## CONSULTANTS:

LANDSCAPE ARCHITECTURE: SARATOGA ASSOCIATES LANDSCAPE ARCHITECTS, ARCHITECTS, ENGINEERS AND PLANNERS, P.C. 21 CONGRESS STREET, SUITE 201 SARATOGA SPRINGS, NY 12866

CIVIL/STRUCTURAL ENGINEERING: MEAGHER ENGINEERING 2024 W. HENRIETTA ROAD, SUITE 2C ROCHESTER, NY 14623

SURVEY: FAGAN ENGINEERING 113 CHEMUNG PLAZA ELMIRA, NY 14904

## LIST OF DRAWINGS:

## <u>GENERAL</u>

G100 COVER SHEET G101 OVERALL SITE PLAN

# LANDSCAPE ARCHITECTURE L100 EXISTING CONDITIONS PLAN

L200 DEMOLITION AND REMOVALS PLAN

## CIVIL/STRUCTURAL

S100 NOTES
S200 PROPOSED PIER LAYOUT
S300 SECTION AND DETAILS
S400 SECTIONS AND DETAILS
S500 FRAMING PLAN
S600 PROPOSED CONDUIT PLAN

## **GENERAL NOTES:**

- 1. ALL EXISTING UNDERGROUND UTILITIES ARE SHOWN BASED ON AVAILABLE RECORD MAPS. THEIR EXACT LOCATION MAY DIFFER FROM THAT AS SHOWN AND OTHERS MAY EXIST. CONTRACTOR SHALL VERIFY THE LOCATION OF UNDERGROUND UTILITIES PRIOR TO CONSTRUCTION AND SHALL NOTIFY THE DIRECTOR'S REPRESENTATIVE OF ANY DISCREPANCIES WITH THE PLANS. IT SHALL BE THE CONTRACTORS RESPONSIBILITY TO PROCEED WITH CARE IN EXECUTING THE WORK. CONTACT U.F.P.O. 48 HOURS BEFORE DIGGING AT 1-800-962-7962.
- 2. ANY EXISTING UNDERGROUND UTILITIES DAMAGED DURING CONSTRUCTION OPERATIONS SHALL BE RESTORED TO ORIGINAL CONDITION IN CONFORMANCE WITH THE AGENCY HAVING JURISDICTION. IT IS THE CONTRACTOR'S RESPONSIBILITY TO TAKE THE NECESSARY PRECAUTIONS TO ENSURE THAT EXISTING UTILITIES WILL NOT BE DAMAGED DURING THE COURSE OF NEW CONSTRUCTION. DAMAGED UTILITIES SHALL BE RESTORED AT THE EXPENSE OF THE CONTRACTOR.
- THE CONTRACTOR SHALL VERIFY EXISTING CONDITIONS IN THE FIELD PRIOR TO COMMENCEMENT OF WORK AND NOTIFY THE OWNER'S REPRESENTATIVE OF ANY CONDITIONS THAT VARY FROM THE PLANS.
- 4. THE CONTRACTOR SHALL COMPLY WITH ALL PERMIT CONDITIONS.
- 5. THE CONTRACTOR IS RESPONSIBLE FOR CONDUCTING HIS WORK IN A SAFE MANNER. ALL WORK SHALL BE IN ACCORDANCE WITH THE LATEST APPLICABLE O.S.H.A REGULATIONS.
- 6. THE CONTRACTOR SHALL BE RESPONSIBLE FOR MAINTAINING PUBLIC TRAFFIC IN A SAFE AND EFFICIENT MANNER AT ALL TIMES DURING THE CONSTRUCTION PERIOD. PROVIDE FENCING, SIGNS, FLAGMEN AND OTHER FACILITIES AS NECESSARY.
- 7. ALL UNUSABLE EXCESS MATERIALS AND UNSUITABLE SOILS AND DEBRIS SHALL BE REMOVED FROM THE SITE AND DISPOSED OF BY THE CONTRACTOR IN A LEGAL MANNER.

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# Town of Urbana

Steuben County, New York est. 1822

8014 Pleasant Valley Rd. Bath NY 1481

## Champlin Beach Pier Project Town of Urbana, NY 14840

## REVISIONS

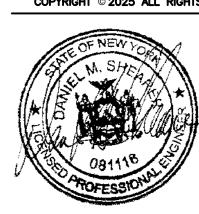
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SARATOGA ASSOCIATES PROJECT#			201	9-021.10

## **COVER SHEET**

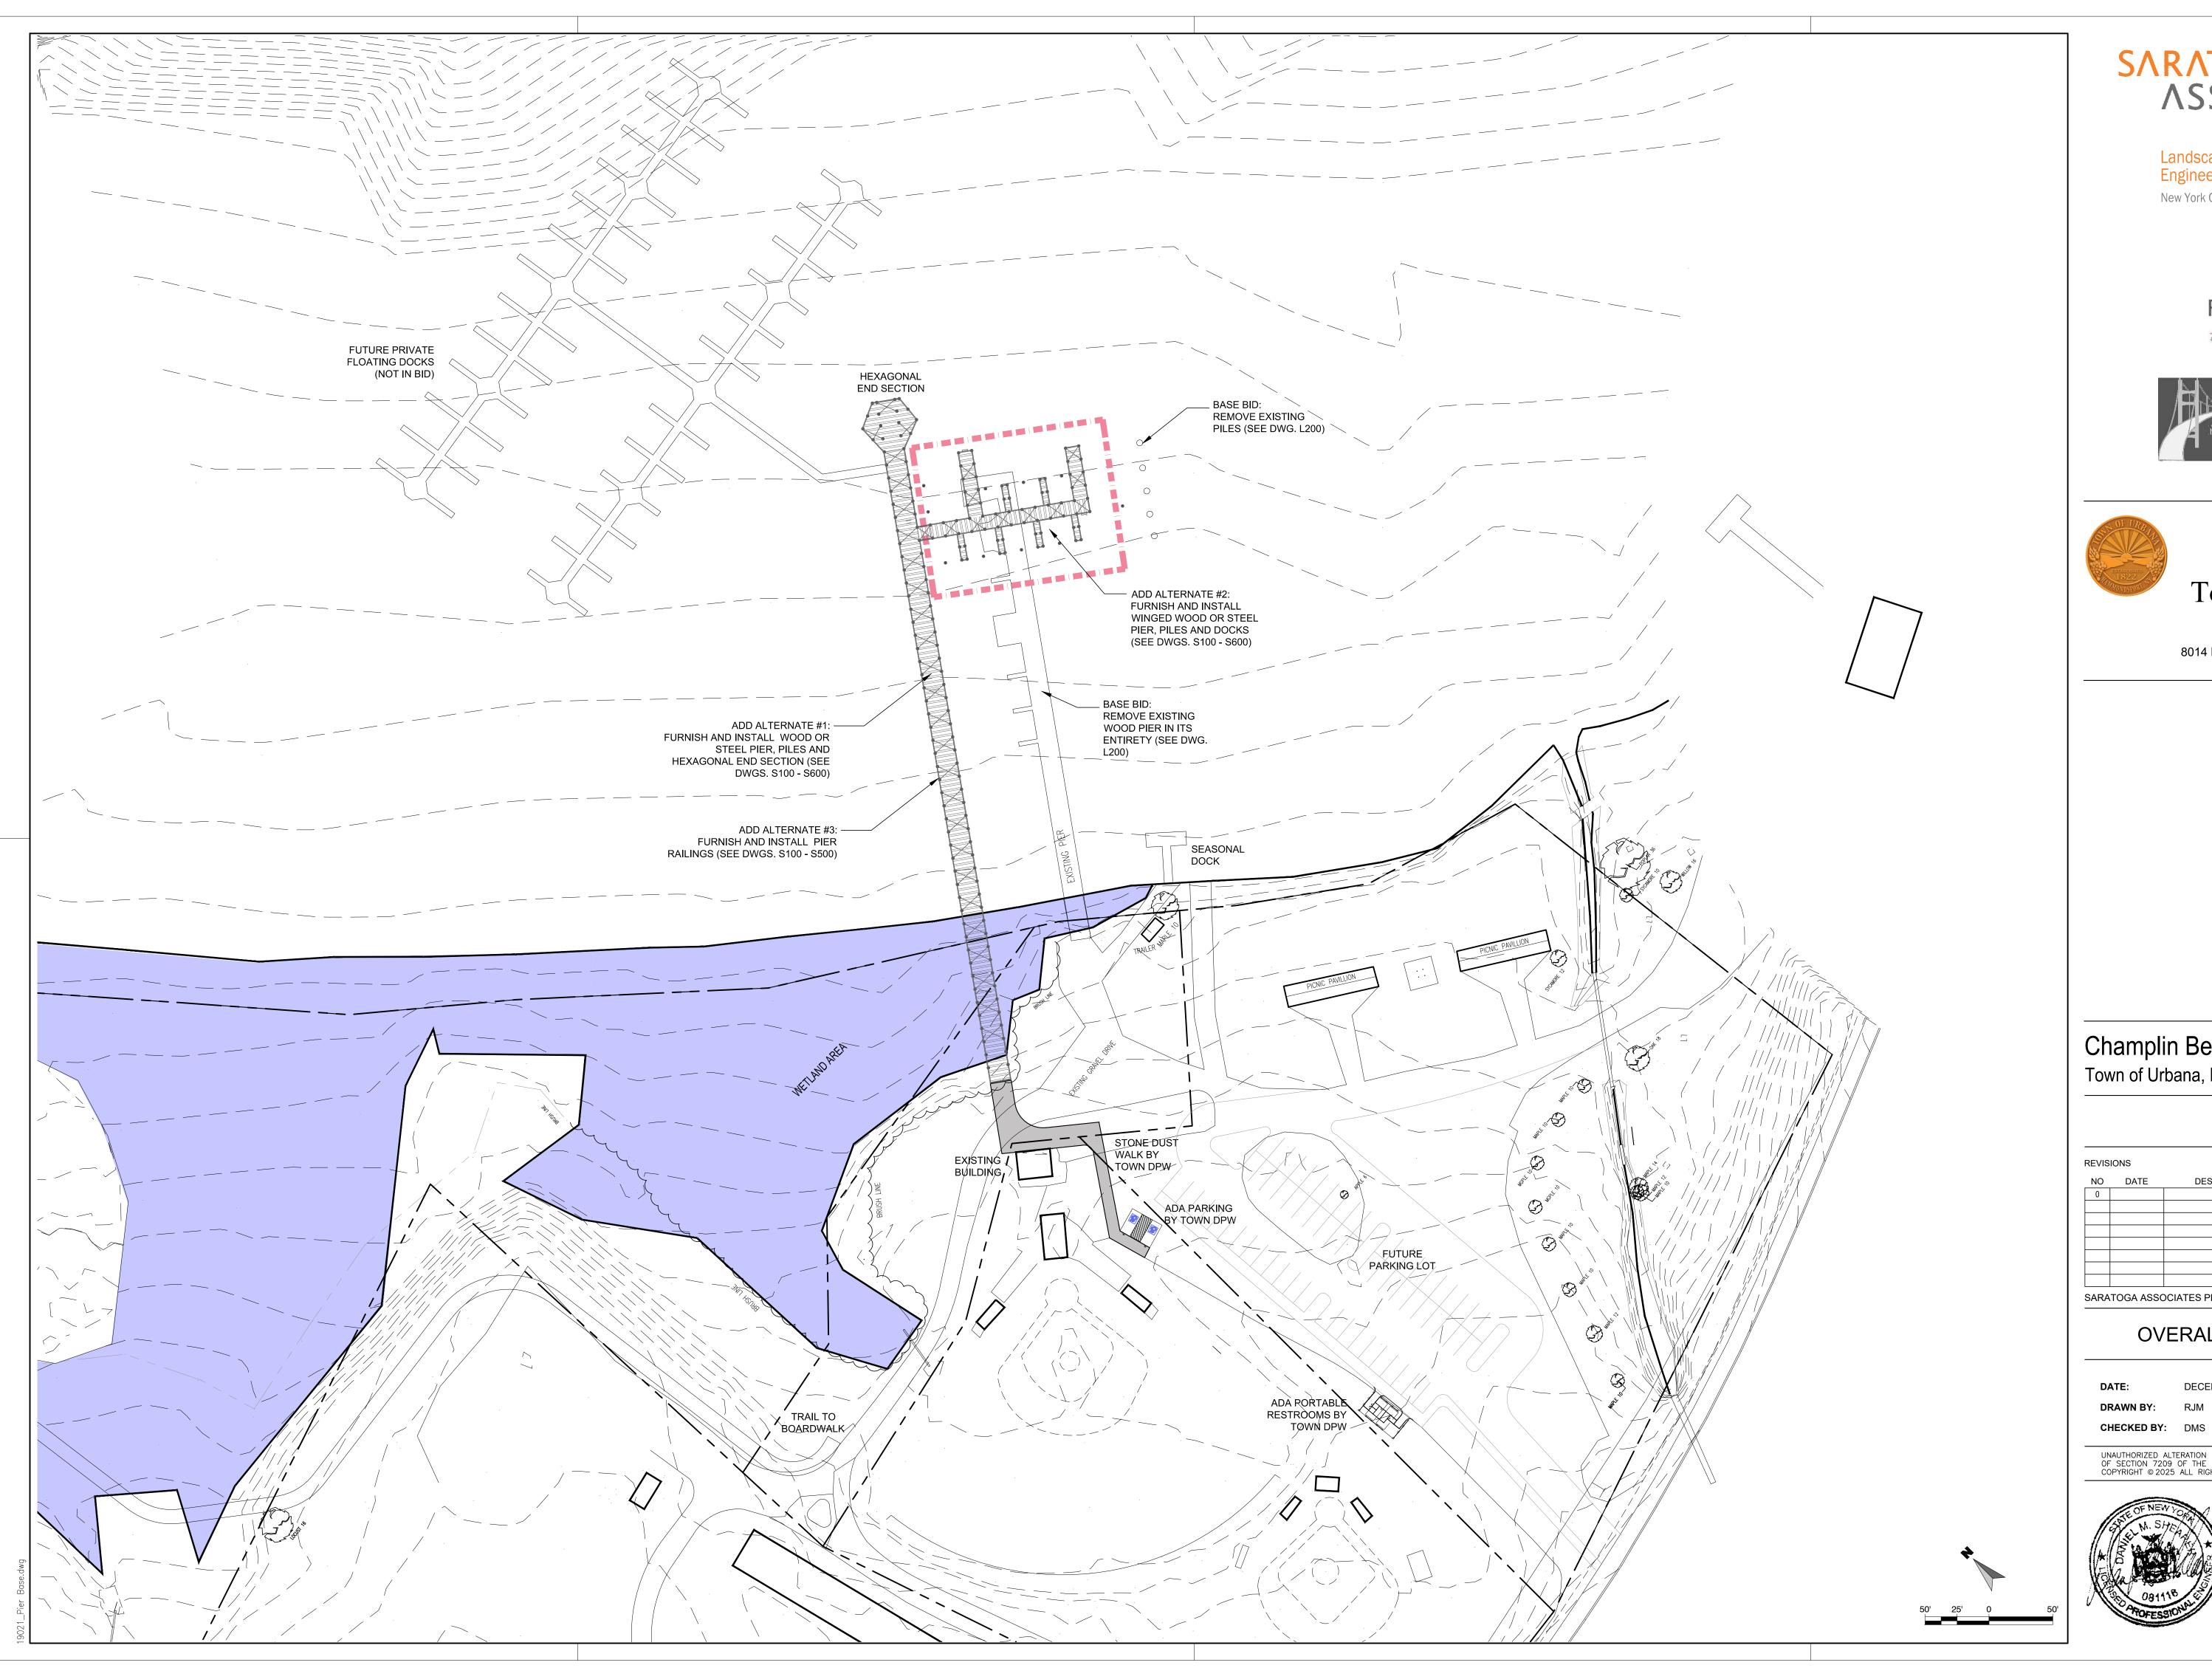
DATE: DECEMBER 05, 2025

DRAWN BY: RJM
CHECKED BY: DMS

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# Town of Urbana

Steuben County, New York est. 1822

8014 Pleasant Valley Rd. Bath NY 1481

## Champlin Beach Pier Project Town of Urbana, NY 14840

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SARATOGA ASSOCIATES PROJECT #			201	9-021.10

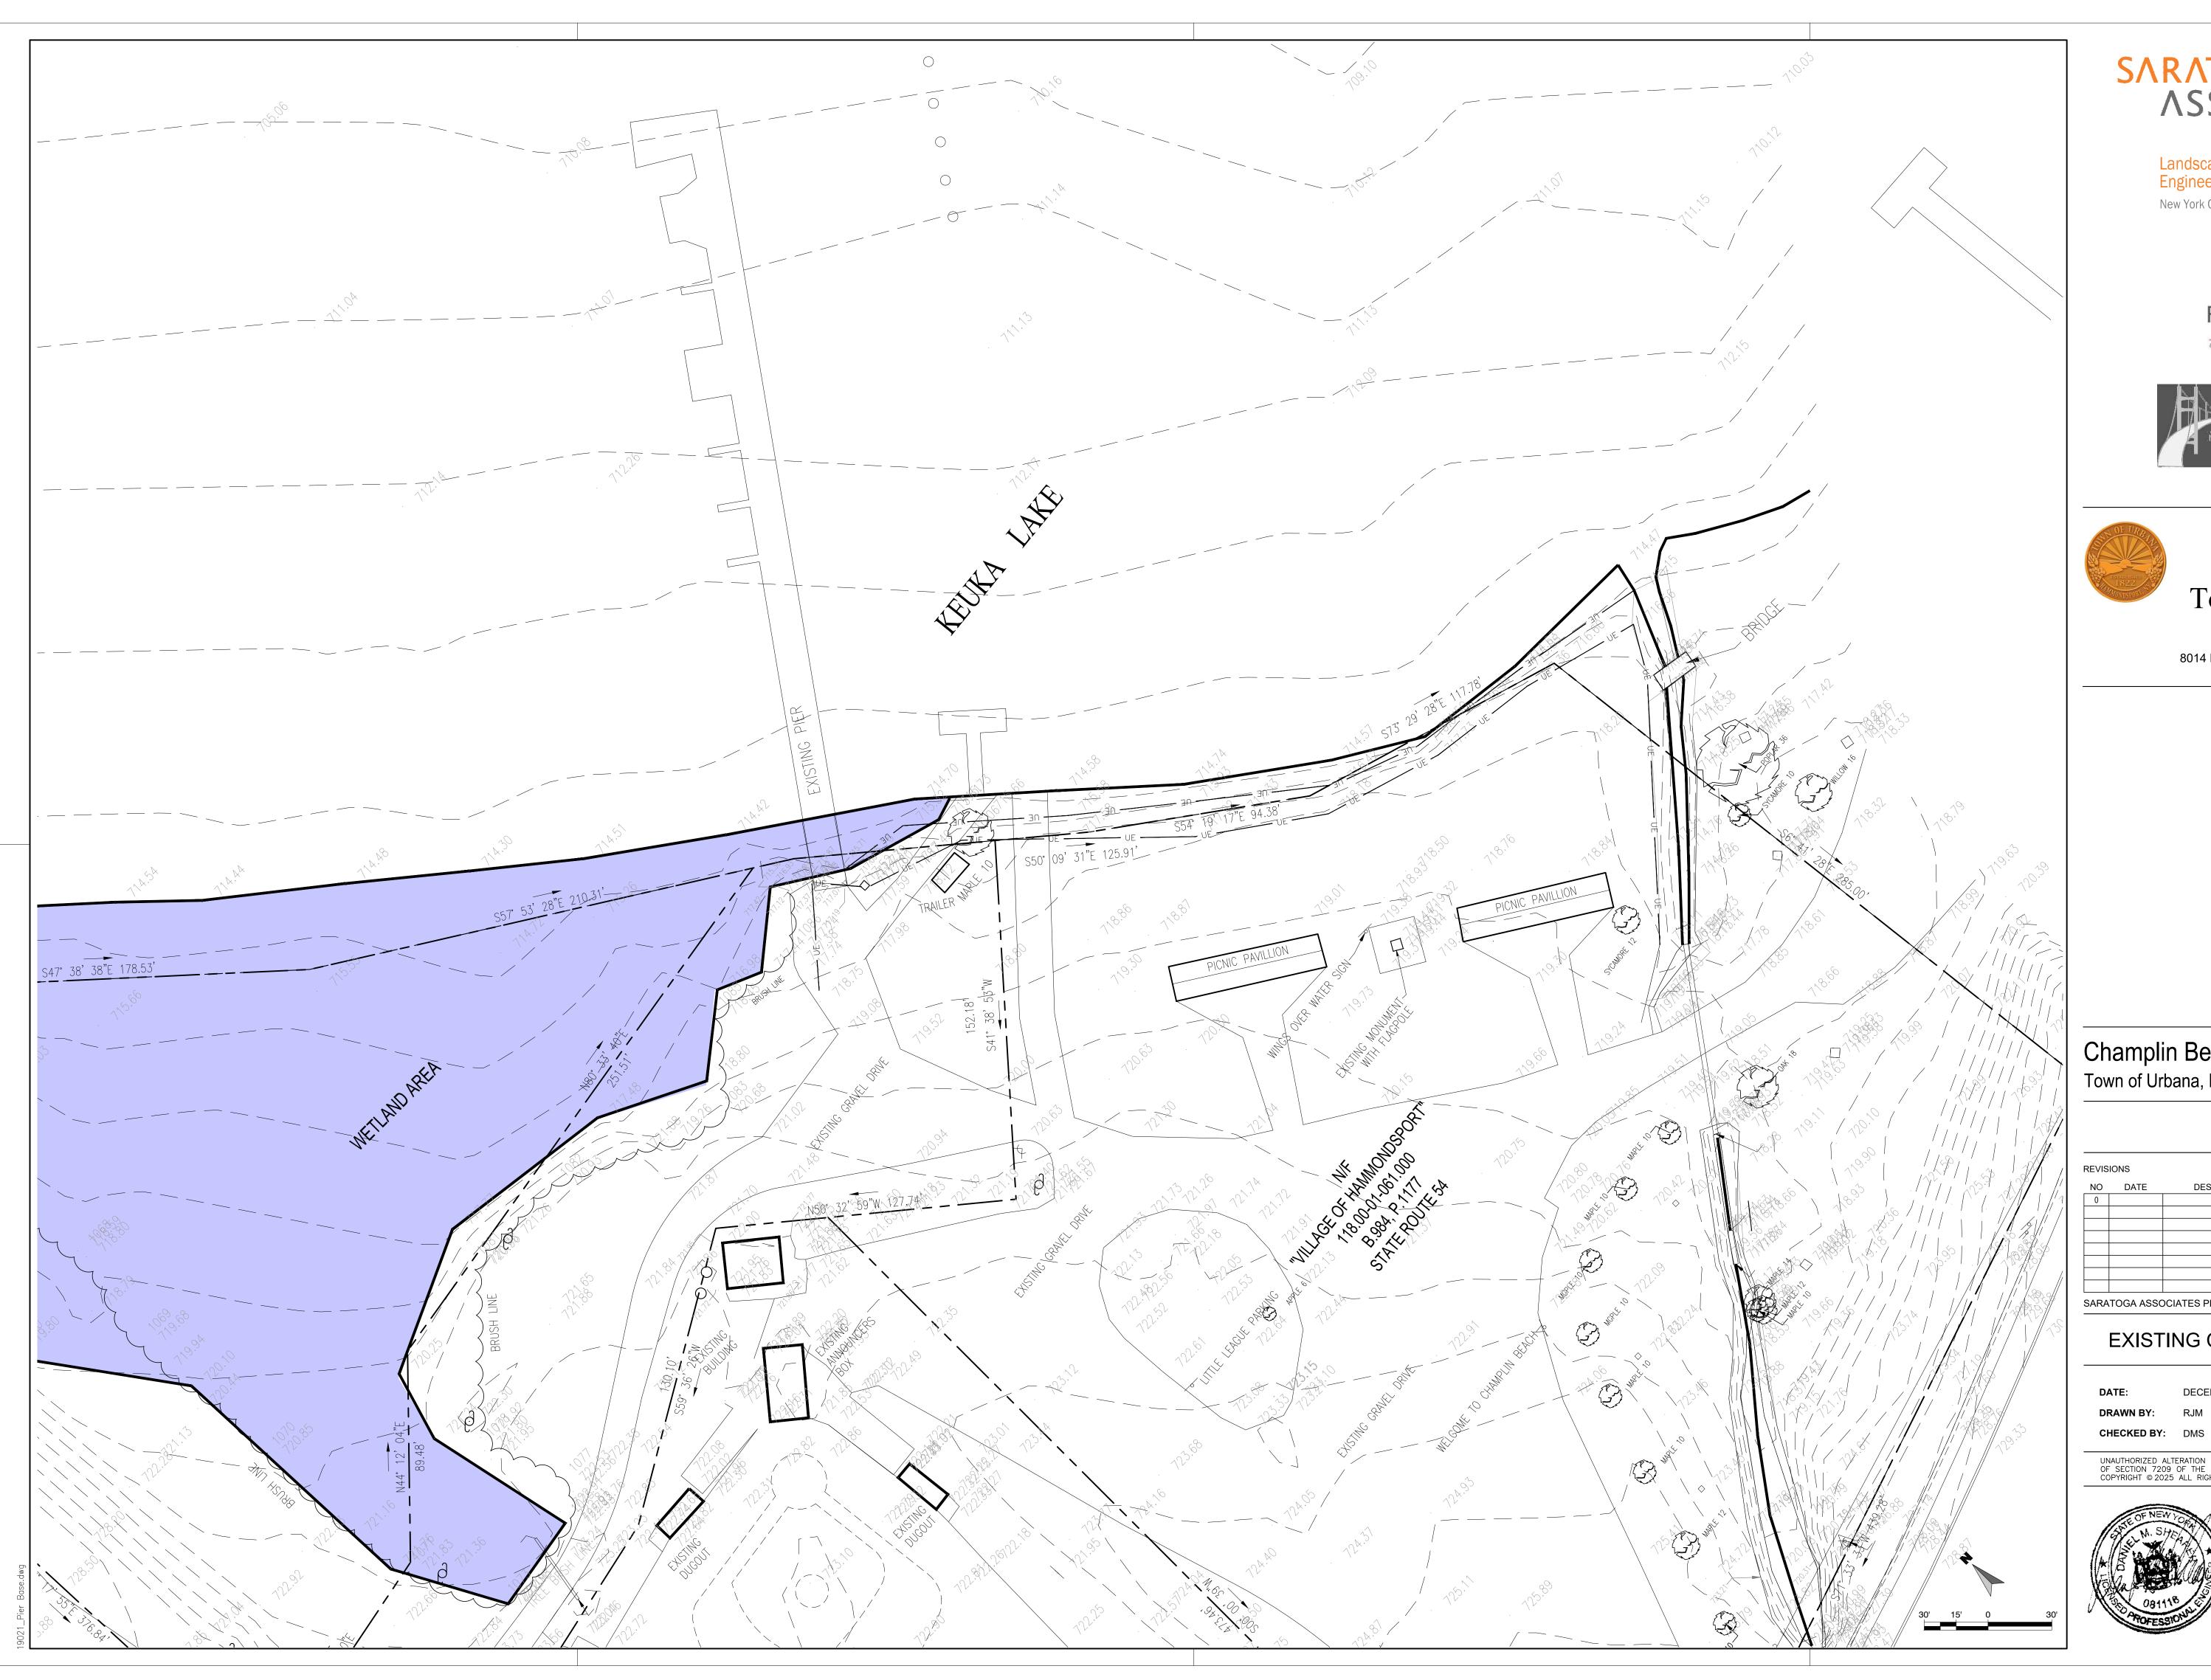
## OVERALL SITE PLAN

DECEMBER 05, 2025

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Town of Urbana Steuben County, New York est. 1822

8014 Pleasant Valley Rd. Bath NY 1481

## Champlin Beach Pier Project Town of Urbana, NY 14840

REVISIONS				
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SARATOGA ASSOCIATES PROJECT#			201	9-021.10

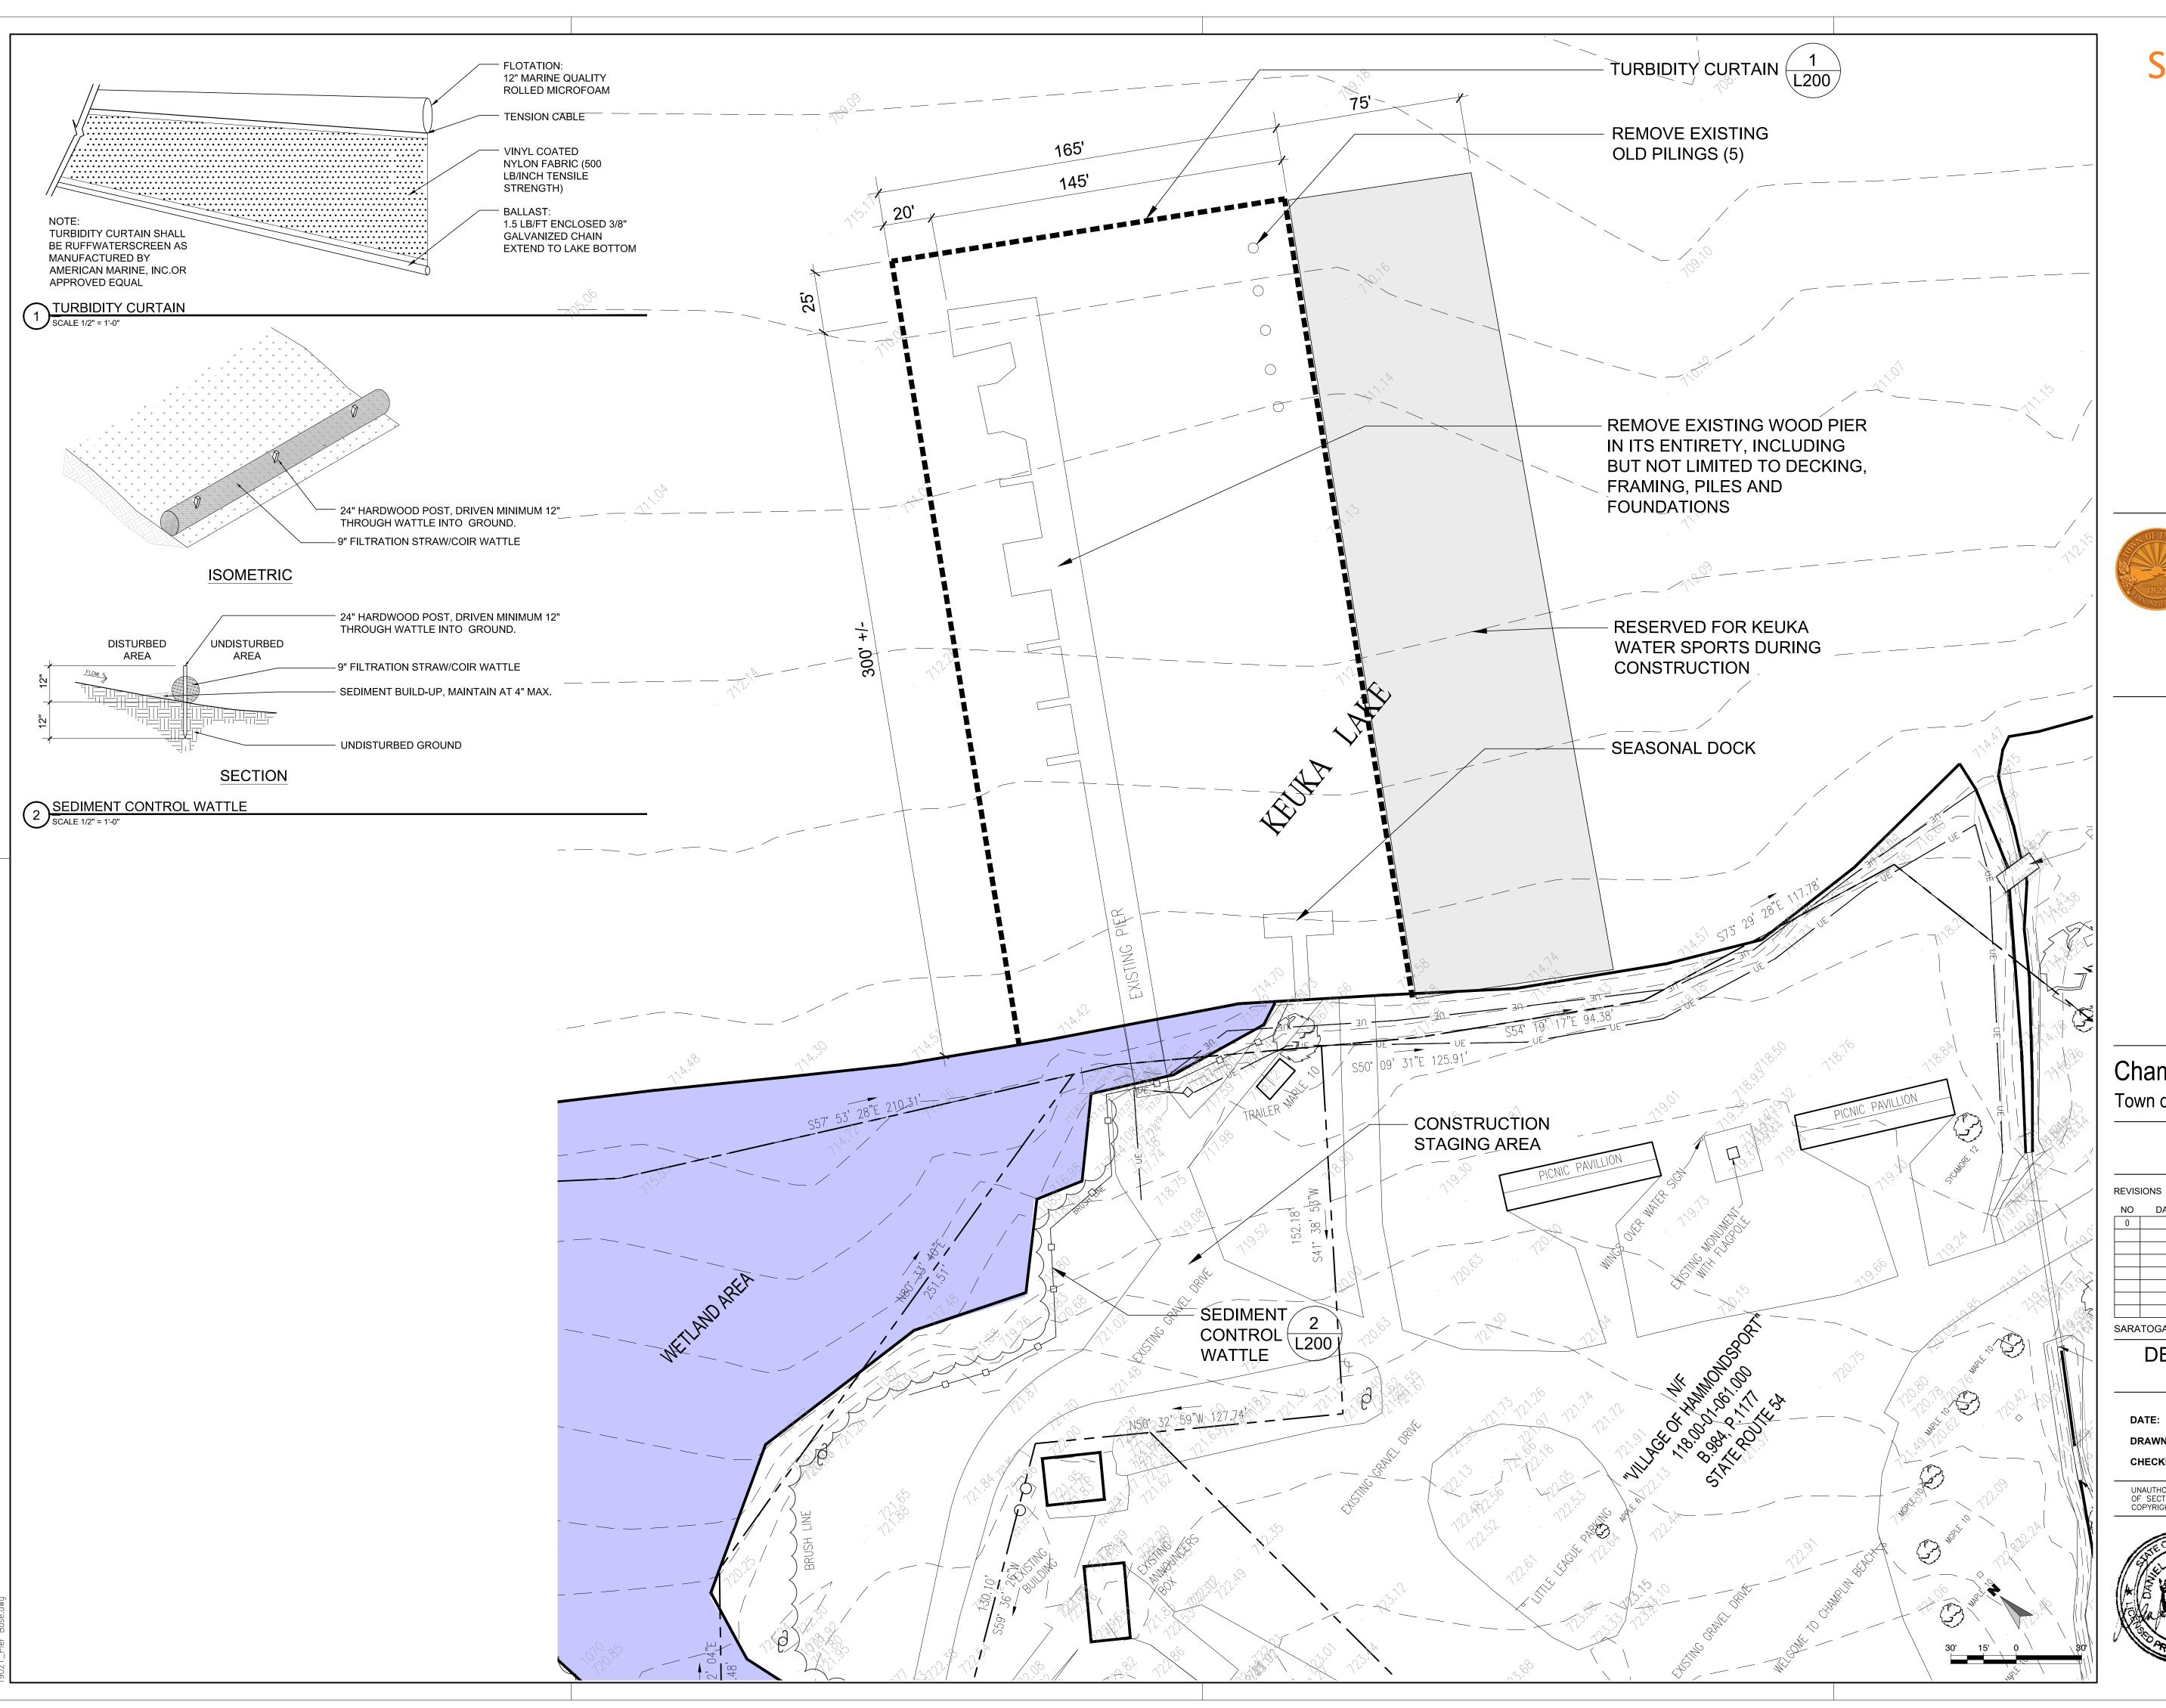
## **EXISTING CONDITIONS PLAN**

DECEMBER 05, 2025

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Town of Urbana Steuben County, New York

8014 Pleasant Valley Rd. Bath NY 1481

Champlin Beach Pier Project Town of Urbana, NY 14840

DESCRIPTION DRAWN CHK 2019-021.10 SARATOGA ASSOCIATES PROJECT # DEMOLITION AND EROSION

**CONTROL PLAN** 

DECEMBER 05, 2025 DRAWN BY: CHECKED BY: DMS

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#### GENERAL NOTES:

- 1. DESIGN SPECIFICATIONS:
- AASHTO LRFD GUIDE SPECIFICATIONS FOR THE DESIGN OF PEDESTRIAN BRIDGES, 2024 (OR CURRENT VERSION)
- AASHTO LRFD BRIDGE DESIGN SPECIFICATIONS WITH ALL PROVISIONS IN EFFECT AS OF FEB. 2024 (OR CURRENT VERSION)
- 2. LIVE LOAD (15' PIER & 10' EXTENSION): AASHTO H5 VEHICLE OR PEDESTRIAN LOAD = 90 PSF, WHICHEVER HAS THE GREATER EFFECT.
- 3. LIVE LOAD (END OF MAIN DOCK AT OCTAGONAL END) SHALL HAVE A 150 PSF LIVE LOAD & 150 PSF DEAD LOAD
- 4. LIVE LOAD (4' DOCKS): PEDESTRIAN LOAD = 90SPF.
- 5. CONSTRUCTION AND MATERIAL SPECIFICATIONS: STANDARD SPECIFICATIONS, CONSTRUCTION AND MATERIALS, NEW YORK STATE DEPARTMENT OF TRANSPORTATION, OFFICE OF ENGINEERING - CURRENT EDITION.
- 6. DETAILS ON THE DRAWINGS LABELED AS "NOT TO SCALE" ARE INTENTIONALLY DRAWN NOT TO SCALE FOR VISUAL CLARITY. ALL OTHER DETAILS FOR WHICH NO SCALE IS SHOWN ARE DRAWN PROPORTIONALLY AND ARE FULLY DIMENSIONED
- 7. ALL SHOP DRAWINGS SUBMITTED FOR THIS PROJECT SHALL BE IN US CUSTOMARY UNITS
- 8. THE LOAD RATINGS ARE IN ACCORDANCE WITH THE AASHTO MANUAL FOR BRIDGE EVALUATION
- 9. ALL DRAWINGS AND CALCULATIONS SUBMITTED BY THE CONTRACTOR FOR ENGINEER REVIEW SHALL BE IN PDF FORMAT AND SHALL BE EITHER 8.5" X 11" OR 11" X 17" WITH TEXT SIZE NO SMALLER THAN 16" SUBMISSIONS ILLEGIBLE WHEN PRINTED ON PAPER WILL BE REJECTED. FULL SIZE AND PAPER SUBMISSIONS SHALL NOT BE ACCEPTED OR REVIEWED. ALL DRAWINGS AND CALCULATIONS SHALL NOTE THE DESIGNER AND CHECKER. THE DESIGNER SHALL NOT CHECK THEIR OWN WORK. 11" X 17" DRAWINGS SHALL HAVE A BLANK SPACE THAT IS EITHER 2.5" X 5.5" OR 3.5" X 3.5" FOR PLACEMENT OF THE REVIEWER'S STAMP. 8.5" X 11" DRAWINGS SHALL HAVE AN APPROVAL COVER SHEET IF SPACE FOR THE STAMP DOES NOT FIT ON THE ACTUAL
- 10. BEARING ANCHOR BOLTS SHALL BE SNUG TIGHT
- 11. ALL PLACEMENTS OF SELECT STRUCTURAL FILL, SHALL BE COMPACTED TO 95 PERCENT OF STANDARD PROCTOR MAXIMUM DENSITY. NO FILL SHALL BE PLACED WITHIN THE WETLAND BOUNDARIES.

#### STRUCTURAL STEEL NOTES:

- 1. ALL STRUCTURAL STEEL SHALL BE GALVANIZED AND CONFORM TO ASTM A992 GRADE 50, ASTM A36 GRADE 36 AND ASTM A252 GRADE 3 STEEL
- 2. ALL STEEL, BOLTS, NUTS AND WASHERS SHALL BE GALVANIZED IN ACCORDANCE WITH THE NEW YORK STATE STEEL CONSTRUCTION MANUAL
- 3. DIMENSIONS FOR THICKNESS OF STEEL ROLLED SHAPES ARE SHOWN ACCORDING TO THE AISC MANUAL
- 4. THE EXISTING PIER REMOVAL & PROPOSED PIER STRUCTURES (ADD ALTERNATE # 1, 2 & 3) ARE A DELEGATED DESIGN; THE CONTRACTOR SHALL PROVIDE ENGINEERING FOR ALL PHASES OF DESIGN, ERECTION, AND CONSTRUCTION. THE DESIGN METHODS USED BY THE CONTRACTOR SHALL BE DOCUMENTED ON THE ERECTION DRAWINGS WITH ALL SUPPORTING STABILITY CALCULATIONS SUBMITTED AND STAMPED BY A LICENSED AND REGISTERED NEW YORK STATE PROFESSIONAL ENGINEER. THE METHODOLOGY FOR REMOVAL OF THE EXISTING PIER SHALL MINIMIZE THE DISTURBANCE OF THE LAKEBED AND THE APPROACH FOR THE REMOVAL SHALL DOCUMENTED AND PRESENTED TO THE ENGINEER OF RECORD FOR APPROVAL.
- 5. THE PROPOSED PIER (ADD ALTERNATE # 1, 2 & 3) SHALL BE CONSTRUCTED OF A COMBINATION OF STEEL/ WOOD AND/OR WOOD CONTRUCTION WITH IPE DECKING AND SHALL HAVE A WARRANTY OF 50 YEARS AS SHOWN ON THE BID DOCUMENTS & AS OUTLINED BY THE OWNER.

#### RAILING NOTES (ADD ALTERNATE #3):

1. ALL RAILING IS TO BE FABRICATED AND ERECTED SO THAT THE RAILS ARE PARALLEL TO EACH OTHER

2. TUBULAR STEEL RAILS, NUTS AND WASHERS AND CARRIAGE BOLTS TO BE PAID FOR UNDER THE RAILING ITEM.

3. RAIL SHALL SPAN A MINIMUM OF 3 POSTS, EXCEPT AT THE END OF THE PIER RAILING WHERE THE RAIL MAY SPAN A MINIMUM OF 2 POSTS.

4. ALL RAILINGS BY OTHERS & APPROVED BY OWNER.

#### TIMBER DECKING NOTES:

- 1. DECKING FOR THE PIER SHALL BE IPE WOOD. ALL WOOD DECKING SHALL MEET THE FOLLOWING MINIMUM REQUIREMENTS FOR MECHANICAL PROPERTIES (PER USDA WOOD HANDBOOK):
- MODULUS OF RUPTURE = 22,600 PSI SHEAR STRENGTH PARALLEL TO GRAIN = 2.060 PSI
- MODULUS OF ELASTICITY = 2,900,000 PSI
- 2. EXTREME FIBER IN BENDING AND TENSION SHALL BE PARALLEL TO GRAIN
- 3. COMPRESSION IS PERPENDICULAR TO GRAIN
- 4. PRESERVATIVE TREATMENTS MUST COMPLY WITH NYSDOT SPECIFICATION SECTION 708-31, AITC 117 AND AITC 190.1
- 5. COAT ALL END GRAIN SECTIONS WITH ANCHORSEAL 2 BY U-C COATINGS OR EQUAL
- 6. STAIN / SEALER ONE COAT, FACTORY APPLIED, TRANSLUCENT PENETRATING STAIN/SEALER PER AITC 111

#### DESIGN PARAMETERS:

- MINIMUM DESIGN LOADS FOR BUILDING AND OTHER STRUCTURES (ASCE 7-22) - AASHTO LRFD GUIDE SPECIFICATIONS FOR THE DESIGN OF PEDESTRIAN BRIDGES, CURRENT EDITION - AASHTO LRFD BRIDGE DESIGN SPECIFICATIONS WITH ALL PROVISIONS IN EFFECT

- PEDESTRIAN 90 PSF (PER AASHTO) H−5 DESIGN VEHICLE (PER AASHTO) – VEHICLE:

3. SNOW LOADS:

- GROUND SNOW LOAD (Pg):

35 PSF (PER FIGURE 7-1 IN ASCE 7-22) 1 (RISK CATEGORY II PER TABLE 1-5.1 IN ASCE 7-22)

- SNOW IMPORTANCE FACTOR (Is): - SNOW EXPOSURE FACTOR (Ce):

0.9 (PER TABLE 7-2 IN ASCE 7-22, FULLY-EXPOSED AND EXPOSURE TYPE B) 1.2 (PER TABLE 7-3 IN ASCE 7-22, UNHEATED / OPEN AIR STRUCTURES)

B (PER TABLES 11.6-1 & 11.6-2 IN ASCE 7-22)

- THERMAL FACTOR (Ct):

- FLAT ROOF SNOW LOAD (Pf): 26.46 PSF (PER EQUATION 7.3-1 IN ASCE 7-22)

- THE BRIDGE & BOARDWALK SHALL BE DESIGNED FOR A MINIMUM WIND LOAD OF 25 PSF

- WIND LOAD SHALL BE CALCULATED OVER THE ENTIRE VERTICAL STRUCTURE OF THE BRIDGE & BOARWALK AS IF FULLY ENCLOSED 5. EARTHQUAKE LOADS: - SEISMIC IMPORTANCE FACTOR (Ie): 1 (RISK CATEGORY II PER TABLE 1-5.1 IN ASCE 7-22)

D (PER SECTION 11.4.2 IN ASCE 7-22) SITE CLASS: - SPECTRAL RESPONSE ACCELERATION (Ss): 0.150 (PER FIGURE 22-1 IN ASCE 7-22) - SPECTRAL RESPONSE ACCELERATION (S1): 0.060 (PER FIGURE 22-2 IN ASCE 7-22) - SPECTRAL RESPONSE COEFFICIENTS (Sds): 0.213 (PER EQUATION 11.4-3 IN ASCE 7-22)

- SPECTRAL RESPONSE COEFFICIENTS (Sd1): 0.117 (PER EQUATION 11.4-4 IN ASCE 7-22) – SEISMIC DESIGN CATEGORY:

6. SERVICEABILITY CRITERIA:

- NOMINAL WIND LOAD DEFLECTION: - NOMINAL LIVE LOAD DEFLECTION:

NOTE: DEFLECTION IN CANTILEVER ARMS DUE TO PEDESTRIAN LIVE LOADING SHALL NOT EXCEED L/220 (WHERE "L" IS THE CANTILEVER LENGTH)

- FUNDAMENTAL FREQUENCY (VERT. MODE): > 3.0 HZ - FUNDAMENTAL FREQUENCY (LAT. MODE): > 1.3 HZ

#### LAKE PROTECTION NOTES:

1. DURING THE COURSE OF CONSTRUCTION, THE CONTRACTOR SHALL CONDUCT OPERATIONS IN SUCH A MANNER AS TO PREVENT OR REDUCE TO A MINIMUM ANY DAMAGE TO ANY STREAM FROM POLLUTION BY DEBRIS, SEDIMENT, OR OTHER FOREIGN MATERIAL, OR FROM MANIPULATION OF EQUIPMENT AND/OR MATERIALS IN OR NEAR SUCH STREAMS. THE CONTRACTOR SHALL NOT RETURN DIRECTLY TO A STREAM ANY WATER WHICH HAS BEEN USED FOR WASH PURPOSES OR OTHER SIMILAR OPERATIONS WHICH CAUSE THE WATER TO BECOME POLLUTED WITH SAND, SILT, CEMENT, OIL, OR OTHER IMPURITIES. IF THE CONTRACTOR USES WATER FROM A STREAM, THE CONTRACTOR SHALL CONSTRUCT AN INTAKE OR A TEMPORARY DAM REQUIRED TO PROTECT AND MAINTAIN WATER RIGHTS AND TO SUSTAIN FISH LIFE DOWNSTREAM.



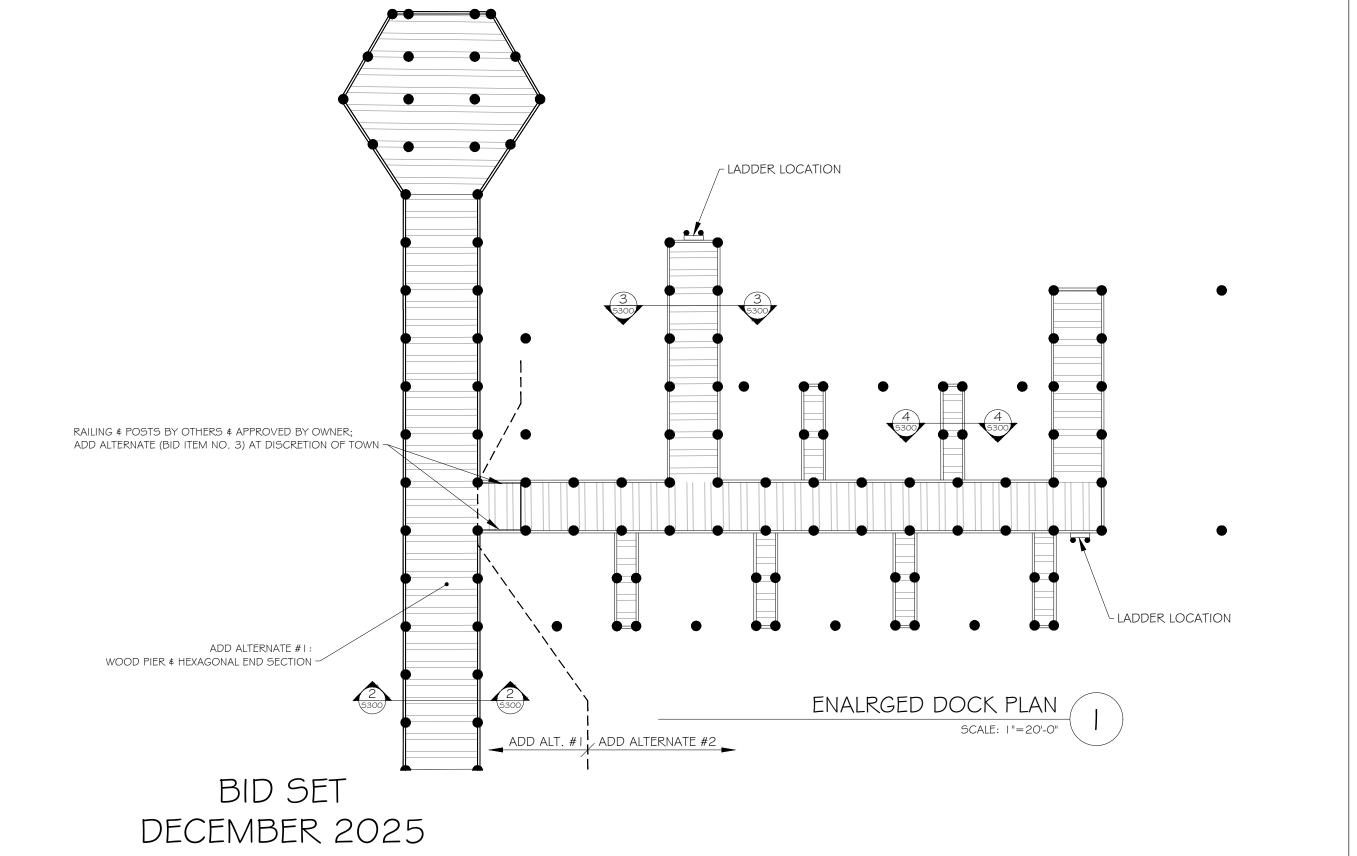
**PROJECT** SITE



#### REQUIRED SPECIAL STRUCTURAL INSPECTIONS

IN ADDITION TO THE REGULAR INSPECTIONS, THE FOLLOWING STRUCTURAL ITEMS REQUIRE SPECIAL INSPECTION IN ACCORDANCE WITH SECTION 1704 OF THE INTERNATIONAL BUILDING CODE. SEE SPECIFICATION SECTION 01415 AND MATERIAL SPECIFICATION SECTIONS FOR SPECIFIC REQUIREMENTS. CONSTRUCTION NOT ASSOCIATED WITH THE STRUCTURAL SYSTEM MAY REQUIRE SPECIAL INSPECTION BUT IS NOT LISTED HERE.

ITEM	SPECIAL INSPECTION REQUIRED	SHOP DRAWING SUBMITTAL	REMARKS
1. SOILS COMPLIANCE PRIOR TO FOUNDATION CONSTRUCTION	YES	NO	REFERENCE BUILDING CODE OF NYS 1705.6 (REFER TO SITE DRAWINGS AND SPECIFICATIONS FOR TESTING AND INSPECTION REQUIREMENTS.
2. STRUCTURAL STEEL FABRICATION	YES	YES	MAY BE OMITTED IF FABRICATOR IS AISC CERTIFIED. REFERENCE BUILDING CODE OF NYS TABLE 1705.2.1
3. STRUCTURAL WELDING	YES	NO	REFERENCE BUILDING CODE OF NYS TABLE 1705.2.1
4. HIGH STRENGTH BOLTING	YES	YES	REFERENCE BUILDING CODE OF NYS TABLE 1705.2.1
5. FABRICATED ITEMS (CUSTOM SEATS FOR PIER)	YES	YES	REFERENCE BUILDING CODE OF NYS SECTION 1705.10. MAY BE OMITTED PER EXEMPTIONS OUTLINED IN SECTION 1704.2.5.
6. DRIVEN DEEP FOUNDATIONS	YES	YES	REFERENCE BUILDING CODE OF NYS TABLE 1705.7



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## Town of Urbana Steuben County, New York

8014 Pleasant Valley Rd. Bath NY 1481

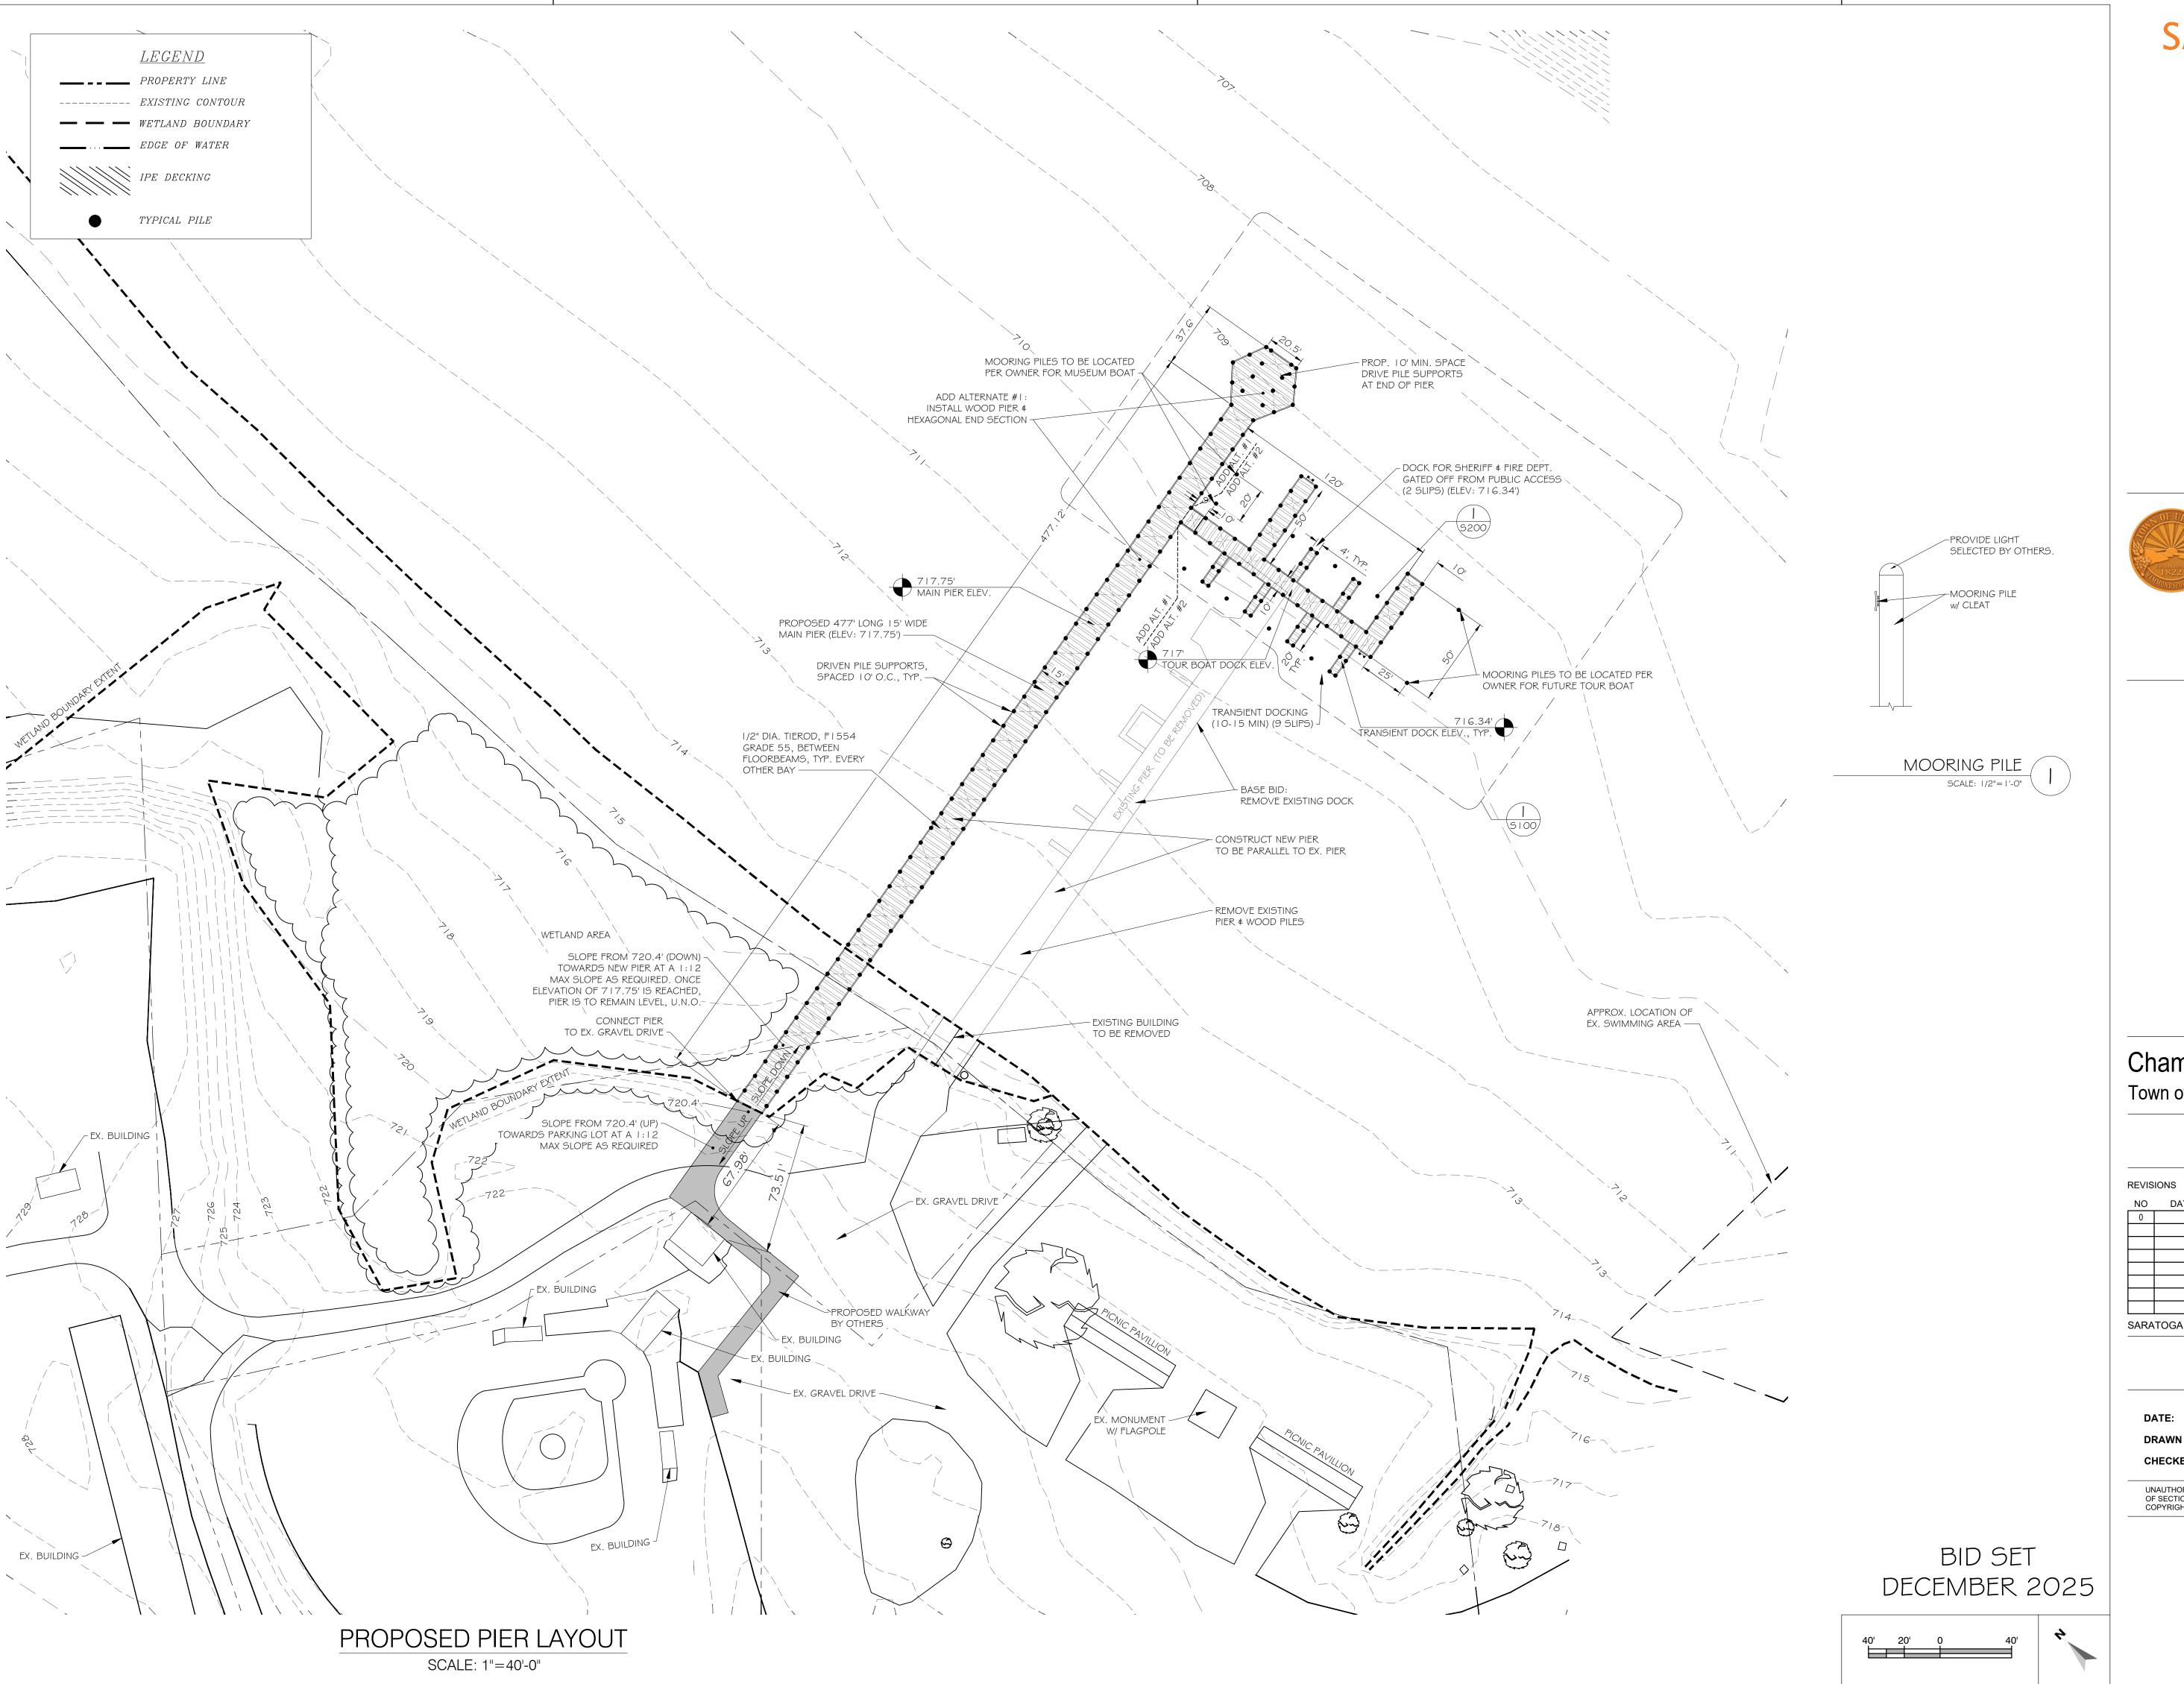
Champlin Beach Pier Project Town of Urbana, NY 14840

REVISIONS DESCRIPTION DRAWN CHK 2019-021.10 SARATOGA ASSOCIATES PROJECT #

NOTES

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Town of Urbana

Steuben County, New York est. 1822

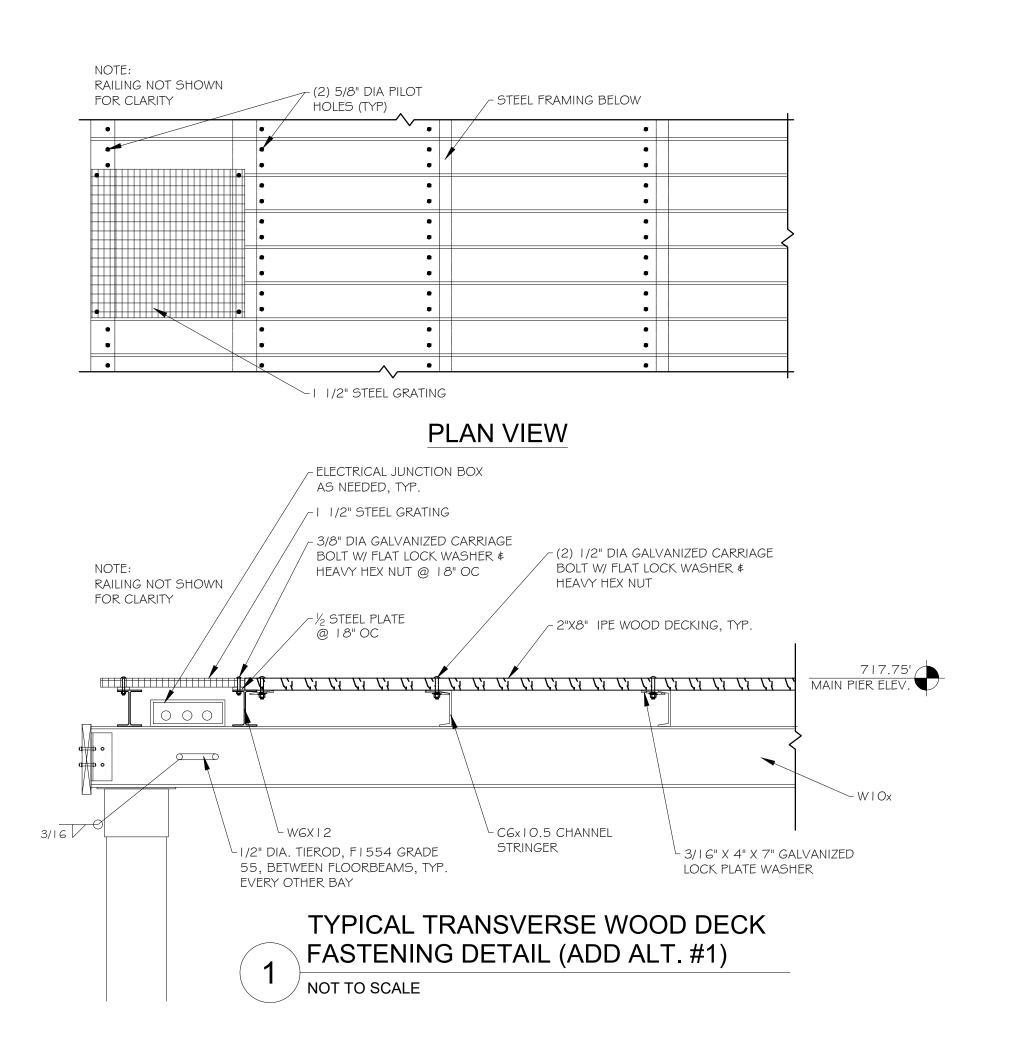
8014 Pleasant Valley Rd. Bath NY 1481

## Champlin Beach Pier Project Town of Urbana, NY 14840

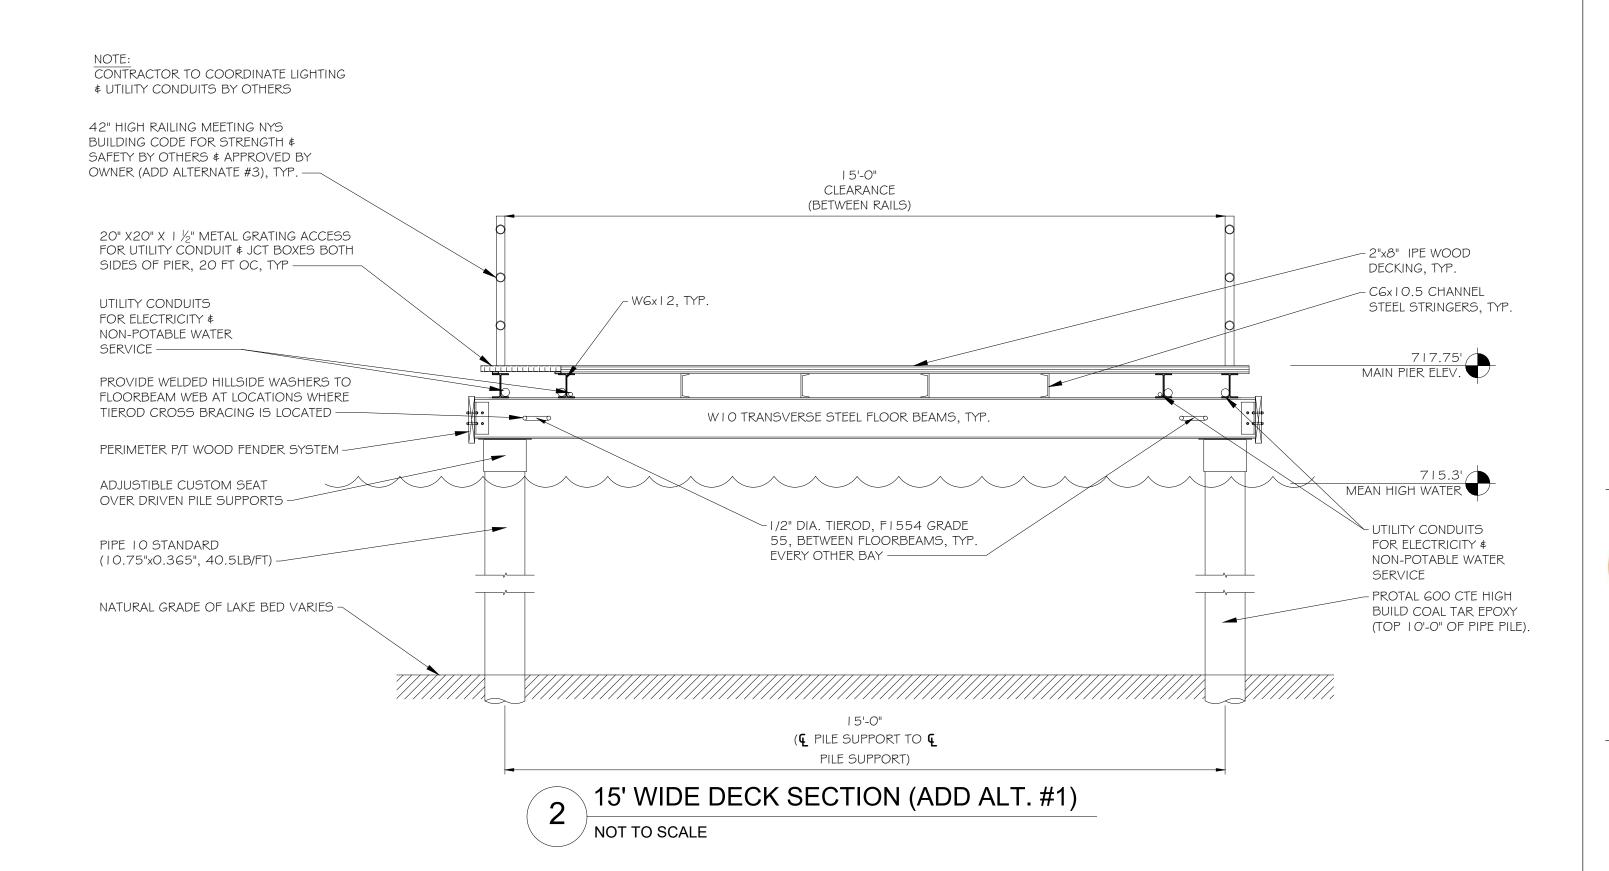
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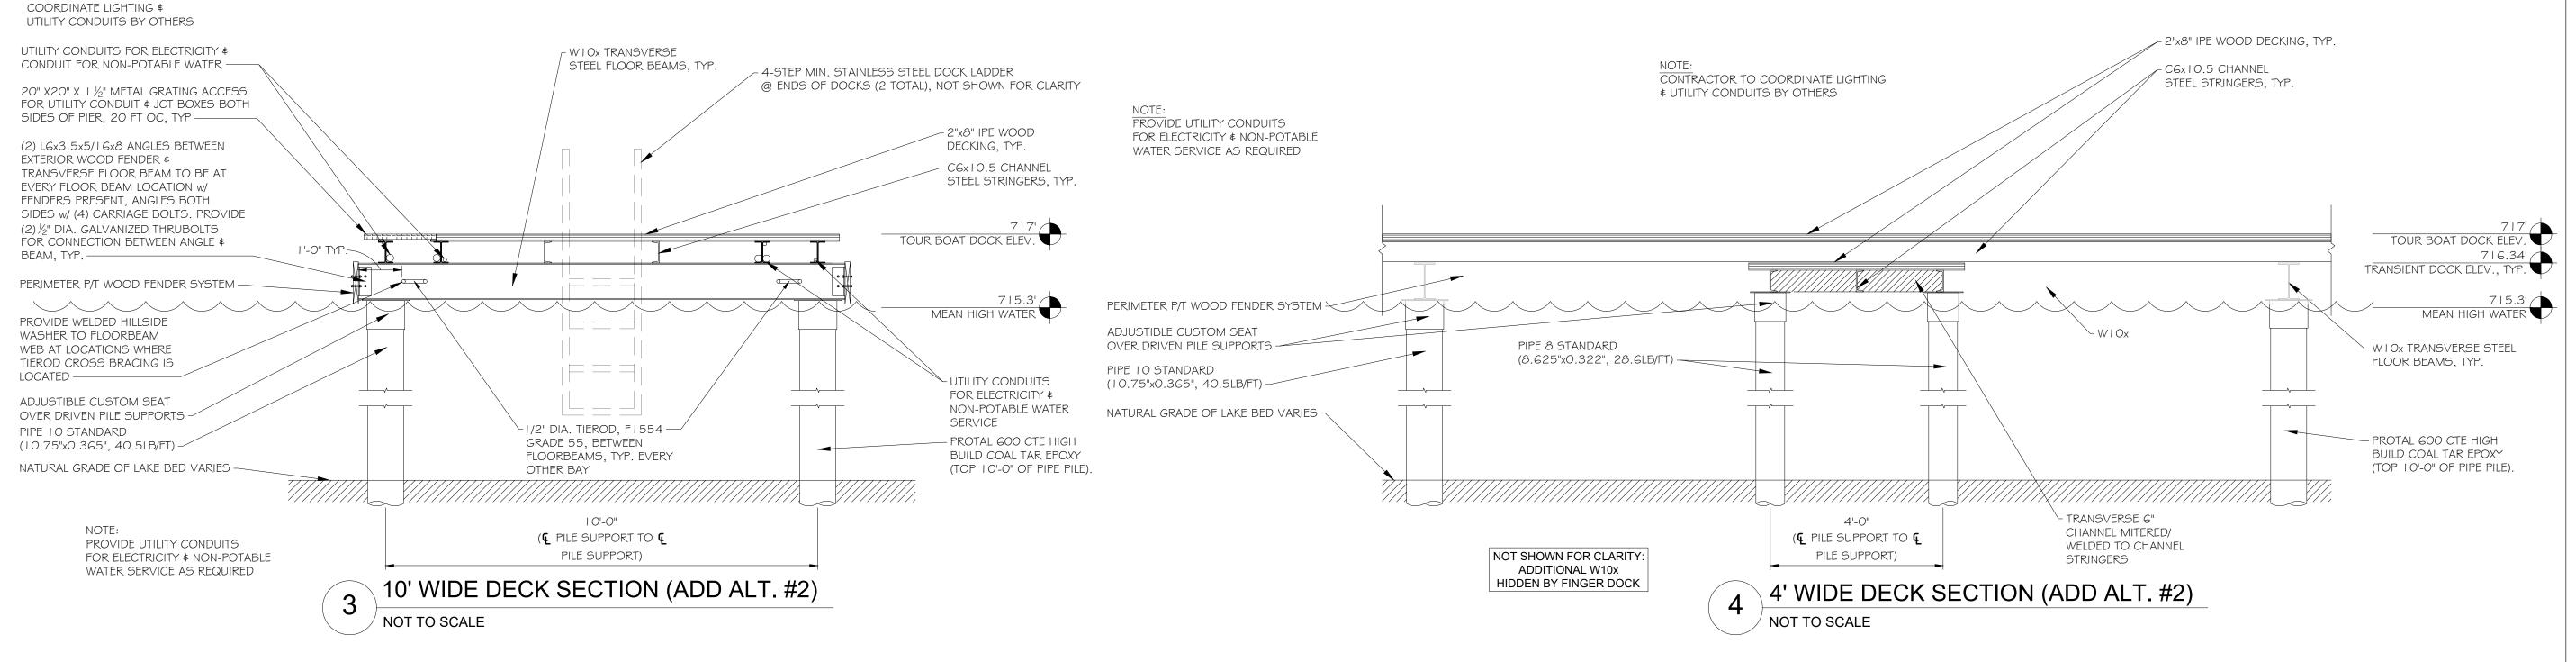
## PROPOSED PIER LAYOUT

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DRAWN BY:	RJM	1"=40'
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CONTRACTOR TO





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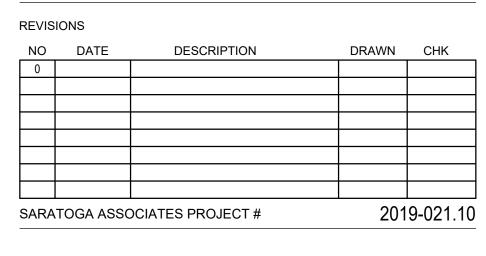
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Town of Urbana
Steuben County, New York

8014 Pleasant Valley Rd. Bath NY 1481

Champlin Beach Pier Project
Town of Urbana, NY 14840



**SECTIONS & DETAILS** 

S300

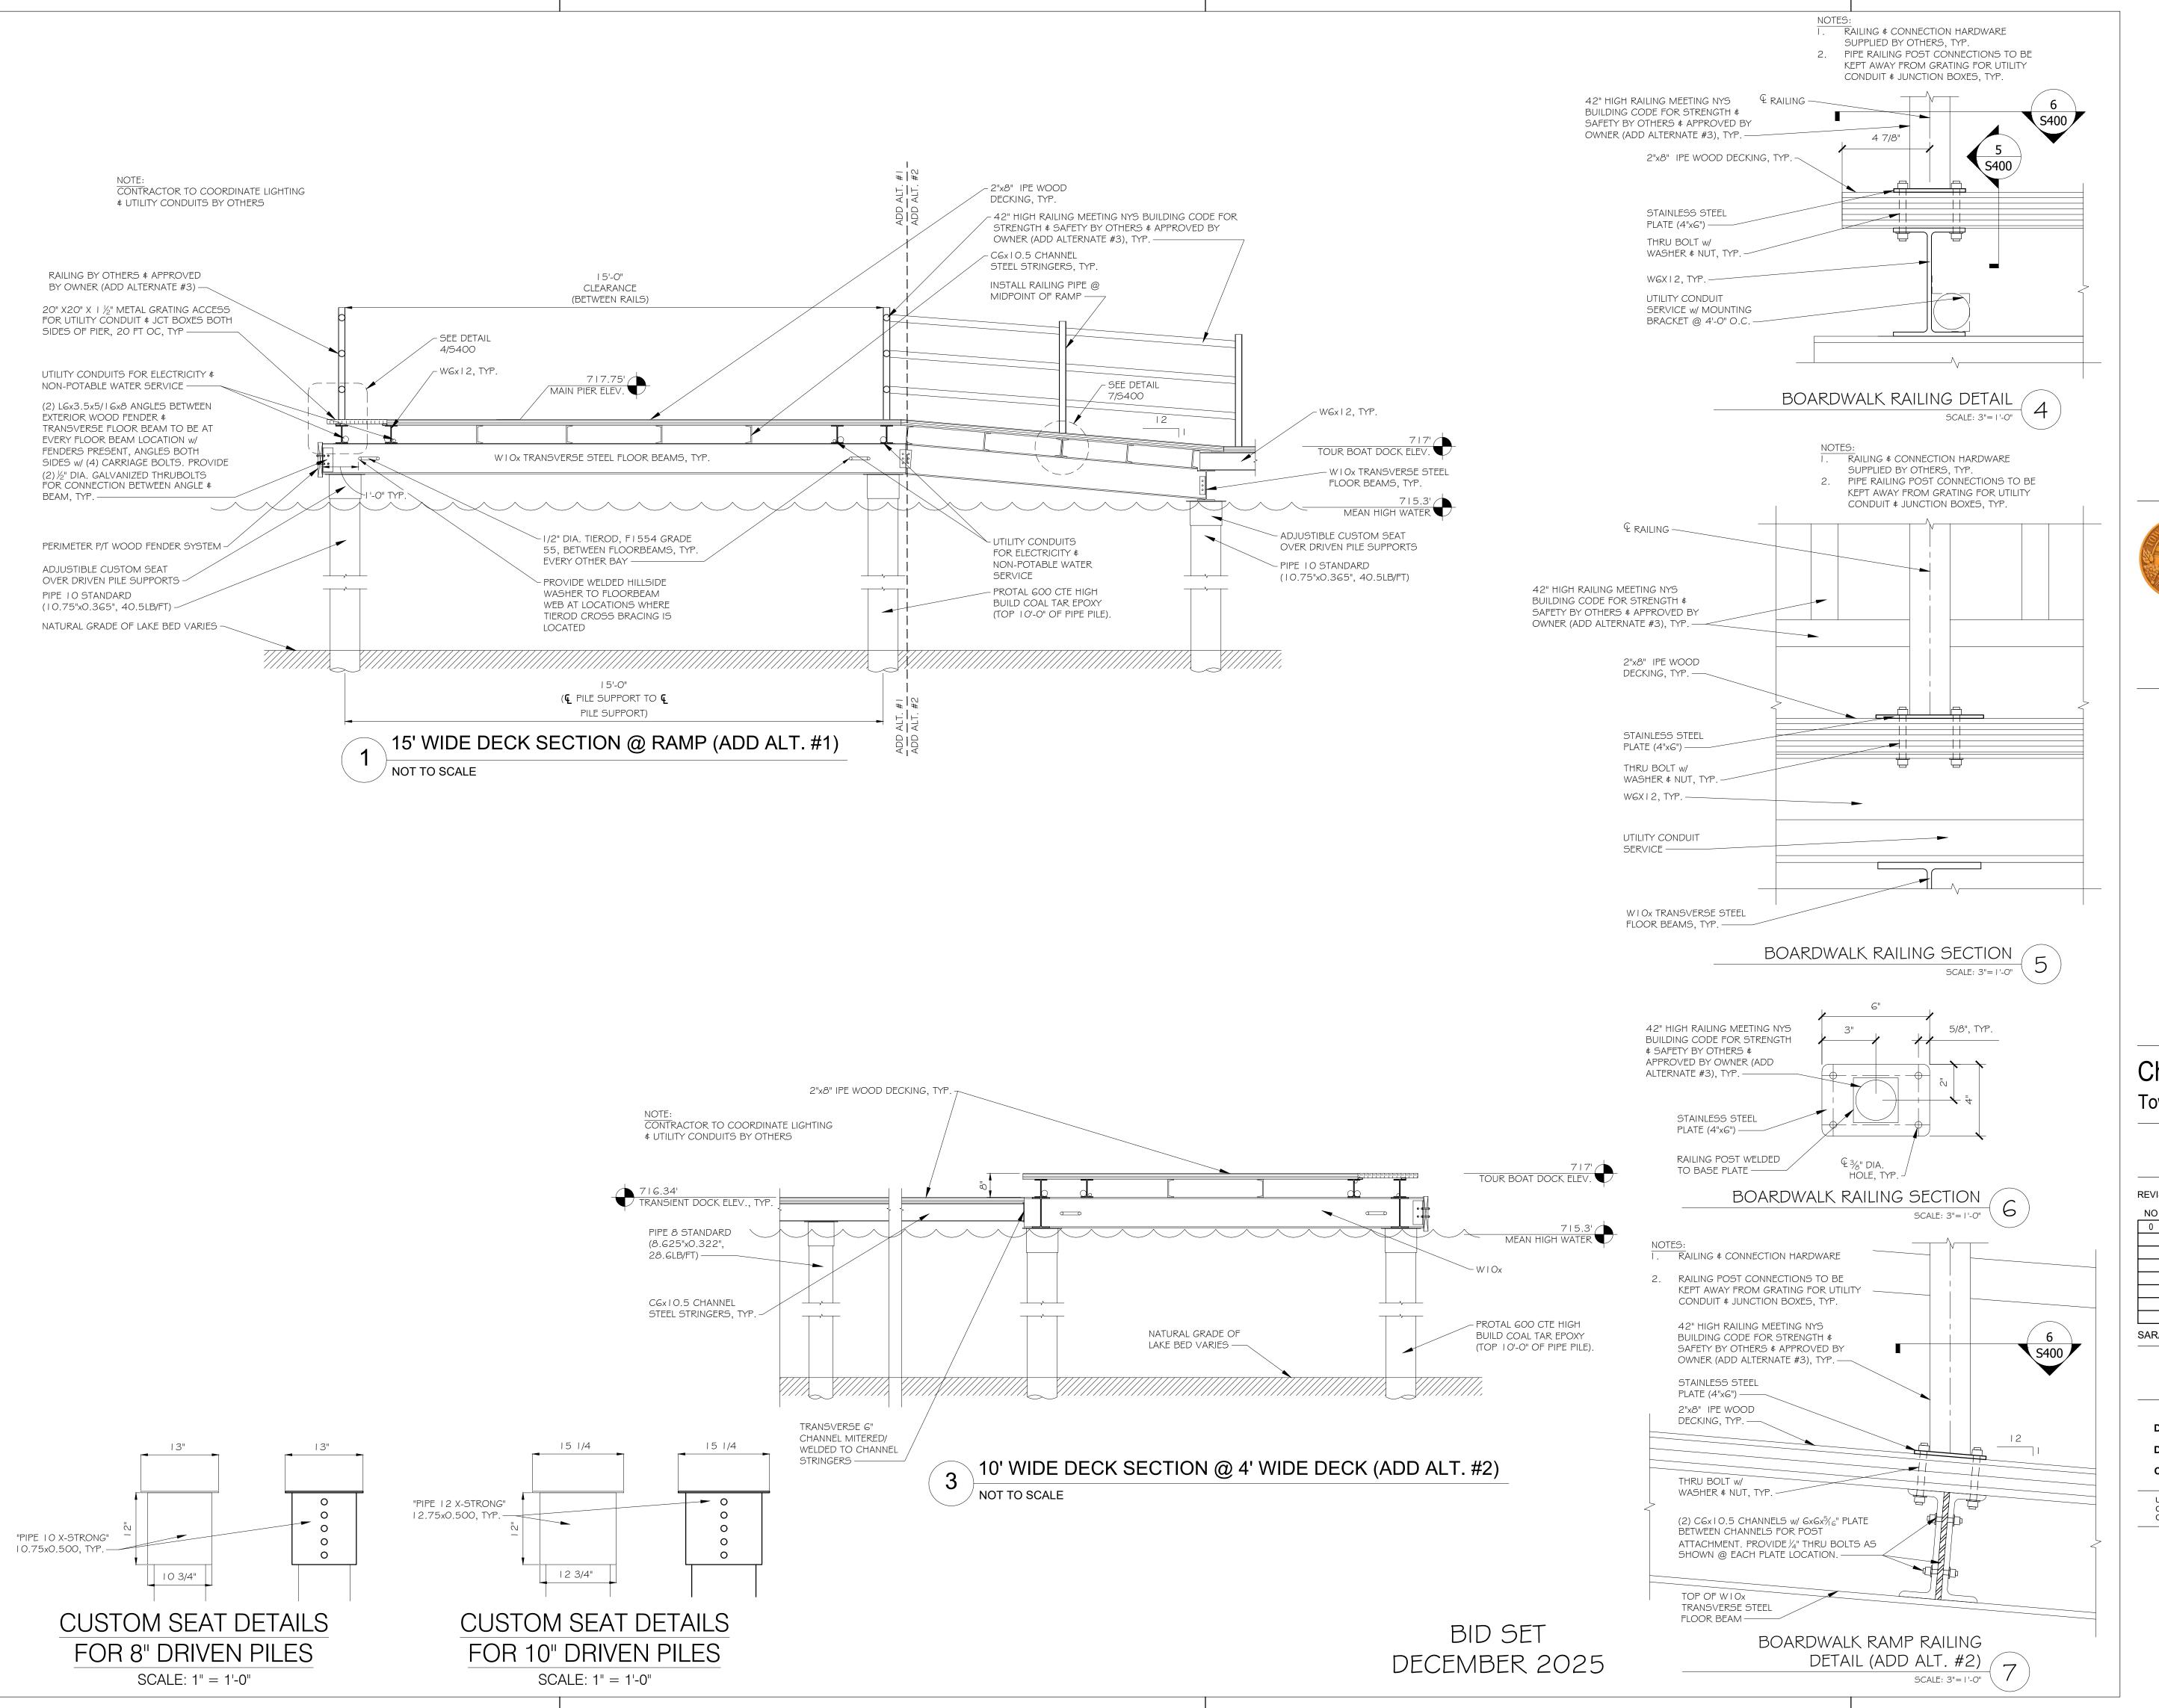
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Town of Urbana Steuben County, New York

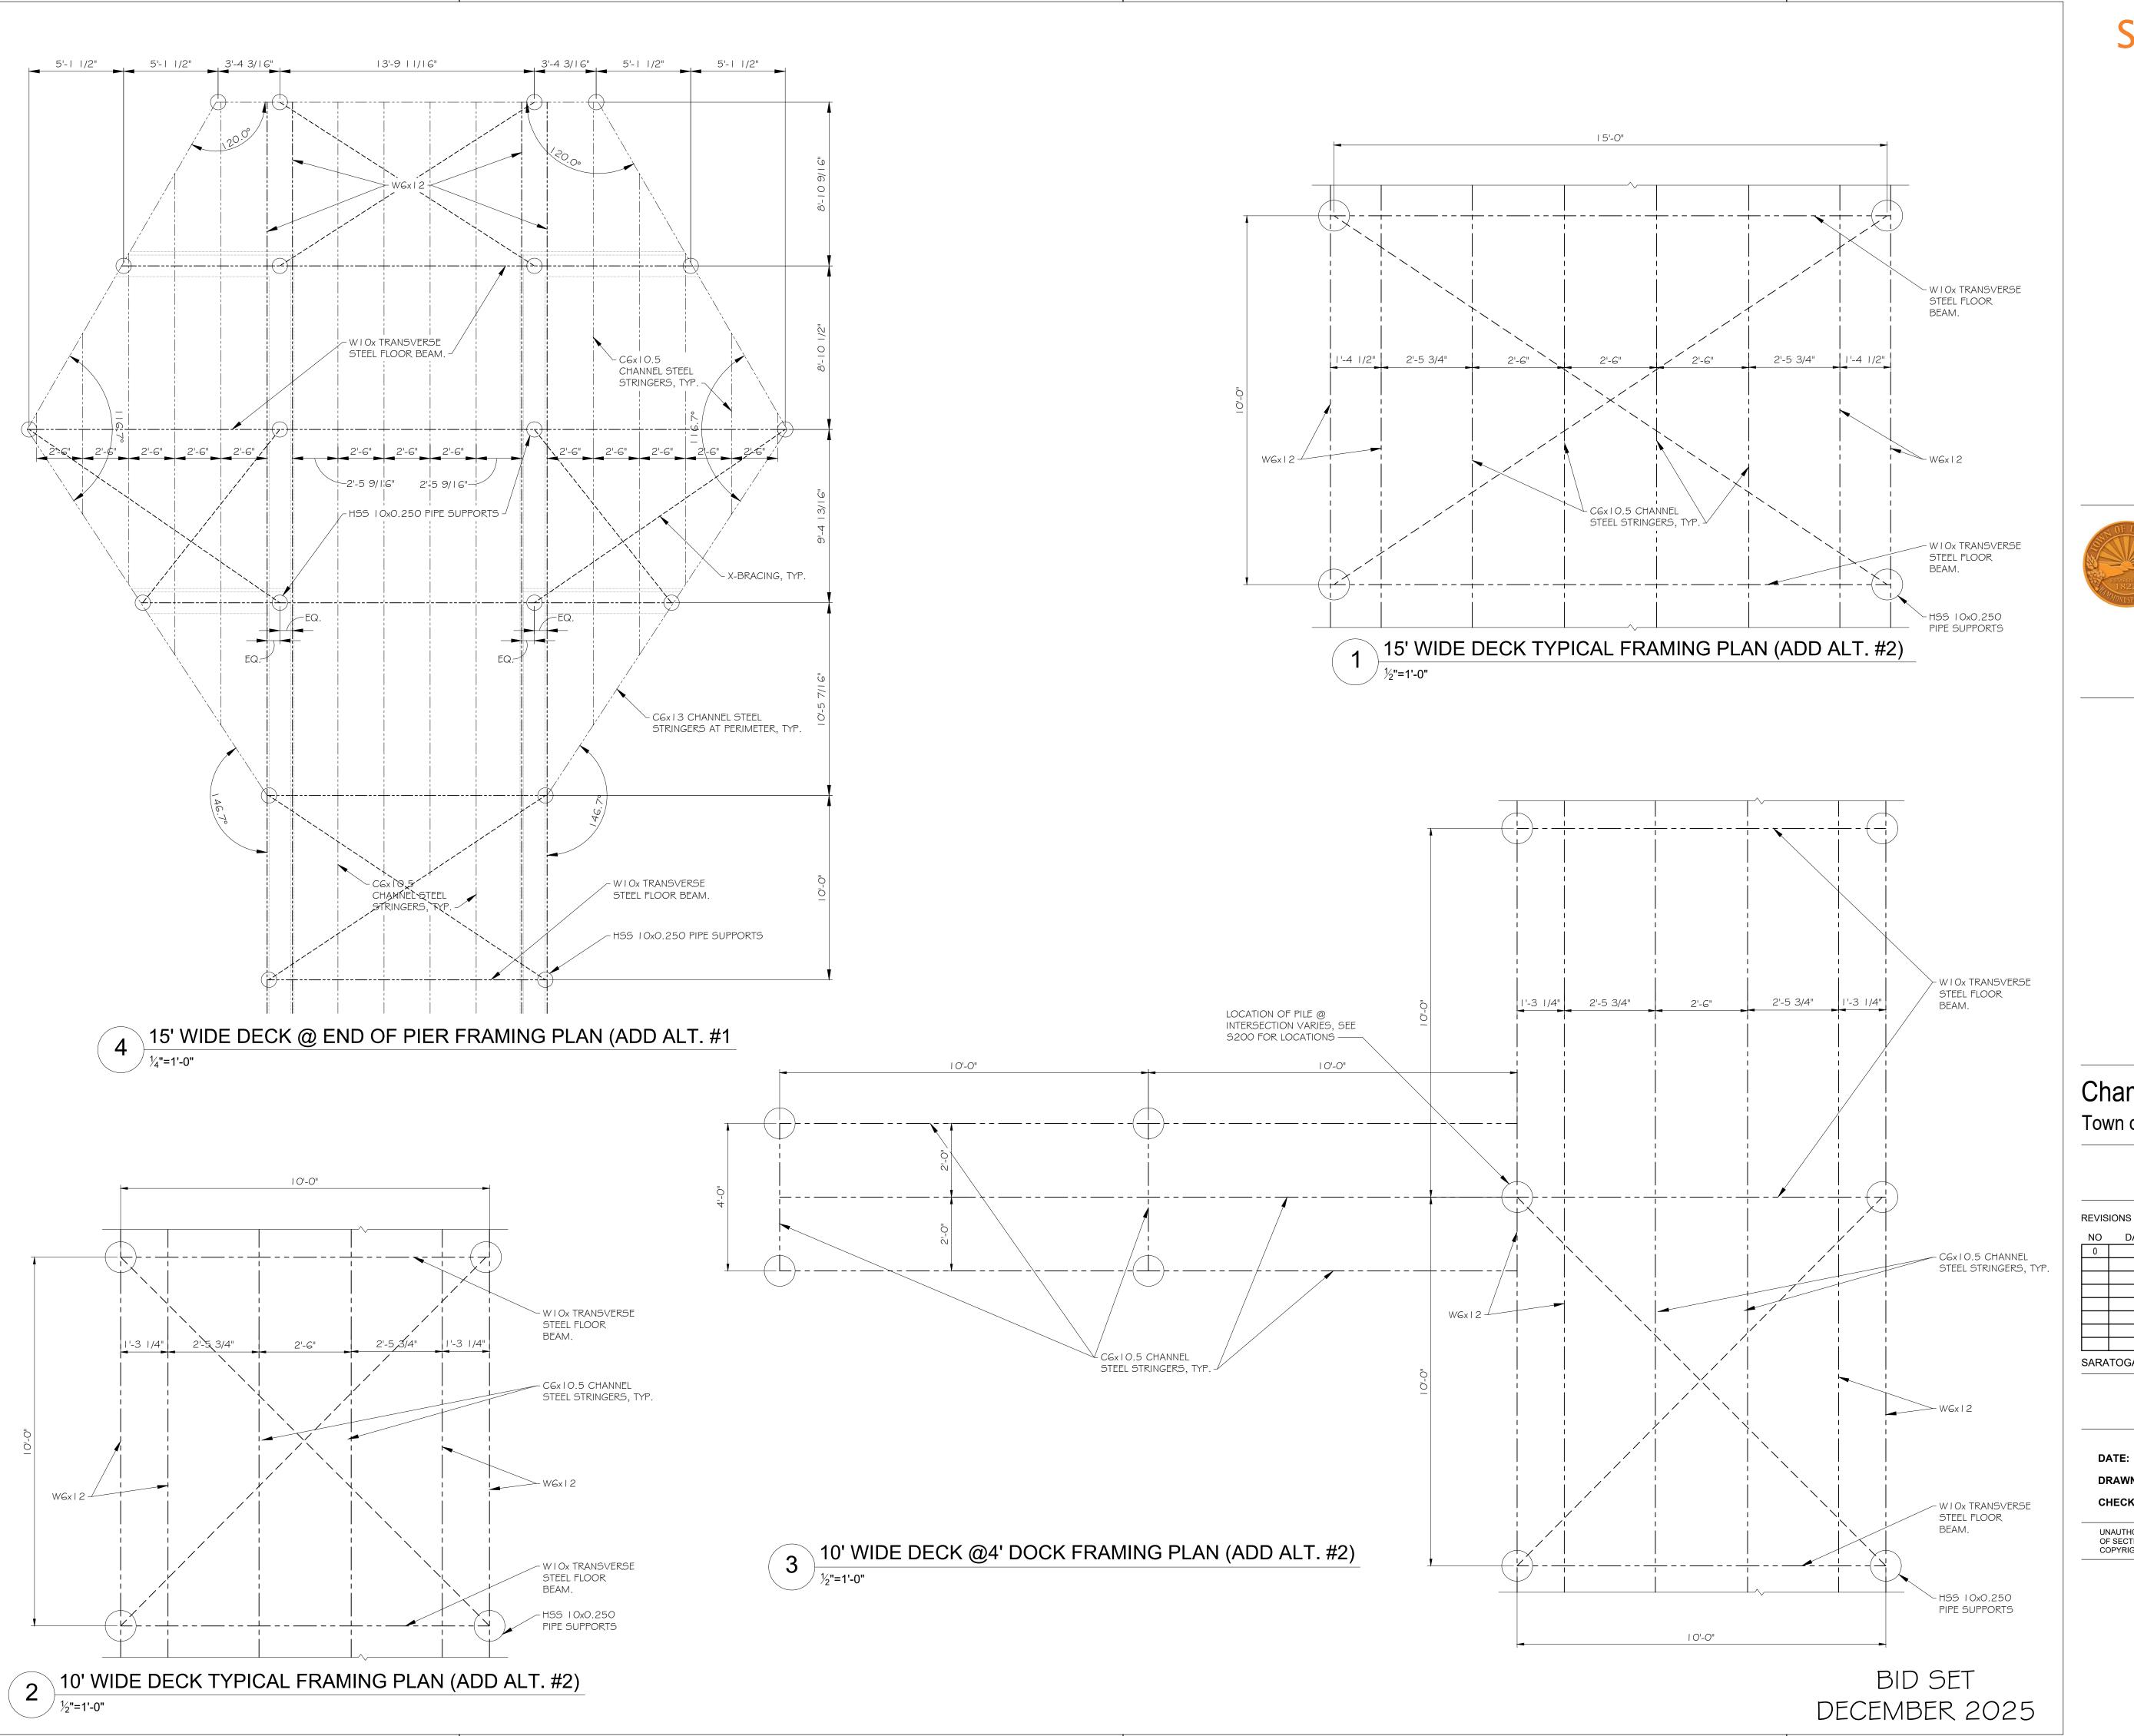
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**SECTIONS & DETAILS** 

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Town of Urbana Steuben County, New York

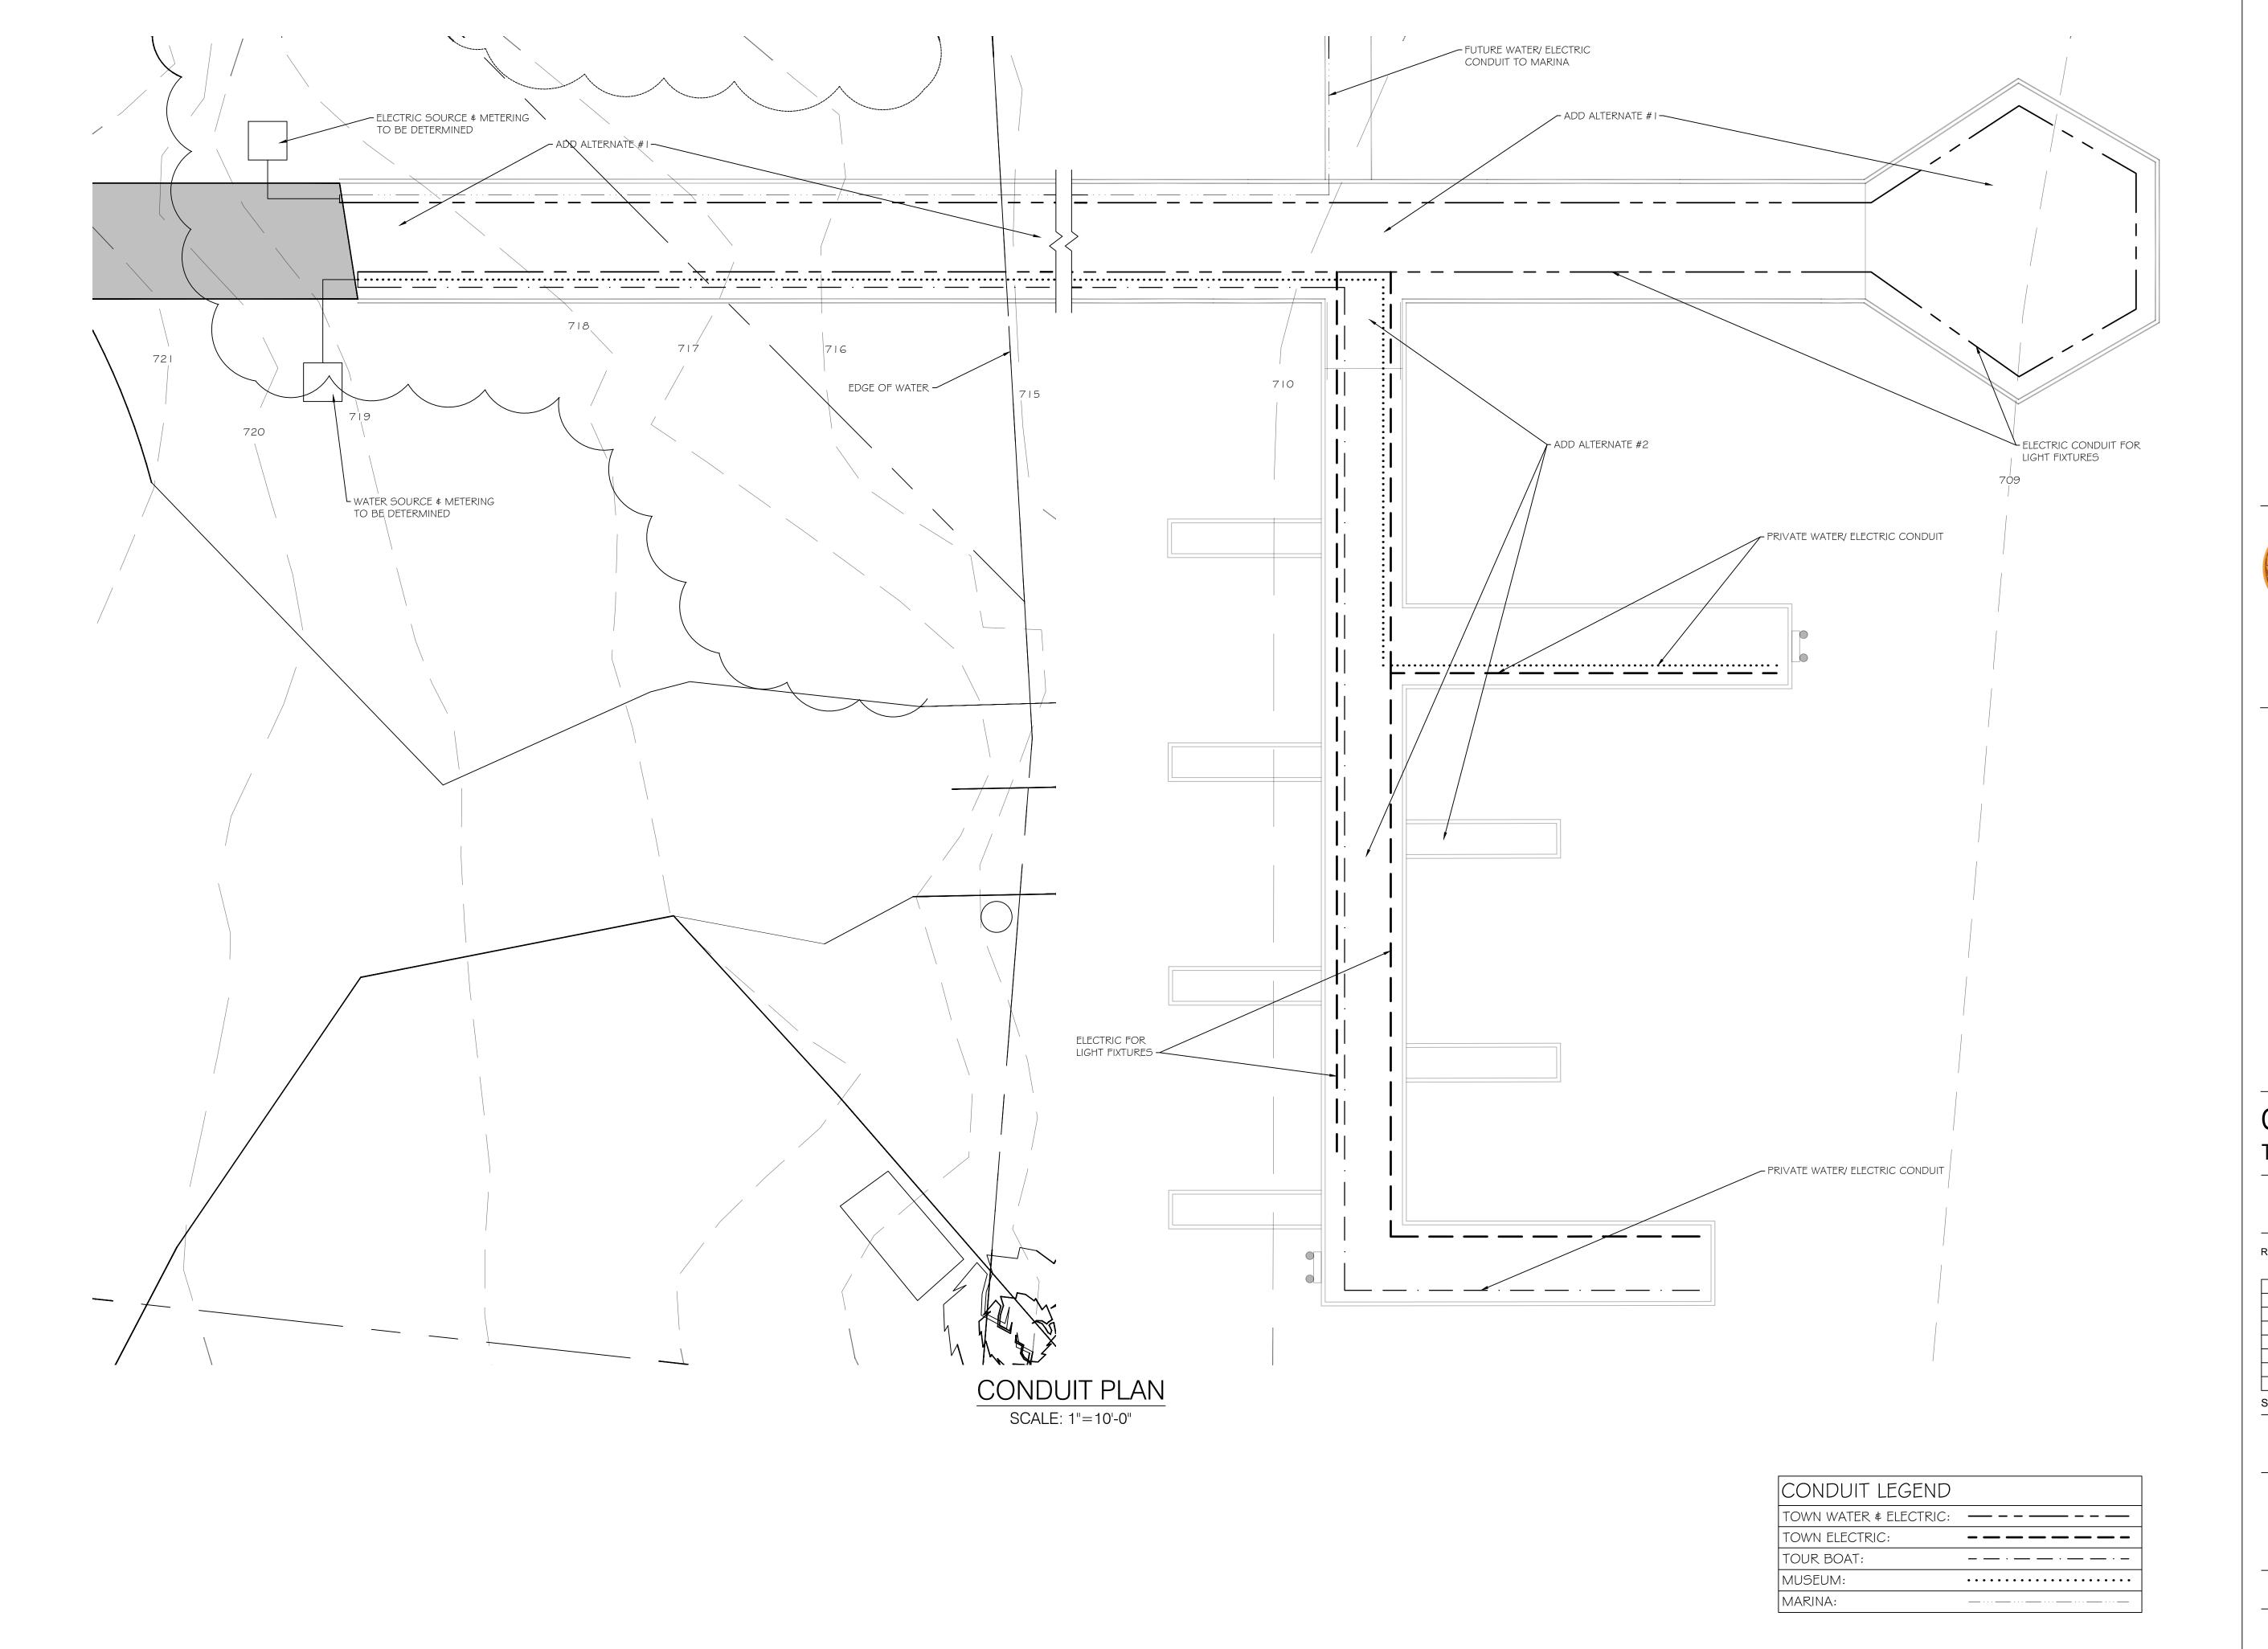
8014 Pleasant Valley Rd. Bath NY 1481

Champlin Beach Pier Project Town of Urbana, NY 14840

REVISIONS DESCRIPTION DRAWN CHK 2019-021.10 SARATOGA ASSOCIATES PROJECT #

FRAMING PLANS

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Town of Urbana Steuben County, New York est. 1822

8014 Pleasant Valley Rd. Bath NY 1481

Champlin Beach Pier Project Town of Urbana, NY 14840

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SARATOGA ASSOCIATES PROJECT #			201	9-021.10

PROPOSED CONDUIT PLAN

S600

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