# HOLTARCHITECTS

CEMENT



HOLT Architects, P.C.

Architects, Planners, and Interior Designers 619 W. State Street, Ithaca, New York 14850 Tel 607.273.7600 www.holt.com

# Peterson Engineering, P.C.

Mechanical, Electrical, and Elevator Engineering 476 East Brighton, Syracuse, New York 13210 Tel 315.476.8311 Fax 315.476.8305

# Elwyn & Palmer Consulting Engineers PLLC

Structural Engineering 950 Danby Road, Suite 201-N, Ithaca, New York 14850 Tel 607.272.5060

# BID SET

# PROJECT LOCATION PLAN Methoral Building and Prints Alternative House Tompkins St. (Route 13) SOUTH CAMPUS PROJECT SITE: Route 28

# SCHEDULE - SHEET LIST

GENERAL

G001 COVER SHEET

G101 FIRST FLOOR OVERALL PLAN
G102 SECOND FLOOR OVERALL PLAN

STRUCTURAL

S100 PARTIAL FIRST FLOOR FRAMING PLAN

S101 MASONRY NOTES, ELEVATIONS, AND DETAILS

ARCHITECTURAL

AG001 GENERAL NOTES AND DOOR SCHEDULE
AD102 PARTIAL SECOND FLOOR DEMOLITION PLAN

A112 OVERALL FLOOR PLAN STRIPING LAYOUT

A113 OVERALL FLOOR PLAN - BLEACHERS EXTENDED
A114 ENLARGED COURT STRIPING LAYOUTS

251 INTERIOR ELEVATIONS

A551 ELEVATOR PLANS AND SECTIONS

MECHANICAL / ELECTRICAL

E001 ELECTRICAL NOTES AND SCHEDULES
M001 MECHANICAL NOTES AND SCHEDULES
ME100 MECHANICAL / ELECTRICAL PLANS

ELEVATOR

V001 PLATFORM LIFT PLAN, NOTES, & SCHEDULE

BLEACHERS

KP01 KEY PLAN

FP01 PLAN OF SEATING BANK A (WEST)

PLAN OF SEATING BANK B (EAST)

SECTION VIEWS BANK A (WEST)

SC02 SECTION VIEWS BANK B (EAST)

SC03 SECTION VIEWS BANK A (WEST)

# PROJECT INFORMATION

DATE: 07/03/2025

HOLT JOB NUMBER: 24092

SUNY CORTLAND JOB NUMBER: 20240031


CONSTRUCTION CLASSIFICATION: TYPE IIB

SPRINKLER PROTECTION: NON-SPRINKLERED


BUILDING USE CLASSIFICATION: (A-5) ASSEMBLY


ALTERATION LEVEL: LEVEL 2


AREA OF RENOVATION (SF): 23,600

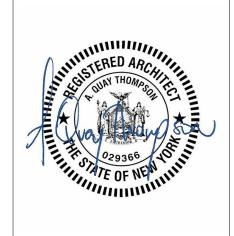



G001

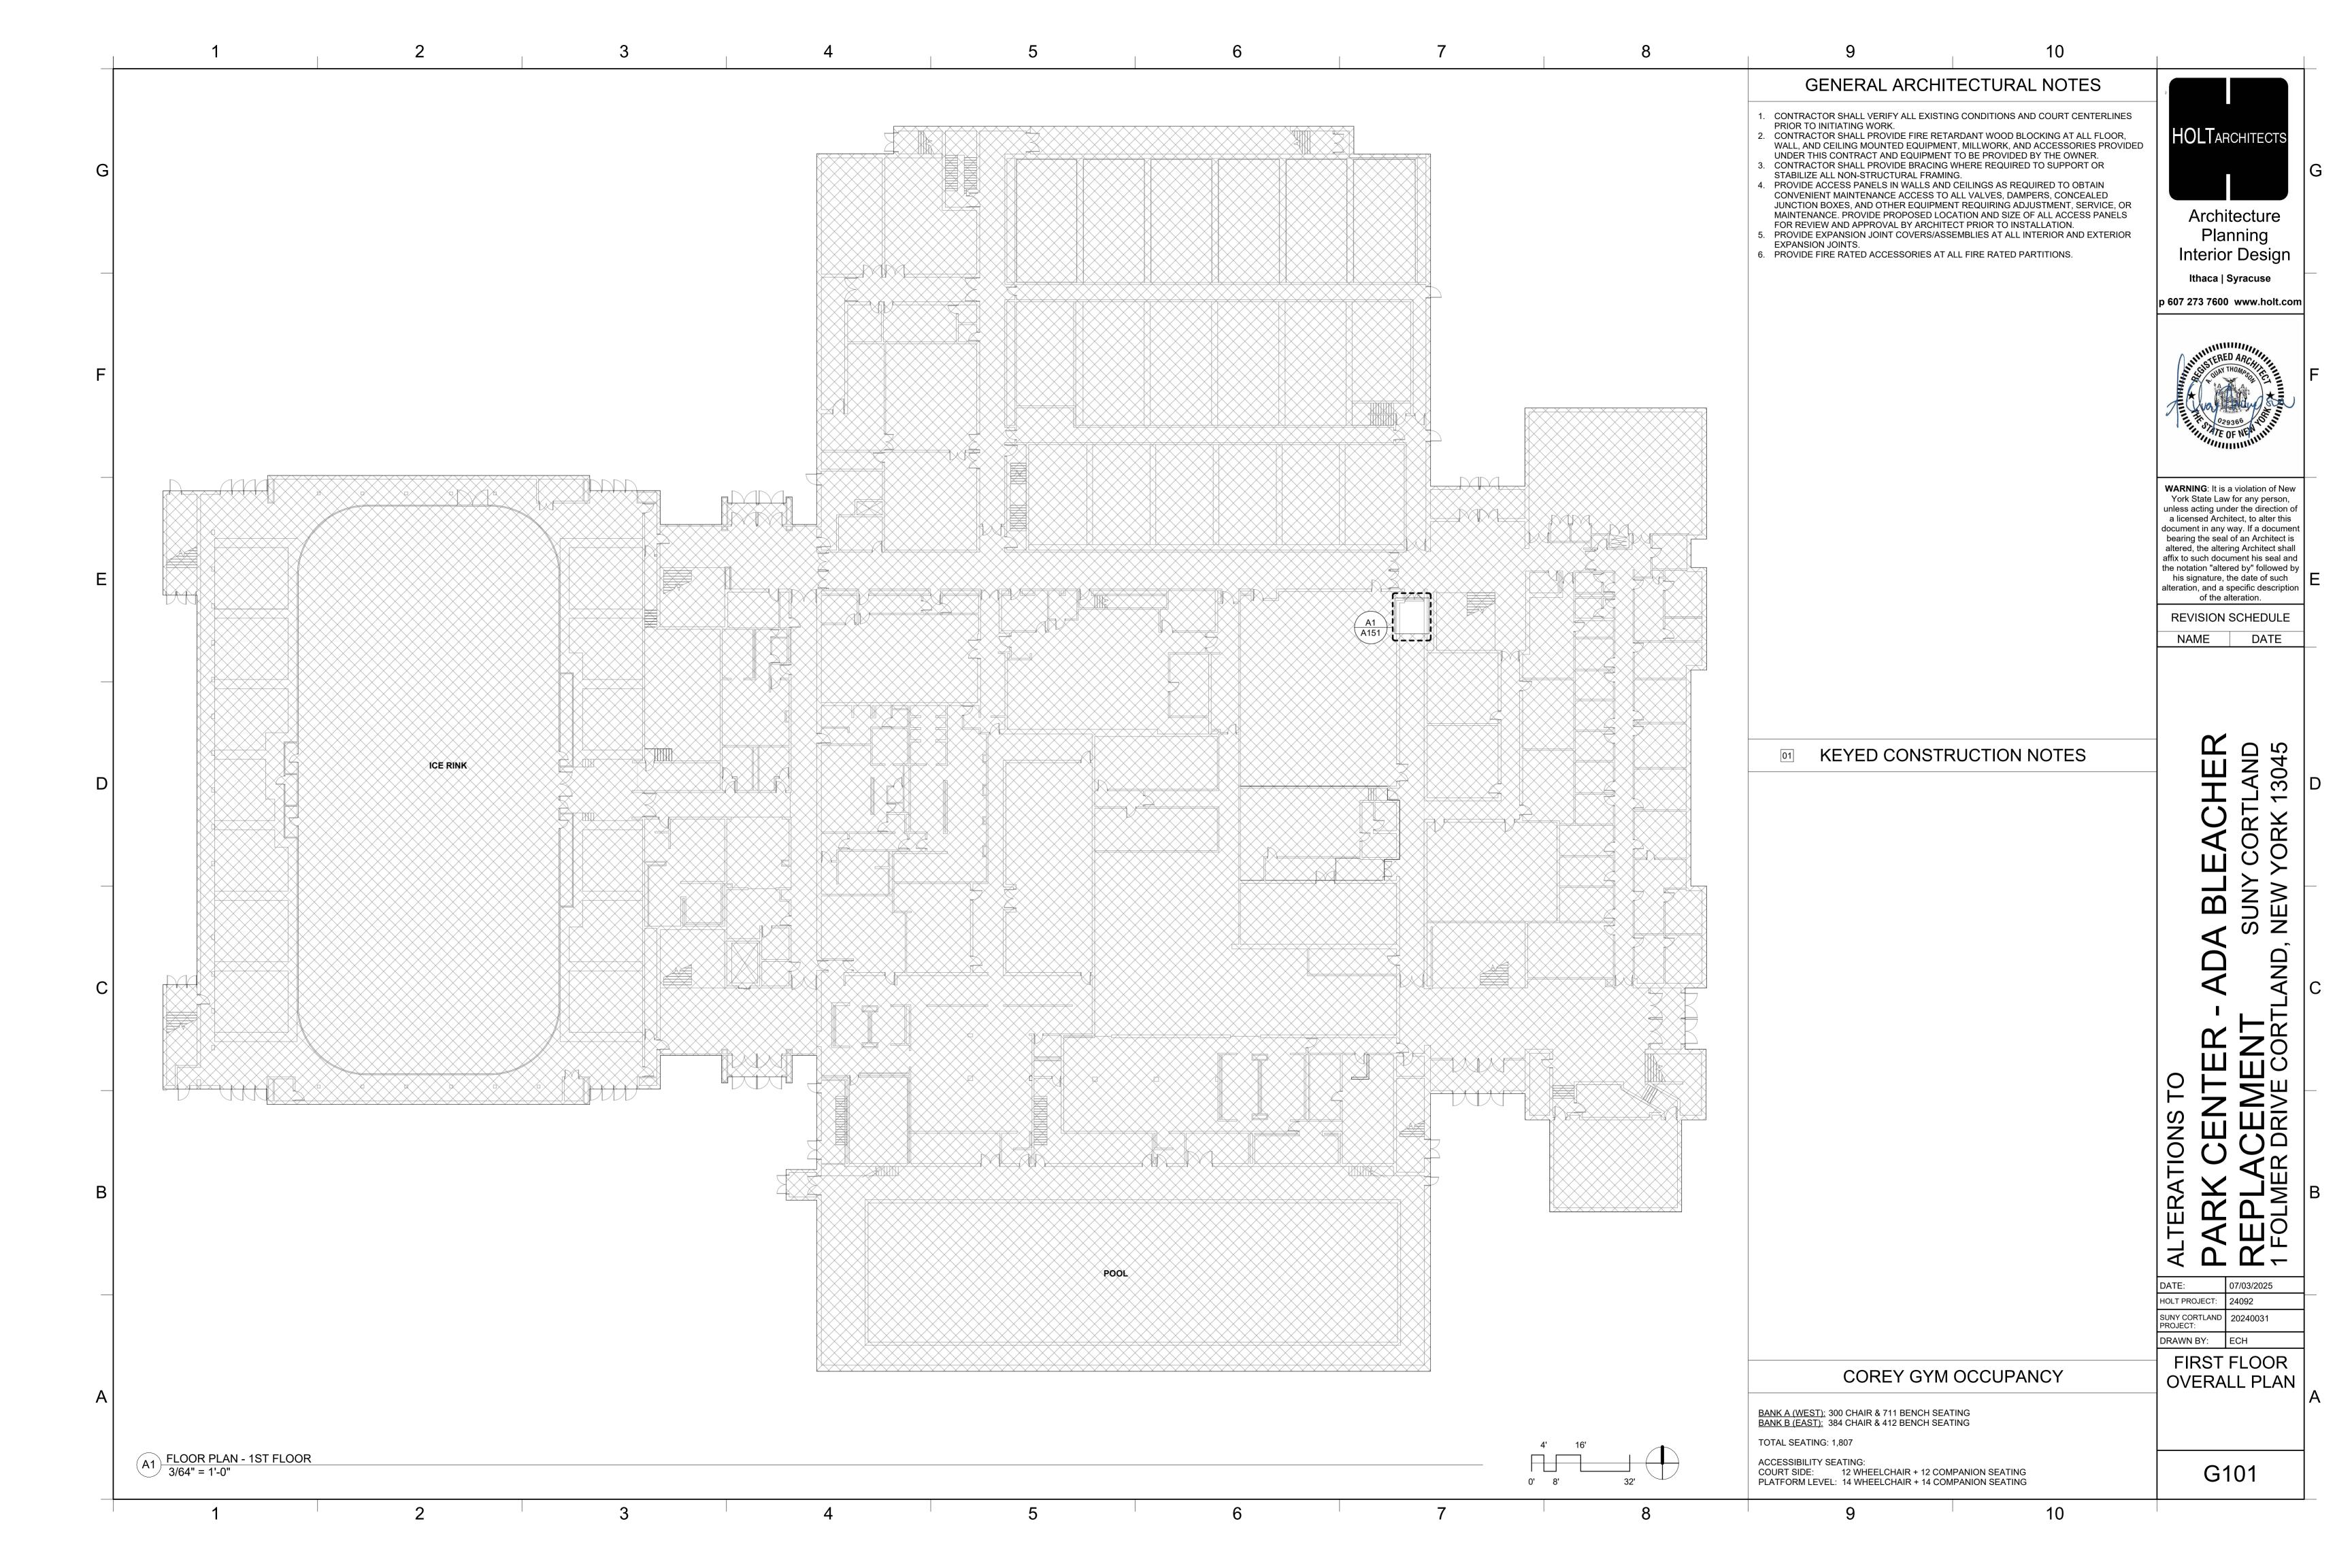


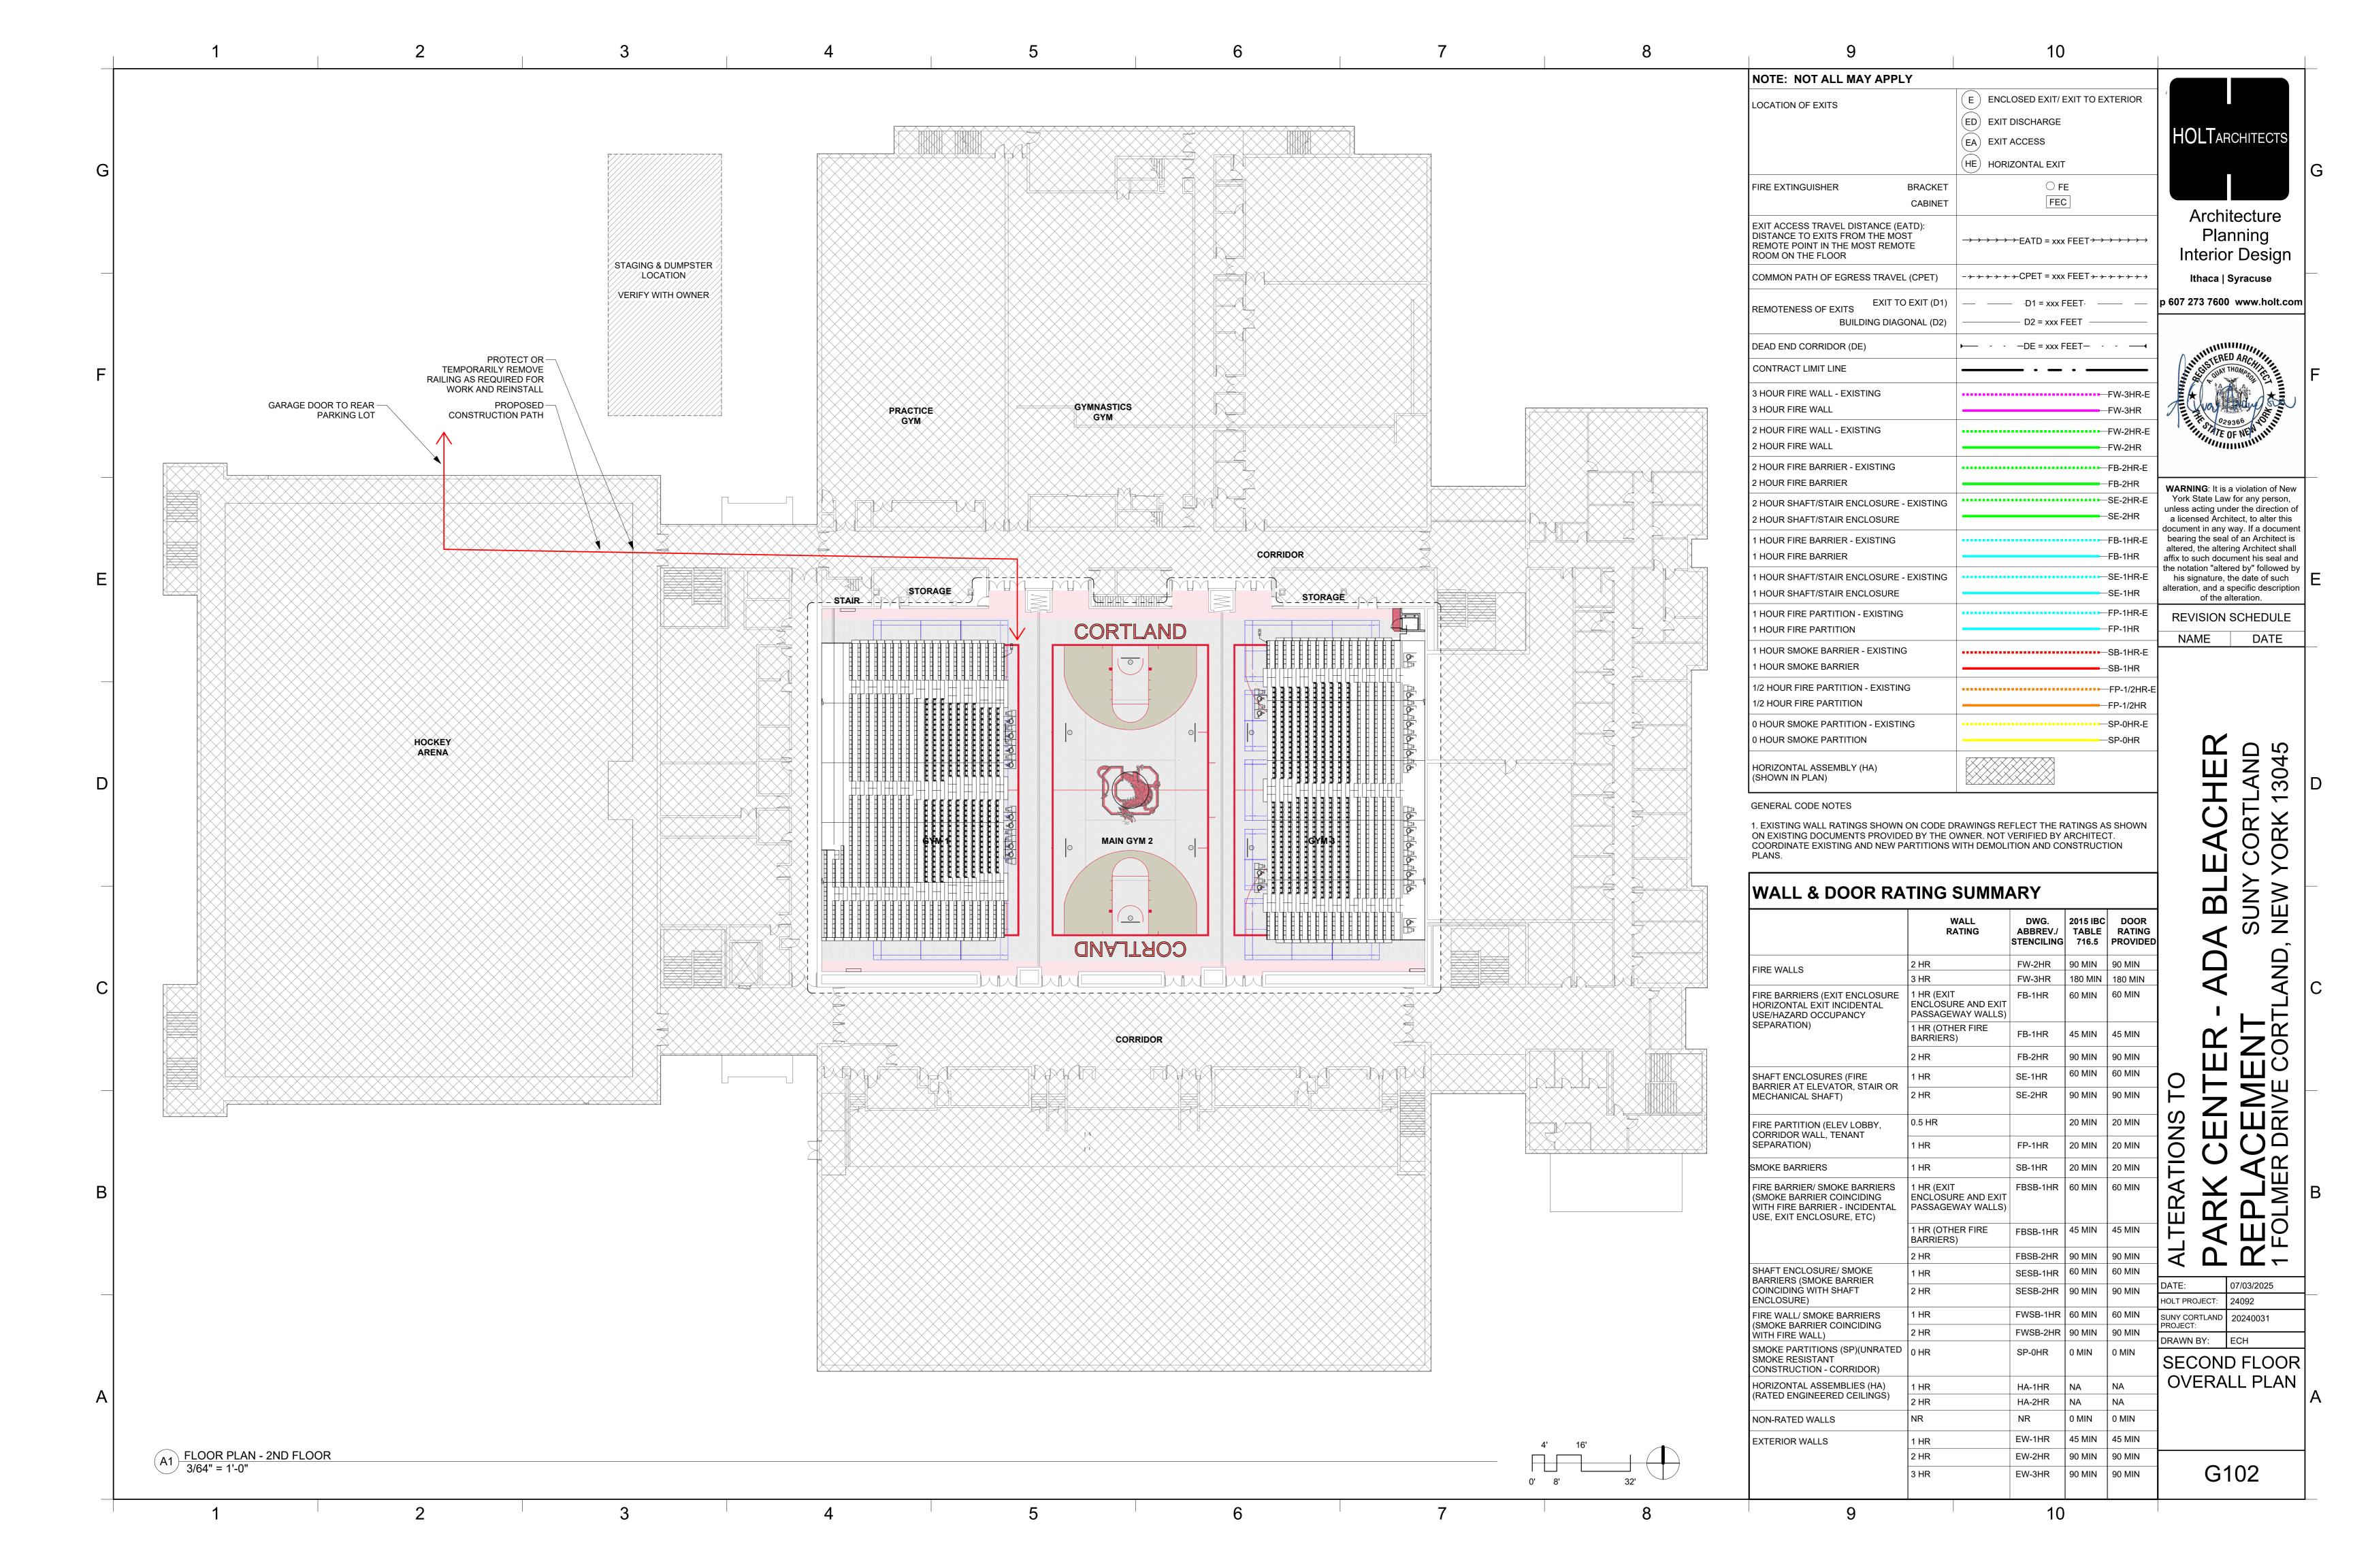


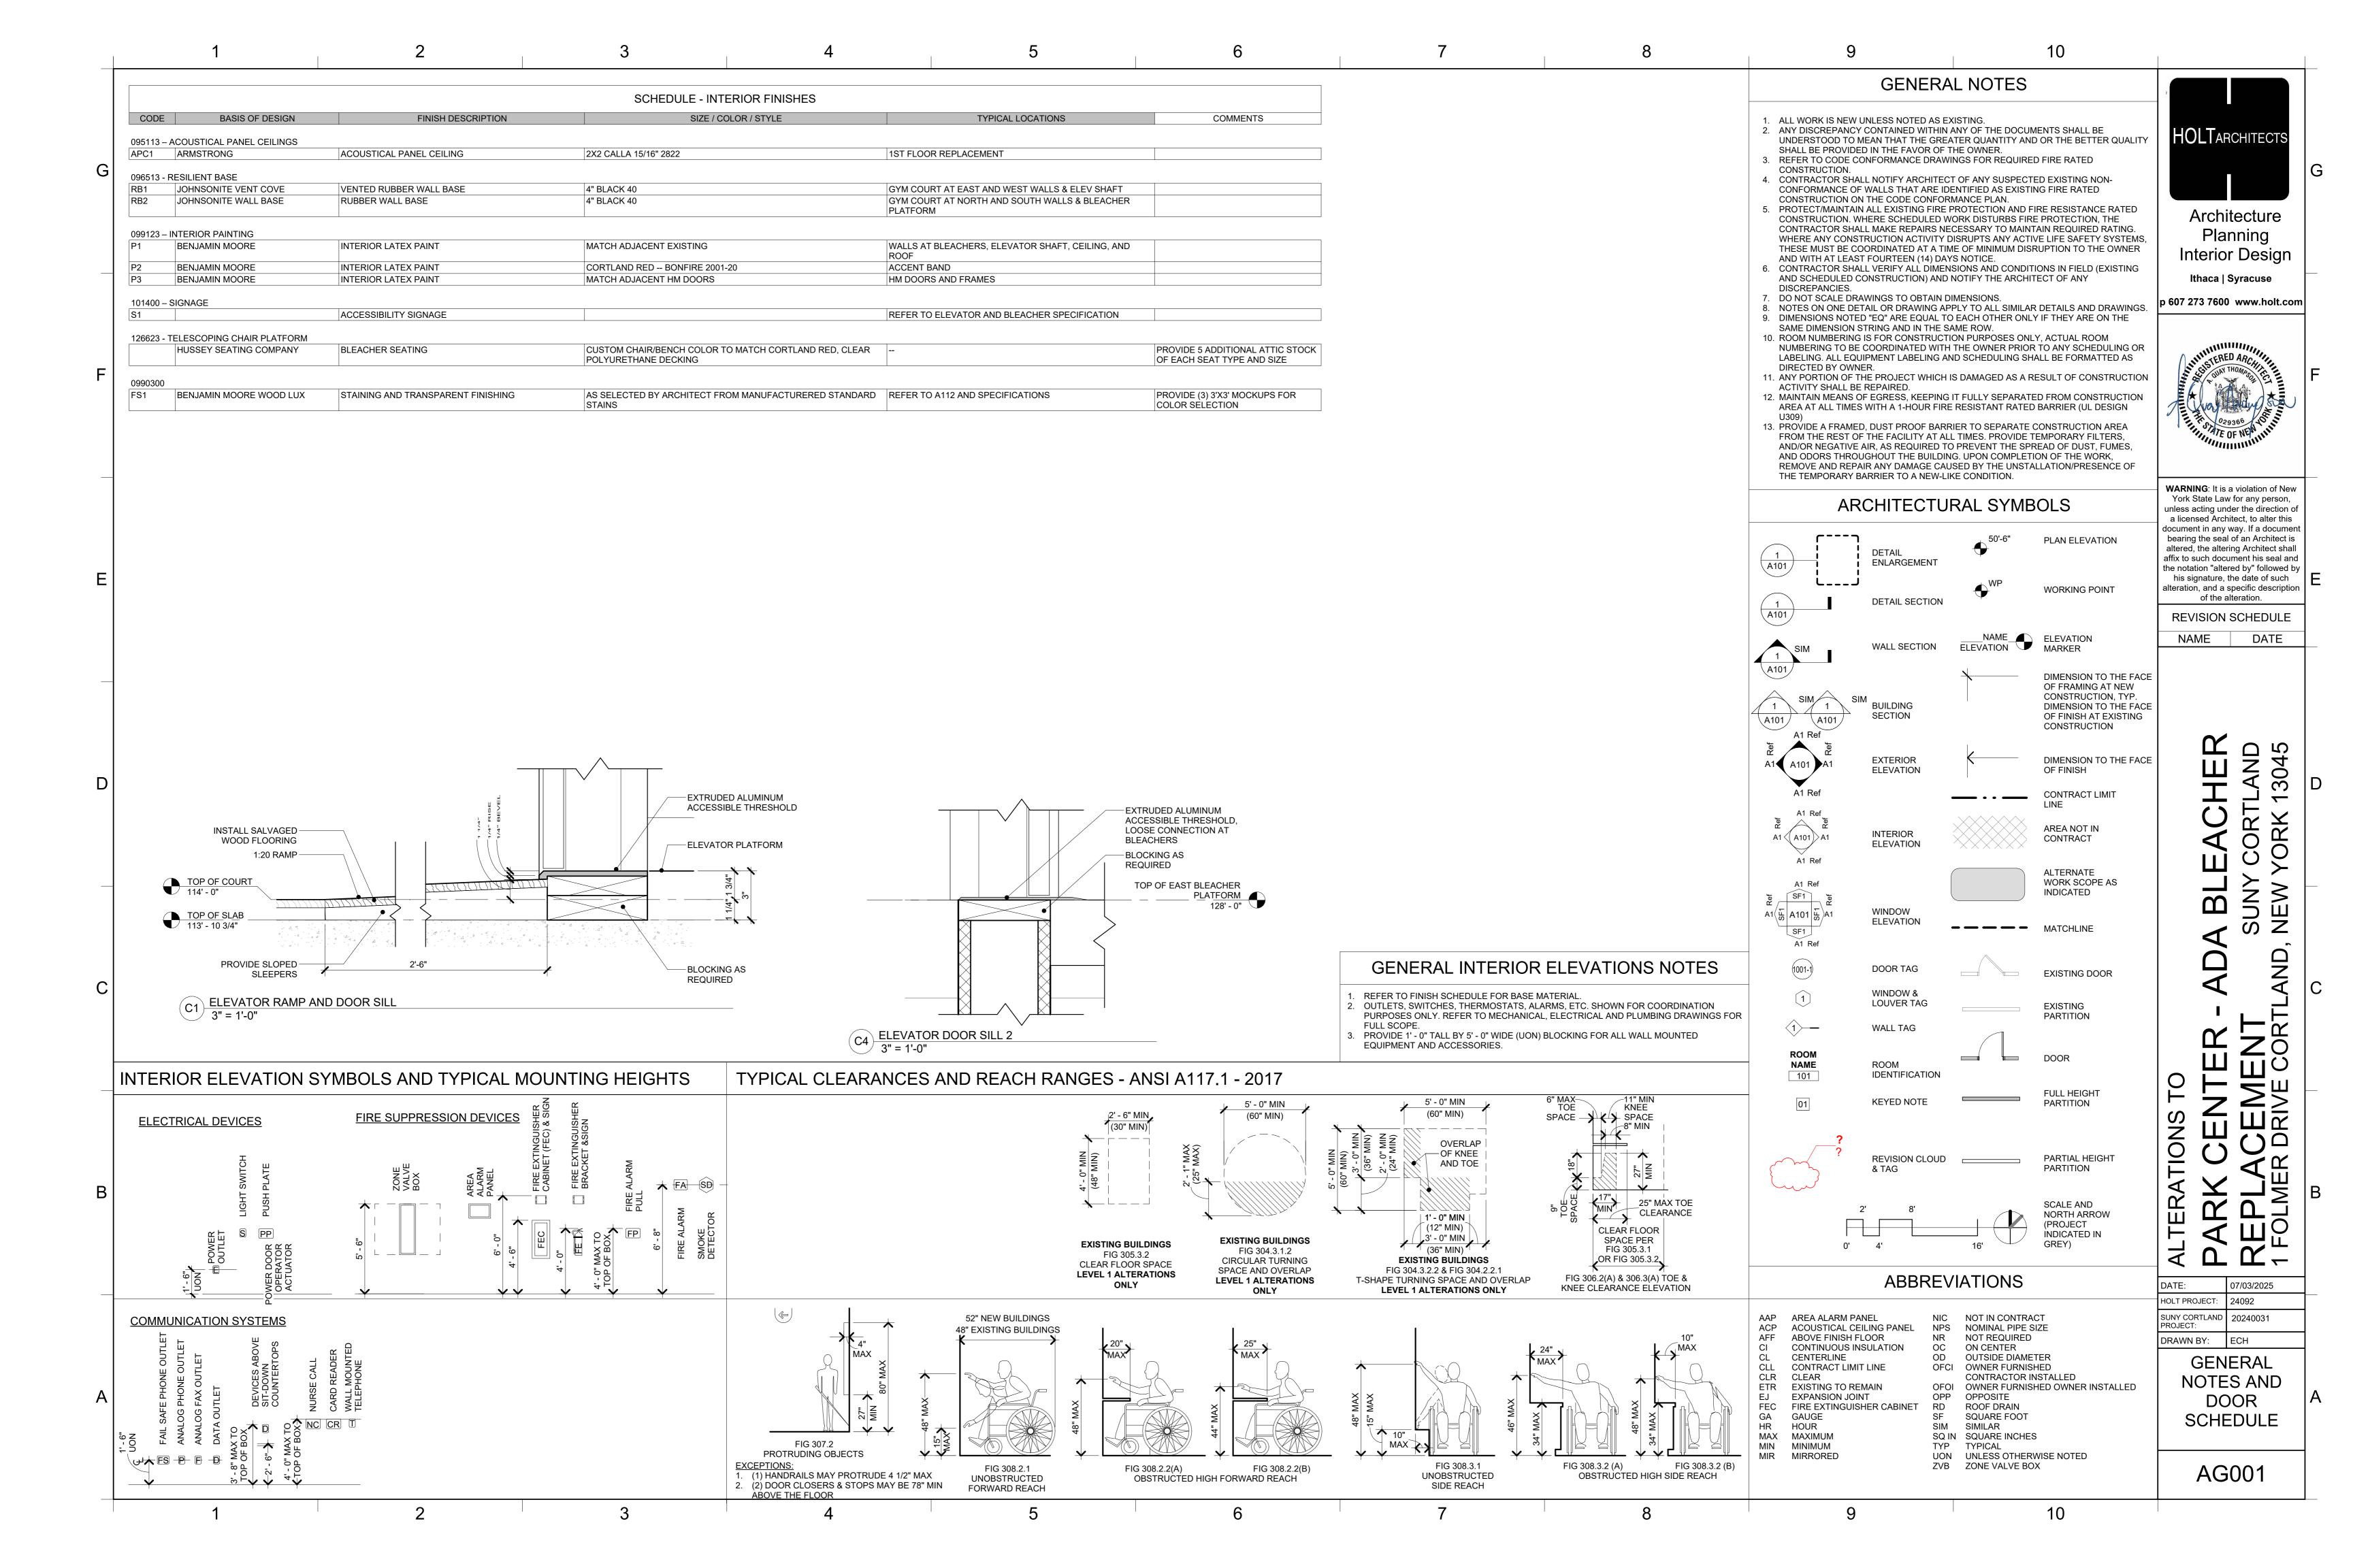


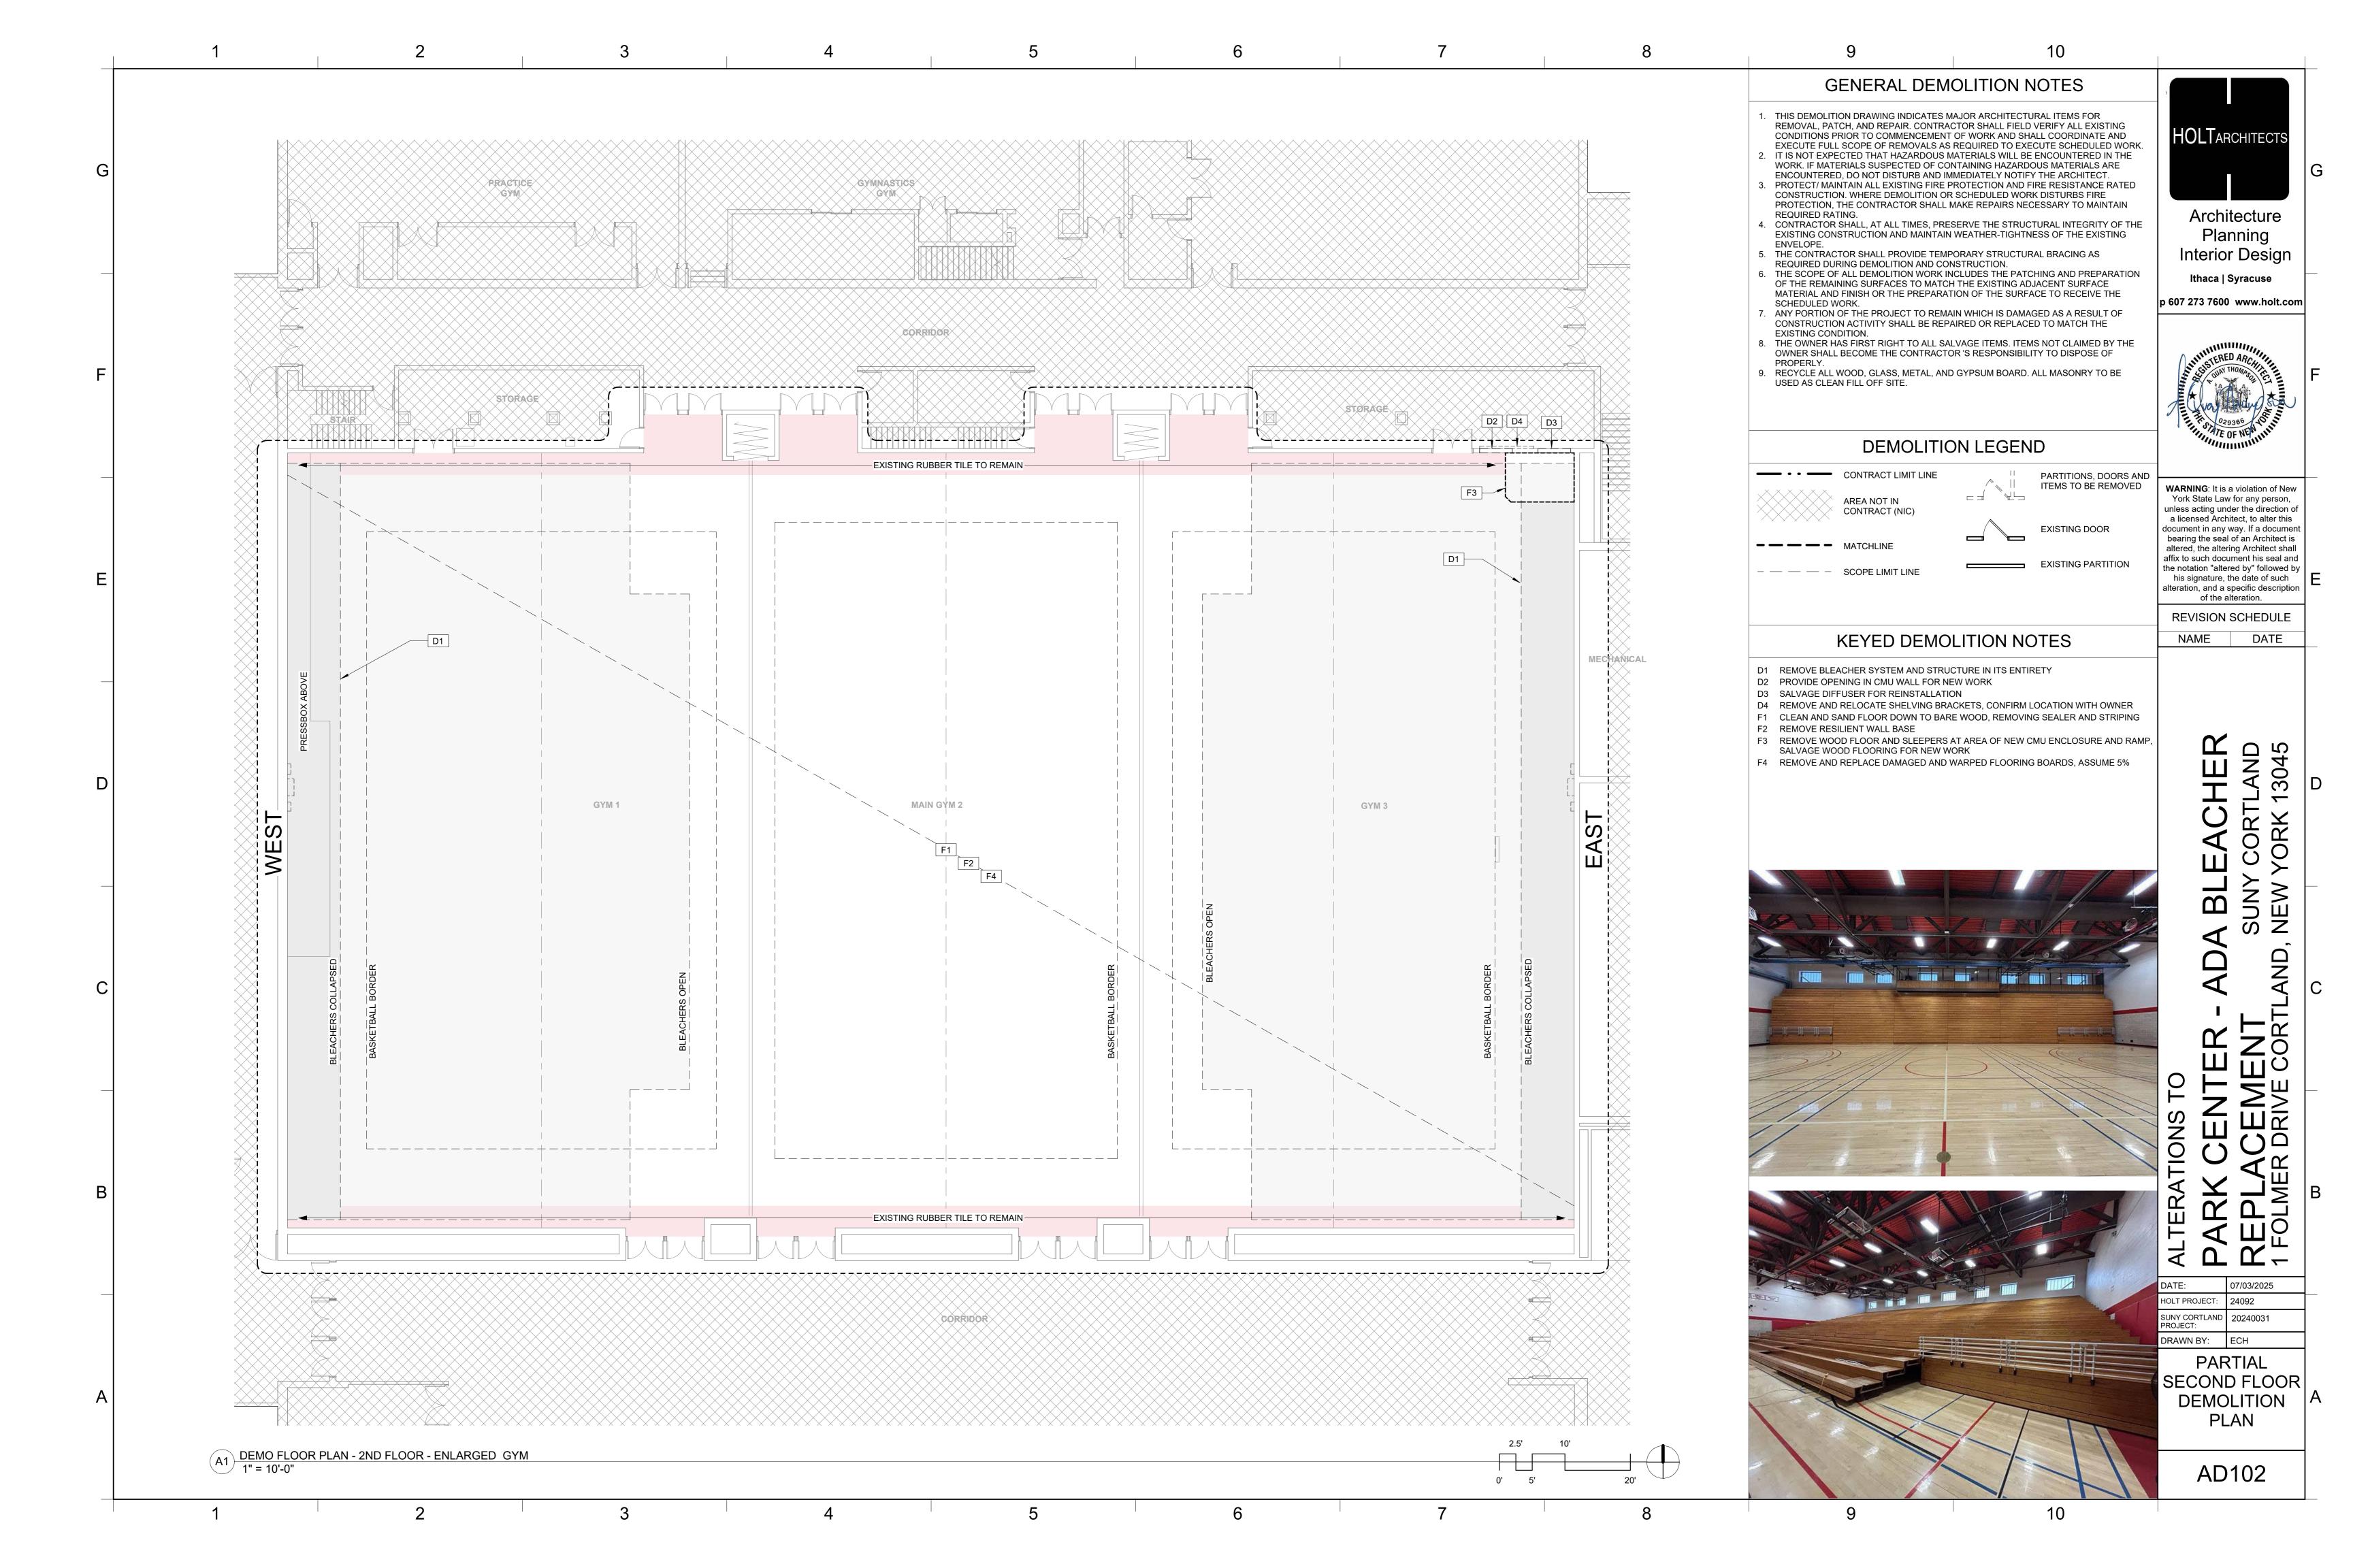


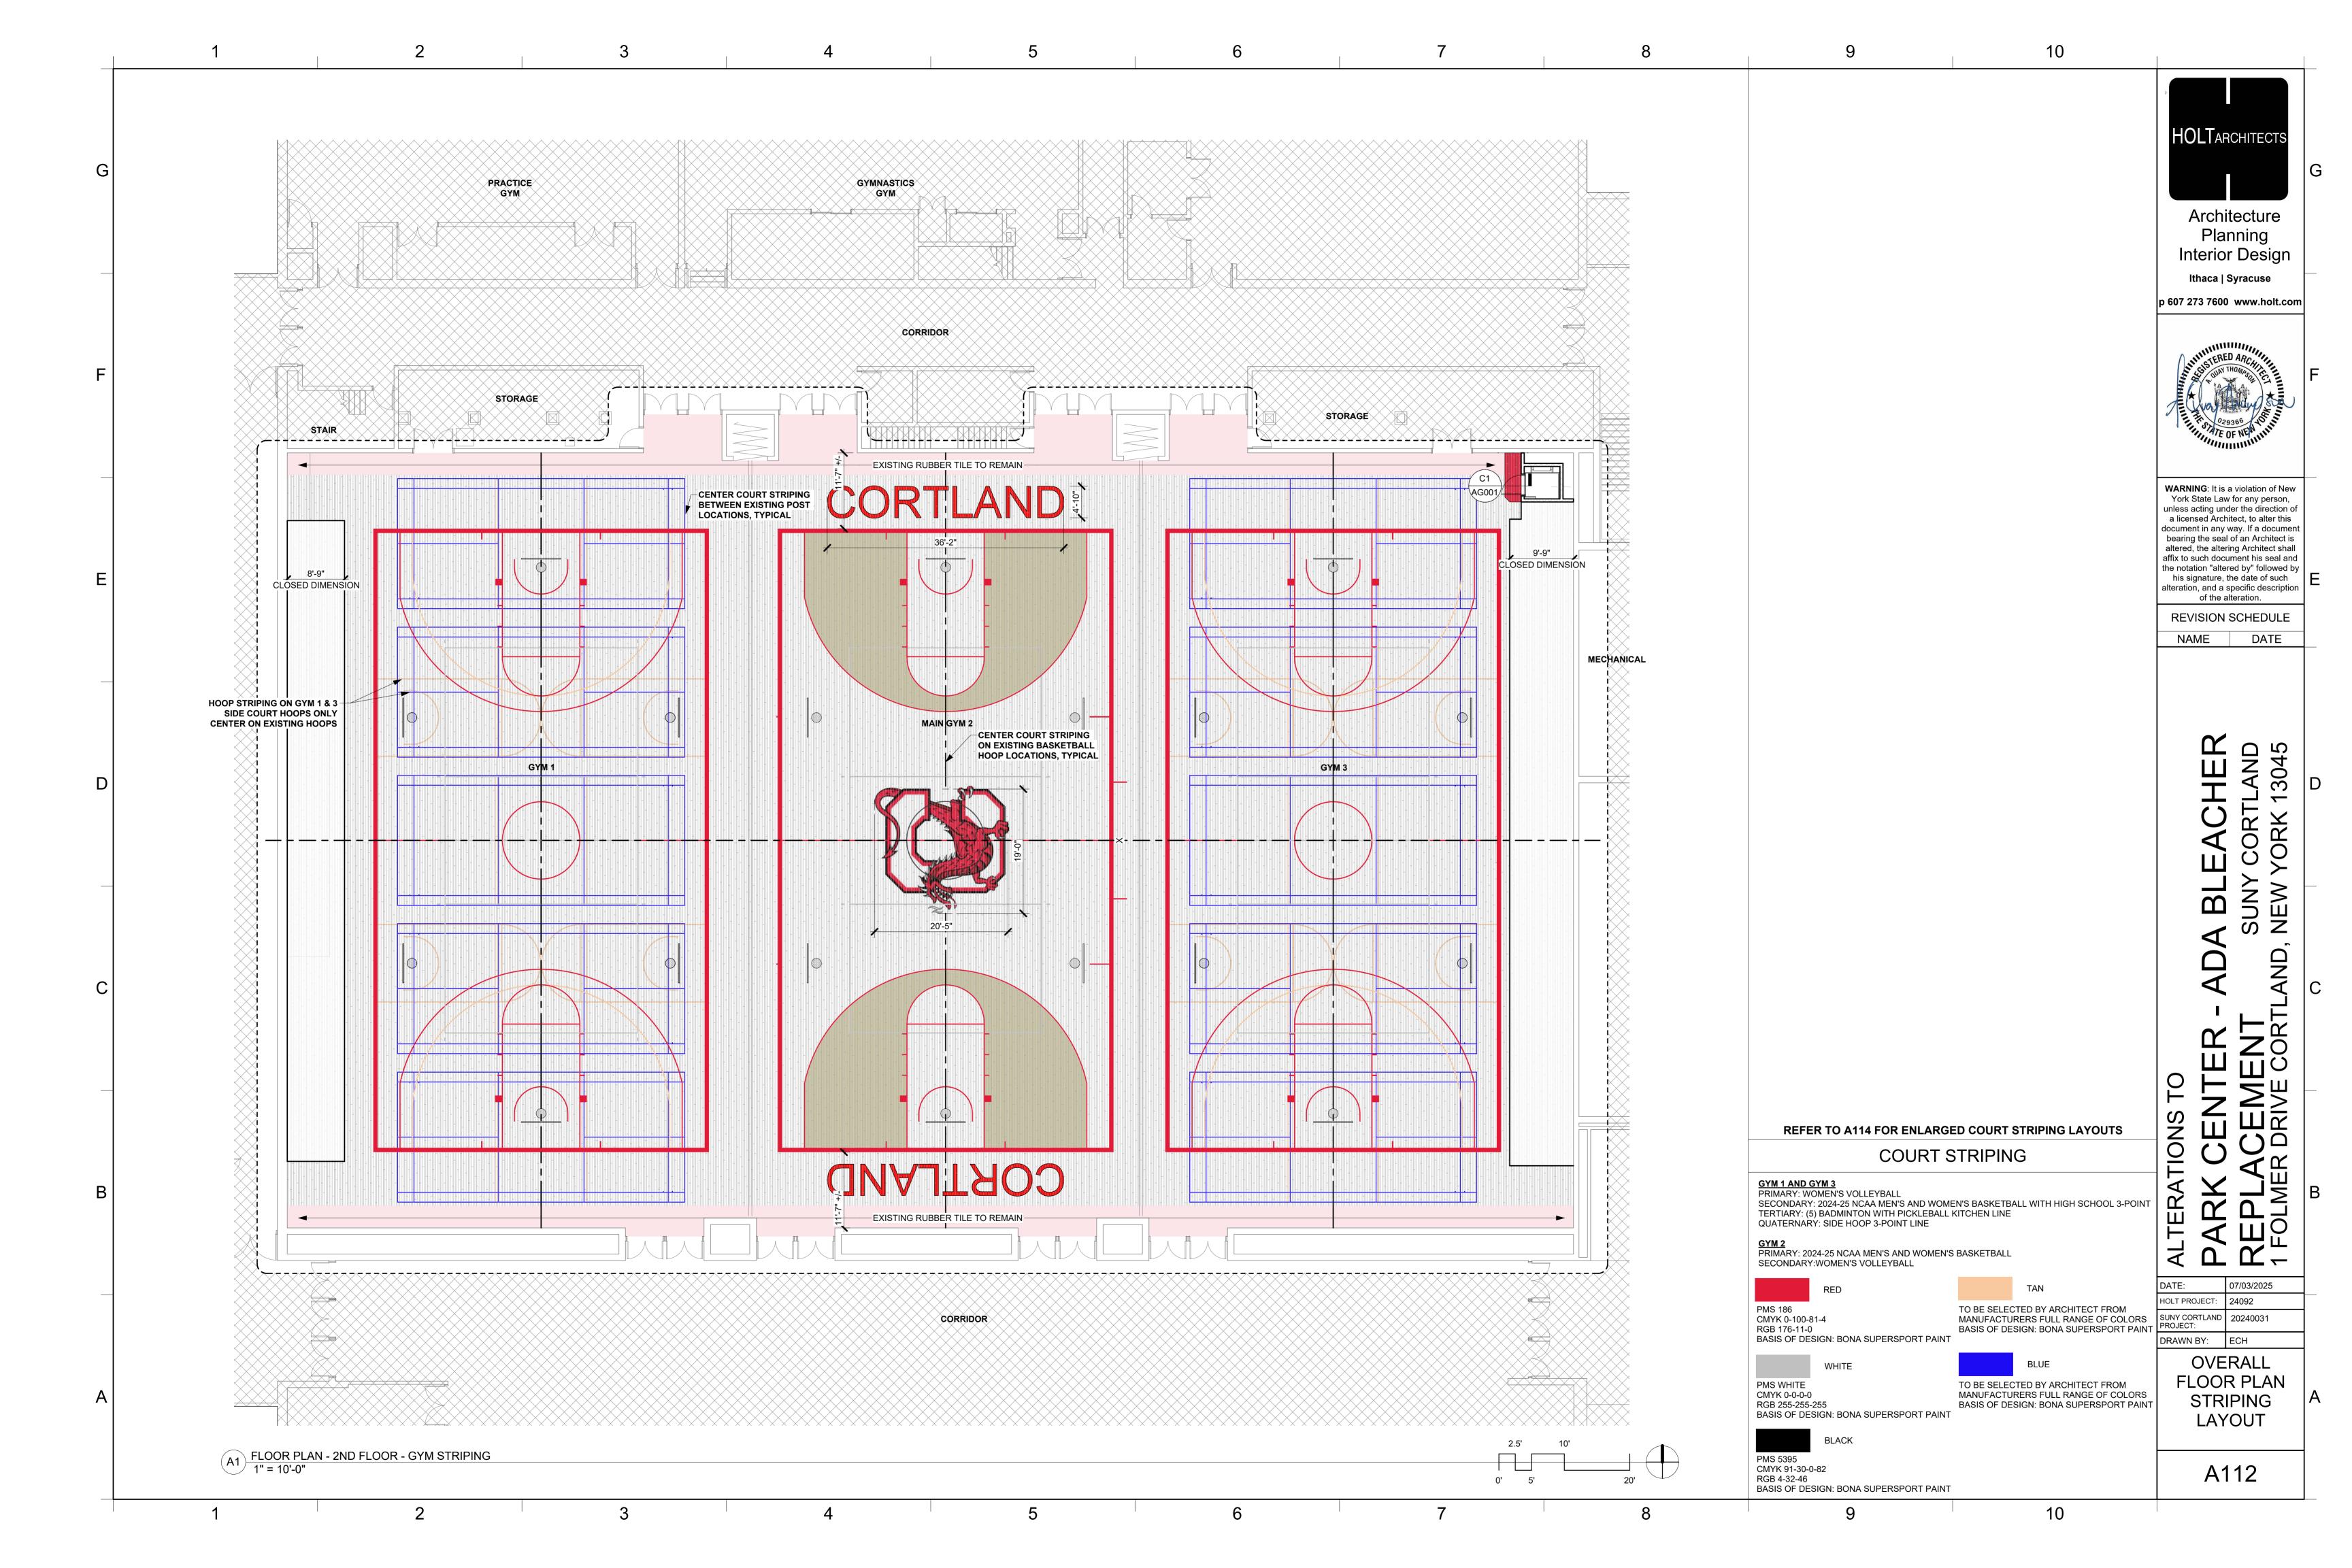

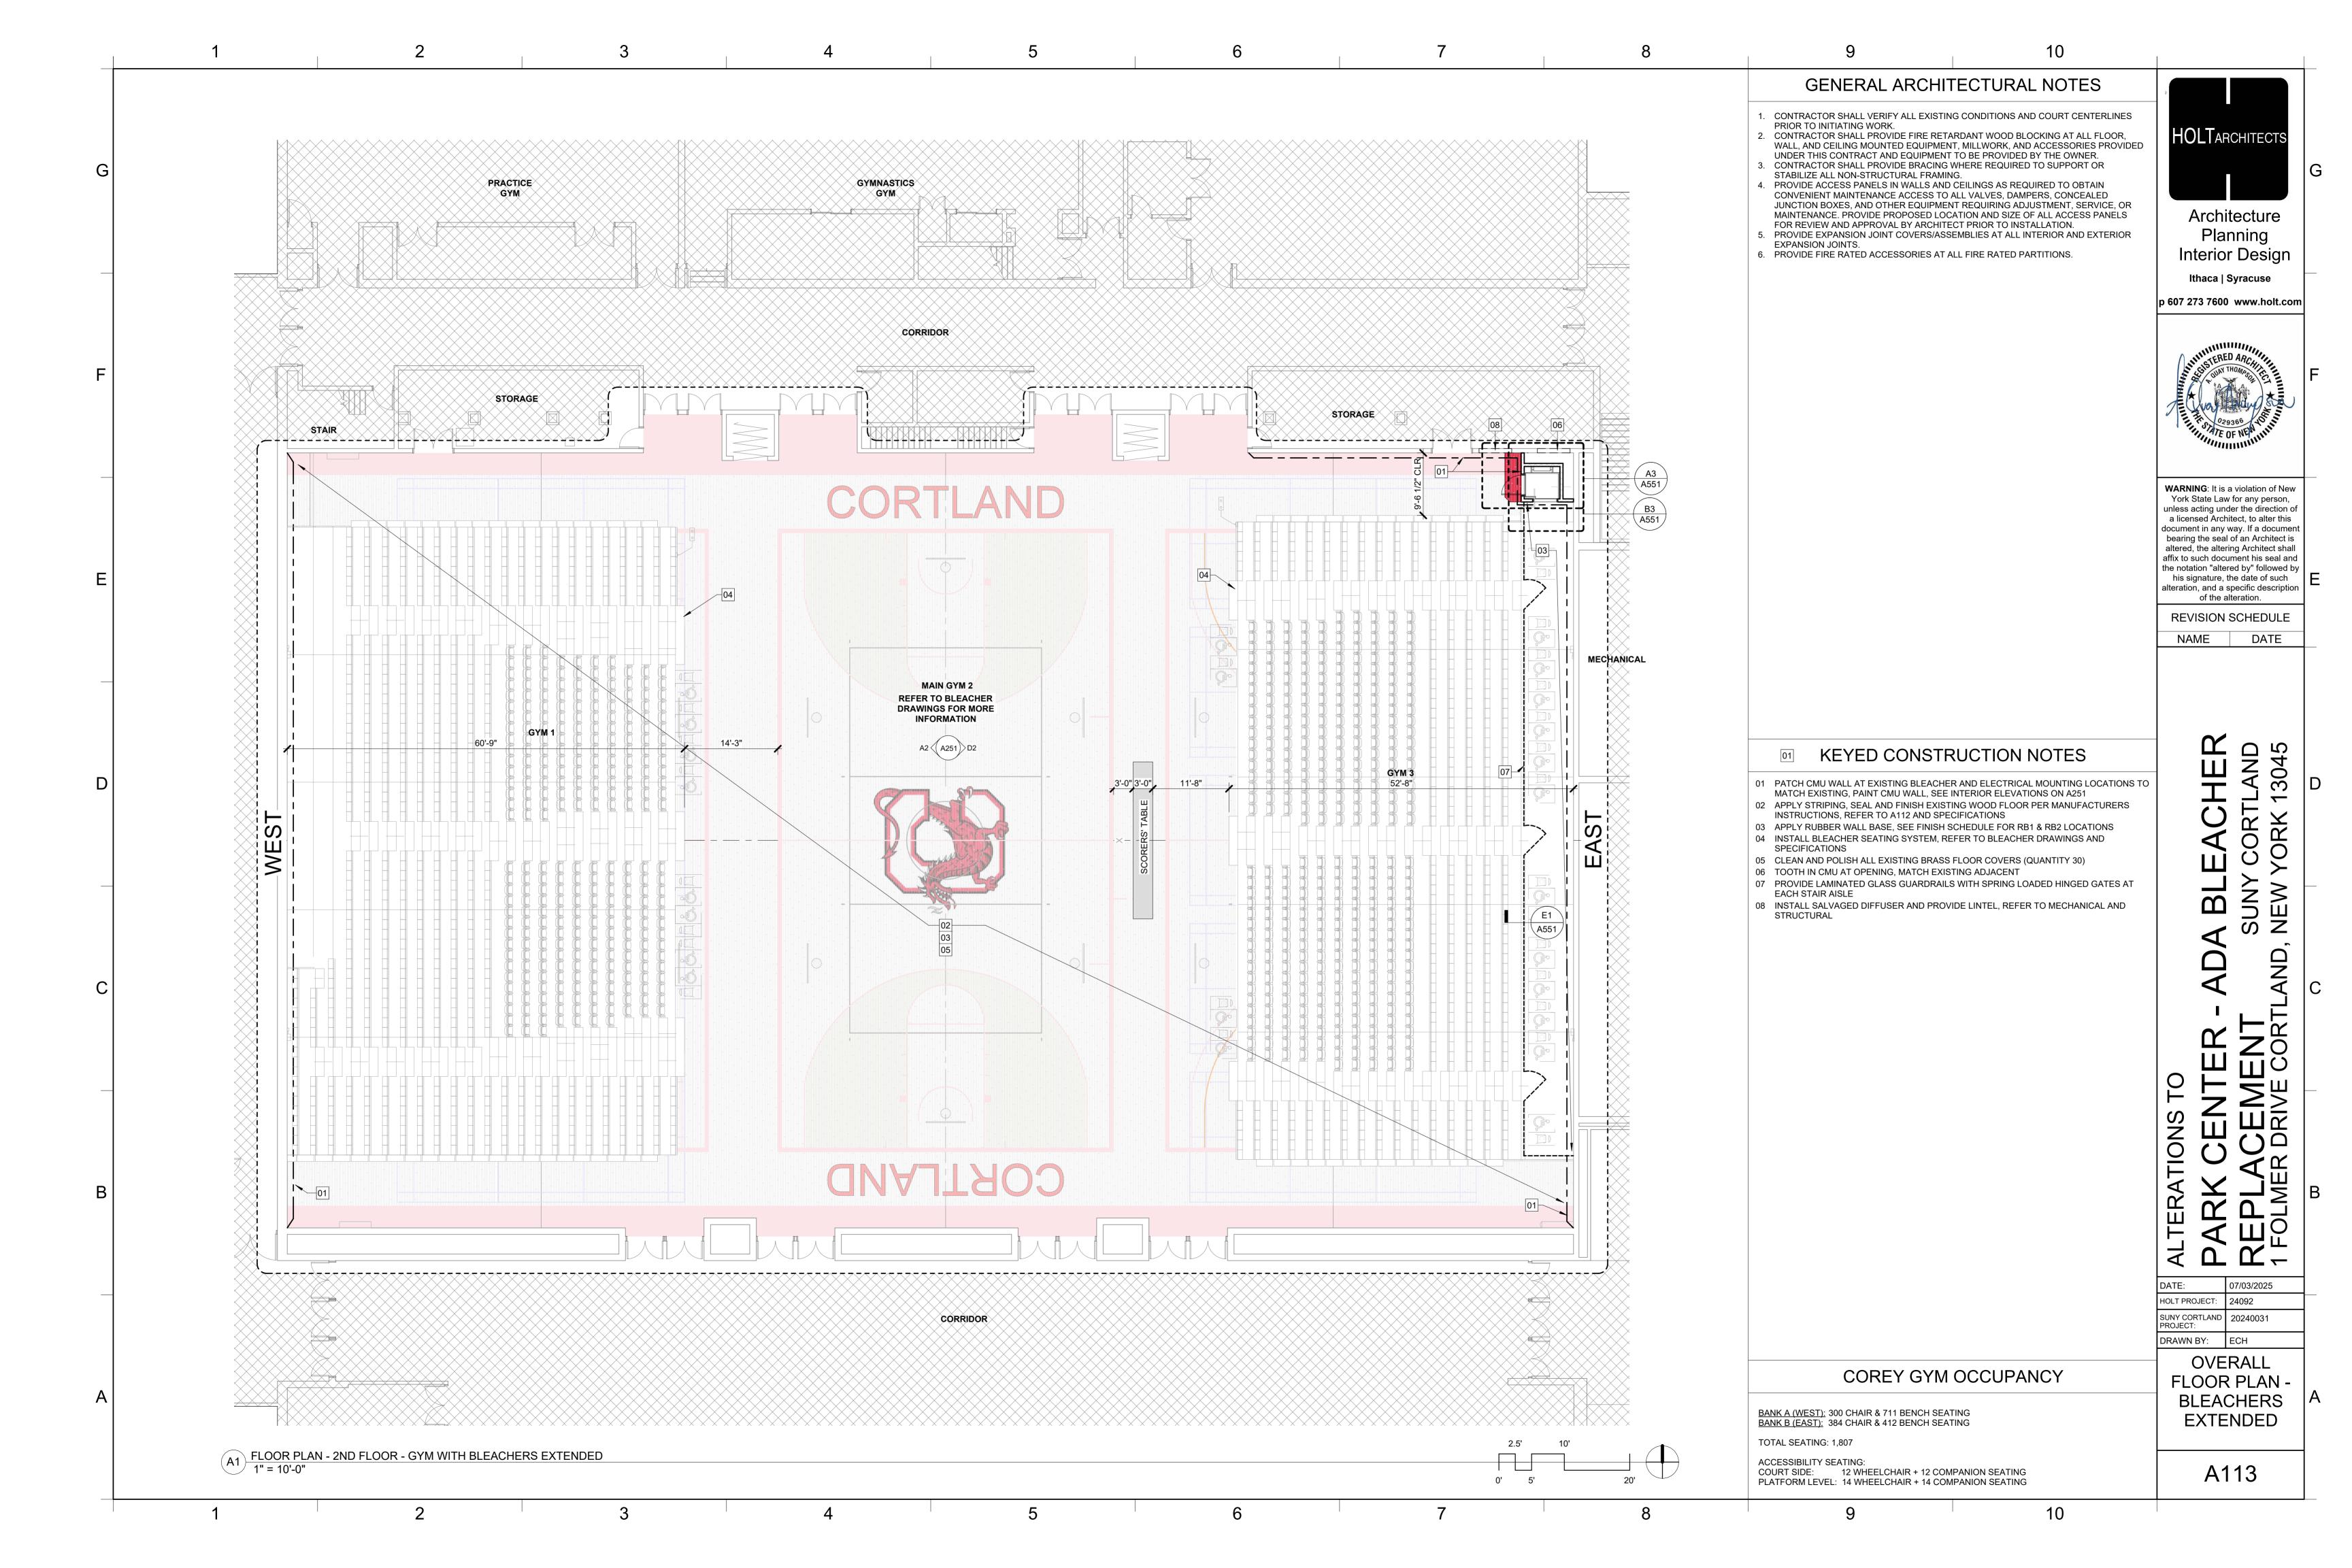

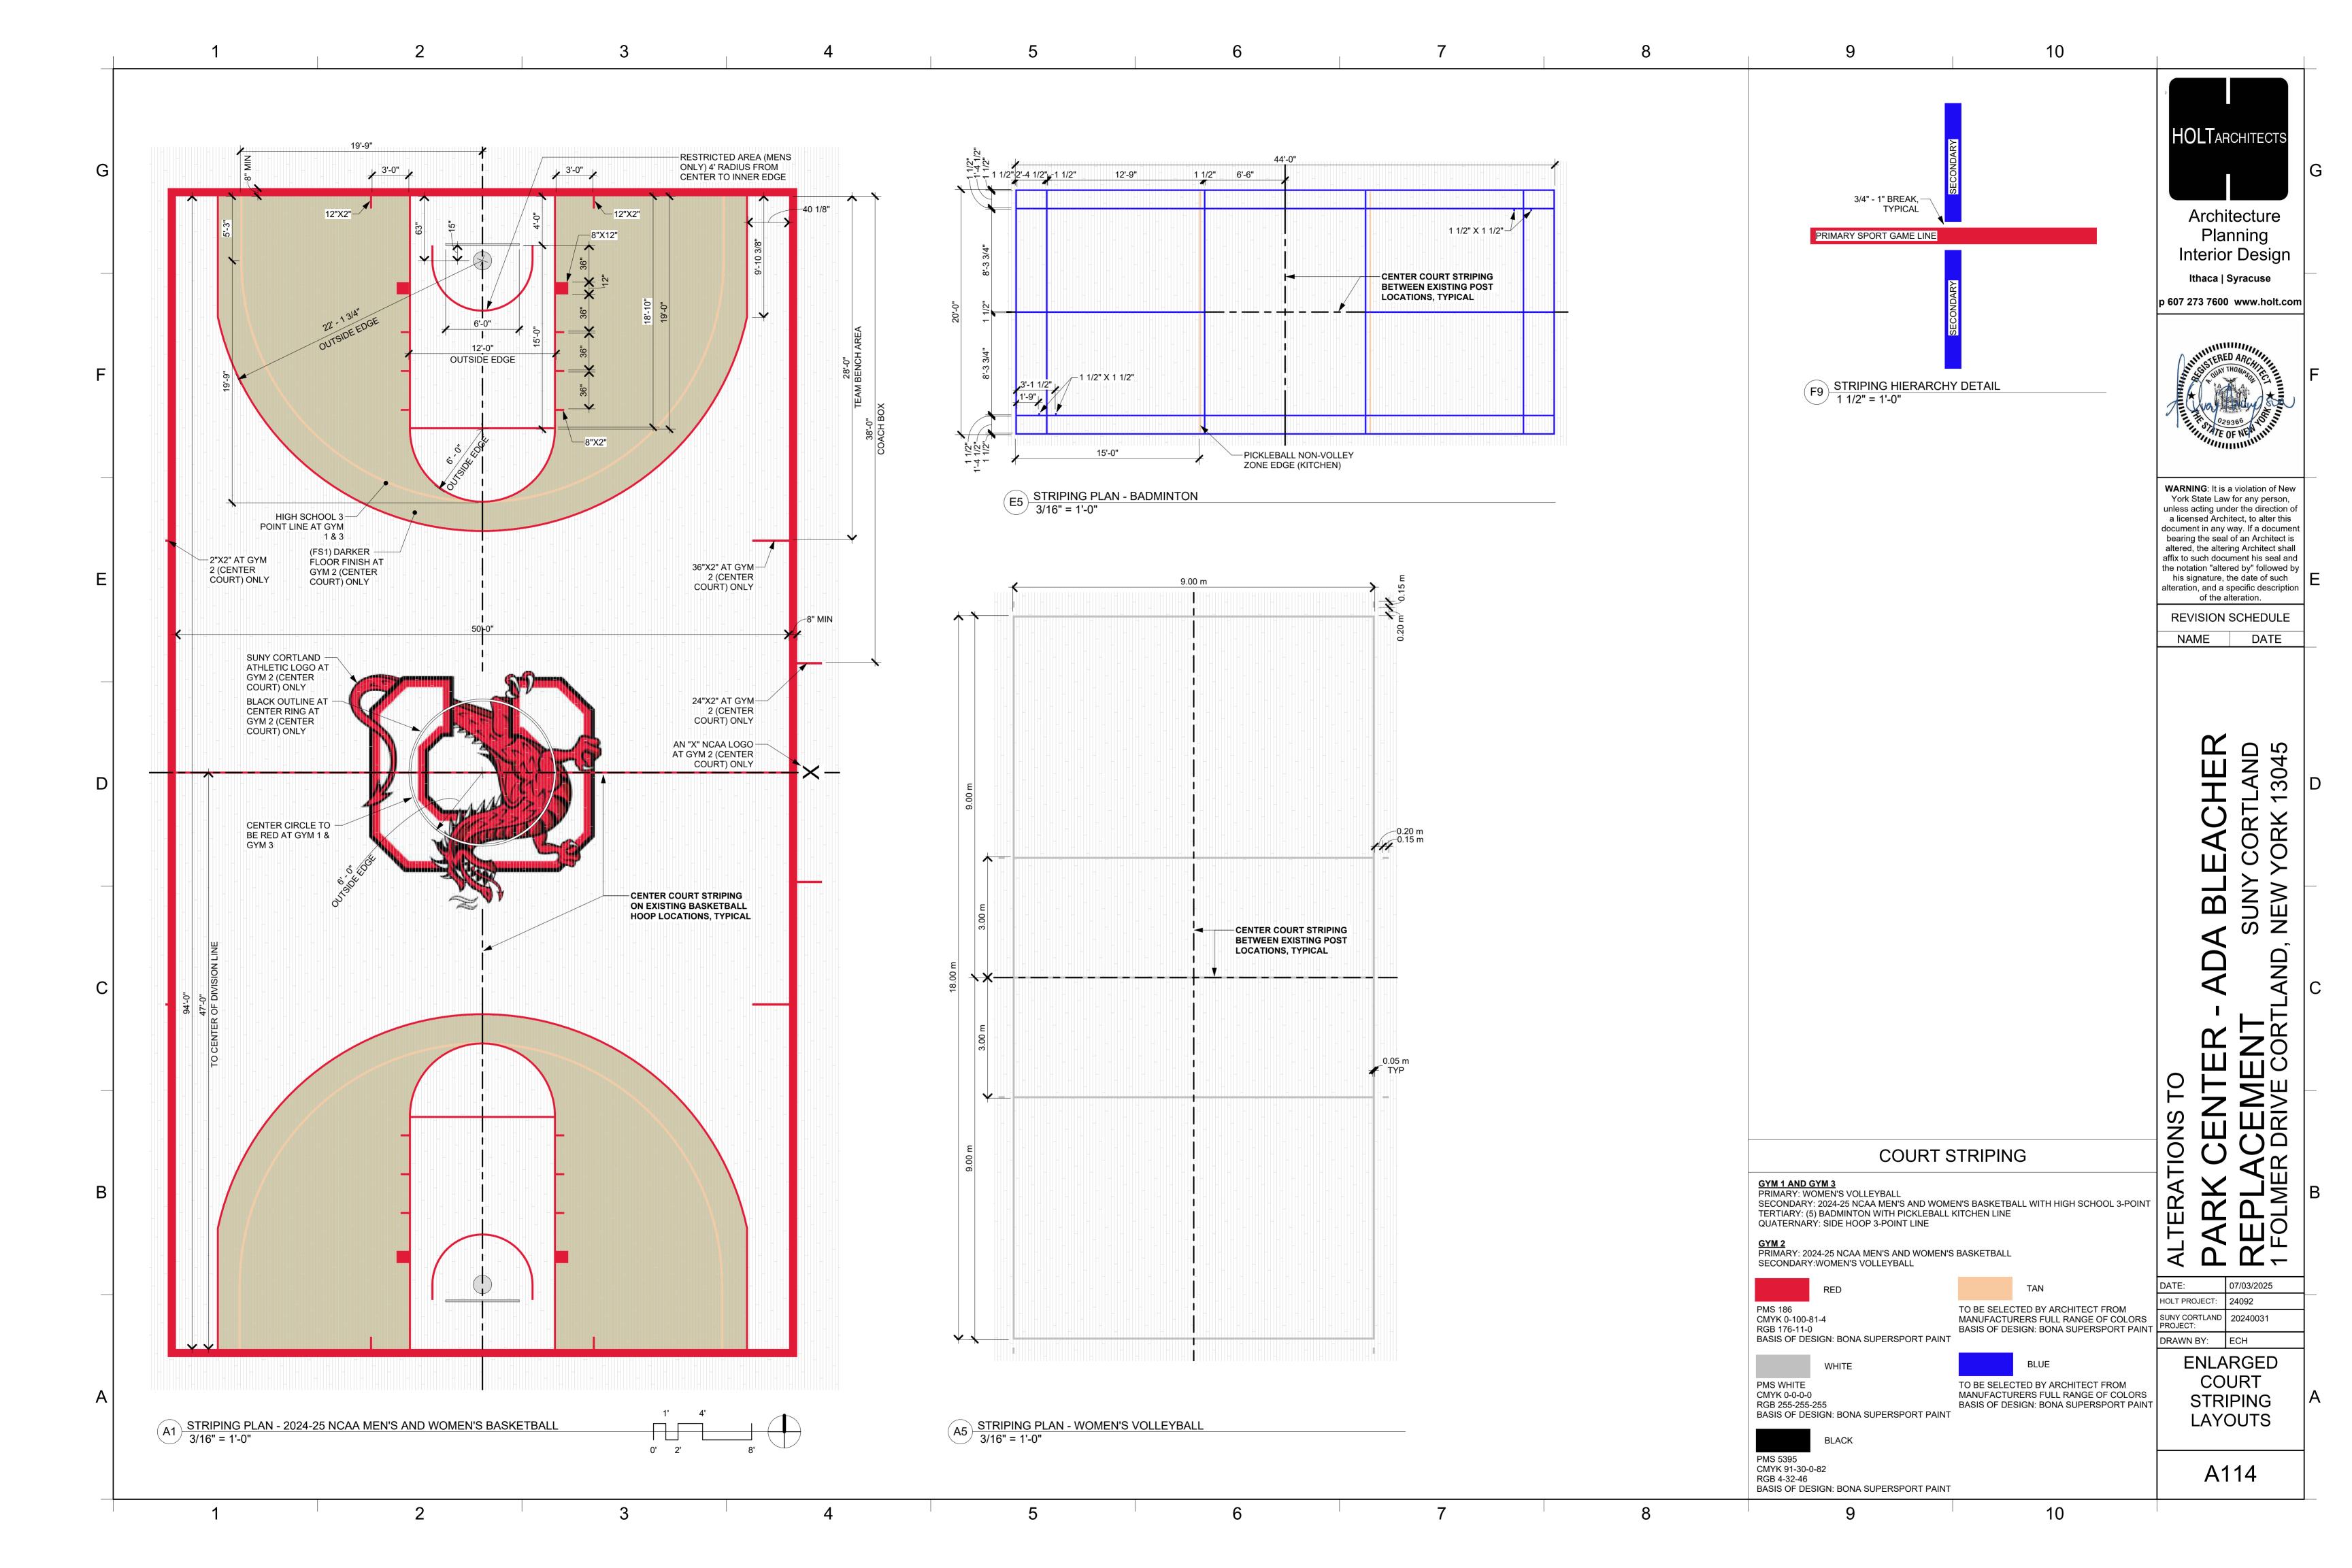

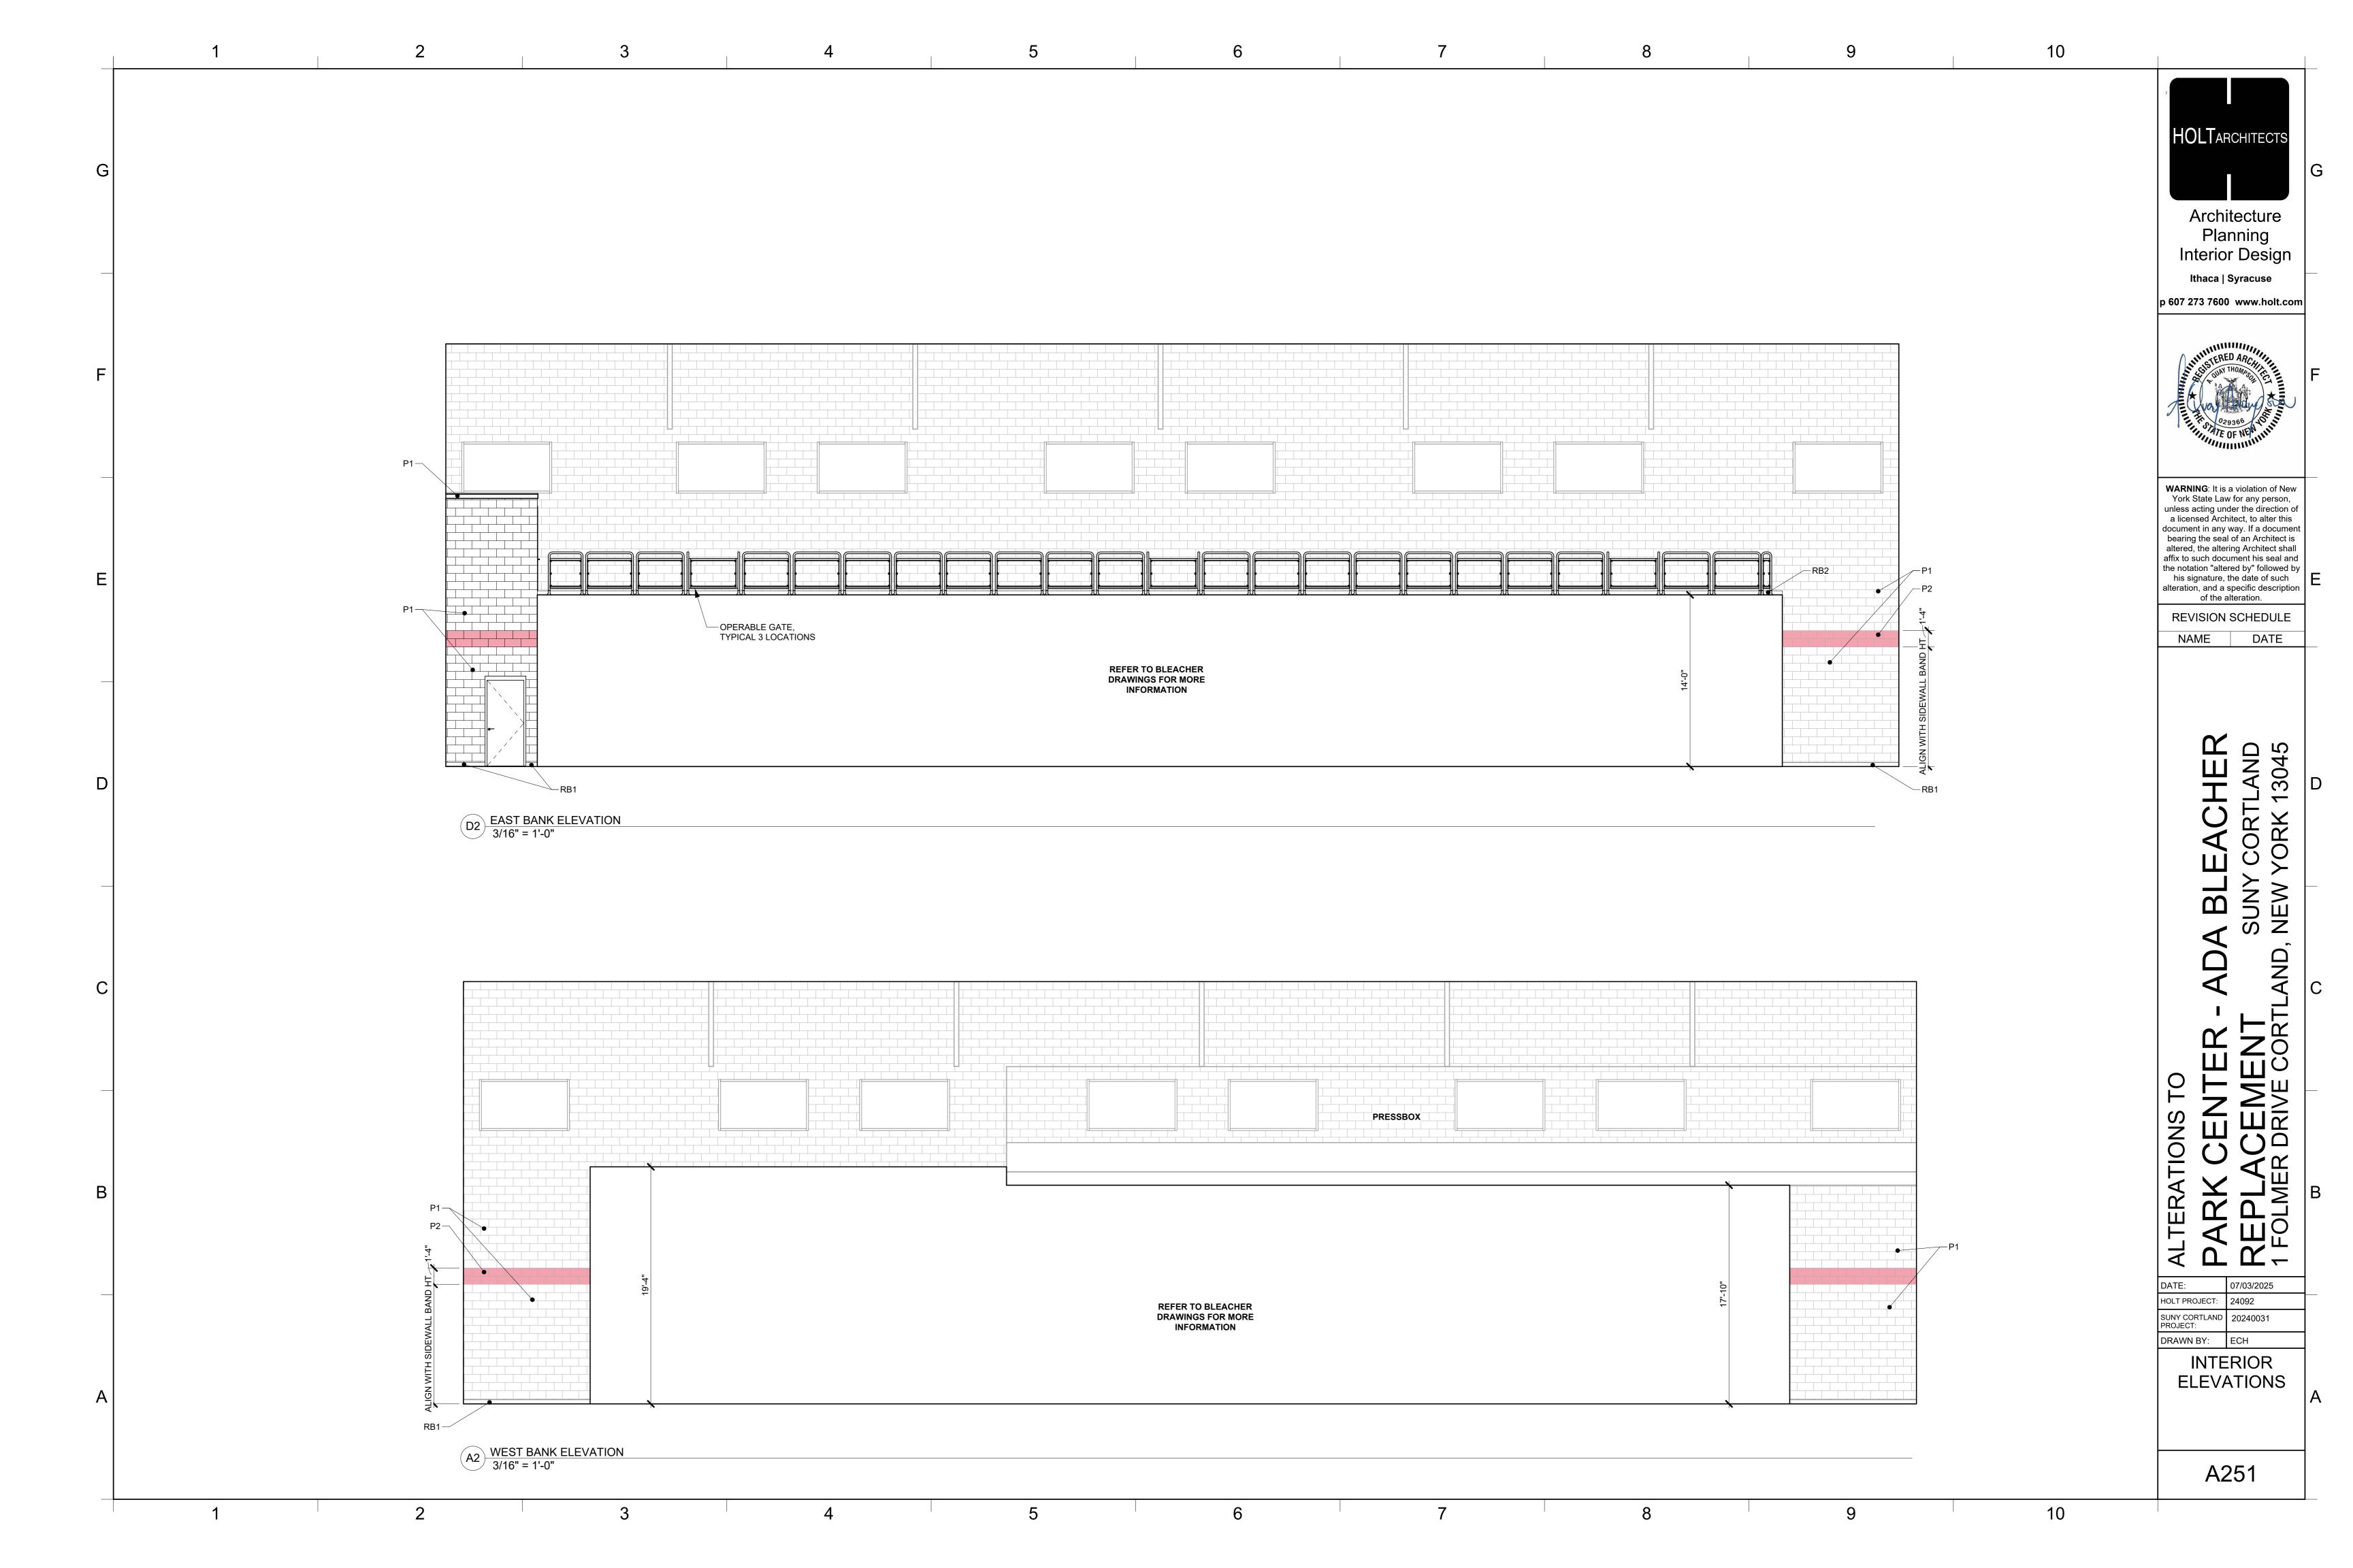

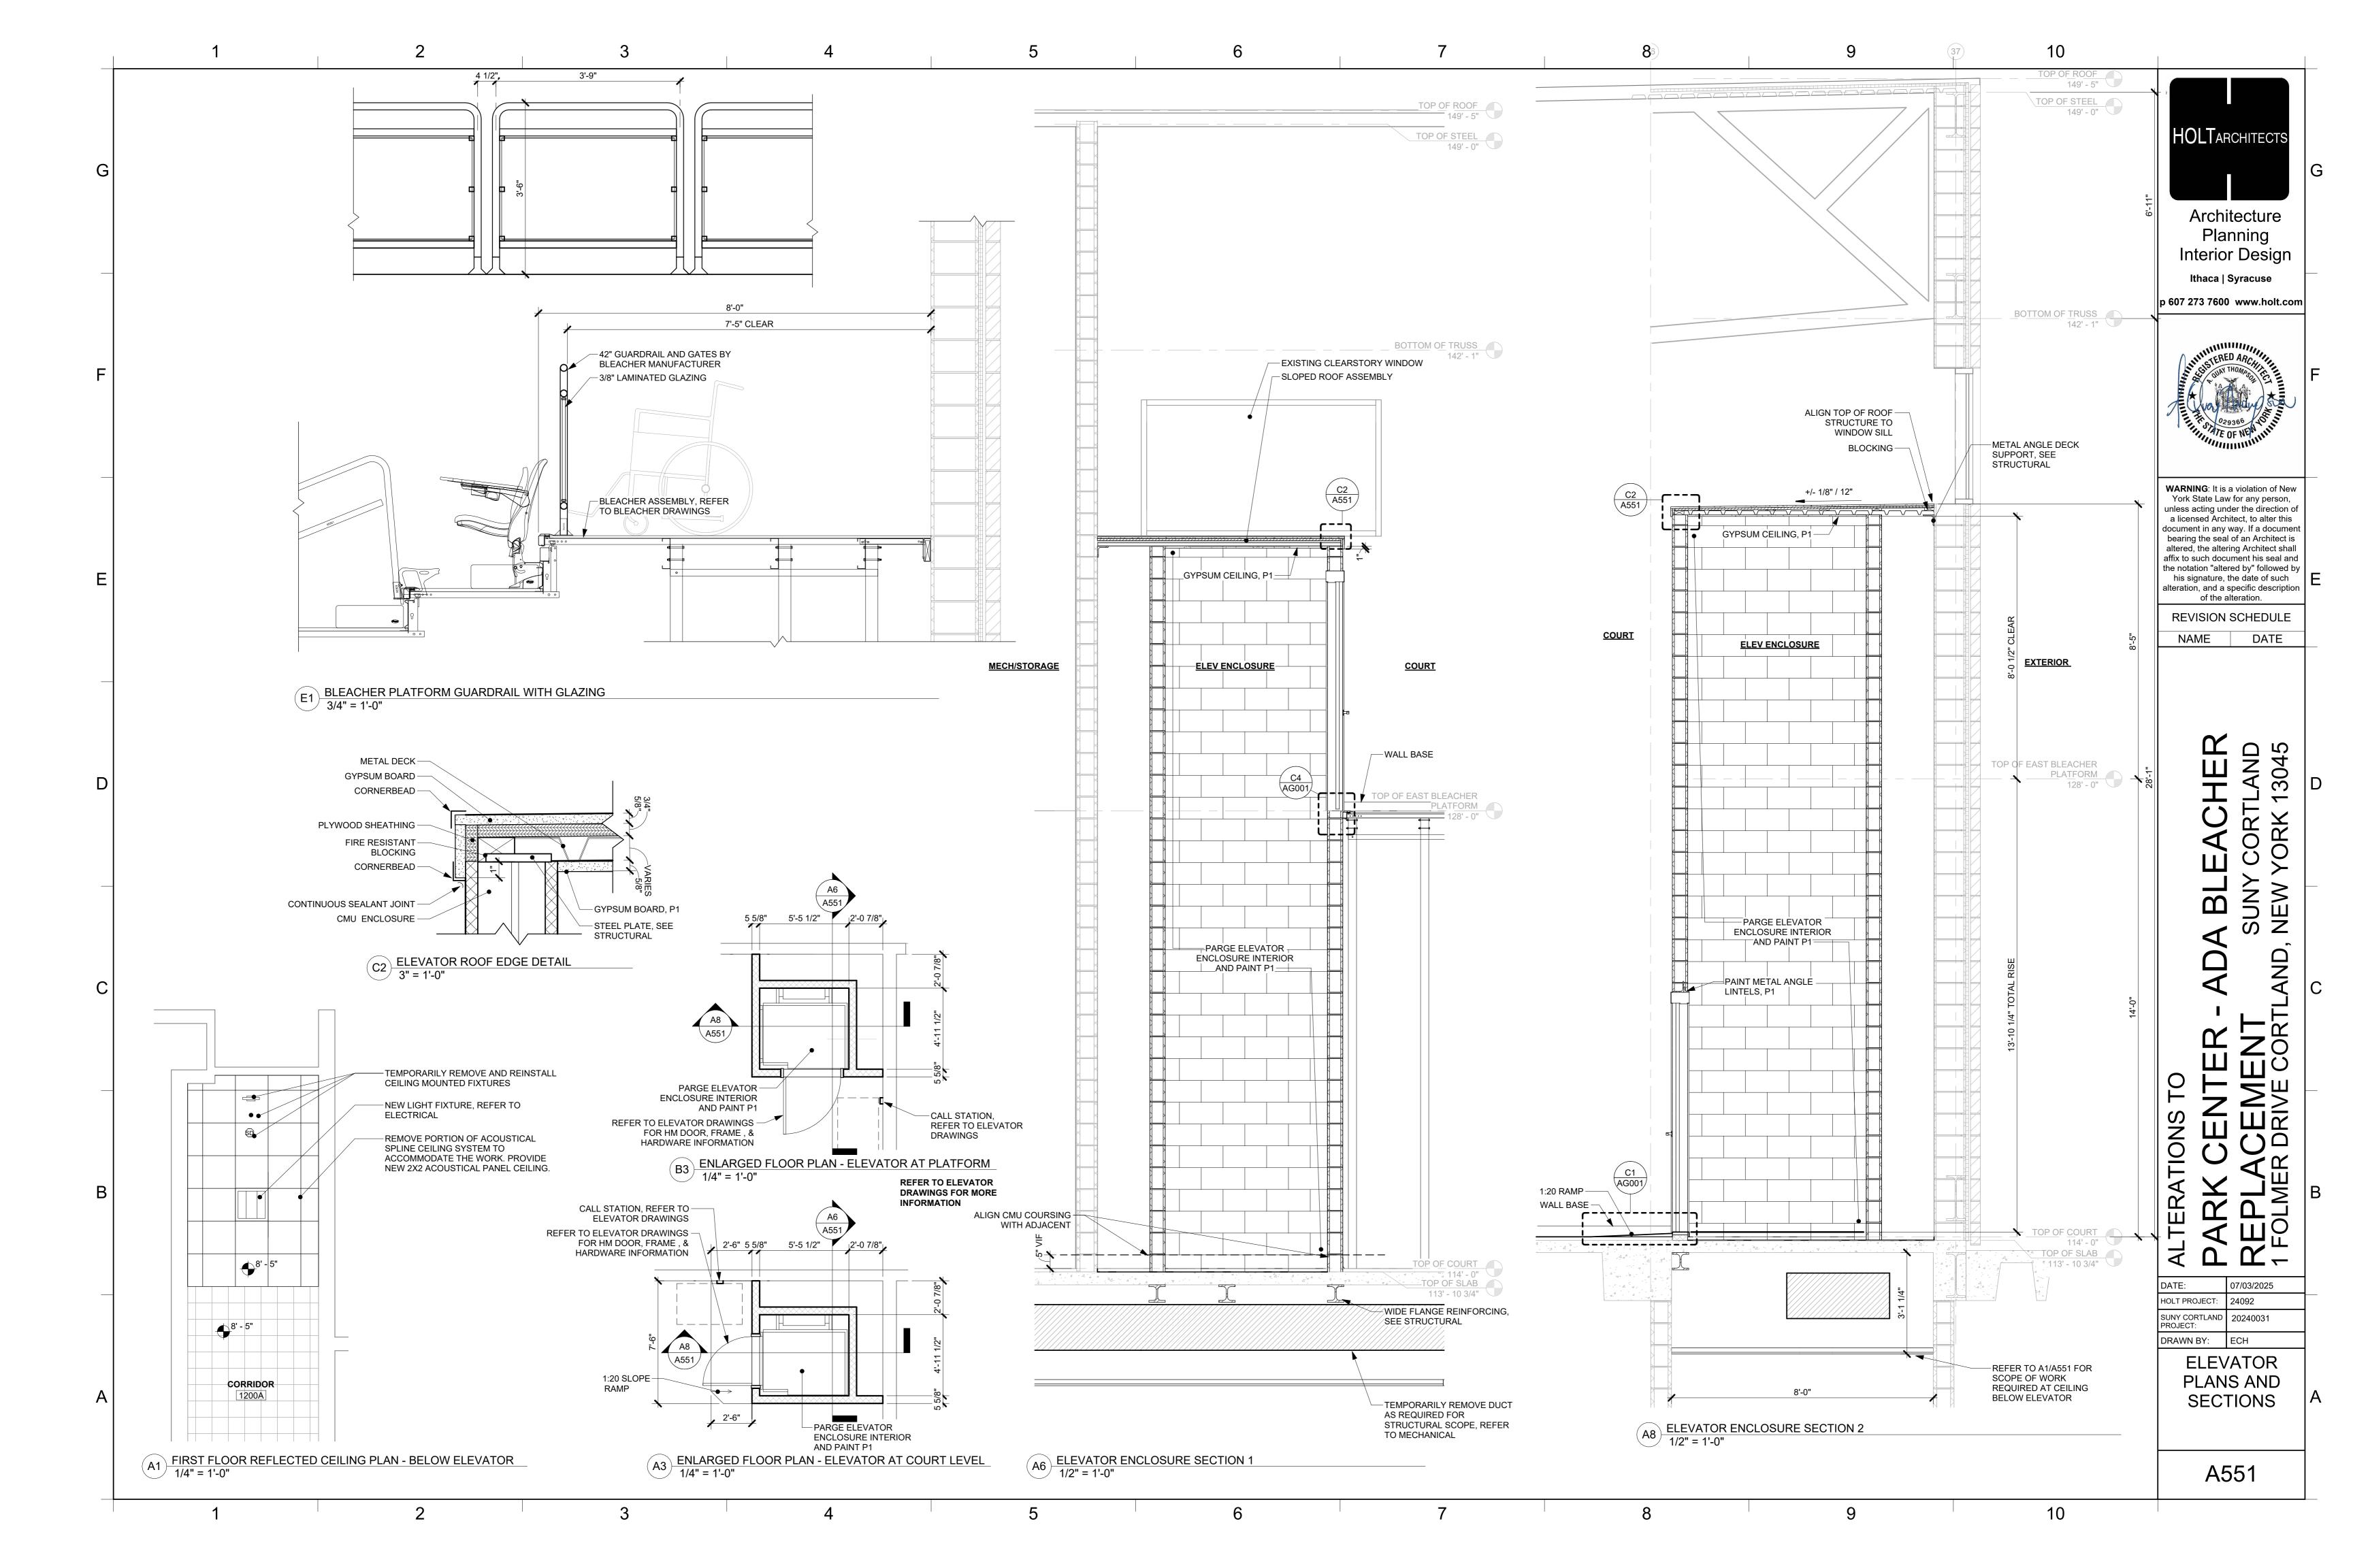

# **ELECTRICAL NOTES**

# E001 **GENERAL NOTES**

- 1. ALL WORK SHALL CONFORM TO THE 2020 EXISTING BUILDING CODE OF NEW YORK STATE, ALL ELECTRICAL WORK IN THE PROJECT AREA SHALL CONFORM TO THE 2017 NATIONAL ELECTRICAL CODE, THE 2020 FIRE CODE OF NEW YORK STATE, AND THE 2020 ENERGY CONSERVATION CODE OF NEW YORK STATE. THESE ARE THE APPLICABLE PORTIONS OF THE NYS UNIFORM FIRE PREVENTION AND BUILDING CODE AT THE TIME OF EXPECTED PERMIT ISSUE.
- 2. ALL WORK SHALL BE CONSTRUCTED IN ACCORDANCE WITH THE REQUIREMENTS OF THE OCCUPATIONAL HEALTH AND SAFETY ACT (OSHA) AS AMENDED AND THE REQUIREMENTS OF THE NEW YORK STATE DEPARTMENT OF LABOR.
- 3. ALL WORK SHALL CONFORM TO SUCF AND SUNY CORTLAND STANDARDS OF QUALITY, MATERIAL AND WORKMANSHIP, AS DETAILED ON THE DRAWINGS AND IN THE SPECIFICATIONS.
- 4. THE CONTRACTOR SHALL PROVIDE AN ELECTRICAL PERMIT, INSPECTION AND CERTIFICATE OF COMPLETION. THE CONTRACTOR SHALL PAY ALL FEES.
- 5. CONFORM TO UTILITY COMPANY RULES & REGULATIONS.
- 6. PROVIDE DETAILED SUBMITTALS FOR ALL MATERIALS AND EQUIPMENT PROVIDED UNDER THIS PROJECT.
- 7. PROVIDE OPERATION AND MAINTENANCE INFORMATION FOR ALL MATERIALS, EQUIPMENT AND SYSTEMS PROVIDED UNDER THIS PROJECT. SEE SPECIFICATIONS.
- 8. PROVIDE SIGNED, DATED, CONTRACTOR AS-BUILT DRAWINGS FOR ALL WORK PROVIDED UNDER THIS PROJECT. MAINTAIN ONE SET OF CONSTRUCTION DRAWINGS DENOTING ANY FIELD CHANGES WHICH ARE MADE AS THE WORK OF THE PROJECT PROGRESSES. KEEP THESE UPDATED. ENGINEER SHALL BE PERMITTED TO BORROW, PHOTOCOPY AND RETURN THESE DRAWINGS AT INTERVALS THROUGHOUT THE
- 9. COORDINATE LOCATIONS OF ELECTRICAL DEVICES AND ELEMENTS WITH OTHER TRADES' WORK.
- 10. ITEMS IDENTIFIED FOR "SALVAGE" SHALL BE REMOVED, PROTECTED, AND STORED FOR THE DURATION OF CONSTRUCTION BY THE CONTRACTOR FOR REINSTALLATION AS PART OF THE NEW WORK, UNLESS NOTED OTHERWISE.
- 11. CONFIRM WITH OWNER THAT MATERIALS HAVE BEEN TESTED AND CONFIRMED NEGATIVE FOR ASBESTOS PRIOR TO STARTING CONSTRUCTION PER NYS DOL PART
- 12. USE CAUTION WHEN CORE DRILLING FLOORS. VERIFY FOR OBSTRUCTIONS ON FLOORS PRIOR TO DRILLING. NOTIFY ARCH/ENGINEER PRIOR TO COMMENCING ANY TYPE OF DRILLING (TYP FOR ALL CORES).
- 13. STRUCTURAL STRENGTH OF METAL STUD WALLS SHALL NOT BE COMPROMISED BY EXCESSIVE DRILLING OR CUTTING FOR CONDUIT WORK. SINGLE HOLES SHALL BE DRILLED AT MIDDLE OF THE STUD AND SEPARATED BY SOLID METAL AT LEAST TWO DIAMETERS OF THE HOLE TO THE NEXT OPENING.
- 14. ALL ELECTRICAL OUTLETS, COMPUTER AND TELEPHONE OUTLETS/JACKS, SWITCHES, PULL STATIONS, THERMOSTATS, EXIT LIGHTS, AND ALL OTHER WALL MOUNTED ACCESSORIES SHALL BE ALIGNED VERTICALLY OR HORIZONTALLY WHEN IN CLOSE PROXIMITY. COORDINATION OF THIS ALIGNMENT SHALL BE THE RESPONSIBILITY OF THE GENERAL CONTRACTOR. LOCATIONS SHALL BE APPROVED BY THE ARCHITECT/ENGINEER. REFER TO ARCHITECTURAL DRAWINGS FOR EXACT LOCATIONS OF FIXTURES AND ELECTRICAL DEVICES. BRING ANY QUESTIONS OR DISCREPANCIES TO THE ATTENTION OF ENGINEER AND ARCHITECT PRIOR TO
- 15. EXISTING CIRCUITING SHOWN ON THESE DRAWINGS HAS BEEN DEVELOPED FROM RECORD DRAWINGS WHICH HAVE BEEN PARTIALLY FIELD VERIFIED. CONTRACTOR SHALL VERIFY CIRCUITING FOR ALL AFFECTED AREAS DURING CONSTRUCTION AND SHALL AMEND THIS DRAWING FOR RECORD AS NECESSARY. TRACE AND VERIFY ALL LOADS ON CIRCUITS INDICATED FOR REUSE.

# **REMOVAL NOTES**

- MAINTAIN CONTINUITY OF ALL EXISTING TO REMAIN ELECTRICAL CIRCUITS, AS REQUIRED.
- 2. FOR CIRCUITS INDICATED TO BE REMOVED, CONTRACTOR SHALL REMOVE ALL CONDUIT, BX, BOXES, AND CONDUCTORS IN ACCESSIBLE CHASE, CEILING SPACES AND WHERE EXPOSED. DO NOT ABANDON ANY SUCH CIRCUITS IN PLACE UNLESS BURIED IN WALLS OR CAST INTO CONCRETE AND INACCESSIBLE. DISCONNECT SUCH CIRCUITS AT BOTH ENDS AND PULL OUT ALL CONDUCTORS. CLOSE UP ALL SPARE UNCOVERED BOXES. PLUG ALL OPEN KNOCKOUTS.

# PATHWAY NOTES

- 1. ALL CONDUIT SHALL BE ELECTRICAL METALLIC TUBING (EMT). FLEXIBLE METALLIC CONDUIT (FMC) SHALL BE ALLOWED WHERE SHOWN. ALL BOXES SHALL BE METAL CONDUIT SIZE SHALL BE 3/4" MINIMUM EXCEPT WHERE SPECIFICALLY SHOWN 1/2" FOR SPECIAL CIRCUITS. NO MC PERMITTED EXCEPT WHERE FISHED INTO EXISTING WALLS FOR OUTLETS AND FOR WHIPS TO LIGHT FIXTURES ABOVE CEILINGS NOT OVER 6'-0" LONG.
- 2. SURFACE RACEWAY SHALL BE METALLIC WIREMOLD RACEWAY. SURFACE RACEWAY SHALL BE PERMITTED ONLY WHERE DESIGNATED ON THE PLANS. MINIMUM SIZE SHALL BE 700 SERIES.
- 3. EXPOSED CONDUIT IN FINISHED SPACED IS PERMITTED IN OPEN OR BAFFLED CEILINGS ONLY. NO EXPOSED CONDUIT ALLOWED ELSEWHERE EXCEPT WHERE SPECIFICALLY SHOWN. REFER TO ARCH DRAWINGS FOR WALL TYPES.
- 4. COORDINATE CONDUIT PATH WITH EXIST PIPING, DUCTWORK AND ELECTRICAL WIRING. EC MAY REUSE EXISTING CONCEALED CONDUIT PATHWAYS WHERE POSSIBLE UPON REVIEW AND APPROVAL BY ENGINEER/ARCHITECT

# CONDUCTOR NOTES

- 1. ALL CONDUCTORS SHALL BE STRANDED COPPER. ALL INSULATED POWER CONDUCTORS SHALL BE TYPE THHN-THWN, ALL FIRE ALARM CONDUCTORS SHALL BE STRANDED. STRANDED CONDUCTORS SHALL BE FIRMLY HELD UNDER DEVICE CAPTIVE CLAMP CONNECTORS PROVIDED BY THE MANUFACTURER.
- 2. BRANCH CIRCUITS: PROVIDE SEPARATE NEUTRALS FOR EACH RECEPTACLE AND POWER CIRCUIT. SHARED NEUTRALS ARE NOT TO BE USED.

# CIRCUITING NOTES

- WIRING SHOWN ON FLOOR PLANS AND DETAILS IS DIAGRAMMATIC TO SHOW TYPICAL CIRCUITING.
- 2. LOAD BALANCE: BALANCE SINGLE PHASE SERVICES TO 10% ON A AND B PHASES. BALANCE THREE PHASE SERVICES TO 20% ON INDIVIDUAL PANELS AND TO WITHIN 10% ON MAIN SERVICE. BALANCE SHALL BE CHECKED BOTH WITH ALL LOADS ON AND WITH NORMAL LOADS ON.
- 3. PROVIDE CIRCUIT NAMEPLATES FOR ALL NEW CIRCUITS. PROVIDE ENGRAVED NAMEPLATES FOR PANELS, TRANSFORMERS, DISCONNECT SWITCHES, MOTOR STARTERS AND CONTROL PANELS, PROVIDE TYPEWRITTEN PANEL DIRECTORY IN PANEL. PROVIDE DUPLICATE TYPEWRITTEN DIRECTORY ON AS-BUILT DRAWINGS.

# KEY TO SYMBOLS & DEVICE SPECIFICATIONS (2)

NOT TO SCALE

# **GENERAL**

- EXISTING WORK TO REMAIN (FAINT LINE)
- CONTRACT WORK (BOLD CONTINUOUS LINE)
- - CONNECT TO POINT DISCONNECT FROM POINT
- JUNCTION BOX J

# **POWER**

- ⇒ 20A, 120V DUPLEX RECEPTACLE
- DUPLEX GFCI 20A, 120V RECEPTACLE
- S DUPLEX GFCI 20A, 120V RECEPTACLE, SURGE SUPPRESSOR
- ♥ QUAD 20A, 120V RECEPTACLE
- ☐ DISCONNECT SWITCH
- PANELBOARD, FLUSH MOUNTED
- PANELBOARD, SURFACE MOUNTED
- HOMERUN TO PANEL LP1, CIRCUIT #3. 2 #12'S IN 3/4" CDT. FED FROM 20A-1P BKR. IS INTENDED UNLESS NOTED OTHERWISE. RUN GREENWIRE GROUND FOR ALL CIRCUITS. ONE GROUND PER RACEWAY SIZED FOR LARGEST CIRCUIT IS ACCEPTABLE.
- SPECIAL RECEPTACLE REFER TO DRAWING FOR SPECIFIC TYPES
- TOGGLE SWITCH, 20A

# LIGHTING

LIGHTING FIXTURES - LETTER INDICATES TYPE (SEE FIXTURE SCHEDULE).  $^{
m J}$ r1 fixtures noted 'nl' shall be circuited on emergency light circuit.

# EXIT SIGN -LIGHTED - PROVIDE FACES, MOUNTING & ARROWS AS

- CEILING-MOUNTED DUAL TECHNOLOGY ANALOG OCCUPANCY SENSOR SWITCH, WATTSTOPPER #DT-305 SERIES
- OCCUPANCY SENSOR POWER-PACK, WATTSTOPPER #BZ-150 SERIES
- STAND-ALONE, COMBINATION 0-10v DIMMER WALL SWITCH / DUAL TECH OCCUPANCY SENSOR, WATTSTOPPER #DW-311
- STAND-ALONE, COMBINATION WALL SWITCH / DUAL TECH OCCUPANCY SENSOR, WATTSTOPPER #DSW-301
- LOW VOLTAGE MOMENTARY SWITCH, WATTSTOPPER #LVSW-101

# TELECOM/AV

- COMPUTER OUTLET NUMBER INDICATES NUMBER OF PORTS
- AV APPEARANCE

# FIRE ALARM

- SMOKE DETECTOR 'R' ADJACENT TO DEVICE DENOTES ELEVATOR RECALL FUNCTION
- 区V15 NOTIFICATION DEVICE VISUAL ONLY NUMBER IS THE CANDELA OUTPUT SETTING - 'CLG' DENOTES CEILING MOUNTED
- AVA15 NOTIFICATION DEVICE AUDIBLE/VISUAL NUMBER IS THE CANDELA OUTPUT SETTING - 'CLG' DENOTES CEILING MOUNTED

# DOOR SECURITY

- CAR READER
- ELECTRIFIED HARDWARE
- ELECTRIFIED HARDWARE


# **ABBREVIATIONS**

- BKR BREAKER CCT/CKT CIRCUIT
- DIVISION DIV ELECTRICAL CONTRACTOR
- EMERGENCY LIGHT EMERGENCY LIGHTING CIRCUIT EMT ELECTRICAL METALLIC TUBING
- GROUND FAULT CIRCUIT INTERRUPTER G/GFI/GFCI LTG LIGHTING
  - NIGHT LIGHT (CONTINUOUS ON) RIGID GALVANIZED STEEL CONDUIT

FLEXIBLE METALLIC CONDUIT

RGS WEATHERPROOF UNO UNLESS NOTED OTHERWISE COMBINED SMOKE/FIRE DAMPER

# PROVIDE NAMEPLATES FOR ALL NEW FIRE ALARM DEVICES INSTALLED UNDER THIS PROJECT, INSTALL ON 4x4 JB COVER. PROVIDE SHOP DRAWING.

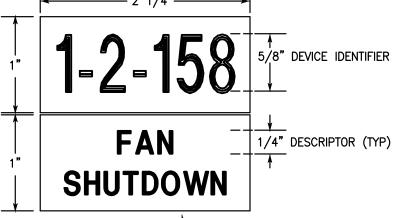


~ INDUSTRIAL VINYL PLASTIC NAMEPLATE -RED COLOR, WHITE LETTERS


**DEVICE NAMEPLATE** 

TYPICAL FIRE ALARM


SCALE: NOT TO SCALE

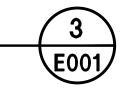



#### PROVIDE LABELS FOR ALL NEW FIRE ALARM DEVICES INSTALLED UNDER THIS PROJECT, INSTALL ON DEVICE. PROVIDE SHOP DRAWING.

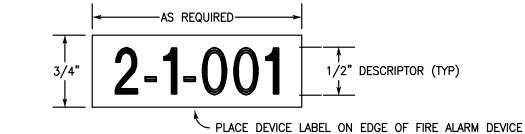


TYPICAL SMOKE/HEAT DETECTOR TAGGING DETAIL SCALE: NOT TO SCALE

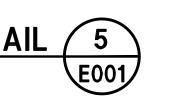

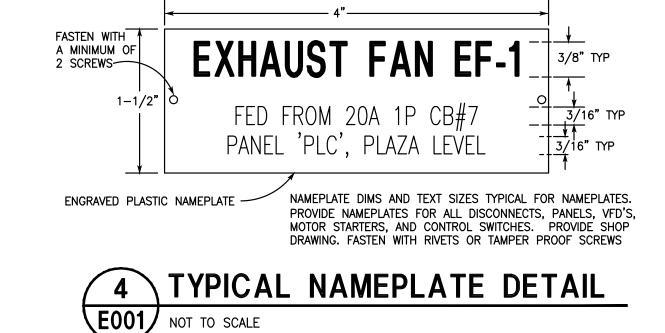

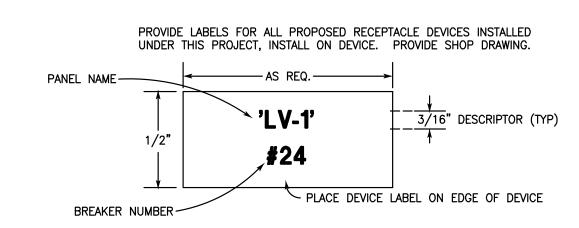

TYPICAL RECEPTACLE TAGGING DETAIL E001 NOT TO SCALE

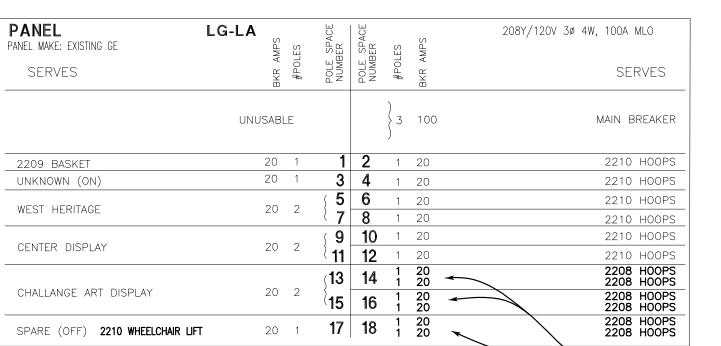

**EXISTING PANEL LG-LA** NOT TO SCALE

SUPPLY DATA

POLES CCT GND


EXISTING 40A CCT TO REMAIN

← EXISTING 40A CCT TO REMAIN


LG-LA | 20A/1P | 2#12 | 1#12 | 3/4" EMT

WIRE

 REMOVE EXISTING SQD TANDEM BREAKERS AND REPLACE WITH GE TANDEM BREAKERS LIST FOR USE WITH PANEL. EXISTING CCTS TO REMAIN

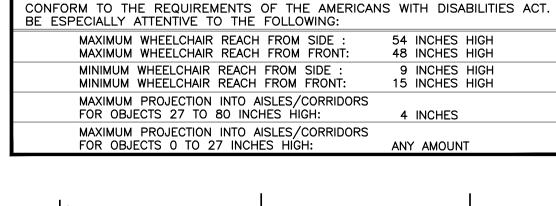

**ADA REQUIREMENTS** 

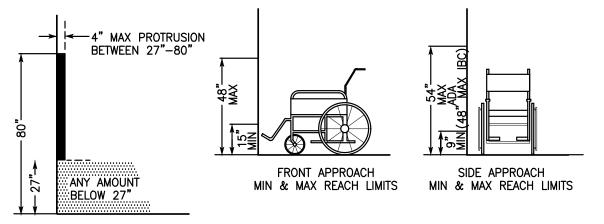

ADA REQUIREMENTS **E001** NOT TO SCALE

PROTRUDING OBJECTS

MAXIMUM PROJECTION

EQU	EQUIPMENT CIRCUITING & CONTROL SCHEDULE											
				CON	TROL	S & L	OCATIO	ON				
FUSED DISC SWITCH BY DIV 26	CIRCUIT BREAKER W/120VAC SHUNT TRIP BY DIV 26	FIRE ALARM CONTROL RELAY(S) BY DIV 28	CONNECTION BY DIV	UNIT STARTUP BY DIV	LIQUIDTIGHT FLEX AT FINAL CONN BY DIV	TOGGLE SWITCH DISCONNECT BY DIV 26	COMBINATION FUSED DISC. MAGNETIC STARTER & HOA SWITCH BY DIV 26	TEMP CONTROL BY DIV 23, INSTALL BY DIV 26	20AMP/1 POLE CCT & POWER RELAY BY DIV 26		ITEM #	REMARKS
30A AT UNIT	-	_	26	14	26	_	_	_	_	26	1	

(2) SEE PLANS FOR EXISTING CCT REVISIONS

(3) SEE PLANS FOR EXISTING CCT REVISIONS

	FI	XTURE	SCHEDUL	E
SYMBOL	TYPE & SIZE	VOLTS	LAMP(S)	MFR & MODEL
D1	12"ø SURFACE MOUNT LED DOWNLIGHT 12"ø x 1"D	120-277	LED MODULE, 3000K, 1500 DELIVERED LUMENS, 80 CRI	TGS THINTEK MINI RW MODEL 881215-RW-TM-CC OR EQUAL. MOUNT TO WIREMOLD V5739 SHALLOW FIXTURE BOX.
R1	2X2 RECESSED LED TROFFER 23-3/4"L x 23-/34"W x 3"D	120-277	LED MODULE, 3500K, 3000 DELIVERED LUMENS, 80 CRI	DAY-BRITE FLUXGRID MODEL 2FGG30L835-2-DS-UNV-DIM

CONFORM TO INDICATED DIMENSIONS RATHER THAN DIMENSIONS SCALED FROM DRAWING. GRAPHIC SCALE PROVIDED HEREIN FOR GENERAL INFORMATION AND TO CONFIRM WHEN DRAWING SIZE HAS BEEN REDUCED OR INCREASED IN REPRODUCTION.

HOLTARCHITECT Architecture Planning

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Fax: (315) 476-8305 email@pgengineers.com NYS PE LICENSE # 082424

**REVISION SCHEDULE** 

EXPIRES 06/30/2028

NAME DATE

# AND 3045 0

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DATE: 07/03/2025 HOLT PROJECT: 24092 SUNY CORTLAND | 20240031 PROJECT: M.A. PETERSON DRAWN BY:

ELECTRICAL

**EQUIPMENT** 

WHEELCHAIR LIFT

WEST BLEACHERS

EX EAST BLEACHERS

LOAD DATA

AMPS | VOLTS | PHASE |

120

208

208

12@1/2 20

12@1/2 20

SCHEDULES

NOTES &

HARDCAST ALUMA-GRIP 701 BRAND DUCT SEALANT. SEAL ALL JOINTS, SEAMS,

8. COORDINATE DUCTWORK WITH WORK OF OTHER CONTRACTORS. ROUGH IN DUCT RUNS

10. PROVIDE ONE REPRODUCIBLE SET OF DUCT AS-BUILT DRAWINGS IN AUTOCAD READABLE

11. PROVIDE VOLUME DAMPERS ON ALL TERMINAL DUCT BRANCHES UPSTREAM OF A DUFFUSER,

REGISTER OR GRILLE. THIS APPLIES TO SUPPLY, RETURN, AND EXHAUST AIR DUCT

FORMAT, SUCH AS DWG OR PDF MEDIA. OTHER AS-BUILTS MAY BE MARKED UP ON PAPER

CONNECTOR JOINT TO RIGID DUCT.

SETS. SEE SPECIFICATIONS.

PRIOR TO INSTALLATION OF ELECTRICAL.

9. DUCT LEAKAGE TESTS ARE REQUIRED ON THIS PROJECT.

CONNECTIONS, TRANSVERSE JOINTS, LONGITUDINAL JOINTS, BOTH FIELD AND SHOP FORMED

JOINTS. ALSO APPLY AT ALL CONNECTIONS TO EQUIPMENT, DIFFUSERS AND, FLEX JOINT

				FOR PIPE DIA. (INCHES)	
TYPE	OPERATING TEMPERATURE	PIPE INSULATION TYPE	FITTING INSULATION TYPE	LESS THAN 1" 1"≤D<1−1/2" 1−1/2"≤D<4" 4"≤D<8" 8" AND LARGER INSULATION WALL THICKNESS (INCHES) - NYS ENERGY CODE	NOTES
SUPPLY & OUTDOOR AIR DUCT	OA: -10°F TO 95°F SA: 55°F TO 75°F		1-1/2" THICK DUCT AN	FIBERGLASS DUCT WRAP WITH FSK FACING FOR ROUND ID 1-1/2" DUCTBOARD FOR RECTANGULAR DUCT	MAINTAIN VAPOR BARRIER
RETURN & GENERAL EXHAUST AIR DUCT INSULATION	ALL: 65°F TO 95°F	-		NONE	

DUCTWORK SCHEDULE											
SYSTEM	STATIC PRESSURE CLASS (IN. W.G.)	SEAL CLASS	LEAKAGE CLASS (CFM/SF @ 1" W.G.) RECTANGULAR/ROUND	MATERIALS	CONSTRUCTION						
GENERAL EXHAUST DUCTWORK	2"	А	12/6	GALVANIZED STEEL, THICKNESS PER SMACNA STANDARDS	SMACNA APPROVED STANDARD SHEET METAL CONSTRUCTION						
BATHROOM EXHAUST DUCTWORK	2"	Α	12/6	ALUMINUM, THICKNESS PER SMACNA STANDARDS	SMACNA APPROVED STANDARD SHEET METAL CONSTRUCTION						
SUPPLY AIR DUCTWORK	2"	Α	12/6	GALVANIZED STEEL, THICKNESS PER SMACNA STANDARDS	SMACNA APPROVED DOUBLE-WALL INSULATED SPIRAL						
RETURN AIR DUCTWORK	2"	Α	12/6	GALVANIZED STEEL, THICKNESS PER SMACNA STANDARDS	SMACNA APPROVED STANDARD SHEET METAL CONSTRUCTION						

CONFORM TO INDICATED DIMENSIONS RATHER THAN DIMENSIONS SCALED FROM DRAWING. GRAPHIC SCALE PROVIDED HEREIN FOR GENERAL INFORMATION AND TO CONFIRM WHEN DRAWING SIZE HAS BEEN REDUCED OR INCREASED IN REPRODUCTION.

Architecture Planning Interior Design Ithaca | Syracuse p 607 273 7600 www.holt.com Peterson Guadagnolo Consulting Engineers PC 476 East Brighton Avenue Syracuse, New York 13210-4144 Telephone: (315) 476-8311 Fax: (315) 476-8305 email@pgengineers.com NYS PE LICENSE # 082424 EXPIRES 06/30/2028 REVISION SCHEDULE NAME DATE ND 045 07/03/2025 HOLT PROJECT: 24092 SUNY CORTLAND | 20240031 PROJECT: DRAWN BY: M.A. PETERSON **MECHANICAL** NOTES & SCHEDULES M001

HOLTARCHITECT

10

FINNED TUBE RADIATION

OUTDOOR AIR

RETURN AIR

SUPPLY AIR

RADIANT PANEL

GALLONS PER MINUTE

TEMPERATURE CONTROL

MEDIUM PRESSURE STEAM

REFRIGERANT SUCTION

REFRIGERANT LIQUID

CONDENSATE DRAIN

WIRE MESH SCREEN

STAINLESS STEEL

INTEGRATED AUTOMATION CONTRACTOR

DIFFERENTIAL PRESSURE TRANSMITTER

LOW TEMPERATURE DETECTOR

STATIC PRESSURE TRANSMITTER

TEMPERATURE TRANSMITTER

VARIABLE FREQUENCY DRIVE

GLYCOL HOT WATER SUPPLY

GLYCOL HOT WATER RETURN

HEATING HOT WATER SUPPLY

HEATING HOT WATER RETURN


LOW PRESSURE STEAM SUPPLY

LOW PRESSURE CONDENSATE RETURN

GCWS GLYCOL CHILLED WATER SUPPLY

GCWR GLYCOL CHILLED WATER RETURN

END SWITCH

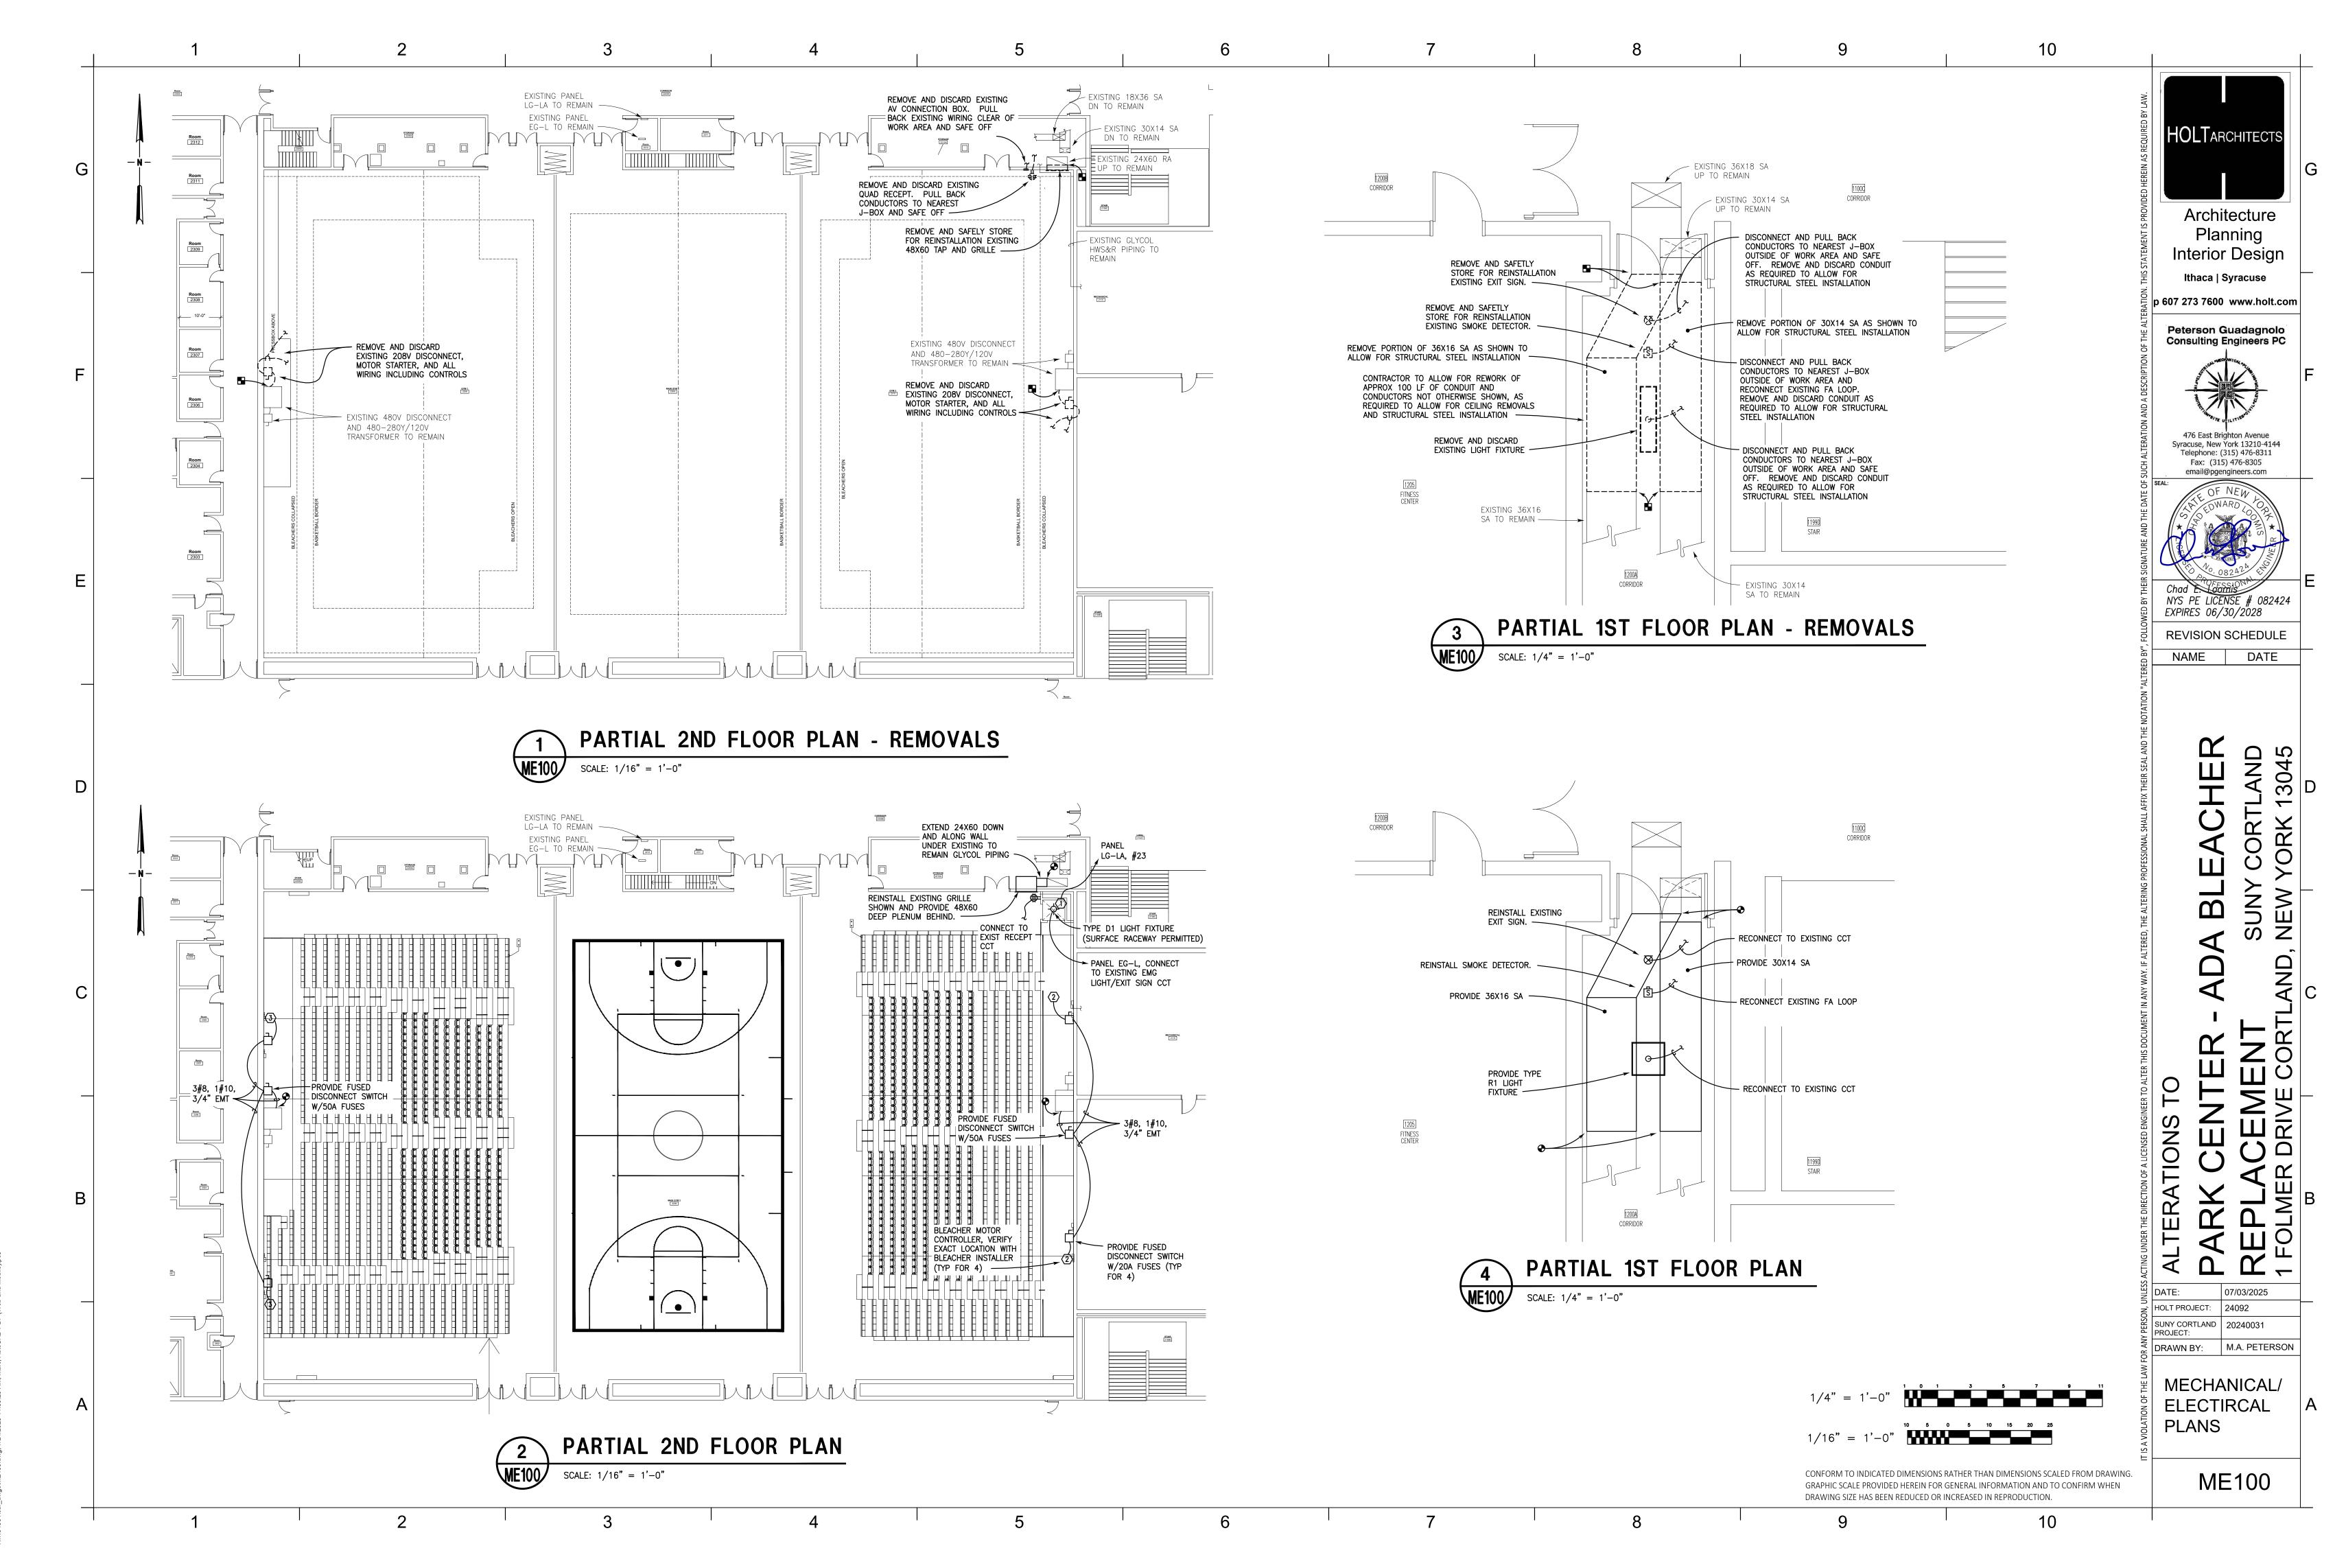

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# **General Notes**

- 1. ALL WORK SHALL CONFORM TO SUNY CORTLAND STANDARDS OF QUALITY, MATERIALS AND WORKMANSHIP.
- 2. ALL WORK SHALL CONFORM TO ALL APPLICABLE RULES, REGULATIONS, CODES AND STANDARDS INCLUDING BUT NOT LIMITED TO THE 2020 BUILDING CODE OF NEW YORK STATE, NFPA, OSHA, FEDERAL, STATE, AND LOCAL ORDINANCES, CODES, LAWS AND REGULATIONS. CONFORM STRICTLY TO THE AMERICAN SOCIETY OF MECHANICAL ENGINEERS PUBLICATION ASME A18.1, SAFETY STANDARD FOR PLATFORM LIFTS AND STAIRWAY CHAIRLIFTS 2014 EDITITION.
- RECORD DRAWINGS: MAINTAIN ONE SET OF CONSTRUCTION DRAWINGS DENOTING ANY FIELD CHANGES WHICH ARE MADE AS THE WORK PROGRESSES. PROVIDE THIS DRAWING SET TO THE ENGINEER AT THE COMPLETION OF THE PROJECT FOR REPRODUCTION.
- 4. BUILDING PERMIT: CONTRACTOR SHALL OBTAIN A ELEVATOR PERMIT BEFORE COMMENCING WORK. CONTRACTOR SHALL PAY ALL PERMIT EXPENSES. PROVIDE ELEVATOR INSPECTION AND CERTIFICATE. PAY ALL FEES.
- 5. ALL CUTTING AND PATCHING SHOWN ON THE DRAWINGS ARE THE RESPONSIBILITY OF THE CONTRACTOR REQUIRING THE OPENING.

# **Disposal Notes**

1. ALL DISCARDED MATERIAL, EQUIPMENT, ETC SHALL BE SORTED AND RECYCLED TO THE GREATEST EXTENT POSSIBLE. ANY MATERIALS, EQUIPMENT, ETC SHALL BE REMOVED FROM THE SITE BY THE CONTRACTOR, CLEANED OF ALL RESIDUAL LUBRICANTS, AND DISPOSED OF IN ACCORDANCE WITH BEST PRACTICES AND ALL ENVIRONMENTAL REGULATIONS


# Scope Of Work


- 1. PROVIDE AND INSTALL NEW VERTICAL PLATFORM LIFT IN SHAFT ENCLOSURE.
- 2. PROVIDE ALL WORK NECESSARY TO OBTAIN A FULLY OPERATIONAL PLATFORM LIFT SYSTEM INSPECTED AND ACCEPTED BY A STATE OF NEW YORK LICENSED ELEVATOR INSPECTOR WITH NO VIOLATIONS.
- 3. THIS WORK IS PLANNED FOR TBD CONSTRUCTION. INCLUDE ANY NECESSARY OVERTIME REQUIRED FOR COMPLETION OF WORK PRIOR TO TBD.


PLATFORM LIFT SCHEDULE																	
#	EQUIPMENT	DATA				ELECTRICAL			MINIMUM HOISTWAY CLEAR DIMENSIONS				IENSIC	ONS	MACHINE TYPE	BASIS OF DESIGN	
CAR		TOTAL RISE	STOPS	OPENING	SPEED	CAPACITY	VOLTAGE	HP	AMPS	HOISTWAY WIDTH	HOISTWAY DEPTH	PIT DEPTH	OVERHEAD CLEARANCE	ENTRA FRONT			
1	PROPOSED BLEACHER LIFT	14'-0"	2	1F 1S	20 FPM	750 LB	120	1	20	4'-11 1/2"	5'-5 5/16"	3" (SEE NOTES)	7'–10"	3'-0" X 7'-0"	3'-6" X 7'-0"	HYDRAULIC CHAIN-DRIVE VERTICAL PLATFORM LIFT	SAVARIA V-1504, GARAVENTA GENESIS, OR EQUAL


NOTES:


1. LIFT WILL SIT ON STRUCTURAL FLOOR SLAB. EXISTING GYM FLOOR HEIGHT IS 1-1/4"( $\pm$ ), SEE ARCH DWGS FOR ADDITIONAL RAMP DETAIL.

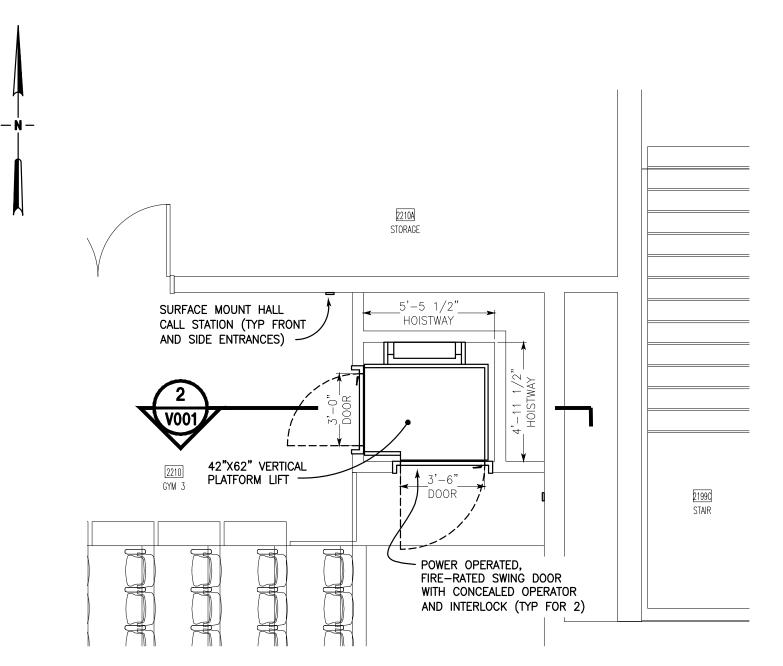

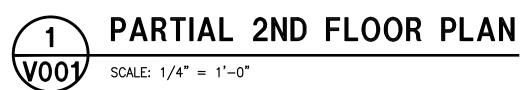

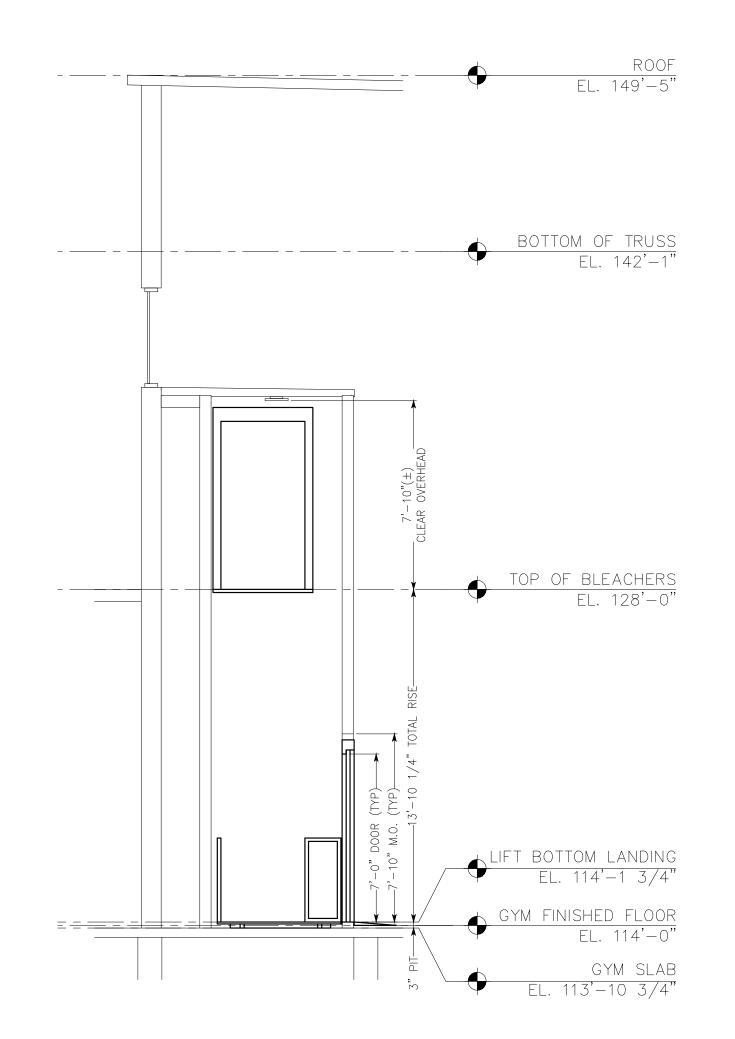

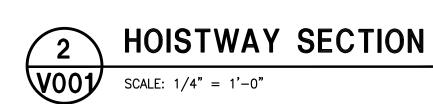

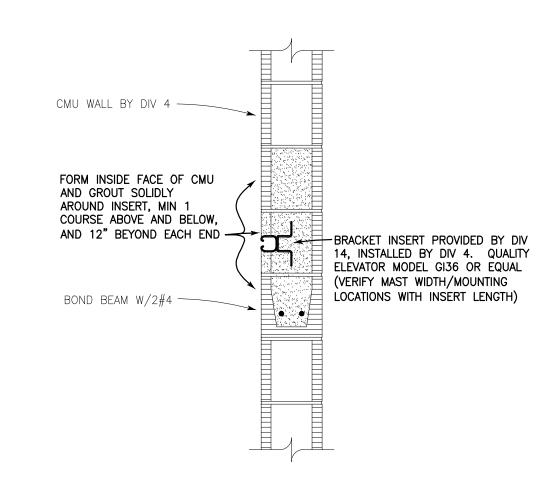





CONFORM TO INDICATED DIMENSIONS RATHER THAN DIMENSIONS SCALED FROM DRAWING.
GRAPHIC SCALE PROVIDED HEREIN FOR GENERAL INFORMATION AND TO CONFIRM WHEN
DRAWING SIZE HAS BEEN REDUCED OR INCREASED IN REPRODUCTION.

p 607 273 7600 www.holt.com Peterson Guadagnolo **Consulting Engineers PC** Syracuse, New York 13210-4144 Telephone: (315) 476-8311 Fax: (315) 476-8305 email@pgengineers.com NYS PE LICENSE # 082424 EXPIRES 06/30/2028 REVISION SCHEDULE NAME DATE HOLT PROJECT: 24092 SUNY CORTLAND 20240031 PROJECT:

M.A.PETERSON

PLATFORM

LIFT PLAN,

NOTES, &

SCHEDULE

V001

DRAWN BY:

**HOLT**ARCHITECTS

Architecture

Planning

Interior Design

Ithaca | Syracuse

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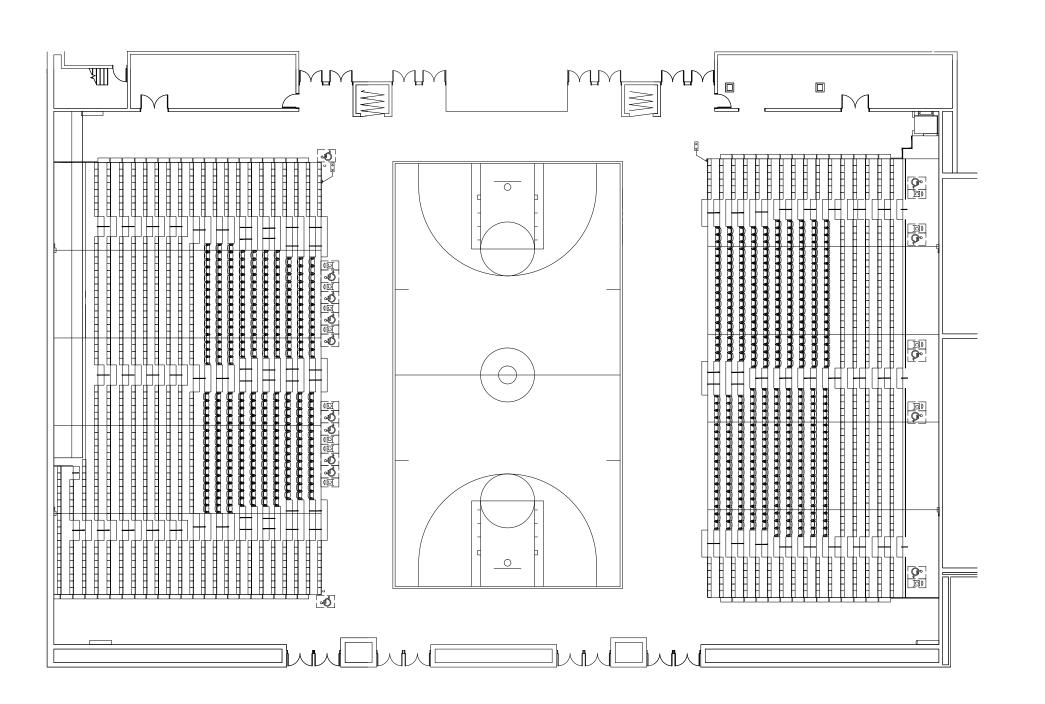
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# FOR REFERENCE ONLY





38 DYER STREET EXT. NORTH BERWICK, ME. 03906 TELEPHONE: (207) 676-2271 FAX: (207) 676-9815

#### IMPORTANT

THIS PLAN HAS BEEN DRAWN IN ACCORDANCE WITH THE THIS PLAN HAS BEEN DRAWN IN ACCORDANCE WITH THE INFORMATION SUPPLIED BY THE ARCHITECT, AND/OR DEALER. HUSSEY SEATING CO. DOES NOT ACCEPT ANY RESPONSIBILITY FOR THE ACCURACY, OR RELEVANCE, SHOULD THERE BE ANY DEVIATION FROM THE INFORMATION SUPPLIED WITHOUT THE APPROVAL OF HUSSEY SEATING CO.

#### GENERAL NOTES

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- THE LAYOUT SHOWN IS DRAWN PER HUSSEY SEATING CO. INTERPRETATION OF: IBC 2021 IN A BUILDING THAT ISNOT SMOKE PROTECTEDPLEASE VER

IF NO OTHER CODE IS INDICATED, IT IS ASSUMED THAT

THE DEALER/ARCHITECT IS AWARE OF THE CODE APPLIED TO THE LAYOUT SHOWN, AND THAT HUSSEY SEATING CO. CANNOT BE HELD RESPONSIBLE IF ANY DEVIATION OCCURS.

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N	CONSTRUCTION	FOR	Tol
	PRELIMIN	ARY	

HUSSEY SEATING CO. NOT FOR CONSTRUCTION

> TOTAL SEATS 1807

PLEASE VERIFY BUILDING CODE AND SMOKE PROTECTION

REVISIONS Field Check

DESCRIPTION

## NICKERSON NY LLC

PHONE: (631) 666-0200 11 MOFFITT BOULEVARD FAX: (631) 666-2667 PO BOX 5751 BAY SHORE, NY 11706 EMAIL: rkeller@nickersoncorp.com

KEY PLAN SUNY CORTLAND CORTLAND, NY

DRAWN BY: AJDDATE: 7/11/2025

СНКО ВҮ: Х

MODIFIED: 7/11/2025 4:14 PM PLOTTED: 7/11/2025 4:15 PM

DATE: X

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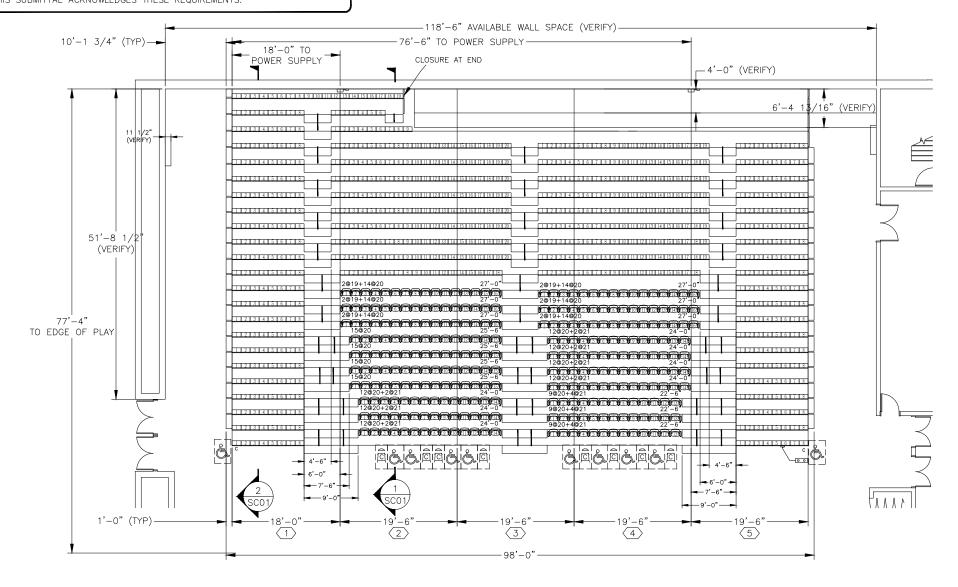
KP01

#### IMPORTANT NOTE REGARDING ACCESSIBILITY COMPLIANCE

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# FOR REFERENCE ONLY





BANK A 1011 SEATS ON STAND, MAX. CAPACITY

		INTE	GRAL POWE	R SUMMAR	2Y				
BANK LETTER		PWR FRAME MODEL	CONTROL: PENDANT/KEY	POWER SUPF 1ST LOC.	PLY LOCATION 2ND LOC.	SERVICE LIGHT			
Α	10	PF4	PENDANT	18'-0"	76'-6"	YES			
		POV	VER SPECIE	TICATIONS					
POWER	R SUPPLY	<u> DETAIL:</u> (2	POWER SUPF	LIES)					
Ę FLO	PROVID  NTROL BOX  TO BE 5'-C  DOR. (CONNE	CTOR CORD	T/ (TYP 2 PLCS)	NON-FUSE SUPPLY (B)	OCKING DISCONNE ID (BY E.C.) SEAT Y E.C.) SEE ELECT ONS (TYP 2 PLCS	TING POWER TRICAL			
EACH MI REF. INT POWER 120/208 POWER	ELECTRICAL SPECIFICATIONS:  EACH MOTOR: 1/2HP, 120/208V, THREE PHASE, 1.25 SERVICE FACTOR REF. INTEGRAL POWER SUMMARY CHART FOR QUANTITIES. POWER SUPPLY: (SUPPLIED BY ELECTRICAL CONTRACTOR)(E.C.) 120/208 VOLTS, 20 AMPS, 3 PHASE, 4 CONDUCTORS + GROUND POWER SUPPLY MUST BE ON A DEDICATED CIRCUIT. MAXIMUM ALLOWABLE FULL LOAD VOLTAGE DROP IS 4 %.								

TITEL PARTE ATTICLE

ACCIDE	GODIEG				DIMIGII GGUDDIUE	MEMBO		iL
ACCES	SORIES				FINISH SCHEDULE	: METRO		REV
1. 1ST TIER INTEGRAL POWER: W/PENDANT CONTROL	13.	SEAT			METRO			RE
T. 131 HER INTEGRAL FOWER. WY ENDANT CONTROL	13.	CONTOU	JR PLASTIC BA	ACKREST	NONE			Fiel
2. INTERMEDIATE AISLE STEP(S) WITH NON-SLIP	14.	RAILS			983 BLACK			By:
TREAD		PANELS			FRONT: N/A	REAR: N/A	END: N/A	H
<ol><li>FRONT SURE-STEP(S) WITH NON-SLIP TREAD</li></ol>	15.	END CU	JRTAINS		N/A			il
4 4015 041(0) 441444 0410 4040 (4040 70 04114)	10	DECKIN	G (MXM26)		N/A			PHON
4. AISLE RAIL(S) MAXAM PLUS ARAR (MRAR T2 ONLY)	16.	DECKIN	G (MXMPLUS)		3/4"[19] AC PLYWOOD	WITH 2 COATS OF CLE	AR POLYURETHANE	F/
5. 2 - SELF STORING RAILED ENDS	17.	CARPET			N/A			EM/
		UNDERS	STRUCTURE		BLACK ALKYD ENAMEL			╟─
6. METRO CHAIRS	18.	NOSES,	RISERS & SKI	IRT PANELS	SILVER ZINC ALLOY MAT	TE		ll Pi
		STEPS			SILVER ZINC ALLOY MAT	TE		ll st
7. 7' REAR CROSS AISLE	19.				FIRST ROW SCI	HEDIILE		ll č
8. 6 - VERTICAL REMOVABLE END RAILS	20.							# ~`
O. O VENTIONE NEWOVABLE END NAIES	20.			D WITH 1	' START IN SECTION	INDICATED, END IN	ADJACENT SECTION	DR
9. 1 - MAXAM26 P-RAIL	21.	BANK	SECTION		МО	DULE LAYOUT		
		Α	1		F	PF4, PF4		СН
10. END CLOSURE	22.	Α	2		F	PF4, PF4		╟─
11. CATCHMENT AISLE(S)	0.7	Α	3		F	PF4, PF4		11 .
II. CAICHMENT AISLE(S)	23.	Α	4		F	PF4, PF4		1/
12.	24.	A	5			PF4, PF4		11
		/ \				1 1, 1 1 1		11
								Λ_

YOUR PARTNER FOR SEATING SOLUTIONS

38 DYER STREET EXT. NORTH BERWICK, ME. 03906 TELEPHONE: (207) 676-2271 FAX: (207) 676-9815


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#### GENERAL NOTES

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  INTERP
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# BANK SUMMARY

MODEL: MAXAM PLUS STAND TYPE: WALL ATTACHED RISE: SEE SECTION VIEW ROW SPACING: SEE SECTION VIEW

FIELD SUMMARY (REQUIRED WITH FIELD CHECK)

FLOOR CONSTRUCTION: WOOD
WALL CONSTRUCTION: CONCRETE BLOCK

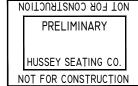PLEASE VERIFY BUILDING CODE AND SMOKE PROTECTION

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l	REV.	СНК	DATE	DESCRIPTION
1	RE\	/ISIO	NS	
1	Field	Chec	k	Approval

NICKERSON NY LLC HONE: (631) 666-0200 11 MOFFITT BOULEVARD

FAX: (631) 666-2667 PO BOX 5751 EMAIL: rkeller@nickersoncorp.com BAY SHORE, NY 11706

PLAN OF SEATING: BANK A SUNY CORTLAND CORTLAND, NY

DRAWN BY: AJD DATE: 7/11/2025DATE: XСНКД ВҮ: X

MODIFIED: 7/11/2025 4:14 PM 1/16" [2] = 1'-0" [305] PLOTTED: 7/11/2025 4:15 PM Q516943\_OPT5 FP01

## IMPORTANT NOTE REGARDING ACCESSIBILITY COMPLIANCE

THE BUILDING CODE REQUIRES THAT A DEFINED NUMBER OF ACCESSIBLE SEATING LOCATIONS WITH COMPANION CHAIRS, BE INTEGRATED INTO THE SEATING BANK. ON THE LAYOUTS PROVIDED 15 ACCESSIBLE SEATS ARE REQUIRED; 5 ARE PROVIDED. THE REMAINING REQUIRED ACCESSIBLE LOCATIONS ARE TO BE PROVIDED ELSEWHERE IN THE SEATING SPACE. APPROVAL OF THIS SUBMITTAL ACKNOWLEDGES THESE REQUIREMENTS.

# FOR REFERENCE ONLY



YOUR PARTNER FOR SEATING SOLUTIONS 38 DYER STREET EXT.

NORTH BERWICK, ME. 03906 TELEPHONE: (207) 676-2271 FAX: (207) 676-9815

#### **IMPORTANT**

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NOT FOR CONSTRUCTION **PRELIMINARY** HUSSEY SEATING CO.

NOT FOR CONSTRUCTION

#### BANK SUMMARY

MODEL: MAXAM PLUS STAND TYPE: WALL ATTACHED RISE: SEE SECTION VIEW ROW SPACING: SEE SECTION VIEW

FIELD SUMMARY (REQUIRED WITH FIELD CHECK)

FLOOR CONSTRUCTION: WOOD
WALL CONSTRUCTION: CONCRETE BLOCK

PLEASE VERIFY BUILDING CODE AND SMOKE PROTECTION

CHK DATE

VISIONS Check Approval By: \_ Date:

NICKERSON NY LLC

NE: (631) 666-0200 AX: (631) 666-2667

PO BOX 5751 IL: rkeller@nickersoncorp.com BAY SHORE, NY 11706


DESCRIPTION

11 MOFFITT BOULEVARD

LAN OF SEATING: BANK B JNY CORTLAND ORTLAND, NY

AWN BY: AJD DATE: 7/11/2025

DATE: XKD BY: X MODIFIED: 7/11/2025 4:14 PM 6" [2] = 1'-0" [305] PLOTTED: 7/11/2025 4:15 PM Q516943\_OPT5 FP02

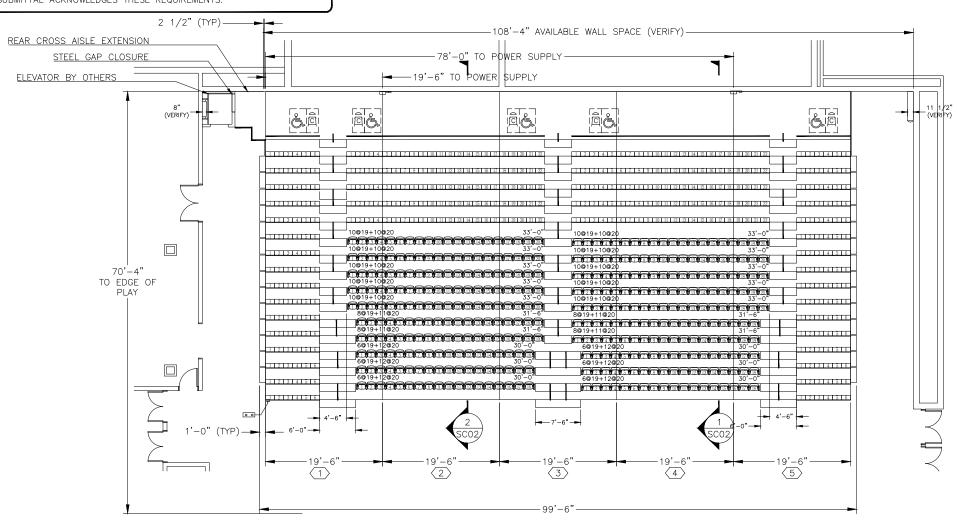

BANK B 796 SEATS ON STAND, MAX. CAPACITY

BANK LETTER	NO. OF MOTORS		CONTROL: PENDANT/KEY	POWER SUPF 1ST LOC.	PLY LOCATION 2ND LOC.	SERVICE LIGHT
В	10	PF4	PENDANT	19'-0"	78'-0"	YES
		POV	VER SPECIE	FICATIONS		
CO Q FLC	CONNE PROVID NTROL BOX TO BE 5'-C DOR. (CONNE	CTOR CORD ED BY HSC PROVIDED BY HS "[1524] ABOVE ECTION BY E.C.)	T/ (TYP 2 PLCS)	MANUAL LO NON-FUSE SUPPLY (B'	DCKING DISCONNE D (BY E.C.) SEAT Y E.C.) SEE ELECT ONS (TYP 2 PLCS	TING POWER TRICAL
EACH M REF. INT POWER 120/200	OTOR: 1/21 TEGRAL POWN SUPPLY: (S B VOLTS, 20 SUPPLY MUS	ER SUMMARY CHA SUPPLIED BY ELEC AMPS, 3 PHASE ST BE ON A DED	HREE PHASE, 1.25 RT FOR QUANTITIES CTRICAL CONTRACTO , 4 CONDUCTORS	S. DR)(E.C.) + GROUND		

INTEGRAL POWER SUMMARY

			_						Ш	H
	ACCES	SORIES				FINISH SCHEDUL	E: METRO		REV.	 c
1.	1ST TIER INTEGRAL POWER: W/PENDANT CONTROL	13.	SEAT			METRO			RE	:VIS
	To the time of time of time of the time of time of time of time of the time of tim		CONTOL	JR PLASTIC B.	ACKREST	NONE			Field	d C
2.	INTERMEDIATE AISLE STEP(S) WITH NON-SLIP	14.	RAILS			983 BLACK			By:	
	TREAD		PANELS			FRONT: N/A	REAR: N/A	END: N/A	I	_
3.	FRONT SURE-STEP(S) WITH NON-SLIP TREAD	15.	END CU	JRTAINS		N/A				
	HOLE BALL (O) MAYAN BUILD ABAB (MBAB TO CALLY)		DECKIN	G (MXM26)		N/A			PHON	1Ε:
4.	AISLE RAIL(S) MAXAM PLUS ARAR (MRAR T2 ONLY)	16.	DECKIN	G (MXMPLUS)		3/4"[19] AC PLYWOOD	WITH 2 COATS OF	CLEAR POLYURETHANE	F.A	٩X:
5	2 - SELF STORING RAILED ENDS	17.	CARPET			N/A			EMA	AL:
•	E SEE STOTME THEED ELIDO		UNDERS	STRUCTURE		BLACK ALKYD ENAMEL			Т	_
6.	METRO CHAIRS	18.	NOSES,	RISERS & SK	IRT PANELS	SILVER ZINC ALLOY MA	ATTE		∏ PI	ĹΑ
			STEPS			SILVER ZINC ALLOY MA	ATTE		l st	
	8' REAR CROSS AISLE WITH FRONT RAILS (INFILL BY OTHERS)	19.				FIRST ROW SO	CHEDULE		Co	
8.	STEEL GAP CLOSURE	20.	MODU	LES DENOTE	ED WITH "	*' START IN SECTION	INDICATED, END	) IN ADJACENT SECTION	1-	_
9.	5 - VERTICAL REMOVABLE END RAILS	21.	BANK	SECTION		М	ODULE LAYOUT		DRA	4WV
			В	1			PF4		СН	KD.
10	. CATCHMENT AISLE(S)	22.	В	2			PF4		<u>                                    </u>	
11	. REAR CROSS AISLE EXTENSION	23.	В	3			PF4		1 1/	/16'
	TREAT GROSS AIGE EXTENSION	23.	В	4			PF4		<b>I</b> ⊢′	10
12		24.	В	5			PF4		1	
									1	



WALL ATTACHED BLEACHERS REQUIRE STRUCTURAL SUPPORT FROM THE BUILDING WALLS. THE ATTACHMENT WALL MUST BE CAPABLE OF SUPPORTING THE IMPOSED LOADS.

#### EXPECTED PULLOUT LOAD PER LF NORMAL TO THE WALL IS:

4 RISERS @ 11 5/8"

 $= 3'-1_0 1/2"$ 

LOAD (PLF)	65	90	115	139	164
UP TO TIERS	10	15	20	25	30

# FOR REFERENCE ONLY



38 DYER STREET EXT. NORTH BERWICK, ME. 03906 TELEPHONE: (207) 676-2271 FAX: (207) 676-9815

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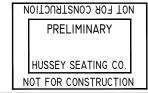
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    INTERPRETATION OF:

    INTERPRETATION OF:

    IN A BUILDING THAT ISNOT SMOKE PROTECTEDPLEASE VERIFY
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### BANK SUMMARY

MODEL: MAXAM PLUS STAND TYPE: WALL ATTACHED RISE: 9 5/8" (T1-T16) 11 5/8" (T17-T20) ROW SPACING: 31" (T1-T16) 33" (T17-T20)

FIELD SUMMARY (REQUIRED WITH FIELD CHECK)

FLOOR CONSTRUCTION: WOOD
WALL CONSTRUCTION: CONCRETE BLOCK




SECTION VIEWS: BANKS A SUNY CORTLAND CORTLAND, NY

Q516943\_OPT5

DRAWN BY: AJD DATE: 7/11/2025DATE: XСНКО ВУ: Х MODIFIED: 7/11/2025 4:14 PM AS NOTED PLOTTED: 7/11/2025 4:15 PM


SC01

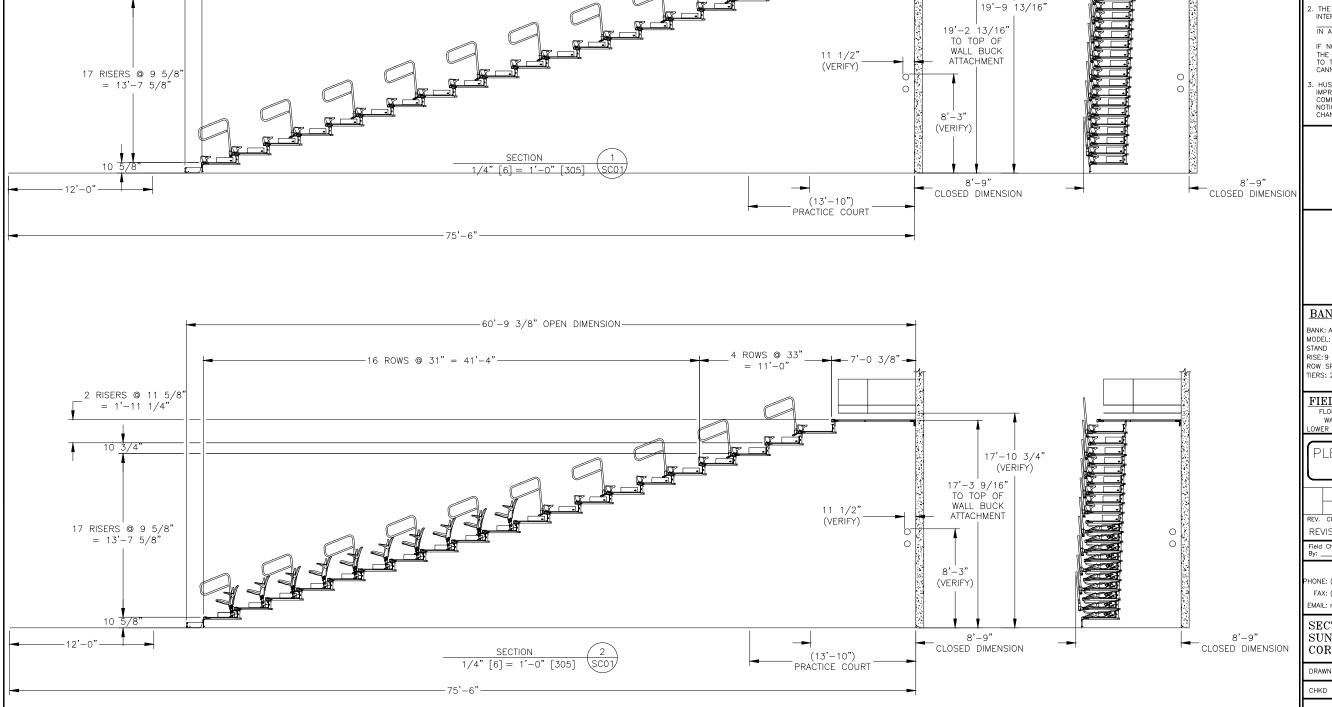

6 ROWS @ 33"

-60'-9 3/8" OPEN DIMENSION-

-16 ROWS @ 31" = 41'-4"-

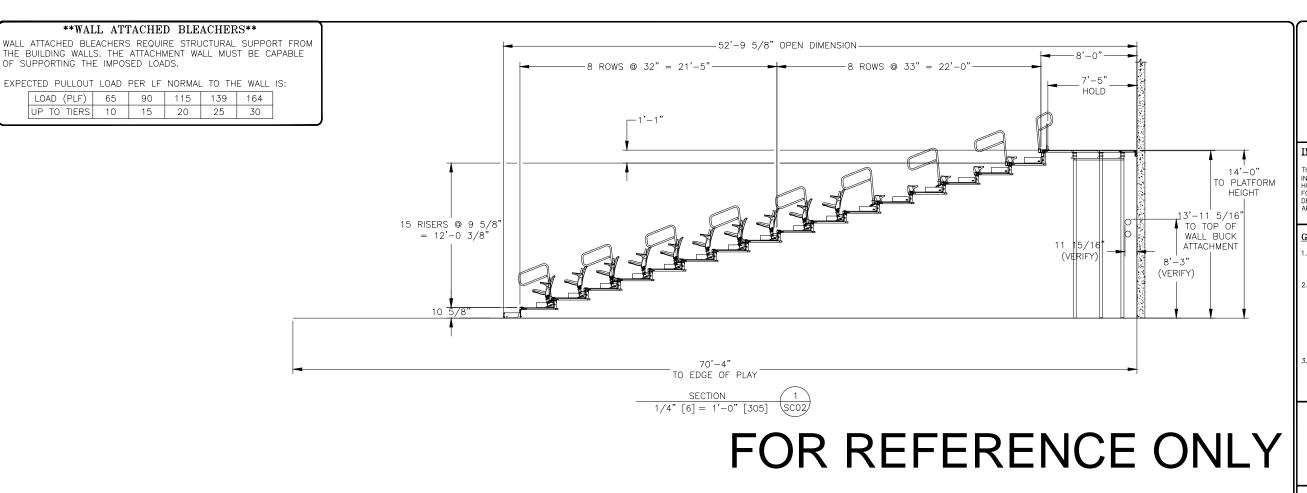



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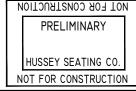
TELEPHONE: (207) 676-2271 FAX: (207) 676-9815

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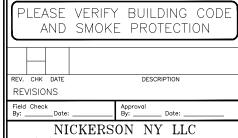


# BANK SUMMARY

MODEL: MAXAM PLUS STAND TYPE: WALL ATTACHED RISE: 9 5/8" (T1-T15) 13" (T16) ROW SPACING: 32" (T1-T8) 33" (T9-T16)

# FIELD SUMMARY (REQUIRED WITH FIELD CHECK)

WALL CONSTRUCTION: CONCRETE BLOCK



#### HONE: (631) 666-0200 11 MOFFITT BOULEVARD PO BOX 5751

FAX: (631) 666-2667 EMAIL: rkeller@nickersoncorp.com BAY SHORE, NY 11706

SECTION VIEWS: BANKS B SUNY CORTLAND

CORTLAND, NY DRAWN BY: AJD DATE: 7/11/2025

CHKD BY: XMODIFIED: 7/11/2025 4:14 PM AS NOTED PLOTTED: 7/11/2025 4:15 PM Q516943\_OPT5 SC02

