

# HAMMONDSPORT CENTRAL SCHOOL DISTRICT

## 2025 CAPITAL IMPROVEMENTS PROJECT

8272 MAIN STREET HAMMONDSPORT, NEW YORK, 14840

### CONSTRUCTION DOCUMENTS

#### LIST OF DRAWINGS:

##### DRAWING VOLUME: 1

##### GENERAL DRAWINGS

G1.1	SYMBOLS AND ABBREVIATIONS
<b>CODE COMPLIANCE DRAWINGS</b>	
MB-C01.1	CODE COMPLIANCE
MB-C01.2	SITE CODE COMPLIANCE PLAN

##### SITE DRAWINGS

MB-L0.1	SITE EXISTING CONDITIONS PLAN
MB-L0.2	SITE EXISTING CONDITIONS PLAN
MB-L0.3	SITE EXISTING CONDITIONS PLAN
MB-L0.4	SITE EXISTING CONDITIONS PLAN
MB-L1.1	SITE DEMOLITION PLAN
MB-L1.2	SITE DEMOLITION PLAN
MB-L1.3	SITE DEMOLITION PLAN
MB-L1.4	SITE DEMOLITION PLAN
MB-L2.1	SITE IMPROVEMENT PLAN
MB-L2.2	SITE IMPROVEMENT PLAN
MB-L2.3	SITE IMPROVEMENT PLAN
MB-L2.4	SITE IMPROVEMENT PLAN
MB-L3.1	SITE GRADING AND UTILITY PLAN
MB-L3.2	SITE GRADING AND UTILITY PLAN
MB-L3.3	SITE GRADING AND UTILITY PLAN
MB-L3.4	SITE GRADING AND UTILITY PLAN
MB-L4.1	SITE DETAILS
MB-L4.2	SITE DETAILS
MB-L4.3	SITE DETAILS
MB-L5.1	SITE EROSION AND SEDIMENT CONTROL PLAN
MB-L5.2	SITE EROSION AND SEDIMENT CONTROL PLAN
MB-L5.3	SITE EROSION AND SEDIMENT CONTROL PLAN
MB-L5.4	SITE EROSION AND SEDIMENT CONTROL PLAN
MB-L6.1	SITE EROSION AND SEDIMENT CONTROL DETAILS

##### STRUCTURAL DRAWINGS

MB-S0.1	STRUCTURAL GENERAL NOTES
MB-S0.2	DEMO PLANS
MB-S1.1	FOUNDATION PLAN - AREAS A & B
MB-S1.2	LOW ROOF FRAMING PLAN - AREA A
MB-S1.3	LOW ROOF FRAMING PLAN - AREAS A & B
MB-S1.4	HIGH ROOF FRAMING PLAN - AREAS A & B
MB-S2.1	SCHEDULES
MB-S3.1	FOUNDATION DETAILS
MB-S4.1	FRAMING DETAILS

##### ABATEMENT DRAWINGS

MB-AB1.1	FIRST FLOOR ASBESTOS ABATEMENT PLAN - AREA A
MB-AB1.2	FIRST FLOOR ASBESTOS ABATEMENT PLAN - AREA B
MB-AB1.3	FIRST FLOOR PCB PLAN - AREA C
MB-AB1.4	SECOND FLOOR ASBESTOS ABATEMENT PLAN - AREA B
MB-AB1.5	SECOND FLOOR PCB PLAN - AREA C

##### ARCHITECTURAL DRAWINGS

MB-A0.1	FIRST FLOOR DEMO PLAN - AREA A
MB-A0.2	FIRST FLOOR DEMO PLAN - AREA B
MB-A0.3	FIRST FLOOR DEMO PLAN - AREA C
MB-A0.4	SECOND FLOOR DEMO PLAN - AREA B
MB-A0.5	SECOND FLOOR DEMO PLAN - AREA C
MB-A1.0A	FIRST FLOOR KEY PLAN
MB-A1.0B	SECOND FLOOR KEY PLAN
MB-A1.1	FIRST FLOOR PLAN - AREA A
MB-A1.2	FIRST FLOOR PLAN - AREA B
MB-A1.3	FIRST FLOOR PLAN - AREA C
MB-A1.4	SECOND FLOOR PLAN - AREA B
MB-A1.5	SECOND FLOOR PLAN - AREA C
MB-A1.6	ROOF PLAN - AREA A
MB-A1.7	ROOF PLAN - AREA B
MB-A1.8	ROOF PLAN - AREA C
MB-A1.9	ROOF DETAILS
MB-A1.10	ROOF SCREEN PLAN, SECTION, ELEVATIONS & DETAILS
MB-A2.1	FIRST FLOOR REFLECTED CEILING PLAN - AREA A
MB-A2.2	FIRST FLOOR REFLECTED CEILING PLAN - AREA B
MB-A2.3	FIRST FLOOR REFLECTED CEILING PLAN - AREA C
MB-A2.4	SECOND FLOOR REFLECTED CEILING PLAN - AREA B
MB-A2.5	SECOND FLOOR REFLECTED CEILING PLAN - AREA C
MB-A2.6	ENLARGED CEILING PLANS & DETAILS
MB-A3.1	EXTERIOR ELEVATIONS
MB-A3.2	BUILDING & WALL SECTIONS
MB-A4.1	WALL SECTIONS
MB-A5.1	ENLARGED GYMNASIUM PLAN
MB-A5.2	ENLARGED TOILET ROOM PLANS
MB-A5.3	ENLARGED KITCHEN & LOCKER ROOMS PLANS
MB-A5.4	ENLARGED PLANS
MB-A5.5	INTERIOR ELEVATIONS & CASEWORK SCHEDULE
MB-A5.6	GYMNASIUM INTERIOR ELEVATIONS
MB-A6.1	DOOR SCHEDULE & TYPES
MB-A6.2	WINDOW SCHEDULE & TYPES
MB-A6.3	STOREFRONT ELEVATIONS
MB-A6.4	LIBRARY MILLWORK DETAILS
MB-A6.5	PLAN DETAILS
MB-A7.1	PARTITION TYPES & DETAILS
MB-A8.1	FIRST FLOOR FINISH PLAN - AREA A
MB-A8.2	FIRST FLOOR FINISH PLAN - AREA B
MB-A8.3	SECOND FLOOR FINISH PLAN - AREA B
MB-A8.4	ENLARGED FLOOR FINISH PLANS AND DETAILS
MB-A8.5	FIRST FLOOR WALL FINISH PLAN - AREA A
MB-A8.6	FIRST FLOOR WALL FINISH PLAN - AREA B
MB-A8.7	FIRST FLOOR WALL FINISH PLAN - AREA C
MB-A8.8	SECOND FLOOR WALL FINISH PLAN - AREAS B & C
MB-A8.9	P360 WALL SYSTEM ELEVATIONS
MB-A9.1	FINISH KEY
MB-A9.2	ROOM FINISH SCHEDULE
MB-A9.3	ROOM SIGNAGE

##### FOOD SERVICE DRAWINGS

MB-F1.0	EXISTING FOODSERVICE EQUIPMENT DRAWING
MB-F2.0	FOODSERVICE EQUIPMENT DRAWING
MB-F3.0	FOODSERVICE EQUIPMENT ELECTRICAL POC DRAWING
MB-F4.0	FOODSERVICE EQUIPMENT PLUMBING POC DRAWING
MB-F5.0	FOODSERVICE EQUIPMENT HVAC DRAWING
MB-F6.0	FOODSERVICE EQUIPMENT FLOOR RECESS DRAWING
MB-F7.0	FOODSERVICE EQUIPMENT POINT OF CONNECTION SCHEDULE
MB-F8.0	HALTON HOOD DRAWING (ITEM#6)
MB-F9.0	HALTON HOOD DRAWING (ITEM#8)

##### MECHANICAL DRAWINGS

MB-H0.1	CRAWLSPACE HVAC DEMOLITION PLAN - AREA A
MB-H0.2	CRAWLSPACE HVAC DEMOLITION PLAN - AREA B
MB-H0.3	FIRST FLOOR HVAC DEMOLITION PLAN - AREA A
MB-H0.4	FIRST FLOOR HVAC DEMOLITION PLAN - AREA B
MB-H0.5	FIRST FLOOR HVAC DEMOLITION PLAN - AREA C
MB-H0.6	SECOND FLOOR HVAC DEMOLITION PLAN - AREA B
MB-H0.7	SECOND FLOOR HVAC DEMOLITION PLAN - AREA C
MB-H0.8	PARTIAL UPPER GYMNASIUM & ROOF DEMOLITION PLAN
MB-H1.1	FIRST FLOOR NEW WORK PLAN - AREA A
MB-H1.2	FIRST FLOOR NEW WORK PLAN - AREA B
MB-H1.3	FIRST FLOOR NEW WORK PLAN - AREA C
MB-H1.4	SECOND FLOOR NEW WORK PLAN - AREA B
MB-H1.5	SECOND FLOOR NEW WORK PLAN - AREA C
MB-H1.6	PARTIAL UPPER GYMNASIUM & ROOF PLAN
MB-H1.7	PARTIAL ROOF PLAN AREAS B & C
MB-H1.8	LOWER LEVEL BOILER ROOM PLAN
MB-H2.1	CRAWLSPACE PIPING PLAN - AREA A
MB-H2.2	CRAWLSPACE PIPING PLAN - AREA B
MB-H2.3	FIRST FLOOR PIPING PLAN - AREA A
MB-H2.4	FIRST FLOOR PIPING PLAN - AREA B
MB-H2.5	FIRST FLOOR PIPING PLAN - AREA C
MB-H2.6	SECOND FLOOR PIPING PLAN - AREA B
MB-H2.7	SECOND FLOOR PIPING PLAN - AREA C
MB-H3.1	SCHEDULES
MB-H3.2	SCHEDULES
MB-H3.3	DETAILS
MB-H3.4	VRF LADDER DIAGRAMS

##### PLUMBING DRAWINGS

MB-P0.1	FIRST FLOOR DEMOLITION PLAN - AREA A
MB-P0.2	FIRST FLOOR DEMOLITION PLAN - AREA B
MB-P0.3	SECOND FLOOR DEMOLITION PLAN - AREA B
MB-P1.1	CRAWL SPACE SANITARY PLAN
MB-P1.2	FIRST FLOOR SANITARY PLAN - AREA A
MB-P1.3	FIRST FLOOR SANITARY PLAN - AREA B
MB-P1.4	SECOND FLOOR SANITARY PLAN AREA B
MB-P1.5	TOILET ROOM SANITARY PLANS
MB-P2.1	FIRST FLOOR DOMESTIC PLAN - AREA A
MB-P2.2	FIRST FLOOR DOMESTIC PLAN - AREA B
MB-P2.3	SECOND FLOOR DOMESTIC PLAN - AREA B
MB-P2.4	TOILET ROOM AND BOILER ROOM DOMESTIC PLANS
MB-P2.5	SCHEDULES & SCHEMATICS

##### ELECTRICAL DRAWINGS

MB-E0.1	CRAWL SPACE DEMOLITION PLAN - AREA A
MB-E0.2	FIRST FLOOR DEMOLITION PLAN - AREA A
MB-E0.3	FIRST FLOOR DEMOLITION PLAN - AREA B
MB-E0.4	FIRST FLOOR DEMOLITION PLAN - AREA C
MB-E0.5	SECOND FLOOR DEMOLITION PLAN
MB-E1.1	CRAWL SPACE POWER PLAN - AREA A
MB-E1.2	FIRST FLOOR POWER PLAN - AREA A
MB-E1.3	FIRST FLOOR POWER PLAN - AREA B
MB-E1.4	FIRST FLOOR POWER PLAN - AREA C
MB-E1.5	SECOND FLOOR POWER PLAN
MB-E1.6	ROOF POWER PLAN - AREA A
MB-E1.7	ROOF POWER PLAN - AREA B AND C
MB-E2.1	FIRST FLOOR LIGHTING & FA PLAN - AREA A
MB-E2.2	FIRST FLOOR LIGHTING & FA PLAN - AREA B
MB-E2.3	FIRST FLOOR LIGHTING & FA PLAN - AREA C
MB-E2.4	SECOND FLOOR LIGHTING & FA PLAN
MB-E3.1	ELECTRICAL ONE-LINE DIAGRAMS
MB-E3.2	ELECTRICAL SCHEDULES
MB-E3.3	ELECTRICAL SCHEDULES AND DETAILS
MB-E3.4	PANELBOARD SCHEDULES
MB-E4.1	SITE ELECTRICAL PLAN

##### TECHNOLOGY DRAWINGS

MB-T0.1	BASEMENT TECHNOLOGY DEMO KEY PLAN
MB-T0.2	FIRST FLOOR TECHNOLOGY DEMO KEY PLAN
MB-T0.3	SECOND FLOOR TECHNOLOGY DEMO KEY PLAN
MB-T0.4	FIRST FLOOR TECHNOLOGY DEMO PLAN - AREA A
MB-T0.5	FIRST FLOOR TECHNOLOGY DEMO PLAN - AREA B
MB-T0.6	FIRST FLOOR TECHNOLOGY DEMO PLAN - AREA C
MB-T0.7	SECOND FLOOR TECHNOLOGY DEMO PLAN - AREA A & B
MB-T1.1	BASEMENT TECHNOLOGY KEY PLAN
MB-T1.2	FIRST FLOOR TECHNOLOGY KEY PLAN
MB-T1.3	SECOND FLOOR TECHNOLOGY KEY PLAN
MB-T1.4	FIRST FLOOR TECHNOLOGY PLAN - AREA A
MB-T1.5	FIRST FLOOR TECHNOLOGY PLAN - AREA B
MB-T1.6	FIRST FLOOR TECHNOLOGY PLAN - AREA C
MB-T1.7	SECOND FLOOR TECHNOLOGY PLAN - AREA A & B
MB-T2.1	DETAILS
MB-T2.2	DETAILS

##### BUS GARAGE CODE COMPLIANCE DRAWINGS

BG-C01.1	CODE COMPLIANCE PLAN
BG-C01.2	SITE CODE COMPLIANCE PLAN

##### BUS GARAGE SITE DRAWINGS

BG-L0.1	SITE EXISTING CONDITIONS
BG-L1.1	SITE DEMOLITION PLAN
BG-L2.1	SITE IMPROVEMENT PLAN

##### BUS GARAGE ARCHITECTURE DRAWINGS

BG-A0.1	FIRST DEMO PLAN - AREA A
BG-A1.1	FIRST FLOOR PLANS, INTERIOR ELEV. AND SCHEDULES
BG-A3.1	EXTERIOR ELEVATION & NOTES

##### BUS GARAGE PLUMBING DRAWINGS

BG-P1.1	FIRST FLOOR PLANS
---------	-------------------

##### BUS GARAGE ELECTRICAL DRAWINGS

BG-E1.1	BUS GARAGE FIRST FLOOR ELECTRICAL PLAN
---------	--

##### BUS GARAGE TECHNOLOGY DRAWINGS

BG-T0.1	FIRST FLOOR TECHNOLOGY DEMO PLAN
BG-T1.1	FIRST FLOOR TECHNOLOGY PLAN
BG-T2.1	DETAILS
BG-T2.2	DETAILS



8782 MAIN ST. HAMMONDSPORT, NY, 14840



ISSUED FOR BID DATE: 12/11/2025  
 PROJECT ISSUE DATE: 10/27/2025  
 HUNT PROJECT NUMBER: 1925-014  
 MAIN BUILDING SED #: 57-29-01-04-0-002-025  
 BUS GRAGE SED #: 57-29-01-04-5-003-008

THIS IS TO CERTIFY THAT TO THE BEST OF OUR KNOWLEDGE, INFORMATION AND BELIEF - THESE PLANS AND SPECIFICATIONS ARE IN ACCORDANCE WITH APPLICABLE REQUIREMENTS OF THE BUILDING CODE, FIRE CODE, AND ENERGY CONSERVATION CONSTRUCTION CODE OF NEW YORK STATE.

SITEWORK SYMBOLS	
	CONTROL POINT
	UTILITY POLE W/ ANCHOR
	SIGN
	EXG. WATER VALVE
	NEW WATER VALVE
	UTILITY POLE W/ LIGHT
	STREET LIGHT
	EXG. FIRE HYDRANT
	NEW FIRE HYDRANT
	CATCH BASIN DRYWELL
	CURB BOX VALVE
	EXISTING DECIDUOUS TREE
	EXISTING CONIFEROUS TREE
	EXG. ELEVATION
#941.5 symbol"/>	NEW ELEVATION
	GAS LINE
	EXISTING MANHOLE
	NEW MANHOLE
	NEW CONTOUR
	EXISTING ELECTRIC
	WATER LINE
	SANITARY LINE
	TELEPHONE LINE
	STORM SEWER
	OVERHEAD UTILITY
	UNDERGROUND ELECTRIC
	ROAD CENTER LINE
	*LINES SHOWN AS SCREENED (GRAY) DENOTE EXISTING
	EDGE OF STREAM OR SWALE
	SHRUBBERY, WOODS
	EXISTING CULVERT
	NEW CULVERT WITH END SECTION

SITEWORK SYMBOLS	
	TEST PIT
	TEST HOLE
	RIP RAP
	COORDINATE POINT LOCATION
	8' REBAR WITH SURVEY CAP SET
	EXISTING IRON ROD
	EXISTING IRON PIPE
	UTILITY POLE
	ORIGINAL LOT LINE
	DEED LINE
	PROPERTY LINE
	EXISTING FENCE
	NEW FENCE
	GUARD RAIL
	EASEMENT LINE
	CONCRETE MONUMENT

PLUMBING SYMBOLS	
	DOMESTIC COLD WATER PIPING
	DOMESTIC HOT WATER PIPING
	DOMESTIC RECIRCULATING WATER PIPING
	SHUT OFF VALVE
	POINT OF CONNECTION
	SPRINKLER HEAD
	VOLUME DAMPER
	NATURAL GAS PIPING
	BELOW SLAB SANITARY PIPING
	ABOVE SLAB SANITARY PIPING
	BELOW SLAB STORM/ROOF DRAINAGE PIPING
	ABOVE SLAB STORM/ROOF DRAINAGE PIPING
	SANITARY VENT PIPING
	CONDENSATE DRAIN PIPING
	EXISTING PIPING TO REMAIN

PLUMBING SYMBOLS	
	DOMESTIC COLD WATER PIPING
	DOMESTIC HOT WATER PIPING
	DOMESTIC RECIRCULATING WATER PIPING
	SHUT OFF VALVE
	POINT OF CONNECTION
	SPRINKLER HEAD
	VOLUME DAMPER
	NATURAL GAS PIPING
	BELOW SLAB SANITARY PIPING
	ABOVE SLAB SANITARY PIPING
	BELOW SLAB STORM/ROOF DRAINAGE PIPING
	ABOVE SLAB STORM/ROOF DRAINAGE PIPING
	SANITARY VENT PIPING
	CONDENSATE DRAIN PIPING
	EXISTING PIPING TO REMAIN

PLUMBING SYMBOLS	
	AUTOMATIC DAMPER
	DIFFUSER NUMBER CFM
	GRILLE NUMBER CFM
	REGISTER NUMBER CFM
	DUCT W/ MANUAL VOLUME DAMPER
	SUPPLY AIR DIFFUSER
	GRILLER OR REG.
	FIRE DAMPER
	THERMOSTAT
	THERMOSTAT W/GUARD
	SENSOR
	MITERED ELBOW W/ TURNING VALVES
	FIRST NUMBER IS SIZE SHOW FOR DUCT WIDTH

PLUMBING SYMBOLS	
	AUTOMATIC DAMPER
	DIFFUSER NUMBER CFM
	GRILLE NUMBER CFM
	REGISTER NUMBER CFM
	DUCT W/ MANUAL VOLUME DAMPER
	SUPPLY AIR DIFFUSER
	GRILLER OR REG.
	FIRE DAMPER
	THERMOSTAT
	THERMOSTAT W/GUARD
	SENSOR
	MITERED ELBOW W/ TURNING VALVES
	FIRST NUMBER IS SIZE SHOW FOR DUCT WIDTH

PLUMBING SYMBOLS	
	AUTOMATIC DAMPER
	DIFFUSER NUMBER CFM
	GRILLE NUMBER CFM
	REGISTER NUMBER CFM
	DUCT W/ MANUAL VOLUME DAMPER
	SUPPLY AIR DIFFUSER
	GRILLER OR REG.
	FIRE DAMPER
	THERMOSTAT
	THERMOSTAT W/GUARD
	SENSOR
	MITERED ELBOW W/ TURNING VALVES
	FIRST NUMBER IS SIZE SHOW FOR DUCT WIDTH

PLUMBING SYMBOLS	
	AUTOMATIC DAMPER
	DIFFUSER NUMBER CFM
	GRILLE NUMBER CFM
	REGISTER NUMBER CFM
	DUCT W/ MANUAL VOLUME DAMPER
	SUPPLY AIR DIFFUSER
	GRILLER OR REG.
	FIRE DAMPER
	THERMOSTAT
	THERMOSTAT W/GUARD
	SENSOR
	MITERED ELBOW W/ TURNING VALVES
	FIRST NUMBER IS SIZE SHOW FOR DUCT WIDTH

PLUMBING SYMBOLS	
	AUTOMATIC DAMPER
	DIFFUSER NUMBER CFM
	GRILLE NUMBER CFM
	REGISTER NUMBER CFM
	DUCT W/ MANUAL VOLUME DAMPER
	SUPPLY AIR DIFFUSER
	GRILLER OR REG.
	FIRE DAMPER
	THERMOSTAT
	THERMOSTAT W/GUARD
	SENSOR
	MITERED ELBOW W/ TURNING VALVES
	FIRST NUMBER IS SIZE SHOW FOR DUCT WIDTH

A	AREA
A/C	AIR CONDITIONING COOLING
AB	ANCHOR BOLTS
ABV	ABOVE
AC	ALTERNATING CURRENT
ACT	ACOUSTICAL TILE
AD	AREA DRAIN
ADD	ADDENDUM
ADH	ADHESIVE
ADJ	ADJACENT
AESS	ARCHITECTURAL EXPOSED STRUCTURAL STEEL
AFF	ABOVE FINISH FLOOR
AGG	AGGREGATE
AHU	AIR HANDLER
AL	ALUMINUM
ALIGN	ALIGNMENT
ALLOW	ALLOWANCE
ALT	ALTERNATE
AMP	AMPERAGE
ANC	ANCHOR(AGE)
ANOD	ANODIZED
APPROX	APPROXIMATE
ARCH	ARCHITECTURAL
ASB	ASBESTOS
ASBC	ASBESTOS CONTRACTOR
ASPH	ASPHALT
AUX	AUXILIARY
AVG	AVERAGE
AWG	AMERICAN WIRE GAGE
BCJ	BRICK CONTROL JOINT
BCU	CLOSER COIL UNIT
BD	BOARD
BEJ	BRICK EXPANSION JOINT
BEL	BELOW
BEV	BEVELED
BF	BOARD FEET
BIT	BITUMINOUS
BLDG	BUILDING
BLK	BLOCK
BLKG	BLOCKING
BM	BENCH MARK
BOF	BOTTOM OF FOOTING
BOT	BOTTOM
BPL	BEARING PLATE
BRG	BEARING
BRK	BRICK
BRKT	BRACKET
BS	BOTH SIDES
BTU	BRITISH THERMAL UNITS
BUR	BUILT-UP ROOF
BW	BOTH WAYS
C	CHANNEL
C-C	CENTER TO CENTER
CAB	CABINET
CAP	CAPACITY
CB	CATCH BASIN
CBF	HUNDRED BOARD FEET
CD	COLD DRAWN
CEM	CEMENT
CER	CERAMIC
CF	CUBIC FOOT
CFLG	COUNTER FLASHING
CFM	CUBIC FOOT/MINUTE
CFMF	COLD-FORMED METAL FRAMING
CFS	CUBIC FEET/SECOND
CH	CABINET HEATER
CHBD	CHALKBOARD
CI	CAST IRON
CP	CAST-IN PLACE CONCRETE
CR	CIRCLE
CJ	CONTROL JOINT
CK	CAULK(ING)
CLG	CEILING

CLO	CLOSET
CLR	CLEAR(ANCE)
CLS	CLOSURE
CMF	CORRUGATED METAL PIPE
CMU	CONCRETE MASONRY UNIT
CO	CLEANOUT, COMPANY
COL	COLUMN
COMB	COMBINATION
COMP	COMPRESSED (I), (ON), (IBLE)
CON	CONNECTOR, CONNECTION
CONC	CONCRETE
CONST	CONSTRUCTION
CONT	CONTINUOUS CONTINUE
CONTR	CONTRACTOR
COORD	COORDINATE
CP	CLAY PIPE
CPG	COPING
CRP	COPPER
CPT	CARPET(ED)
CR	COLD ROLLED
CRS	COURSE(S)
CSMT	CASEMENT
CS	CAST STONE
CT	CERAMIC TILE
CTR	COUNTER
CU	CUBIC
CULV	CULVERT
CV	CHECK VALVE
CW	COLD WATER
CY	CUBIC YARD
DBL	DOUBLE
DC	DIRECT CURRENT
DEG	DEGREE
DEMO	DEMOLITION
DF	DRINKING FOUNTAIN
DI	DIAMETER
DIAG	DIAGONAL
BLDG	BUILDING
DL	DEAD LOAD
DLV	DOOR LOUVER
DN	DOWN
DOZ	DOZEN
DP	DAMP-PROOFING
DPR	DAMPER
DS	DOWNSPOUT
DT	DRAIN TILE
DTA	DOVETAIL ANCHOR
DTL	DETAIL
DWG	DRAWING
EA	EACH
EC	ELECTRICAL CONTRACTOR
EF	EACH FACE
EJ	EXPANSION JOINT
EL	ELEVATION
ELEC	ELECTRICAL
ELEV	ELEVATOR
EMER	EMERGENCY
ENC	ENCLOSURE
ENG	ENGINEER
ENT	ENTRANCE
EOC	EVERY OTHER COURSE
EOD	EDGE OF DECK
EOS	EDGE OF SLAB
EP	ELECTRICAL PANEL BOARD
EQ	EQUAL
EQP	EQUIPMENT
EST	ESTIMATE(ED)
EW	ELECTRICAL WATER COOL
EW	ELECTRIC WALL FAN
EXC	EXCAVATE

EXG	EXISTING
EXH	EXHAUST
EXP	EXPOSED
EXT	EXTERIOR
FA	FIRE ALARM, FRESH AIR
FAI	FRESH AIR INTAKE
FAST	FASTENER
FB	FACE BRICK
FBD	FIBERBOARD
FBO	FINISHED BY OTHERS
FC	FAN COIL
FCU	FAN COIL UNIT
FD	FLOOR DRAIN
FDR	FOLDING DOOR
FE	FIRE EXTINGUISHER
FEC	FIRE EXTINGUISHER CABINET
FF	FINISH FLOOR
FFE	FINISH FLOOR ELEVATION
FGL	FIBERGLASS
FIG	FIGURE
FIN	FINISHED
FLO	FLOOR CLEANOUT
FLEX	FLEXIBLE
FLG	FLASHING
FLOUR	FLOURESCENT
FLR	FLOORING
FND	FOUNDATION
FO	FRAMED OPENING
FOC	FACE OF CONCRETE
FOF	FACE OF FINISH
FOM	FACE OF MASONRY
FOS	FACE OF STUDS
FP	FIREPROOF
FPL	FLOOR PLATE
FR	FRAME(ED), (ING)
FRT	FIRE-RETARDANT
FT	FOOT (I)
FUR	FURRED, FURRING
FURN	FURNITURE
FXT	FIXTURE
GA	GAGE, GAUGE
GALV	GALVANIZED
GAS	GAS
GB	GRAB BAR
GC	GENERAL CONTRACTOR
GCMU	GLAZED CMU
GD	GRADE, GRADING
GF	GRANULAR FILL
GI	GROUND FAL T INTERRUPTER
GI	GALVANIZED IRON
GL	GLASS, GLAZING
GP	GALVANIZED PIPE
GPM	GALLONS PER MINUTE
GSS	GALVANIZED STEEL SHEET
GST	GLAZED STRUCTURAL TILE
GVL	GRAVEL
GWB	GYPSSUM WALL BOARD
GYP	GYPSSUM
HB	HOSE BIB
HC	HVAC CONTRACTOR
HCP	HANDICAP
HD	HEAVY DUTY
HDJT	HEAD JOINT
HDR	HEADER
HDW	HARDWARE
HI	HANDHOLE
HI	HEIGHT OF INSTRUMENT
HI	HOOK(S)
HM	HOLLOW METAL
HOR	HORIZONTAL
HP	HORSEPOWER

HR	HANDRAIL
HT	HEIGHT
HTR	HEATING
HTR	HEATER
HTX	HEAT EXCHANGER
HVAC	HEATING, VENTILATION & AIR CONDITIONING
HW	HOT WATER
HWH	HOT WATER HEATER
HYD	HYDRANT
ID	INSIDE DIAMETER
IN	INCH (I)
INCN	INCORPORATOR
INCL	INCLUDED, INCLUDING
INFO	INFORMATION
INS	INSULATED
INT	INTERIOR
INV	INVERT (ELEVATION)
IP	IRON PIPE / IRON PIPE SIZE
JC	JANITORS CLOSET
JF	JOINT FILLER
JNT	JOINT
JST	JOIST
KIT	KITCHEN
KO	KNOCKOUT
KPL	KICKPLATE
L	LENGTH
LAB	LABORATORY
LAD	LADDER
LAM	LAMINATE(D)
LAT	LATITUDE
LAV	LAVATORY
LBL	LABEL
LF	LINEAR FOOT
LH	LEFT HAND
LIC	LICENSE(D)
LN	LINEAR
LNO	LINOLEUM
LQ	LINQ
LKR	LOCKER
LL	LIVE LOAD
LLH	LONG LEG HORIZONTAL
LLV	LONG LEG VERTICAL
LMS	LUMBER
LONG	LONGITUDE, LONGITUDINAL
LP	LIGHT PANEL
LPT	LOW POINT
LRG	LARGE
LT	LIGHT
LTL	LINTEL
LVR	LOUVER
LVT	LUXURY VINYL TILE
MAINT	MAINTENANCE
MAS	MASONRY
MATL	MATERIAL
MAX	MAXIMUM
MBF	1000 BOARD FEET
MBR	MEMBER
MC	MECHANICAL CONTRACTOR
MECH	MECHANICAL
MED	MEDIUM
MD	MANUFACTURED
MFG	MANUFACTURING
MFR	MANUFACTURE(R)
MGR	MANAGER
MH	MANHOLE
MIN	MINIMUM
MIR	MIRROR
MKB	MARKERBOARD
MLD	MOLDING, MOLDING
MMB	MEMBRANE

MNT	MOUNT(ED), (ING)
MO	MASONRY OPENING
MOD	MODULAR
MON	MONUMENT
MOV	MOVABLE
MRB	MARBLE
MRO	METAL ROOF DECKING
MTR	METAL FRURING
MTL	METAL
MULL	MULLION
MULT	MULTIPLE
MWK	MILLWORK
NF	NOW OR FORMERLY
NA	NOT AVAILABLE/APPLICABLE
NAT	NATURAL
NEC	NATIONAL ELECTRIC CODE
NEG	NEGATIVE
NIC	NOT IN CONTRACT
NL	NAILABLE
NMT	NON-METALLIC
NOM	NOMINAL
NR	NOISE REDUCTION COEFFICIENT
NS	NEAR SIDE
NTS	NOT TO SCALE
OH	OVERHEAD
OV	OVERALL
OBS	OBSCURE
OC	ON CENTER(S)
OD	OUTSIDE DIAMETER
OFF	OFFICE
OHG	OVERHANG
OPG	OPENING
OPH	OPPOSITE HAND
OPP	OPPOSITE
OPS	OPPOSITE SURFACE
ORIG	ORIGINAL
OWSJ	OPEN-WEB STEEL JOIST
PA	PUBLIC ADDRESS
PAB	PARALLEL
PB	PANIC BAR
PBD	PARTICLE BOARD
PC	PLUMBING CONTRACTOR
PCC	PRECAST CONCRETE
PCF	POUNDS PER CUBIC FOOT
PE	PORCELAIN ENAMEL
PEN	PENETRATION
PERF	PERFORATE(D)
PERI	PERIMETER
PERM	PERMANENT
PERP	PERPENDICULAR
PFB	PREFABRICATE(D)
PFN	PREFINISHED
PG	PLATE GLASS
PKG	PARKING
PL	PLATE
PLAM	PLATIC LAMINATE
PLAST	PLASTER
PLBG	PLUMBING
PLF	POUNDS PER LINEAR FOOT
PLS	PLASTIC
PNL	PANEL
PNT	PAINT(ED)
PGB	POINT OF BEGINNING
PR	PAIR
PRF	PREFORMED
PROJ	PROJECT
PRT	PRESERVATIVE TREATED
PSC	PRE-STRESSED CONCRETE
PSF	POUNDS PER SQUARE FOOT
PSI	POUNDS PER SQUARE INCH
PT	POINT
PTD	PAPER TOWEL DISPENSER


PTN	PARTITION
PTR	PAPER TOWEL RECEPTOR
STOR	STORAGE
STR	STRUCTURAL
PVCP	PVC PIPE
PVMT	PAVEMENT
PWD	PLYWOOD
QT	QUARRY TILE
QTR	QUARTER
QTY	QUANTITY
R	RISE(R

**BUILDING INFORMATION**

YEAR BUILT: 1956  
 ADDITIONS: 1965, 1991, 2000, 2012  
 EXISTING CONSTRUCTION TYPE: IIB  
 OCCUPANCY CLASSIFICATION: E- EDUCATION  
 EXG BUILDING CODE COMPLIANCE METHOD: WORK AREA METHOD  
 CLASSIFICATION OF WORK: ALTERATION 2  
 SQ. FT. CALCULATIONS:  
 GROSS S.F. OF EXG. BASEMENT FLR. 2,993 S.F.  
 GROSS S.F. OF EXG. FIRST FLR. 87,371 S.F.  
 GROSS S.F. OF EXG. SECOND FLR. 21,818 S.F.  
 TOTAL GROSS S.F. (EXISTING) 112,172 S.F.  
 BUILDING FOOTPRINT 87,371 S.F.  
 BUILDING AREA INFORMATION:  
 NUMBER OF STORES: 2  
 NUMBER OF SIDES ACCESSIBLE: 4  
 SPRINKLERED: NO  
 BASIC FIRE AREA: < 20,000 S.F. UNSPRINKLERED  
 ALLOWABLE BUILDING AREA: 14,500 S.F. PER FLOOR (TABLE 503)  
 FIRST FLOOR TRAVEL DISTANCE: 88' ACTUAL  
 SECOND FLOOR TRAVEL DISTANCE: 74' ACTUAL  
 200 FT. MAX

**EGRESS REQUIREMENTS/CALCULATIONS**

RESCUE WINDOW  
 MINIMUM SIZE: NET CLEAR OPENING OF 5.7 SQ. FT. (0.53 M2) (NYSBC 1026.2)  
 MINIMUM DIMENSIONS: NET CLEAR HEIGHT SHALL BE 24". NET CLEAR OPENING WIDTH DIMENSION SHALL BE 20" (NYSBC 1026.1)  
 DOOR OCCUPANT LOAD CALC.  
 EGRESS WIDTH  
 PER OCC. SERVED: 2" (TWO SPRINKLER)  
 15" (W/ SPRINKLER)  
 (NYSBC TABLE 1005.1)

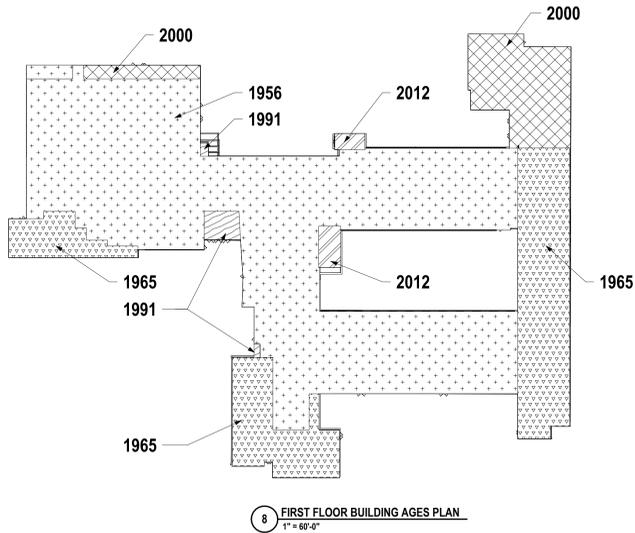

8 FIRST FLOOR BUILDING AGES PLAN  
 1" = 60'-0"

**PLUMBING FIXTURE COUNT**

FIXTURE TYPE	NYSCB # REQ GROUP E	TOTAL PROVIDED
WOMENS WATER CLOSETS	21.52	20
MENS WATER CLOSETS	21.52	14
URINAL SUBSTITUTION ALLOWED	66%	9
GENDER NEUTRAL WATER CLOSET	-	20
TOTAL WATER CLOSET/URINALS	44	63
WOMENS LAVATORIES	21.42	18
MENS LAVATORIES	21.52	18
GENDER NEUTRAL LAVATORIES	-	10
TOTAL LAVATORIES	44	46
DRINKING FOUNTAINS	22	18 *EXISTING NON-CONFORMING
SERVICE SINKS	1	1


PLUMBING FIXTURE COUNT OF "E" CLASSIFICATION (2902.1)  
 1. OCCUPANT LOAD 1 PER 50

**LEVEL OF ALTERATION**


FLOOR	TOTAL SF PER FLOOR	LEVEL 1 SF	LEVEL 2 SF	ADDITION SF
BASEMENT	2,993 SF	0 SF	0 SF	0 SF
FIRST FLOOR	74,885 SF	13,053 SF	6,885 SF	281 SF
SECOND FLOOR	20,931 SF	9,246 SF	734 SF	0 SF
OVERALL	100,739 SF	22,299 SF	7,619 SF	281 SF

**ALTERATION KEY**


- LEVEL 1 ALTERATIONS
- LEVEL 2 ALTERATIONS
- ADDITION

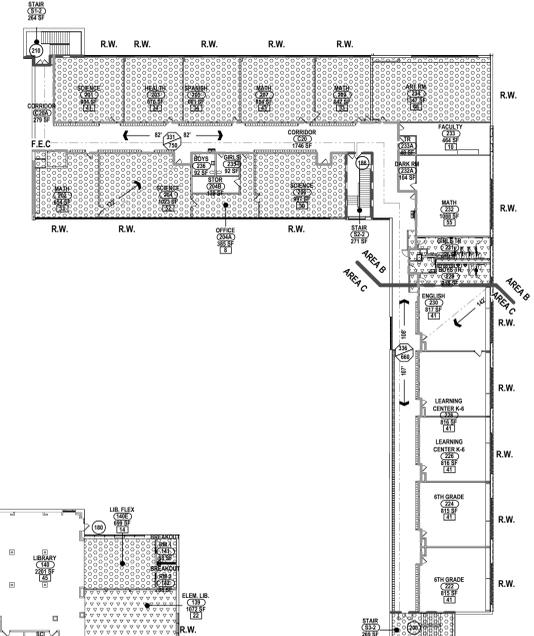

4 SECOND FLOOR CODE COMPLIANCE PLAN  
 1" = 30'-0"

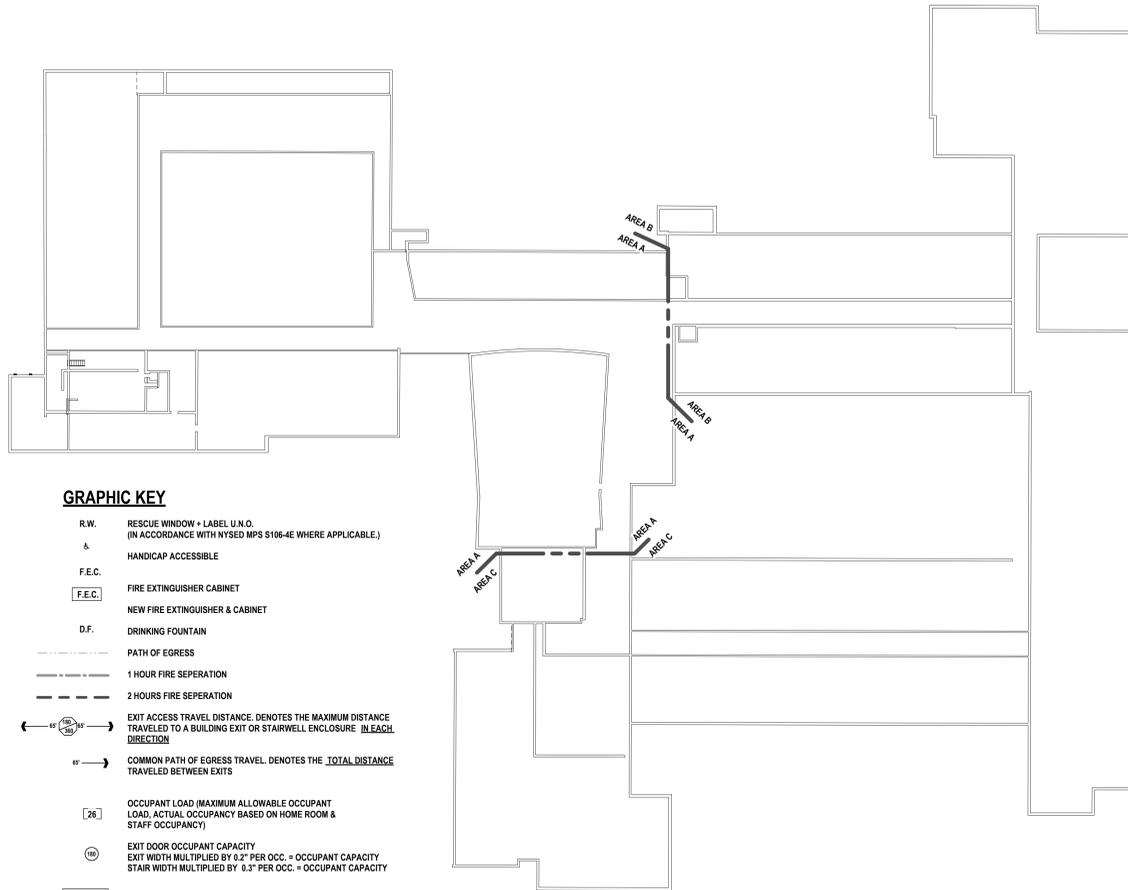

5 BASEMENT/CRAWL SPACE CODE COMPLIANCE PLAN  
 1" = 30'-0"

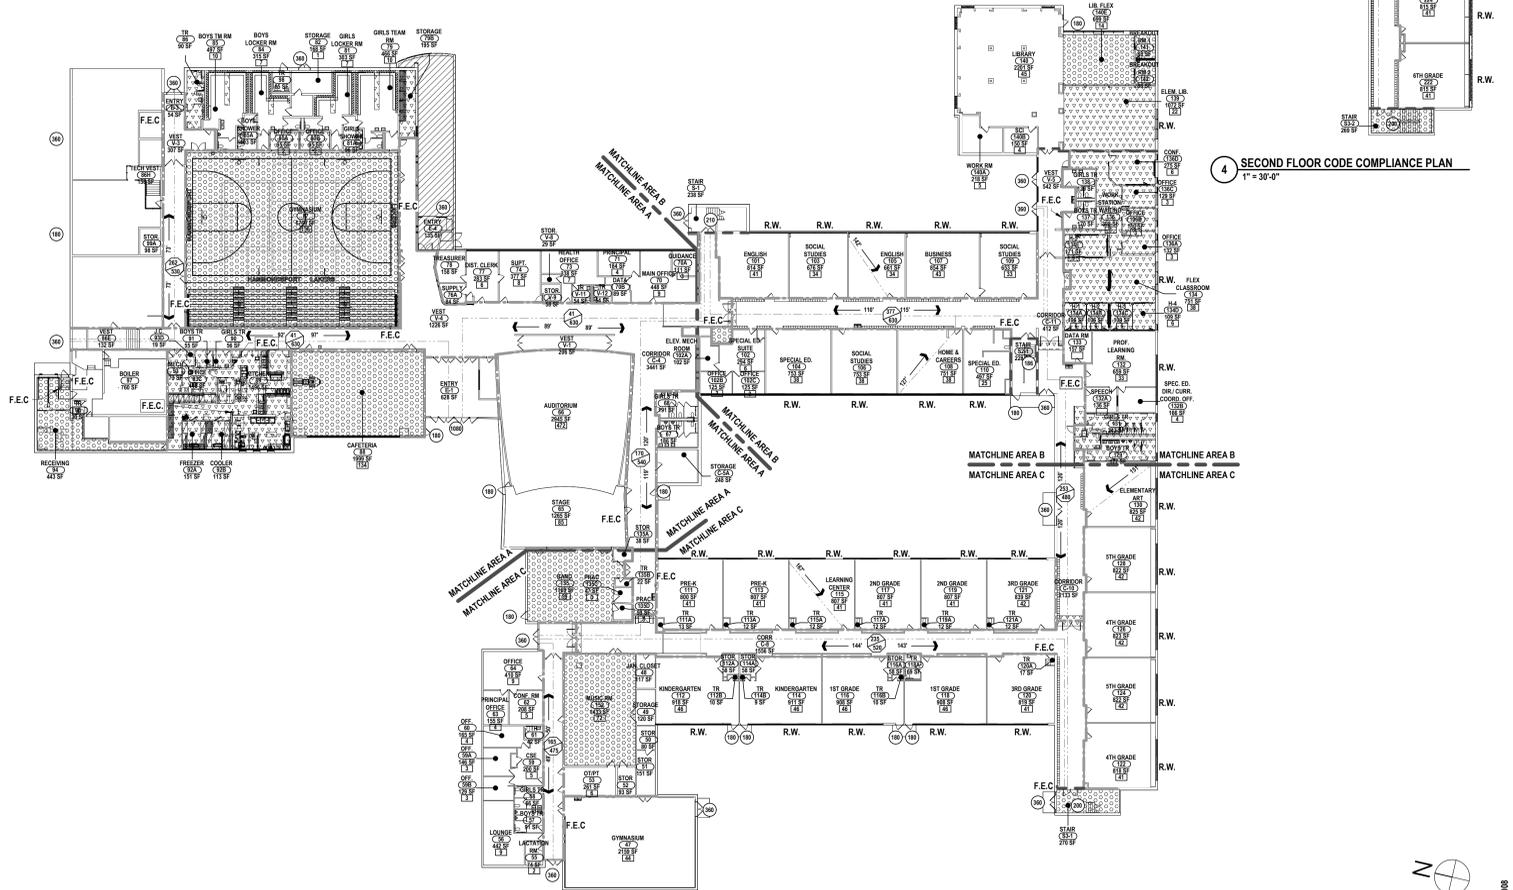

1 FIRST FLOOR CODE COMPLIANCE PLAN  
 1" = 30'-0"

**GRAPHIC KEY**

- R.W. RESCUE WINDOW + LABEL U.N.O. (IN ACCORDANCE WITH NYSBC MPS S106-4E WHERE APPLICABLE.)
- △ HANDICAP ACCESSIBLE
- F.E.C. FIRE EXTINGUISHER CABINET
- [F.E.C.] NEW FIRE EXTINGUISHER & CABINET
- D.F. DRINKING FOUNTAIN
- PATH OF EGRESS
- 1 HOUR FIRE SEPERATION
- 2 HOURS FIRE SEPERATION
- EXIT ACCESS TRAVEL DISTANCE. DENOTES THE MAXIMUM DISTANCE TRAVELED TO A BUILDING EXIT OR STAIRWELL ENCLOSURE IN EACH DIRECTION
- COMMON PATH OF EGRESS TRAVEL. DENOTES THE TOTAL DISTANCE TRAVELED BETWEEN EXITS
- [28] OCCUPANT LOAD (MAXIMUM ALLOWABLE OCCUPANT LOAD. ACTUAL OCCUPANCY BASED ON HOME ROOM & STAFF OCCUPANCY)
- ⊙ EXIT DOOR OCCUPANT CAPACITY  
 EXIT WIDTH MULTIPLIED BY 0.2" PER OCC. = OCCUPANT CAPACITY  
 STAIR WIDTH MULTIPLIED BY 0.3" PER OCC. = OCCUPANT CAPACITY
- EXISTING TO REMAIN
- RENOVATIONS AND ALTERATIONS: 21,592 SF TOTAL

DESCRIPTION OF REVISION:  
 # DATE: 1 10/12/2025  
 ISSUE FOR BID


HUNT ENGINEERS ARCHITECTS | SURVEYORS  
 HORSEHEADS, NY 607-658-1000  
 PROSPERITIES, NY 562-837-7668  
 BANGHARTON, NY 607-798-8881  
 ALBANY, NY 607-798-8881  
 WWW.HUNT-EAS.COM  
 NY CERTIFICATE NO. 0016250 PA CERTIFICATE NO. TSC22020131464-1

CODE COMPLIANCE  
 2025 CAPITAL IMPROVEMENTS PROJECT  
 HAMMONDSPORT CENTRAL SCHOOL DISTRICT  
 8272 MAIN STREET HAMMONDSPORT, NEW YORK, 14840

MB-CO1.1  
 PROJECT NO. 1925.014



1 SITE CODE COMPLIANCE PLAN  
SCALE: 1" = 30'

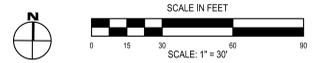


SED NUMBERS: MB, 57-29-01-04-00-02-05, BG, 57-29-01-04-5-005-008

**SITE CODE COMPLIANCE PLAN**  
**2025 CAPITAL IMPROVEMENTS PROJECT**  
**HAMMONDSPORT CENTRAL SCHOOL DISTRICT**  
 8272 MAIN STREET, HAMMONDSPORT, NEW YORK, 14840


**MB-CO1.2**  
 PROJECT NO: 1925.014

**HUNT ENGINEERS | ARCHITECTS | SURVEYORS**  
 HORSEHEADS, NY 607-353-8800 ROCHESTER, NY 661-597-7860 TOWANAC, PA 570-265-4888  
 BINGHAMTON, NY 607-738-1881 ALBANY, NY 607-738-8881  
 WWW.HUNTEAS.COM  
 NY CERTIFICATE NO. 0016220 PA CERTIFICATE NO. TSC220313464-1

#	DATE	DESCRIPTION OF REVISION	ISSUED FOR	ISSUED BY
1	12/11/2025			EB
DRAWN BY:				EB
CHECKED BY:				SM
DATE:				10/27/2025
PHASE:				CD
<small>IT IS A VIOLATION OF THE LAW FOR ANY PERSON TO MAKE UNAUTHORIZED ALTERATIONS OR ADDITIONS TO PLANS          BEARING A LICENSED ENGINEER'S, ARCHITECT'S OR SURVEYOR'S SEAL</small>				

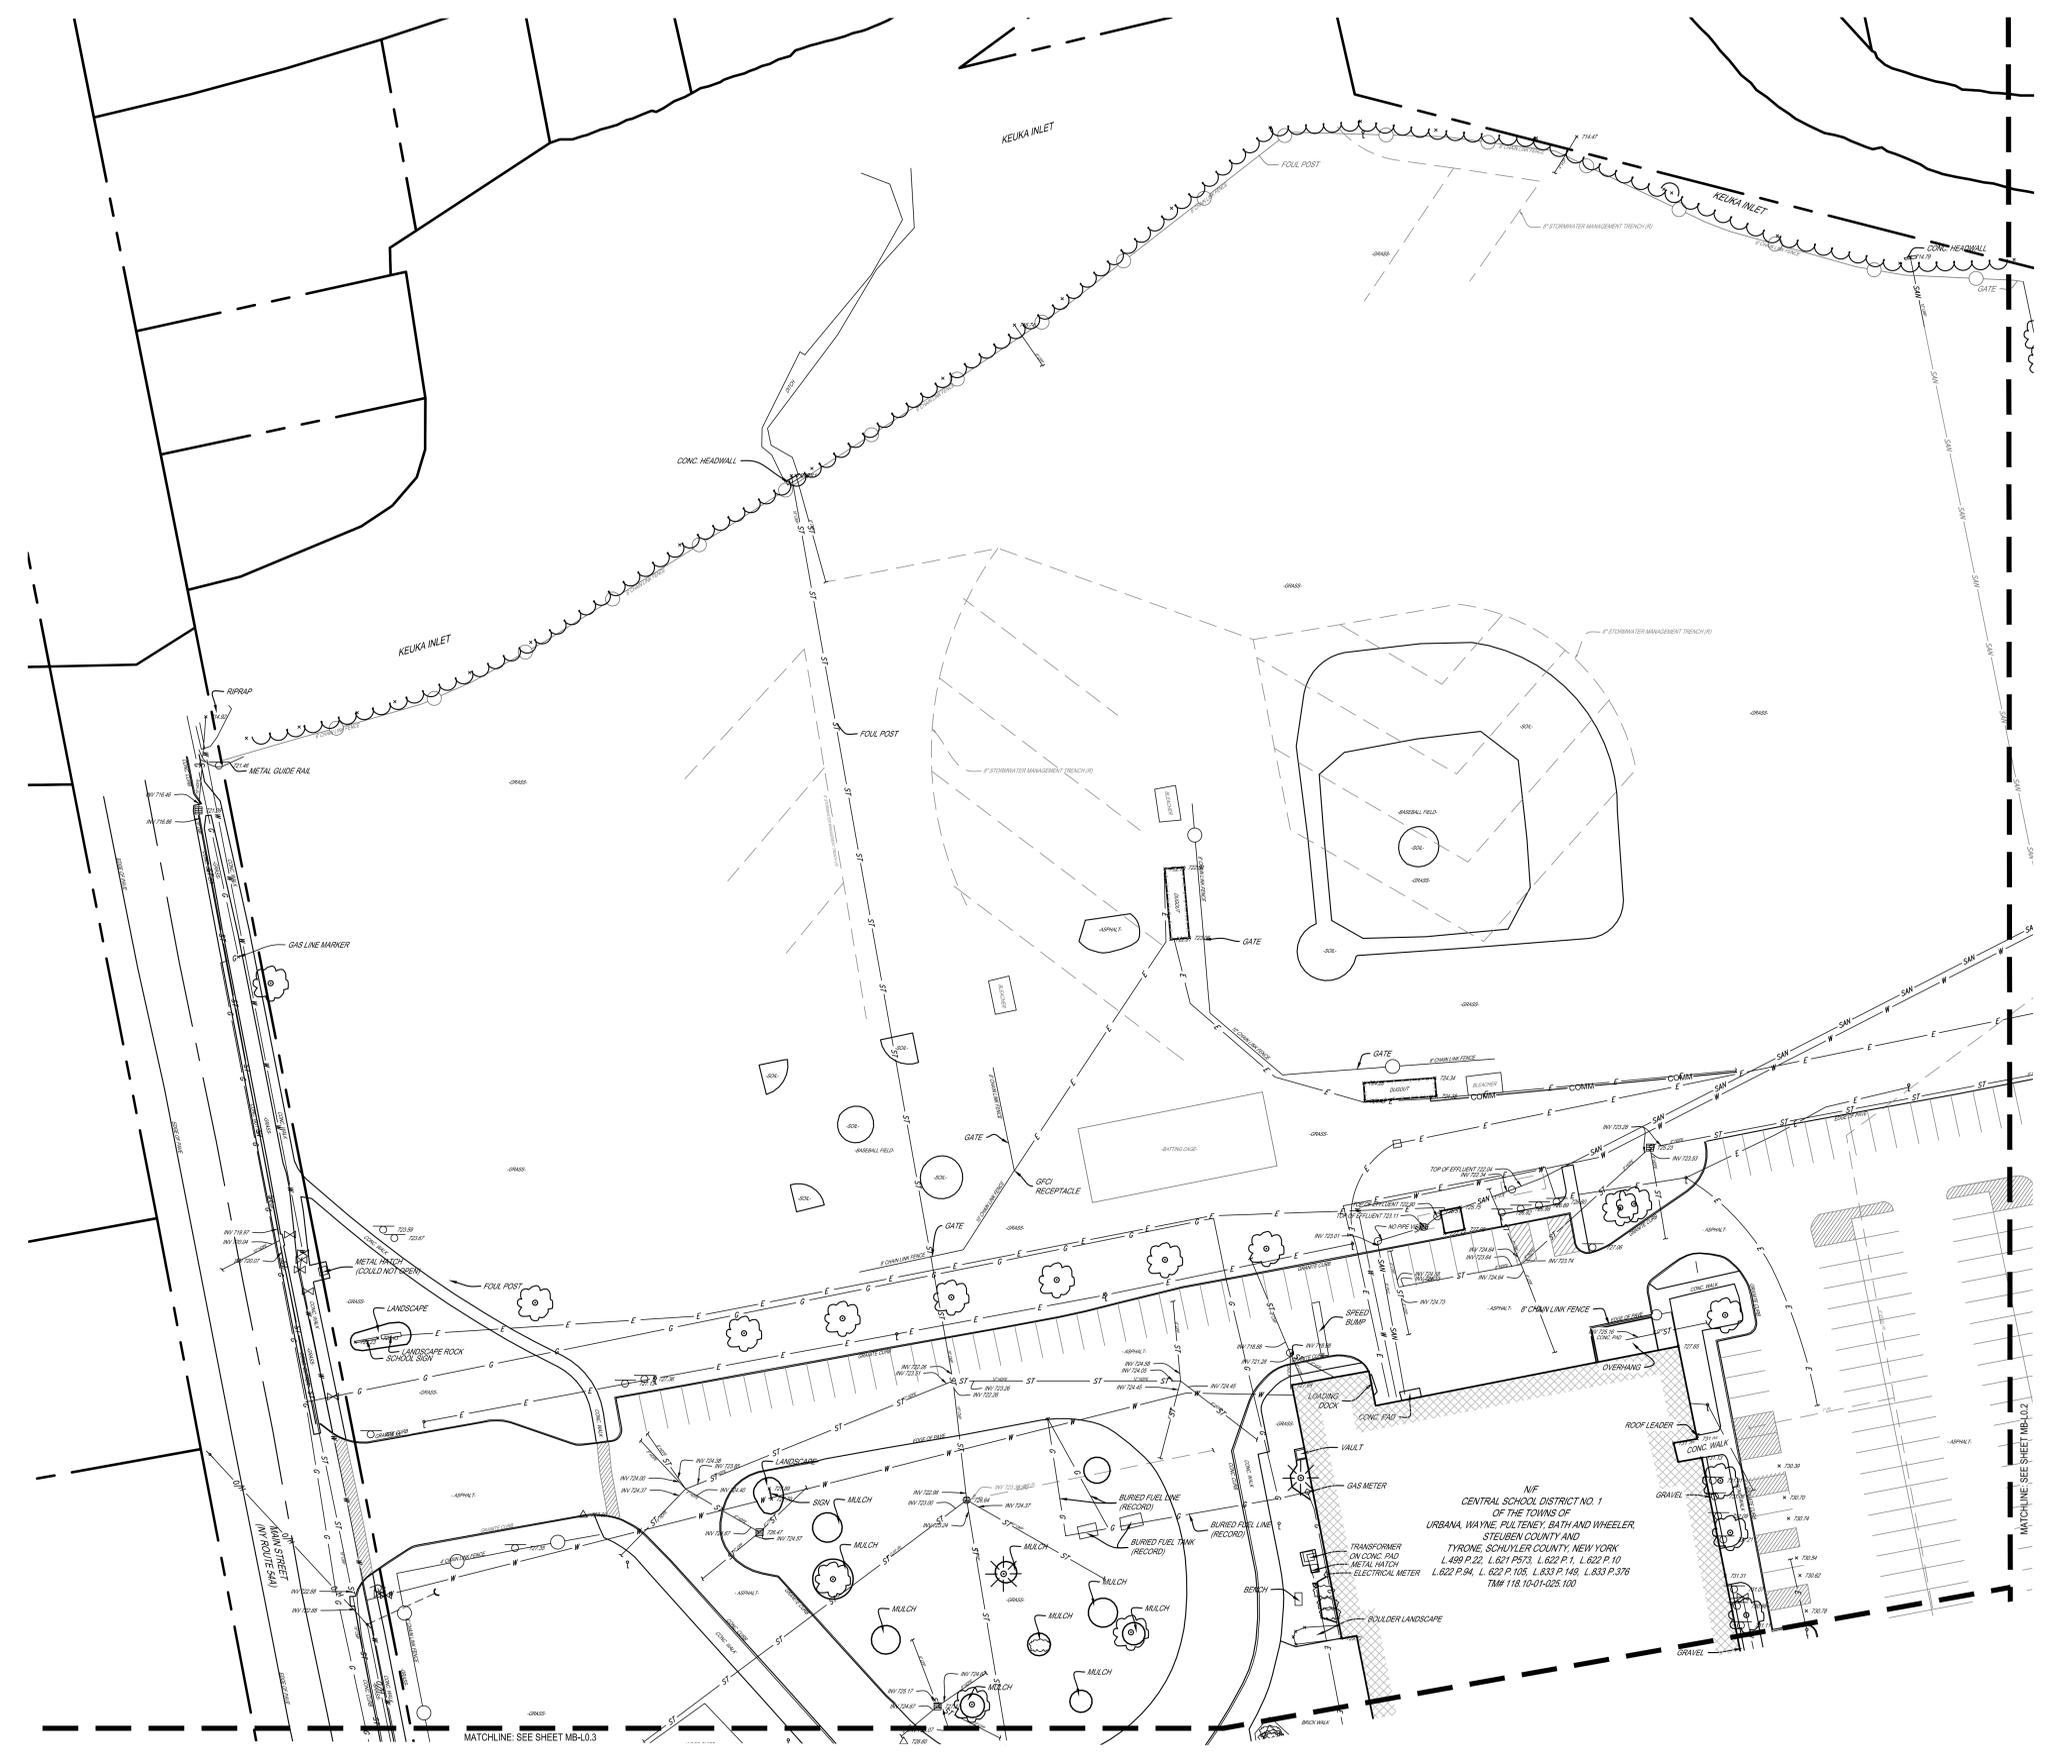

1 SITE EXISTING CONDITIONS PLAN  
SCALE: 1" = 30'

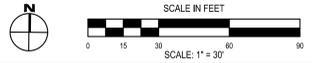

SED NUMBERS: MB, 57-28-01-04-00-02-05, BG, 57-28-01-04-5-005-008

SITE EXISTING CONDITIONS PLAN  
 2025 CAPITAL IMPROVEMENTS PROJECT  
 HAMMONDSPORT CENTRAL SCHOOL DISTRICT  
 8272 MAIN STREET, HAMMONDSPORT, NEW YORK, 14840

**MB-L0.1**  
PROJECT NO: 1925.014


**HUNT ENGINEERS | ARCHITECTS | SURVEYORS**  
 HORSEHEADS, NY 687-855-8005 ROCHESTER, NY 663-557-7860 TOWANDA, PA 570-265-4688  
 BINGHAMTON, NY 607-738-1881 ALBANY, NY 607-738-8881  
 WWW.HUNTEAS.COM  
 NY CERTIFICATE NO. 0016220 PA CERTIFICATE NO. TSC2203131464-1

#	DATE	DESCRIPTION OF REVISION	ISSUED FOR	CD
1	12/11/2025	ISSUED FOR BID		


DRAWN BY: EB  
 CHECKED BY: SM  
 DATE: 10/27/2025  
 PHASE: CD  
 Copyright 2025

THIS IS A VIOLATION OF THE LAW FOR ANY PERSON TO MAKE UNAUTHORIZED ALTERATIONS OR ADDITIONS TO PLANS OR DRAWINGS PREPARED BY HUNT ENGINEERS, ARCHITECTS & SURVEYORS, INC.



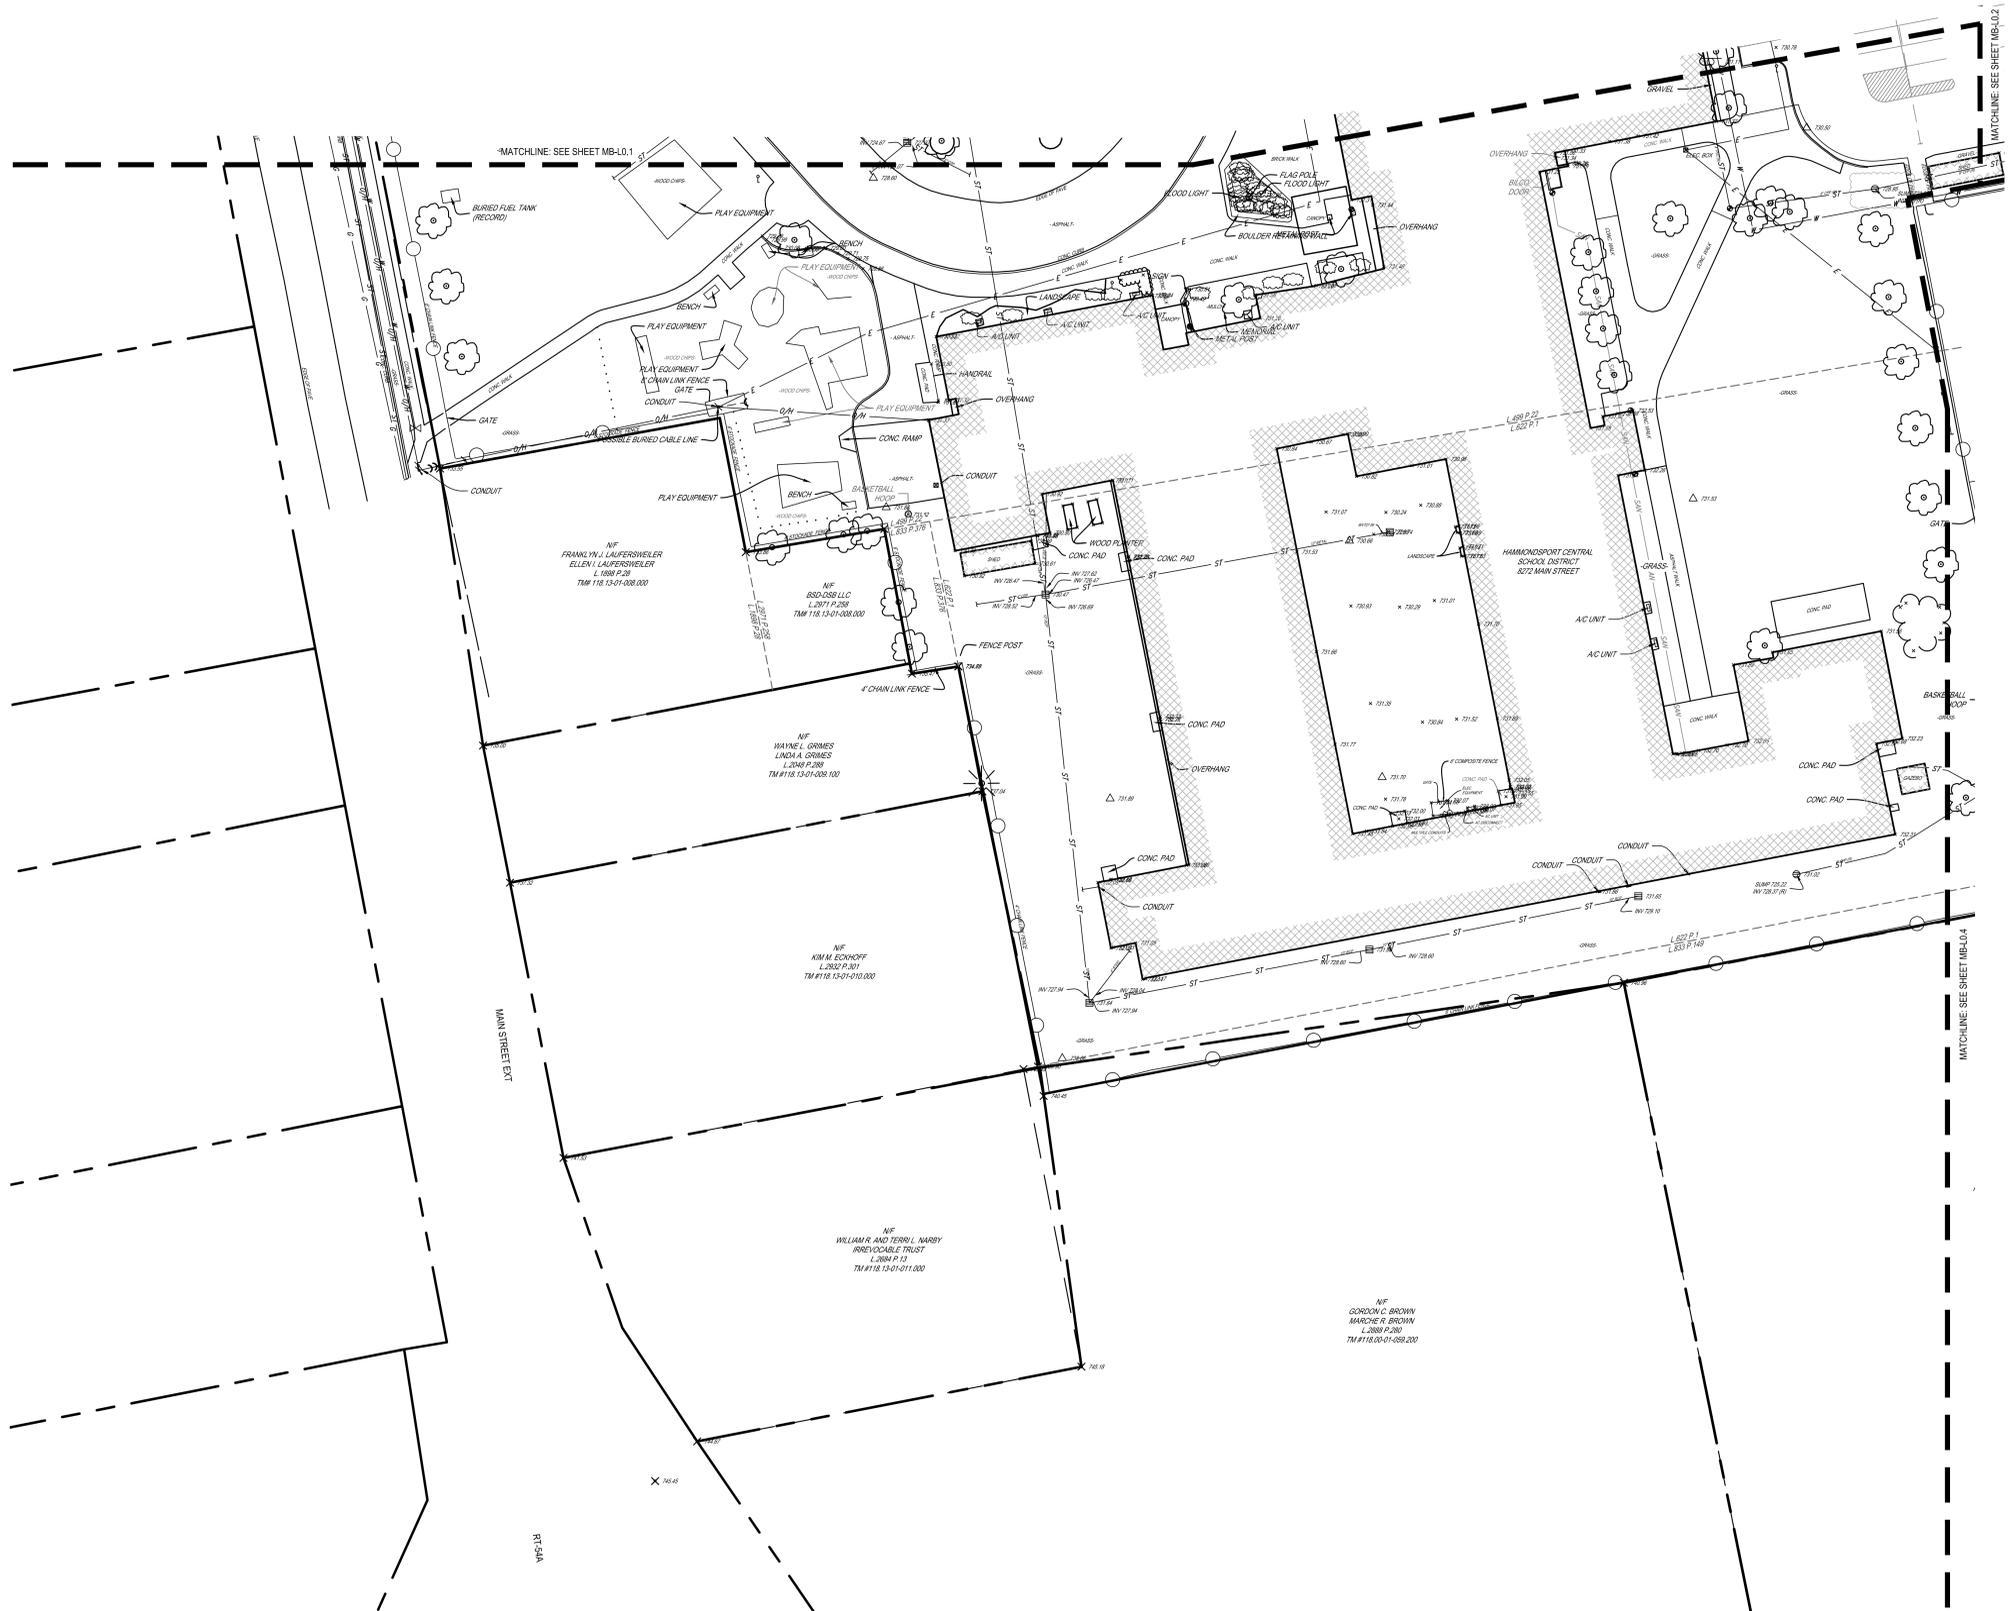

1 SITE EXISTING CONDITIONS PLAN  
SCALE: 1" = 30'

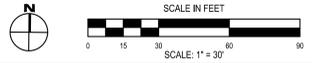

SED NUMBERS: MB, 57-28-01-04-000-005, BG, 57-28-01-04-5-005-008

**SITE EXISTING CONDITIONS PLAN**  
**2025 CAPITAL IMPROVEMENTS PROJECT**  
**HAMMONDSPORT CENTRAL SCHOOL DISTRICT**  
 8272 MAIN STREET, HAMMONDSPORT, NEW YORK, 14840

**MB-L0.3**  
 PROJECT NO: 1925.014

**HUNT ENGINEERS | ARCHITECTS | SURVEYORS**  
 HORSEHEADS, NY 607-365-8000 ROCHESTER, NY 662-597-7960 TOWANDA, PA 570-265-4888  
 BINGHAMTON, NY 607-738-5881 ALBANY, NY 607-738-8881  
 WWW.HUNTEAS.COM  
 NY CERTIFICATE NO. 0016220 PA CERTIFICATE NO. TSC220313464-1

DATE	12/11/2025	DESCRIPTION OF REVISION	ISSUED FOR BID
PHASE	CD		
CHECKED BY:	SM	DATE:	10/27/2025
DRAWN BY:	EB	PHASE:	CD


TITLE & NOTATION OF THE PLAN FOR ANY PERSON TO MAKE UNAUTHORIZED ALTERATIONS OR ADDITIONS TO PLANS  
 © HUNT ENGINEERS, ARCHITECTS & SURVEYORS, INC. 2025





- SITE DEMOLITION NOTES:**
- BASE BID:**
1. REMOVE PLAYGROUND EQUIPMENT, AND FOUNDATIONS.
  2. REMOVE CONCRETE SIDEWALK AND SUBBASE TO LIMITS SHOWN.
  3. REMOVE BASKETBALL HOOP AND FOUNDATION.
  4. REMOVE CHAINLINK FENCE AND FOUNDATIONS.
  5. REMOVE ADA SIGNS AND FOUNDATIONS.
  6. REMOVE BATTING CAGES AND FOUNDATIONS.
  7. REMOVE SOFTBALL BACKSTOP AND FOUNDATIONS.
  8. REMOVE EXISTING CLAY AND BASE PLATES.
  9. SALVAGE DUGOUTS FOR RELOCATION. REMOVE CONCRETE PAD AND SUBBASE UNDERNEATH, EC TO TRACE AND DISCONNECT EXISTING ELECTRICAL DEVICES AND ASSOCIATED CIRCUITRY/CONDUIT BACK TO SOURCE. COMMUNICATIONS CABLING AND INFRASTRUCTURE IN DUGOUT FOR SCOREBOARD TO BE REMOVED BACK TO SCOREBOARD EXTENT WITHOUT INTERFERING WITH ANY OTHER INSTALLATIONS. CIRCUITRY PERTAINING TO SCOREBOARD AND SPORTS LIGHTING TO REMAIN. EXISTING DEVICES / INFRASTRUCTURE TO REMAIN ON THE INTERIOR OF THE DUGOUT. PREPARE FOR DUGOUT RELOCATION AND RECONNECTION TO DEVICES.
  10. REMOVE TENNIS COURT SURFACING. PROTECT ASPHALT TO REMAIN. PREPARE COURTS FOR CRACK REPAIR AND RESURFACING.
  11. PROTECT EXISTING TENNIS NET POLES TO REMAIN.
  12. SAWCUT AND REMOVE ASPHALT PAVEMENT AND SUBBASE 2" FROM EDGE OF CURB.
  13. REMOVE GRANITE CURB AND SALVAGE FOR REUSE.
  14. REMOVE EXISTING CONCRETE RAMP, SUBBASE, AND TRUNCATED DOMES. PROTECT EXISTING FIRE HYDRANT AND WATER LINE TO REMAIN.
  15. PROTECT EXISTING TREE TO REMAIN. SEE DETAIL 15/MB-L4.2.
  16. ALTERNATE 1: REMOVE CHAINLINK FENCE, GATE AND FOUNDATIONS. PROTECT EXISTING FOUL POST TO REMAIN.
  17. REMOVE GAS LINE FOR RELOCATION IN COORDINATION WITH CORNING NATURAL GAS.
  18. REMOVE EXISTING TREE. GRIND ROOTS AND STUMP. REMOVE WOOD CHIPS AND BACKFILL WITH TOPSOIL.
  19. SALVAGE EXISTING TREE FOR RELOCATION. CONTRACTOR RESPONSIBLE FOR REPLACEMENT IN-KIND IF RELOCATION IS UNSUCCESSFUL.
  20. PROTECT EXISTING PLAYGROUND EQUIPMENT, BENCHES, AND FOUNDATIONS TO REMAIN.
  21. SALVAGE EXISTING BLEACHERS FOR REUSE.
  22. REMOVE ENGINEERED WOOD FIBER TO EXTENTS OF PLAYGROUND. PROTECT EXISTING EQUIPMENT AND FOUNDATIONS NOTED TO REMAIN. PROTECT EXISTING UNDERDRAIN TO REMAIN.
  23. REMOVE EXISTING VESTIBULE, OVERHANG AND BILCO DOOR. SEE ARCHITECTURE.
  24. REMOVE EXISTING SANITARY LINE TO LIMITS SHOWN.
  25. REMOVE EXISTING SANITARY CLEANOUT.
  26. REMOVE EXISTING STORM LINE TO LIMITS SHOWN. IF REMOVE WILL IMPACT EXISTING TREES, CUT AND USE FLOWABLE FILL IN THOSE AREAS.
  27. REMOVE EXISTING STORM CLEANOUT.
  28. REMOVE EXISTING WATER LINE TO LIMITS SHOWN. IF REMOVE WILL IMPACT EXISTING TREES, CUT AND USE FLOWABLE FILL IN THOSE AREAS.
  29. EXISTING PULL BOX TO BE REMOVED AND CIRCUITRY TO BE RELOCATED. DISCONNECT AND SECURE EXISTING CIRCUITRY FOR REUSE.
  30. EXISTING CONDUITS TO BE REMOVED BACK TO BUILDING FROM PULL BOX LOCATION. CONDUIT RUNS INTO CRAWL SPACE NEAR THIS LOCATION. MODIFY EXISTING CONDUIT / CIRCUITRY IN CRAWL SPACE FOR PARKING LOT / TENNIS COURT CIRCUITS IN ORDER TO CONNECT TO NEW PULL BOX LOCATION.
  31. ALTERNATE 2: REMOVE EXISTING DRYWELL.
  32. ALTERNATE 2: REMOVE EXISTING STORM PIPE.
  33. DISCONNECT AND REMOVE EXISTING GFCI RECEPTACLE, AND ASSOCIATED CONDUIT / CIRCUITRY BACK TO BASEBALL FIELD DUGOUT.
  34. REMOVE EXISTING CONDUIT PERTAINING TO EXISTING SITE LIGHTING / TENNIS COURT CIRCUITRY FROM PULL TO EXTENTS AS SHOWN ON PLAN. EC TO VERIFY CONDUIT ROUTING PRIOR TO STARTING WORK.
  35. REMOVE EXISTING GRAVEL DRIVE TO LIMITS NECESSARY FOR TRENCHING NEW UTILITIES. SEE SHEET MB-E4.1.

1 SITE DEMOLITION PLAN  
SCALE: 1" = 30'

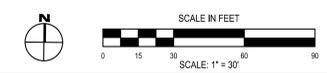


<p><b>HUNT ENGINEERS   ARCHITECTS   SURVEYORS</b></p> <p>HORSEHEADS, NY 607-808-8000 ROCHESTER, NY 661-357-7860 TOWANDA, PA 570-265-4888        BINGHAMTON, NY 607-738-1881 ALBANY, NY 607-738-8881        WWW.HUNTEAS.COM        NY CERTIFICATE NO. 0016220 PA CERTIFICATE NO. 15C20313464-1</p>	<p>DRAWN BY: EB        CHECKED BY: SM        DATE: 10/27/2025        PHASE: CD</p>
<p>DESCRIPTION OF REVISION:        ISSUED FOR BID</p>	<p># DATE</p> <p>1 10/11/2025</p>
<p>IT IS A VIOLATION OF THE LAW FOR ANY PERSON TO MAKE UNAUTHORIZED ALTERATIONS OR ADDITIONS TO PLANS OR DRAWINGS PREPARED BY A LICENSED ENGINEER, ARCHITECT OR SURVEYOR AND SEAL.</p>	

<p><b>SITE DEMOLITION PLAN</b></p> <p><b>2025 CAPITAL IMPROVEMENTS PROJECT</b></p> <p><b>HAMMONDSPORT CENTRAL SCHOOL DISTRICT</b></p> <p>8272 MAIN STREET, HAMMONDSPORT, NEW YORK, 14840</p>	<p><b>MB-L1.1</b></p> <p>PROJECT NO: 1925.014</p>
--	---



1 SITE DEMOLITION PLAN  
SCALE: 1" = 30'

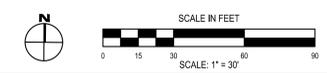

- SITE DEMOLITION NOTES:**
- BASE BID:**
1. REMOVE PLAYGROUND EQUIPMENT, AND FOUNDATIONS.
  2. REMOVE CONCRETE SIDEWALK AND SUBBASE TO LIMITS SHOWN.
  3. REMOVE BASKETBALL HOOP AND FOUNDATION.
  4. REMOVE CHAINLINK FENCE AND FOUNDATIONS.
  5. REMOVE ADA SIGNS AND FOUNDATIONS.
  6. REMOVE BATTING CAGES AND FOUNDATIONS.
  7. REMOVE SOFTBALL BACKSTOP AND FOUNDATIONS.
  8. REMOVE EXISTING CLAY AND BASE PLATES.
  9. SALVAGE DUGOUTS FOR RELOCATION. REMOVE CONCRETE PAD AND SUBBASE UNDERNEATH. EC TO TRACE AND DISCONNECT EXISTING ELECTRICAL DEVICES AND ASSOCIATED CIRCUITRY/CONDUIT BACK TO SOURCE. COMMUNICATIONS CABLING AND INFRASTRUCTURE IN DUGOUT FOR SCOREBOARD TO BE REMOVED BACK TO SCOREBOARD EXTENT WITHOUT INTERFERING WITH ANY OTHER INSTALLATIONS. CIRCUITRY PERTAINING TO SCOREBOARD AND SPORTS LIGHTING TO REMAIN. EXISTING DEVICES / INFRASTRUCTURE TO REMAIN ON THE INTERIOR OF THE DUGOUT. PREPARE FOR DUGOUT RELOCATION AND RECONNECTION TO DEVICES.
  10. REMOVE TENNIS COURT SURFACING. PROTECT ASPHALT TO REMAIN. PREPARE COURTS FOR CRACK REPAIR AND RESURFACING.
  11. PROTECT EXISTING TENNIS NET POLES TO REMAIN.
  12. SAWCUT AND REMOVE ASPHALT PAVEMENT AND SUBBASE 2' FROM EDGE OF CURB.
  13. REMOVE GRANITE CURB AND SALVAGE FOR REUSE.
  14. REMOVE EXISTING CONCRETE RAMP, SUBBASE, AND TRUNCATED DOMES. PROTECT EXISTING FIRE HYDRANT AND WATER LINE TO REMAIN.
  15. PROTECT EXISTING TREE TO REMAIN. SEE DETAIL, 15MB-L4.2.
  16. ALTERNATE 1: REMOVE CHAINLINK FENCE, GATE AND FOUNDATIONS. PROTECT EXISTING FOUL POST TO REMAIN.
  17. REMOVE GAS LINE FOR RELOCATION IN COORDINATION WITH CORNING NATURAL GAS.
  18. REMOVE EXISTING TREE. GRIND ROOTS AND STUMP. REMOVE WOOD CHIPS AND BACKFILL WITH TOPSOIL.
  19. SALVAGE EXISTING TREE FOR RELOCATION. CONTRACTOR RESPONSIBLE FOR REPLACEMENT IN-KIND IF RELOCATION IS UNSUCCESSFUL.
  20. PROTECT EXISTING PLAYGROUND EQUIPMENT, BENCHES, AND FOUNDATIONS TO REMAIN.
  21. SALVAGE EXISTING BLEACHERS FOR REUSE.
  22. REMOVE ENGINEERED WOOD FIBER TO EXTENTS OF PLAYGROUND. PROTECT EXISTING EQUIPMENT AND FOUNDATIONS NOTED TO REMAIN. PROTECT EXISTING UNDERDRAIN TO REMAIN.
  23. REMOVE EXISTING VESTIBULE, OVERHANG AND BILCO DOOR. SEE ARCHITECTURE.
  24. REMOVE EXISTING SANITARY LINE TO LIMITS SHOWN.
  25. REMOVE EXISTING SANITARY CLEANOUT.
  26. REMOVE EXISTING STORM LINE TO LIMITS SHOWN. IF REMOVAL WILL IMPACT EXISTING TREES, CUT AND USE FLOWABLE FILL IN THOSE AREAS.
  27. REMOVE EXISTING STORM CLEANOUT.
  28. REMOVE EXISTING WATER LINE TO LIMITS SHOWN. IF REMOVAL WILL IMPACT EXISTING TREES, CUT AND USE FLOWABLE FILL IN THOSE AREAS.
  29. EXISTING PULL BOX TO BE REMOVED AND CIRCUITRY TO BE RELOCATED. DISCONNECT AND SECURE EXISTING CIRCUITRY FOR REUSE.
  30. EXISTING CONDUITS TO BE REMOVED BACK TO BUILDING FROM PULL BOX LOCATION. CONDUIT RUNS INTO CRAWL SPACE NEAR THIS LOCATION. MODIFY EXISTING CONDUIT / CIRCUITRY IN CRAWL SPACE FOR PARKING LOT / TENNIS COURT CIRCUITS IN ORDER TO CONNECT TO NEW PULL BOX LOCATION.
  31. ALTERNATE 2: REMOVE EXISTING DRYWELL.
  32. ALTERNATE 2: REMOVE EXISTING STORM PIPE.
  33. DISCONNECT AND REMOVE EXISTING GFCI RECEPTACLE, AND ASSOCIATED CONDUIT / CIRCUITRY BACK TO BASEBALL FIELD DUGOUT.
  34. REMOVE EXISTING CONDUIT PERTAINING TO EXISTING SITE LIGHTING / TENNIS COURT CIRCUITRY FROM PULL BOX TO EXTENTS AS SHOWN ON PLAN. EC TO VERIFY CONDUIT ROUTING PRIOR TO STARTING WORK.
  35. REMOVE EXISTING GRAVEL DRIVE TO LIMITS NECESSARY FOR TRENCHING NEW UTILITIES. SEE SHEET MB-E4.1.

SED NUMBERS: MB, 57-28-01-04-00-0205, BG, 57-28-01-04-5-005-008


**SITE DEMOLITION PLAN**  
**2025 CAPITAL IMPROVEMENTS PROJECT**  
**HAMMONDSPORT CENTRAL SCHOOL DISTRICT**  
8272 MAIN STREET, HAMMONDSPORT, NEW YORK, 14840

**MB-L1.2**  
PROJECT NO: 1925.014

DATE	DESCRIPTION OF REVISION	ISSUED FOR	BY
1 12/11/2025			EB
PHASE:			SM
DATE:	10/27/2025		CD
CHECKED BY:			
DRAWN BY:			


IT IS A VIOLATION OF THE LAW FOR ANY PERSON TO MAKE UNAUTHORIZED ALTERATIONS OR ADDITIONS TO PLANS.  
SEALING A LICENSED ENGINEER, ARCHITECT OR SURVEYOR'S SEAL.

**HUNT ENGINEERS | ARCHITECTS | SURVEYORS**  
HORSEHEADS, NY 867-8800 BINGHAMTON, NY 661-597-7860 TOWANACK, PA 570-265-4688  
BINGHAMTON, NY 867-788-8881 ALBANY, NY 607-738-8881  
WWW.HUNTEAS.COM  
NY CERTIFICATE NO. 0016220 PA CERTIFICATE NO. TSC220313464-1

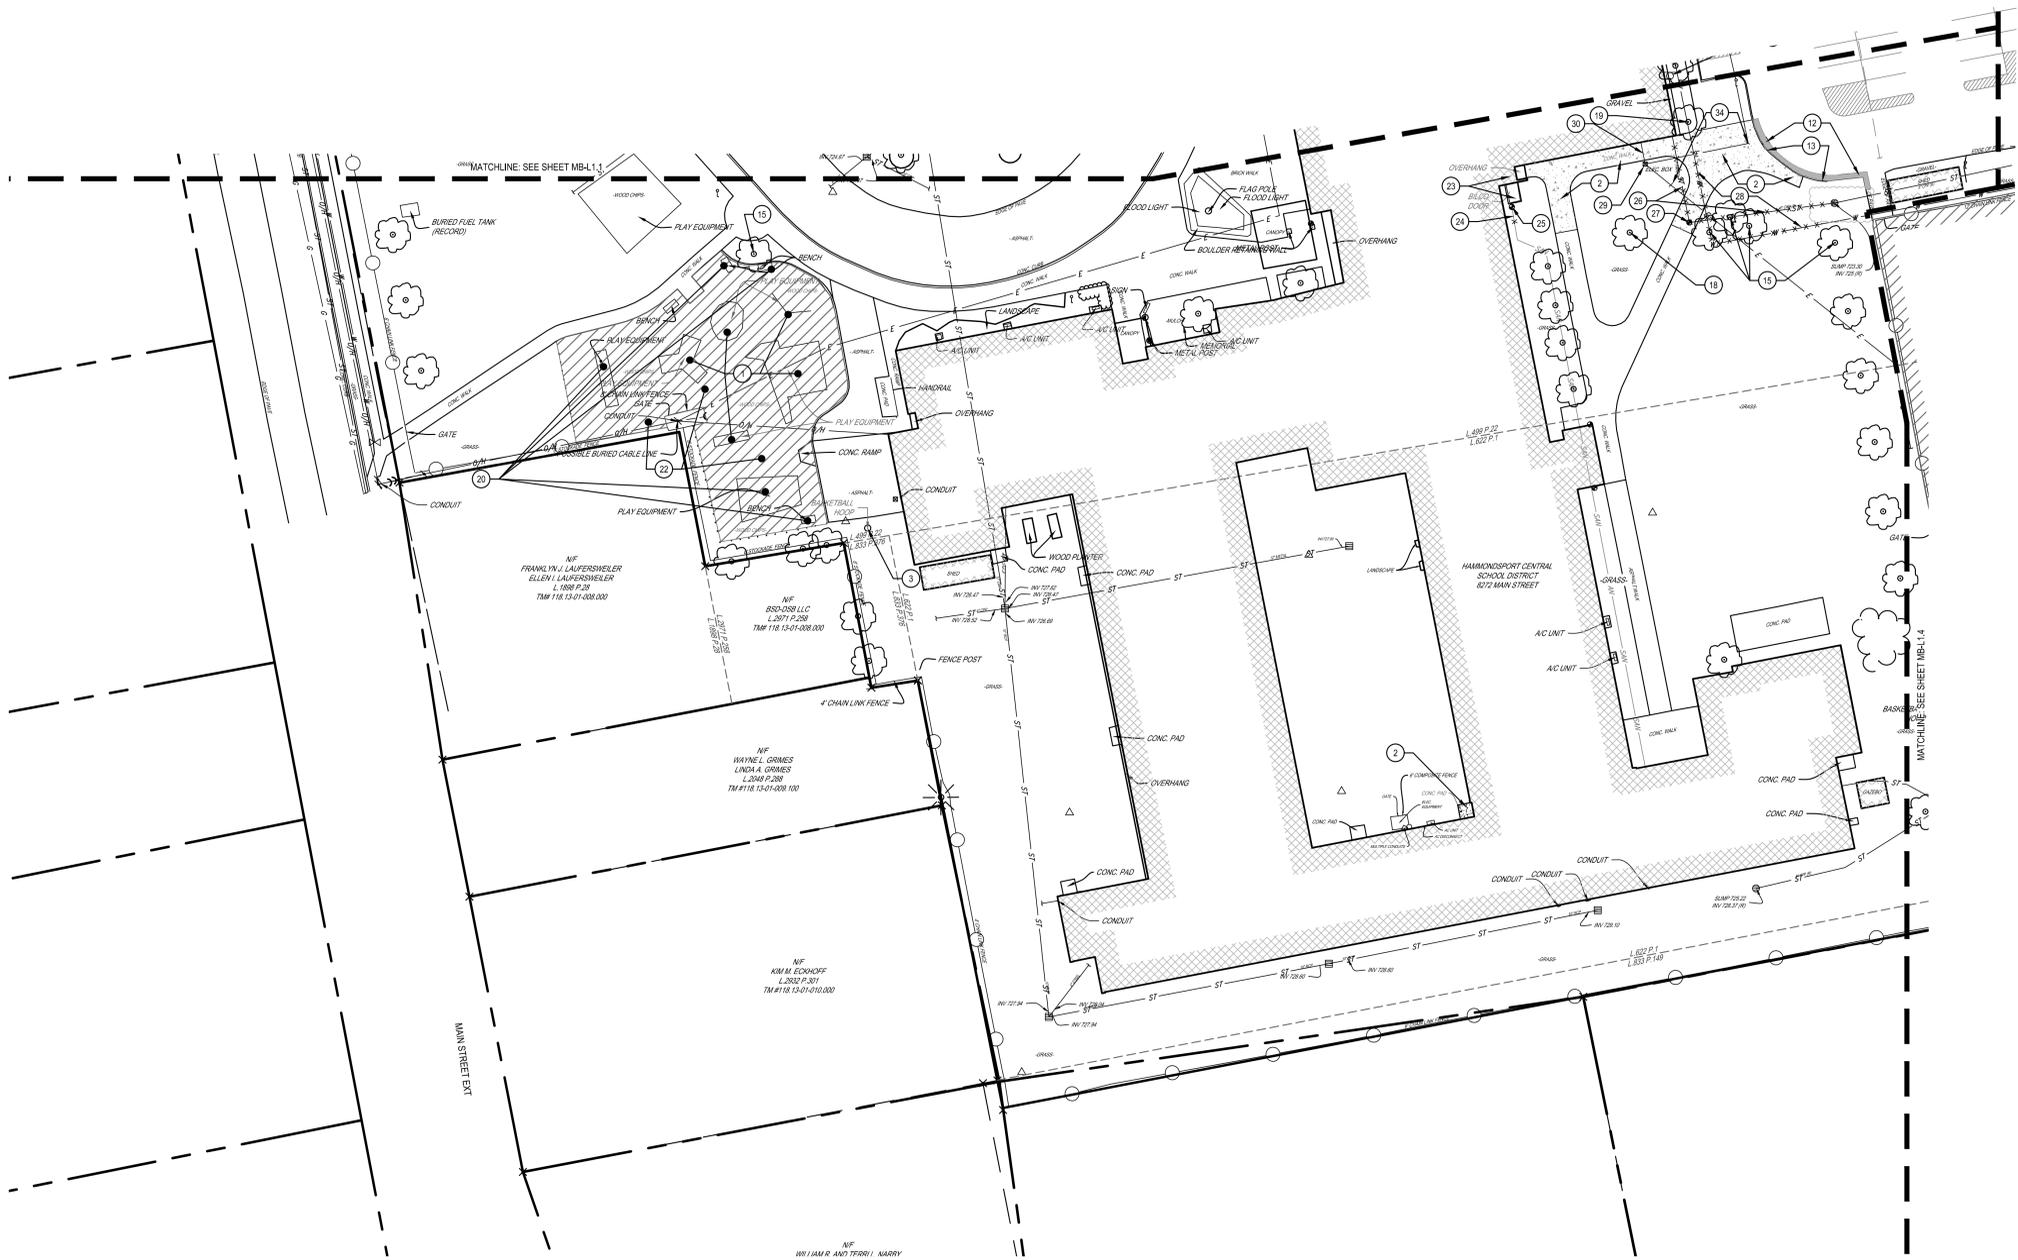

- SITE DEMOLITION NOTES:**
- BASE BID:**
- REMOVE PLAYGROUND EQUIPMENT, AND FOUNDATIONS.
  - REMOVE CONCRETE SIDEWALK AND SUBBASE TO LIMITS SHOWN.
  - REMOVE BASKETBALL HOOP AND FOUNDATION.
  - REMOVE CHAINLINK FENCE AND FOUNDATIONS.
  - REMOVE ADA SIGNS AND FOUNDATIONS.
  - REMOVE BATTING CAGES AND FOUNDATIONS.
  - REMOVE SOFTBALL BACKSTOP AND FOUNDATIONS.
  - REMOVE EXISTING CLAY AND BASE PLATES.
  - SALVAGE DUGOUTS FOR RELOCATION. REMOVE CONCRETE PAD AND SUBBASE UNDERNEATH. EC TO TRACE AND DISCONNECT EXISTING ELECTRICAL DEVICES AND ASSOCIATED CIRCUITRY/CONDUIT BACK TO SOURCE. COMMUNICATIONS CABLING AND INFRASTRUCTURE IN DUGOUT FOR SCOREBOARD TO BE REMOVED BACK TO SCOREBOARD EXTENT WITHOUT INTERFERING WITH ANY OTHER INSTALLATIONS. CIRCUITRY PERTAINING TO SCOREBOARD AND SPORTS LIGHTING TO REMAIN. EXISTING DEVICES / INFRASTRUCTURE TO REMAIN ON THE INTERIOR OF THE DUGOUT. PREPARE FOR DUGOUT RELOCATION AND RECONNECTION TO DEVICES.
  - REMOVE TENNIS COURT SURFACING. PROTECT ASPHALT TO REMAIN. PREPARE COURTS FOR CRACK REPAIR AND RESURFACING.
  - PROTECT EXISTING TENNIS NET POLES TO REMAIN.
  - SAW CUT AND REMOVE ASPHALT PAVEMENT AND SUBBASE 2' FROM EDGE OF CURB.
  - REMOVE GRANITE CURB AND SALVAGE FOR REUSE.
  - REMOVE EXISTING CONCRETE RAMP, SUBBASE, AND TRUNCATED DOMES. PROTECT EXISTING FIRE HYDRANT AND WATER LINE TO REMAIN.
  - PROTECT EXISTING TREE TO REMAIN. SEE DETAIL 15MB4.4.2.
  - ALTERNATE 1: REMOVE CHAINLINK FENCE, GATE AND FOUNDATIONS. PROTECT EXISTING FOUL POST TO REMAIN.
  - REMOVE GAS LINE FOR RELOCATION IN COORDINATION WITH CORNING NATURAL GAS.
  - REMOVE EXISTING TREE. GRIND ROOTS AND STUMP. REMOVE WOOD CHIPS AND BACKFILL WITH TOPSOIL.
  - SALVAGE EXISTING TREE FOR RELOCATION. CONTRACTOR RESPONSIBLE FOR REPLACEMENT IN KIND IF RELOCATION IS UNSUCCESSFUL.
  - PROTECT EXISTING PLAYGROUND EQUIPMENT, BENCHES, AND FOUNDATIONS TO REMAIN.
  - SALVAGE EXISTING BLEACHERS FOR REUSE.
  - REMOVE ENGINEERED WOOD FIBER TO EXTENTS OF PLAYGROUND. PROTECT EXISTING EQUIPMENT AND FOUNDATIONS NOTED TO REMAIN. PROTECT EXISTING UNDERDRAIN TO REMAIN.
  - REMOVE EXISTING VESTIBULE, OVERHANG AND BILCO DOOR. SEE ARCHITECTURE.
  - REMOVE EXISTING SANITARY LINE TO LIMITS SHOWN.
  - REMOVE EXISTING SANITARY CLEANOUT.
  - REMOVE EXISTING STORM LINE TO LIMITS SHOWN. IF REMOVAL WILL IMPACT EXISTING TREES, CUT AND USE FLOWABLE FILL IN THOSE AREAS.
  - REMOVE EXISTING STORM CLEANOUT.
  - REMOVE EXISTING WATER LINE TO LIMITS SHOWN. IF REMOVAL WILL IMPACT EXISTING TREES, CUT AND USE FLOWABLE FILL IN THOSE AREAS.
  - EXISTING PULL BOX TO BE REMOVED AND CIRCUITRY TO BE RELOCATED. DISCONNECT AND SECURE EXISTING CIRCUITRY FOR REUSE.
  - EXISTING CONDUITS TO BE REMOVED BACK TO BUILDING FROM PULL BOX LOCATION. CONDUIT RUNS INTO CRAWL SPACE NEAR THIS LOCATION. MODIFY EXISTING CONDUIT / CIRCUITRY IN CRAWL SPACE FOR PARKING LOT / TENNIS COURT CIRCUITS IN ORDER TO CONNECT TO NEW PULL BOX LOCATION.
  - ALTERNATE 2: REMOVE EXISTING DRYWELL.
  - ALTERNATE 2: REMOVE EXISTING STORM PIPE.
  - DISCONNECT AND REMOVE EXISTING GFCI RECEPTACLE, AND ASSOCIATED CONDUIT / CIRCUITRY BACK TO BASEBALL FIELD DUGOUT.
  - REMOVE EXISTING CONDUIT PERTAINING TO EXISTING SITE LIGHTING / TENNIS COURT CIRCUITRY FROM PULL TO EXTENTS AS SHOWN ON PLAN. EC TO VERIFY CONDUIT ROUTING PRIOR TO STARTING WORK.
  - REMOVE EXISTING GRAVEL DRIVE TO LIMITS NECESSARY FOR TRENCHING NEW UTILITIES. SEE SHEET MB-EA-1.

1 SITE DEMOLITION PLAN  
SCALE: 1" = 30'

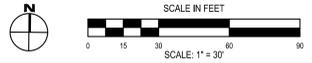

DATE	12/11/2025	DESCRIPTION OF REVISION	ISSUED FOR BID
DATE	10/27/2025	DATE	10/27/2025
PHASE	CD	CHECKED BY:	SM
		DRAWN BY:	EB

**HUNT ENGINEERS | ARCHITECTS | SURVEYORS**  
 HORSEHEADS, NY 807-880-8000 ROCHESTER, NY 866-597-7860 FOWANCO, PA 570-265-4688  
 BINGHAMTON, NY 807-798-1881 ALBANY, NY 807-798-8881  
 WWW.HUNTEAS.COM  
 NY CERTIFICATE NO. 0016220 PA CERTIFICATE NO. 15C2020313464-1

**SITE DEMOLITION PLAN**  
**2025 CAPITAL IMPROVEMENTS PROJECT**  
**HAMMONDSPORT CENTRAL SCHOOL DISTRICT**  
 8272 MAIN STREET, HAMMONDSPORT, NEW YORK, 14840

**MB-L1.3**  
 PROJECT NO: 1925.014

SED NUMBERS MB-57-26-01-04-00-02-05, BG-57-26-01-04-5-005-008

THIS IS A VIOLATION OF THE LAW FOR ANY PERSON TO MAKE UNAUTHORIZED ALTERATIONS OR ADDITIONS TO PLANS  
 DRAWING LICENSED ENGINEER, ARCHITECT OR SURVEYOR





- # SITE IMPROVEMENT NOTES:**
- BASE BID:**
1. PROVIDE FULL DEPTH HEAVY DUTY ASPHALT. SEE DETAIL 6MB-L4.2.
  2. PROVIDE GRANITE CURB. REUSE SALVAGED PIECES TO EXTENT POSSIBLE. SEE DETAIL 3MB-L4.2.
  3. PROVIDE 6" THICK FIBER REINFORCED CONCRETE SIDEWALK. SEE DETAIL 1MB-L4.1.
  4. PROVIDE ADA RAMP AND TRUNCATED DOMES. SEE DETAIL 2MB-L4.2.
  5. PROVIDE 6" GRANITE CURB TAPER. SEE DETAIL 5MB-L4.2.
  6. PROVIDE CROSSWALK PAVEMENT STRIPING TO MATCH EXISTING CONDITION.
  7. PROVIDE ENGINEERED WOOD FIBER PLAY SURFACING FOR THE ENTIRETY OF THE PLAYGROUND AREA AT A MINIMUM DEPTH OF 12". SEE DETAIL 8MB-L4.2.
  8. PROVIDE NEW PLAYGROUND EQUIPMENT AND FOUNDATIONS. BASIS OF DESIGN IS POWERSCAPE MODULAR PLAY STRUCTURES BY GAMETIME, A PLAYCORE COMPANY. SEE DETAILS 9MB-L4.1 & 9MB-L4.2.
  9. PROVIDE BASKETBALL HOOP AND FOUNDATION. SEE DETAIL 1MB-L4.2.
  10. PROVIDE CONCRETE PAD WITH FROST WALL AT DOOR. SEE DETAIL 10MB-L4.2.
  11. PROVIDE COURT CRACK REPAIR, RESURFACING AND STRIPING FOR PICKLEBALL AND TENNIS AS SHOWN. SEE DETAILS 4 & 7MB-L4.1.
  12. PROVIDE 4 PORTABLE PICKLEBALL NETS. SEE SPECIFICATIONS.
  13. PROVIDE SINGLE CHAIN LINK FENCE SWING GATE. SEE DETAIL 8MB-L4.1.
  14. AERATE, OVERSEED, AND TOPDRESS SOCCER FIELD TO 10' BEYOND LIMITS OF FIELD. RESTRIPE FIELD. SEE DETAIL 5MB-L4.1.
  15. ALTERNATE 2: PROVIDE 6" THICK FIBER REINFORCED CONCRETE SIDEWALK. SEE DETAIL 1MB-L4.1.
  16. PROVIDE LONG JUMP PIT COVER FOR EXISTING PIT. SEE SPECIFICATIONS.
  17. PROVIDE 6' TALL GALVANIZED CHAIN LINK FENCE. SEE DETAIL 3MB-L4.1.
  18. PROVIDE 50 SEAT, 5 ROW, PREFERRED ALUMINUM FREESTANDING BLEACHER BY NATIONAL RECREATION SYSTEMS OR APPROVED EQUAL.
  19. PROVIDE SALVAGED DUGOUT WITH NEW CONCRETE PAD & FOUNDATION. SEE DETAIL 10MB-L4.1.
  20. INSTALL SALVAGED BLEACHER.
  21. PROVIDE BATTING CAGES. SEE DETAIL 6MB-L4.1.
  22. PROVIDE ADA PARKING SIGNS. SEE DETAIL 2MB-L4.1
  23. ALTERNATE 1: PROVIDE 6' TALL GALVANIZED CHAIN LINK FENCE. SEE DETAIL 3MB-L4.1.
  24. ALTERNATE 1: PROVIDE 4" WIDE SINGLE SWING GATE TO MATCH EXISTING LOCATION. SEE DETAIL 8MB-L4.1.
  25. PROVIDE 8' TALL GALVANIZED CHAIN LINK FENCE. SEE DETAIL 3MB-L4.1.
  26. NEW VESTIBULE AND CANOPY. SEE ARCHITECTURAL DRAWINGS.
  27. RELOCATE EXISTING TREE. ENSURE NEW LOCATION IS PREPPED AND READY FOR PLANTING PRIOR TO REMOVAL FROM ORIGINAL LOCATION. PROVIDE REPLACEMENT IN KIND IF ANY TRUNK OR MAIN LEADER DAMAGE OCCURS DURING TRANSPLANTING OR MAINTENANCE PERIOD.
  28. PROVIDE GRAVEL PAD REPLACEMENT TO LIMITS OF ELECTRICAL TRENCHING DISTURBANCE. SEE DETAIL 17MB-L4.2.
- NOTE: TOPSOIL, SEED AND MULCH ALL DISTURBED LAWN AREAS.

1 SITE IMPROVEMENT PLAN  
SCALE: 1" = 30'



SED NUMBERS MB, 57-28-01-04-00-025, BG, 57-28-01-04-5-005-008

**SITE IMPROVEMENT PLAN**  
**2025 CAPITAL IMPROVEMENTS PROJECT**  
**HAMMONDSPORT CENTRAL SCHOOL DISTRICT**  
 8272 MAIN STREET, HAMMONDSPORT, NEW YORK, 14840

**MB-L2.1**  
 PROJECT NO: 1925.014

**HUNT ENGINEERS ARCHITECTS | SURVEYORS**  
 HORSEHEADS, NY 607-868-8808 ROCHESTER, NY 661-397-7864 TOWANDA, PA 570-265-4888  
 BINGHAMTON, NY 607-738-1881 ALBANY, NY 607-738-8881  
 WWW.HUNTEAS.COM  
 NY CERTIFICATE NO. 0016220 PA CERTIFICATE NO. TSC220313464-1

DATE	DESCRIPTION OF REVISION	ISSUED FOR	CD
12/11/2025	ISSUED FOR BID		

DRAWN BY: EB  
 CHECKED BY: SM  
 DATE: 10/27/2025  
 PHASE: CD  
 Copyright 2025

TITLE & VALIDATION OF THE DRAWING FOR ANY PERSON TO MAKE UNAUTHORIZED ALTERATIONS OR ADDITIONS TO THIS DRAWING IS LIMITED TO THE SIGNATURE AND SEAL OF THE REGISTERED PROFESSIONAL ENGINEER OR ARCHITECT.





- # SITE IMPROVEMENT NOTES:**
- BASE BID:**
1. PROVIDE FULL DEPTH HEAVY DUTY ASPHALT. SEE DETAIL 6MB-L4.2.
  2. PROVIDE GRANITE CURB. REUSE SALVAGED PIECES TO EXTENT POSSIBLE. SEE DETAIL 3MB-L4.2.
  3. PROVIDE 5" THICK FIBER REINFORCED CONCRETE SIDEWALK. SEE DETAIL 1MB-L4.1
  4. PROVIDE ADA RAMP AND TRUNCATED DOMES. SEE DETAIL 2MB-L4.2.
  5. PROVIDE 6" GRANITE CURB TAPER. SEE DETAIL 5MB-L4.2.
  6. PROVIDE CROSSWALK PAVEMENT STRIPING TO MATCH EXISTING CONDITION.
  7. PROVIDE ENGINEERED WOOD FIBER PLAY SURFACING FOR THE ENTIRETY OF THE PLAYGROUND AREA AT A MINIMUM DEPTH OF 12". SEE DETAIL 9MB-L4.2.
  8. PROVIDE NEW PLAYGROUND EQUIPMENT AND FOUNDATIONS. BASIS OF DESIGN IS POWERSCAPE A PLAYCORE COMPANY. SEE DETAILS 9MB-L4.1 & 9MB-L4.2.
  9. PROVIDE BASKETBALL HOOP AND FOUNDATION. SEE DETAIL 1MB-L4.2.
  10. PROVIDE CONCRETE PAD WITH FROST WALL AT DOOR. SEE DETAIL 10MB-L4.2.
  11. PROVIDE COURT CRACK REPAIR, RESURFACING AND STRIPING FOR PICKLEBALL AND TENNIS AS SHOWN. SEE DETAILS 4 & 7MB-L4.1.
  12. PROVIDE 4 PORTABLE PICKLEBALL NETS. SEE SPECIFICATIONS.
  13. PROVIDE SINGLE CHAIN LINK FENCE SWING GATE. SEE DETAIL 8MB-L4.1.
  14. AERATE, OVERSEED, AND TOPDRESS SOCCER FIELD TO 10' BEYOND LIMITS OF FIELD. RESTRIPE FIELD. SEE DETAIL 5MB-L4.1.
  15. ALTERNATE 2: PROVIDE 5" THICK FIBER REINFORCED CONCRETE SIDEWALK. SEE DETAIL 1MB-L4.1.
  16. PROVIDE LONG JUMP PIT COVER FOR EXISTING PIT. SEE SPECIFICATIONS.
  17. PROVIDE 6" TALL GALVANIZED CHAIN LINK FENCE. SEE DETAIL 3MB-L4.1.
  18. PROVIDE 50 SEAT, 5 ROW, PREFERRED ALUMINUM FREESTANDING BLEACHER BY NATIONAL RECREATION SYSTEMS OR APPROVED EQUAL.
  19. PROVIDE SALVAGED DUGOUT WITH NEW CONCRETE PAD & FOUNDATION. SEE DETAIL 10MB-L4.1.
  20. INSTALL SALVAGED BLEACHER.
  21. PROVIDE BATTING CAGES. SEE DETAIL 6MB-L4.1.
  22. PROVIDE ADA PARKING SIGNS. SEE DETAIL 2MB-L4.1
  23. ALTERNATE 1: PROVIDE 6" TALL GALVANIZED CHAIN LINK FENCE. SEE DETAIL 3MB-L4.1.
  24. ALTERNATE 1: PROVIDE 4" WIDE SINGLE SWING GATE TO MATCH EXISTING LOCATION. SEE DETAIL 8MB-L4.1.
  25. PROVIDE 6" TALL GALVANIZED CHAIN LINK FENCE. SEE DETAIL 3MB-L4.1.
  26. NEW VESTIBULE AND CANOPY. SEE ARCHITECTURAL DRAWINGS.
  27. RELOCATE EXISTING TREE. ENSURE NEW LOCATION IS PREPPED AND READY FOR PLANTING PRIOR TO REMOVAL FROM ORIGINAL LOCATION. PROVIDE REPLACEMENT IN KIND IF ANY TRUNK OR MAIN LEADER DAMAGE OCCURS DURING TRANSPLANTING OR MAINTENANCE PERIOD.
  28. PROVIDE GRAVEL PAD REPLACEMENT TO LIMITS OF ELECTRICAL TRENCHING DISTURBANCE. SEE DETAIL 17MB-L4.2.
- NOTE: TOPSOIL, SEED AND MULCH ALL DISTURBED LAWN AREAS.

1 SITE IMPROVEMENT PLAN  
SCALE: 1" = 30'



SED NUMBERS MB, 57-28-01-04-00-02-05, BG, 57-28-01-04-5-005-008

**SITE IMPROVEMENT PLAN**  
**2025 CAPITAL IMPROVEMENTS PROJECT**  
**HAMMONDSPOORT CENTRAL SCHOOL DISTRICT**  
 8272 MAIN STREET, HAMMONDSPOORT, NEW YORK, 14840

**MB-L2.3**


PROJECT NO: 1925.014

#	DATE	DESCRIPTION OF REVISION	ISSUED FOR
1	12/11/2025	ISSUED FOR BID	

DRAWN BY: EB  
 CHECKED BY: SM  
 DATE: 10/27/2025  
 PHASE: CD  
 Copyright 2025

**HUNT ENGINEERS ARCHITECTS | SURVEYORS**  
 HORSEHEADS, NY 807-808-8000 ROCHESTER, NY 866-397-7860 TOWANDA, PA 570-265-4888  
 BINGHAMTON, NY 807-738-5881 ALBANY, NY 887-738-8881  
 WWW.HUNTEAS.COM  
 NY CERTIFICATE NO. 0016220 PA CERTIFICATE NO. TSC2020131464-1

IT IS A VIOLATION OF THE LAW FOR ANY PERSON TO MAKE UNAUTHORIZED ALTERATIONS OR ADDITIONS TO PLANS  
 OF ANY LICENSED ENGINEER, ARCHITECT OR SURVEYOR.

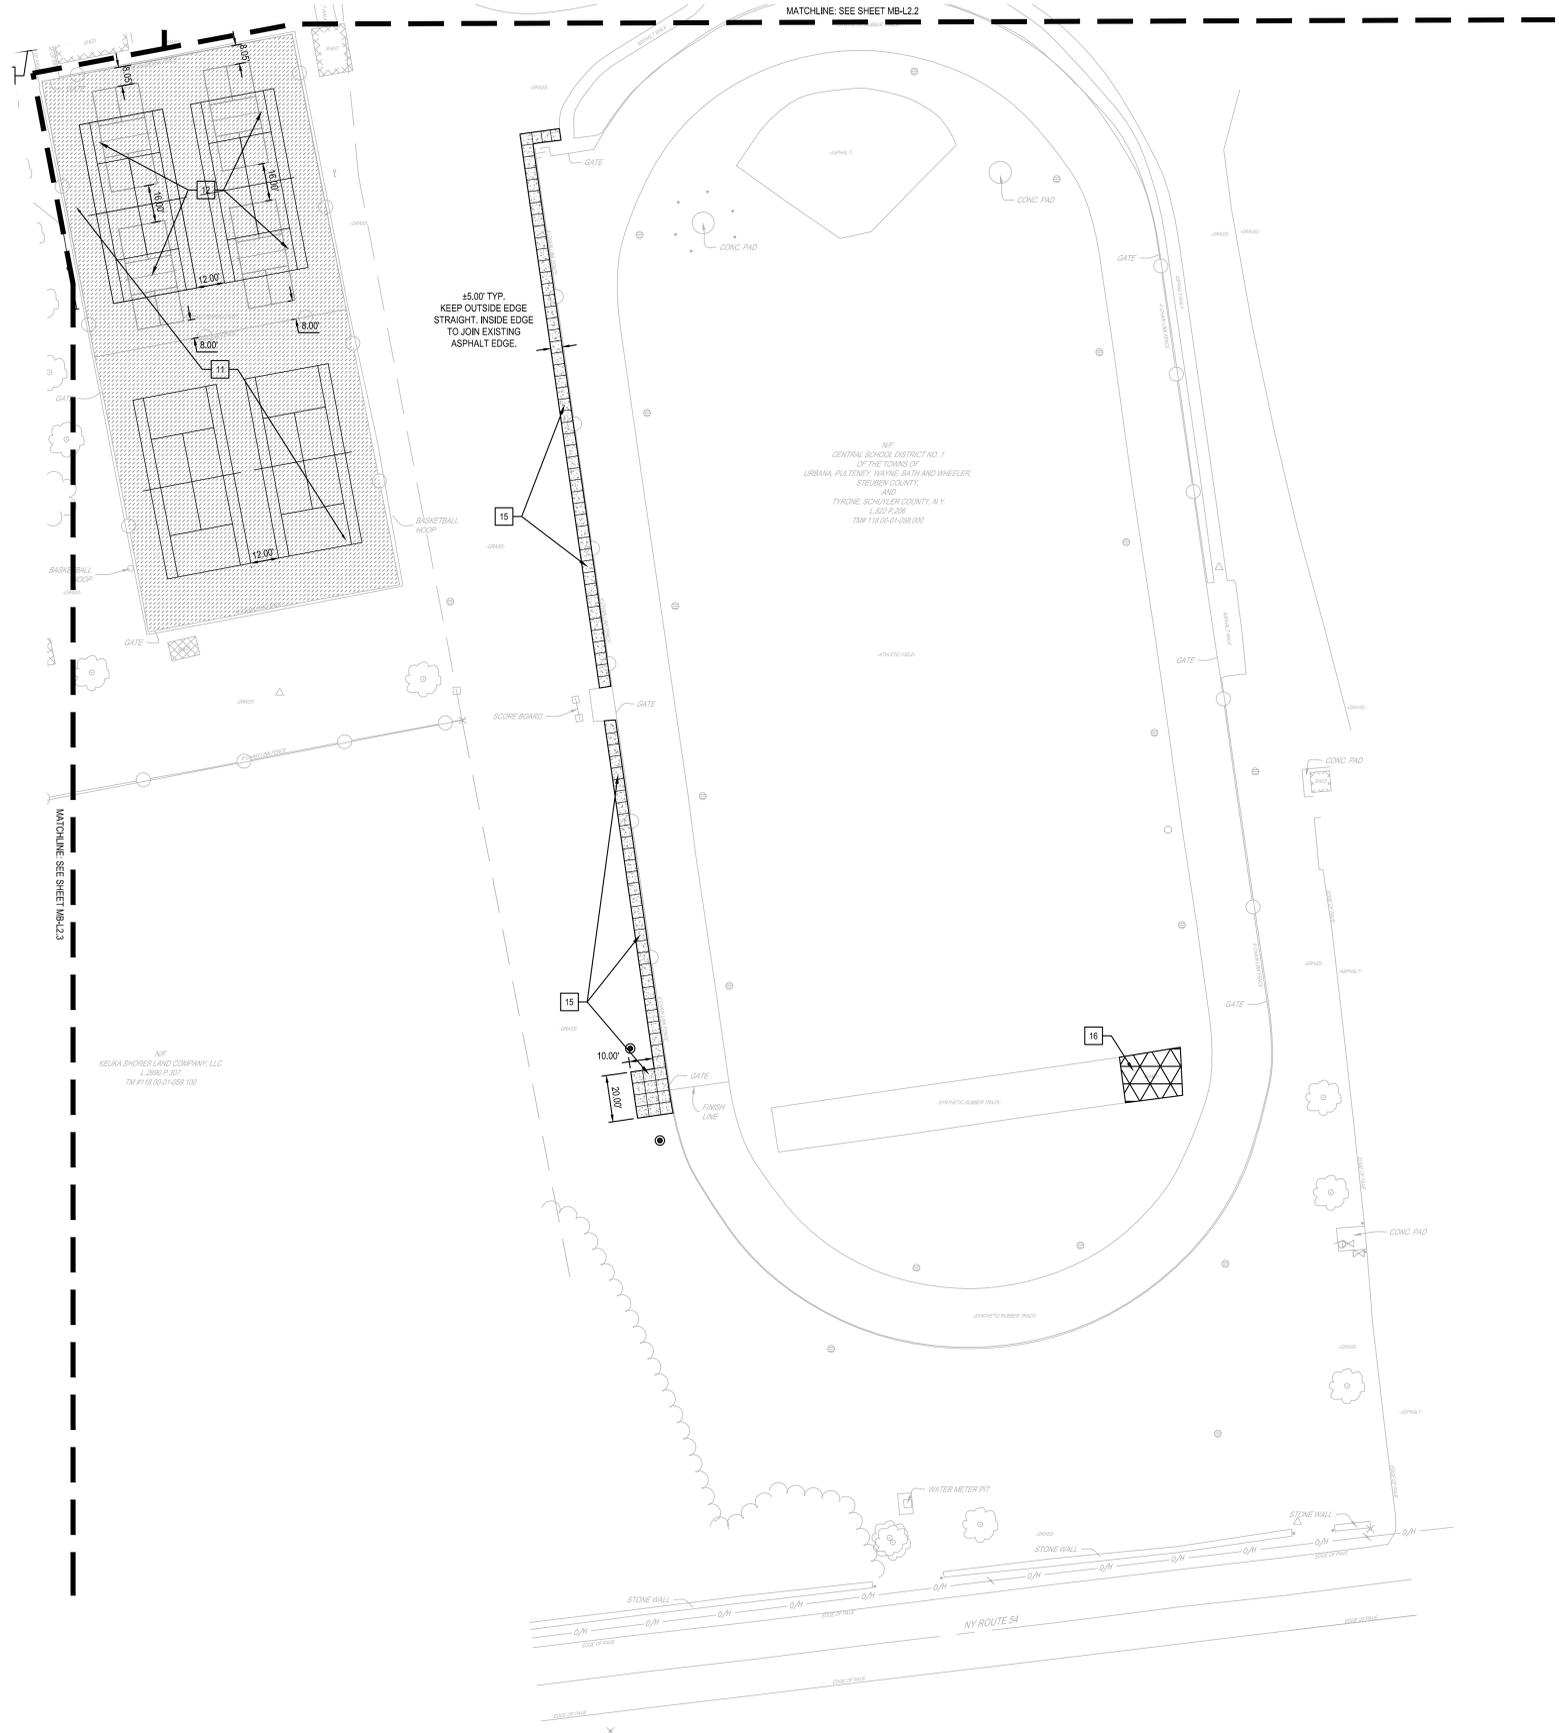

- SITE IMPROVEMENT NOTES:**
- BASE BID:**
1. PROVIDE FULL DEPTH HEAVY DUTY ASPHALT. SEE DETAIL 6MB-L4.2.
  2. PROVIDE GRANITE CURB. REUSE SALVAGED PIECES TO EXTENT POSSIBLE. SEE DETAIL 3MB-L4.2.
  3. PROVIDE 5" THICK FIBER REINFORCED CONCRETE SIDEWALK. SEE DETAIL 1MB-L4.1.
  4. PROVIDE ADA RAMP AND TRUNCATED DOMES. SEE DETAIL 2MB-L4.2.
  5. PROVIDE 6" GRANITE CURB TAPER. SEE DETAIL 5MB-L4.2.
  6. PROVIDE CROSSWALK PAVEMENT STRIPING TO MATCH EXISTING CONDITION.
  7. PROVIDE ENGINEERED WOOD FIBER PLAY SURFACING FOR THE ENTIRETY OF THE PLAYGROUND AREA AT A MINIMUM DEPTH OF 12". SEE DETAIL 8MB-L4.2.
  8. PROVIDE NEW PLAYGROUND EQUIPMENT AND FOUNDATIONS. BASIS OF DESIGN IS POWERSCAPE MODULAR PLAY STRUCTURES BY GAMETIME, A PLAYCORE COMPANY. SEE DETAILS 9MB-L4.1 & 9MB-L4.2.
  9. PROVIDE BASKETBALL HOOP AND FOUNDATION. SEE DETAIL 1MB-L4.2.
  10. PROVIDE CONCRETE PAD WITH FROST WALL AT DOOR. SEE DETAIL 10MB-L4.2.
  11. PROVIDE COURT CRACK REPAIR, RESURFACING AND STRIPING FOR PICKLEBALL AND TENNIS AS SHOWN. SEE DETAILS 4 & 7MB-L4.1.
  12. PROVIDE 4 PORTABLE PICKLEBALL NETS. SEE SPECIFICATIONS.
  13. PROVIDE SINGLE CHAIN LINK FENCE SWING GATE. SEE DETAIL 8MB-L4.1.
  14. AERATE, OVERSEED, AND TOPDRESS SOCCER FIELD TO 10' BEYOND LIMITS OF FIELD. RESTRIPE FIELD. SEE DETAIL 5MB-L4.1.
  15. ALTERNATE 2: PROVIDE 5" THICK FIBER REINFORCED CONCRETE SIDEWALK. SEE DETAIL 1MB-L4.1.
  16. PROVIDE LONG JUMP PIT COVER FOR EXISTING PIT. SEE SPECIFICATIONS.
  17. PROVIDE 6' TALL GALVANIZED CHAIN LINK FENCE. SEE DETAIL 3MB-L4.1.
  18. PROVIDE 30 SEAT, 5 ROW, PREFERRED ALUMINUM FREESTANDING BLEACHER BY NATIONAL RECREATION SYSTEMS OR APPROVED EQUAL.
  19. PROVIDE SALVAGED DUGOUT WITH NEW CONCRETE PAD & FOUNDATION. SEE DETAIL 10MB-L4.1.
  20. INSTALL SALVAGED BLEACHER.
  21. PROVIDE BATTING CAGES. SEE DETAIL 6MB-L4.1.
  22. PROVIDE ADA PARKING SIGNS. SEE DETAIL 2MB-L4.1.
  23. ALTERNATE 1: PROVIDE 6' TALL GALVANIZED CHAIN LINK FENCE. SEE DETAIL 3MB-L4.1.
  24. ALTERNATE 1: PROVIDE 4" WIDE SINGLE SWING GATE TO MATCH EXISTING LOCATION. SEE DETAIL 8MB-L4.1.
  25. PROVIDE 8' TALL GALVANIZED CHAIN LINK FENCE. SEE DETAIL 3MB-L4.1.
  26. NEW VESTIBULE AND CANOPY. SEE ARCHITECTURAL DRAWINGS.
  27. RELOCATE EXISTING TREE. ENSURE NEW LOCATION IS PREPPED AND READY FOR PLANTING PRIOR TO REMOVAL FROM ORIGINAL LOCATION. PROVIDE REPLACEMENT IN KIND IF ANY TRUNK OR MAIN LEADER DAMAGE OCCURS DURING TRANSPLANTING OR MAINTENANCE PERIOD.
  28. PROVIDE GRAVEL PAD REPLACEMENT TO LIMITS OF ELECTRICAL TRENCHING DISTURBANCE. SEE DETAIL 17MB-L4.2.
- NOTE: TOPSOIL, SEED AND MULCH ALL DISTURBED LAWN AREAS.

DRAWN BY:	EB		
CHECKED BY:	SM		
DATE:	10/27/2025		
PHASE:	CD		
#	DATE	DESCRIPTION OF REVISION	ISSUED FOR BID
1	12/11/2025		

**HUNT ENGINEERS | ARCHITECTS | SURVEYORS**  
 HORSEHEADS, NY 687-8800 ROCHESTER, NY 662-597-7860 TOWANDA, PA 570-265-4888  
 BINGHAMTON, NY 607-738-5881 ALBANY, NY 607-738-8881  
 WWW.HUNTEAS.COM  
 NY CERTIFICATE NO. 0016220 PA CERTIFICATE NO. 15C220313464-1

**SITE IMPROVEMENT PLAN**  
**2025 CAPITAL IMPROVEMENTS PROJECT**  
**HAMMONDSPORT CENTRAL SCHOOL DISTRICT**  
 8272 MAIN STREET, HAMMONDSPORT, NEW YORK, 14840


**MB-L2.4**  
 PROJECT NO: 1925.014

**1 SITE IMPROVEMENT PLAN**  
 SCALE: 1" = 30'




SED NUMBERS MB-57-28-01-04-00-02-05, BG-57-28-01-04-5-005-008



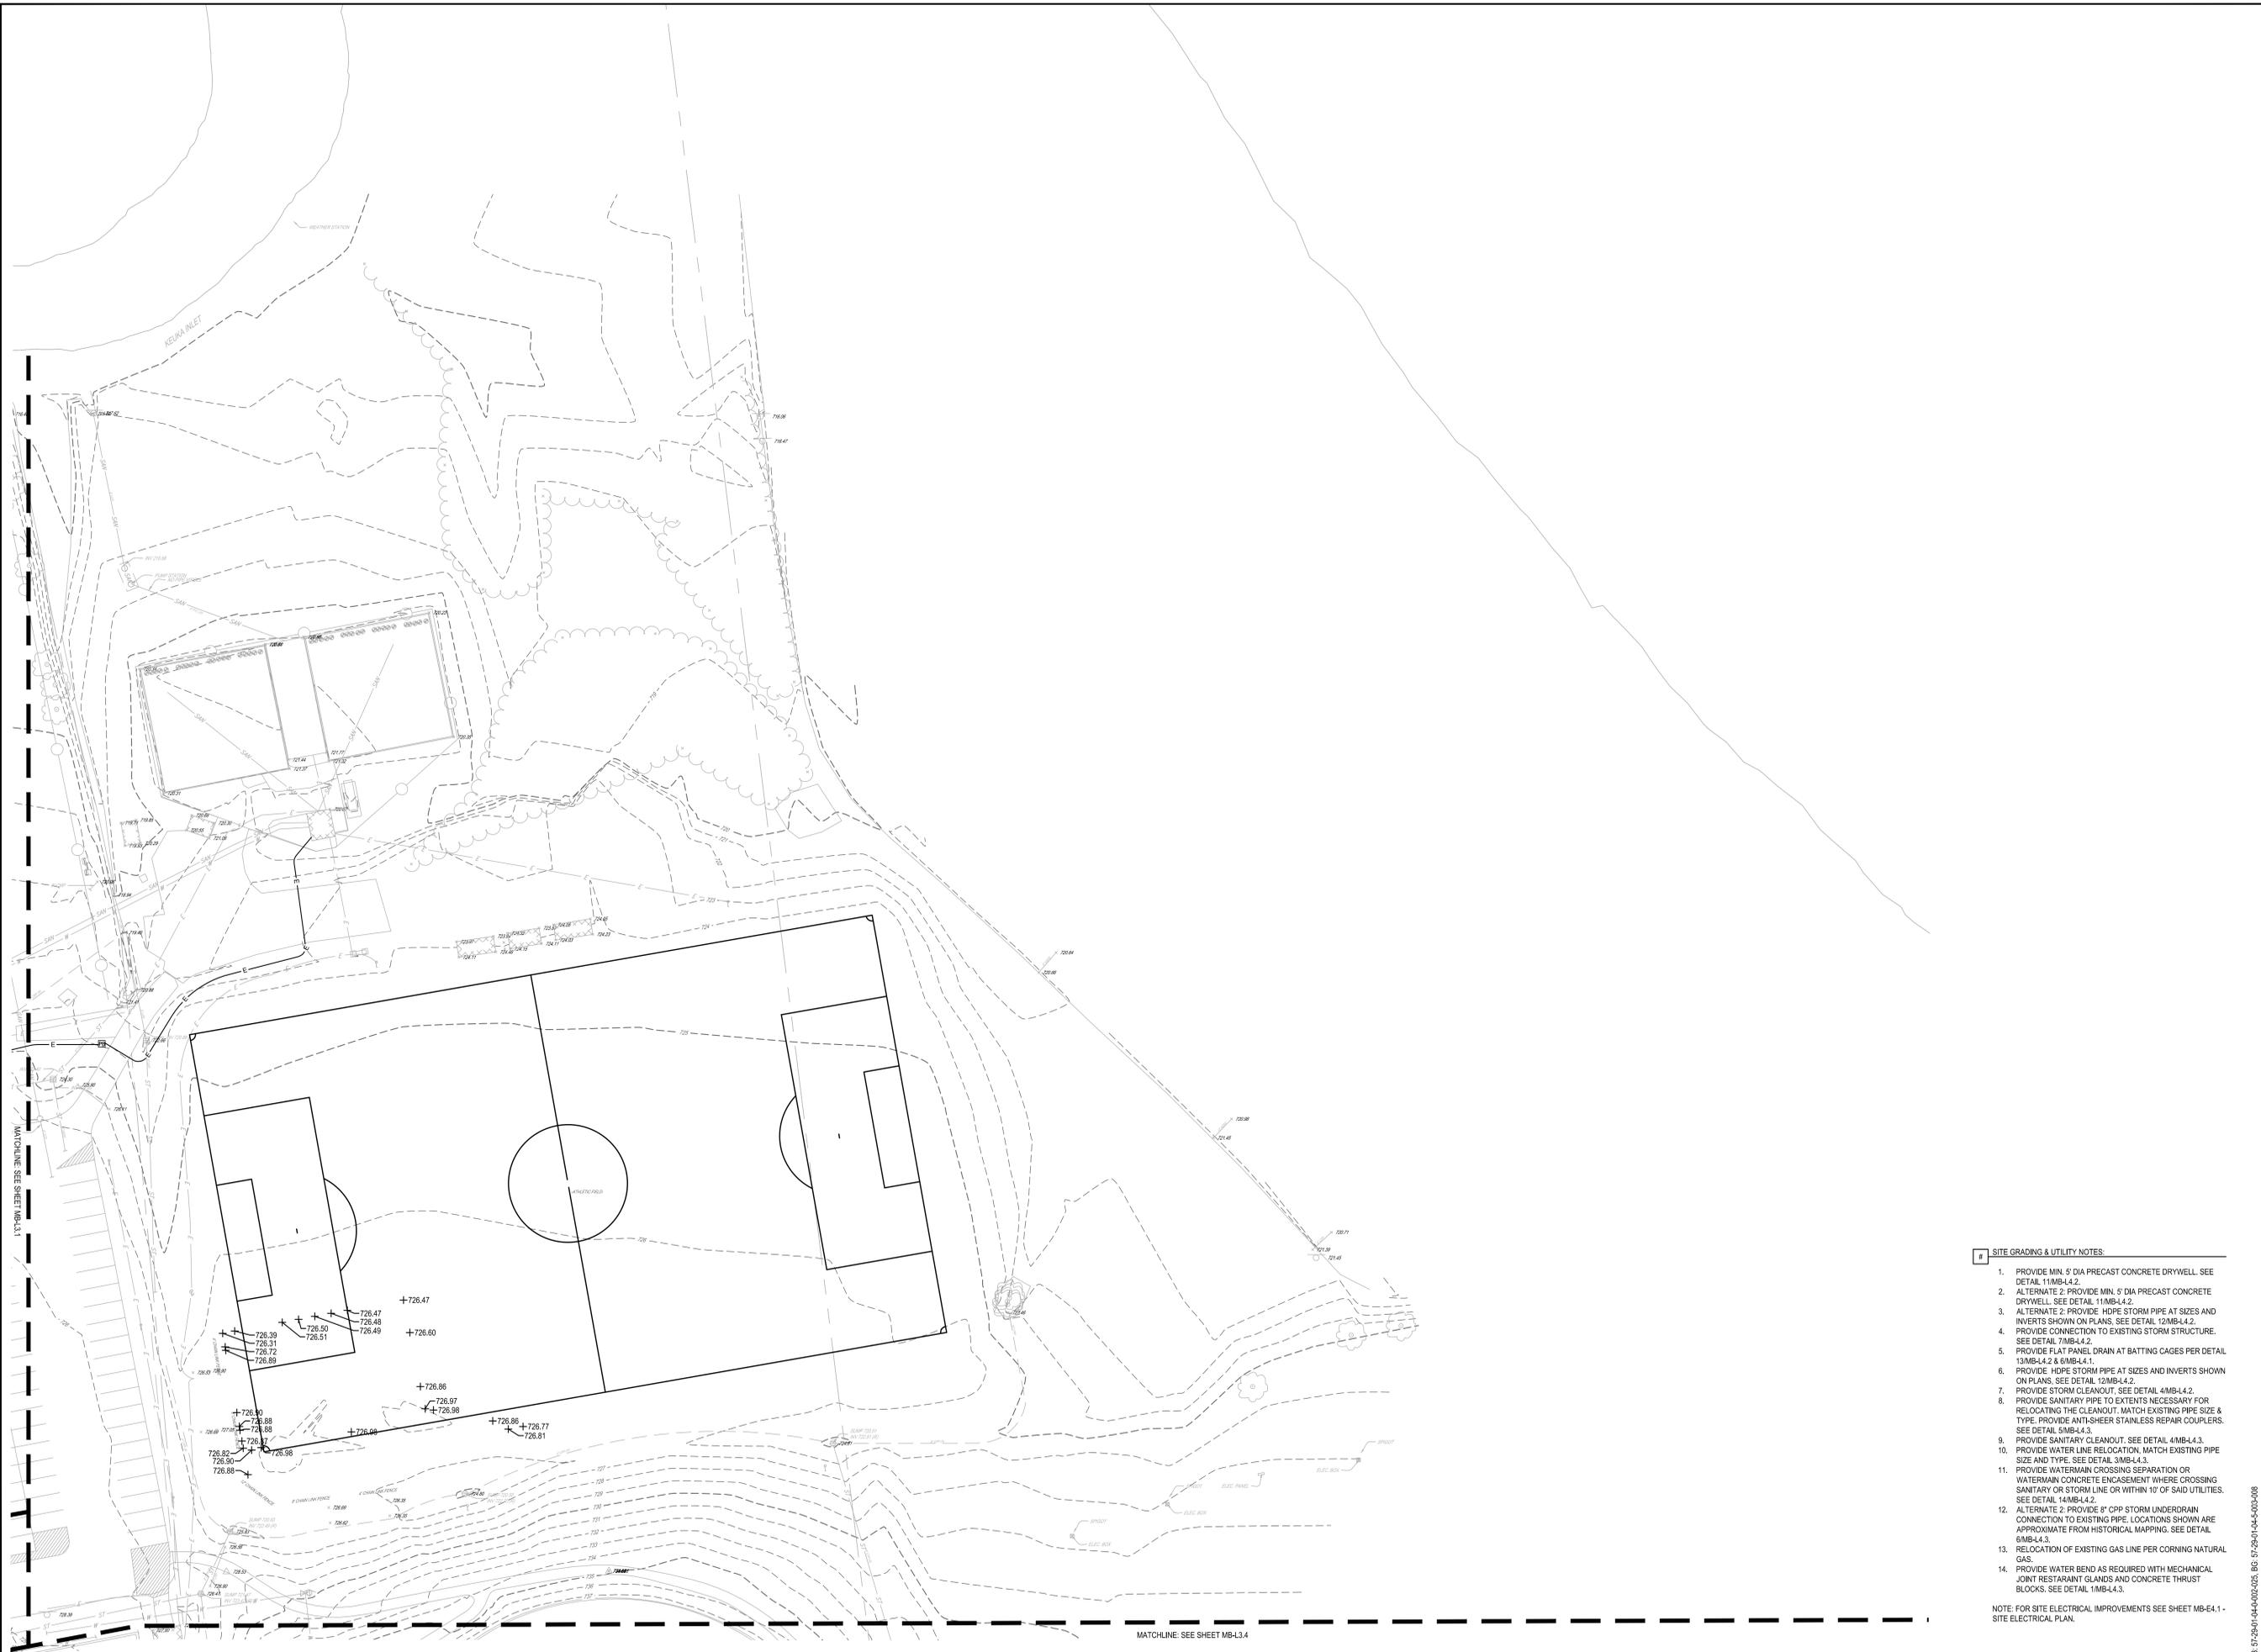

1 SITE GRADING & UTILITY PLAN  
SCALE: 1" = 30'

- SITE GRADING & UTILITY NOTES:**
1. PROVIDE MIN. 6" DIA PRECAST CONCRETE DRYWELL. SEE DETAIL 11MB-L4.2.
  2. ALTERNATE 2: PROVIDE MIN. 5" DIA PRECAST CONCRETE DRYWELL. SEE DETAIL 11MB-L4.2.
  3. ALTERNATE 2: PROVIDE HDPE STORM PIPE AT SIZES AND INVERTS SHOWN ON PLANS. SEE DETAIL 12MB-L4.2.
  4. PROVIDE CONNECTION TO EXISTING STORM STRUCTURE. SEE DETAIL 7AMB-L4.2.
  5. PROVIDE FLAT PANEL DRAIN AT BATTING CAGES PER DETAIL 13MB-L4.2 & 6MB-L4.1.
  6. PROVIDE HDPE STORM PIPE AT SIZES AND INVERTS SHOWN ON PLANS. SEE DETAIL 12MB-L4.2.
  7. PROVIDE STORM CLEANOUT. SEE DETAIL 4MB-L4.2.
  8. PROVIDE SANITARY PIPE TO EXTENTS NECESSARY FOR RELOCATING THE CLEANOUT. MATCH EXISTING PIPE SIZE & TYPE. PROVIDE ANTI-SHEER STAINLESS REPAIR COUPLERS. SEE DETAIL 5MB-L4.3.
  9. PROVIDE SANITARY CLEANOUT. SEE DETAIL 4MB-L4.3.
  10. PROVIDE WATER LINE RELOCATION. MATCH EXISTING PIPE SIZE AND TYPE. SEE DETAIL 3MB-L4.3.
  11. PROVIDE WATERMAIN CROSSING SEPARATION OR WATERMAIN CONCRETE ENCASUREMENT WHERE CROSSING SANITARY OR STORM LINE OR WITHIN 10' OF SAID UTILITIES. SEE DETAIL 14MB-L4.2.
  12. ALTERNATE 2: PROVIDE 8" CPP STORM UNDERDRAIN CONNECTION TO EXISTING PIPE. LOCATIONS SHOWN ARE APPROXIMATE FROM HISTORICAL MAPPING. SEE DETAIL 6MB-L4.3.
  13. RELOCATION OF EXISTING GAS LINE PER CORNING NATURAL GAS.
  14. PROVIDE WATER BEND AS REQUIRED WITH MECHANICAL JOINT RESTRAINT GLANDS AND CONCRETE THRUST BLOCKS. SEE DETAIL 1MB-L4.3.
- NOTE: FOR SITE ELECTRICAL IMPROVEMENTS SEE SHEET MB-E4-1 SITE ELECTRICAL PLAN.

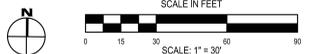


DATE	DESCRIPTION OF REVISION	ISSUED FOR	BY
10/27/2025			EB
10/27/2025			SM
10/27/2025			CD
10/27/2025			CD

**HUNT ENGINEERS | ARCHITECTS | SURVEYORS**  
 HORSEHEADS, NY 607-888-8888 ROCHESTER, NY 661-597-7868 TOWANDA, PA 570-265-4888  
 BINGHAMTON, NY 607-738-5881 ALBANY, NY 607-738-8881  
 WWW.HUNTEAS.COM  
 NY CERTIFICATE NO. 0016220 PA CERTIFICATE NO. TSC220313464-1

**SITE GRADING AND UTILITY PLAN**  
**2025 CAPITAL IMPROVEMENTS PROJECT**  
**HAMMONDSPORT CENTRAL SCHOOL DISTRICT**  
 8272 MAIN STREET, HAMMONDSPORT, NEW YORK, 14840

**MB-L3.2**  
 PROJECT NO. 1925.014

SED NUMBERS MB-57-26-01-04-00-02-05, BG-57-26-01-04-5-005-008

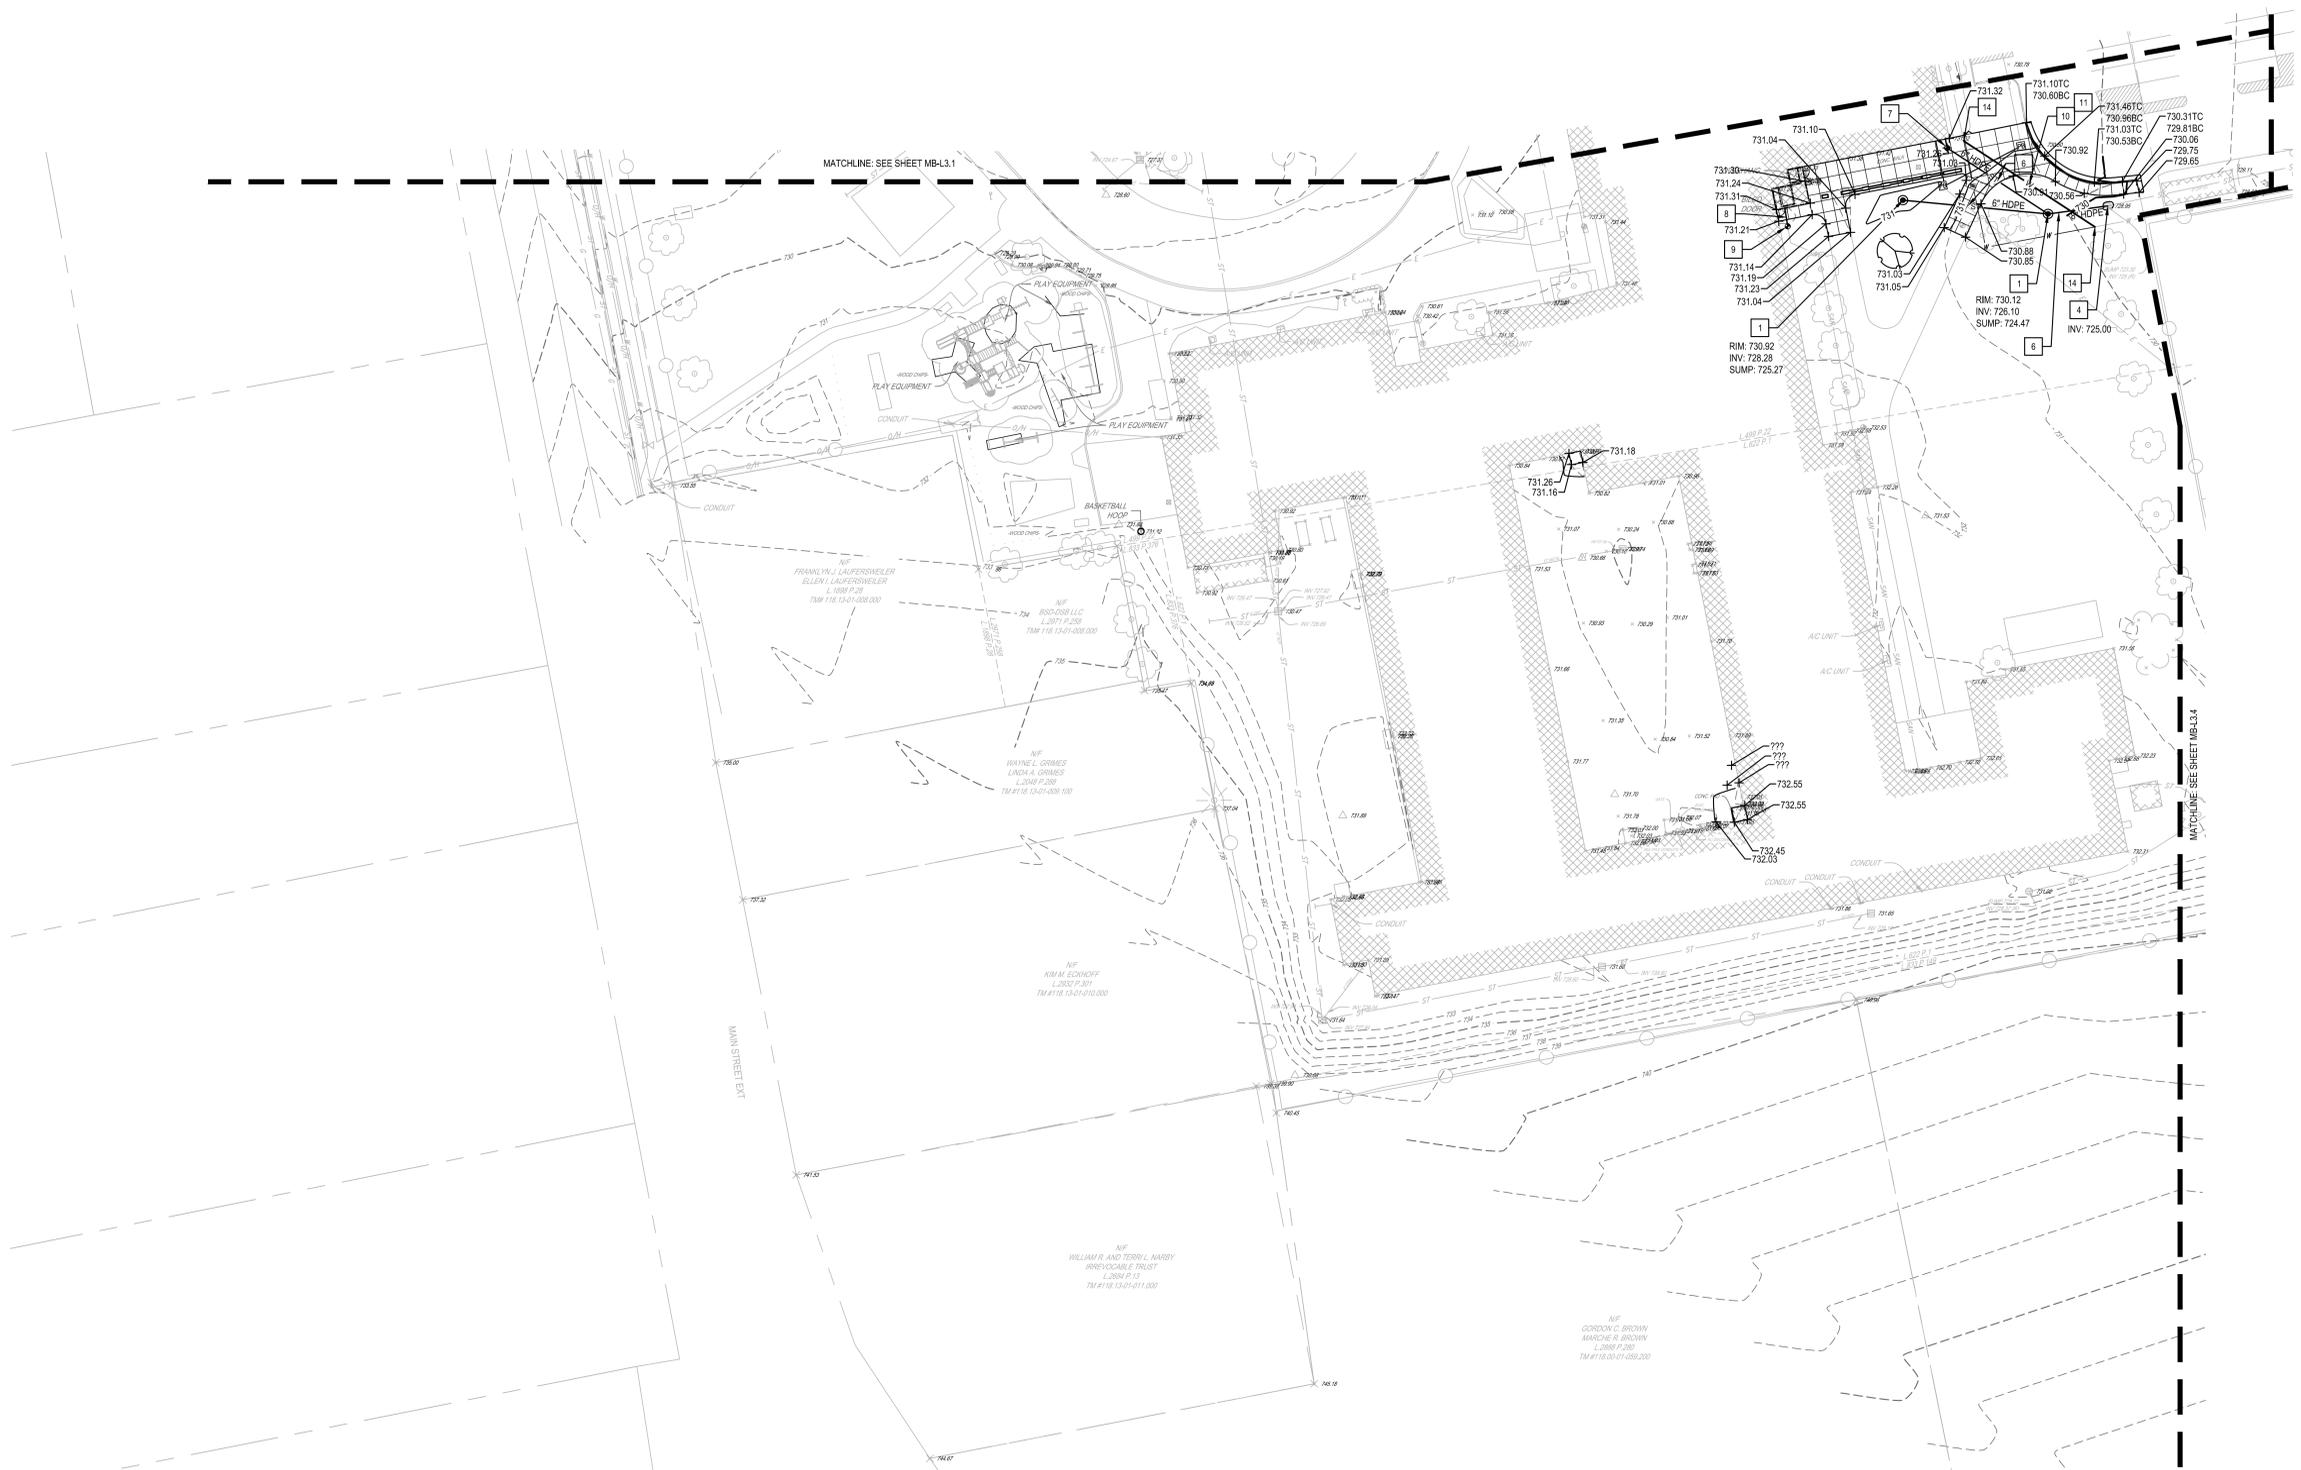

1 SITE GRADING & UTILITY PLAN  
SCALE: 1" = 30'

- 1 SITE GRADING & UTILITY NOTES:**
1. PROVIDE MIN. 5' DIA PRECAST CONCRETE DRYWELL. SEE DETAIL 11MB-L4.2.
  2. ALTERNATE 2: PROVIDE MIN. 5' DIA PRECAST CONCRETE DRYWELL. SEE DETAIL 11MB-L4.2.
  3. ALTERNATE 2: PROVIDE HDPE STORM PIPE AT SIZES AND INVERTS SHOWN ON PLANS. SEE DETAIL 12MB-L4.2.
  4. PROVIDE CONNECTION TO EXISTING STORM STRUCTURE. SEE DETAIL 7MB-L4.2.
  5. PROVIDE FLAT PANEL DRAIN AT BATTING CAGES PER DETAIL 13MB-L4.2 & 6MB-L4.1.
  6. PROVIDE HDPE STORM PIPE AT SIZES AND INVERTS SHOWN ON PLANS. SEE DETAIL 12MB-L4.2.
  7. PROVIDE STORM CLEANOUT. SEE DETAIL 4MB-L4.2.
  8. PROVIDE SANITARY PIPE TO EXTENTS NECESSARY FOR RELOCATING THE CLEANOUT. MATCH EXISTING PIPE SIZE & TYPE. PROVIDE ANTI-SHEER STAINLESS REPAIR COUPLERS. SEE DETAIL 5MB-L4.3.
  9. PROVIDE SANITARY CLEANOUT. SEE DETAIL 4MB-L4.3.
  10. PROVIDE WATER LINE RELOCATION. MATCH EXISTING PIPE SIZE AND TYPE. SEE DETAIL 3MB-L4.3.
  11. PROVIDE WATERMAIN CROSSING SEPARATION OR WATERMAIN CONCRETE ENCASUREMENT WHERE CROSSING SANITARY OR STORM LINE OR WITHIN 10' OF SAID UTILITIES. SEE DETAIL 14MB-L4.2.
  12. ALTERNATE 2: PROVIDE 8" CPP STORM UNDERDRAIN CONNECTION TO EXISTING PIPE. LOCATIONS SHOWN ARE APPROXIMATE FROM HISTORICAL MAPPING. SEE DETAIL 6MB-L4.3.
  13. RELOCATION OF EXISTING GAS LINE PER CORNING NATURAL GAS.
  14. PROVIDE WATER BEND AS REQUIRED WITH MECHANICAL JOINT RESTRAINT GLANDS AND CONCRETE THRUST BLOCKS. SEE DETAIL 1MB-L4.3.
- NOTE: FOR SITE ELECTRICAL IMPROVEMENTS SEE SHEET MB-E4.1 - SITE ELECTRICAL PLAN.



DRAWN BY: EB	
CHECKED BY: SM	
DATE: 10/27/2025	CD
PHASE: CD	
DESCRIPTION OF REVISION: ISSUED FOR BID	
#	DATE
1	10/11/2025


ISSUED FOR BID

IT IS A VIOLATION OF THE LAW FOR ANY PERSON TO MAKE UNAUTHORIZED ALTERATIONS OR ADDITIONS TO PLANS DRAWN BY A LICENSED ENGINEER, ARCHITECT OR SURVEYOR.  
Copyright 2025

**HUNT ENGINEERS | ARCHITECTS | SURVEYORS**  
 HORSEHEADS, NY 607-365-8800 ROCHESTER, NY 661-597-7960 TOWANDA, PA 570-265-4688  
 BINGHAMTON, NY 607-738-1881 ALBANY, NY 607-738-8881  
 WWW.HUNTEAS.COM  
 NY CERTIFICATE NO. 0016220 PA CERTIFICATE NO. TSC220313464-1

**SITE GRADING AND UTILITY PLAN**  
**2025 CAPITAL IMPROVEMENTS PROJECT**  
**HAMMONDSPORT CENTRAL SCHOOL DISTRICT**  
 8272 MAIN STREET, HAMMONDSPORT, NEW YORK, 14840

**MB-L3.3**  
 PROJECT NO. 1925.014

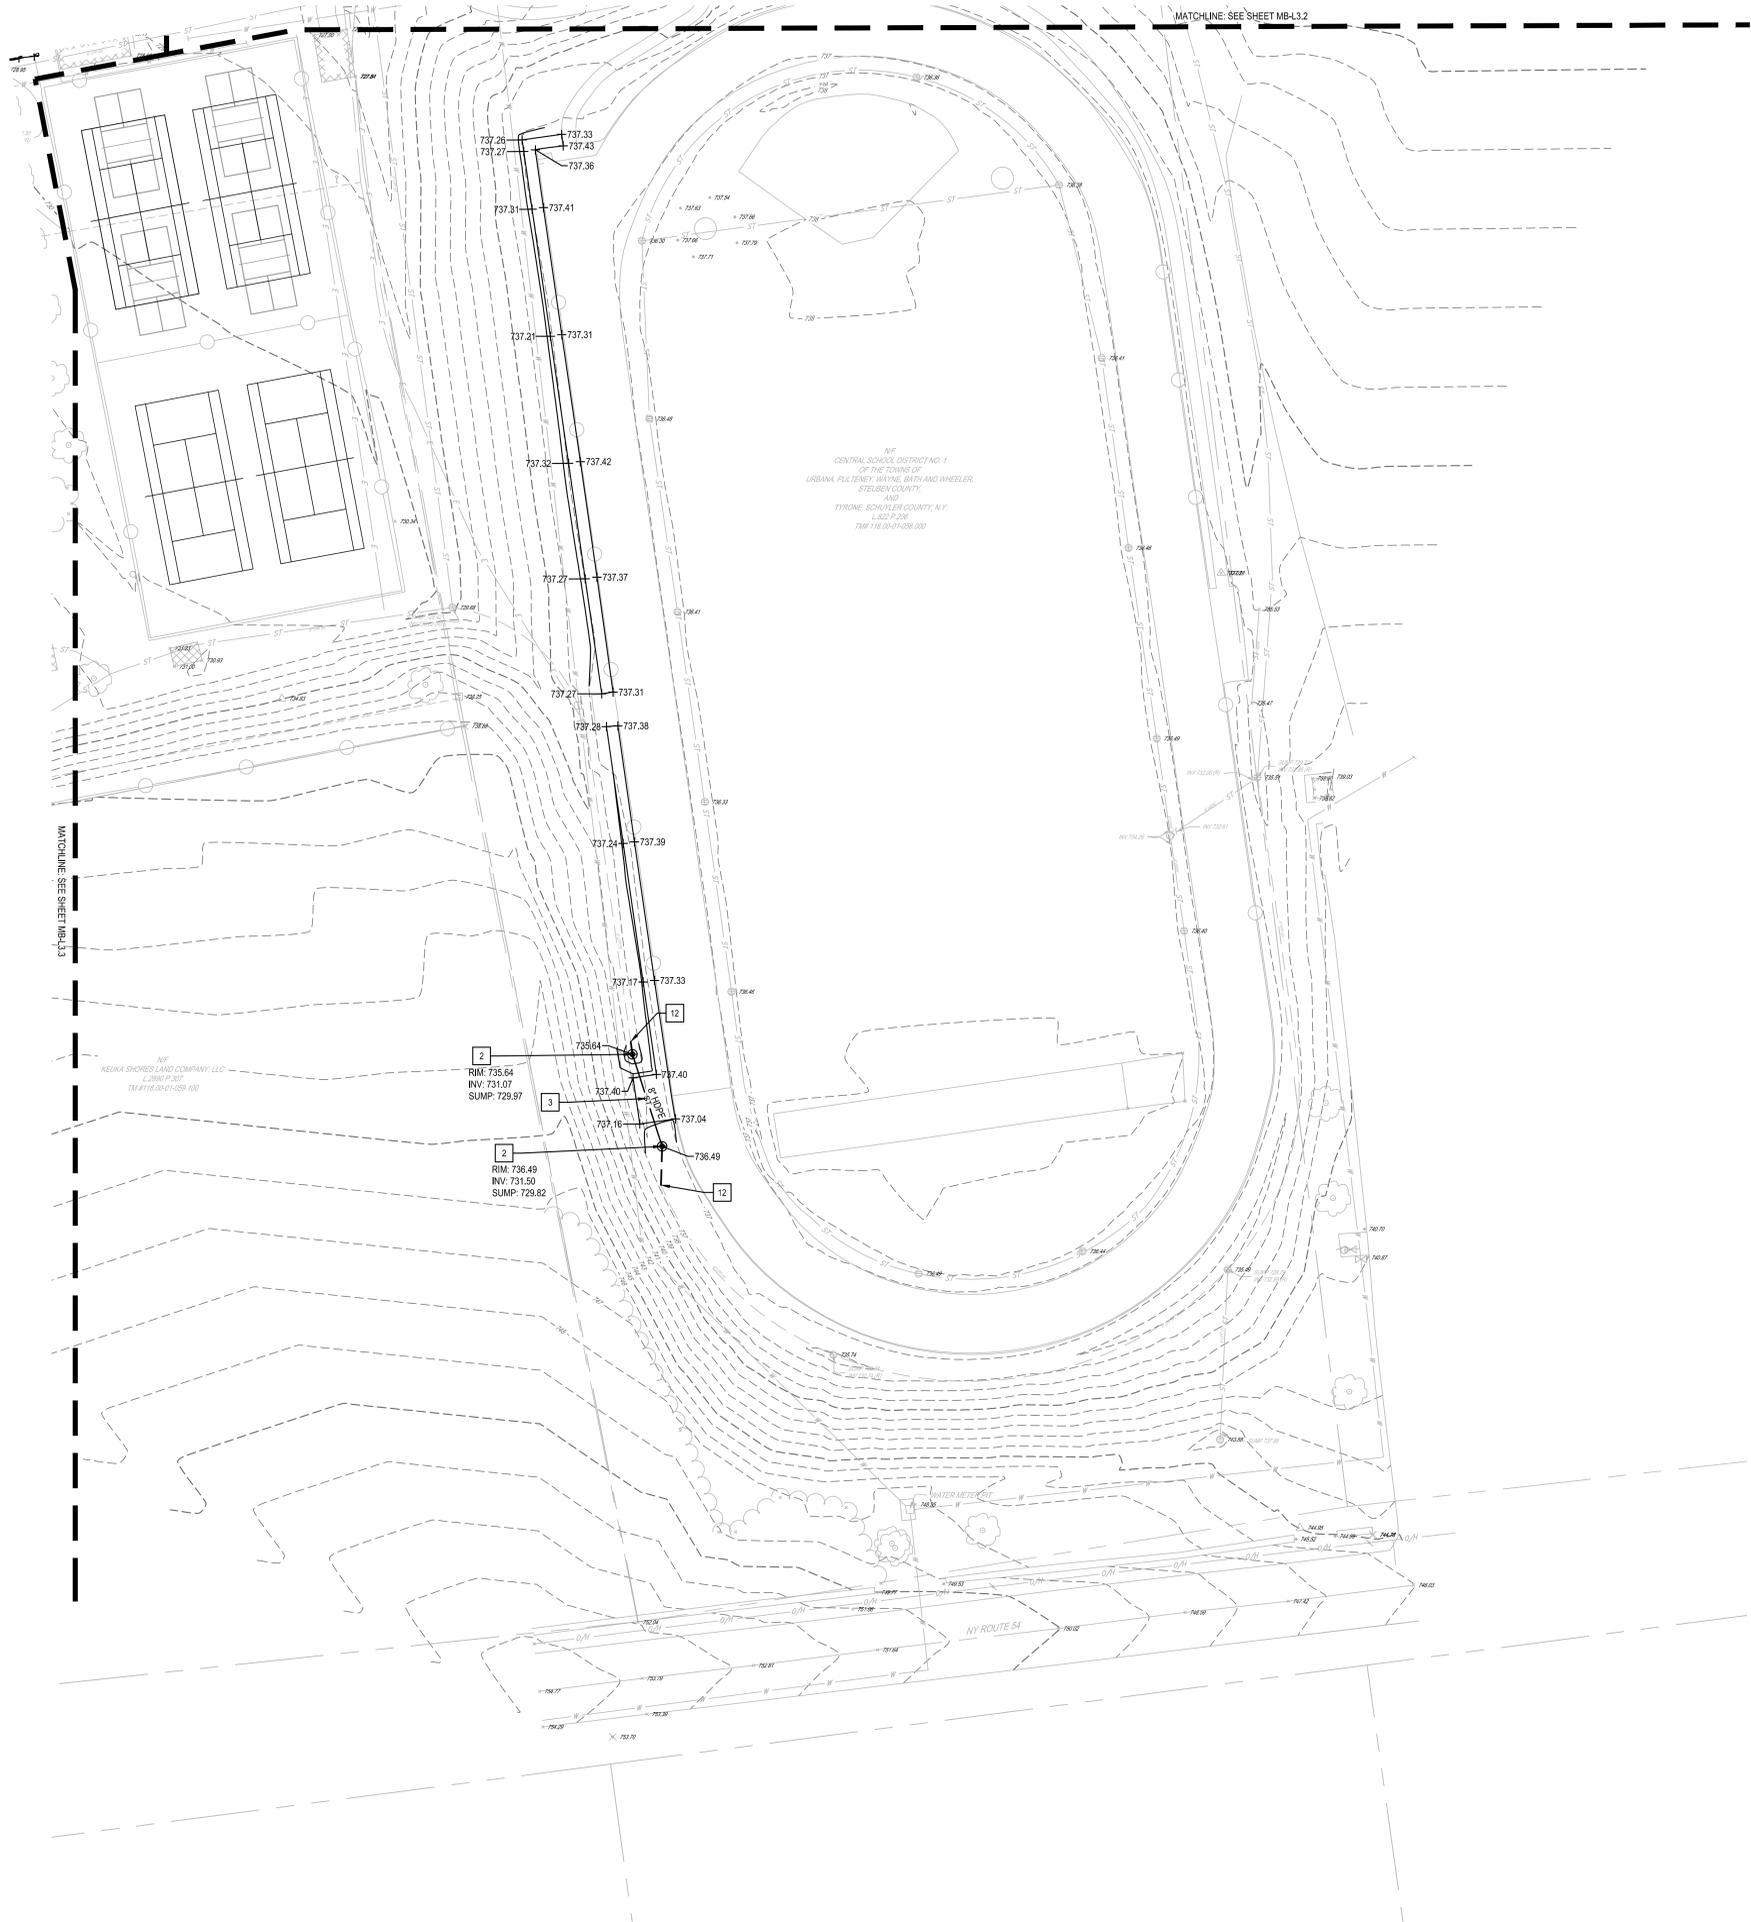

NY  
 CENTRAL SCHOOL DISTRICT NO. 1  
 OF THE TOWNS OF  
 URBANA, PULTENEY, WAINE, BATH AND WAEGLER,  
 STEUBEN COUNTY,  
 AND  
 TYRONE, SCHUYLER COUNTY, N.Y.  
 L.S.D. PLAN  
 T.M.F. 118.041-088.000


NY  
 KEUKA SHORES LAND COMPANY, LLC  
 L.S.D. PLAN  
 T.M.F. 118.041-088.100

2  
 T.M.F. 735.64  
 INV. 731.07  
 SUMP: 729.97

2  
 R.M. 736.49  
 INV. 731.50  
 SUMP: 729.82

- 1 SITE GRADING & UTILITY NOTES:**
1. PROVIDE MIN. 5' DIA PRECAST CONCRETE DRYWELL. SEE DETAIL 11MB-L4.2.
  2. ALTERNATE 2: PROVIDE MIN. 5' DIA PRECAST CONCRETE DRYWELL. SEE DETAIL 11MB-L4.2.
  3. ALTERNATE 2: PROVIDE HDPE STORM PIPE AT SIZES AND INVERTS SHOWN ON PLANS. SEE DETAIL 12MB-L4.2.
  4. PROVIDE CONNECTION TO EXISTING STORM STRUCTURE. SEE DETAIL 7MB-L4.2.
  5. PROVIDE FLAT PANEL DRAIN AT BATTING CAGES PER DETAIL 13MB-L4.2 & 6MB-L4.1.
  6. PROVIDE HDPE STORM PIPE AT SIZES AND INVERTS SHOWN ON PLANS. SEE DETAIL 12MB-L4.2.
  7. PROVIDE STORM CLEANOUT. SEE DETAIL 4MB-L4.2.
  8. PROVIDE SANITARY PIPE TO EXTENTS NECESSARY FOR RELOCATING THE CLEANOUT. MATCH EXISTING PIPE SIZE & TYPE. PROVIDE ANTI-SHEER STAINLESS STEEL REPAIR COUPLERS. SEE DETAIL 5MB-L4.3.
  9. PROVIDE SANITARY CLEANOUT. SEE DETAIL 4MB-L4.3.
  10. PROVIDE WATER LINE RELOCATION. MATCH EXISTING PIPE SIZE AND TYPE. SEE DETAIL 3MB-L4.3.
  11. PROVIDE WATERMAIN CROSSING SEPARATION OR WATERMAIN CONCRETE ENCASUREMENT WHERE CROSSING SANITARY OR STORM LINE OR WITHIN 10' OF SAID UTILITIES. SEE DETAIL 14MB-L4.2.
  12. ALTERNATE 2: PROVIDE 8" GPP STORM UNDERDRAIN CONNECTION TO EXISTING PIPE. LOCATIONS SHOWN ARE APPROXIMATE FROM HISTORICAL MAPPING. SEE DETAIL 6MB-L4.3.
  13. RELOCATION OF EXISTING GAS LINE PER CORNING NATURAL GAS.
  14. PROVIDE WATER BEND AS REQUIRED WITH MECHANICAL JOINT RESTRAINT GLANDS AND CONCRETE THRUST BLOCKS. SEE DETAIL 1MB-L4.3.
- NOTE: FOR SITE ELECTRICAL IMPROVEMENTS SEE SHEET MB-E4.1- SITE ELECTRICAL PLAN.

**1 ALTERNATE 2: SITE GRADING & UTILITY PLAN**  
 SCALE: 1" = 30'

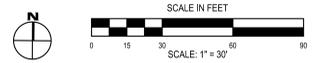

DATE	DESCRIPTION OF REVISION	ISSUED FOR BID
1 10/11/2025		

DRAWN BY:	EB
CHECKED BY:	SM
DATE:	10/27/2025
PHASE:	CD


10/27/2025  
 10/27/2025  
 10/27/2025  
 10/27/2025

**HUNT ENGINEERS | ARCHITECTS | SURVEYORS**  
 HORSEHEADS, NY 607-888-8888 ROCHESTER, NY 661-397-7860 TOWANACK, PA 570-265-4888  
 BINGHAMTON, NY 607-738-5881 ALBANY, NY 607-738-8881  
 WWW.HUNTEAS.COM  
 NY CERTIFICATE NO. 0016220 PA CERTIFICATE NO. 15C220313464-1

**SITE GRADING AND UTILITY PLAN**  
**2025 CAPITAL IMPROVEMENTS PROJECT**  
**HAMMONDSPORT CENTRAL SCHOOL DISTRICT**  
 8272 MAIN STREET, HAMMONDSPORT, NEW YORK, 14840


**MB-L3.4**  
 PROJECT NO: 1925.014

SED NUMBERS MB-57-29-01-04-00-025, BG-57-29-01-04-5-005-008

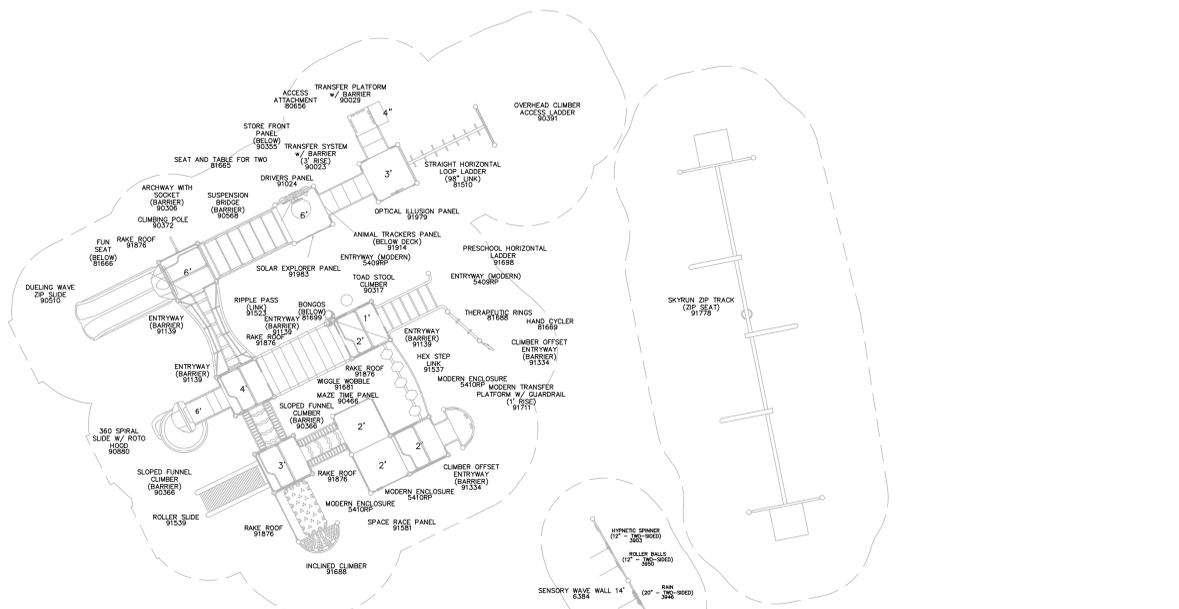


NOTE:  
BASIS OF DESIGN IS POWERSCAPE  
MODULAR PLAY STRUCTURES.  
FREE-STANDING PLAY EQUIPMENT AND  
ACCESSORIES AS MANUFACTURED BY  
GAMETIME, A PLAYCORE COMPANY.  
SEE SPECIFICATION FOR ADDITIONAL  
INFORMATION ON EQUIPMENT AND  
INSTALLATION.

9 PLAYGROUND EQUIPMENT LAYOUT  
SCALE: 1/4" = 1'-0"


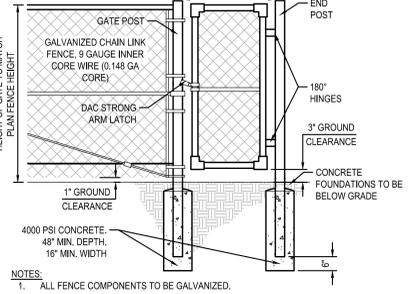


8 CHAINLINK FENCE GATE  
SCALE: N.T.S.


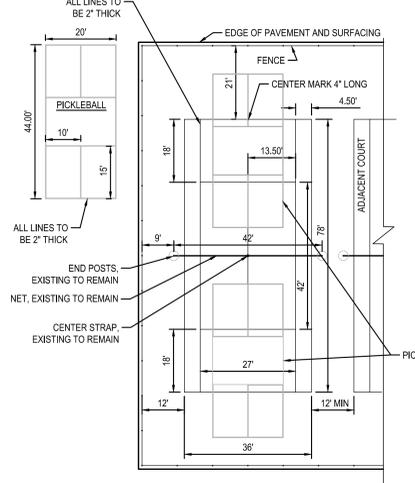


7 TENNIS & PICKLEBALL LAYOUT DETAIL  
SCALE: 1" = 30'


11 BATTING CAGE ELECTRICAL BOX  
SCALE: 1/4" = 1'-0"

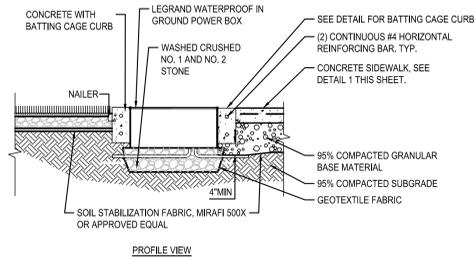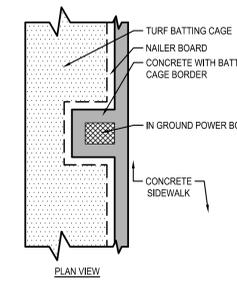


10 DUGOUT FOUNDATION  
SCALE: 1/4" = 1'-0"

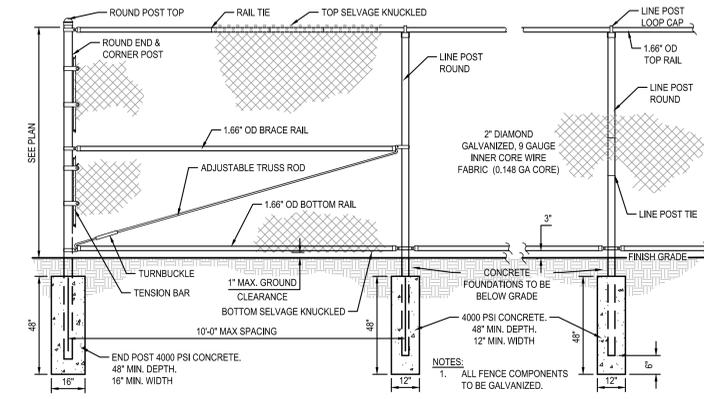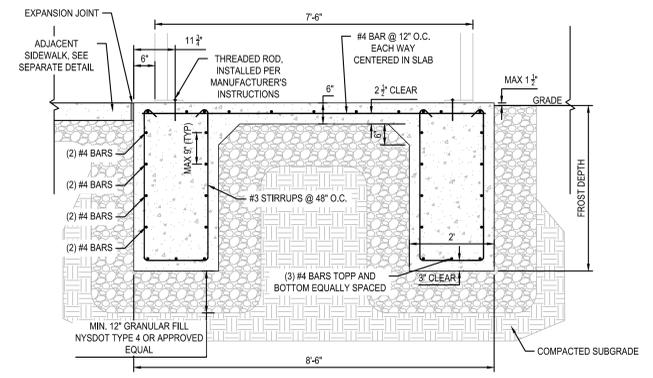

3 CHAIN LINK FENCE WITH BOTTOM RAIL DETAIL  
SCALE: N.T.S.

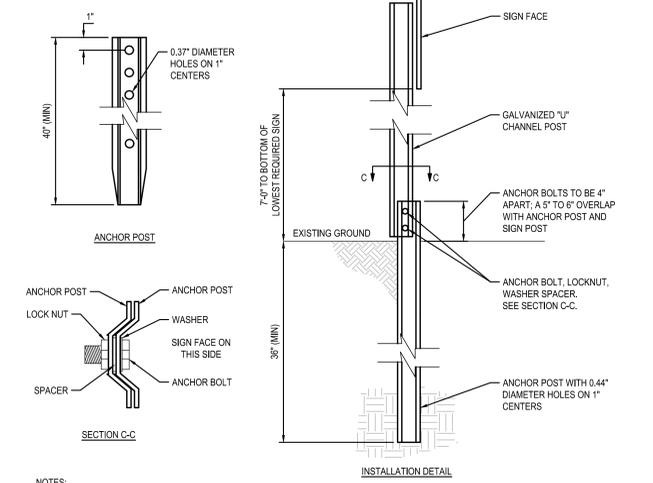

2 ACCESSIBLE PARKING SIGNAGE AND LAYOUT  
SCALE: N.T.S.

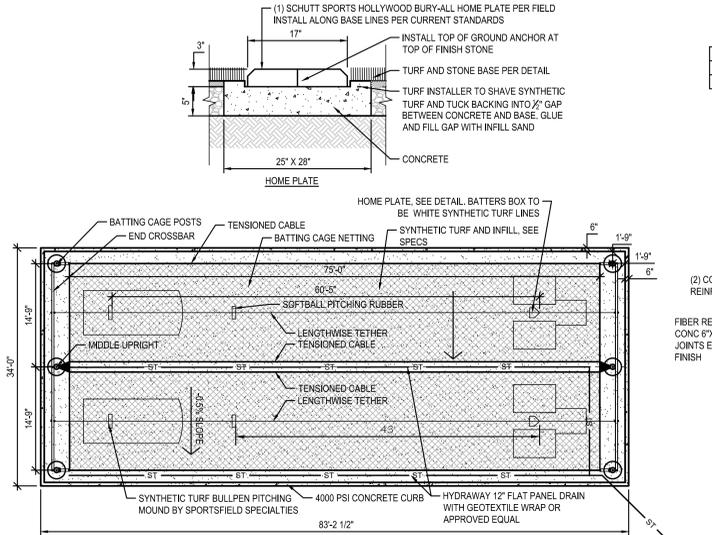


6 BASEBALL BATTING TUNNEL PLAN  
SCALE: 1/4" = 1'-0"




5 NATURAL TURF SOCCER FIELD LAYOUT  
SCALE: N.T.S.


TYPE	MODEL	NET LENGTH	POLE TO POLE
DOUBLE TUNNEL	BTBD	75'-0"	78'-8 5/8"

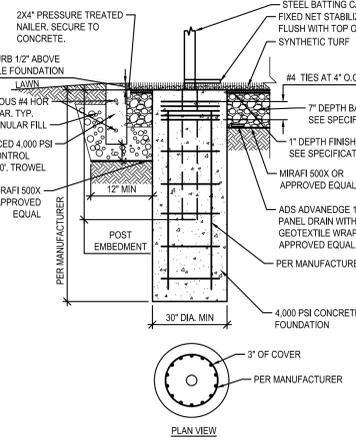

4 TENNIS ASPHALT SURFACE DETAIL  
SCALE: N.T.S.

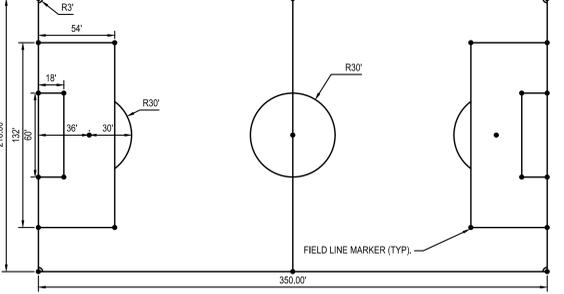

1 CONCRETE SIDEWALK DETAIL  
SCALE: N.T.S.

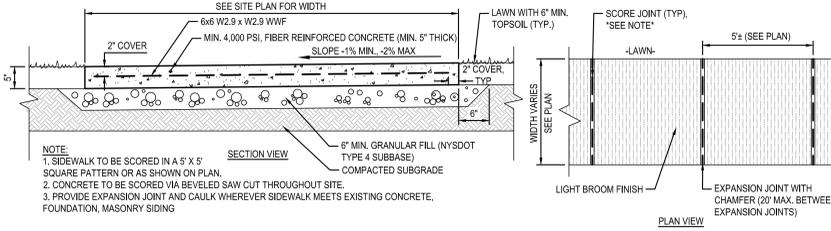


1 CONCRETE SIDEWALK DETAIL  
SCALE: N.T.S.

DRAWN BY: EB  
CHECKED BY: SM  
DATE: 10/27/2023  
PHASE: CD  
ISSUED FOR BID  
DESCRIPTION OF REVISION:  
1 12/11/2023


**HUNT** ENGINEERS ARCHITECTS | SURVEYORS  
HORSEHEADS, NY 607-869-8000 ROCHESTER, NY 661-597-7860 FOWAN, PA 570-265-4888  
BINGHAMTON, NY 607-798-1881 ALBANY, NY 607-798-8881  
WWW.HUNTEAS.COM  
NY CERTIFICATE NO. 0016220 PA CERTIFICATE NO. TSC202313464-1

**2025 CAPITAL IMPROVEMENTS PROJECT**  
**HAMMONDSPORT CENTRAL SCHOOL DISTRICT**  
8272 MAIN STREET, HAMMONDSPORT, NEW YORK, 14840  
**MB-L4.1**  
PROJECT NO: 1925.014




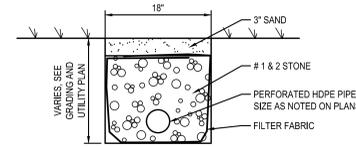


6 UNDERDRAIN DETAIL  
 SCALE: N.T.S.

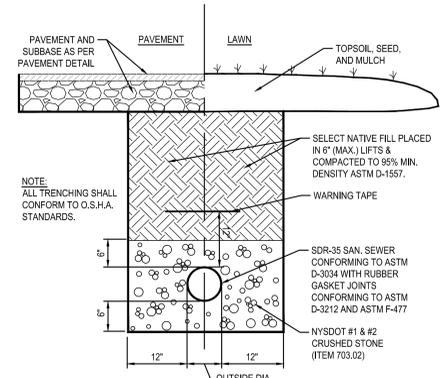


5 TYPICAL SANITARY SEWER TRENCH DETAIL  
 SCALE: N.T.S.

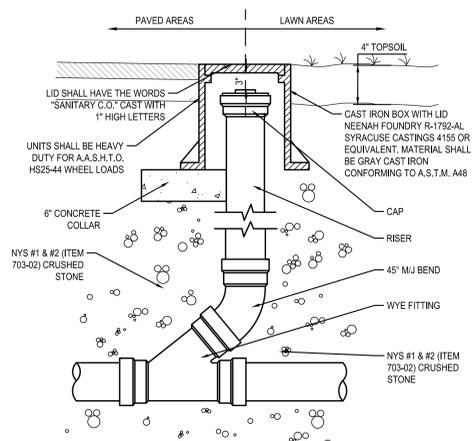


4 SANITARY CLEANOUT DETAIL  
 SCALE: N.T.S.

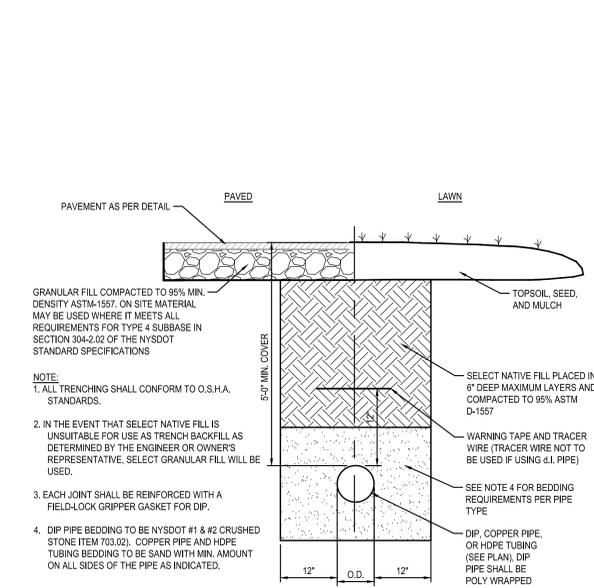

3 WATERMAIN TRENCH SECTION  
 SCALE: N.T.S.

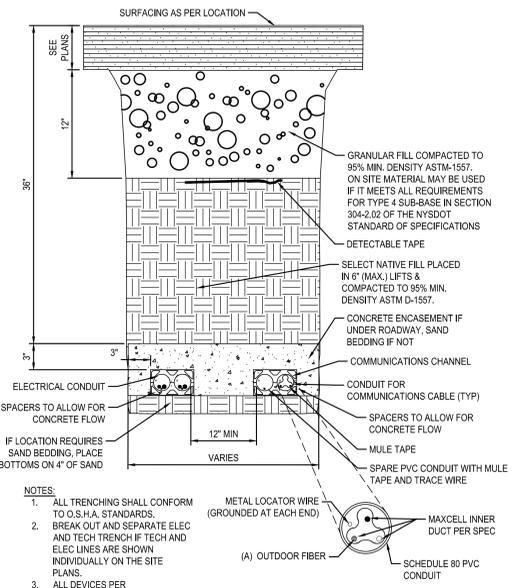

2 TYPICAL ELECTRICAL AND TECHNOLOGY COMBINED TRENCH DETAIL  
 SCALE: 1" = 10'

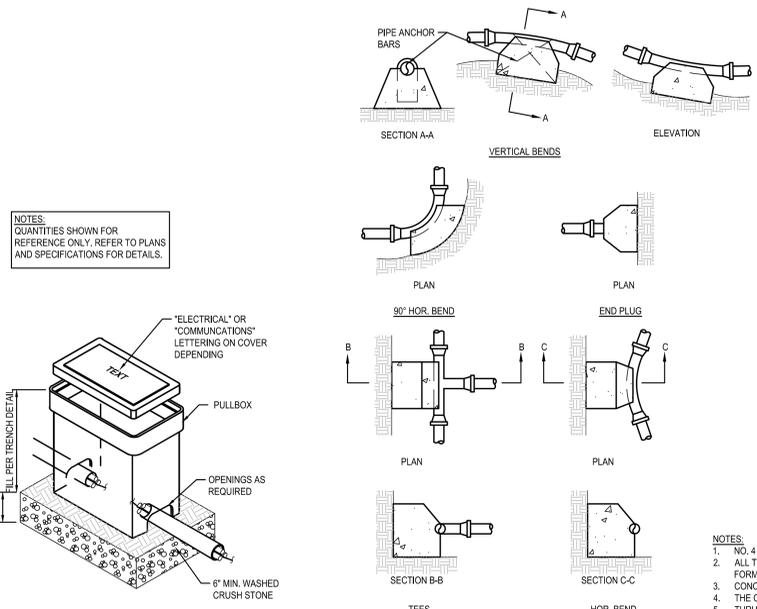

1 THRUST BLOCK DETAILS  
 SCALE: N.T.S.


PIPE DIA. (INCHES)	VERTICAL THRUST BLOCK VOLUME 100 P.S.I.G. INTERNAL PRESSURE					4" PIPE DEFLECTION TO 11 1/4" BEND
	90° BEND	60° BEND	45° BEND	22 1/2° BEND	1"	
6	1.5 C.Y.	1.2 C.Y.	0.8 C.Y.	0.4 C.Y.	-	2.0 C.Y.
8	2.6 C.Y.	2.0 C.Y.	1.4 C.Y.	0.7 C.Y.	-	4.0 C.Y.
10 & 12	6.0 C.Y.	4.2 C.Y.	3.2 C.Y.	1.6 C.Y.	-	8.0 C.Y.
14 & 16	11.2 C.Y.	7.9 C.Y.	6.1 C.Y.	3.1 C.Y.	-	1.6 C.Y.

SOIL	SAFE BEARING LOAD P.S.F.	FACTOR
MUCK PEAT	0	-
SOFT CLAY	300	4.00
SAND	1000	2.00
SAND & GRAVEL	1500	1.33
SAND & GRAVEL CEMENTED W/CLAY	2000	1.00
SHALE	5000	0.40

MINIMUM THRUST BLOCK AREAS REQUIRED AT PIPE BENDS AND PLUGS UNDER VARIOUS INTERNAL PRESSURE IN GRANULAR SOIL WITH A BEARING LOAD OF 2000 P.S.F.

PIPE DIA. (INCHES)	HORIZ. THRUST BLOCK AREA - S.F. 100 P.S.I.G. INTERNAL PRESSURE						
	PLUG OR TEE	90° BEND	60° BEND	45° BEND	22 1/2° BEND	11 1/4" BEND	1"
4	1	1	1	1	-	-	-
6	2	2	2	1	-	-	-
8	3	3	3	2	1	1	-
10	4.5	6	4	3	2.5	2	1
12	6	8	6	4	3	2	1
14 & 16	10	14	10	8	5	4	2

- NOTES:
- NO. 4 REBAR FOR ANCHORS TO CONCRETE SHALL BE USED.
  - ALL THRUST BLOCKS SHALL BE POURED AGAINST UNDISTURBED EARTH. ALL THRUST BLOCKS TO BE FORMED TO AVOID CONCRETE CONTACT WITH BOLT HEADS OR NUTS.
  - CONCRETE MIN. COMPRESSIVE STRENGTH SHALL BE 4000 PSI AT 28 DAYS.
  - THE CONTRACTOR SHOULD ALWAYS CONSIDER TEST PRESSURES WHEN CALCULATING BEARING AREA.
  - THRUST BLOCKS SHALL BE POURED AT ALL BENDS AND TAPPING SLEEVE AND VALVE CONNECTIONS

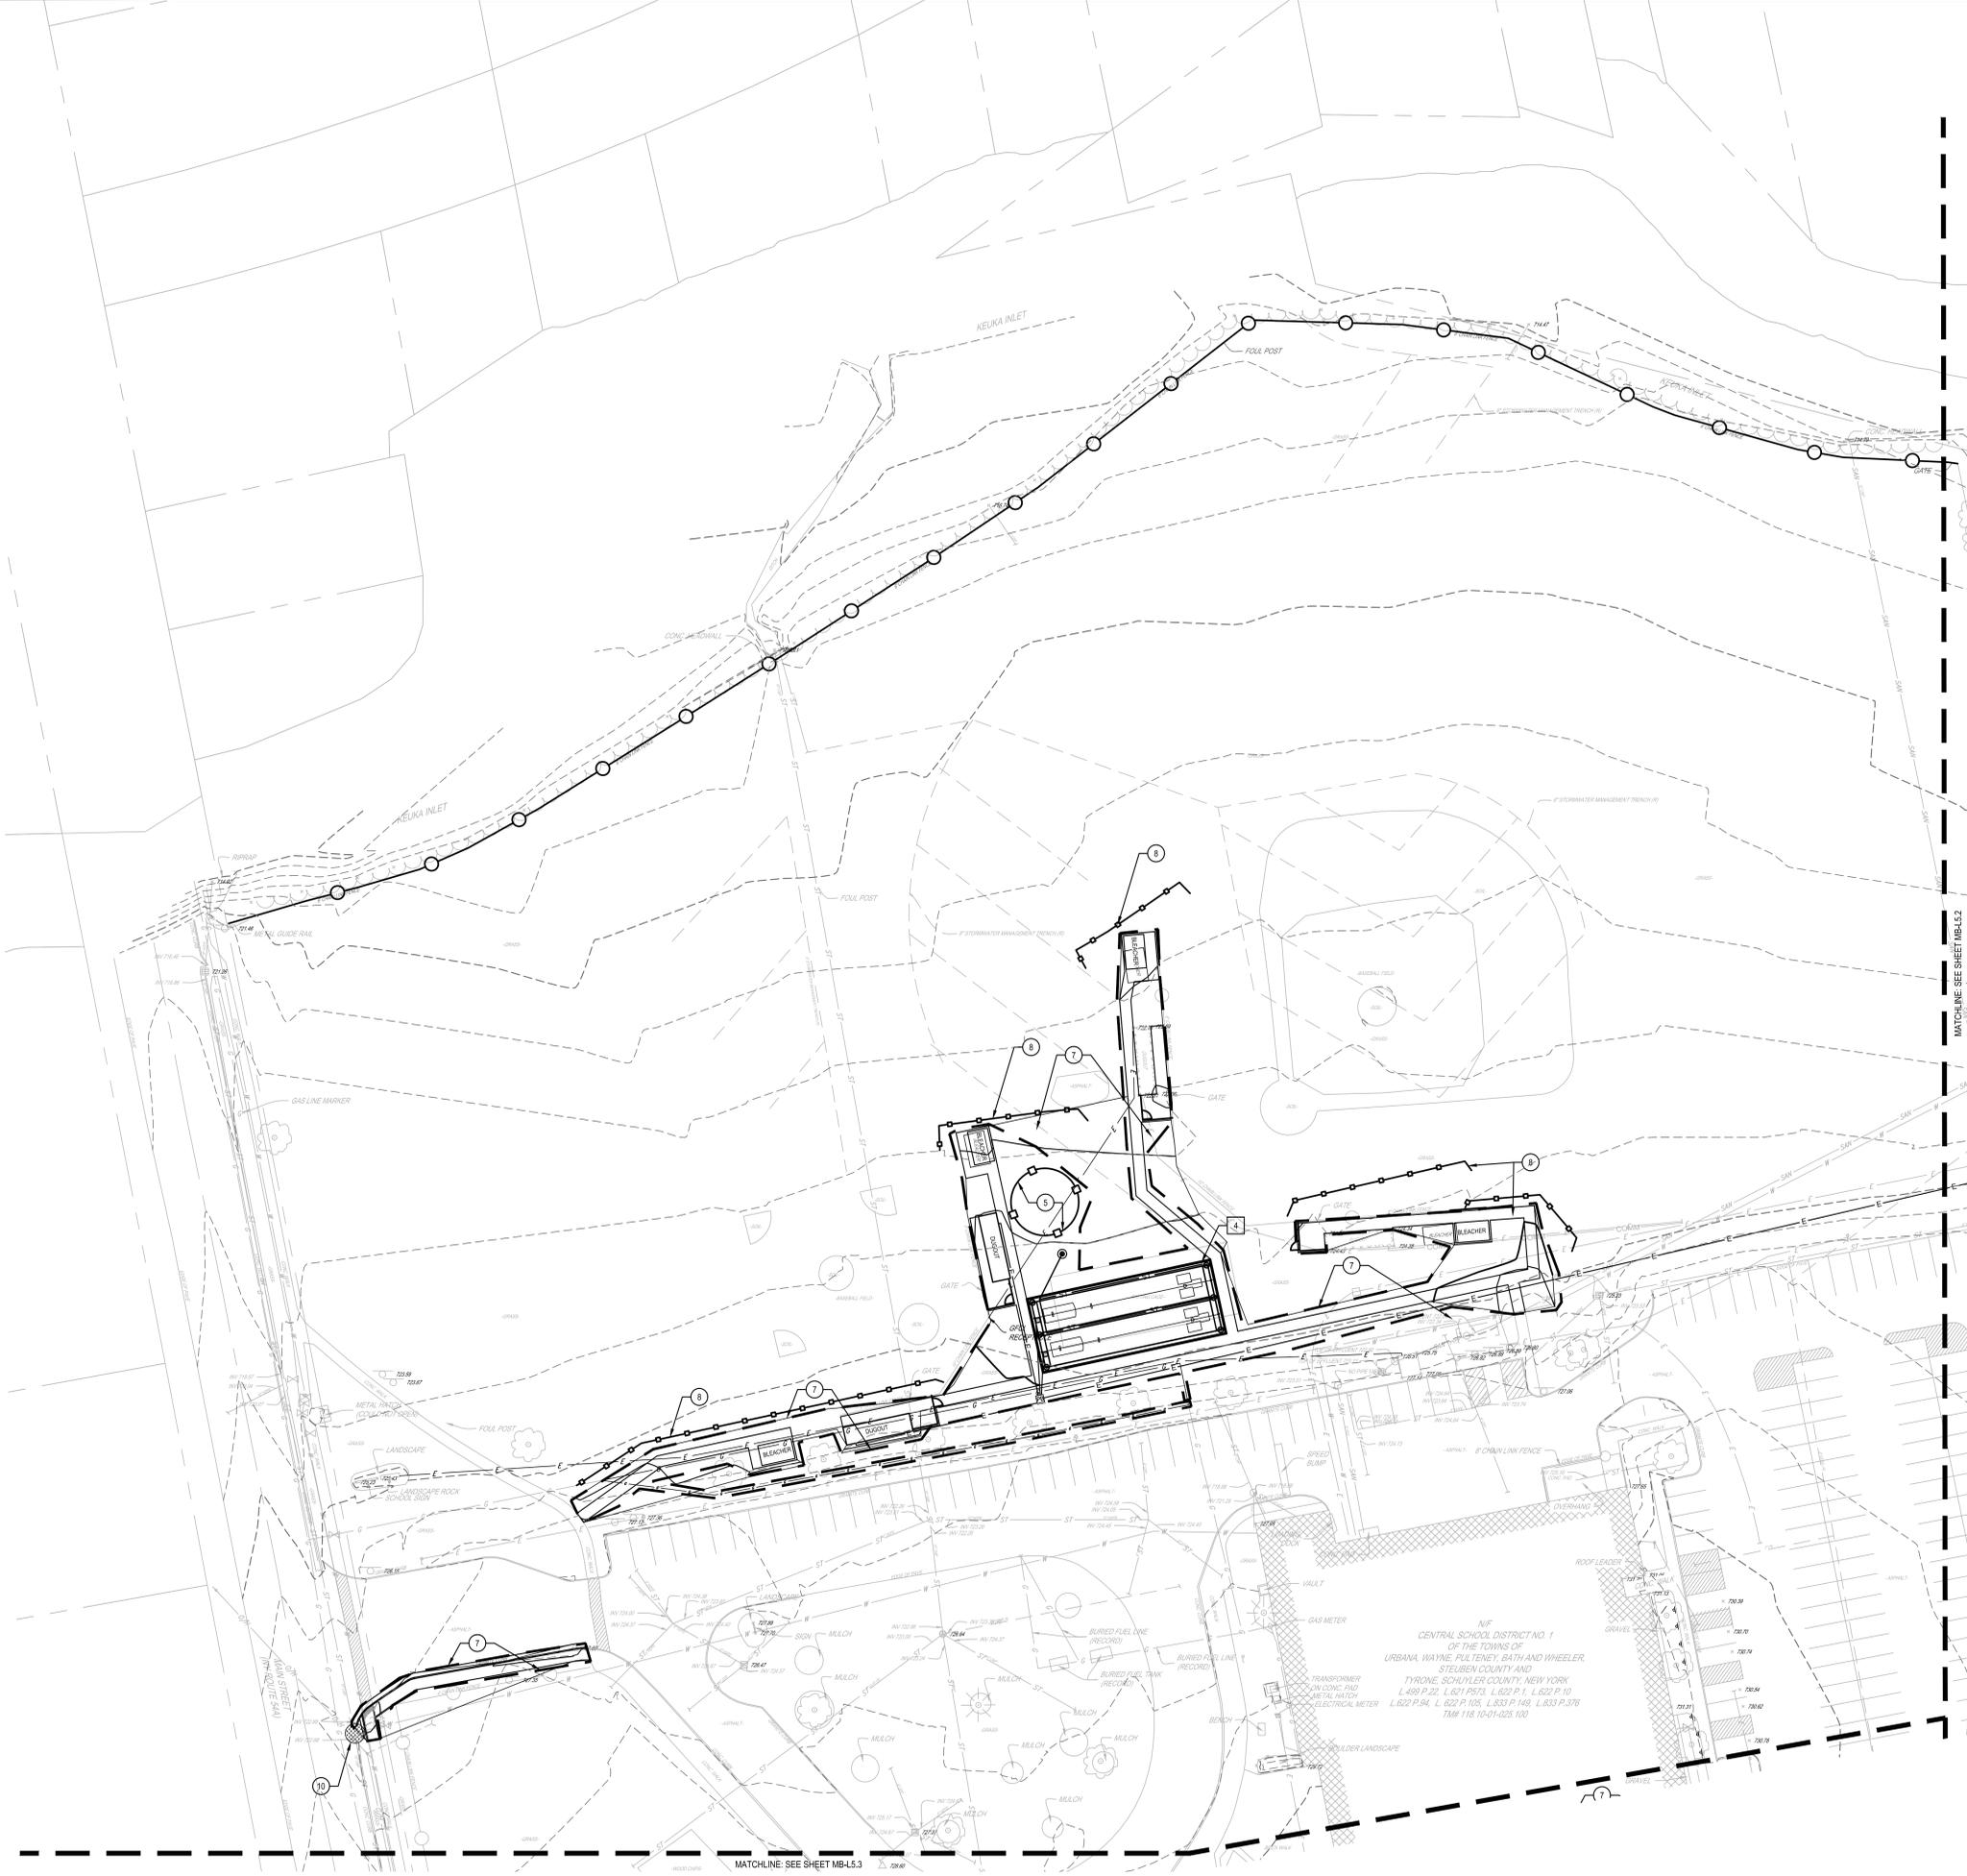

- 4 SITE E & SC PROTECTION PLAN NOTES:**
1. PROVIDE 12 INCH SILT SOCK (TYP.). SEE DETAIL 4MB-L6.1.
  2. PROVIDE INLET PROTECTION (TYP.). SEE DETAIL 1MB-L6.1.
  3. PROVIDE CONCRETE WASHOUT AREA AS NEEDED. CONTRACTOR TO CONFIRM FINAL LOCATION WITH DIRECTION BY THE PROPERTY OWNER. SEE DETAIL 5MB-L6.1.
  4. PROVIDE CONSTRUCTION ENTRANCE AS NEEDED. CONTRACTOR TO CONFIRM FINAL LOCATION WITH DIRECTION BY THE PROPERTY OWNER. SEE DETAIL 3MB-L6.1.
  5. FINAL SOIL STOCKPILE LOCATIONS TO BE CHOSEN BY THE CONTRACTOR AND PROPERTY OWNER. SEE DETAIL 2MB-L6.1.
  6. FINAL STAGING AREA LOCATIONS TO BE CHOSEN BY THE CONTRACTOR AND PROPERTY OWNER.
  7. LIMIT OF DISTURBANCE (40.98 ACRES) A SWPPP WILL NOT BE REQUIRED DUE TO THE AREA OF DISTURBANCE BEING LESS THAN AN ACRE.
  8. ALTERNATE: INLET PROTECTION. SEE DETAIL 1MB-L6.1.

- LEGEND**
- INLET PROTECTION
  - EROSION CONTROL BLANKET
  - SILT SOCK
  - STAGING AREA
  - CONCRETE WASHOUT
  - TOPSOIL STOCKPILE
  - LIMIT OF DISTURBANCE

DATE	12/11/2025	DESCRIPTION OF REVISION	ISSUED FOR BID
#	1		

**HUNT ENGINEERS | ARCHITECTS | SURVEYORS**  
 HORSEHEADS, NY 687-855-8800 ROCHESTER, NY 662-557-7860 TOWANDA, PA 570-265-4888  
 BINGHAMTON, NY 607-738-1881 ALBANY, NY 607-738-8881  
 WWW.HUNTEAS.COM  
 NY CERTIFICATE NO. 0016229 PA CERTIFICATE NO. TSC2203131464-1  
 SCENARIO: CLASSIFIED BUSINESS, PAPERLESS & 3D/SWISS AND SOL

**SITE EROSION AND SEDIMENT CONTROL PLAN**  
**2025 CAPITAL IMPROVEMENTS PROJECT**  
**HAMMONDSPORT CENTRAL SCHOOL DISTRICT**  
 8272 MAIN STREET, HAMMONDSPORT, NEW YORK, 14840

**1 SITE EROSION AND SEDIMENT CONTROL PLAN**  
 SCALE: 1" = 30'




SED NUMBERS: MB, 57-29-01-04-00-02-05, BG, 57-29-01-04-5-005-008

**MB-L5.1**  
 PROJECT NO: 1925.014






- 1 SITE E & SC PROTECTION PLAN NOTES:**
1. PROVIDE 12 INCH SILT SOCK (TYP.). SEE DETAIL 4MB-L6.1.
  2. PROVIDE INLET PROTECTION (TYP.). SEE DETAIL 1MB-L6.1.
  3. PROVIDE CONCRETE WASHOUT AREA AS NEEDED. CONTRACTOR TO CONFIRM FINAL LOCATION WITH DIRECTION BY THE PROPERTY OWNER. SEE DETAIL 5MB-L6.1.
  4. PROVIDE CONSTRUCTION ENTRANCE AS NEEDED. CONTRACTOR TO CONFIRM FINAL LOCATION WITH DIRECTION BY THE PROPERTY OWNER. SEE DETAIL 3MB-L6.1.
  5. FINAL SOIL STOCKPILE LOCATIONS TO BE CHOSEN BY THE CONTRACTOR AND PROPERTY OWNER. SEE DETAIL 2MB-L6.1.
  6. FINAL STAGING AREA LOCATIONS TO BE CHOSEN BY THE CONTRACTOR AND PROPERTY OWNER.
  7. LIMIT OF DISTURBANCE (±0.88 ACRES) A SWPPP WILL NOT BE REQUIRED DUE TO THE AREA OF DISTURBANCE BEING LESS THAN AN ACRE.
  8. ALTERNATE: INLET PROTECTION. SEE DETAIL 1MB-L6.1.

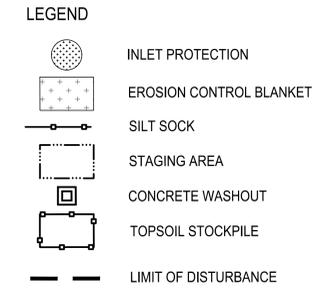

**1 SITE EROSION AND SEDIMENT CONTROL PLAN**  
SCALE: 1" = 30'

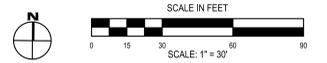

SED. NUMBERS MB, 57-29-01-04-00-02-05, BG, 57-29-01-04-5-005-08

**SITE EROSION AND SEDIMENT CONTROL PLAN**  
**2025 CAPITAL IMPROVEMENTS PROJECT**  
**HAMMONDSPT. CENTRAL SCHOOL DISTRICT**  
 8272 MAIN STREET, HAMMONDSPT., NEW YORK, 14840


**MB-L5.3**  
PROJECT NO: 1925.014

DATE	DESCRIPTION OF REVISION	ISSUED FOR	BY
1 12/11/2025			

**HUNT ENGINEERS | ARCHITECTS | SURVEYORS**  
 HORSEHEADS, NY 607-355-8800 ROCHESTER, NY 662-597-7864 TOWANDA, PA 570-265-4888  
 BINGHAMTON, NY 607-738-1881 ALBANY, NY 607-738-8881  
 WWW.HUNTEAS.COM  
 NY CERTIFICATE NO. 0016229 PA CERTIFICATE NO. TSC2020131464-1

DRAWN BY: DM  
 CHECKED BY: SM  
 DATE: 10/27/2025  
 PHASE: CD  
 TIT IS A VIOLATION OF THE LAW FOR ANY PERSON TO MAKE UNAUTHORIZED ALTERATIONS OR ADDITIONS TO THIS DOCUMENT. CONSULT HUNTS ENGINEERS, ARCHITECTS & SURVEYORS FOR ALL.

MATCHLINE SEE SHEET MB-L5.2

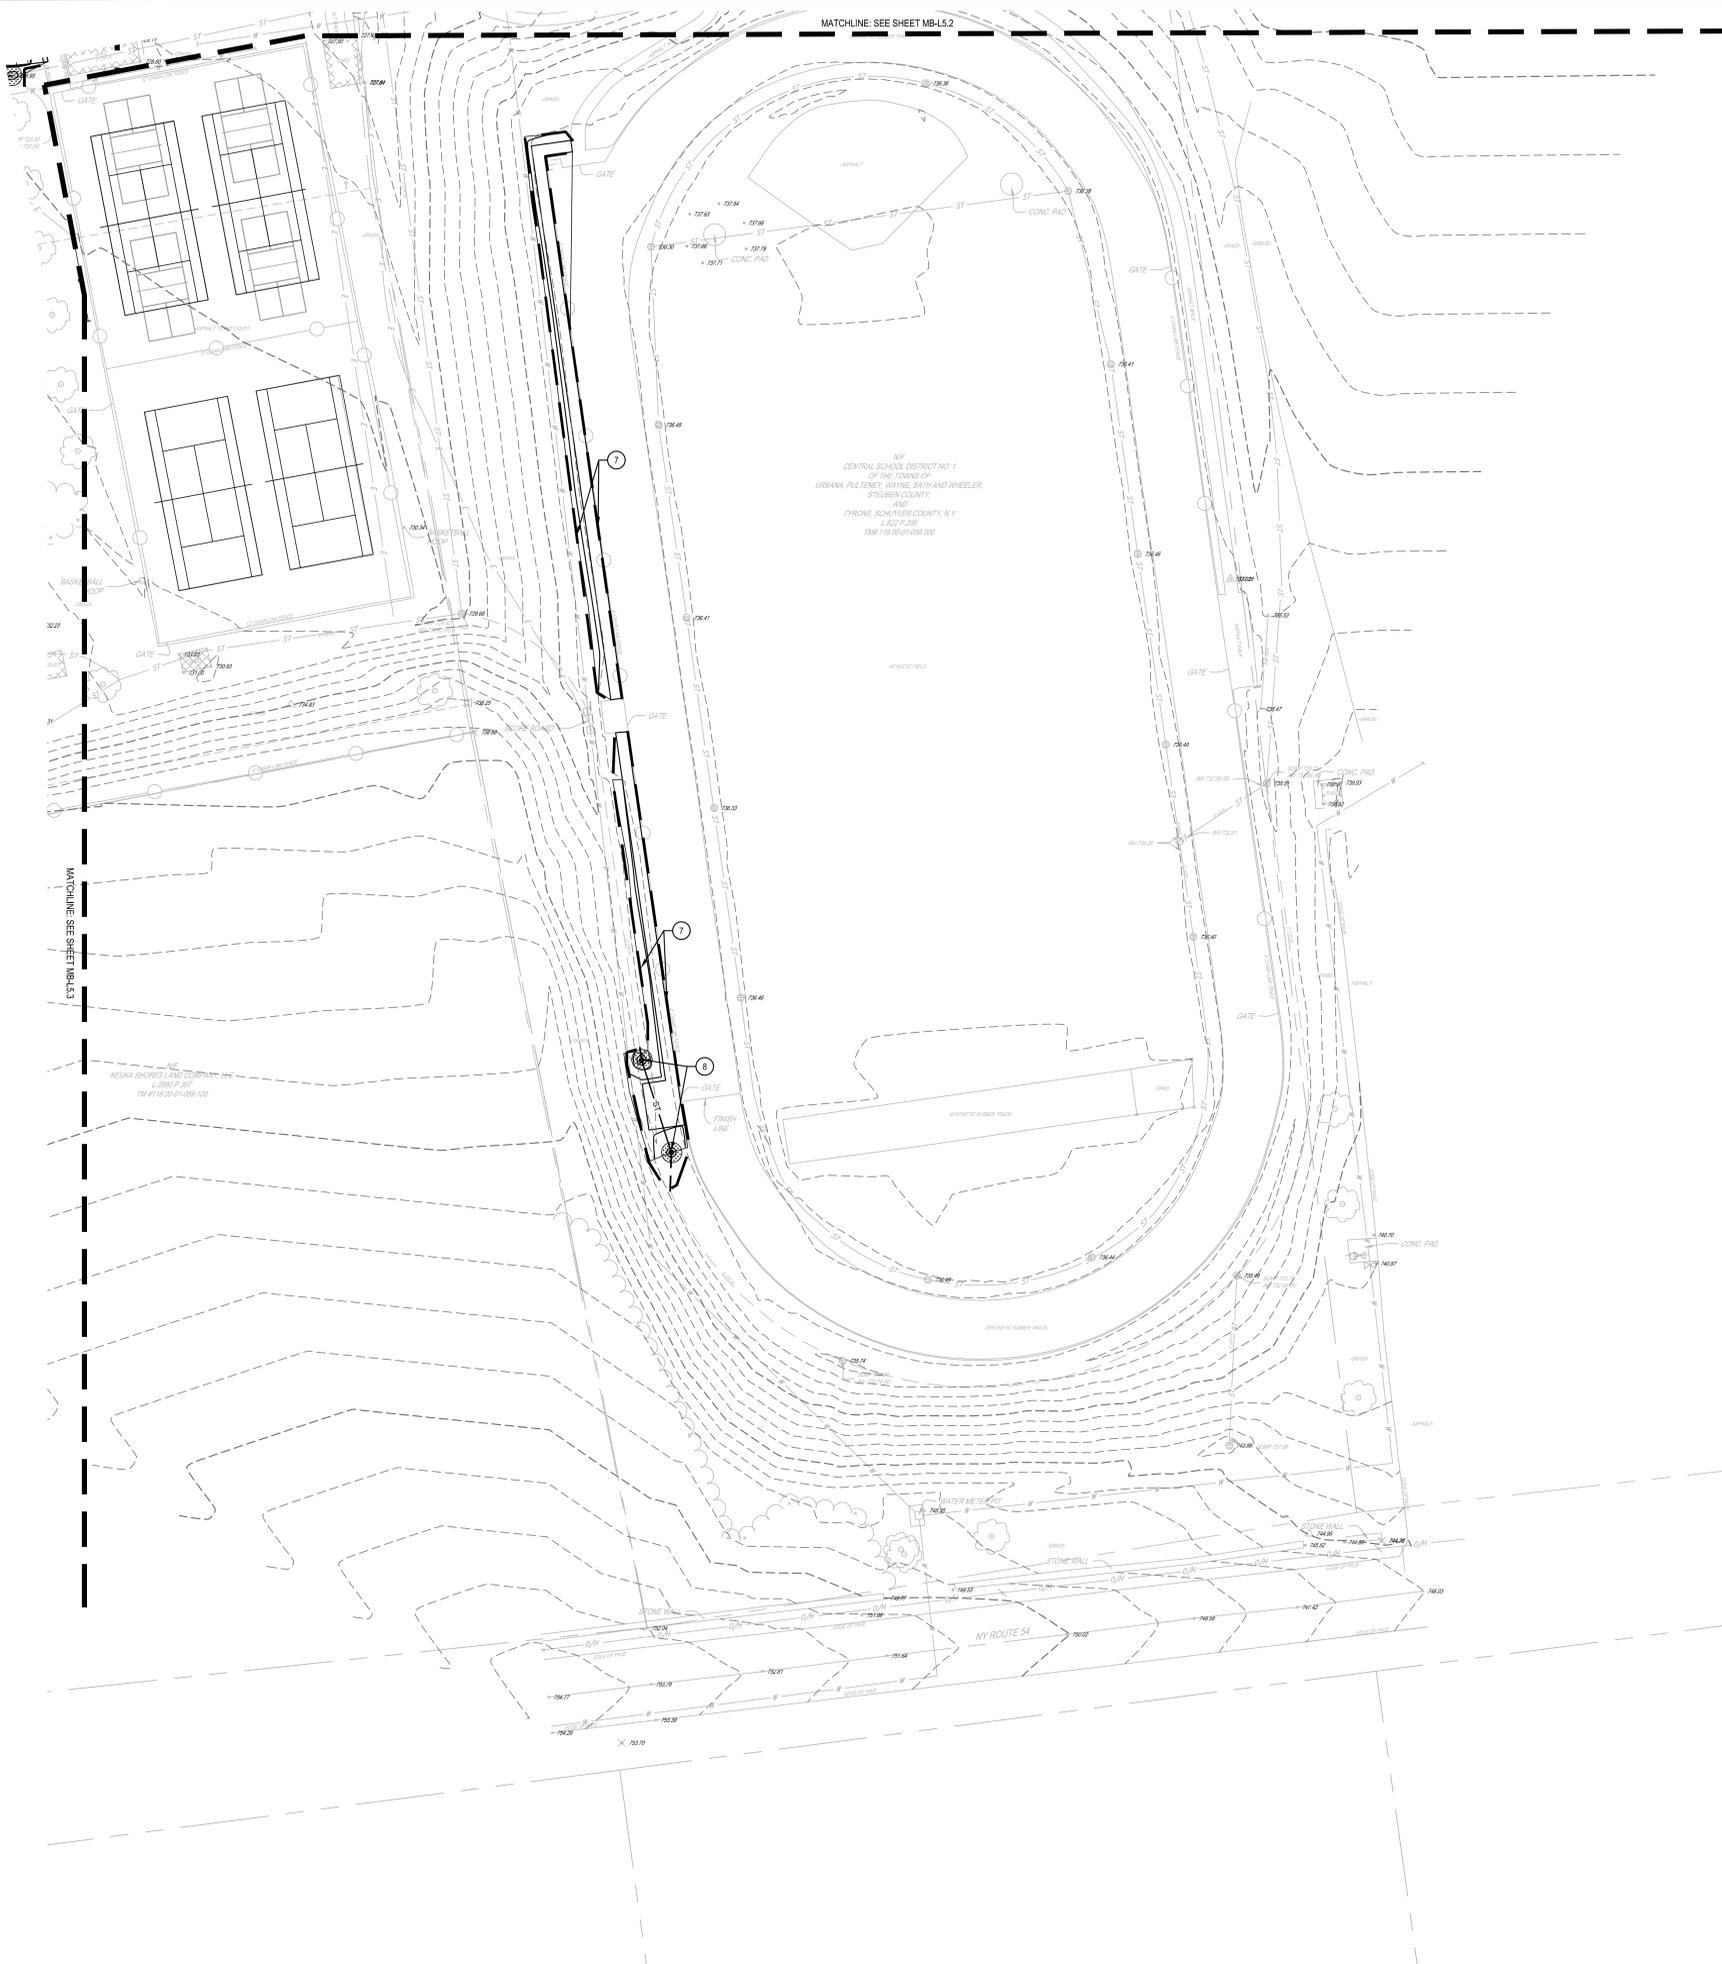

N/F  
 CENTRAL SCHOOL DISTRICT NO. 1  
 OF THE TOWNS OF  
 URBANA, PLUTENEY, WAYNE, BATH AND WHEELER,  
 STEUBEN COUNTY,  
 AND  
 PYRONE, SCHUYLER COUNTY, N.Y.  
 L.S. 2023.006  
 TMAP 17A 03-01-050.000

- SITE E & SC PROTECTION PLAN NOTES:**
1. PROVIDE 12 INCH SILT SOCK (TYP.), SEE DETAIL 4MB-L6.1.
  2. PROVIDE INLET PROTECTION (TYP.), SEE DETAIL 1MB-L6.1.
  3. PROVIDE CONCRETE WASHOUT AREA AS NEEDED. CONTRACTOR TO CONFIRM FINAL LOCATION WITH DIRECTION BY THE PROPERTY OWNER. SEE DETAIL 5MB-L6.1.
  4. PROVIDE CONSTRUCTION ENTRANCE AS NEEDED. CONTRACTOR TO CONFIRM FINAL LOCATION WITH DIRECTION BY THE PROPERTY OWNER. SEE DETAIL 3MB-L6.1.
  5. FINAL SOIL STOCKPILE LOCATIONS TO BE CHOSEN BY THE CONTRACTOR AND PROPERTY OWNER. SEE DETAIL 2MB-L6.1.
  6. FINAL STAGING AREA LOCATIONS TO BE CHOSEN BY THE CONTRACTOR AND PROPERTY OWNER.
  7. LIMIT OF DISTURBANCE (40.98 ACRES) A SWPPP WILL NOT BE REQUIRED DUE TO THE AREA OF DISTURBANCE BEING LESS THAN AN ACRE.
  8. ALTERNATE: INLET PROTECTION. SEE DETAIL 1MB-L6.1.

- LEGEND**
- INLET PROTECTION
  - EROSION CONTROL BLANKET
  - SILT SOCK
  - STAGING AREA
  - CONCRETE WASHOUT
  - TOPSOIL STOCKPILE
  - LIMIT OF DISTURBANCE

**1 ALTERNATE 2: SITE EROSION AND SEDIMENT CONTROL PLAN**  
 SCALE: 1" = 30'



DRAWN BY:	DO		
CHECKED BY:	SM		
DATE:	10/27/2023		
PHASE:	CD		
#	DATE	DESCRIPTION OF REVISION	ISSUED FOR
1	12/11/2023		

**HUNT ENGINEERS | ARCHITECTS | SURVEYORS**

HORSEHEADS, NY 607-808-8000 ROCHESTER, NY 661-397-7860 TOWANDA, PA 570-265-4888  
 BINGHAMTON, NY 607-738-1881 ALBANY, NY 607-738-8881  
 WWW.HUNTEAS.COM  
 NY CERTIFICATE NO. 0016220 PA CERTIFICATE NO. TSC220313464-1

**SITE EROSION AND SEDIMENT CONTROL PLAN**  
**2025 CAPITAL IMPROVEMENTS PROJECT**  
**HAMMONDSPOUT CENTRAL SCHOOL DISTRICT**  
 8272 MAIN STREET, HAMMONDSPOUT, NEW YORK, 14840

**MB-L5.4**  
 PROJECT NO: 1925.014

SED NUMBERS MB, 57-29-01-04-00-005, BG, 57-29-01-04-5-005-008

IT IS A VIOLATION OF THE LAW FOR ANY PERSON TO MAKE UNAUTHORIZED ALTERATIONS OR ADDITIONS TO PLANS DRAWN BY A LICENSED ENGINEER, ARCHITECT OR SURVEYOR. © Copyright 2023

**I. GENERAL REQUIREMENTS:**

- FOR BIDDING PURPOSES, PROSPECTIVE BIDDERS SHALL MAKE THEMSELVES FAMILIAR WITH THE STORMWATER POLLUTION PREVENTION PLAN (SWPPP) THAT IS ON FILE AT THE OWNER'S OFFICE OR IT WILL OTHERWISE BE MADE AVAILABLE UPON REQUEST.
- THE STORMWATER POLLUTION PREVENTION PLAN (SWPPP) REPORT DOCUMENT, WHICH ALSO INCLUDES THE E&S PLANS (SHEETS MS-L7.1 AND MS-L8.1), DEFINES AND MEETS THE REQUIREMENTS OF THE NEW YORK STATE DEPARTMENT OF ENVIRONMENTAL CONSERVATION (NYSDEC) PHASE II STORMWATER REGULATIONS.
- ALL CONTRACTORS AND SUB-CONTRACTORS SHALL CERTIFY WITH THE SWPPP REPORT THAT THEY WILL IMPLEMENT AND MAINTAIN STORMWATER MANAGEMENT PRACTICES AND EROSION AND SEDIMENT CONTROL MEASURES AS SPECIFIED IN THE DOCUMENTS MENTIONED ABOVE.
- EROSION CONTROL MEASURES INSTALLED AND MAINTAINED BY THE SITE WORK CONTRACTOR ARE SUBJECT TO THE REVIEW AND APPROVAL BY THE NYSDEC, DESIGN ENGINEER AND OWNER'S REPRESENTATIVE. IMMEDIATE ACTION BY THE CONTRACTOR SHALL BE TAKEN IF ADDITIONAL OR CORRECTIVE MEASURES ARE REQUIRED BY ANY ONE OF THESE CITED REVIEWERS. EROSION CONTROL MEASURES NOT SPECIFICALLY SHOWN ON CONTRACT DRAWINGS, SHALL BE INSTALLED AS WARRANTED BY FIELD CONDITIONS AND AS DIRECTED BY THE AFOREMENTIONED REVIEWERS.
- AS DESIGN ENGINEER, OUR OFFICE HAS NOTIFIED THE OWNER OF THE INSPECTION REQUIREMENTS UNDER THE GENERAL PERMIT. DISTURBANCES OF ONE ACRE OR GREATER REQUIRE THAT THE OWNER FILE A NOTICE OF INTENT AND A SWPPP WITH THE NYSDEC UNDER STATE POLLUTANT DISCHARGE ELIMINATION SYSTEM (SPDES). THE REGULATIONS REQUIRE THAT A "CERTIFIED INSPECTOR" OR "LICENSED PROFESSIONAL" COMPLETE A WEEKLY INSPECTION THROUGHOUT THE PERIOD OF LAND DISTURBANCE OR TWO (2) INSPECTIONS EVERY WEEK IF GREATER THAN 5 ACRES IS DISTURBED AT ANY ONE TIME.

**III. MAINTENANCE AND REPAIR OF EROSION AND SEDIMENT FACILITIES**

- PROPER MAINTENANCE AND REPAIR OF EROSION AND SEDIMENT CONTROL FACILITIES ARE NECESSARY TO THE EFFECTIVENESS OF THE EROSION AND SEDIMENT POLLUTION CONTROL FACILITIES.
- DISTURBED GROUND SURFACES SHALL BE SPRINKLED WITH WATER AND/OR CARBON CHLORIDE, AS NEEDED, TO LIMIT THE FORMATION AND MIGRATION OF AIRBORNE DUST.
- OPERATIONAL MEASURES SHALL BE EMPLOYED DURING CONSTRUCTION TO PREVENT THE SPILLS OF FUELS AND LUBRICANTS. IF A SPILL OCCURS, IT SHALL BE CONTROLLED IMMEDIATELY TO PREVENT ITS ENTRY INTO OFF-SITE AREAS INCLUDING ADJACENT STORM SEWER.
- ANY TEMPORARY EROSION CONTROL FACILITY SHALL REMAIN FUNCTIONAL UNTIL VEGETATIVE COVER IS SUFFICIENTLY ESTABLISHED WITHIN THE RESPECTIVE TRIBUTARY DRAINAGE AREA.
- ANY DEBRIS ACCUMULATED IN EROSION AND SEDIMENT CONTROL FACILITIES SHALL BE REMOVED AND PROPERLY DISPOSED OF. THESE FACILITIES SHALL BE CHECKED DAILY AND AFTER RAINFALL EVENTS, AND REALIGNED AS NEEDED. SEDIMENT SHALL BE REMOVED WHEN IT REACHES THE FOLLOWING DEPTHS:  

SILT SOCK -	1/2 HEIGHT
-------------	------------

NOTE: DISTURBED AREAS SHALL BE CONSIDERED AS PERMANENTLY STABILIZED WHEN A MINIMUM COVER OF 80% HAS BEEN ESTABLISHED.
- ANY EROSION AND SEDIMENT CONTROL DEVICES THAT ARE NOTED AS DEFICIENT BY AN INSPECTOR OR NYSDEC STAFF SHALL BE REPAIRED OR REPLACED WITHIN 24 HOURS OF RECEIVING NOTICE.

**VI. SEQUENCE OF CONSTRUCTION**

THE FOLLOWING ARE STEPS REGARDING THE CONSTRUCTION AND INSTALLATION OF VARIOUS PROJECT COMPONENTS THAT WILL ASSIST IN THE CONTROL OF EROSION AND SEDIMENT CONTROL.

- CONTRACTOR SHALL REVIEW AND SIGN/CERTIFY THE SWPPP DOCUMENTATION. A COPY OF THE CERTIFIED SWPPP SHALL BE RETAINED AT THE PROJECT SITE THROUGHOUT THE DURATION OF THE PROJECT.
- A FIELD MEETING SHALL BE CONDUCTED WITH THE SWPPP INSPECTOR AND THE CONTRACTOR IN CHARGE OF EROSION AND SEDIMENT CONTROL MEASURES.
- INSTALL STABILIZED CONSTRUCTION ENTRANCE AND PERIMETER PROTECTION MEASURES (SILT SOCK, STORM INLET PROTECTION, ETC.).
- ROUGH GRADE SITE WITH E&S CONTROL MEASURES AS SHOWN ON PLANS.
- TEMPORARILY STABILIZE ALL DISTURBED AREAS.
- INSTALL UTILITIES AND STORM CONVEYANCE STRUCTURES AND PIPES. PROVIDE STORM INLET PROTECTION AS INDICATED.
- INSTALL PAVEMENT, SIDEWALK, SPORTS FIELDS, AND ALL OTHER PROPOSED SITE IMPROVEMENTS.
- PROVIDE PERMANENT VEGETATION ON ALL DISTURBED AREAS.
- REMOVE ALL TEMPORARY EROSION AND SEDIMENT CONTROLS ONCE 80% STABILIZATION HAS BEEN ACHIEVED.
- CONTRACTOR SHALL NOTIFY PROJECT DESIGN ENGINEER/ARCHITECT THAT SITE STABILIZATION IS COMPLETED. THE SWPPP IS TO BE REMOVED FROM THE SITE AND NOTICE OF TERMINATION SHOULD BE CONSIDERED.

NOTE: AT NO POINT DURING CONSTRUCTION SHALL GREATER THAN 5 ACRES OF THE PROJECT SITE BE DISTURBED AT ANY ONE TIME WITHOUT PRIOR APPROVAL OF A 5-ACRE WAIVER FROM THE NYSDEC.

**II. EROSION & SEDIMENT POLLUTION CONTROL (E & SPC) GUIDELINES:**

- THE CONTRACTOR SHALL BE RESPONSIBLE FOR IMPLEMENTING EROSION AND SEDIMENT CONTROL TO PROTECT DOWNSTREAM WATER BODIES.
- THE CONTRACTOR SHALL BE RESPONSIBLE FOR CONSTRUCTION CONTROL AND MAINTENANCE OF SOIL EROSION AND SEDIMENT CONTROL FACILITIES TO ENSURE PROPER FUNCTIONING OF SAID FACILITIES (DURING CONSTRUCTION).
- AFTER THE PROJECT HAS BEEN COMPLETED, THE CONTRACTOR SHALL HAVE THE RESPONSIBILITY FOR ENSURING THAT ALL TEMPORARY SOIL EROSION AND SEDIMENT CONTROL MEASURES HAVE BEEN REMOVED OR REPLACED BY PERMANENT CONTROLS.
- ANY DISTURBED AREAS THAT WILL BE LEFT EXPOSED FOR MORE THAN FIVE (5) DAYS, AND NOT SUBJECT TO CONSTRUCTION TRAFFIC, WILL IMMEDIATELY RECEIVE A TEMPORARY SEEDING. IF THE SEASON PREVENTS THE ESTABLISHMENT OF A TEMPORARY COVER, THE DISTURBED AREAS WILL BE MULCHED WITH STRAW OR EQUIVALENT MATERIAL, AT A RATE OF 2.5 - 3.0 TONS PER ACRE, ACCORDING TO STATE STANDARDS.
- PERMANENT VEGETATION TO BE SEEDING OR SODDED ON ALL EXPOSED AREAS WITHIN FIVE (5) DAYS AFTER FINAL GRADING. MULCH AS NECESSARY FOR SEED PROTECTION AND ESTABLISHMENT. LIME AND FERTILIZE SEED BED PRIOR TO PERMANENT SEEDING.
- EROSION AND SEDIMENT POLLUTION CONTROL FACILITIES AND PRACTICES UTILIZED IN THE CONSTRUCTION OF THE PROJECT SHALL BE CONSISTENT WITH THE LATEST VERSIONS OF THE NEW YORK STATE STANDARDS AND SPECIFICATIONS FOR EROSION AND SEDIMENT CONTROL, NEW YORK STATE STORMWATER MANAGEMENT DESIGN MANUAL, AND THE NEW YORK STATE SPDES GENERAL PERMIT FOR STORMWATER DISCHARGES.
- NATURAL VEGETATION SHALL BE RETAINED, PROTECTED, AND SUPPLEMENTED, AS FEASIBLE PRIOR TO AND DURING CONSTRUCTION.
- CUT AND FILL SLOPES SHALL BE BROUGHT TO FINAL PROPOSED GRADES AS SOON AS POSSIBLE IN THE CONSTRUCTION SEQUENCES, AND SEEDED AND MULCHED IMMEDIATELY.
- EROSION AND SEDIMENT POLLUTION CONTROL FACILITIES (SILT SOCK, INLET PROTECTION, STABILIZED CONSTRUCTION ENTRANCES AND ALL OTHER ACCEPTABLE FACILITIES) SHALL BE MAINTAINED THROUGHOUT CONSTRUCTION UNTIL COMPLETE SITE STABILIZATION.
- HEAVY CONSTRUCTION EQUIPMENT SHALL BE KEPT AS CLOSE TO THE WORK AREA AS PRACTICAL TO MINIMIZE DISTURBANCE OF SOIL ALREADY STABILIZED OR UNDISTURBED.
- TOPSOIL AND OTHER SOIL REMOVED DURING CONSTRUCTION SHALL BE STOCKPILED IN A SUITABLE LOCATION CLEAR FROM ANY STORMWATER DRAINAGE COURSES. STOCKPILES WHICH ARE INACTIVE FOR MORE THAN 5 DAYS SHALL BE SEEDING.
- VEGETATIVE STABILIZATION SHALL BE PERIODICALLY INSPECTED FOR SUFFICIENT GROWTH AND PROGRESS. AREAS NOT RESPONDING SHALL BE PROMPTLY RESEEDED AND REMULCHED AS SOON AS POSSIBLE. AREAS SHOWING SIGNS OF EROSION PRIOR TO STABILIZATION SHALL BE GRADED, RESEEDED, AND REMULCHED AS SOON AS POSSIBLE. SOD OR EROSION CONTROL FABRIC SHALL BE UTILIZED WHERE ADEQUATE STABILIZATION IS NOT OCCURRING.
- ALL PERIMETER SOIL EROSION AND SEDIMENT CONTROL MEASURES SHALL BE INSTALLED BEFORE BEGINNING EARTH MOVING ACTIVITIES, OR IN THEIR PROPER SEQUENCE, AND MAINTAINED UNTIL PERMANENT PROTECTION IS ESTABLISHED.
- A STABILIZED CONSTRUCTION ENTRANCE PAD OF 1.5' TO 2' CLEAN STONE WILL BE PLACED AT ALL CONSTRUCTION DRIVEWAYS BEFORE INITIAL SITE DISTURBANCE.
- THE APPLICATION OF TOPSOIL, LIMING, FERTILIZING, SEEDING, AND MULCHING FOR DISTURBED AREAS SHALL BE CONSISTENT WITH THE STANDARD GENERAL PRACTICES FOR CONSTRUCTION.
- IMMEDIATELY FOLLOWING INITIAL DISTURBANCES OF ROUGH GRADING, ALL CRITICAL AREAS SUBJECT TO EROSION (I.E., STEEP SLOPES AND ROADWAY EMBANKMENTS, ETC.) WILL RECEIVE A TEMPORARY SEEDING IN COMBINATION WITH STRAW MULCH OR A SUITABLE EQUIVALENT, AT A RATE OF 2.5 - 3.0 TONS PER ACRE.
- AT THE TIME WHEN SITE PREPARATION FOR PERMANENT VEGETATIVE STABILIZATION IS TO BE ESTABLISHED, ANY SOIL THAT WILL NOT PROVIDE A SUITABLE ENVIRONMENT TO SUPPORT ADEQUATE VEGETATIVE GROUND COVER SHALL BE REMOVED OR TREATED IN SUCH A WAY THAT WILL PERMANENTLY ADJUST THE SOIL CONDITIONS AND RENDER IT SUITABLE FOR VEGETATIVE GROUND COVER.
- IF THE REMOVAL OR TREATMENT OF THE SOIL WILL NOT PROVIDE SUITABLE CONDITIONS, NON-VEGETATIVE MEANS OF PERMANENT GROUND STABILIZATION WILL HAVE TO BE EMPLOYED.
- IT SHALL BE THE CONTRACTOR'S RESPONSIBILITY TO MAINTAIN EROSION AND SEDIMENT CONTROL MEASURES UNTIL ALL CONTRIBUTING AREAS HAVE BEEN PERMANENTLY STABILIZED.

**IV. SOIL RESTORATION REQUIREMENTS**


- AERATION AND THE APPLICATION OF 6 INCHES OF TOPSOIL IS REQUIRED IN ANY PROPOSED LAWN AREA WHERE TOPSOIL HAS BEEN DISTURBED.
- FULL SOIL RESTORATION IS REQUIRED IN HEAVY TRAFFIC AREAS ON SITE, ESPECIALLY BETWEEN 5 AND 25 FEET AROUND THE PROPOSED BUILDING, BUT NOT WITHIN A 5 FOOT PERIMETER AROUND FOUNDATION WALLS. RESTORATION IS ALSO REQUIRED ON REDEVELOPMENT PROJECTS IN AREAS WHERE EXISTING IMPERVIOUS AREA WILL BE CONVERTED TO PERVIOUS AREA.
- FULL SOIL RESTORATION REQUIREMENTS ARE AS FOLLOWS:
  - SOIL RESTORATION IS TO TAKE PLACE DURING PERIODS OF RELATIVELY LOW TO MODERATE SUBSOIL MOISTURE, FOLLOWING ROUGH GRADING OF THE DISTURBED SUBSOILS
  - APPLY 3 INCHES OF COMPOST OVER SUBSOIL
  - TILL COMPOST INTO SUBSOIL TO A DEPTH OF AT LEAST 12 INCHES USING A CAT-MOUNTED RIPPER, TRACTOR-MOUNTED DISC, OR TILLER. MIXING, AND CIRCULATING AIR AND COMPOST INTO SUBSOILS
  - ROCK-PICK UNTIL UPLIFTED STONEROCK MATERIALS OF FOUR INCHES AND LARGER SIZE ARE CLEANED OFF THE SITE
  - APPLY TOPSOIL TO A DEPTH OF 6 INCHES
  - VEGETATE AS SPECIFIED ON PLANS
- AT THE END OF THE PROJECT AN INSPECTOR SHOULD BE ABLE TO PUSH A 3/8 INCH METAL BAR 12 INCHES INTO THE SOIL JUST WITH BODY WEIGHT.
- TILLING SHOULD NOT BE PERFORMED WITHIN THE DRIP LINE OF ANY EXISTING TREES OR OVER UTILITY INSTALLATIONS THAT ARE WITHIN 24 INCHES OF THE SURFACE.
- ADDITIONAL INFORMATION AND GUIDANCE MAY BE FOUND IN "DEEP-RIPPING AND DECOMPACTION" PUBLISHED BY NYSDEC DIVISION OF WATER 2008.

**V. MULCHING AND SEEDING REQUIREMENTS**

- SEEDBED PREPARATION:
  - APPLY LIMESTONE (EQUIVALENT TO 50 PERCENT (50%) CALCIUM PLUS MAGNESIUM OXIDES) AT A RATE OF 90 POUNDS PER 1,000 SQUARE FEET. APPLY FERTILIZER AT A RATE OF 600 POUNDS PER ACRE OR 14 POUNDS PER 1,000 SQUARE FEET USING 10-20-10 OR EQUIVALENT.
  - WORK LIME AND FERTILIZER INTO SOIL AS NEARLY AS PRACTICAL TO A DEPTH OF 4 INCHES WITH A DISC, SPRINGTOOTH HARROW OR OTHER SUITABLE EQUIPMENT. THE FINAL HARROWING OR DISING OPERATION SHOULD BE ON THE GENERAL CONTOUR. CONTINUE TILLAGE UNTIL A REASONABLY UNIFORM SEEDBED IS PREPARED.
  - INSPECT SEEDBED JUST BEFORE SEEDING. IF TRAFFIC HAS LEFT THE SOIL COMPACT, THE AREA MUST BE RETILLED AS ABOVE.


**TEMPORARY REQUIREMENTS**

- SEEDING:
  - APPLY LAWN MIX AT A RATE (SEE SPECIFICATIONS)
  - APPLY SEED WITH MECHANICAL SEEDER. OPTIMUM SEEDING DEPTH IS ONE INCH (EXCEPT SANDY SOILS, 2 INCHES).
  - WHERE FEASIBLE, EXCEPT WHERE EITHER A CULTIPAPER TYPE SEEDER OR HYDROSEEDER IS USED, THE SEEDING SHALL BE FIRMED FOLLOWING SEEDING OPERATIONS WITH A ROLLER, OR LIGHT DRAG. SEEDING OPERATIONS SHOULD BE ON THE CONTOUR.
- MULCHING:
  - MULCH MATERIALS SHALL BE UNROTTED SALT HAY OR SMALL GRASS STRAW AT A RATE OF 2-1/2 TO 3 TONS PER ACRE, OR 70 TO 90 POUNDS PER 1,000 SQUARE FEET. MULCH SHOULD NOT BE GROUND OR CHOPPED INTO SHORT PIECES.
  - SPREAD UNIFORMLY BY HAND OR MECHANICALLY SO THAT APPROXIMATELY 75 PERCENT TO 95 PERCENT OF THE SOIL SURFACE WILL BE COVERED.
  - MULCH ANCHORING SHALL BE ACCOMPLISHED IMMEDIATELY AFTER PLACEMENT TO MINIMIZE LOSS BY WIND OR WATER. 1. MULCHING NETTINGS - STAPLE, JUTE OR COTTON NETTINGS TO THE SOIL SURFACE. USE A DEGRADABLE NETTING IN AREAS TO BE MOVED.
- PERMANENT SEEDING TO BE INSTALLED PER MANUFACTURER'S SPECIFICATIONS.

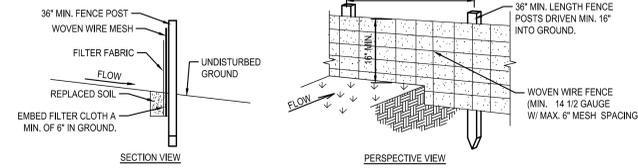

- NOTES:**
- WOVEN WIRE FENCE TO BE FASTENED SECURELY TO FENCE POST WITH WIRE TIRES OR STAPLES. POSTS SHALL BE HARDWOOD OR STEEL OF EITHER "T" OR "L" TYPE.
  - FILTER CLOTH TO BE FASTENED SECURELY TO WOVEN WIRE FENCE WITH TIES SPACED EVERY 24" AT TOP AND MID SECTION FENCE SHALL BE WOVEN WIRE, 12 1/2 GAUGE, 6" MAXIMUM MESH OPENINGS.
  - WHEN TWO SECTIONS OF FILTER CLOTH ADJOIN EACH OTHER THEY SHALL BE OVERLAPPED BY SIX INCHES AND FOLDED. FILTER CLOTH SHALL BE EITHER FILTER X, MIRAFI 100X, STABILINKA T140N, OR APPROVED EQUAL.
  - PREFABRICATED UNITS SHALL BE GEOFAB, ENVROFENCE, OR APPROVED EQUAL.
  - MAINTENANCE SHALL BE PERFORMED AS NEEDED AND MATERIAL REMOVED WHEN "BULGES" DEVELOP IN THE SILT FENCE.


**7 SILT FENCE DETAIL**  
SCALE: N.T.S.

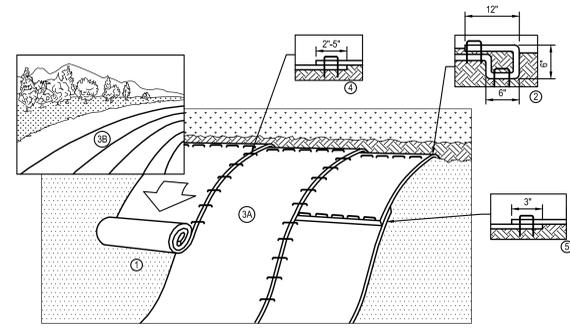

- PREPARE SOIL BEFORE INSTALLING ROLLED EROSION CONTROL PRODUCTS (RECPS) INCLUDING ANY NECESSARY APPLICATION OF LIME, FERTILIZER, AND SEED.
- BEGIN AT THE TOP OF THE SLOPE BY ANCHORING THE RECPS IN A 6" DEEP X 6" WIDE TRENCH WITH APPROXIMATELY 12" OF RECPS EXTENDED BEYOND THE UP-SLOPE PORTION OF THE TRENCH. ANCHOR THE RECPS WITH A ROW OF STAPLES/STAKES APPROXIMATELY 12" APART IN THE BOTTOM OF THE TRENCH. BACKFILL AND COMPACT THE TRENCH AFTER STAPLING. APPLY SEED TO COMPACTED SOIL AND FOLD REMAINING 12" PORTION OF RECPS BACK OVER SEED AND COMPACTED SOIL. SECURE RECPS OVER COMPACTED SOIL WITH A ROW OF STAPLES/STAKES SPACED APPROXIMATELY 12" APART ACROSS THE WIDTH OF THE RECPS.
- ROLL THE RECPS (A) DOWN OR (B) HORIZONTALLY ACROSS THE SLOPE. RECPS WILL UNROLL WITH APPROPRIATE SIDE AGAINST THE SOIL SURFACE. ALL RECPS MUST BE SECURELY FASTENED TO SOIL SURFACE BY PLACING STAPLES/STAKES IN APPROPRIATE LOCATION AS SHOWN IN THE STAPLE PATTERN GUIDE. WHEN USING THE DOT SYSTEM, STAPLES/STAKES SHOULD BE PLACED THROUGH EACH OF THE COLORED DOTS CORRESPONDING TO THE APPROPRIATE STAPLE PATTERN.
- THE EDGES OF PARALLEL RECPS MUST BE STAPLED WITH APPROXIMATELY 2'-5" OVERLAP DEPENDING ON RECPS TYPE.
- CONSECUTIVE RECPS SPICED DOWN THE SLOPE MUST BE PLACED END OVER END (SHINGLE STYLE) WITH AN APPROXIMATE 3" OVERLAP. STAPLE THROUGH OVERLAPPED AREA, APPROXIMATELY 12" APART ACROSS ENTIRE RECPS WIDTH.


**6 SLOPE STABILIZATION DETAIL**  
SCALE: N.T.S.

- VEGETATIVE STABILIZATION SHALL BE PERIODICALLY INSPECTED FOR SUFFICIENT GROWTH AND PROGRESS. AREAS NOT RESPONDING SHALL BE PROMPTLY RESEEDED AND REMULCHED AS SOON AS POSSIBLE. AREAS SHOWING SIGNS OF EROSION PRIOR TO STABILIZATION SHALL BE GRADED, RESEEDED, AND REMULCHED AS SOON AS POSSIBLE. SOD OR EROSION CONTROL FABRIC SHALL BE UTILIZED WHERE ADEQUATE STABILIZATION IS NOT OCCURRING.
- ALL PERIMETER SOIL EROSION AND SEDIMENT CONTROL MEASURES SHALL BE INSTALLED BEFORE BEGINNING EARTH MOVING ACTIVITIES, OR IN THEIR PROPER SEQUENCE, AND MAINTAINED UNTIL PERMANENT PROTECTION IS ESTABLISHED.
- A STABILIZED CONSTRUCTION ENTRANCE PAD OF 1.5' TO 2' CLEAN STONE WILL BE PLACED AT ALL CONSTRUCTION DRIVEWAYS BEFORE INITIAL SITE DISTURBANCE.
- THE APPLICATION OF TOPSOIL, LIMING, FERTILIZING, SEEDING, AND MULCHING FOR DISTURBED AREAS SHALL BE CONSISTENT WITH THE STANDARD GENERAL PRACTICES FOR CONSTRUCTION.
- IMMEDIATELY FOLLOWING INITIAL DISTURBANCES OF ROUGH GRADING, ALL CRITICAL AREAS SUBJECT TO EROSION (I.E., STEEP SLOPES AND ROADWAY EMBANKMENTS, ETC.) WILL RECEIVE A TEMPORARY SEEDING IN COMBINATION WITH STRAW MULCH OR A SUITABLE EQUIVALENT, AT A RATE OF 2.5 - 3.0 TONS PER ACRE.
- AT THE TIME WHEN SITE PREPARATION FOR PERMANENT VEGETATIVE STABILIZATION IS TO BE ESTABLISHED, ANY SOIL THAT WILL NOT PROVIDE A SUITABLE ENVIRONMENT TO SUPPORT ADEQUATE VEGETATIVE GROUND COVER SHALL BE REMOVED OR TREATED IN SUCH A WAY THAT WILL PERMANENTLY ADJUST THE SOIL CONDITIONS AND RENDER IT SUITABLE FOR VEGETATIVE GROUND COVER.
- IF THE REMOVAL OR TREATMENT OF THE SOIL WILL NOT PROVIDE SUITABLE CONDITIONS, NON-VEGETATIVE MEANS OF PERMANENT GROUND STABILIZATION WILL HAVE TO BE EMPLOYED.
- IT SHALL BE THE CONTRACTOR'S RESPONSIBILITY TO MAINTAIN EROSION AND SEDIMENT CONTROL MEASURES UNTIL ALL CONTRIBUTING AREAS HAVE BEEN PERMANENTLY STABILIZED.

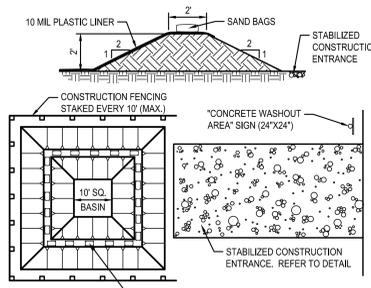


- NOTES:**
- ALL TOOLS AND EQUIPMENT UTILIZED DURING ANY CONCRETE CONSTRUCTION, INCLUDING HAND TOOLS, WHEELBARROWS, TRUCKS, CHUTES SHALL UTILIZE THE CONCRETE WASHOUT AREA.
  - WASHOUT AREA TO BE MAINTAINED AND CLEANED OUT PERIODICALLY TO PREVENT WASHWATER AND/OR SOLIDS FROM EXITING THE WASHOUT TRAP.

**5 CONCRETE WASH OUT DETAIL**  
SCALE: N.T.S.

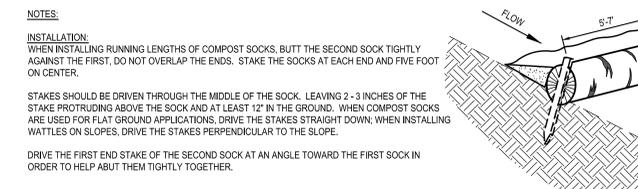


- NOTES:**
- INSTALLATION:** WHEN INSTALLING RUNNING LENGTHS OF COMPOST SOCKS, BUTT THE SECOND SOCK TIGHTLY AGAINST THE FIRST. DO NOT OVERLAP THE ENDS. STAKE THE SOCKS AT EACH END AND FIVE FOOT ON CENTER.
- STAKES SHOULD BE DRIVEN THROUGH THE MIDDLE OF THE SOCK, LEAVING 2-3 INCHES OF THE STAKE PROTRUDING ABOVE THE SOCK AND AT LEAST 12" IN THE GROUND. WHEN COMPOST SOCKS ARE USED FOR FLAT GROUND APPLICATIONS, DRIVE THE STAKES STRAIGHT DOWN. WHEN INSTALLING WATTLES ON SLOPES, DRIVE THE STAKES PERPENDICULAR TO THE SLOPE.
- DRIVE THE FIRST END STAKE OF THE SECOND SOCK AT AN ANGLE TOWARD THE FIRST SOCK IN ORDER TO HELP ABUT THEM TIGHTLY TOGETHER.
- INSTALLATION NOTES:**
- COMPOST SOCKS SHALL BE INSTALLED PRIOR TO ANY LAND-DISTURBING ACTIVITIES.
  - COMPOST SOCKS SHALL BE "SILT SOCK", "FILTERREX" OR OTHER APPROVED FILTER FABRIC SOCK OR COMPOST.
  - COMPOST SOCKS SHALL BE FILLED WITH WOOD CHIPS OR COMPOST. SEE SPECIFICATIONS FOR APPROVED COMPOSITION OF WOOD CHIPS OR COMPOST.
  - NOT FOR USE IN CONCENTRATED FLOW AREAS.
  - COMPOST SOCKS SHALL BE INSTALLED PER MANUFACTURER'S SPECIFICATIONS.
  - ON SLOPES, COMPOST SOCKS SHOULD BE INSTALLED ON CONTOUR WITH A SLIGHT DOWNWARD ANGLE AT THE END OF THE ROW IN ORDER TO PREVENT PONDING AT THE MID SECTION.
  - RUNNING LENGTHS OF SOCKS SHOULD BE ABUTTED FIRMLY TO ENSURE NO LEAKAGE AT THE ABUTMENTS.
  - COMPOST SOCK SHALL BE IN CONSTANT CONTACT WITH THE GROUND SURFACE.
  - WOOD STAKES SHALL BE USED TO SECURE THE WATTLES. 1/2" TO 5/8" REBAR IS ALSO ACCEPTABLE. BE SURE TO USE A STAKE THAT IS LONG ENOUGH TO PROTRUDE SEVERAL INCHES ABOVE THE WATTLE.
- MAINTENANCE:** SEDIMENT ACCUMULATED BEHIND WATTLE SHALL BE REMOVED WHEN SEDIMENT HAS ACCUMULATED TO ONE-HALF THE DIAMETER OF THE WATTLE.

**4 COMPOST OR SILT SOCK INSTALLATION DETAIL**  
SCALE: N.T.S.

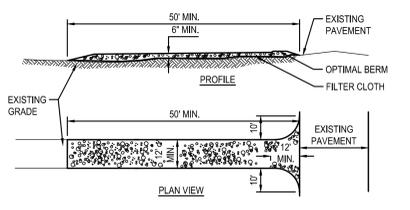


- NOTES:**
- STONE SIZE - USE 3"-4" STONE, OR RECLAIMED OR RECYCLED CONCRETE EQUIVALENT.
  - LENGTH - AS REQUIRED, BUT NOT LESS THAN 50 FEET.
  - THICKNESS - NOT LESS THAN 6 INCHES.
  - WIDTH - 12 FOOT MINIMUM, BUT NOT LESS THAN THE FULL WIDTH AT THE POINTS WHERE INGRESS OR EGRESS OCCURS.
  - FILTER CLOTH - WILL BE PLACED OVER ENTIRE AREA PRIOR TO PLACING OF STONE. FILTER CLOTH WILL NOT BE REQUIRED ON A SINGLE RESIDENCE LOT.
  - SURFACE WATER - ALL SURFACE WATER FLOWING OR DIRECTED TOWARD CONSTRUCTION ENTRANCES SHALL BE PIPED ACROSS THE ENTRANCE. IF PIPING IS IMPRACTICAL, A MOUNTABLE BERM WITH 5:1 SLOPES WILL BE PERMITTED.
  - MAINTENANCE - THE ENTRANCE SHALL BE MAINTAINED IN A CONDITION WHICH WILL PREVENT TRACKING OR FLOWING OF SEDIMENT ONTO PUBLIC RIGHTS-OF-WAY. THIS MAY REQUIRE PERIODIC TOP DRESSING WITH ADDITIONAL STONE AS CONDITIONS DEMAND AND REPAIR AND/OR CLEANEST OF ANY MEASURES USED TO TRAP SEDIMENT. ALL SEDIMENT SPILLED, DROPPED, WASHED OR TRACKED ONTO PUBLIC RIGHTS-OF-WAY MUST BE REMOVED IMMEDIATELY.
  - WASHING - WHEELS SHALL BE CLEANED TO REMOVE SEDIMENT PRIOR TO ENTRANCE ONTO PUBLIC RIGHTS-OF-WAY. WHEN WASHING IS REQUIRED, IT SHALL BE DONE ON AN AREA STABILIZED WITH STONE AND WHICH DRAINS INTO AN APPROVED SEDIMENT TRAPPING DEVICE.
  - PERIODIC INSPECTION AND NEEDED MAINTENANCE SHALL BE PROVIDED AFTER EACH RAIN.

**3 CONSTRUCTION ENTRANCE DETAIL**  
SCALE: N.T.S.

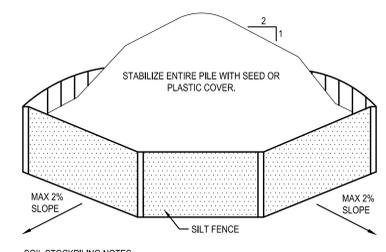

- SOIL STOCKPILING NOTES:**
- AREA CHOSEN FOR STOCKPILING OPERATIONS SHALL BE DRY AND STABLE.
  - MAXIMUM SLOPE OF STOCKPILE SHALL BE 1:2.
  - UPON COMPLETION OF SOIL STOCKPILING, EACH PILE SHALL BE SURROUNDED WITH SILT FENCING AND THEN STABILIZED WITH SEED OR SECURED IMPERVIOUS COVER.
  - SEE SILT FENCE INSTALLATION DETAIL.

**2 SOIL STOCKPILE AREA DETAIL**  
SCALE: N.T.S.

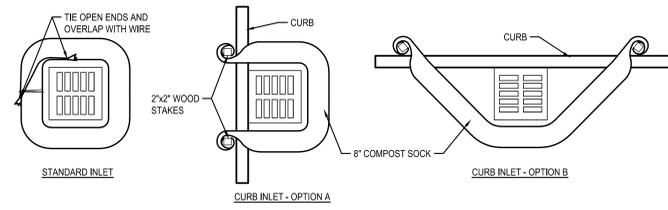

- INSTALLATION NOTES:**
- COMPOST SOCKS SHALL BE INSTALLED PRIOR TO ANY LAND-DISTURBING ACTIVITIES.
  - COMPOST SOCKS SHALL BE "SILT SOCK", "FILTERREX" OR OTHER APPROVED FILTER FABRIC SOCK.
  - COMPOST SOCKS SHALL BE FILLED WITH WOOD CHIPS OR COMPOST. SEE SPECIFICATIONS FOR APPROVED COMPOSITION OF WOOD CHIPS OR COMPOST.
  - COMPOST SOCKS SHALL BE INSTALLED PER MANUFACTURER'S SPECIFICATIONS.
  - COMPOST SOCK SHALL BE IN CONSTANT CONTACT WITH THE GROUND SURFACE.
  - WOOD STAKES SHALL BE USED TO SECURE THE WATTLES. 1/2" TO 5/8" REBAR IS ALSO ACCEPTABLE. BE SURE TO USE A STAKE THAT IS LONG ENOUGH TO PROTRUDE SEVERAL INCHES ABOVE THE WATTLE.
  - EXCESS FABRIC SHALL BE WRAPPED AROUND THE STAKES.
  - FOR INLETS NOT ON A CURB THE COMPOST SOCK SHALL BE TIED OFF AT BOTH ENDS WITH THE WIRE AND OVERLAPPED TO PROVIDE SUITABLE PROTECTION.
- MAINTENANCE:** SEDIMENT ACCUMULATED BEHIND WATTLE SHALL BE REMOVED WHEN SEDIMENT HAS ACCUMULATED TO ONE-HALF THE DIAMETER OF THE SILT/COMPOST SOCK.

**1 COMPOST/SILT SOCK INLET PROTECTION DETAIL**  
SCALE: N.T.S.

DRAWN BY: EB  
 CHECKED BY: SM  
 DATE: 10/27/2023  
 PHASE: CD  
 DESCRIPTION OF REVISION:  
 ISSUED FOR BID  
 DATE: 12/10/2023  
 # 1

**HUNT ENGINEERS ARCHITECTS | SURVEYORS**  
 HORSEHEADS, NY 607-808-8000 ROCHESTER, NY 661-357-5760 TOWANDA, PA 570-265-4888  
 BINGHAMTON, NY 607-738-1581 ALBANY, NY 607-738-8881  
 WWW.HUNT-EAS.COM  
 NY CERTIFICATE NO. 0016220 PA CERTIFICATE NO. TSC2023131464-1

**SITE EROSION AND SEDIMENT CONTROL DETAILS**  
**2025 CAPITAL IMPROVEMENTS PROJECT**  
**HAMMONDSPORT CENTRAL SCHOOL DISTRICT**  
 8272 MAIN STREET, HAMMONDSPORT, NEW YORK, 14840  
 PROJECT NO: 1925.014

**MB-L6.1**  
 SED. NUMBER: MB-57-29-01-04-00-02-05, BG-57-29-01-04-5-002-008

GENERAL STRUCTURAL NOTES

A. BUILDING CODES AND STANDARDS

- THE FOLLOWING CODES AND STANDARDS, INCLUDING ALL SPECIFICATION REFERENCED WITHIN, SHALL APPLY TO THE DESIGN, CONSTRUCTION, QUALITY CONTROL AND SAFETY OF ALL WORK PERFORMED ON THE PROJECT.
  - "2020 BUILDING CODE OF NEW YORK STATE"
  - "MINIMUM DESIGN LOADS FOR BUILDING AND OTHER STRUCTURES", (ANSI/ASCE 7) AMERICAN SOCIETY OF CIVIL ENGINEERS.
- ADDITIONAL CODES FOR MATERIALS SHALL BE FOUND IN THE APPROPRIATE SECTIONS THAT FOLLOW. USE THOSE SECTIONS FOR THE APPLICABLE CODES.

B. DESIGN LOADS

1. GRAVITY - DEAD LOADS

AREA	PSF
EXISTING ROOF	SELF WEIGHT (V.I.F.)
NEW ROOF	25 PSF

AREA	PSF
SLAB ON-GRADE, TYPICAL U.N.O. CLASSROOMS	100 PSF
CORRIDOR	100 PSF
STAIRS AND EXITS	100 PSF

3. WIND LOADS

- BASIC WIND SPEED (V) = 117 MPH
- ALLOWABLE DESIGN WIND SPEED (V<sub>ASD</sub>) = 90 MPH
- OCCUPANCY RISK CATEGORY III
- WIND EXPOSURE CATEGORY B
- ENCLOSED BUILDING (GC<sub>pf</sub>) = ±0.18
- MODIFICATION FACTORS (K<sub>d</sub>)=1, (K<sub>e</sub>)= 1.0, (K<sub>f</sub>) = 0.85, (K<sub>g</sub>) = 1.0
- MAIN WIND-FORCE RESISTING SYSTEM LOADS (PSF)

WINDWARD (PER ZONE)		LEEWARD (PER ZONE)		OVERHANG (PER ZONE)	
INTERIOR	END	INTERIOR	END	END	CORNER
WALL: 4.6	ROOF: -18.1	WALL: 9.0	ROOF: -26.1	WALL: -9.8	ROOF: -11.5

EFFECTIVE AREA		INTERIOR ZONE		END ZONE	
10SF	+24.6	-26.7	+24.6	-32.9	
50SDF	+18.3	-20.4	+18.3	-20.4	

EFFECTIVE AREA		INTERIOR ZONE		END ZONE		CORNER ZONE	
10 SF	+10.0	-24.6	+10.0	-41.3	+10.0	-22.1	
100SF	+7.9	-22.5	+7.9	-26.7	+7.9	-26.7	

EFFECTIVE AREA		END ZONE		CORNER ZONE	
10 SF	+3.4	-38.4			
100 SF	-33.4	-16.7			

4. LATERAL LOADS: SEISMIC

- SEISMIC BASE SHEAR (V) = 1.5 KIPS
- OCCUPANCY RISK CATEGORY III
- IMPORTANCE FACTOR (I) = 1.25
- SITE CLASS D (ASSUMED)
- SEISMIC DESIGN CATEGORY A
- SPECTRAL RESPONSE ACCELERATION (S<sub>ds</sub>) = 0.12 (S<sub>d1</sub>) = 0.15 (S<sub>d2</sub>) = 0.057 (S<sub>1</sub>) = 0.04
- SEISMIC FORCE-RESISTING SYSTEM ORDINARY BRACED FRAMES
- RESPONSE MODIFICATION FACTOR (R)=3.25
- ANALYSIS PROCEDURE EQUIVALENT LATERAL FORCE

- FLOOD LOAD
  - AREA OUTSIDE 100 YEAR FLOOD AREA PER FEMA FLOOD INSURANCE MAP #3607750001C.
- ROOF RAIN LOAD DATA
  - RAIN INTENSITY (100 YEAR 60 MIN. DURATION) (I) = 2.61 IN/HR.

C. FOUNDATION/EARTHWORK/GEOTECHNICAL REPORT

1. DESIGN DATA

- NO GEOTECHNICAL INFORMATION HAS BEEN PROVIDED BY THE OWNER AT THIS TIME. FOUNDATIONS ARE DESIGNED BASED ON ASSUMED BEARING PRESSURES AND SHALL BE CONFIRMED BY A GEOTECHNICAL ENGINEER BEFORE PLACEMENT OF FOUNDATIONS.
- ALL EXTERIOR FOUNDATIONS SHALL BEAR A MINIMUM OF 4" 0" BELOW GRADE AND 1" 6" BELOW INTERIOR FINISHED FLOOR GRADE. IN CASE OF CONFLICT, NOTIFY THE ARCHITECT AND STRUCTURAL ENGINEER IN ADVANCE OF ANY CONSTRUCTION TO ALLOW FOR ADJUSTMENT.

- FOUNDATION SYSTEM
  - SPREAD FOOTINGS
    - BUILDING SPREAD AND STRIP FOOTINGS SHALL BEAR ON UNDISTURBED NATURAL SOILS OR PROPERLY PLACED AND COMPACTED ENGINEERED FILL WITH A MINIMUM ALLOWABLE BEARING PRESSURE OF 2000 PSF. BEARING PRESSURES SHALL BE VERIFIED BY AN EXPERIENCED QUALIFIED GEOTECHNICAL ENGINEER PRIOR TO PLACEMENT OF FOUNDATIONS.
    - NEW FOOTING BEARING ELEVATIONS ARE TO MATCH ADJACENT EXISTING FOOTING BEARING WHERE APPLICABLE UNLESS INDICATED OTHERWISE ON PLANS.

3. GENERAL

- SEE THE SPECIFICATIONS AND FOR EXCAVATION, DEWATERING AND PREPARATION OF THE FOUNDATION AND SLAB-ON-GRADE SUBGRADE, INCLUDING COMPACTION PROCEDURES, REQUIREMENTS CONTAINED IN THE GEOTECHNICAL REPORTS ARE PART OF THIS WORK.
- CONTRACTOR SHALL VERIFY ALL EXISTING FIELD CONDITIONS THAT MAY AFFECT THE INSTALLATION OF THE FOUNDATION SYSTEM AS SHOWN PRIOR TO STARTING WORK.
- THE CONTRACTOR SHALL BE RESPONSIBLE FOR LOCATION AND PROTECTING ALL EXISTING UTILITIES, EXISTING STRUCTURES, ETC., WHETHER INDICATED OR NOT, WHICH MAY BE AFFECTED BY THE CONSTRUCTION PROCESS.
- UTILITY LINES SHALL NOT BE PLACED THROUGH OR BELOW FOUNDATIONS WITHOUT THE STRUCTURAL ENGINEER'S APPROVAL.
- BEARING ELEVATIONS INDICATED ON THE DRAWINGS ARE ESTIMATED FROM SOIL BEARING AND EXISTING FOUNDATION ELEVATION DATA. PRIOR TO PLACING FOUNDATIONS, AN EXPERIENCED, QUALIFIED GEOTECHNICAL ENGINEER SHALL MAKE DETERMINATION OF FINAL BEARING ELEVATIONS AND VERIFICATION OF ALLOWABLE BEARING PRESSURE.
- CONCRETE FOR FOUNDATIONS SHALL BE POURED ON THE SAME DAY SUBGRADE APPROVAL IS GIVEN BY THE GEOTECHNICAL ENGINEER.
- THE SLOPE BETWEEN THE LOWER EDGES OF ADJACENT FOUNDATIONS SHALL NOT EXCEED 45 DEGREES WITH THE HORIZONTAL, UNLESS INDICATED OTHERWISE ON PLANS. MAINTAIN A 1:1 SLOPE FROM BOTTOM EDGE OF ANY EXCAVATION.

- FOLLOWING REQUIRED STRIPPING OPERATIONS, ANY PROOFROLLING SHALL BE AS DIRECTED BY AN EXPERIENCED, QUALIFIED GEOTECHNICAL ENGINEER. THE PURPOSE OF THE PROOFROLLING WILL BE TO LOCATE ANY ISOLATED AREAS OF SOFT OR LOOSE SOILS REQUIRING IMPROVEMENT OR REPLACEMENT. SOFT AREAS SHALL BE UNDERCUT AND REPLACED BY PROPERLY COMPACTED MATERIALS.

- ALL SHORING, SHEETING, AND DEWATERING SHALL BE THE TOTAL RESPONSIBILITY OF THE CONTRACTOR. THE CONTRACTOR'S ENGINEER REGISTERED IN THE PROJECT'S JURISDICTION SHALL DESIGN SHEETING AND SHORING. ALL SUBMITTALS SHALL BEAR THE ENGINEER'S SEAL AND SIGNATURE.

4. BACKFILL

- ALL BACKFILL SHALL BE ACCOMPLISHED USING MATERIAL APPROVED BY THE GEOTECHNICAL ENGINEER, WITH OPTIMUM MOISTURE CONTENT FOR COMPACTING AND SHALL BE FREE OF DEBRIS.
- NO BACKFILL MATERIAL SHALL BE PLACED AGAINST FOUNDATION WALLS UNTIL THE UPPER BRACING FLOORS ARE IN PLACE FOR AT LEAST 7 DAYS, OR ADEQUATE BRACING, AS DESIGNED BY THE CONTRACTOR'S ENGINEER, IS INSTALLED. THE CONTRACTOR'S ENGINEER REGISTERED IN THE PROJECT'S JURISDICTION SHALL DESIGN BRACING. ALL SUBMITTALS SHALL BEAR THE ENGINEER'S SEAL AND SIGNATURE.
- WHERE THE FINAL GRADE ELEVATIONS ARE APPROXIMATELY EQUAL ON BOTH SIDES OF A WALL, BACKFILL IN LIFTS TO MAINTAIN LEVEL ELEVATIONS WITHIN 10" ON BOTH SIDES AT ANY TIME.

5. STRUCTURAL FILL

- REFER TO SPECIFICATIONS FOR COMPACTED STRUCTURAL FILL. INSPECTION OF THE PLACEMENT OF COMPACTED STRUCTURAL FILL SHALL BE BY AN EXPERIENCED, QUALIFIED GEOTECHNICAL ENGINEER.
- APPROVED MATERIAL SHOULD BE PLACED IN 8" MINIMUM INDIVIDUAL MOISTURE CONDITIONED AS REQUIRED TO ACHIEVE COMPACTION TO A MINIMUM IN-PLACE DENSITY OF 95% MAX. IN ACCORDANCE WITH ASTM SPECIFICATION D-1557 (MODIFIED PROCTOR) FOR FILL BELOW FOOTINGS AND SLABS-ON-GRADE.

D. CONSTRUCTION

1. GENERAL

- UNAUTHORIZED REPRODUCTION OF ANY PORTION OF THE STRUCTURAL CONTRACT DRAWINGS FOR RESUBMITTAL AS SHOP DRAWINGS IS PROHIBITED. SHOP DRAWINGS PRODUCED IN SUCH A MANNER WILL BE REJECTED AND RETURNED.
- THESE DRAWINGS REPRESENT THE COMPLETED PROJECT WHICH HAS BEEN DESIGNED FOR THE WEIGHTS OF MATERIALS INDICATED ON THE DRAWINGS AND FOR THE SUPERIMPOSED LOADS INDICATED ON THE DRAWINGS AND FOR THE SUPERIMPOSED LOADS INDICATED IN THE DESIGN LOADS. IT IS THE CONTRACTOR'S RESPONSIBILITY TO DETERMINE ALLOWABLE CONSTRUCTION LOADS AND TO PROVIDE PROPER DESIGN AND CONSTRUCTION OF FALSE WORK, STAGINGS, BRACINGS, SHEETING AND SHORING, ETC. ALL SHORING CALCULATIONS AND DRAWINGS SHALL BE SIGNED AND SEALED BY AN ENGINEER REGISTERED IN THE PROJECT'S JURISDICTION.
- IN CASE OF CONFLICT BETWEEN THE GENERAL NOTES, DETAILS AND SPECIFICATIONS, THE MOST RIGID REQUIREMENTS SHALL GOVERN.
- IMPLEMENTING JOB SITE SAFETY AND CONSTRUCTION PROCEDURES ARE THE SOLE RESPONSIBILITY OF THE CONTRACTOR.
- ALL COSTS OF INVESTIGATION AND/OR REDESIGN DUE TO THE CONTRACTOR MIS LOCATION OF STRUCTURAL ELEMENTS OR OTHER LACK OF CONFORMANCE WITH THE PROJECT DOCUMENTS, SHALL BE AT THE CONTRACTOR'S EXPENSE.

- CONTRACTOR SHALL REFER TO ARCHITECTURAL, MECHANICAL, PLUMBING, ELECTRICAL AND OTHER APPLICABLE DRAWINGS FOR SIZE AND LOCATIONS OF OPENINGS, SLEEVES, CONCRETE HOUSEKEEPING PADS, INSERTS, AND DEPRESSIONS.
- SEE ARCHITECTURAL DRAWINGS AND SPECIFICATIONS FOR DETAILED INFORMATION REGARDING FINISHES, FIREPROOFING, WATERPROOFING, ETC.

- CONTRACTOR SHALL FURNISH DIMENSIONED SHOP DRAWINGS AT ALL LEVELS LOCATING FLOOR AND ROOF EDGES FOR REVIEW BY THE ARCHITECT AND STRUCTURAL ENGINEER.
- CONTRACTOR SHALL FURNISH DIMENSIONED SHOP DRAWINGS AT ALL LEVELS SHOWING THE LOCATIONS OF ALL SLEEVES AND OPENINGS REQUIRED BY ALL TRADES.
- THE CONTRACTOR SHALL SUBMIT, FOR REVIEW, DRAWINGS AND CALCULATIONS SIGNED AND SEALED BY A STRUCTURAL ENGINEER REGISTERED IN THE PROJECT'S JURISDICTION FOR THE FOLLOWING ASSEMBLIES. THIS REVIEW SHALL BE FOR GENERAL CONFORMANCE WITH THE PROJECT PARAMETERS AS INDICATED ON THE DRAWINGS AND IN THE GENERAL NOTES. THE DESIGN OF THESE ASSEMBLIES IS THE RESPONSIBILITY OF THE ENGINEER WHO HAS SIGNED AND SEALED THESE DRAWINGS AND CALCULATIONS. THE DESIGN OF THESE ASSEMBLIES SHALL TAKE INTO ACCOUNT ALL VERTICAL AND LATERAL LOADS REQUIRED BY APPLICABLE BUILDING CODES.

- STUD WALL MASONRY BACKUP AND RELATED CONNECTIONS: BACK UP SYSTEM WITH ATTACHED MASONRY SHALL BE DESIGNED FOR A MAXIMUM DEFLECTION OF 1/800 OF THE SPAN IN INCHES, OR 3/8", WHICHEVER IS LESS, AT THE APPLICABLE DESIGN WIND LOAD. THE SUBMITTED DRAWINGS AND CALCULATIONS SHALL CLEARLY SHOW THE LOAD REACTIONS AS APPLIED TO THE BUILDING STRUCTURE.
- CURTAIN WALL AND RELATED CONNECTIONS: CURTAIN WALL SYSTEM SHALL BE DESIGNED FOR A MAXIMUM DEFLECTION OF 1/180 OF THE SPAN, THE SUBMITTED DRAWINGS AND CALCULATIONS SHALL CLEARLY SHOW THE LOAD REACTIONS AS APPLIED TO THE BUILDING STRUCTURE.

- SHORING AND BRACING SYSTEMS FOR ALL EXISTING BUILDING SUPPORT DURING CONSTRUCTION. THE SUBMITTED DRAWINGS AND CALCULATIONS SHALL CLEARLY SHOW THE LOAD REACTIONS AS APPLIED TO THE BUILDING STRUCTURE.

- WORK NOT INCLUDED ON THE DRAWINGS BUT IMPLIED TO BE SIMILAR TO THAT SHOWN AT CORRESPONDING PLACES ELSEWHERE ON THE DRAWINGS SHALL BE REPEATED.

- EXISTING BUILDING INFORMATION SHOWN IS BASED ON EXISTING BUILDING DRAWINGS, FIELD OBSERVATIONS, AND/OR ARCHITECTURAL DRAWINGS. THE CONTRACTOR SHALL VERIFY ALL EXISTING BUILDING INFORMATION SHOWN (DIMENSIONS, ELEVATIONS, ETC.) AND NOTIFY THE ARCHITECT AND STRUCTURAL ENGINEERS OF ANY DISCREPANCIES. NEW SLABS ARE TO BE AT THE SAME ELEVATIONS AS ADJACENT EXISTING SLABS, UNLESS INDICATED OTHERWISE. FOUNDATION ELEVATIONS OR COLUMN LENGTHS SHALL BE ADJUSTED WITH THE APPROVAL OF THE STRUCTURAL ENGINEER TO ACHIEVE MATCHING SLAB ELEVATIONS.

- SEE ARCHITECTURAL DRAWINGS FOR LOCATIONS OF MASONRY AND DRYWALL, NON-LOADBEARING PARTITIONS, PROVIDE SLIP CONNECTIONS THAT ALLOW VERTICAL MOVEMENT AT THE HEADS OF ALL SUCH PARTITIONS. UNLESS SHOWN ON THE DRAWINGS, THE CONNECTIONS SHALL BE DESIGNED TO SUPPORT THE TOP OF THE WALLS LATERALLY FOR THE CODE REQUIRED LATERAL LOAD. PROVIDE COMPRESSIBLE FIRE SAFING AT THE TOP OF WALL AS REQUIRED BY ARCHITECTURAL DRAWINGS.

- REFER TO SPECIFICATIONS FOR COMPACTED STRUCTURAL FILL. INSPECTION OF THE PLACEMENT OF COMPACTED STRUCTURAL FILL SHALL BE BY AN EXPERIENCED, QUALIFIED GEOTECHNICAL ENGINEER.

- APPROVED MATERIAL SHOULD BE PLACED IN 8" MINIMUM INDIVIDUAL MOISTURE CONDITIONED AS REQUIRED TO ACHIEVE COMPACTION TO A MINIMUM IN-PLACE DENSITY OF 95% MAX. IN ACCORDANCE WITH ASTM SPECIFICATION D-1557 (MODIFIED PROCTOR) FOR FILL BELOW FOOTINGS AND SLABS-ON-GRADE.

E. CONCRETE

1. CODES

- "BUILDING CODE REQUIREMENTS FOR STRUCTURAL CONCRETE, ACI 318", AMERICAN CONCRETE INSTITUTE.
- "ACI MANUAL OF CONCRETE PRACTICE - PARTS 1 THROUGH 5".
- "MANUAL OF STANDARD PRACTICE", CONCRETE REINFORCING STEEL INSTITUTE.

2. MATERIALS

- THE FOLLOWING ASTM STANDARDS AND DESIGN STRESSES SHALL BE USED FOR THE APPROPRIATE MATERIALS USED IN THE CONSTRUCTION OF THIS PROJECT.

APPLICATION	f <sub>c</sub> (28 DAYS)	WEIGHT (PCF)	W/C (MAX)
SLABS-ON-GRADE (INTERIOR)	3500	145	0.50
SLABS-ON-GRADE (EXTERIOR)	4000	145	0.45
FOOTINGS	3000	145	0.55
COLUMNS	4000	145	0.50
WALLS	4000	145	0.50
FILL ON METAL DECK	3500	115	0.50

\*PUMP MIXES: MAXIMUM WATER/CEMENT RATIO MUST BE MAINTAINED. IF ADDITIONAL WORKABILITY IS REQUIRED FOR PUMPED PLACEMENT, THE HIGH OR MID-RANGE WATER REDUCERS SHALL BE USED IN LIEU OF ADDITIONAL WATER.

- CEMENT:
  - ASTM C150; TYPE I OR III
  - ASTM C150; TYPE II FOR CONCRETE IN CONTACT WITH EARTH.
- CEMENT SUBSTITUTES:
  - ASTM C595; TYPE IS (LIMIT TO 50% MAX OF CEMENTITIOUS CONTENT BY WEIGHT)

- AGGREGATES:
  - ASTM C33 (NORMAL WEIGHT)
  - ASTM C330 (STRUCTURAL LIGHTWEIGHT)
- AIR:
  - ASTM C260
  - CONCRETE EXPOSED TO WEATHER SHALL BE AIR-ENTRAINED (5%) (1-1 1/2%) BY VOLUME.

- REINFORCEMENT:
  - DEFORMED REINFORCING BARS WELDABLE DEFORMED REINFORCING BARS WELDED WIRE FABRIC (WWF) THREADBAR AND COUPLER
  - ASTM A615, GRADE 60
  - ASTM A706 OR APPROVED EQUAL
  - DYWIDAG MEETING ACI 318-12 14.3.4 SPLICES OR APPROVED EQUAL
- ANCHORING SYSTEM:
  - ADHESIVE REINFORCING EXPANSION BOLTS
  - HLTI HY-200 SYSTEM OR APPROVED EQUAL
  - HLTI KWIK BOLT TZ OR APPROVED EQUAL

3. CAST-IN-PLACE

- REINFORCING STEEL CLEAR COVER SHALL BE AS FOLLOWS UNLESS NOTED OTHERWISE:
  - NONPRESTRESSED/ NON-POST-TENSIONED CONCRETE:
    - CONCRETE CAST AGAINST AND PERMANENTLY EXPOSED TO EARTH OR CONCRETE EXPOSED TO WEATHER OR WEATHER:
      - #6 BARS AND LARGER 2"
      - #6 BARS AND SMALLER 1-1/2"
    - SLABS, WALLS AND JOISTS, #11 BARS AND SMALLER 3/4"
    - BEAMS, AND COLUMNS:
      - PRIMARY REINFORCEMENT, TIES, STIRRUPS, AND SPIRALS 1-1/2"

- NO SPLICES OF REINFORCEMENT SHALL BE PERMITTED EXCEPT AS DETAILED OR AUTHORIZED BY THE STRUCTURAL ENGINEER. MAKE BARS CONTINUOUS AROUND CORNERS, WHEN PERMITTED. SPLICES SHALL BE MADE BY CONTACT TENSION LAP SPLICES, UNLESS OTHERWISE NOTED.
- WELDED WIRE FABRIC REINFORCEMENT SHALL BE SUPPLIED IN SHEETS, EXCEPT FOR SLAB ON GRADE CONSTRUCTION WHERE ROLLS MAY BE LAP TWO FULL MESH LENGTHS AT SPLICES AND WIRE TOGETHER.
- NO WELDING OF REINFORCING SHALL BE PERMITTED UNLESS SPECIFICALLY CALLED FOR OR APPROVED BY THE STRUCTURAL ENGINEER.

- PROVIDE PLASTIC TIPPED BOLSTERS AND CHAIRS AT ALL LOCATIONS WHERE THE CONCRETE SURFACE IN CONTACT WITH THE BOLSTERS OR CHAIRS ARE EXPOSED.
- CONSTRUCTION JOINTS AND CONTROL JOINTS IN SLABS ON GRADE SHALL BE ARRANGED TO LIMIT MAXIMUM LENGTH BETWEEN JOINTS TO 15'-0" IN ANY DIRECTION, ALLOW A MINIMUM OF 48 HOURS TIME BETWEEN PLACEMENT OF ADJACENT SECTIONS.

- ALL FORMWORK, SHORING, AND RESHORING, SHALL BE DESIGNED BY THE CONTRACTOR'S ENGINEER REGISTERED IN THE PROJECT'S JURISDICTION. ALL SUBMISSIONS SHALL BEAR THE ENGINEER'S SEAL AND SIGNATURE.
- NO SLEEVES SHALL BE PLACED THROUGH ANY CONCRETE ELEMENT UNLESS SHOWN ON THE STRUCTURAL DRAWINGS. APPROVED SLEEVING SHOP DRAWINGS OR SPECIFICALLY AUTHORIZED IN WRITING BY THE STRUCTURAL ENGINEER.

- ALL INSERTS AND SLEEVES SHALL BE CAST-IN-PLACE WHENEVER FEASIBLE. DRILLED OR POWDER DRIVEN FASTENERS WILL BE PERMITTED WHEN PROVEN TO THE SATISFACTION OF THE STRUCTURAL ENGINEER THAT THE FASTENERS WILL NOT SPALL THE CONCRETE AND HAVE THE SAME CAPACITY AS CAST-IN-PLACE INSERTS.
- WHEN INSTALLING EXPANSION BOLTS OR ADHESIVE ANCHORS, THE CONTRACTOR SHALL TAKE MEASURES TO AVOID DRILLING OR CUTTING OF ANY EXISTING REINFORCING AND DESTRUCTION OF CONCRETE. HOLES SHALL BE BLOWN CLEAN PRIOR TO PLACING BOLTS OR ADHESIVE ANCHORS.

- CHAMFER ALL EXPOSED CONCRETE CORNERS, 3/4" x 3/4" MINIMUM, UNLESS NOTED OTHERWISE ON ARCHITECTURAL DRAWINGS.
- THE CONCRETE SLABS SHALL BE FINISHED, WITHIN TOLERANCE, TO THE ELEVATIONS INDICATED ON THE DRAWINGS.
- THE BEARING ELEVATION OF A THICKENED SLAB SHALL NOT SLOPE MORE THAN 1" FOR EVERY 2' OF HORIZONTAL DISTANCE UNLESS NOTED OTHERWISE.

- CONCRETE SLABS ON GRADE SHALL BE PLACED ON A MINIMUM 6" LAYER OF CLEAN, WELL-GRADED GRAVEL OR CRUSHED STONE CONFORMING TO THE SPECIFICATIONS OVER PROPERLY COMPACTED SUBGRADE. A VAPOR BARRIER SHALL BE PLACED ON TOP OF THE LAYER OF GRAVEL AT INTERIOR SLABS.
- CONCRETE SLABS THAT ARE PART OF THE ELEVATED FLOOR FRAMING SYSTEMS SHALL ACHIEVE 28-DAY DESIGN STRENGTH PRIOR TO THE APPLICATION OF ANY SUPERIMPOSED LOADS SUCH AS CURTAIN WALLS, MASONRY VENEERS

4. INSPECTION AND TESTING

- REFER TO SPECIFICATION SECTIONS 014000, 014533 AND 033000.

F. STRUCTURAL STEEL

1. CODES

- "AISC STEEL CONSTRUCTION MANUAL", FOURTEENTH EDITION, 2011, AMERICAN INSTITUTE OF STEEL CONSTRUCTION (INCLUDING SPECIFICATIONS FOR STRUCTURAL STEEL BUILDINGS, SPECIFICATION FOR STRUCTURAL JOINTS USING HIGH-STRENGTH BOLTS, AND AISC CODE OF STANDARD PRACTICE FOR STEEL BUILDINGS AND BRIDGES, WITH EXCEPTION, IF ANY, AS INDICATED IN THE SPECIFICATIONS).
- "MANUAL OF STEEL CONSTRUCTION, VOLUME I CONNECTIONS", ASD NINTH EDITION LRFD SECOND EDITION, AMERICAN INSTITUTE OF STEEL CONSTRUCTION.
- "DETAILING FOR STEEL CONSTRUCTION", AMERICAN INSTITUTE OF STEEL CONSTRUCTION.
- "STRUCTURAL WELDING CODE ANSII/AWS D1.1", AMERICAN WELDING SOCIETY.

2. MATERIALS

- ROLLED SHAPES: ASTM A992; F<sub>y</sub> = 50ksi
- CHANNELS, ANGLES AND PLATES: ASTM A588
- STRUCTURAL TUBING (RECTANGULAR HSS): ASTM A500, GRADE C, F<sub>y</sub> = 50 ksi
- STRUCTURAL TUBING (ROUND HSS): ASTM A500, GRADE C, F<sub>y</sub> = 50 ksi
- STRUCTURAL PIPE: ASTM A53, GRADE B, F<sub>y</sub> = 35 ksi
- WELDING ELECTRODES: AWS A5.1 OR A 5.5, E70XX
- HIGH STRENGTH BOLTS: ASTM F1554-08
- ANCHOR RODS: ASTM A1554 GRADE 36
- SMOOTH & THREADED ROD: ASTM A36
- BRACED FRAME TIE RODS: ASTM A308
- EXPANSION BOLTS: HELIX KWIK BOLT II OR APPROVED EQUAL
- ADHESIVE ANCHORING SYSTEM: HELIX HIT SYSTEM OR APPROVED EQUAL
- HEADED SHEAR STUDS: ASTM A108

3. GENERAL

- ALL SHOP AND FIELD CONNECTIONS SHALL BE MADE WITH HIGH STRENGTH BOLTS OR WELDS. ALL HIGH STRENGTH BOLT AND NUTS SHALL BE CLEARLY MARKED AS REQUIRED BY AISC SPECIFICATIONS. CONNECTIONS MADE WITH UNMARKED BOLTS AND NUTS WILL BE REJECTED.
- PROVIDE ACCESS FOR INSPECTION OF ALL SHOP AND FIELD CONNECTIONS FOR PROPER MATERIALS AND WORKMANSHIP.
- ALTERNATIVE CONNECTION DESIGNS SHALL ONLY BE ALLOWED WITH PRIOR APPROVAL OF THE STRUCTURAL ENGINEER. IF SUCH APPROVAL IS GRANTED ALL CONNECTIONS, SPLICES AND ERECTION PICES NOT IN ACCORDANCE WITH CONTRACT DRAWINGS (FABRICATOR REDESIGN) SHALL BE DESIGNED BY THE FABRICATOR'S ENGINEER REGISTERED IN THE PROJECT'S JURISDICTION. CALCULATIONS AND SHOP DRAWINGS SHALL BE SUBMITTED BEARING THE ENGINEER'S SEAL AND SIGNATURE.

- PRIOR TO STARTING FABRICATION, CERTIFIED COPIES OF MILL TEST REPORTS SHALL BE SUBMITTED TO THE STRUCTURAL ENGINEER.
- THE GENERAL CONTRACTOR SHALL NOTIFY THE STRUCTURAL ENGINEER OF ANY FABRICATION OR ERECTION ERRORS OR DEVIATIONS AND RECEIVE WRITTEN APPROVAL BEFORE ANY FIELD CORRECTIONS ARE MADE.

- CONNECTIONS SHALL BE SELECTED FOR REACTIONS AS SHOWN ON PLANS AND AS DETAILED AND SCHEDULED. REACTIONS ARE SHOWN AS FACTORED ASD LOADINGS. NO CONNECTION SHALL CONSIST OF LESS THAN (2) 3/4" DIAMETER F3125-N BOLTS OR WELDS DEVELOPING LESS THAN 10,000 POUNDS. MINIMUM WELD 3/16" FLEET.
- UNLESS OTHERWISE NOTED, ALL F3125 BOLTS SHALL BE TIGHTENED TO THE "SNUG TIGHT" CONDITION DEFINED AS THE TIGHTNESS ATTAINED BY A FEW IMPACTS OR AN IMPACT WRENCH OR THE FULL EFFORT OF A MAN USING AN ORDINARY SPUD WRENCH. THE SNUG TIGHT CONDITION MUST ENSURE THAT THE PILES OF THE CONNECTED MATERIAL HAVE BEEN BROUGHT INTO SNUG CONTACT.

- PERMANENT FRAMING AND FINAL CONNECTION DETAILS ARE SHOWN ON THE DRAWINGS. THE FABRICATOR AND ERECTOR ARE RESPONSIBLE FOR THE DESIGN OF TEMPORARY BRACING AND RECOMMENDED ERECTION PROCEDURES.
- WELDING ELECTRODES, WELDING PROCESS, MINIMUM PREHEAT AND INTERPASS TEMPERATURES SHALL BE IN ACCORDANCE WITH THE AISC AND AWS SPECIFICATIONS. ANY STRUCTURAL STEEL DAMAGED IN WELDING IS TO BE REPLACED OR ACCEPTABLY REINFORCED AS ACCEPTABLE TO THE STRUCTURAL ENGINEER.

- GAS CUTTING TORCHES SHALL NOT BE USED TO CORRECT FABRICATION ERRORS WITHOUT THE APPROVAL OF THE STRUCTURAL ENGINEER.
- ALL STEEL AT AND BELOW FINISHED GRADE OR FLOOR SLAB SHALL RECEIVE TWO (2) COATS OF BITUMINOUS PAINT - OR 3" MINIMUM CONCRETE COVER. ALL STRUCTURAL STEEL THAT IS LOCATED IN EXTERIOR UNHEATED SPACES, INCLUDING STEEL DIRECTLY EXPOSED TO WEATHER, SHALL BE SHOP GALVANIZED AND PRIMED. SEE "A" DRAWINGS FOR FINISH PAINTING.

- ALL STRUCTURAL STEEL THAT IS SUBJECT TO WETTING WITH SALT-LADEN WATER OR OTHER MILD CHEMICAL ATTACK SHALL BE COMMERCIAL BLAST CLEANED AND PAINTED WITH THREE COATS OF EPOXY PAINT IN ACCORDANCE WITH STEEL STRUCTURES PAINTING COUNCIL PAINTING SYSTEM SPECIFICATION NO. 13.01. A URETHANE TOPCOAT SHALL BE PROVIDED FOR ALL STEEL EXPOSED TO VIEW.
- ALL F3125 BOLTS SUBJECT TO DIRECT TENSION OR DESIGNED AS SC (SLIP CRITICAL) SHALL BE PRE-TENSIONED IN ACCORDANCE WITH ONE OF THE FOLLOWING METHODS AS DESCRIBED IN THE AISC "MANUAL OF STEEL CONSTRUCTION": TURN-OF-NUT TIGHTENING, CALIBRATED WRENCH TIGHTENING OR DIRECT TENSION INDICATOR TIGHTENING.

4. INSPECTION AND TESTING

- REFER TO SPECIFICATION SECTION 014000, 014533 AND 051200.

G. STEEL DECK

1. CODES

- SDI-NC1.0 "STANDARD FOR NONCOMPOSITE STEEL FLOOR DECK" - STEEL DECK INSTITUTE
- SDI-RD1.0 "STANDARD FOR STEEL ROOF DECK" - STEEL DECK INSTITUTE
- SDI-C "STANDARD FOR COMPOSITE STEEL FLOOR DECK SLABS" - STEEL DECK INSTITUTE
- ASIS 1100 "NORTH AMERICAN SPECIFICATION FOR THE DESIGN OF COLD-FORMED STEEL STRUCTURAL MEMBERS", AMERICAN IRON AND STEEL INSTITUTE.

2. MATERIALS

- GALVANIZED METAL FLOOR AND ROOF DECK: ASTM A653

3. GENERAL


- TYPICAL NON-ACOUSTIC ROOF DECK PROPERTIES ARE BASED ON PRODUCTS MANUFACTURED BY VULCRAFT™ AS NOTED. PROVIDE STEEL DECK WITH THE FOLLOWING MINIMUM SECTION PROPERTIES:
  - 1 1/2" DEEP, 20 GAGE TYPE B, WIDE RIB, ROOF DECK:
    - l<sub>p</sub> = 0.201 in<sup>4</sup>
    - S<sub>p</sub> = 0.234 in<sup>3</sup>
    - S<sub>x</sub> = 0.247 in<sup>3</sup>

- COMPOSITE FLOOR DECK PROPERTIES ARE BASED ON PRODUCTS MANUFACTURED BY VULCRAFT™. PROVIDE STEEL DECK WITH THE FOLLOWING MINIMUM PROPERTIES:
  - 2" DEEP, 20 GAGE, COMPOSITE FLOOR DECK (2VLI):
    - l<sub>p</sub> = 0.409 in<sup>4</sup>
    - S<sub>p</sub> = 0.341 in<sup>3</sup>
    - S<sub>x</sub> = 0.346 in<sup>3</sup>


- "DECKS BY OTHER MANUFACTURERS MAY BE SUPPLIED PROVIDED SECTION PROPERTIES ARE WITHIN 5%+ OF THOSE SPECIFIED AND IF APPROVED BY THE ARCHITECT AND STRUCTURAL ENGINEER.
- INSTALL IN ACCORDANCE WITH SDI SUGGESTED SPECIFICATIONS UNLESS NOTED OTHERWISE ON THE DRAWINGS. INDIVIDUAL SHEETS SHALL EXTEND OVER AT LEAST THREE SPANS, WITH LAPS TO BE PLACED OVER SUPPORTS.

- USE WELDING WASHERS FOR DECK MATERIAL, 22 GAGE AND LIGHTER AND WHERE RECOMMENDED BY THE DECK MANUFACTURER.
- EXCEPT WHERE NOTED ON PLANS, DECK SUPPLIER SHALL PROVIDE ALL ADDITIONAL FRAMING TO SUPPORT DECK AT OPENINGS THROUGH DECK AND ALL CLOSURE ANGLES AND PLATES WHERE REQUIRED TO RESULT IN A COMPLETE INSTALLATION.

- NON-ACOUSTIC ROOF AND NON-COMPOSITE DECKS SHALL BE WELDED TO STEEL SUPPORTS, INCLUDING THE EDGE SUPPORT PARALLEL TO THE DECK SPAN WITH 5/8" DIAMETER EFFECTIVE FUSION DIAMETER, PLUG WELDS, 3/4" OR 3/4" PATTERNS FASTEN SIDE LAPS WITH 1-1/2" SEAM WELDS OR #10 SELF-TAPPING SCREWS AT 18" O.C. MAXIMUM SPACING.
- COMPOSITE DECKS SHALL BE WELDED TO ALL SUPPORTS

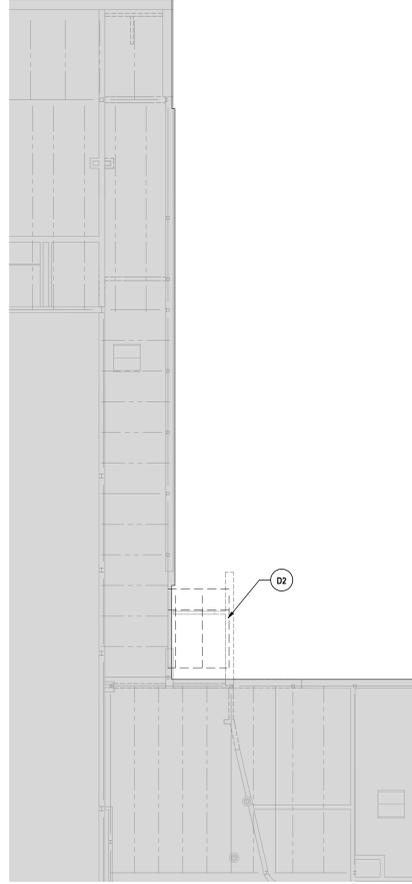

2 LOW ROOF FRAMING DEMO PLAN - AREA A  
1/8" = 1'-0"

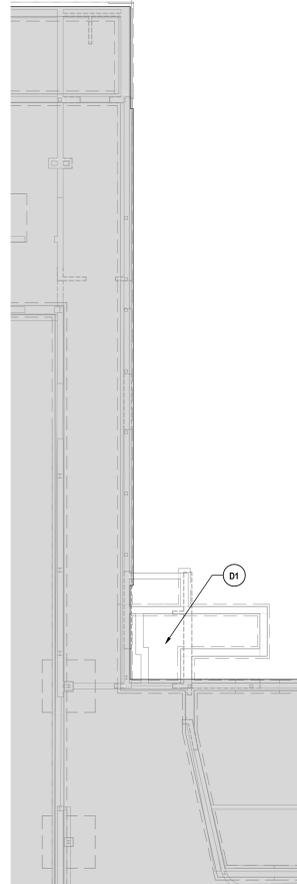


1 FOUNDATION DEMO PLAN AREA A  
1/8" = 1'-0"

**GENERAL NOTES**

- A MAINTAIN EXISTING STRUCTURAL SYSTEMS AT ALL TIMES, EXCEPT IN AREAS NOTED FOR DEMOLITION IN ITS ENTIRETY. PROVIDE TEMPORARY SHORING AND BRACING AT LOCATIONS WHERE THE EXISTING STRUCTURE IS BEING MODIFIED. MASONRY WALLS ARE BEING REMOVED OR OPENINGS ARE BEING PROVIDED IN MASONRY WALLS. PROTECT THE EXISTING STRUCTURE SCHEDULED TO REMAIN FROM DAMAGE DURING DEMOLITION. MAINTAIN SHORING AND BRACING UNTIL THE NEW STRUCTURE IS INSTALLED AND READY TO ACCEPT LOADS.
- B DIMENSIONS SHOWN FOR ALL NEW OPENINGS IN EXISTING CONSTRUCTION SHOULD BE COORDINATED WITH THE NEW PLANS AND EXISTING CONDITIONS IN THE FILED.
- C ITEMS SHOWN ARE INTENDED TO GIVE GENERAL DESCRIPTION. CONTRACTOR IS RESPONSIBLE FOR VERIFYING ACTUAL QUANTITIES LOCATION AND TYPE FOR THE EXISTING FIELD CONDITIONS, IN ORDER TO COMPLETE NEW WORK.

**# DEMOLITION NOTES**

- D1 DEMO EXISTING ELEVATED CONCRETE SLAB AND CUT FOUNDATION WALLS AS REQUIRED FOR NEW WORK.
- D2 DEMO EXISTING VESTIBULE STRUCTURE IN ITS ENTIRETY.

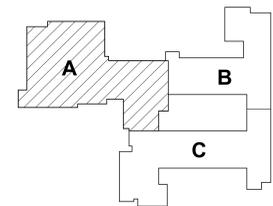

KEY PLAN

DEMO PLANS  
2025 CAPITAL IMPROVEMENTS PROJECT  
HAMMONDSPOORT CSD  
8272 MAIN STREET HAMMONDSPOORT, NEW YORK, 14840

**MB-S0.2**  
PROJECT NO: 1925-014

SET #: BG-5728-01-04-0-003-008, MR-5728-01-04-0-002-025


#	DATE:	DESCRIPTION OF REVISION:
1	10/27/2025	ISSUED FOR BID

DRAWN BY:	MKB
CHECKED BY:	BSS
DATE:	10/27/2025
PHASE:	CD

IT IS A VIOLATION OF THE LAW FOR ANY PERSON TO MAKE UNAUTHORIZED ALTERATIONS OR ADDITIONS TO PLANS DRAWN BY A LICENSED ENGINEER, ARCHITECT OR SURVEYOR.

**HUNT** ENGINEERS | ARCHITECTS | SURVEYORS  
HORSEHEADS, NY 807-265-1000    ROCHESTER, NY 585-237-7500    TOYAHVALLE, PA 570-265-4600  
BINGHAMTON, NY 607-798-8881    ALBANY, NY 607-798-8881  
WWW.HUNTEAS.COM  
NY CERTIFICATE NO. 0016250    PA CERTIFICATE NO. TSC22031464-1


Copyright 2025

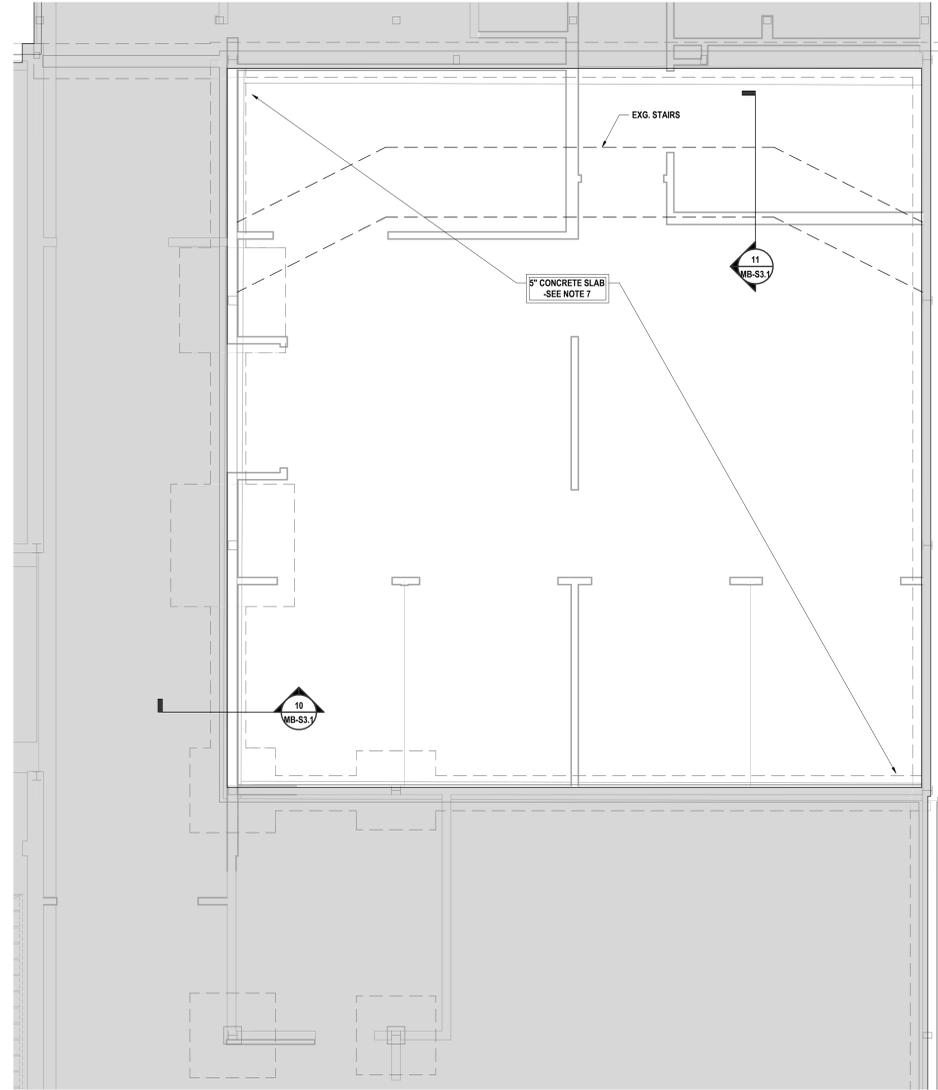

**2 PARTIAL FOUNDATION/FLOOR FRAMING PLAN - AREA B**  
1/8" = 1'-0"

**PLAN NOTES:**


- TOP OF SLAB EL. = 0'-0" UNLESS NOTED. FLOOR ELEVATION TO MATCH EXISTING FLOOR ELEVATION. THIS IS TO BE THE REFERENCE ELEVATION FOR THIS LEVEL. ALL ELEVATIONS INDICATED (4'-0") ARE TAKEN FROM THIS REFERENCE ELEVATION.
- SEE SHEET MB-S0.1 FOR GENERAL NOTES, INCLUDING COMPACTION REQUIREMENTS FOR FOUNDATIONS AND SLABS.
- SEE SHEET MB-S3.1 FOR TYPICAL DETAILS.
- COLUMN & FOOTING KEY:**
  - FOOTING MARK (SEE SCHEDULE ON SHEET MB-S2.1)
  - COLUMN
  - TOP OF FOOTING ELEVATION (IF DIFFERENT FROM TYPICAL) RELATIVE TO REFERENCE ELEVATION
  - TOP OF PIER ELEVATION
  - PIER MARK, (SEE SCHEDULE ON SHEET MB-S2.1)
- ALL PIERS, COLUMNS AND FOOTINGS SHALL BE CENTERED ON COLUMN LINES UNLESS NOTED.
- SEE "A" SERIES DRAWINGS FOR DIMENSIONS NOT SHOWN.
- 5" FIBER REINFORCED SLAB ON GRADE ADDITIONALLY REINFORCED WITH 6x6-W2.0xW2.0 WWF. PROVIDE SUPPORT CHAIRS TO HOLD WWF IN POSITION DURING CONCRETE PLACEMENT. PROVIDE AIR ENTRAINMENT AND 2% SLOPE AT EXTERIOR SLABS.
- AT SLABS PROVIDE CONSTRUCTION OR CONTROL JOINTS AT A SPACING NOT TO EXCEED 15'-0" UNLESS NOTED C.J. ON PLANS. FOR ADDITIONAL INFORMATION SEE TYPICAL DETAILS.
- PROVIDE (2) #5x4'-0" MID-DEPTH OF SLAB AT ALL INTERIOR CORNERS.

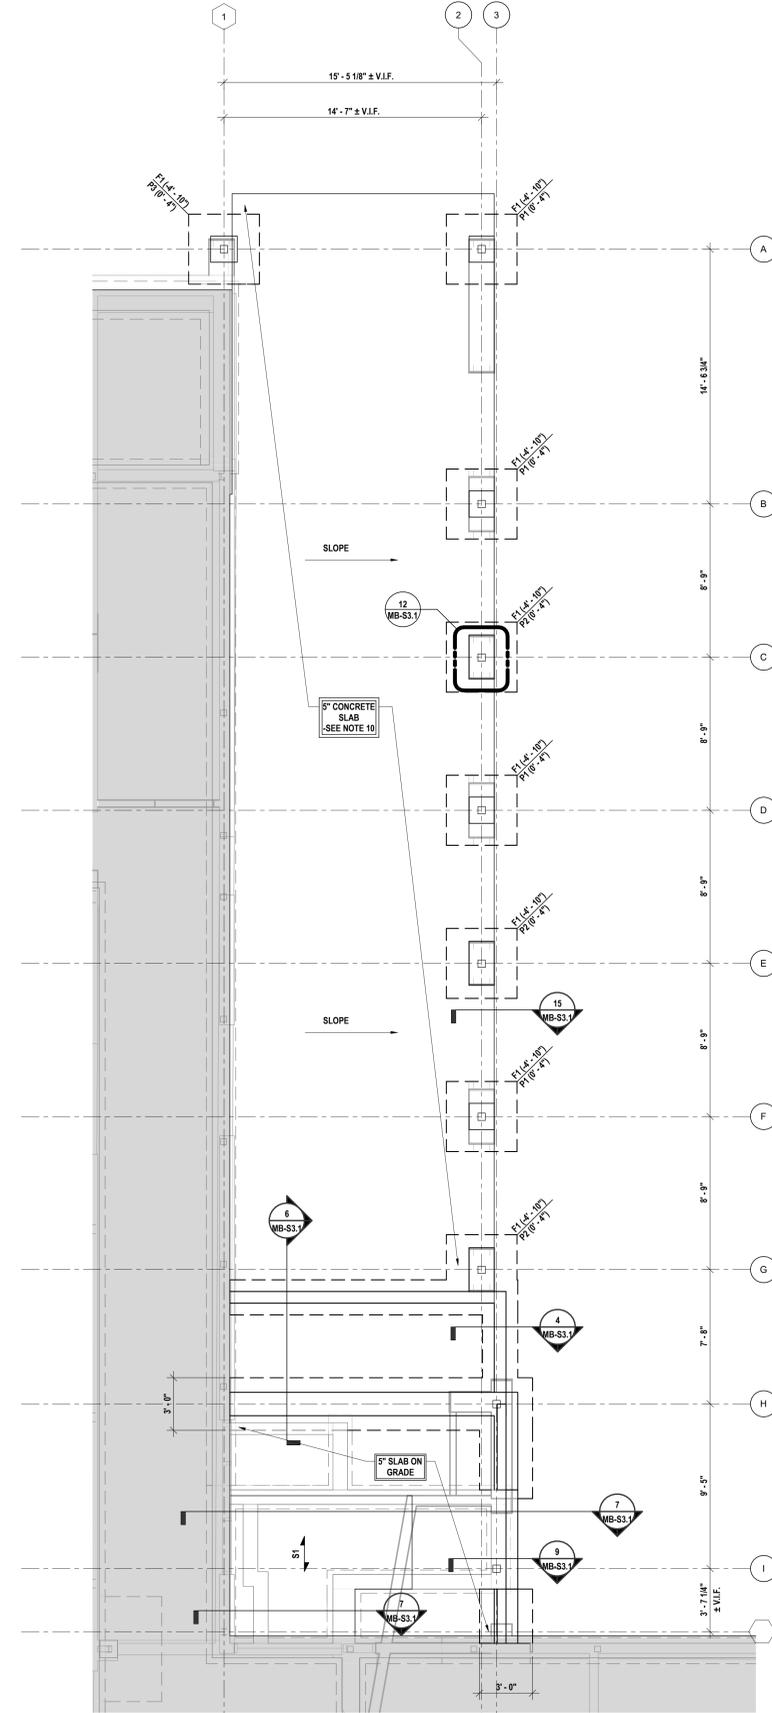

**1 PARTIAL FOUNDATION PLAN - AREA A**  
1/4" = 1'-0"

**PLAN NOTES:**

- TOP OF SLAB EL. = 1'-4" ± V.I.F. UNLESS NOTED. FLOOR ELEVATION TO MATCH EXISTING FLOOR ELEVATION. THIS IS TO BE THE REFERENCE ELEVATION FOR THIS LEVEL. ALL ELEVATIONS INDICATED (4'-0") ARE TAKEN FROM THIS REFERENCE ELEVATION.
- SEE SHEET MB-S0.1 FOR GENERAL NOTES, INCLUDING COMPACTION REQUIREMENTS FOR FOUNDATIONS AND SLABS.
- SEE SHEET MB-S3.1 FOR TYPICAL DETAILS.
- COLUMN & FOOTING KEY:**
  - FOOTING MARK (SEE SCHEDULE ON SHEET MB-S2.1)
  - COLUMN
  - TOP OF FOOTING ELEVATION (IF DIFFERENT FROM TYPICAL) RELATIVE TO REFERENCE ELEVATION
  - TOP OF PIER ELEVATION
  - PIER MARK, (SEE SCHEDULE ON SHEET MB-S2.1)
- SEE SHEET MB-S2.1 FOR COLUMN AND BASE PLATE SCHEDULES AND DETAILS.
- ALL PIERS, COLUMNS AND FOOTINGS SHALL BE CENTERED ON COLUMN LINES UNLESS NOTED.
- TOP OF INTERIOR FOOTING ELEVATION = (-1'-0") UNLESS NOTED.
- TOP OF EXTERIOR FOOTING ELEVATION = (-3'-0") UNLESS NOTED. TOP OF WALL FOOTING ELEVATION TO MATCH ADJACENT COLUMN FOOTING. STEP FOOTING AS REQUIRED PER THE TYPICAL DETAILS.
- SEE "A" SERIES DRAWINGS FOR DIMENSIONS NOT SHOWN.
- 5" FIBER REINFORCED SLAB ON GRADE ADDITIONALLY REINFORCED WITH 6x6-W2.0xW2.0 WWF. PROVIDE SUPPORT CHAIRS TO HOLD WWF IN POSITION DURING CONCRETE PLACEMENT. PROVIDE AIR ENTRAINMENT AND 2% SLOPE AT EXTERIOR SLABS.
- AT SLABS PROVIDE CONSTRUCTION OR CONTROL JOINTS AT A SPACING NOT TO EXCEED 15'-0" UNLESS NOTED C.J. ON PLANS. FOR ADDITIONAL INFORMATION SEE TYPICAL DETAILS.
- PROVIDE (2) #5x4'-0" MID-DEPTH OF SLAB AT ALL INTERIOR CORNERS.
- SLOPE SLABS AS REQUIRED FOR DRAINAGE (MIN 1/8" PER FOOT). SEE "A & P" SERIES DRAWINGS.
- FLOOR TRENCHING IS ANTICIPATED IN THIS AREA, COORDINATE WITH "A & P" SERIES DRAWINGS. PROVIDE SLAB REPAIR PER THE TYPICAL DETAILS.
- ALL SLEEVES FOR OTHER TRADES SHALL CROSS THROUGH THE FOUNDATION WALL. STEP FOOTING AS REQUIRED. COORDINATE SIZE, LOCATION AND INVERT WITH "L" SERIES DRAWINGS AND OTHER CONTRACTED WORK.
- S-1 = 5 1/2" NORMAL WEIGHT CONCRETE OVER 2" DEEP 20 GAGE COMPOSITE FLOOR DECK (TOTAL THICKNESS = 5 1/2") ADDITIONALLY REINFORCED WITH 6x6-W2.0xW2.0 WWF. ELEVATED SLAB AND SLAB ON GRADE ARE TO BE PLACED IN THE SAME POUR.

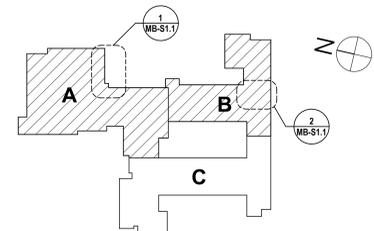


KEY PLAN

DRAWN BY:	MKB
CHECKED BY:	BSS
DATE:	10/27/2025
PHASE:	CD

**HUNT ENGINEERS ARCHITECTS | SURVEYORS**  
 HORSEHEADS, NY 607-563-1000    ROCKY HILLS, NY 562-837-7668    TOYAHVALLEY, PA 470-265-4668  
 BINGHAMTON, NY 607-798-8881    ALBANY, NY 607-798-8881    WWW.HUNTHEAS.COM  
 NY CERTIFICATE NO. 0016250    PA CERTIFICATE NO. TSC22020313464-1


**FOUNDATION PLAN - AREAS A & B**  
**2025 CAPITAL IMPROVEMENTS PROJECT**  
**HAMMONDSPOORT CSD**  
 8272 MAIN STREET HAMMONDSPOORT, NEW YORK, 14840  
**MB-S1.1**  
 PROJECT NO: 1925-014

SED #: BG-5728-01-04-6-002-008; MR-5728-01-04-6-002-025

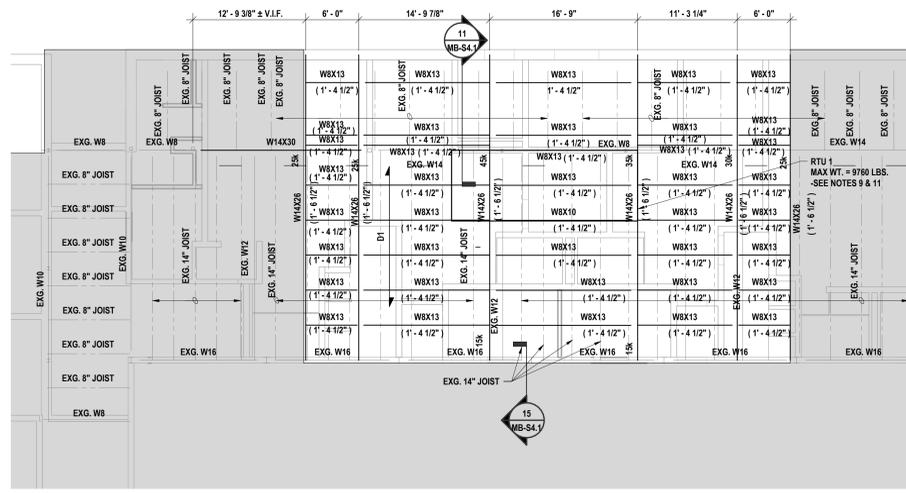


2 LOW ROOF PLAN - ALTERNATE #1  
1/8\"/>

- PLAN NOTES:
- TOP OF ROOF STEEL = 8'-0" ± V.I.F., UNLESS NOTED. THIS IS TO BE THE REFERENCE ELEVATION FOR THIS LEVEL. ALL ELEVATIONS INDICATED (8'-0") ARE TAKEN FROM THIS REFERENCE ELEVATION.
  - SEE MB-S4.1 FOR GENERAL NOTES.
  - SEE MB-S4.1 FOR TYPICAL DETAILS.
  - STRUCTURAL STEEL FRAMING KEY.

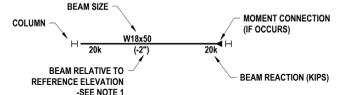


- D1 = TYPE B, WIDE RIB, 1 1/2" DEEP, 20 GAUGE GALVANIZED ROOF DECK.
- SEE MB-S4.1 FOR TYPICAL LINTEL (L-4) SCHEDULE AND LOOSE LINTEL SCHEDULE.
- TOP OF STEEL ELEVATION OF BEAMS PARALLEL TO JOISTS IS TO MATCH SLOPE OF JOIST BETWEEN SUPPORTING GIRDERS AT EACH END UNLESS NOTED.
- ALL JOISTS ARE SPACED EVENLY BETWEEN COLUMN LINES UNLESS NOTED.
- COORDINATE SIZE AND LOCATION OF ALL OPENINGS, WELLS, AND SLEEVES WITH OTHER CONTRACTED WORK. PROVIDE SUPPORTS AT CURBS AND OPENINGS PER THE TYPICAL DETAILS.
- MAINTAIN EXISTING STRUCTURAL SYSTEMS AT ALL TIMES, EXCEPT IN AREAS NOTED FOR DEMOLITION IN ITS ENTIRETY. PROVIDE TEMPORARY SHORING AND BRACING AT LOCATIONS WHERE THE EXISTING STRUCTURE IS BEING MODIFIED. PROTECT THE EXISTING STRUCTURE SCHEDULED TO REMAIN FROM DAMAGE DURING DEMOLITION. MAINTAIN SHORING AND BRACING UNTIL THE NEW STRUCTURE IS INSTALLED AND READY TO ACCEPT LOADS. SUPPORT EXISTING WALLS WHERE THE WALL SYSTEMS ARE BEING PARTIALLY REMOVED OR OPENINGS ARE BEING PROVIDED UNTIL THE LINTELS ARE IN PLACE.
- MECHANICAL ROOF TOP UNITS SHOWN INDICATE MAXIMUM UNIT WEIGHT. ACTUAL UNIT SUPPLIED MAY VARY IN SIZE AND WEIGHT FROM THE DESIGN. COORDINATE SIZE AND LOCATION WITH OTHER CONTRACTED WORK AND CONTACT ENGINEER OF RECORD IF THE SUPPLIED UNIT WEIGHT IS GREATER THAN SHOWN.

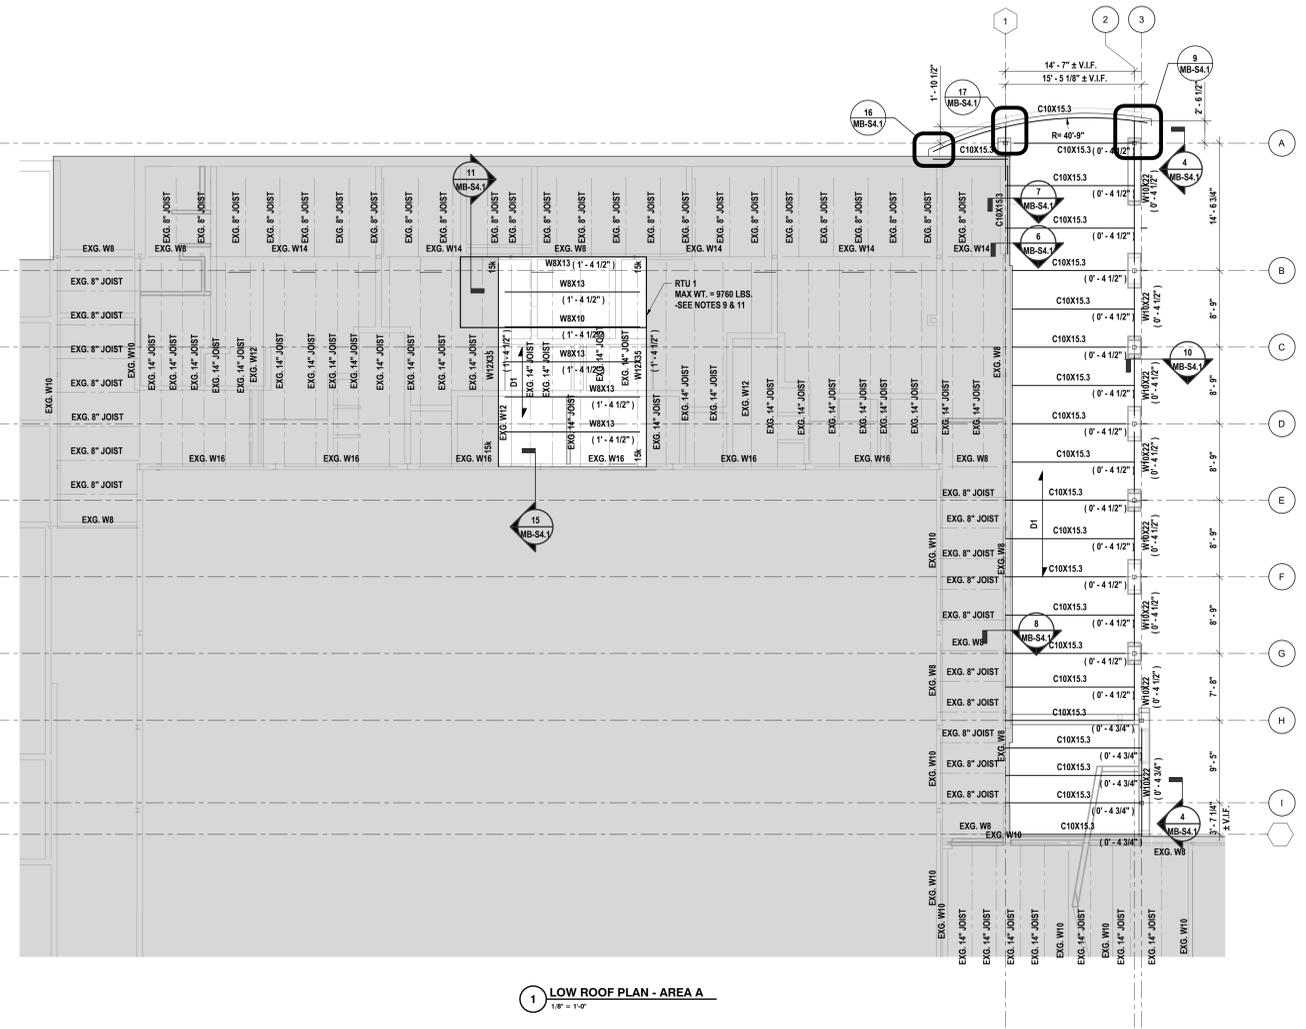


1 LOW ROOF PLAN - AREA A  
1/8\"/>

- PLAN NOTES:
- TOP OF ROOF STEEL = 8'-0" ± V.I.F., UNLESS NOTED. THIS IS TO BE THE REFERENCE ELEVATION FOR THIS LEVEL. ALL ELEVATIONS INDICATED (8'-0") ARE TAKEN FROM THIS REFERENCE ELEVATION.
  - SEE MB-S4.1 FOR GENERAL NOTES.
  - SEE MB-S4.1 FOR TYPICAL DETAILS.
  - STRUCTURAL STEEL FRAMING KEY.

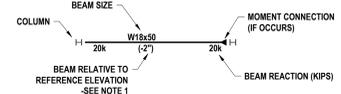

- D1 = TYPE B, WIDE RIB, 1 1/2" DEEP, 20 GAUGE GALVANIZED ROOF DECK.
- SEE MB-S4.1 FOR TYPICAL LINTEL (L-4) SCHEDULE AND LOOSE LINTEL SCHEDULE.
- TOP OF STEEL ELEVATION OF BEAMS PARALLEL TO JOISTS IS TO MATCH SLOPE OF JOIST BETWEEN SUPPORTING GIRDERS AT EACH END UNLESS NOTED.
- ALL JOISTS ARE SPACED EVENLY BETWEEN COLUMN LINES UNLESS NOTED.
- COORDINATE SIZE AND LOCATION OF ALL OPENINGS, INFILLS, AND SLEEVES WITH OTHER CONTRACTED WORK. PROVIDE SUPPORTS AT CURBS AND OPENINGS PER THE TYPICAL DETAILS.
- MAINTAIN EXISTING STRUCTURAL SYSTEMS AT ALL TIMES, EXCEPT IN AREAS NOTED FOR DEMOLITION IN ITS ENTIRETY. PROVIDE TEMPORARY SHORING AND BRACING AT LOCATIONS WHERE THE EXISTING STRUCTURE IS BEING MODIFIED. PROTECT THE EXISTING STRUCTURE SCHEDULED TO REMAIN FROM DAMAGE DURING DEMOLITION. MAINTAIN SHORING AND BRACING UNTIL THE NEW STRUCTURE IS INSTALLED AND READY TO ACCEPT LOADS. SUPPORT EXISTING WALLS WHERE THE WALL SYSTEMS ARE BEING PARTIALLY REMOVED OR OPENINGS ARE BEING PROVIDED UNTIL THE LINTELS ARE IN PLACE.
- MECHANICAL ROOF TOP UNITS SHOWN INDICATE MAXIMUM UNIT WEIGHT. ACTUAL UNIT SUPPLIED MAY VARY IN SIZE AND WEIGHT FROM THE DESIGN. COORDINATE SIZE AND LOCATION WITH OTHER CONTRACTED WORK AND CONTACT ENGINEER OF RECORD IF THE SUPPLIED UNIT WEIGHT IS GREATER THAN SHOWN.

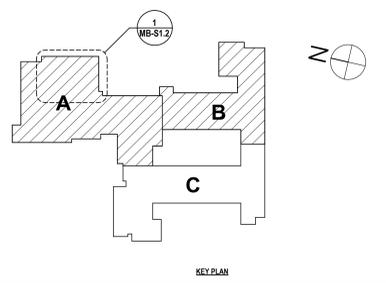

DATE:	10/27/2025	DRAWN BY:	MKB
PHASE:	CD	CHECKED BY:	BSS
DESCRIPTION OF REVISION:		ISSUED FOR BID	


**HUNT ENGINEERS ARCHITECTS | SURVEYORS**  
 HORSEHEADS, NY 10763-0008    ROCKY HILLS, CT 06067    TOWANDA, PA 17796-2051-6608  
 BANGHAMTON, NY 13902-7988-8881    ALBANY, NY 12242-7988-8881  
 WWW.HUNTEAS.COM    WWW.HUNTEAS.COM

NY CERTIFICATE NO. 0016250    PA CERTIFICATE NO. TSC220313464-1

**LOW ROOF FRAMING PLAN - AREA A**  
**2025 CAPITAL IMPROVEMENTS PROJECT**  
**HAMMONDSPORT CSD**  
 8272 MAIN STREET HAMMONDSPORT, NEW YORK, 14840

**MB-S1.2**  
 PROJECT NO: 1925-014


SED #: BG-5728-01-04-0-003-008, MR-5728-01-04-0-002-025

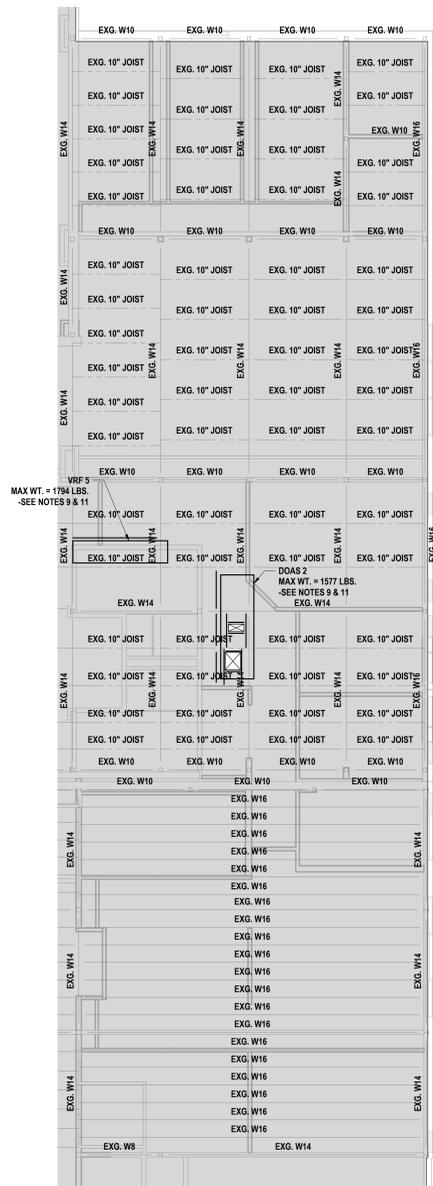


2 LOW ROOF/SECOND FLOOR FRAMING PLAN - AREA B  
1/8" = 1'-0"

PLAN NOTES:

- TOP OF EXISTING ROOF STEEL = 10'-6", UNLESS NOTED, THIS IS TO BE THE REFERENCE ELEVATION FOR THIS LEVEL. ALL ELEVATIONS INDICATED (±0'-0") ARE TAKEN FROM THIS REFERENCE ELEVATION.
- SEE MB-S1.1 FOR GENERAL NOTES.
- SEE MB-S4.1 FOR TYPICAL DETAILS.
- STRUCTURAL STEEL FRAMING KEY.

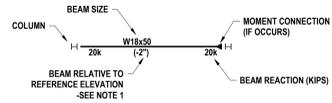


- D1+ TYPE B, WIDE RIB, 1 1/2" DEEP, 20 GAGE GALVANIZED ROOF DECK.
- SEE MB-S4.1 FOR TYPICAL LINTEL (L-4) SCHEDULE AND LOOSE LINTEL SCHEDULE.
- TOP OF STEEL ELEVATION OF BEAMS PARALLEL TO JOISTS IS TO MATCH SLOPE OF JOIST BETWEEN SUPPORTING GIRDERS AT EACH END UNLESS NOTED.
- ALL JOISTS ARE SPACED EVENLY BETWEEN COLUMN LINES UNLESS NOTED.
- COORDINATE SIZE AND LOCATION OF ALL OPENINGS, INFILLS, AND SLEEVES WITH OTHER CONTRACTED WORK. PROVIDE SUPPORTS AT CURBS AND OPENINGS PER THE TYPICAL DETAILS.
- MAINTAIN EXISTING STRUCTURAL SYSTEMS AT ALL TIMES, EXCEPT IN AREAS NOTED FOR DEMOLITION IN ITS ENTIRETY. PROVIDE TEMPORARY SHORING AND BRACING AT LOCATIONS WHERE THE EXISTING STRUCTURE IS BEING MODIFIED. PROTECT THE EXISTING STRUCTURE SCHEDULED TO REMAIN FROM DAMAGE DURING DEMOLITION. MAINTAIN SHORING AND BRACING UNTIL THE NEW STRUCTURE IS INSTALLED AND READY TO ACCEPT LOADS. SUPPORT EXISTING WALLS WHERE THE WALL SYSTEMS ARE BEING PARTIALLY REMOVED OR OPENINGS ARE BEING PROVIDED UNTIL THE LINTELS ARE IN PLACE.
- MECHANICAL ROOF TOP UNITS SHOWN INDICATE MAXIMUM UNIT WEIGHT. ACTUAL UNIT SUPPLIED MAY VARY IN SIZE AND WEIGHT FROM THE DESIGN. COORDINATE SIZE AND LOCATION WITH OTHER CONTRACTED WORK AND CONTACT ENGINEER OF RECORD IF THE SUPPLIED UNIT WEIGHT IS GREATER THAN SHOWN.

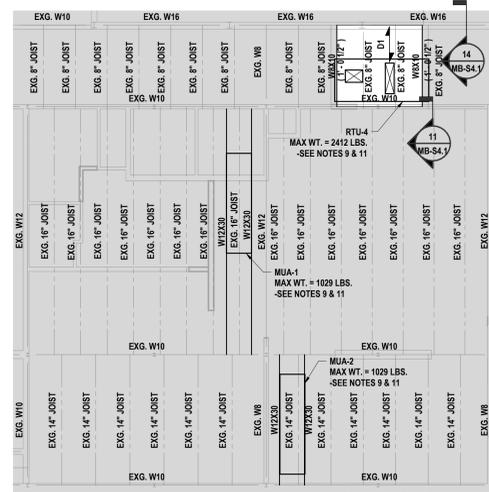


1 PARTIAL LOW ROOF FRAMING PLAN - AREA A  
1/8" = 1'-0"

PLAN NOTES:

- TOP OF EXISTING ROOF STEEL = 10'-6" ± V.I.F., UNLESS NOTED, THIS IS TO BE THE REFERENCE ELEVATION FOR THIS LEVEL. ALL ELEVATIONS INDICATED (±0'-0") ARE TAKEN FROM THIS REFERENCE ELEVATION.
- SEE MB-S4.1 FOR GENERAL NOTES.
- SEE MB-S4.1 FOR TYPICAL DETAILS.
- STRUCTURAL STEEL FRAMING KEY.

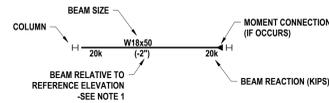

- D1+ TYPE B, WIDE RIB, 1 1/2" DEEP, 20 GAGE GALVANIZED ROOF DECK.
- SEE MB-S4.1 FOR TYPICAL LINTEL (L-4) SCHEDULE AND LOOSE LINTEL SCHEDULE.
- TOP OF STEEL ELEVATION OF BEAMS PARALLEL TO JOISTS IS TO MATCH SLOPE OF JOIST BETWEEN SUPPORTING GIRDERS AT EACH END UNLESS NOTED.
- ALL JOISTS ARE SPACED EVENLY BETWEEN COLUMN LINES UNLESS NOTED.
- COORDINATE SIZE AND LOCATION OF ALL OPENINGS, INFILLS, AND SLEEVES WITH OTHER CONTRACTED WORK. PROVIDE SUPPORTS AT CURBS AND OPENINGS PER THE TYPICAL DETAILS.
- MAINTAIN EXISTING STRUCTURAL SYSTEMS AT ALL TIMES, EXCEPT IN AREAS NOTED FOR DEMOLITION IN ITS ENTIRETY. PROVIDE TEMPORARY SHORING AND BRACING AT LOCATIONS WHERE THE EXISTING STRUCTURE IS BEING MODIFIED. PROTECT THE EXISTING STRUCTURE SCHEDULED TO REMAIN FROM DAMAGE DURING DEMOLITION. MAINTAIN SHORING AND BRACING UNTIL THE NEW STRUCTURE IS INSTALLED AND READY TO ACCEPT LOADS. SUPPORT EXISTING WALLS WHERE THE WALL SYSTEMS ARE BEING PARTIALLY REMOVED OR OPENINGS ARE BEING PROVIDED UNTIL THE LINTELS ARE IN PLACE.
- MECHANICAL ROOF TOP UNITS SHOWN INDICATE MAXIMUM UNIT WEIGHT. ACTUAL UNIT SUPPLIED MAY VARY IN SIZE AND WEIGHT FROM THE DESIGN. COORDINATE SIZE AND LOCATION WITH OTHER CONTRACTED WORK AND CONTACT ENGINEER OF RECORD IF THE SUPPLIED UNIT WEIGHT IS GREATER THAN SHOWN.

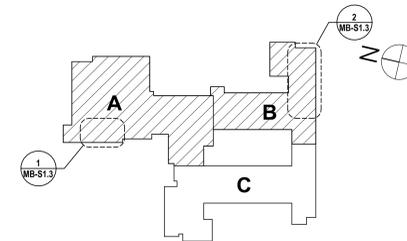

KEY PLAN

SED #: BG-5728-01-04-000-008, MR-5728-01-04-002-025

LOW ROOF FRAMING PLAN - AREAS A & B  
2025 CAPITAL IMPROVEMENTS PROJECT  
HAMMONDSPOORT CSD  
8272 MAIN STREET HAMMONDSPOORT, NEW YORK, 14840


PROJECT NO: 1925-014

MB-S1.3

#	DATE	DESCRIPTION OF REVISION
1	10/27/2025	ISSUED FOR BID


DRAWN BY: MKB  
CHECKED BY: BSS  
DATE: 10/27/2025  
PHASE: CD

Copyright 2025  
HUNT ENGINEERS ARCHITECTS | SURVEYORS  
HORSEHEADS, NY 607-456-1058  
ROCKY HILLS, CT 860-337-7568  
BINGHAMTON, NY 607-738-8881  
ALBANY, NY 607-738-8881  
WWW.HUNTEAS.COM  
NY CERTIFICATE NO. 0016250 PA CERTIFICATE NO. TSC220313464-1

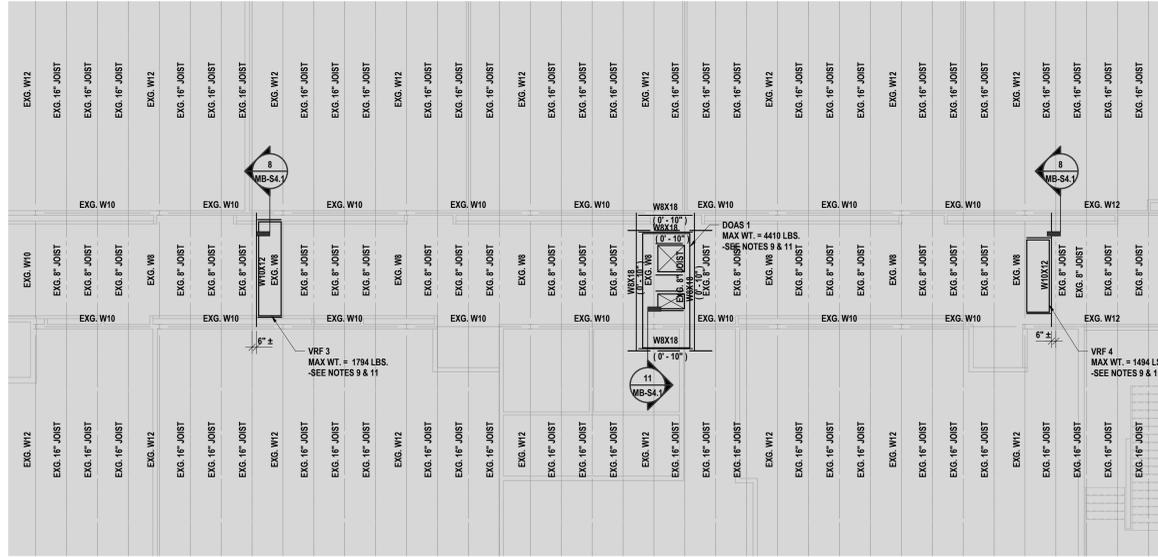


**2 PARTIAL HIGH ROOF FRAMING PLAN - AREA B**  
3/8" = 1'-0"

- PLAN NOTES:**
1. TOP OF EXISTING ROOF STEEL = 21'-1" ± V.L.F., UNLESS NOTED. THIS IS TO BE THE REFERENCE ELEVATION FOR THIS LEVEL. ALL ELEVATIONS INDICATED (±0'-0") ARE TAKEN FROM THIS REFERENCE ELEVATION.
  2. SEE MB-S0.1 FOR GENERAL NOTES.
  3. SEE MB-S4.1 FOR TYPICAL DETAILS.
  4. STRUCTURAL STEEL FRAMING KEY:

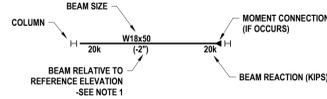


5. D1+ TYPE B, WIDE RIB, 1 1/2" DEEP, 20 GAGE GALVANIZED ROOF DECK.
6. SEE MB-S4.1 FOR TYPICAL LINTEL (L-4) SCHEDULE AND LOOSE LINTEL SCHEDULE.
7. TOP OF STEEL ELEVATION OF BEAMS PARALLEL TO JOISTS IS TO MATCH SLOPE OF JOIST BETWEEN SUPPORTING GIRDERS AT EACH END UNLESS NOTED.
8. ALL JOISTS ARE SPACED EVENLY BETWEEN COLUMN LINES UNLESS NOTED.
9. COORDINATE SIZE AND LOCATION OF ALL OPENINGS, INFILLS, AND SLEEVES WITH OTHER CONTRACTED WORK. PROVIDE SUPPORTS AT CURBS AND OPENINGS PER THE TYPICAL DETAILS.
10. MAINTAIN EXISTING STRUCTURAL SYSTEMS AT ALL TIMES, EXCEPT IN AREAS NOTED FOR DEMOLITION IN ITS ENTIRETY. PROVIDE TEMPORARY SHORING AND BRACING AT LOCATIONS WHERE THE EXISTING STRUCTURE IS BEING MODIFIED. PROTECT THE EXISTING STRUCTURE SCHEDULED TO REMAIN FROM DAMAGE DURING DEMOLITION. MAINTAIN SHORING AND BRACING UNTIL THE NEW STRUCTURE IS INSTALLED AND READY TO ACCEPT LOADS. SUPPORT EXISTING WALLS WHERE THE WALL SYSTEMS ARE BEING PARTIALLY REMOVED OR OPENINGS ARE BEING PROVIDED UNTIL THE LINTELS ARE IN PLACE.
11. MECHANICAL ROOF TOP UNITS SHOWN INDICATE MAXIMUM UNIT WEIGHT. ACTUAL UNIT SUPPLIED MAY VARY IN SIZE AND WEIGHT FROM THE DESIGN. COORDINATE SIZE AND LOCATION WITH OTHER CONTRACTED WORK AND CONTACT ENGINEER OF RECORD IF THE SUPPLIED UNIT WEIGHT IS GREATER THAN SHOWN.

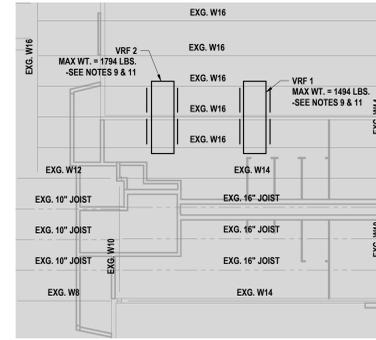


**1 PARTIAL HIGH ROOF FRAMING PLAN - AREA B**  
3/8" = 1'-0"

- PLAN NOTES:**
1. TOP OF EXG. ROOF STEEL = 21'-4" ± V.L.F., UNLESS NOTED. THIS IS TO BE THE REFERENCE ELEVATION FOR THIS LEVEL. ALL ELEVATIONS INDICATED (±0'-0") ARE TAKEN FROM THIS REFERENCE ELEVATION.
  2. SEE MB-S0.1 FOR GENERAL NOTES.
  3. SEE MB-S4.1 FOR TYPICAL DETAILS.
  4. STRUCTURAL STEEL FRAMING KEY:

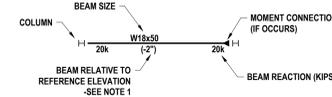

5. D1+ TYPE B, WIDE RIB, 1 1/2" DEEP, 20 GAGE GALVANIZED ROOF DECK.
6. SEE MB-S4.1 FOR TYPICAL LINTEL (L-4) SCHEDULE AND LOOSE LINTEL SCHEDULE.
7. TOP OF STEEL ELEVATION OF BEAMS PARALLEL TO JOISTS IS TO MATCH SLOPE OF JOIST BETWEEN SUPPORTING GIRDERS AT EACH END UNLESS NOTED.
8. ALL JOISTS ARE SPACED EVENLY BETWEEN COLUMN LINES UNLESS NOTED.
9. COORDINATE SIZE AND LOCATION OF ALL OPENINGS, INFILLS, AND SLEEVES WITH OTHER CONTRACTED WORK. PROVIDE SUPPORTS AT CURBS AND OPENINGS PER THE TYPICAL DETAILS.
10. MAINTAIN EXISTING STRUCTURAL SYSTEMS AT ALL TIMES, EXCEPT IN AREAS NOTED FOR DEMOLITION IN ITS ENTIRETY. PROVIDE TEMPORARY SHORING AND BRACING AT LOCATIONS WHERE THE EXISTING STRUCTURE IS BEING MODIFIED. PROTECT THE EXISTING STRUCTURE SCHEDULED TO REMAIN FROM DAMAGE DURING DEMOLITION. MAINTAIN SHORING AND BRACING UNTIL THE NEW STRUCTURE IS INSTALLED AND READY TO ACCEPT LOADS. SUPPORT EXISTING WALLS WHERE THE WALL SYSTEMS ARE BEING PARTIALLY REMOVED OR OPENINGS ARE BEING PROVIDED UNTIL THE LINTELS ARE IN PLACE.
11. MECHANICAL ROOF TOP UNITS SHOWN INDICATE MAXIMUM UNIT WEIGHT. ACTUAL UNIT SUPPLIED MAY VARY IN SIZE AND WEIGHT FROM THE DESIGN. COORDINATE SIZE AND LOCATION WITH OTHER CONTRACTED WORK AND CONTACT ENGINEER OF RECORD IF THE SUPPLIED UNIT WEIGHT IS GREATER THAN SHOWN.

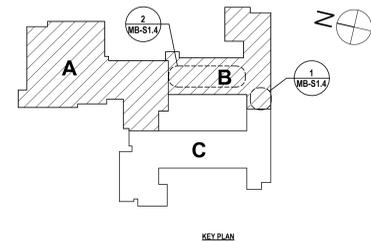

SED #: BG-5728-01-04-003-008; MR-5728-01-04-002-025

**HIGH ROOF FRAMING PLAN - AREAS A & B**  
**2025 CAPITAL IMPROVEMENTS PROJECT**  
**HAMMONDSPOORT CSD**  
8272 MAIN STREET HAMMONDSPOORT, NEW YORK, 14840

**MB-S1.4**  
PROJECT NO: 1925-014

**HUNT ENGINEERS ARCHITECTS | SURVEYORS**  
HORSEHEADS, NY 607-258-1000 | ROCKY HILLS, CT 860-307-7600 | TOWANDA, PA 570-265-6600  
BINGHAMTON, NY 607-798-8881 | ALBANY, NY 607-758-1801  
WWW.HUNTHEAS.COM  
NY CERTIFICATE NO. 0016250 PA CERTIFICATE NO. TSC220313464-1

#	DATE:	DESCRIPTION OF REVISION:	DRAWN BY:	MKB
1	10/27/2025	ISSUED FOR BID	CHECKED BY:	BSS
			DATE:	10/27/2025
			PHASE:	CD


Copyright 2025  
IT IS A VIOLATION OF THE LAW FOR ANY PERSON TO MAKE UNAUTHORIZED ALTERATIONS OR ADJUSTMENTS TO PLANS  
DRAWING ELECTRONIC SOURCE: PROJECTS 3D STRUCTURE DATE:

COLUMN SCHEDULE							
COLUMN LOCATION	SIZE	BASE REFERENCE	BASE OFFSET	TOP REFERENCE	TOP OFFSET	BASE PLATE MARK	NOTES
A-1	HSS5X5X1/4	-1'-4"	0' - 4"	5'-0"	-0' - 8"	BP-1	
A-2	HSS5X5X1/4	-1'-4"	0' - 4"	5'-0"	-0' - 3 5/8"	BP-2	
B-2	HSS5X5X1/4	-1'-4"	0' - 4"	5'-0"	0' - 4 3/8"	BP-2	
C-2	HSS5X5X1/4	-1'-4"	0' - 4"	5'-0"	0' - 4 3/8"	BP-2	
D-2	HSS5X5X1/4	-1'-4"	0' - 4"	5'-0"	0' - 4 3/8"	BP-2	
E-2	HSS5X5X1/4	-1'-4"	0' - 4"	5'-0"	0' - 4 3/8"	BP-2	
F-2	HSS5X5X1/4	-1'-4"	0' - 4"	5'-0"	0' - 4 3/8"	BP-2	
G-2	HSS5X5X1/4	-1'-4"	0' - 4"	5'-0"	0' - 4 3/8"	BP-2	
H-3	HSS5X5X1/4	-1'-4"	0' - 4"	5'-0"	0' - 4 1/8"	BP-1	
I-3	HSS5X5X1/4	-1'-4"	0' - 4"	5'-0"	-0' - 6"	BP-3	

FOOTING SCHEDULE			
MARK	SIZE	REINFORCING	NOTES
F1	3'-0"x3'-0"x1'-0"	(4) #5 BARS E.W.	

PIER REINFORCING SCHEDULE				
MARK	PIER SIZE	VERTICAL REINFORCING	TIES	NOTES
P1	17'x18"	(8) #6 BARS	(4) @ 3", R @ 12"	
P2	17'x20"	(12) #6 BARS	(4) @ 3", R @ 12"	
P3	18'x18"	(8) #6 BARS	(4) @ 3", R @ 12"	

BASE PLATE SCHEDULE				
MARK	SIZE	ANCHOR BOLT SIZE	EMBEDMENT	NOTES
BP-1	12"x12"x3/4"	(4) 3/4" Ø	9"	
BP-2	8"x12"x3/4"	(4) 3/4" Ø	9"	
BP-3	8"x12"x3/4"	(4) 1/2" Ø THREADED ROD	6"	-SEE DETAIL 9A/MB-S3.1

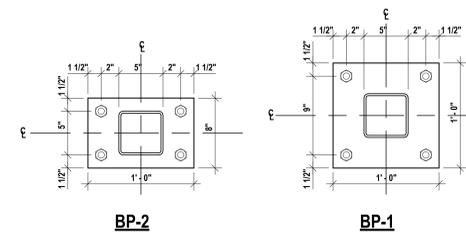


DRAWN BY: MKB		11/21/2025 10/27/2025 CD 10/27/2025 CD 10/27/2025 CD
CHECKED BY: BSS		
DATE: 10/27/2025		
PHASE: CD		
#	DATE	DESCRIPTION OF REVISION:
1	10/21/2025	ISSUED FOR BID

**HUNT** ENGINEERS | ARCHITECTS | SURVEYORS


HORSEHEADS, NY 607-565-1000    ROCKY HILLS, NY 562-537-7500    TOWANDA, PA 570-265-6666  
 BINGHAMTON, NY 607-798-8881    ALBANY, NY 607-798-8881  
 WWW.HUNTEAS.COM  
 NY CERTIFICATE NO. 0016250    PA CERTIFICATE NO. TSC2202031464-1

**SCHEDULES**  
**2025 CAPITAL IMPROVEMENTS PROJECT**  
**HAMMONDSPOORT CSD**  
 8272 MAIN STREET HAMMONDSPOORT, NEW YORK, 14840  
**MB-S2.1**  
 PROJECT NO: 1925-014


SET #: BG-5728-01-04-5-003-008, MR. 5728-01-04-5-002-025

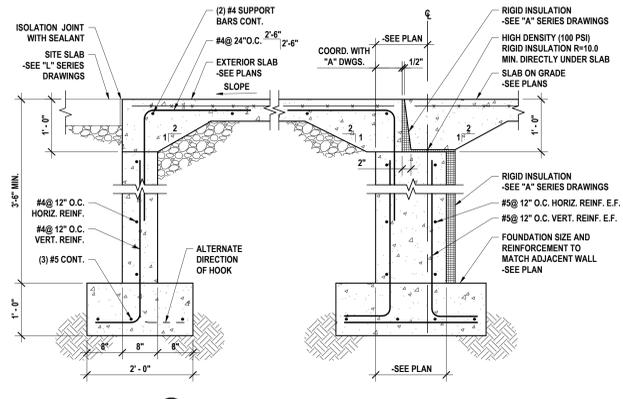


**6** TYPICAL FROST WALL AT ENTRANCE  
3/4" = 1'-0"

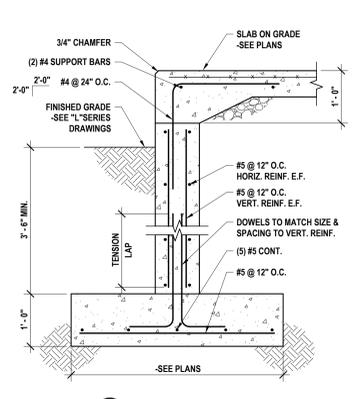


**8** OVERPOUR SLAB  
3/4" = 1'-0"

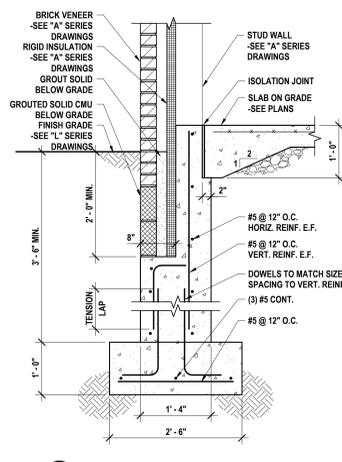


**4** EXTERIOR WALL FOUNDATION  
3/4" = 1'-0"

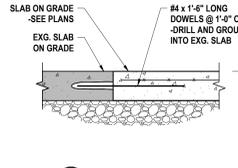

**3** DOWEL AT EXISTING SLAB  
1" = 1'-0"

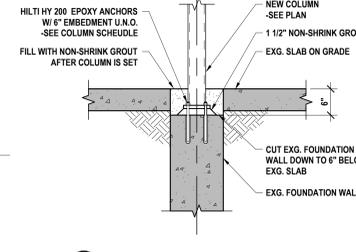


**2** TYPICAL COLUMN ON EXISTING WALL  
3/4" = 1'-0"

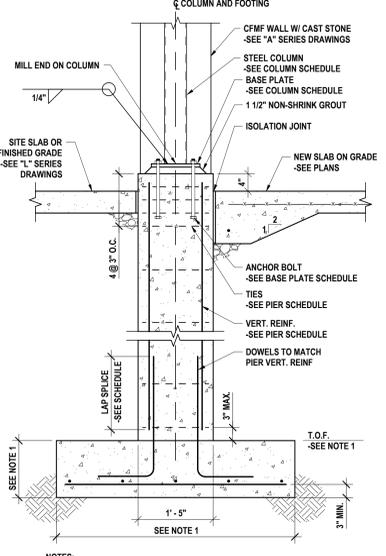


**8** COLUMN FOUNDATION AT RAISED PIER  
3/4" = 1'-0"

NOTES:  
1. SEE FOOTING SCHEDULE FOR FOOTING SIZE, DEPTH, AND REINFORCEMENT.  
2. SEE PIER SCHEDULE FOR PIER SIZE AND REINFORCEMENT.  
3. LEVELING PLATES MAY BE USED (NOT SHOWN).

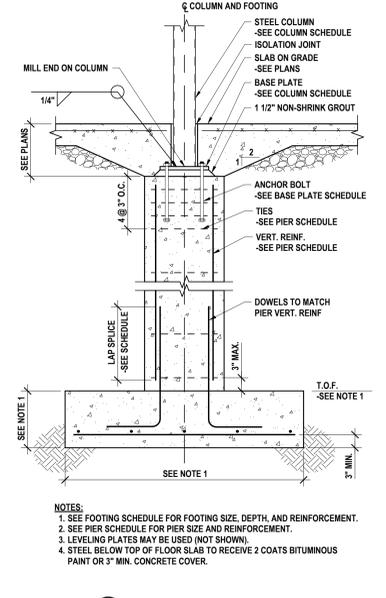


**1** TYPICAL COLUMN FOUNDATION  
3/4" = 1'-0"


NOTES:  
1. SEE FOOTING SCHEDULE FOR FOOTING SIZE, DEPTH, AND REINFORCEMENT.  
2. SEE PIER SCHEDULE FOR PIER SIZE AND REINFORCEMENT.  
3. LEVELING PLATES MAY BE USED (NOT SHOWN).  
4. STEEL BELOW TOP OF FLOOR SLAB TO RECEIVE 2 COATS BITUMINOUS PAINT OR 3\"/>

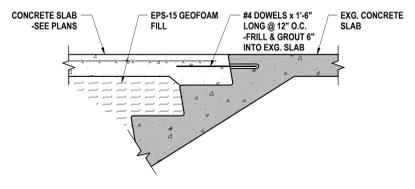


**11** GEOFOAM FILL AT STAIRS  
3/4" = 1'-0"

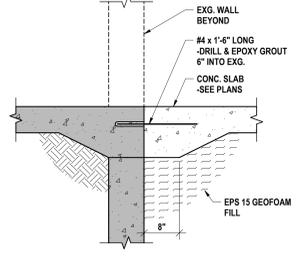


**10** SLAB DOWEL AT GEOFOAM FILL  
3/4" = 1'-0"

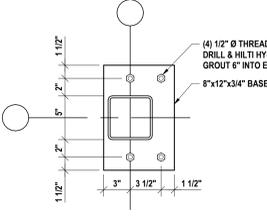


**9A** OFFSET BASE PLATE AT EXG.  
1 1/2" = 1'-0"

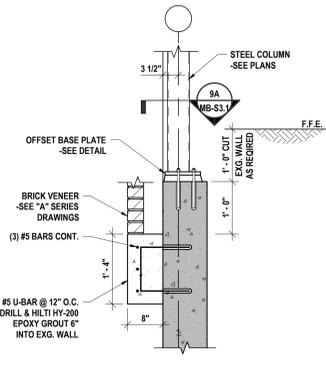


**9** COLUMN AT EXG. WALL  
3/4" = 1'-0"

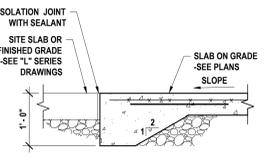


**15** THICKENED SLAB EDGE  
3/4" = 1'-0"

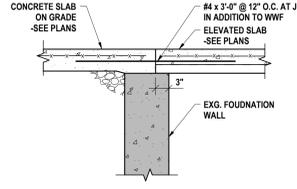


**14** SLAB TRANSITION DETAIL  
3/4" = 1'-0"

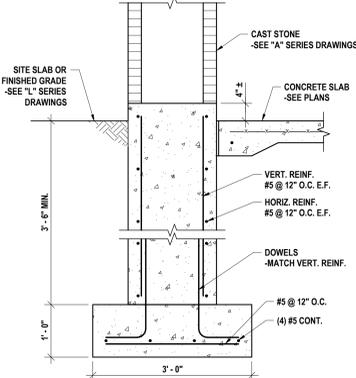

**13** CONCRETE WALL EXTENSION  
3/4" = 1'-0"

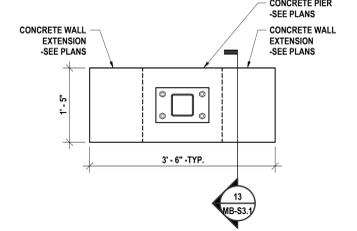

**12** CONCRETE WALL EXTENSIONS AT P-1 PIERS  
3/4" = 1'-0"

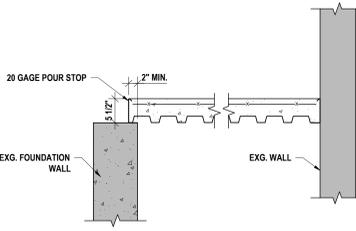

**7** COMPOSITE DECK AT CRAWSPACE  
3/4" = 1'-0"

SET & BG: 57-28-01-04-4-003-008, MR: 57-28-01-04-4-002-021

FOUNDATION DETAILS  
2025 CAPITAL IMPROVEMENTS PROJECT  
HAMMONDSPOUR CSD  
8272 MAIN STREET HAMMONDSPOUR, NEW YORK, 14840

**MB-S3.1**  
PROJECT NO: 1925-014

**HUNT ENGINEERS ARCHITECTS | SURVEYORS**  
HORSEHEADS, NY 607-458-1000    ROCKY HILLS, CT 860-377-7768    TOWANNA, PA 470-265-4668  
BINGHAMTON, NY 607-798-8881    ALBANY, NY 607-798-8881  
WWW.HUNTEAS.COM  
NY CERTIFICATE NO. 0016250    PA CERTIFICATE NO. TSC220313464-1

#	DATE:	DESCRIPTION OF REVISION:
1	10/27/2025	ISSUED FOR BID

DRAWN BY:	MKB
CHECKED BY:	BSS
DATE:	10/27/2025
PHASE:	CD

THIS IS A VOUCHER OF THE LAW FOR ANY PERSON TO MAKE UNAUTHORIZED ALTERATIONS OR ADDITIONS TO PLANS. SEALS, STAMPS, SIGNATURES, OR PRINTED NAMES ARE NOT VALID.

WALL THICKNESS	MASONRY OPENING	
	UP TO 4'-0"	4'-0" TO 8'-0"
4" INTERIOR	WT 4 x 6.5 (CUT FLANGES TO 3 1/2" AT ENDS)	WT 6 x 8 (CUT FLANGES TO 3 1/2" AT ENDS)
4" EXTERIOR	L 3 1/2 x 3 1/2 x 5/16	L 5 x 3 1/2 x 5/16 (LLV)
6"	WT 4 x 9	WT 7 x 11
8"	(2) L4 x 3 1/2 x 5/16 (LLV)	(2) 5 x 3 1/2 x 5/16 (LLV)
10"	(2) L4 x 3 1/2 x 5/16 (LLV) WITH 9" x 5/16" PLATE	(2) 5 x 3 1/2 x 5/16 (LLV) 9" x 5/16" PLATE
12"	(2) L5 x 3 1/2 x 5/16 (LLV) WITH 11" x 5/16" PLATE	(2) 5 x 3 1/2 x 5/16 (LLV) WITH 11" x 5/16" PLATE
11"-2" (8" CMU)	L 3 1/2 x 3 1/2 x 5/16 WITH CFMF HEADER	L 5 x 3 1/2 x 5/16 (LLV) WITH CFMF HEADER
1'-4" (8" CMU)	(3) L4 x 3 1/2 x 5/16 (LLV) WITH 15" x 5/16" PLATE	(3) L5 x 3 1/2 x 5/16 (LLV) WITH 15" x 5/16" PLATE
1'-5" (8" CMU)	(3) L4 x 3 1/2 x 5/16 (LLV) WITH 16" x 5/16" PLATE	(3) L5 x 3 1/2 x 5/16 (LLV) WITH 16" x 5/16" PLATE
1'-9" (10" CMU)	(3) L4 x 3 1/2 x 5/16 (LLV) WITH 17" x 5/16" PLATE	(3) L5 x 3 1/2 x 5/16 (LLV) WITH 17" x 5/16" PLATE

NOTES:  
1. ALL EXTERIOR LINTELS SHALL BE GALVANIZED.  
2. BOTTOM PLATE TO BE CUT 1/2" SHORTER THAN THE MASONRY OPENING.

DRAWN BY: MKK  
CHECKED BY: BSS  
DATE: 10/27/2025  
PHASE: CD


# DATE: 1 10/10/25  
DESCRIPTION OF REVISION:  
ISSUED FOR BID

IT IS A VIOLATION OF THE LAW FOR ANY PERSON TO MAKE UNAUTHORIZED ALTERATIONS OR ADDITIONS TO PLANS  
DRAWN/REVISIONS/ENGINEER: PROJECTS 303@HUNTERS.COM


**HUNT ENGINEERS ARCHITECTS | SURVEYORS**  
HORSEHEADS, NY 807-798-8088  
ROCKY HILLS, NY 807-798-8088  
BANGOR, NY 807-798-8088  
ALBANY, NY 807-798-8088  
WWW.HUNTERS.COM  
NY CERTIFICATE NO. 0016250 PA CERTIFICATE NO. TSC220313464-1

**HUNT ENGINEERS ARCHITECTS | SURVEYORS**  
HORSEHEADS, NY 807-798-8088  
ROCKY HILLS, NY 807-798-8088  
BANGOR, NY 807-798-8088  
ALBANY, NY 807-798-8088  
WWW.HUNTERS.COM  
NY CERTIFICATE NO. 0016250 PA CERTIFICATE NO. TSC220313464-1


PROJECT NO: 1925-014

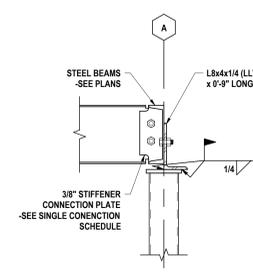


19 CHANNEL TO CHANNEL CONNECTION AT CANTILEVER  
1" = 1'-0"

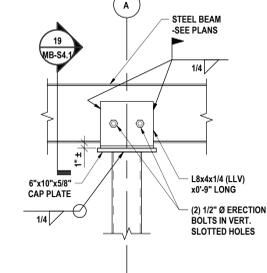


18 CANTILEVER CHANNEL CONNECTION TO COLUMN  
1" = 1'-0"

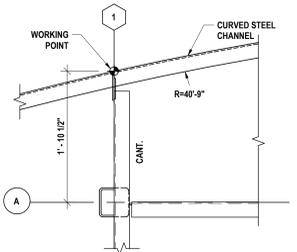


17 CURVED CHANNEL AT EXISTING GRID  
1" = 1'-0"

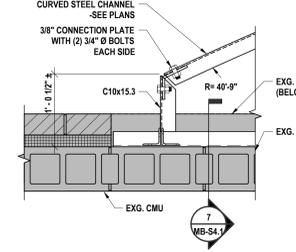


16 CURVED CHANNEL CONNECTION AT EXISTING WALL  
1" = 1'-0"

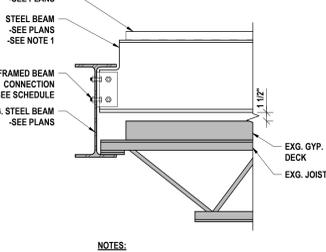


15 UNIT SUPPORT AT EAST GYM WALL  
1" = 1'-0"

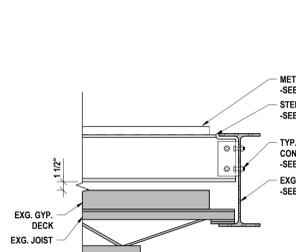


14 UNIT SUPPORT AT WEST GYM WALL  
1" = 1'-0"

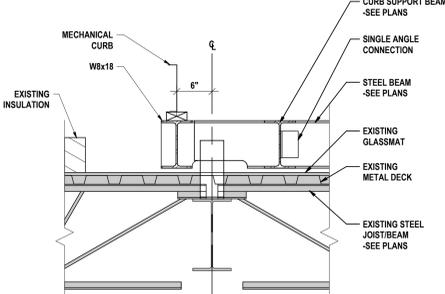


13 LOW DUNNAGE END SUPPORT AT MECHANICAL CURB  
1" = 1'-0"

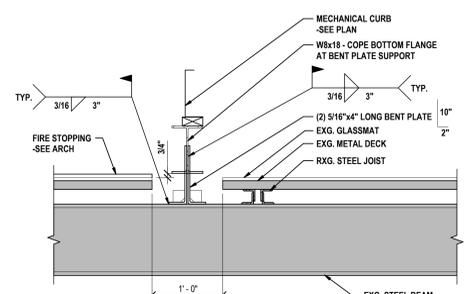


12 LOW DUNNAGE SECTION  
1" = 1'-0"

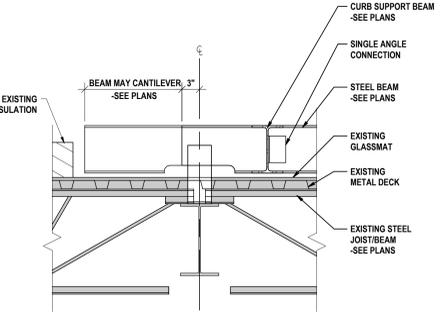


11 LOW DUNNAGE END SUPPORT  
1" = 1'-0"

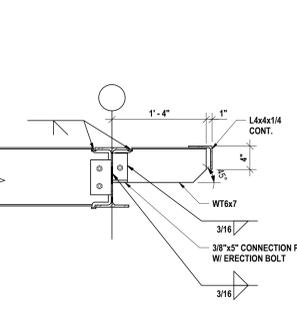


10 ROOF EDGE DETAIL  
1" = 1'-0"

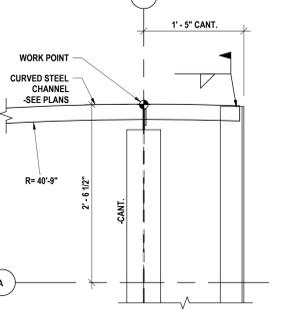


9 CURVED CHANNEL AT CANOPY  
1" = 1'-0"

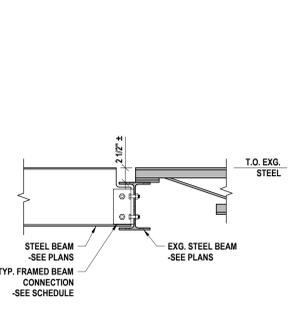


8 NEW BEAM AT EXG. STEEL  
1" = 1'-0"

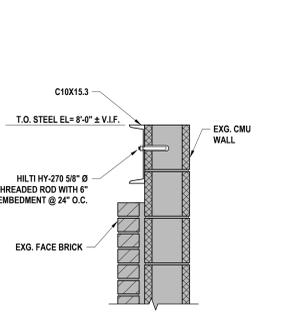


7 CHANNEL CONNECTION TO WALL  
1" = 1'-0"

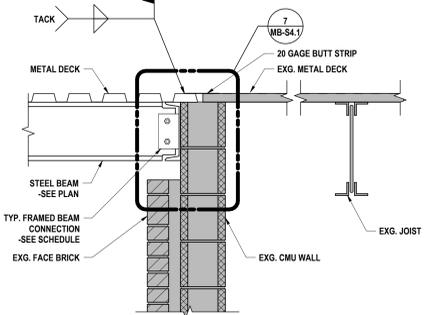


6 CHANGE IN DECK DIRECTION AT CMU WALL  
1" = 1'-0"

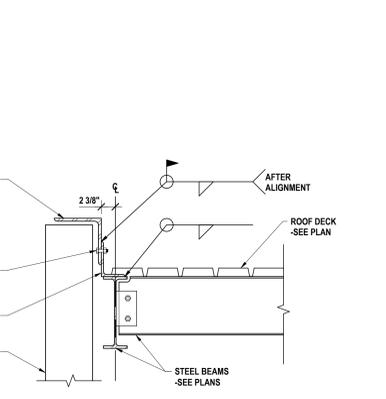

5 ROOF EDGE SUPPORT  
1" = 1'-0"

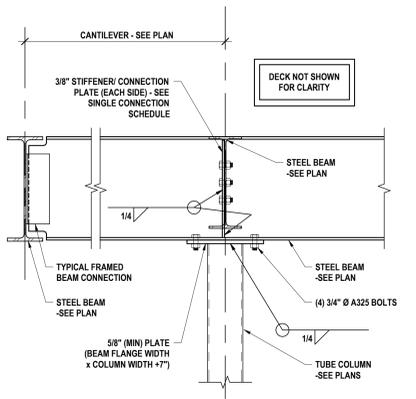


4 BEAM CONTINUOUS OVER COLUMN  
1" = 1'-0"

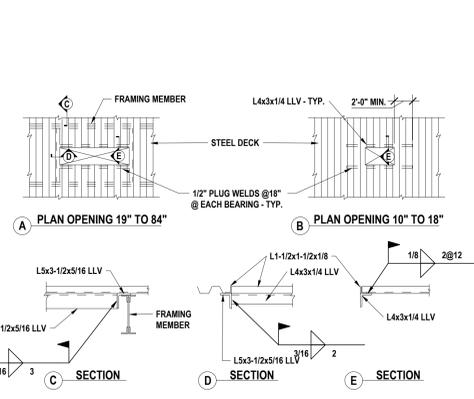

3 OPENINGS IN STEEL ROOF DECK  
3/4\"/>

TOTAL NUMBER OF BOLTS IN CLIPS	MINIMUM CONNECTION ON BEAM	MAXIMUM CONNECTION ON BEAM	3/4" Ø BOLT CAPACITY (KIPS)	5/16" E70XX WELD CAPACITY (KIPS)
4	W8, W10, W12	W8, W10	36.0	45.0
6	W14, W16, W18	W12, W14	56.7	65.7
8	W21, W24	W16	75.6	85.5
10	W27, W30	W18	94.5	103.5
12	W33, W36	W21	112.5	119.7


NOTES:  
1. WHEN THE GIRDER OR BEAM WEB THICKNESS IS LESS THAN LISTED THICKNESS SHOWN, MULTIPLY LISTED CAPACITY BY RATIO OF ACTUAL THICKNESS TO LISTED MINIMUM THICKNESS.  
2. THE LESSER OF THE GIRDER OR BEAM CONNECTION CAPACITIES SHALL BE TAKEN AS THE CONTROLLING CONNECTION CAPACITY.  
3. EITHER A325-N OR A325-X BOLTS MAY BE USED.  
4. WHEN CONNECTING TO EXISTING STEEL REDUCE CAPACITY TO 0.85 OF LISTED CAPACITY.

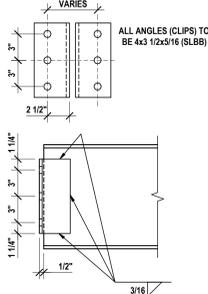

2 TYPICAL FRAMED BEAM CONNECTIONS  
1 1/2" = 1'-0"

MINIMUM CONNECTION ON BEAM	MAXIMUM CONNECTION ON BEAM	NO. OF BOLTS (TOTAL)	3/4" Ø BOLTS CAPACITY (KIPS)			
			A325-N STD & SSL	MIN. WEB (IN)	A325-X STD & SSL	MIN. WEB (IN)
W8, W10, W12	W8, W10	2	15.0	0.143	16.8	0.181
W14, W16, W18	W12, W14	3	26.5	0.168	33.4	0.212
W21, W24	W16	4	37.9	0.180	46.8	0.223
W27, W30	W18	5	48.1	0.187	57.8	0.220
W33, W36	W21	6	60.1	0.191	68.7	0.218

NOTES:  
1. WHEN BEAM WEB THICKNESS IS LESS THAN LISTED THICKNESS, MULTIPLY LISTED CAPACITY BY RATIO OF ACTUAL THICKNESS TO LISTED MINIMUM THICKNESS.  
2. MINIMUM COLUMN THICKNESS = 0.25".  
3. USE WELDING ELECTRODES E70XX FOR ALL WELDS.  
4. WHEN CONNECTING TO EXISTING STEEL MULTIPLY THE LISTED CAPACITY BY 0.85

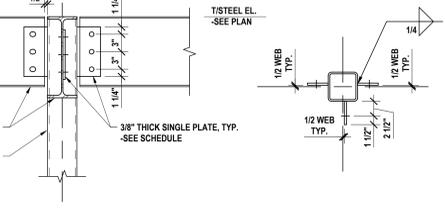

1 TYPICAL SINGLE PLATE CONNECTION AT COLUMN  
1" = 1'-0"

FRAMING DETAILS  
2025 CAPITAL IMPROVEMENTS PROJECT  
HAMMONDSPOINT CSD  
8272 MAIN STREET HAMMONDSPOINT, NEW YORK, 14840  
MB-S4.1  
PROJECT NO: 1925-014

**GENERAL ASBESTOS ABATEMENT NOTES:**


- A REFER TO ASBESTOS ABATEMENT SPECIFICATION FOR ADDITIONAL INFORMATION.
- B ALL WORK IS TO COMPLY WITH APPLICABLE CODE WITHIN JURISDICTION OR HIGHER. SITE SPECIFIC VARIANCES MAY BE IMPLEMENTED IF APPROVED BY THE ARCHITECT.
- C ASBESTOS SURVEY WAS COMPLETED. THE REPORT IS PART OF THE CONTRACT DOCUMENTS.
- D THE REGULATED ABATEMENT WORK AREA SHALL BE VACATED BY THE OCCUPANTS AND NON-CERTIFIED PERSONNEL PRIOR TO WORK AREA PREPARATION, AND SHALL REMAIN VACATED UNTIL THE ASBESTOS PROJECT IS COMPLETE.
- E THE PERSONAL AND WASTE DECONTAMINATION SYSTEM ENCLOSURE(S) SHALL BE PROVIDED OUTSIDE THE REGULATED ABATEMENT WORK AREA AND ATTACHED TO THE BUILDING AT ENTRY/EXIT LOCATIONS. THESE LOCATIONS SHALL BE REVIEWED AND APPROVED BY THE OWNER/OWNER'S REPRESENTATIVE PRIOR TO COMMENCEMENT OF WORK. THE DECONTAMINATION UNIT(S) SHALL BE CORDONED OFF AT A DISTANCE OF TWENTY-FIVE (25) FEET IN ALL DIRECTIONS TO SEPARATE IT FROM PUBLIC AREAS. THE CONTRACTOR SHALL ESTABLISH, MARK, AND MAINTAIN PROPER EXITS WITHIN EACH WORK AREA FOR NORMAL AND EMERGENCY USE AND MAINTAIN A CLEAR EGRESS PATH.
- F ALL TOOLS AND EQUIPMENT SHALL BE REMOVED FROM SITE AFTER DECONTAMINATION.
- G AFTER ALL REGULATED AREAS HAS PASSED FINAL AIR CLEARANCE AND PASSED FINAL INSPECTION, THE REGULATED AREAS CAN BE DISMANTLED. ANY REMOTE OR ATTACHED DECONTAMINATION CHAMBERS MUST BE DISMANTLED AND REMOVED FROM SITE. ALL PLASTIC SHEATHING, TAPE AND GLUE RESIDUE MUST BE REMOVED FROM THE WORK AREAS. ALL DAMAGED PEELING PAINT AND DAMAGED DRYWALL MUST BE RETURNED TO THEIR ORIGINAL CONDITION.
- H ALL WASTE GENERATED AS PART OF ASBESTOS PROJECT SHALL BE REMOVED FROM THE SITE WITHIN TEN (10) CALENDAR DAYS AFTER SUCCESSFUL COMPLETION OF ALL REGULATED WORK AREAS.
- I HIDDEN SUSPECT ASBESTOS CONTAINING MATERIALS MAYBE ENCOUNTER BEHIND WALL AND CHALK BOARDS, MIRRORS, UNDER CABINETS, UNWINDENTS AND ABOVE HARD PLASTER CEILING AND BEHIND WET WALLS AND INSIDE EXTERIOR WALLS THAT MAY DEMOLISHED DURING RENOVATIONS. IF SUSPECTS ARE ASBESTOS CONTAINING THE CONTRACTOR SHALL STOP WORKING IMMEDIATELY AND CONTACT THE OWNER'S REPRESENTATIVE FOR ADDITIONAL INSTRUCTIONS.
- J ALL WASTE GENERATED AS PART OF THE ASBESTOS AND PCB WINDOW PHASE OF THE PROJECT SHALL BE LEGALLY DISPOSED OF AT USEPARTY'S APPROVED LANDFILL OR WASTE FACILITY. ALL GENERATED WASTES REMOVED FROM THE WORK SITE SHALL BE PROPERLY DOCUMENTED WITH A WASTE MANIFEST. A COPY OF THE WASTE MANIFEST AND TRIP TICKET WILL BE GIVEN TO THE OWNER'S REPRESENTATIVE PRIOR TO THE WASTE CONTAINER LEAVING THE SITE. ALL WASTE SHALL BE PACKAGED, TRANSPORTED AND DISPOSED IN ACCORDANCE WITH LOCAL, STATE AND FEDERAL REGULATIONS.

**# ABATEMENT PLAN DRAWING NOTES:**


- AB1 REMOVE ACM VAPOR BARRIER IN ITS ENTIRETY INCLUDING THE WOODEN FLOOR UTILIZING FULL ENCLOSURE WITH NEGATIVE AIR. ALL WOODEN MATERIALS WITHOUT ASBESTOS CONTAINING MASTICS MAY BE DISPOSED OF AS CONSTRUCTION DEBRIS. THE VAPOR BARRIER AND ASBESTOS CONTAMINATED WOOD OR METAL FOUND ATTACHED OR ADHERED TO THE VAPOR BARRIER MUST BE DISPOSED OF AS ASBESTOS WASTE.
- AB2 REMOVE AND DISPOSE OF ALL ASBESTOS CONTAINING EXTERIOR WINDOW CAULK UTILIZING CRITICAL BARRIERS ON THE INSIDE OF THE WINDOWS.
- AB3 REMOVE THE ENTIRE CEILING SYSTEM, INCLUDING THE ASBESTOS CONTAMINATED ON CEILING TILE, ASBESTOS CONTAINING MASTIC, AND ASBESTOS CONTAMINATED MASTICS FROM THE CEILING UTILIZING FULL ENCLOSURE WITH NEGATIVE AIR. DISPOSE OF ALL MATERIALS AS ASBESTOS WASTE.
- AB4 REMOVE ALL ASBESTOS CONTAINING ELBOW AND JOINT INSULATION FROM ABOVE CEILING AND INSIDE WALLS. IN ACCORDANCE WITH INDUSTRIAL CODE RULE 56.
- AB5 REMOVE APPROXIMATELY 3 SQFT OF CEILING TILE, GLUE DOTS AND PLASTER BOARD, WHERE INDICATED.

**# HAZARDOUS MATERIAL PLAN DRAWING NOTES:**

- P1 REMOVE ALL EXTERIOR PCB CONTAINING WINDOW CAULK.
- P2 REMOVAL MUST BE COMPLETED BY WORKERS THAT ARE 40 HOUR HAZARDOUS WORKER TRAINED AND CERTIFIED.
- P3 DISPOSAL OF CAULK IN ACCORDANCE WITH THE REQUIREMENTS OF 40CFR761.3, 761.20(A) AND 761.62.

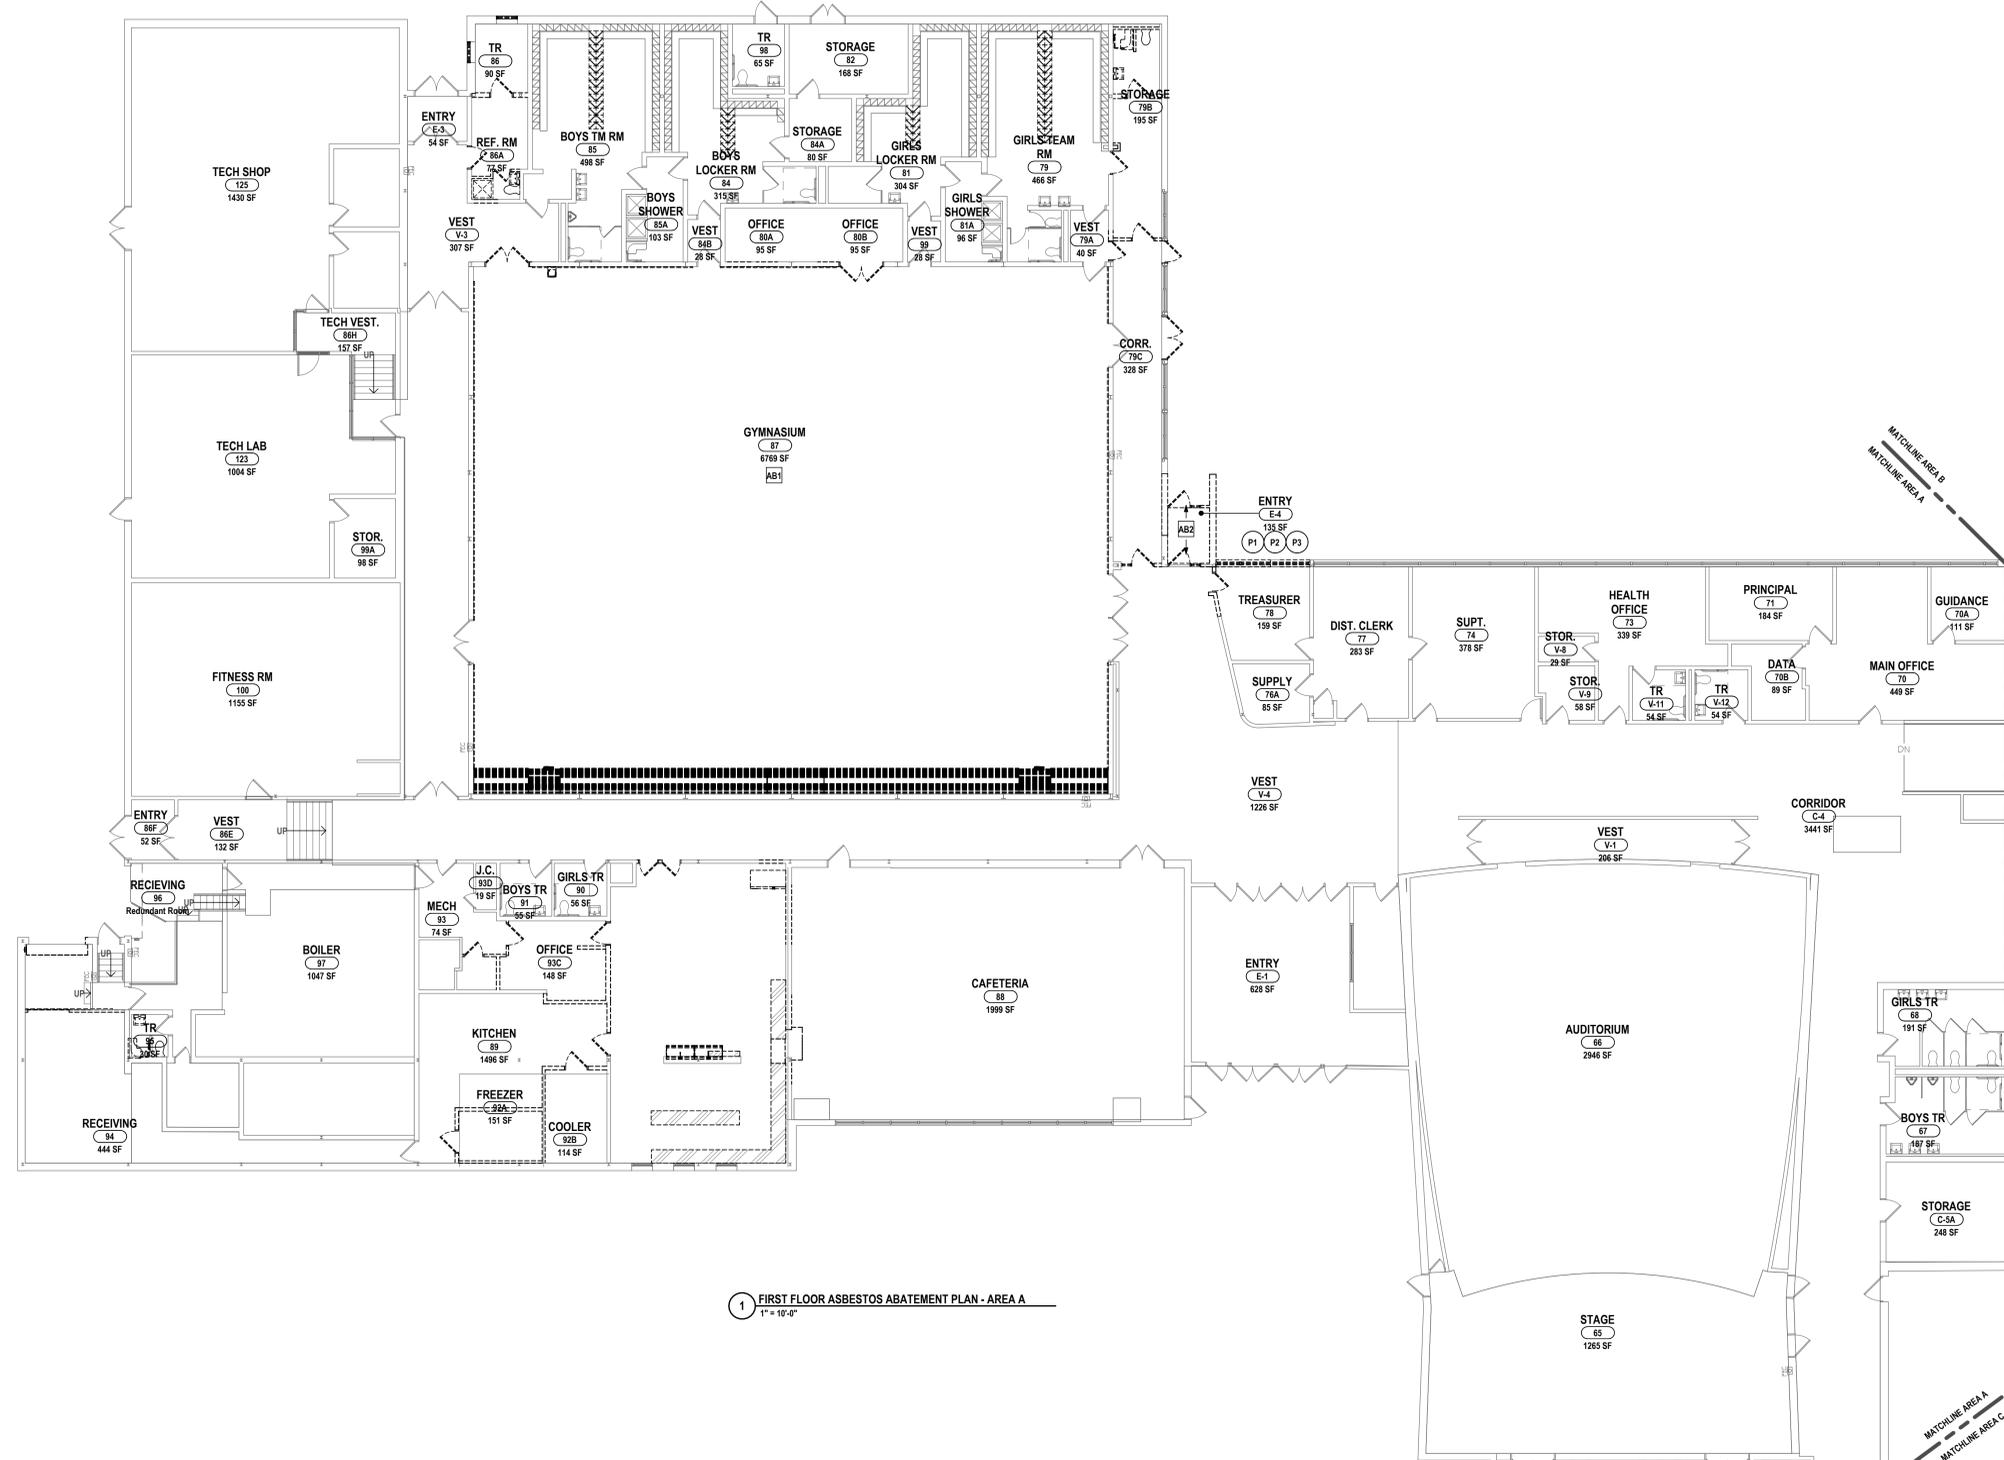

**1 FIRST FLOOR ASBESTOS ABATEMENT PLAN - AREA A**  
1" = 10'-0"

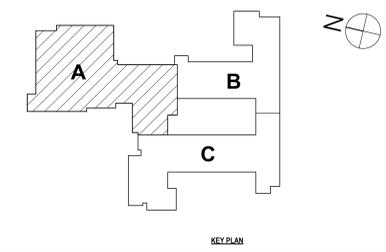

#	DATE:	DESCRIPTION OF REVISION:	ISSUE FOR BID
1	10/27/2025		

**HUNT ENGINEERS ARCHITECTS | SURVEYORS**

HORSEHEADS, NY 607-265-1000    PISCATAWAY, NY 562-337-7668    TOWANDA, PA 570-265-4668  
 BINGHAMTON, NY 607-738-8881    ALBANY, NY 607-738-8881  
 WWW.HUNTEAS.COM  
 NY CERTIFICATE NO. 0016250    PA CERTIFICATE NO. TSC22020131464-1

**FIRST FLOOR ASBESTOS ABATEMENT PLAN - AREA A**  
**2025 CAPITAL IMPROVEMENTS PROJECT**  
**HAMMONDSPORT CENTRAL SCHOOL DISTRICT**  
 8272 MAIN STREET HAMMONDSPORT, NEW YORK, 14840

**MB-AB1.1**

PROJECT NO: 1925.014

SED #: MB-57-28-01-04-02-02-03-03-06-07-29-01-04-5-003-208

DRAWN BY: TSK  
 CHECKED BY: JJ  
 DATE: 10/27/2025  
 PHASE: CD

THIS IS A PORTION OF THE MAP FOR ANY PERSON TO MAKE UNAUTHORIZED ALTERATIONS OR ADDITIONS TO PLANS DRAWING UTILIZED. ENGINEER, ARCHITECT'S OR SURVEYOR'S SEAL.

KEY PLAN

**GENERAL ASBESTOS ABATEMENT NOTES:**


- A REFER TO ASBESTOS ABATEMENT SPECIFICATION FOR ADDITIONAL INFORMATION.
- B ALL WORK IS TO COMPLY WITH APPLICABLE CODE WITHIN JURISDICTION OR HIGHER. SITE SPECIFIC VARIANCES MAY BE IMPLEMENTED IF APPROVED BY THE ARCHITECT.
- C ASBESTOS SURVEY WAS COMPLETED. THE REPORT IS PART OF THE CONTRACT DOCUMENTS.
- D THE REGULATED ABATEMENT WORK AREA SHALL BE VACATED BY THE OCCUPANTS AND NON-CERTIFIED PERSONNEL PRIOR TO WORK AREA PREPARATION, AND SHALL REMAIN VACATED UNTIL THE ASBESTOS PROJECT IS COMPLETE.
- E THE PERSONAL AND WASTE DECONTAMINATION SYSTEM ENCLOSURE(S) SHALL BE PROVIDED OUTSIDE THE REGULATED ABATEMENT WORK AREA AND ATTACHED TO THE BUILDING AT ENTRY/EXIT LOCATIONS. THESE LOCATIONS SHALL BE REVIEWED AND APPROVED BY THE OWNER'S REPRESENTATIVE PRIOR TO COMMENCEMENT OF WORK. THE DECONTAMINATION UNIT(S) SHALL BE CORDONED OFF AT A DISTANCE OF TWENTY-FIVE (25) FEET IN ALL DIRECTIONS TO SEPARATE IT FROM PUBLIC AREAS. THE CONTRACTOR SHALL ESTABLISH, MARK, AND MAINTAIN PROPER EXITS WITHIN EACH WORK AREA FOR NORMAL AND EMERGENCY USE AND MAINTAIN A CLEAR EGRESS PATH.
- F ALL TOOLS AND EQUIPMENT SHALL BE REMOVED FROM SITE AFTER DECONTAMINATION.
- G AFTER ALL REGULATED AREAS HAS PASSED FINAL AIR CLEARANCE AND PASSED FINAL INSPECTION, THE REGULATED AREAS CAN BE DISMANTLED. ANY REMOTE OR ATTACHED DECONTAMINATION CHAMBERS MUST BE DISMANTLED AND REMOVED FROM SITE. ALL PLASTIC SHEATHING, TAPE AND GLUE RESIDUE MUST BE REMOVED FROM THE WORK AREAS. ALL DAMAGED PEELING PAINT AND DAMAGED DRYWALL MUST BE RETURNED TO THEIR ORIGINAL CONDITION.
- H ALL WASTE GENERATED AS PART OF ASBESTOS PROJECT SHALL BE REMOVED FROM THE SITE WITHIN TEN (10) CALENDAR DAYS AFTER SUCCESSFUL COMPLETION OF ALL REGULATED WORK AREAS.
- I HIDDEN SUSPECT ASBESTOS CONTAINING MATERIALS MAYBE ENCOUNTER BEHIND WALL AND CHAUK BOARDS, MIRRORS, UNDER CABINETS, UNMOUNTED AND ABOVE HARD PLASTER CEILING AND BEHIND WET WALLS AND INSIDE EXTERIOR WALLS THAT MAY DEMOLISHED DURING RENOVATIONS. IF SUSPECTS ARE ASBESTOS CONTAINING THE CONTRACTOR SHALL STOP WORKING IMMEDIATELY AND CONTACT THE OWNER'S REPRESENTATIVE FOR ADDITIONAL INSTRUCTIONS.
- J ALL WASTE GENERATED AS PART OF THE ASBESTOS AND PCB WINDOW PHASE OF THE PROJECT SHALL BE LEGALLY DISPOSED OF AT USEPANTS APPROVED LANDFILL OR WASTE FACILITY. ALL GENERATED WASTES REMOVED FROM THE WORK SITE SHALL BE PROPERLY DOCUMENTED WITH A WASTE MANIFEST. A COPY OF THE WASTE MANIFEST AND TRIP TICKET WILL BE GIVEN TO THE OWNER'S REPRESENTATIVE PRIOR TO THE WASTE CONTAINER LEAVING THE SITE. ALL WASTE SHALL BE PACKAGED, TRANSPORTED AND DISPOSED IN ACCORDANCE WITH LOCAL, STATE AND FEDERAL REGULATIONS.

**# ABATEMENT PLAN DRAWING NOTES:**


- AB1 REMOVE ACM VAPOR BARRIER IN ITS ENTIRETY INCLUDING THE WOODEN FLOOR UTILIZING FULL ENCLOSURE WITH NEGATIVE AIR. ALL WOODEN MATERIALS WITHOUT ASBESTOS CONTAINING MASTICS MAY BE DISPOSED OF AS CONSTRUCTION DEBRIS. THE VAPOR BARRIER AND ASBESTOS CONTAMINATED WOOD OR METAL FOUND ATTACHED OR ADHERED TO THE VAPOR BARRIER MUST BE DISPOSED OF AS ASBESTOS WASTE.
- AB2 REMOVE AND DISPOSE OF ALL ASBESTOS CONTAINING EXTERIOR WINDOW CAULK UTILIZING CRITICAL BARRIERS ON THE INSIDE OF THE WINDOWS.
- AB3 REMOVE THE ENTIRE CEILING SYSTEM, INCLUDING THE ASBESTOS CONTAMINATED ON CEILING TILE, ASBESTOS CONTAINING MASTIC, AND ASBESTOS CONTAMINATED MASTICS FROM THE CEILING UTILIZING FULL ENCLOSURE WITH NEGATIVE AIR. DISPOSE OF ALL MATERIALS AS ASBESTOS WASTE.
- AB4 REMOVE ALL ASBESTOS CONTAINING ELBOW AND JOINT INSULATION FROM ABOVE CEILING AND INSIDE WALLS. IN ACCORDANCE WITH INDUSTRIAL CODE RULE 56.
- AB5 REMOVE APPROXIMATELY 3 SQFT OF CEILING TILE, GLUE DOTS AND PLASTER BOARD, WHERE INDICATED.

**# HAZARDOUS MATERIAL PLAN DRAWING NOTES:**

- P1 REMOVE ALL EXTERIOR PCB CONTAINING WINDOW CAULK.
- P2 REMOVAL MUST BE COMPLETED BY WORKERS THAT ARE 40 HOUR HAZARDOUS WORKER TRAINED AND CERTIFIED.
- P3 DISPOSAL OF CAULK IN ACCORDANCE WITH THE REQUIREMENTS OF 40CFR761.3, 761.20(A) AND 761.62.

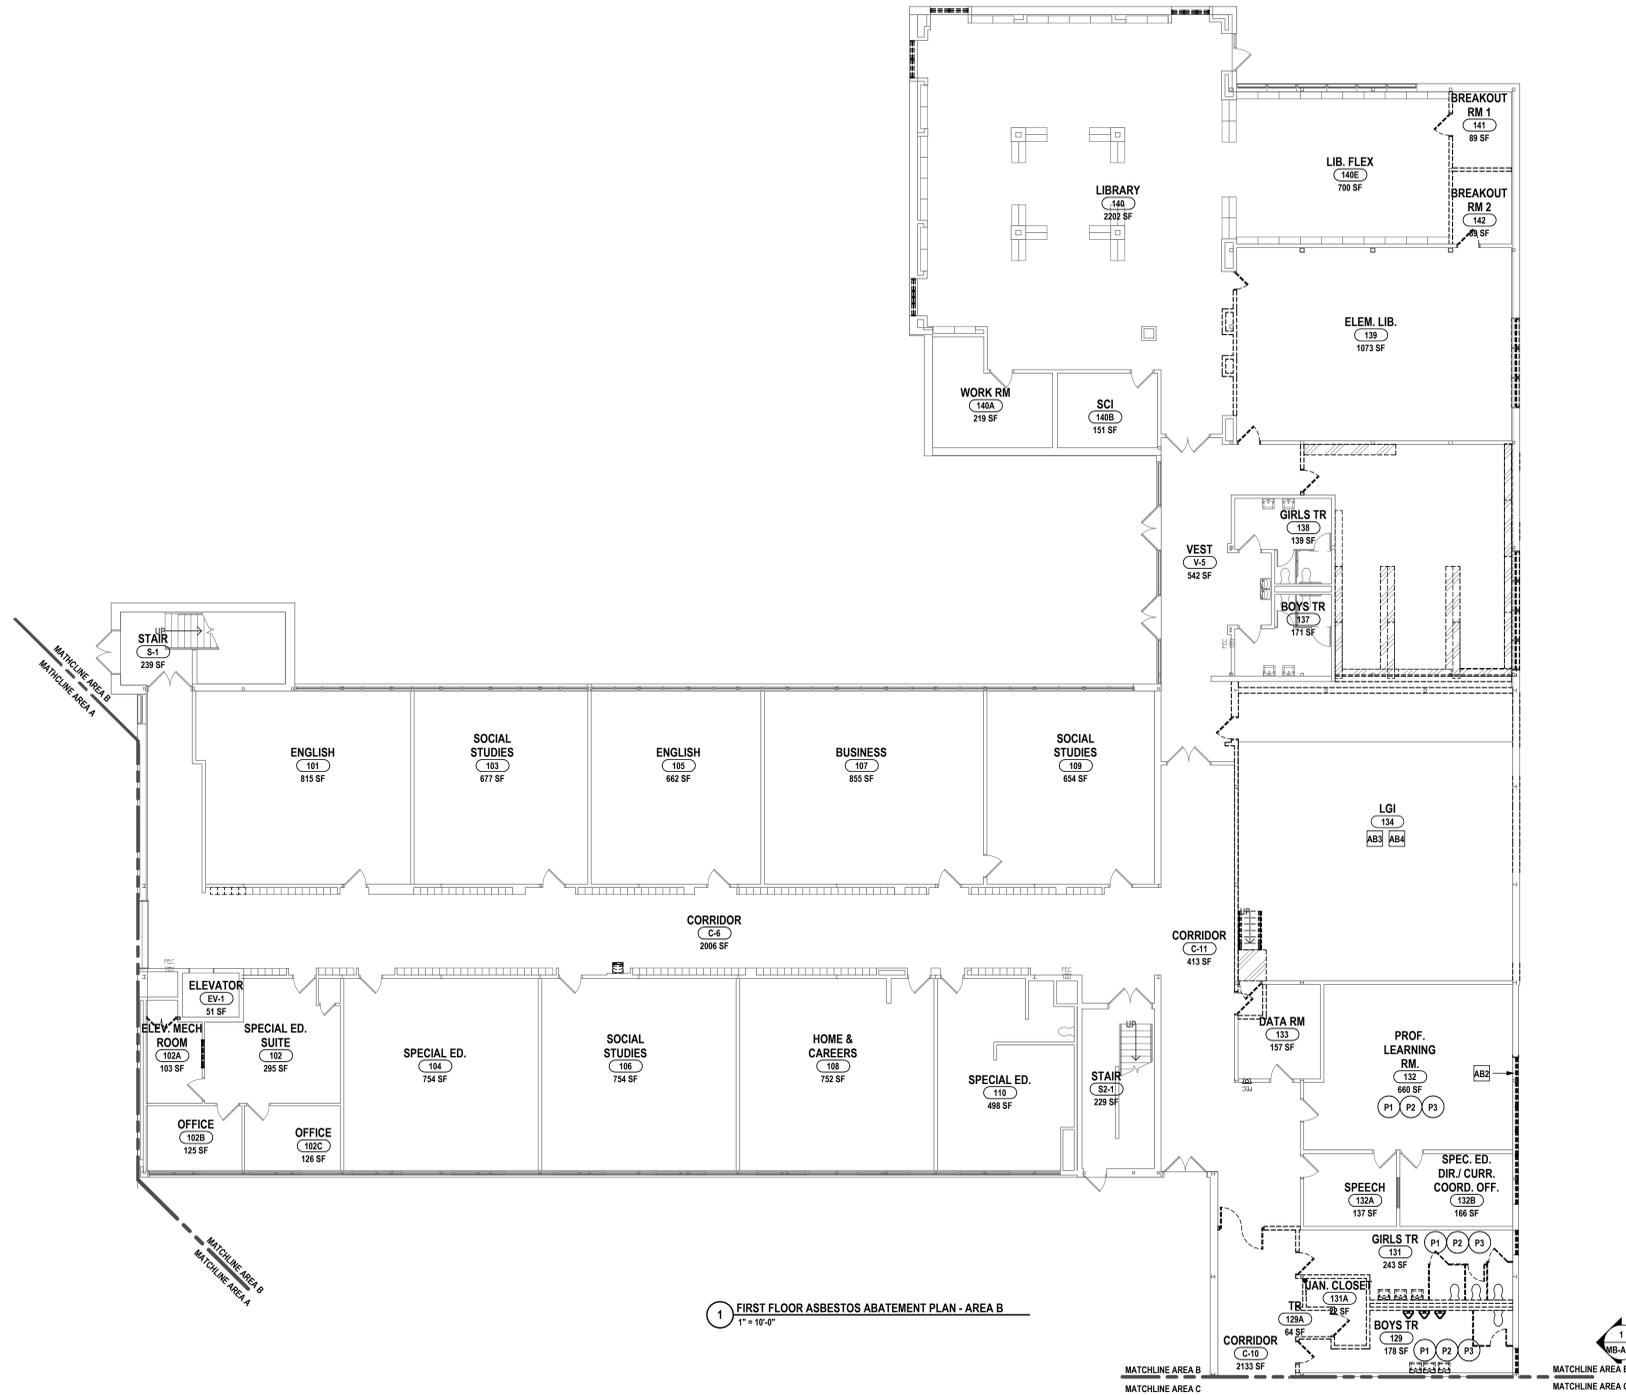

1 FIRST FLOOR ASBESTOS ABATEMENT PLAN - AREA B  
1" = 10'-0"

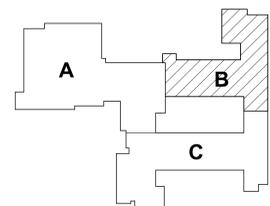

KEY PLAN

DRAWN BY:	TSH
CHECKED BY:	JL
DATE:	10/27/2025
PHASE:	CD
# DATE:	1 10/10/25
DESCRIPTION OF REVISION:	ISSUE FOR BID

**HUNT ENGINEERS ARCHITECTS | SURVEYORS**  
 HORSEHEADS, NY 607-858-1008  
 ROCHESTER, NY 585-237-7500  
 BINGHAMTON, NY 607-798-8881  
 ALBANY, NY 607-758-1801  
 WWW.HUNTEAS.COM  
 NY CERTIFICATE NO. 0016250 PA CERTIFICATE NO. TSC22020131464-1

**FIRST FLOOR ASBESTOS ABATEMENT PLAN - AREA B**  
**2025 CAPITAL IMPROVEMENTS PROJECT**  
**HAMMONDSPORT CENTRAL SCHOOL DISTRICT**  
 8272 MAIN STREET HAMMONDSPORT, NEW YORK, 14840

**MB-AB1.2**  
 PROJECT NO: 1925.014

SED #: MB-5728-01-04-02-02510; 5728-01-04-04-003-008

**GENERAL ASBESTOS ABATEMENT NOTES:**


- A REFER TO ASBESTOS ABATEMENT SPECIFICATION FOR ADDITIONAL INFORMATION.
- B ALL WORK IS TO COMPLY WITH APPLICABLE CODE WITHIN JURISDICTION OR HIGHER. SITE SPECIFIC VARIANCES MAY BE IMPLEMENTED IF APPROVED BY THE ARCHITECT.
- C ASBESTOS SURVEY WAS COMPLETED. THE REPORT IS PART OF THE CONTRACT DOCUMENTS.
- D THE REGULATED ABATEMENT WORK AREA SHALL BE VACATED BY THE OCCUPANTS AND NON-CERTIFIED PERSONNEL PRIOR TO WORK AREA PREPARATION, AND SHALL REMAIN VACATED UNTIL THE ASBESTOS PROJECT IS COMPLETE.
- E THE PERSONAL AND WASTE DECONTAMINATION SYSTEM ENCLOSURE(S) SHALL BE PROVIDED OUTSIDE THE REGULATED ABATEMENT WORK AREA AND ATTACHED TO THE BUILDING AT ENTRY/EXIT LOCATIONS. THESE LOCATIONS SHALL BE REVIEWED AND APPROVED BY THE OWNER'S REPRESENTATIVE PRIOR TO COMMENCEMENT OF WORK. THE DECONTAMINATION UNIT(S) SHALL BE CORDONED OFF AT A DISTANCE OF TWENTY-FIVE (25) FEET IN ALL DIRECTIONS TO SEPARATE IT FROM PUBLIC AREAS. THE CONTRACTOR SHALL ESTABLISH, MARK, AND MAINTAIN PROPER EXITS WITHIN EACH WORK AREA FOR NORMAL AND EMERGENCY USE AND MAINTAIN A CLEAR EGRESS PATH.
- F ALL TOOLS AND EQUIPMENT SHALL BE REMOVED FROM SITE AFTER DECONTAMINATION.
- G AFTER ALL REGULATED AREAS HAS PASSED FINAL AIR CLEARANCE AND PASSED FINAL INSPECTION, THE REGULATED AREAS CAN BE DISMANTLED. ANY REMOTE OR ATTACHED DECONTAMINATION CHAMBERS MUST BE DISMANTLED AND REMOVED FROM SITE. AL PLASTIC SHEATHING, TAPE AND GLUE RESIDUE MUST BE REMOVED FROM THE WORK AREAS. ALL DAMAGED PEELING PAINT AND DAMAGED DRYWALL MUST BE RETURNED TO THEIR ORIGINAL CONDITION.
- H ALL WASTE GENERATED AS PART OF ASBESTOS PROJECT SHALL BE REMOVED FROM THE SITE WITHIN TEN (10) CALENDAR DAYS AFTER SUCCESSFUL COMPLETION OF ALL REGULATED WORK AREAS.
- I HIDDEN SUSPECT ASBESTOS CONTAINING MATERIALS MAYBE ENCOUNTER BEHIND WALL AND CHAUK BOARDS, MIRRORS, UNDER CABINETS, UNWINDENTS AND ABOVE HARD PLASTER CEILING AND BEHIND WET WALLS AND INSIDE EXTERIOR WALLS THAT MAY DEMOLISHED DURING RENOVATIONS. IF SUSPECTS ARE ASBESTOS CONTAINING THE CONTRACTOR SHALL STOP WORKING IMMEDIATELY AND CONTACT THE OWNER'S REPRESENTATIVE FOR ADDITIONAL INSTRUCTIONS.
- J ALL WASTE GENERATED AS PART OF THE ASBESTOS AND PCB WINDOW PHASE OF THE PROJECT SHALL BE LEGALLY DISPOSED OF AT USEPANY'S APPROVED LANDFILL OR WASTE FACILITY. ALL GENERATED WASTES REMOVED FROM THE WORK SITE SHALL BE PROPERLY DOCUMENTED WITH A WASTE MANIFEST. A COPY OF THE WASTE MANIFEST AND TRIP TICKET WILL BE GIVEN TO THE OWNER'S REPRESENTATIVE PRIOR TO THE WASTE CONTAINER LEAVING THE SITE. ALL WASTE SHALL BE PACKAGED, TRANSPORTED AND DISPOSED IN ACCORDANCE WITH LOCAL, STATE AND FEDERAL REGULATIONS.

**# ABATEMENT PLAN DRAWING NOTES:**


- AB1 REMOVE ACM VAPOR BARRIER IN ITS ENTIRETY INCLUDING THE WOODEN FLOOR UTILIZING FULL ENCLOSURE WITH NEGATIVE AIR. ALL WOODEN MATERIALS WITHOUT ASBESTOS CONTAINING MASTICS MAY BE DISPOSED OF AS CONSTRUCTION DEBRIS. THE VAPOR BARRIER AND ASBESTOS CONTAMINATED WOOD OR METAL FOUND ATTACHED OR ADHERED TO THE VAPOR BARRIER MUST BE DISPOSED OF ASBESTOS WASTE.
- AB2 REMOVE AND DISPOSE OF ALL ASBESTOS CONTAINING EXTERIOR WINDOW CAULK UTILIZING CRITICAL BARRIERS ON THE INSIDE OF THE WINDOWS.
- AB3 REMOVE THE ENTIRE CEILING SYSTEM, INCLUDING THE ASBESTOS CONTAMINATED ON CEILING TILE, ASBESTOS CONTAINING MASTIC, AND ASBESTOS CONTAMINATED MASTICS FROM THE CEILING UTILIZING FULL ENCLOSURE WITH NEGATIVE AIR. DISPOSE OF ALL MATERIALS AS ASBESTOS WASTE.
- AB4 REMOVE ALL ASBESTOS CONTAINING ELBOW AND JOINT INSULATION FROM ABOVE CEILING AND INSIDE WALLS IN ACCORDANCE WITH INDUSTRIAL CODE RULE 56.
- AB5 REMOVE APPROXIMATELY 3 SQFT OF CEILING TILE, GLUE DOTS AND PLASTER BOARD, WHERE INDICATED.

**# HAZARDOUS MATERIAL PLAN DRAWING NOTES:**

- P1 REMOVE ALL EXTERIOR PCB CONTAINING WINDOW CAULK.
- P2 REMOVAL MUST BE COMPLETED BY WORKERS THAT ARE 40 HOUR HAZARDOUS WORKER TRAINED AND CERTIFIED.
- P3 DISPOSAL OF CAULK IN ACCORDANCE WITH THE REQUIREMENTS OF 40CFR761.3, 761.20(A) AND 761.62.

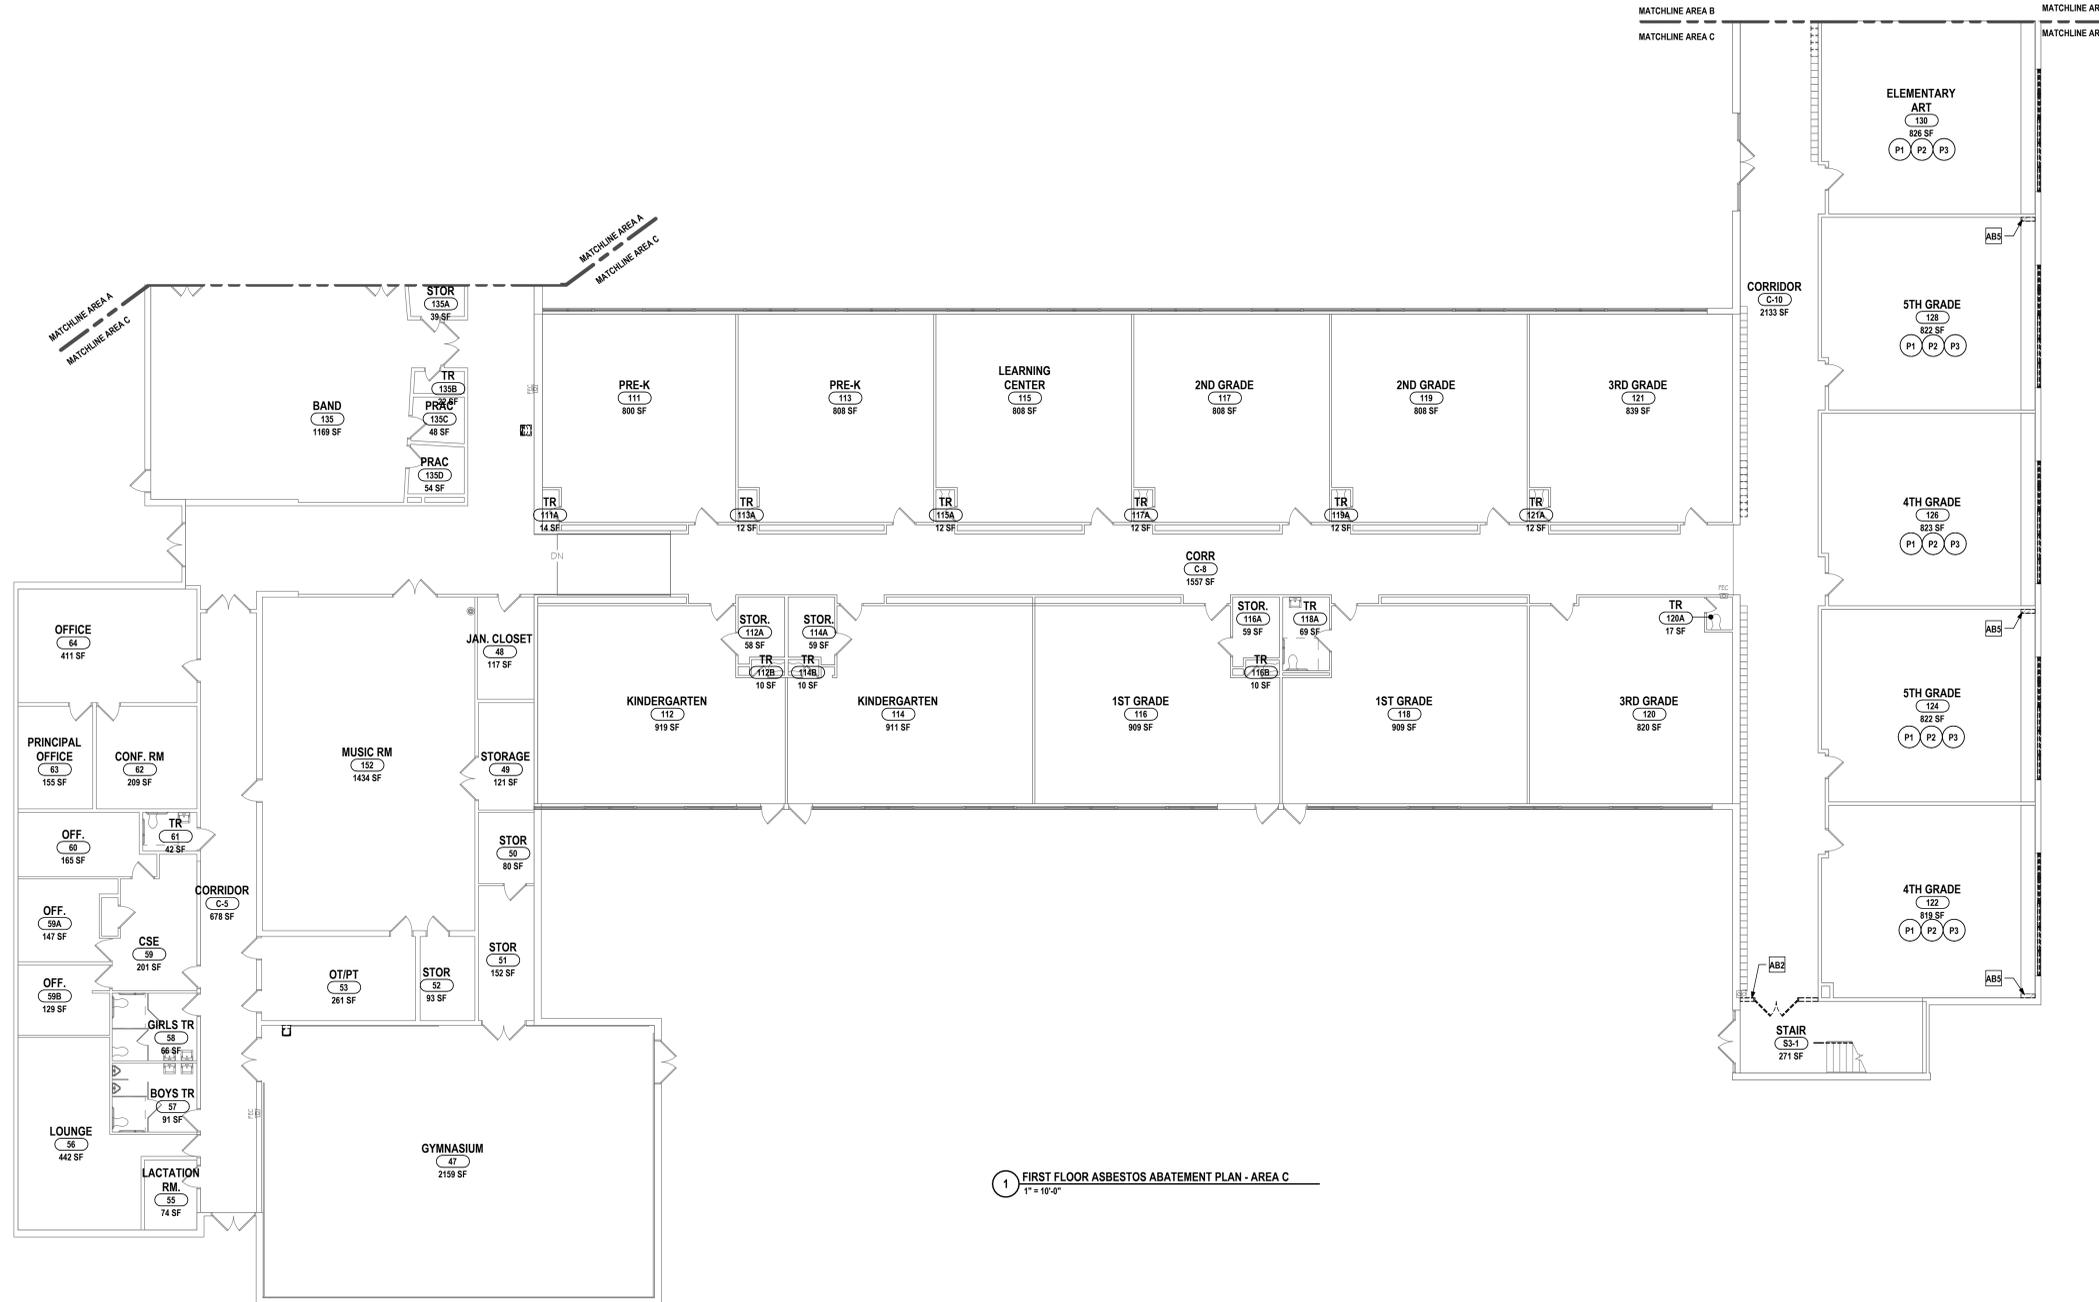

1 FIRST FLOOR ASBESTOS ABATEMENT PLAN - AREA C  
1" = 10'-0"

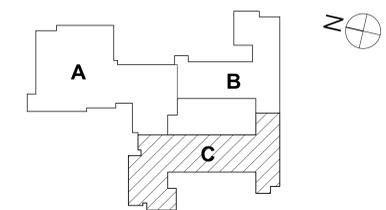

DRAWN BY:	TSK
	JJ
CHECKED BY:	JJ
DATE:	10/27/2025
PHASE:	CD
DESCRIPTION OF REVISION:	
#	DATE
1	10/10/2025
ISSUE FOR BID	

**HUNT ENGINEERS ARCHITECTS | SURVEYORS**  
 HORSEHEADS, NY 807-358-1008  
 ROSCHESTER, NY 562-337-7500  
 BINGHAMTON, NY 607-738-8881  
 WWW.HUNTEAS.COM  
 NY CERTIFICATE NO. 0016250 PA CERTIFICATE NO. TSC22020131464-1

**FIRST FLOOR PCB PLAN - AREA C**  
**2025 CAPITAL IMPROVEMENTS PROJECT**  
**HAMMONDSPORT CENTRAL SCHOOL DISTRICT**  
 8272 MAIN STREET HAMMONDSPORT, NEW YORK, 14840

**MB-AB1.3**  
 PROJECT NO. 1925.014

SED #: MB-5728-01-04-02-02510; 5729-01-04-5-005-008

THIS IS A PORTION OF THE MAP FOR ANY PERSON TO MAKE UNAUTHORIZED ALTERATIONS OR ADDITIONS TO THIS DRAWING. LICENSED ENGINEER, PROJECT NO. 2025-0001



**GENERAL ASBESTOS ABATEMENT NOTES:**


- A REFER TO ASBESTOS ABATEMENT SPECIFICATION FOR ADDITIONAL INFORMATION.
- B ALL WORK IS TO COMPLY WITH APPLICABLE CODE WITHIN JURISDICTION OR HIGHER. SITE SPECIFIC VARIANCES MAY BE IMPLEMENTED IF APPROVED BY THE ARCHITECT.
- C ASBESTOS SURVEY WAS COMPLETED; THE REPORT IS PART OF THE CONTRACT DOCUMENTS.
- D THE REGULATED ABATEMENT WORK AREA SHALL BE VACATED BY THE OCCUPANTS AND NON-CERTIFIED PERSONNEL PRIOR TO WORK AREA PREPARATION, AND SHALL REMAIN VACATED UNTIL THE ASBESTOS PROJECT IS COMPLETE.
- E THE PERSONAL AND WASTE DECONTAMINATION SYSTEM ENCLOSURE(S) SHALL BE PROVIDED OUTSIDE THE REGULATED ABATEMENT WORK AREA AND ATTACHED TO THE BUILDING AT ENTRY/EXIT LOCATIONS. THESE LOCATIONS SHALL BE REVIEWED AND APPROVED BY THE OWNER/OWNER'S REPRESENTATIVE PRIOR TO COMMENCEMENT OF WORK. THE DECONTAMINATION UNIT(S) SHALL BE CORDONED OFF AT A DISTANCE OF TWENTY-FIVE (25) FEET IN ALL DIRECTIONS TO SEPARATE IT FROM PUBLIC AREAS. THE CONTRACTOR SHALL ESTABLISH, MARK, AND MAINTAIN PROPER EXITS WITHIN EACH WORK AREA FOR NORMAL AND EMERGENCY USE AND MAINTAIN A CLEAR EGRESS PATH.
- F ALL TOOLS AND EQUIPMENT SHALL BE REMOVED FROM SITE AFTER DECONTAMINATION.
- G AFTER ALL REGULATED AREAS HAS PASSED FINAL AIR CLEARANCE AND PASSED FINAL INSPECTION, THE REGULATED AREAS CAN BE DISMANTLED. ANY REMOTE OR ATTACHED DECONTAMINATION CHAMBERS MUST BE DISMANTLED AND REMOVED FROM SITE. ALL PLASTIC SHEATHING, TAPE AND GLUE RESIDUE MUST BE REMOVED FROM THE WORK AREAS. ALL DAMAGED PEELING PAINT AND DAMAGED DRYWALL MUST BE RETURNED TO THEIR ORIGINAL CONDITION.
- H ALL WASTE GENERATED AS PART OF ASBESTOS PROJECT SHALL BE REMOVED FROM THE SITE WITHIN TEN (10) CALENDAR DAYS AFTER SUCCESSFUL COMPLETION OF ALL REGULATED WORK AREAS.
- I HIDDEN SUSPECT ASBESTOS CONTAINING MATERIALS MAYBE ENCOUNTER BEHIND WALL AND CHAUK BOARDS, MIRRORS, UNDER CABINETS, UNINVENTS AND ABOVE HARD PLASTER CEILING AND BEHIND WET WALLS AND INSIDE EXTERIOR WALLS THAT MAY DEMOLISHED DURING RENOVATIONS. IF SUSPECTS ARE ASBESTOS CONTAINING THE CONTRACTOR SHALL STOP WORKING IMMEDIATELY AND CONTACT THE OWNER 'S REPRESENTATIVE FOR ADDITIONAL INSTRUCTIONS.
- J ALL WASTE GENERATED AS PART OF THE ASBESTOS AND PCB WINDOW PHASE OF THE PROJECT SHALL BE LEGALLY DISPOSED OF AT USEPANY'S APPROVED LANDFILL OR WASTE FACILITY. ALL GENERATED WASTES REMOVED FROM THE WORK SITE SHALL BE PROPERLY DOCUMENTED WITH A WASTE MANIFEST. A COPY OF THE WASTE MANIFEST AND TRIP TICKET WILL BE GIVEN TO THE OWNER 'S REPRESENTATIVE PRIOR TO THE WASTE CONTAINER LEAVING THE SITE. ALL WASTE SHALL BE PACKAGED, TRANSPORTED AND DISPOSED IN ACCORDANCE WITH LOCAL, STATE AND FEDERAL REGULATIONS.

**# ABATEMENT PLAN DRAWING NOTES:**


- AB1 REMOVE ACM VAPOR BARRIER IN ITS ENTIRETY INCLUDING THE WOODEN FLOOR UTILIZING FULL ENCLOSURE WITH NEGATIVE AIR. ALL WOODEN MATERIALS WITHOUT ASBESTOS CONTAINING MASTICS MAY BE DISPOSED OF AS CONSTRUCTION DEBRIS. THE VAPOR BARRIER AND ASBESTOS CONTAMINATED WOOD OR METAL FOUND ATTACHED OR ADHERED TO THE VAPOR BARRIER MUST BE DISPOSED OF ASBESTOS WASTE.
- AB2 REMOVE AND DISPOSE OF ALL ASBESTOS CONTAINING EXTERIOR WINDOW CAULK UTILIZING CRITICAL BARRIERS ON THE INSIDE OF THE WINDOWS.
- AB3 REMOVE THE ENTIRE CEILING SYSTEM, INCLUDING THE ASBESTOS CONTAMINATED ON CEILING TILE, ASBESTOS CONTAINING MASTIC, AND ASBESTOS CONTAMINATED MASTICS FROM THE CEILING UTILIZING FULL ENCLOSURE WITH NEGATIVE AIR. DISPOSE OF ALL MATERIALS AS ASBESTOS WASTE.
- AB4 REMOVE ALL ASBESTOS CONTAINING ELBOW AND JOINT INSULATION FROM ABOVE CEILING AND INSIDE WALLS. IN ACCORDANCE WITH INDUSTRIAL CODE RULE 56.
- AB5 REMOVE APPROXIMATELY 3 SQFT OF CEILING TILE, GLUE DOTS AND PLASTER BOARD, WHERE INDICATED.

**# HAZARDOUS MATERIAL PLAN DRAWING NOTES:**

- P1 REMOVE ALL EXTERIOR PCB CONTAINING WINDOW CAULK.
- P2 REMOVAL MUST BE COMPLETED BY WORKERS THAT ARE 40 HOUR HAZARDOUS WORKER TRAINED AND CERTIFIED.
- P3 DISPOSAL OF CAULK IN ACCORDANCE WITH THE REQUIREMENTS OF 40CFR761.3, 761.20(A) AND 761.62.

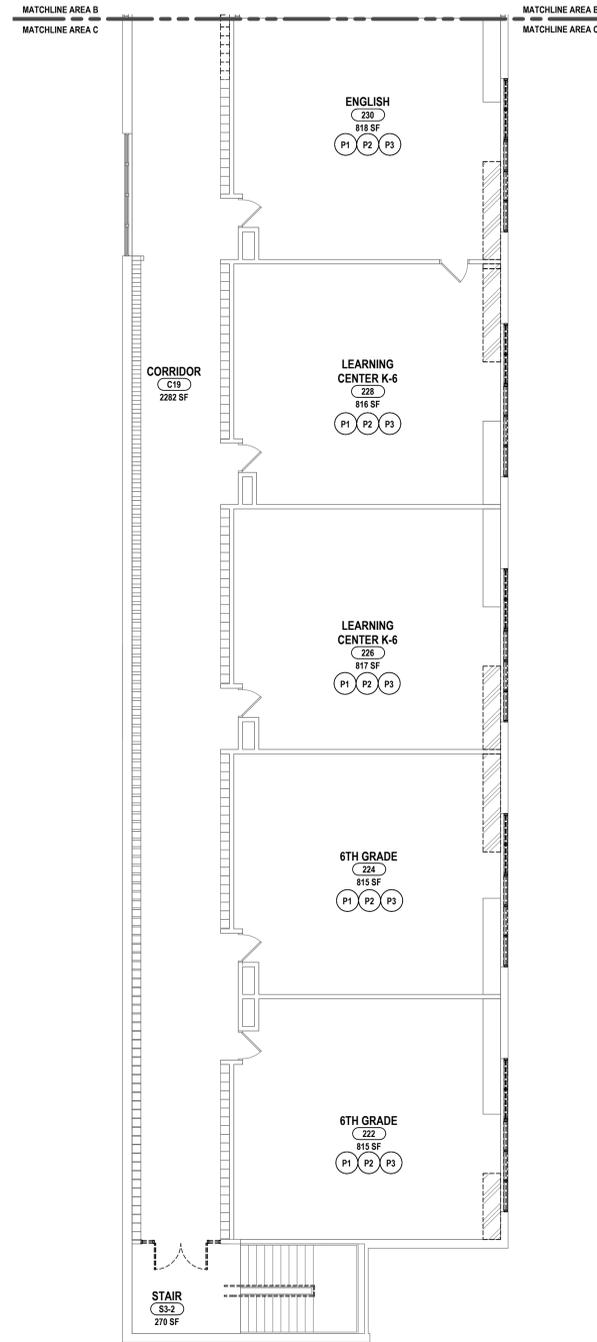

1 SECOND FLOOR ASBESTOS ABATEMENT PLAN - AREA C  
1/8" = 1'-0"

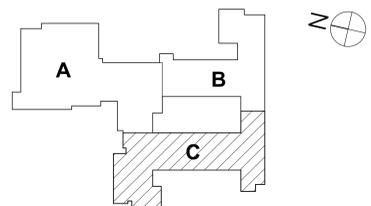

KEY PLAN

#	DATE	DESCRIPTION OF REVISION	ISSUE FOR BID
1	10/10/2025		

DRAWN BY:	TSH
CHECKED BY:	JL
DATE:	10/27/2025
PHASE:	CD

IT IS A VIOLATION OF THE LAW FOR ANY PERSON TO MAKE UNAUTHORIZED ALTERATIONS OR ADDITIONS TO PLANS DRAWING NO. 2025-0144-02-025-010. ENGINEER, ARCHITECT, SURVEYOR'S SEAL.

**HUNT ENGINEERS | ARCHITECTS | SURVEYORS**  
 HORSEHEADS, NY 607-456-1000    ROCKY HILLS, NY 860-307-7600    TOWANDA, PA 570-265-4668  
 BINGHAMTON, NY 607-798-8881    ALBANY, NY 607-798-8881  
 WWW.HUNTEAS.COM  
 NY CERTIFICATE NO. 0016250    PA CERTIFICATE NO. TSC22020131464-1

SECOND FLOOR PCB PLAN - AREA C  
 2025 CAPITAL IMPROVEMENTS PROJECT  
 HAMMONDSPORT CENTRAL SCHOOL DISTRICT  
 8272 MAIN STREET HAMMONDSPORT, NEW YORK, 14840

**MB-AB1.5**  
 PROJECT NO: 1925.014


SED #: MB-5728-01-04-02-025-010; 5728-01-04-04-003-008

**GENERAL DEMO NOTES:**


- A ASBESTOS CONTAINING MATERIALS HAVE BEEN IDENTIFIED AS PART OF THIS PROJECT. THE OWNER HAS REPORTS IDENTIFYING ACM MATERIALS AND WILL HAVE THESE AVAILABLE FOR CONTRACTORS REFERENCE. IF SUSPECT MATERIAL NOT SCHEDULED IS ENCOUNTERED, STOP WORK IMMEDIATELY. DO NOT DISTURB THE MATERIAL AND NOTIFY THE OWNER'S REPRESENTATIVES.
- B CONTRACTOR TO PROVIDE PROTECTIVE BARRIER AT ALL AREAS OF DEMOLITION. KEEP ALL EXITS FREE AND CLEAR AT ALL TIMES DURING FACILITY OPERATIONS.
- C THE OWNER RESERVES THE RIGHT TO RETAIN ANY REMOVED ITEMS AFTER CONTRACTOR REMOVAL. THE CONTRACTOR SHALL REMOVE FROM THE SITE AND DISPOSE OF ALL REMOVED ITEMS THE OWNER DOES NOT WISH TO RETAIN.
- D CONTRACTOR SHALL PROTECT EXISTING CONSTRUCTION TO REMAIN AS REQUIRED DURING DEMOLITION. PATCH, REPAIR, PAINT OR RE-FINISH EXISTING CONSTRUCTION MATERIALS AND FINISHES DAMAGED DURING DEMOLITION TO THEIR ORIGINAL CONDITION.
- E CONTRACTOR TO COORDINATE THE WORK OF THIS CONTRACT WITH THE WORK OF ALL OTHER CONTRACTED WORK AND WORK PERFORMED BY THE OWNER.
- F DIMENSIONS SHOWN FOR ALL NEW OPENINGS IN EXISTING CONSTRUCTION SHOULD BE COORDINATED WITH THE NEW PLANS AND EXISTING CONDITIONS IN THE FIELD.
- G ITEMS SHOWN ARE INTENDED TO GIVE APPROXIMATE QUANTITY, LOCATION AND TYPE. CONTRACTOR IS RESPONSIBLE FOR VERIFYING ACTUAL QUANTITIES AND EXISTING FIELD CONDITIONS IN ORDER TO COMPLETE THE WORK.
- H COORDINATE ANY WALL/FLOOR REPAIR/FILL THAT IS CAUSED BY THE REMOVAL OF EQUIPMENT BY OTHER PRIME CONTRACTORS AND PREPARE SURFACE TO RECEIVE NEW FINISHES.
- I REMOVE EXISTING WOOD BLOCKING FOR EXISTING WALL MOUNTED EQUIPMENT AND/OR DEVICES THAT INTERFERE WITH NEW WORK OR NEW ROOM FINISHES AND WALL TREATMENTS. TYPICAL FOR ALL AREAS.
- J MAINTAIN EXISTING STRUCTURAL SYSTEMS AT ALL TIMES. PROVIDE TEMPORARY SHORING AND BRACING AT LOCATIONS WHERE THE EXISTING STRUCTURE IS BEING MODIFIED. PROTECT THE EXISTING STRUCTURE SCHEDULED TO REMAIN FROM DAMAGE DURING DEMOLITION. MAINTAIN SHORING AND BRACING UNTIL THE NEW STRUCTURE IS INSTALLED AND READY TO ACCEPT LOADS.
- K GRINDING OF CONCRETE FLOORS AND SUBSTRATES OF DIFFERENT HEIGHTS IN THE SAME AREA IS REQUIRED AT WALL REMOVALS AND NEW DOORS IN EXISTING WALLS TO ALLOW THE NEW FINISHES TO ALIGN BETWEEN ADJACENT ROOMS AND ADJACENT ROOMS THAT BECOME ONE ROOM.
- L ROOM NUMBERS INDICATED ARE EXISTING BUILDING NUMBERS. REFER TO NEW FLOOR PLANS FOR NEW ROOM NUMBERING (SERIES A-I DRAWINGS).
- M EXISTING BRICK VENEER SCHEDULED FOR DEMOLITION IS TO BE REMOVED WITH CARE, SALVAGED, CLEANED AND STORED FOR RE-USE (TOOTH-N-PATCHING) IN DIFFERENT LOCATIONS OF THE BUILDING AS REQUIRED.

**DEMOLITION NOTES:**

- D1 REMOVE STUD PARTITION COMPLETELY UP TO EXISTING DECK OR STRUCTURE ABOVE TO EXTENTS SHOWN ON PLAN. DEMOLITION TO INCLUDE BASE, DOORS, FRAMES GLAZING AND ALL WALL MOUNTED/RECESSED ACCESSORIES, CASEWORK AND EQUIPMENT. REPAIR DAMAGED WALLS, FLOORING, AND ADJACENT SURFACES SCHEDULED TO REMAIN IN PLACE AFTER DEMOLITION. PREPARE FOR NEW FINISHES.
- D2 REMOVE MASONRY PARTITIONS COMPLETELY UP TO EXISTING DECK OR STRUCTURE ABOVE TO EXTENTS SHOWN ON PLAN. DEMOLITION TO INCLUDE BASE, DOORS, FRAMES, GLAZING AND WALL MOUNTED/RECESSED ACCESSORIES, CASEWORK AND EQUIPMENT. REPAIR DAMAGED WALLS, FLOORING, AND ADJACENT SURFACES SCHEDULED TO REMAIN IN PLACE AFTER DEMOLITION. PREPARE FOR NEW FINISHES.
- D3 PROVIDE NEW OPENING IN MASONRY WALL FOR NEW PASSAGE, DOOR/WINDOW FRAME, BLOCKING, LINTEL OR STEEL COLUMN. REFER TO LINTEL SCHEDULE FOR SIZE AND TYPE. REPAIR DAMAGED WALL AND FLOOR SURFACES TO RECEIVE NEW FINISHES.
- D4 PROVIDE NEW OPENING IN STUD PARTITION WALL FOR NEW PASSAGE, DOOR/WINDOW FRAME, BLOCKING, OR STEEL COLUMN.
- D5 REMOVE DOOR, FRAME, AND HARDWARE IN THEIR ENTIRETY TO EXTENTS SHOWN ON PLAN. REPAIR DAMAGED SURFACES SCHEDULED TO REMAIN IN PLACE TO MATCH EXISTING CONSTRUCTION AND PREPARE SURFACES TO RECEIVE NEW FINISHES.
- D6 REMOVE WINDOW, FRAME, HARDWARE, AND WINDOW TREATMENT SYSTEMS IN THEIR ENTIRETY. REPAIR DAMAGED SURFACES SCHEDULED TO REMAIN IN PLACE TO MATCH EXISTING CONSTRUCTION AND PREPARE SURFACES TO RECEIVE NEW FINISHES. REFER TO "AB" DRAWINGS FOR ADDITIONAL INFORMATION.
- D7 REMOVE GYM FLOOR SYSTEM IN ITS ENTIRETY. PREPARE FOR NEW GYM FLOOR SYSTEM.
- D8 REMOVE TOILET PARTITIONS, ASSOCIATED BRACING, ACCESSORIES AND ALL WALL MOUNTED ITEMS INCLUDING, BUT NOT LIMITED TO MIRRORS, SOAP DISPENSERS, GRAB BARS, ETC. PREPARE FLOOR AND WALL SURFACES FOR NEW FINISHES.
- D9 REMOVE LOCKERS, BASE AND ASSOCIATED ACCESSORIES IN THEIR ENTIRETY. REPAIR DAMAGED WALL AND FLOOR SURFACES TO RECEIVE NEW FINISHES.
- D10 REMOVE SUSPENDED CEILING SYSTEMS AND SOFFITS IN THEIR ENTIRETY. REPAIR DAMAGED WALL SCHEDULED TO REMAIN IN PLACE. PREPARE SURFACES TO RECEIVE NEW FINISHES.
- D11 REMOVE ADHERED CEILING TILE, SOFFIT, CLOUD CEILING AND FRAMING SYSTEMS IN THEIR ENTIRETY. REPAIR DAMAGED WALL SCHEDULED TO REMAIN IN PLACE. PREPARE SURFACES TO RECEIVE NEW FINISHES.
- D12 REMOVE BUILT-IN CASEWORK/SHELVING UNITS, MARKER/DISPLAY BOARDS, MIRRORS AND WALL MOUNTED ACCESSORIES IN THEIR ENTIRETY. REPAIR DAMAGED WALL SCHEDULED TO REMAIN IN PLACE. PREPARE CONCRETE SLAB TO RECEIVE NEW FINISHES.
- D13 REMOVE CARPET FLOORING IN ITS ENTIRETY. REPAIR DAMAGED SURFACES SCHEDULED TO REMAIN IN PLACE. PREPARE CONCRETE SLAB TO RECEIVE NEW FINISHES.
- D14 REMOVE VCT FLOORING IN ITS ENTIRETY. PREPARE EXISTING CONCRETE SLAB FOR NEW FLOORING. D15 NOT USED
- D16 REMOVE PORCELAIN FLOOR TILE BASE AND MORTAR BED IN THEIR ENTIRETY. PREPARE EXISTING CONCRETE SLAB TO RECEIVE NEW FINISHES.
- D17 REMOVE CERAMIC FLOOR TILE BASE AND MORTAR BED IN THEIR ENTIRETY. PREPARE EXISTING CONCRETE SLAB TO RECEIVE NEW FINISHES.
- D18 MODIFY MILLWORK WHERE SPECIFIED AS REQUIRED.
- D19 REMOVE PORTION OF EXISTING WALL AS REQUIRED TO ACCOMMODATE UV REPLACEMENT.
- D20 REMOVE SLIDING DOOR, FRAME, AND HARDWARE IN THEIR ENTIRETY TO EXTENTS SHOWN ON PLAN. REPLACE WITH NEW DOOR. SEE DOOR SCHEDULE.
- D21 REMOVE DRINKING FOUNTAIN AND REPLACE WITH NEW FIXTURE BY PLUMBING CONTRACTOR. REFER TO PLUMBING DRAWINGS. GENERAL CONTRACTOR TO REPAIR FINISHES AS REQUIRED.
- D22 REMOVE ASSOCIATED ITEMS AS REQUIRED TO PREPARE FOR NEW ELEVATOR MODERNIZATION. REFER TO SPECIFICATION SECTION 14 28 19.
- D23 REMOVE WALL PADS AND ASSOCIATED BLOCKING/HANGING SYSTEM IN ITS ENTIRETY FROM THE EXISTING WALL SYSTEM. REPAIR DAMAGED SURFACES SCHEDULED TO REMAIN IN PLACE TO MATCH EXISTING CONSTRUCTION.
- D24 REMOVE ALL WALL MOUNTED TECTUM ACOUSTIC PANELS AND ASSOCIATED ACCESSORIES IN THEIR ENTIRETY.
- D25 REMOVE BLEACHERS, MOTORS AND ALL ACCESSORIES IN THEIR ENTIRETY.
- D26 REMOVE EXISTING RUBBER FLOORING IN ITS ENTIRETY. PREPARE EXISTING CONCRETE SLAB TO RECEIVE NEW FINISHES.
- D27 REMOVE FREEZERS AND COOLERS IN THEIR ENTIRETY.
- D28 REMOVE ALL FLOORING FINISH DOWN TO CONCRETE SLAB. PREPARE FOR NEW FINISHES.
- D29 REMOVE LOADING DOCK BUMPER SYSTEM AND ALL ASSOCIATED ACCESSORIES.
- D30 REMOVE OVERHEAD SECTIONAL DOOR.
- D31 DEMOLISH ALL FINISHES DOWN TO STRUCTURE. PREPARE FOR NEW FINISHES.
- D32 REMOVE WALL FINISHES AND INSTALL BLOCKING FOR NEW WALL MOUNTED WATER FOUNTAIN. PREPARE NEW FINISHES.
- D33 REMOVE STAIR AND LANDING IN ITS ENTIRETY.
- D34 REMOVE ALL BUILT-IN WALL CABINETS/SHELVING UNITS AND WALL MOUNTED ACCESSORIES IN THEIR ENTIRETY. REPAIR DAMAGED WALL SCHEDULED TO REMAIN IN PLACE. PREPARE SURFACES TO RECEIVE NEW FINISHES.
- D35 REMOVE BILCO DOOR.
- D36 REMOVE CORRIDOR CEILING AND FLOORING TO EXTENTS SHOWN; MODIFY EXISTING CORRIDOR CEILING AND FLOORING TO RECEIVE NEW FINISHES.
- D37 REMOVE PORTIONS OF WINDOW AFTER DAMAGE IS ACCESSED. REMOVE SURROUNDING WALL SURFACE WHERE DAMAGE OCCURS.
- D38 PREPARE FLOOR FOR EXPANDED POLYSTYRENE INFILL.
- D39 REMOVE FIRE EXTINGUISHER CABINET. SALVAGE EXISTING EXTINGUISHER AND ASSOCIATED ACCESSORIES FOR REUSE; REMOVE WALL FINISHES AND PREPARE FOR NEW FINISHES.
- D40 REMOVE ISLAND BENCHES. STORE FOR REINSTALLATION.
- D41 ABATEMENT CONTRACTOR TO REMOVE ADHERED CEILING TILE GLUE/MASTIC. GYPSUM SOFFITS AND ALL SUPPORT SYSTEMS IN THEIR ENTIRETY. REPAIR DAMAGED WALL SURFACES SCHEDULED TO REMAIN IN PLACE. PREPARE SURFACES TO RECEIVE NEW FINISHES.
- D42 REMOVE A PORTION OF UV METAL SHELVING, AND COUNTERTOP. REPAIR DAMAGED WALL SCHEDULED TO REMAIN IN PLACE. PREPARE SURFACES TO RECEIVE NEW FINISHES.
- D43 PARTIALLY REMOVE AND REINSTALL METAL MILLWORK FOR PIPING BY MC.
- D44 REMOVE ALL EXISTING WALL TILE FINISH. PROVIDE NEW CEMENTIOUS BACKER BOARD FOR NEW TILE FINISH.
- D45 REMOVE PORTION OF FLOOR WHERE SPECIFIED FOR ELEVATOR MODERNIZATION SCOPE.
- D46 REMOVE PORTION OF EXISTING FLOOR SLAB FOR TRENCHING. SEE "P" DWGS FOR ADDITIONAL INFORMATION.
- D47 REMOVE MOTORIZED CURTAIN IN ITS ENTIRETY. REFER TO "E" DWGS FOR MORE INFORMATION.

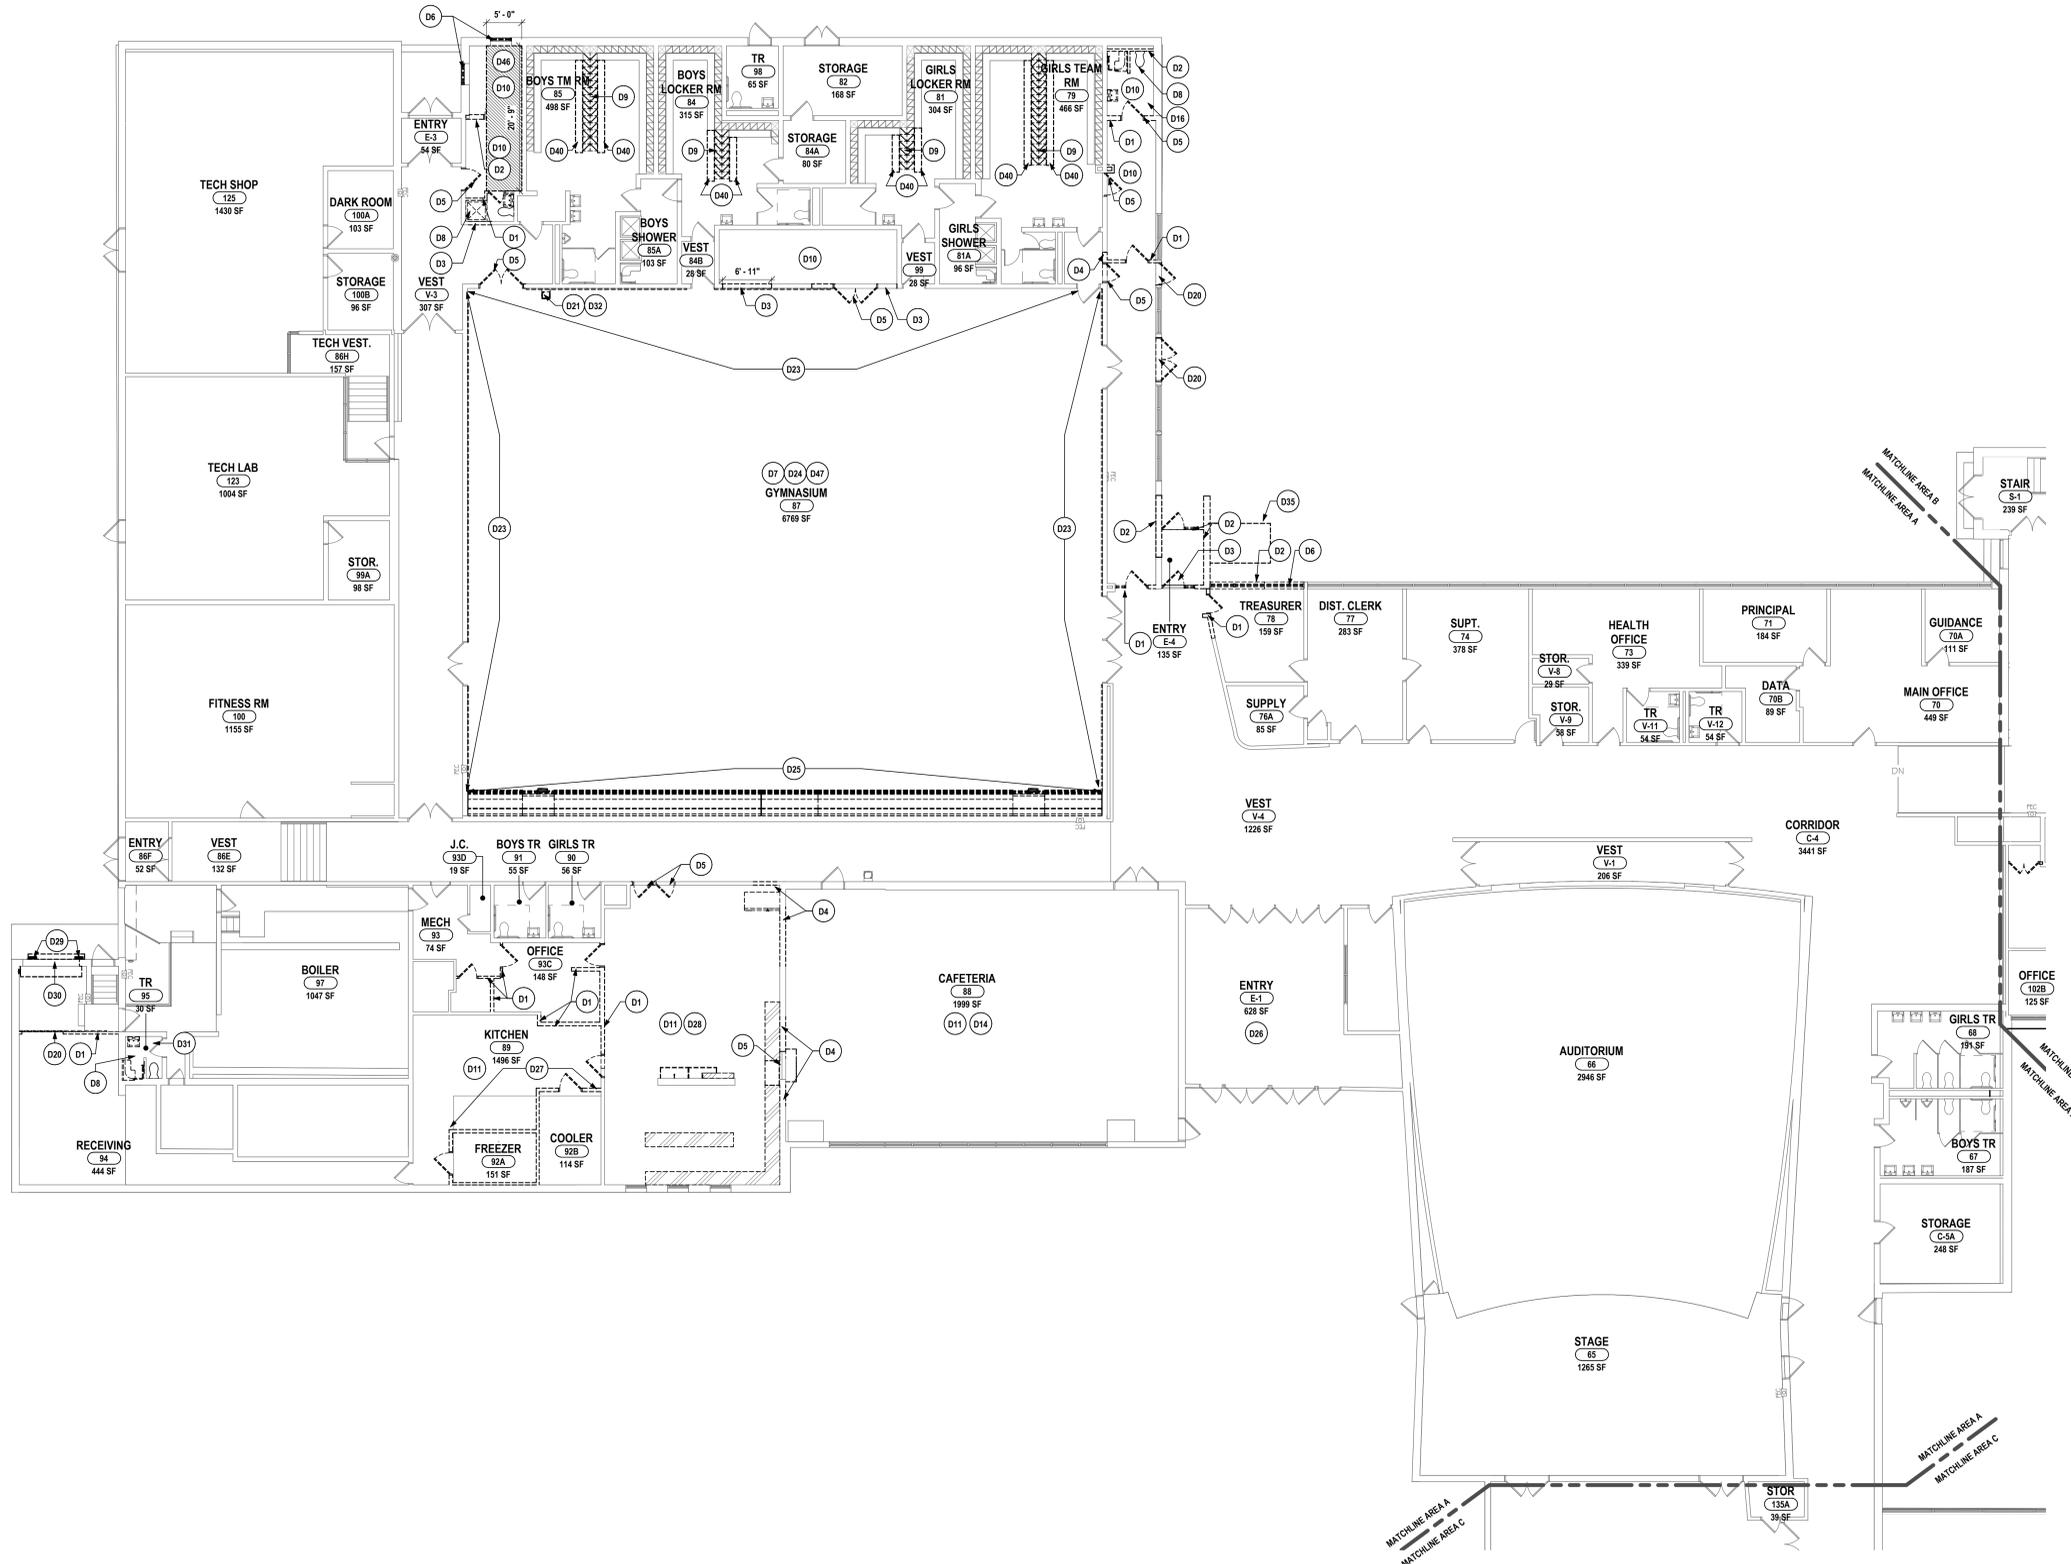

1 FIRST FLOOR DEMO PLAN - AREA A  
1" = 10'-0"

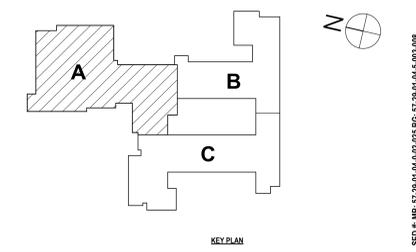

KEY PLAN

FIRST FLOOR DEMO PLAN - AREA A  
2025 CAPITAL IMPROVEMENTS PROJECT  
HAMMONDSPORT CENTRAL SCHOOL DISTRICT  
8272 MAIN STREET HAMMONDSPORT, NEW YORK, 14840

MB-A0.1  
PROJECT NO: 1925.014


HUNT ENGINEERS ARCHITECTS | SURVEYORS  
HORSEHEADS, NY 607-268-4008  
ROCKY HILLS, CT 860-888-8888  
BINGHAMTON, NY 607-798-8881  
ALBANY, NY 607-798-4801  
WWW.HUNT-EAS.COM  
NY CERTIFICATE NO. 0016250 PA CERTIFICATE NO. TSC2020131464-1

DESCRIPTION OF REVISION:  
1 10/27/2025  
ISSUE FOR BID

DRAWN BY: KLC  
CHECKED BY: JJ  
DATE: 10/27/2025  
PHASE: CD

ASBESTOS CONTAINING MATERIALS HAVE BEEN IDENTIFIED AS PART OF THIS PROJECT. THE OWNER HAS REPORTS IDENTIFYING ACM MATERIALS AND WILL HAVE THESE AVAILABLE FOR CONTRACTORS REFERENCE. IF SUSPECT MATERIAL NOT SCHEDULED IS ENCOUNTERED, STOP WORK IMMEDIATELY. DO NOT DISTURB THE MATERIAL AND NOTIFY THE OWNER'S REPRESENTATIVES.



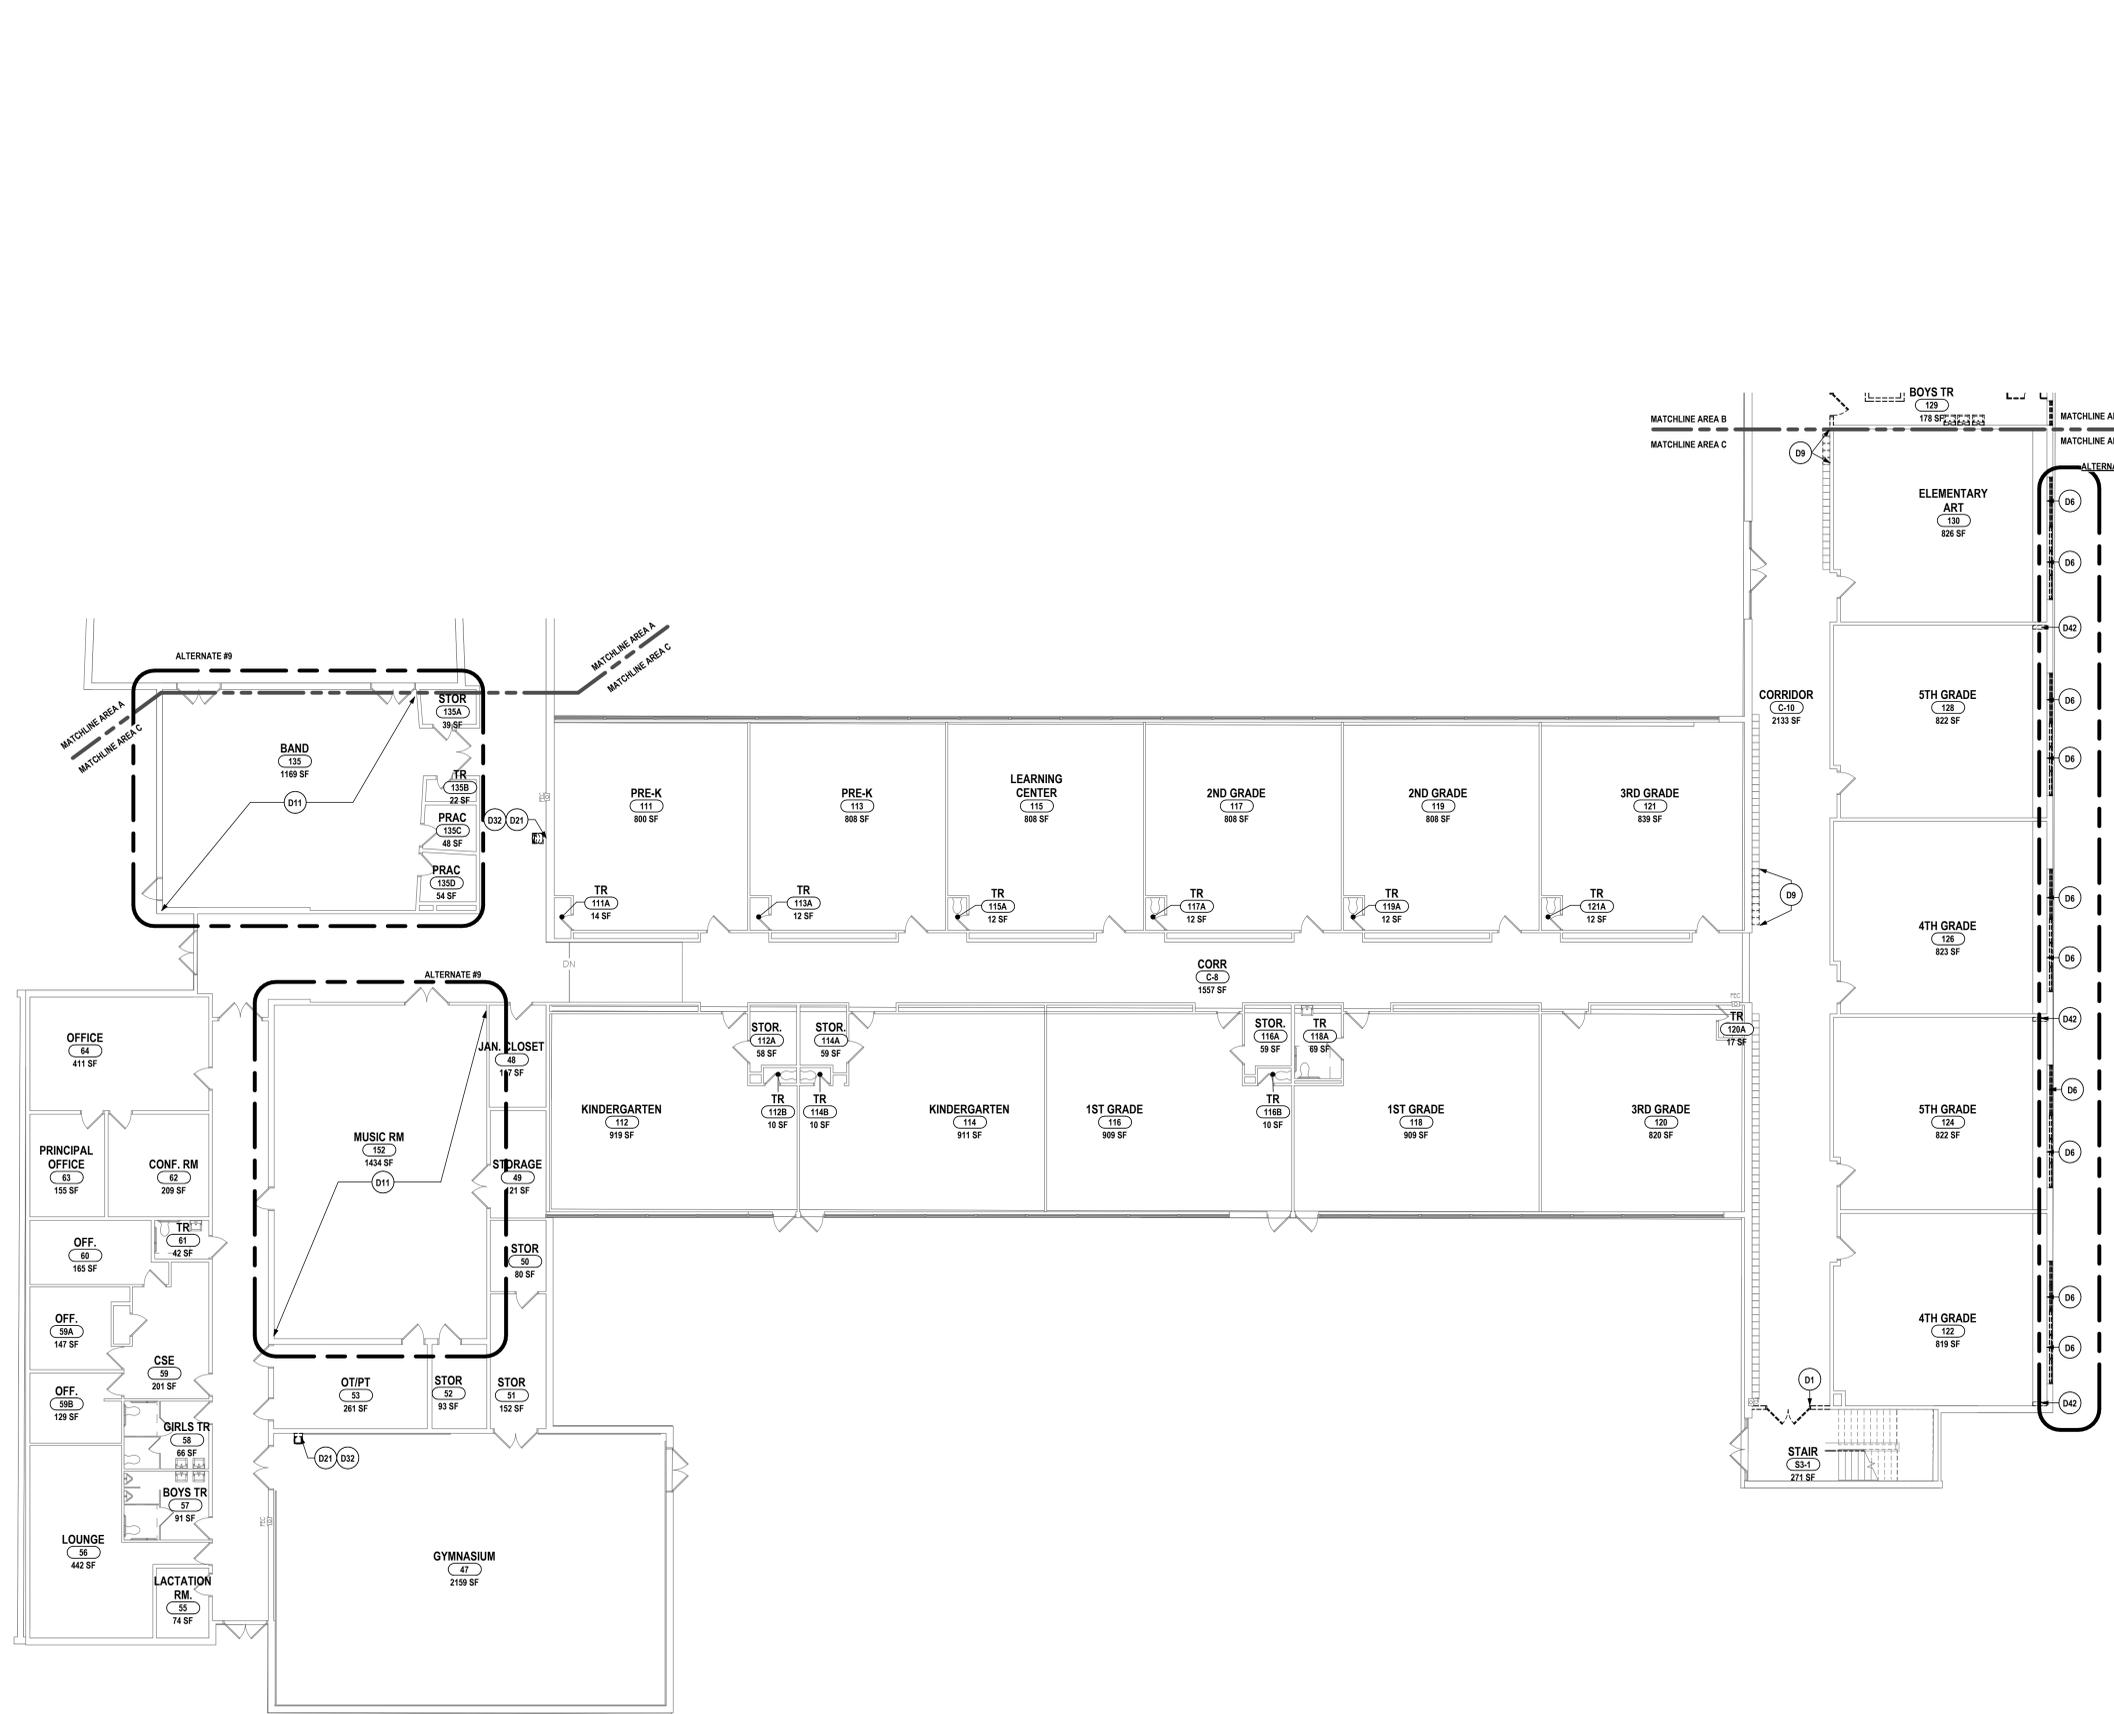

1 FIRST FLOOR DEMO PLAN - AREA C  
1" = 10'-0"

**GENERAL DEMO NOTES:**

- A ASBESTOS CONTAINING MATERIALS HAVE BEEN IDENTIFIED AS PART OF THIS PROJECT. THE OWNER HAS REPORTS IDENTIFYING ACM MATERIALS AND WILL HAVE THESE AVAILABLE FOR CONTRACTORS REFERENCE. IF SUSPECT MATERIAL NOT SCHEDULED IS ENCOUNTERED, STOP WORK IMMEDIATELY. DO NOT DISTURB THE MATERIAL AND NOTIFY THE OWNER'S REPRESENTATIVES.
- B CONTRACTOR TO PROVIDE PROTECTIVE BARRIER AT ALL AREAS OF DEMOLITION. KEEP ALL EXITS FREE AND CLEAR AT ALL TIMES DURING FACILITY OPERATIONS.
- C THE OWNER RESERVES THE RIGHT TO RETAIN ANY REMOVED ITEMS AFTER CONTRACTOR REMOVAL. THE CONTRACTOR SHALL REMOVE FROM THE SITE AND DISPOSE OF ALL REMOVED ITEMS THE OWNER DOES NOT WISH TO RETAIN.
- D CONTRACTOR SHALL PROTECT EXISTING CONSTRUCTION TO REMAIN AS REQUIRED DURING DEMOLITION. PATCH, REPAIR, PAINT OR RE-FINISH EXISTING CONSTRUCTION MATERIALS AND FINISHES DAMAGED DURING DEMOLITION TO THEIR ORIGINAL CONDITION.
- E CONTRACTOR TO COORDINATE THE WORK OF THIS CONTRACT WITH THE WORK OF ALL OTHER CONTRACTED WORK AND WORK PERFORMED BY THE OWNER.
- F DIMENSIONS SHOWN FOR ALL NEW OPENINGS IN EXISTING CONSTRUCTION SHOULD BE COORDINATED WITH THE NEW PLANS AND EXISTING CONDITIONS IN THE FIELD.
- G ITEMS SHOWN ARE INTENDED TO GIVE APPROXIMATE QUANTITY, LOCATION AND TYPE. CONTRACTOR IS RESPONSIBLE FOR VERIFYING ACTUAL QUANTITIES AND EXISTING FIELD CONDITIONS IN ORDER TO COMPLETE THE WORK.
- H COORDINATE ANY WALL/FLOOR REPAIR/FILL THAT IS CAUSED BY THE REMOVAL OF EQUIPMENT BY OTHER PRIME CONTRACTORS AND PREPARE SURFACE TO RECEIVE NEW FINISHES.
- I REMOVE EXISTING WOOD BLOCKING FOR EXISTING WALL MOUNTED EQUIPMENT AND/OR DEVICES THAT INTERFERE WITH NEW WORK OR NEW ROOM FINISHES AND WALL TREATMENTS. TYPICAL FOR ALL AREAS.
- J MAINTAIN EXISTING STRUCTURAL SYSTEMS AT ALL TIMES. PROVIDE TEMPORARY SHORING AND BRACING AT LOCATIONS WHERE THE EXISTING STRUCTURE IS BEING MODIFIED. PROTECT THE EXISTING STRUCTURE SCHEDULED TO REMAIN FROM DAMAGE DURING DEMOLITION. MAINTAIN SHORING AND BRACING UNTIL THE NEW STRUCTURE IS INSTALLED AND READY TO ACCEPT LOADS. GRINDING OF CONCRETE FLOORS AND SUBSTRATES OF DIFFERENT HEIGHTS IN THE SAME AREA IS REQUIRED AT WALL REMOVALS AND NEW DOORS IN EXISTING WALLS TO ALLOW THE NEW FINISHES TO ALIGN BETWEEN ADJACENT ROOMS AND ADJACENT ROOMS THAT BECOME ONE ROOM.
- L ROOM NUMBERS INDICATED ARE EXISTING BUILDING NUMBERS. REFER TO NEW FLOOR PLANS FOR NEW ROOM NUMBERING (SEE SERIES A - DRAWINGS).
- M EXISTING BRICK VENEER SCHEDULED FOR DEMOLITION IS TO BE REMOVED WITH CARE, SALVAGED, CLEANED AND STORED FOR RE-USE (TOOTH-IN PATCHING) IN DIFFERENT LOCATIONS OF THE BUILDING AS REQUIRED.

**DEMOLITION NOTES:**


- D1 REMOVE STUD PARTITION COMPLETELY UP TO EXISTING DECK OR STRUCTURE ABOVE TO EXTENTS SHOWN ON PLAN. DEMOLITION TO INCLUDE BASE, DOORS, FRAMES GLAZING AND ALL WALL MOUNTED/RECESSED ACCESSORIES, CASEWORK AND EQUIPMENT. REPAIR DAMAGED WALLS, FLOORING, AND ADJACENT SURFACES SCHEDULED TO REMAIN IN PLACE AFTER DEMOLITION. PREPARE FOR NEW FINISHES.
- D2 REMOVE MASONRY PARTITIONS COMPLETELY UP TO EXISTING DECK OR STRUCTURE ABOVE TO EXTENTS SHOWN ON PLAN. DEMOLITION TO INCLUDE BASE, DOORS, FRAMES, GLAZING AND WALL MOUNTED/RECESSED ACCESSORIES, CASEWORK AND EQUIPMENT. REPAIR DAMAGED WALLS, FLOORING, AND ADJACENT SURFACES SCHEDULED TO REMAIN IN PLACE AFTER DEMOLITION. PREPARE FOR NEW FINISHES.
- D3 PROVIDE NEW OPENING IN MASONRY WALL FOR NEW PASSAGE, DOOR/WINDOW FRAME, BLOCKING, LINTEL OR STEEL COLUMN. REFER TO LINTEL SCHEDULE FOR SIZE AND TYPE. REPAIR DAMAGED WALL AND FLOOR SURFACES TO RECEIVE NEW FINISHES.
- D4 PROVIDE NEW OPENING IN STUD PARTITION WALL FOR NEW PASSAGE, DOOR/WINDOW FRAME, BLOCKING, OR STEEL COLUMN.
- D5 REMOVE DOOR, FRAME, AND HARDWARE IN THEIR ENTIRETY TO EXTENTS SHOWN ON PLAN. REPAIR DAMAGED SURFACES SCHEDULED TO REMAIN IN PLACE TO MATCH EXISTING CONSTRUCTION AND PREPARE SURFACES TO RECEIVE NEW FINISHES.
- D6 REMOVE WINDOW, FRAME, HARDWARE, AND WINDOW TREATMENT SYSTEMS IN THEIR ENTIRETY. REPAIR DAMAGED SURFACES SCHEDULED TO REMAIN IN PLACE TO MATCH EXISTING CONSTRUCTION AND PREPARE SURFACES TO RECEIVE NEW FINISHES. REFER TO "AB" DRAWINGS FOR ADDITIONAL INFORMATION.
- D7 REMOVE GYM FLOOR SYSTEM IN ITS ENTIRETY. PREPARE FOR NEW GYM FLOOR SYSTEM.
- D8 REMOVE TOILET PARTITIONS, ASSOCIATED BRACING, ACCESSORIES AND ALL WALL MOUNTED ITEMS INCLUDING, BUT NOT LIMITED TO MIRRORS, SOAP DISPENSERS, GRAB BARS, ETC. PREPARE FLOOR AND WALL SURFACES FOR NEW FINISHES.
- D9 REMOVE LOCKERS, BASE AND ASSOCIATED ACCESSORIES IN THEIR ENTIRETY. REPAIR DAMAGED WALL AND FLOOR SURFACES TO RECEIVE NEW FINISHES.
- D10 REMOVE SUSPENDED CEILING SYSTEMS AND SOFFITS IN THEIR ENTIRETY. REPAIR DAMAGED WALL SCHEDULED TO REMAIN IN PLACE. PREPARE SURFACES TO RECEIVE NEW FINISHES.
- D11 REMOVE ADHERED CEILING TILE, SOFFIT, CLOUD CEILING AND FRAMING SYSTEM IN THEIR ENTIRETY. REPAIR DAMAGED WALL SCHEDULED TO REMAIN IN PLACE. PREPARE SURFACES TO RECEIVE NEW FINISHES.
- D12 REMOVE BUILT-IN CASEWORK/SHELVING UNITS, MARKER/DISPLAY BOARDS, MIRRORS AND WALL MOUNTED ACCESSORIES IN THEIR ENTIRETY. REPAIR DAMAGED WALL SCHEDULED TO REMAIN IN PLACE. PREPARE SURFACES TO RECEIVE NEW FINISHES.
- D13 REMOVE CARPET FLOORING IN ITS ENTIRETY. REPAIR DAMAGED SURFACES SCHEDULED TO REMAIN IN PLACE. PREPARE CONCRETE SLAB TO RECEIVE NEW FINISHES.
- D14 REMOVE VCT FLOORING IN ITS ENTIRETY. PREPARE EXISTING CONCRETE SLAB FOR NEW FLOORING.
- D15 NOT USED
- D16 REMOVE PORCELAIN FLOOR TILE BASE AND MORTAR BED IN THEIR ENTIRETY. PREPARE EXISTING CONCRETE SLAB TO RECEIVE NEW FINISHES.
- D17 REMOVE CERAMIC FLOOR TILE BASE AND MORTAR BED IN THEIR ENTIRETY. PREPARE EXISTING CONCRETE SLAB TO RECEIVE NEW FINISHES.
- D18 MODIFY MILLWORK WHERE SPECIFIED AS REQUIRED.
- D19 REMOVE PORTION OF EXISTING WALL AS REQUIRED TO ACCOMMODATE UV REPLACEMENT.
- D20 REMOVE SLIDING DOOR, FRAME, AND HARDWARE IN THEIR ENTIRETY TO EXTENTS SHOWN ON PLAN. REPLACE WITH NEW DOOR. SEE DOOR SCHEDULE.
- D21 REMOVE DRINKING FOUNTAIN AND REPLACE WITH NEW FIXTURE BY PUMING CONTRACTOR; REFER TO PLUMBING DRAWINGS. GENERAL CONTRACTOR TO REPAIR FINISHES AS REQUIRED.
- D22 REMOVE ASSOCIATED ITEMS AS REQUIRED TO PREPARE FOR NEW ELEVATOR MODERNIZATION. REFER TO SPECIFICATION SECTION 14 28 19.
- D23 REMOVE WALL PADS AND ASSOCIATED BLOCKING/HANGING SYSTEM IN ITS ENTIRETY FROM THE EXISTING WALL SYSTEM. REPAIR DAMAGED SURFACES SCHEDULED TO REMAIN IN PLACE TO MATCH EXISTING CONSTRUCTION.
- D24 REMOVE ALL WALL MOUNTED TECTUM ACOUSTIC PANELS AND ASSOCIATED ACCESSORIES IN THEIR ENTIRETY.
- D25 REMOVE BLEACHERS, MOTORS AND ALL ACCESSORIES IN THEIR ENTIRETY.
- D26 REMOVE EXISTING RUBBER FLOORING IN ITS ENTIRETY. PREPARE EXISTING CONCRETE SLAB TO RECEIVE NEW FINISHES.
- D27 REMOVE FREEZERS AND COOLERS IN THEIR ENTIRETY.
- D28 REMOVE ALL FLOORING FINISH DOWN TO CONCRETE SLAB. PREPARE FOR NEW FINISHES.
- D29 REMOVE LOADING DOCK BUMPER SYSTEM AND ALL ASSOCIATED ACCESSORIES.
- D30 REMOVE OVERHEAD SECTIONAL DOOR
- D31 DEMOLISH ALL FINISHES DOWN TO STRUCTURE. PREPARE FOR NEW FINISHES.
- D32 REMOVE WALL FINISHES AND INSTALL BLOCKING FOR NEW WALL MOUNTED WATER FOUNTAIN. PREPARE NEW FINISHES.
- D33 REMOVE STAIR AND LANDING IN ITS ENTIRETY.
- D34 REMOVE ALL BUILT-IN WALL CABINETS/SHELVING UNITS AND WALL MOUNTED ACCESSORIES IN THEIR ENTIRETY. REPAIR DAMAGED WALL SCHEDULED TO REMAIN IN PLACE. PREPARE SURFACES TO RECEIVE NEW FINISHES.
- D35 REMOVE BILCO DOOR.
- D36 REMOVE CORRIDOR CEILING AND FLOORING TO EXTENTS SHOWN; MODIFY EXISTING CORRIDOR CEILING AND FLOORING TO RECEIVE NEW FINISHES.
- D37 REMOVE PORTIONS OF WINDOW AFTER DAMAGE IS ACCESSED, REMOVE SURROUNDING WALL SURFACE WHERE DAMAGE OCCURS.
- D38 PREPARE FLOOR FOR EXPANDED POLYSTYRENE INFILL.
- D39 REMOVE FIRE EXTINGUISHER CABINET, SALVAGE EXISTING EXTINGUISHER AND ASSOCIATED ACCESSORIES FOR REUSE. REMOVE WALL FINISHES AND PREPARE FOR NEW DRINKING FOUNTAIN.
- D40 REMOVE ISLAND BENCHES. STORE FOR REINSTALLATION.
- D41 ABATEMENT CONTRACTOR TO REMOVE ADHERED CEILING TILE GLUE/MASTIC, GYPSUM SOFFITS AND ALL SUPPORT SYSTEMS IN THEIR ENTIRETY. REPAIR DAMAGED WALL SURFACES SCHEDULED TO REMAIN IN PLACE. PREPARE SURFACES TO RECEIVE NEW FINISHES. REFER TO SPECIFICATION 02 21 00.
- D42 REMOVE A PORTION OF UV METAL SHELVING, AND COUNTERTOP. REPAIR DAMAGED WALL SCHEDULED TO REMAIN IN PLACE. PREPARE SURFACES TO RECEIVE NEW FINISHES.
- D43 PARTIALLY REMOVE AND REINSTALL METAL MILLWORK FOR PIPING BY MC.
- D44 REMOVE ALL EXISTING WALL TILE FINISH. PROVIDE NEW CEMENTIOUS BACKER BOARD FOR NEW TILE FINISH.
- D45 REMOVE PORTION OF FLOOR WHERE SPECIFIED FOR ELEVATOR MODERNIZATION SCOPE.
- D46 REMOVE PORTION OF EXISTING FLOOR SLAB FOR TRENCHING. SEE "T" DWGS FOR ADDITIONAL INFORMATION.
- D47 REMOVE MOTORIZED CURTAIN IN ITS ENTIRETY. REFER TO "E" DWGS FOR MORE INFORMATION.

DRAWN BY:	KLC	
CHECKED BY:	JL	
DATE:	10/27/2025	
PHASE:	CD	
#	DATE:	DESCRIPTION OF REVISION:
1	10/10/2025	ISSUE FOR BID


**HUNT ENGINEERS ARCHITECTS | SURVEYORS**  
 HORSEHEADS, NY 607-298-8088    ROCHESTER, NY 585-637-7668    TOWANDA, PA 570-265-4668  
 BANGOR, NY 607-798-8881    ALBANY, NY 607-798-8881  
 WWW.HUNTEAM.COM  
 NY CERTIFICATE NO. 0016250    PA CERTIFICATE NO. 15C2020131464-1

**FIRST FLOOR DEMO PLAN - AREA C**  
**2025 CAPITAL IMPROVEMENTS PROJECT**  
**HAMMONDSPORT CENTRAL SCHOOL DISTRICT**  
 8272 MAIN STREET HAMMONDSPORT, NEW YORK, 14840

**MB-A0.3**  
PROJECT NO: 1925.014

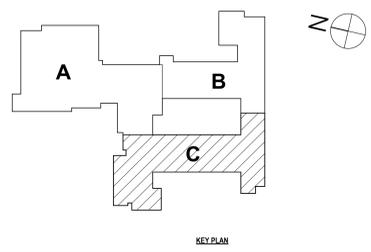

SED #: MB-25-01-04-02-025-00-07-29-01-04-5-003-008  
 11/18/2025 10:58 AM

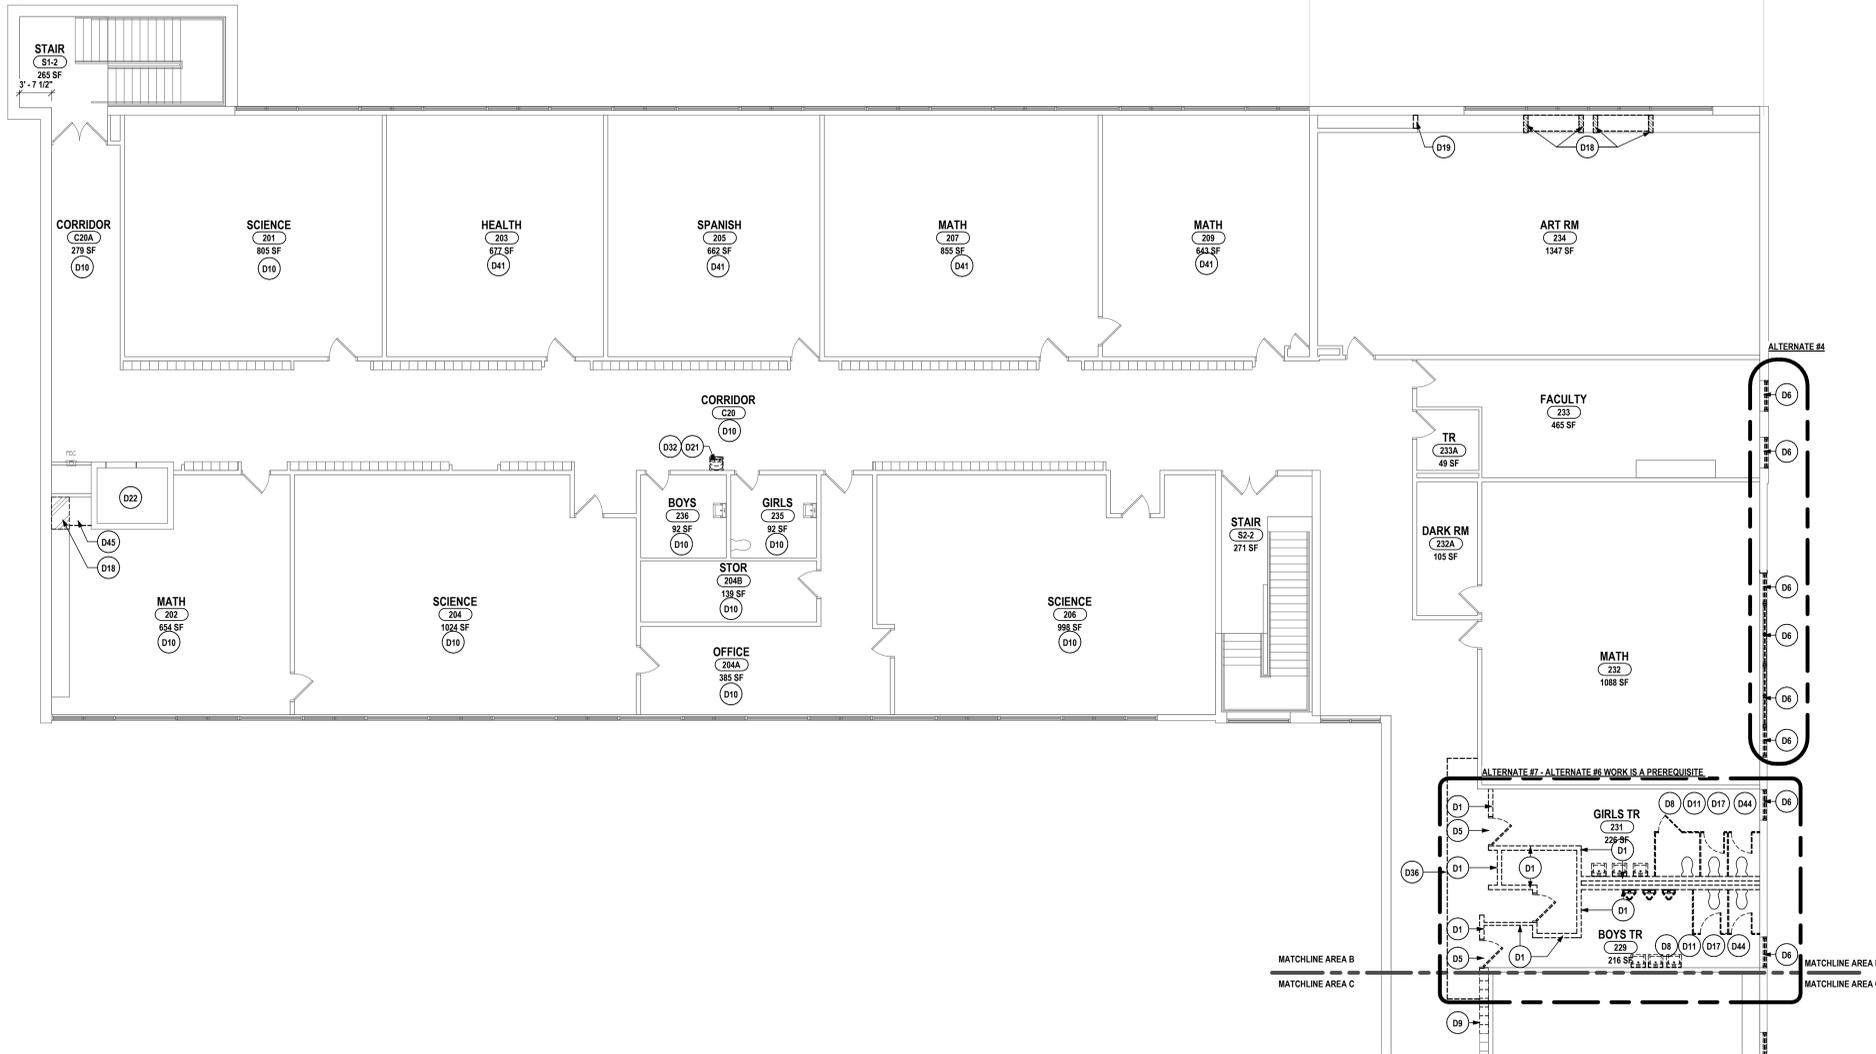

1 SECOND FLOOR DEMO PLAN - AREA B  
1/8" = 1'-0"

**GENERAL DEMO NOTES:**

- A ASBESTOS CONTAINING MATERIALS HAVE BEEN IDENTIFIED AS PART OF THIS PROJECT. THE OWNER HAS REPORTS IDENTIFYING ACM MATERIALS AND WILL HAVE THESE AVAILABLE FOR CONTRACTORS REFERENCE. IF SUSPECT MATERIAL, NOT SCHEDULED IS ENCOUNTERED, STOP WORK IMMEDIATELY, DO NOT DISTURB THE MATERIAL AND NOTIFY THE OWNER'S REPRESENTATIVES.
- B CONTRACTOR TO PROVIDE PROTECTIVE BARRIER AT ALL AREAS OF DEMOLITION. KEEP ALL EXITS FREE AND CLEAR AT ALL TIMES DURING FACILITY OPERATIONS.
- C THE OWNER RESERVES THE RIGHT TO RETAIN ANY REMOVED ITEMS AFTER CONTRACTOR REMOVAL. THE CONTRACTOR SHALL REMOVE FROM THE SITE AND DISPOSE OF ALL REMOVED ITEMS THE OWNER DOES NOT WISH TO RETAIN.
- D CONTRACTOR SHALL PROTECT EXISTING CONSTRUCTION TO REMAIN AS REQUIRED DURING DEMOLITION. PATCH, REPAIR, PAINT OR RE-FINISH EXISTING CONSTRUCTION MATERIALS AND FINISHES DAMAGED DURING DEMOLITION TO THEIR ORIGINAL CONDITION.
- E CONTRACTOR TO COORDINATE THE WORK OF THIS CONTRACT WITH THE WORK OF ALL OTHER CONTRACTED WORK AND WORK PERFORMED BY THE OWNER.
- F DIMENSIONS SHOWN FOR ALL NEW OPENINGS IN EXISTING CONSTRUCTION SHOULD BE COORDINATED WITH THE NEW PLANS AND EXISTING CONDITIONS IN THE FIELD.
- G ITEMS SHOWN ARE INTENDED TO GIVE APPROXIMATE QUANTITY, LOCATION AND TYPE. CONTRACTOR IS RESPONSIBLE FOR VERIFYING ACTUAL QUANTITIES AND EXISTING FIELD CONDITIONS IN ORDER TO COMPLETE THE WORK.
- H COORDINATE ANY WALL FLOOR REPAIR/INFILL THAT IS CAUSED BY THE REMOVAL OF EQUIPMENT BY OTHER PRIME CONTRACTORS AND PREPARE SURFACE TO RECEIVE NEW FINISHES.
- I REMOVE EXISTING WOOD BLOCKING FOR EXISTING WALL MOUNTED EQUIPMENT AND/OR DEVICES THAT INTERFERE WITH NEW WORK OR NEW ROOM FINISHES AND WALL TREATMENTS. TYPICAL FOR ALL AREAS.
- J MAINTAIN EXISTING STRUCTURAL SYSTEMS AT ALL TIMES. PROVIDE TEMPORARY SHORING AND BRACING AT LOCATIONS WHERE THE EXISTING STRUCTURE IS BEING MODIFIED. PROTECT THE EXISTING STRUCTURE SCHEDULED TO REMAIN FROM DAMAGE DURING DEMOLITION. MAINTAIN SHORING AND BRACING UNTIL THE NEW STRUCTURE IS INSTALLED AND READY TO ACCEPT LOADS.
- K GRINDING OF CONCRETE FLOORS AND SUBSTRATES OF DIFFERENT HEIGHTS IN THE SAME AREA IS REQUIRED AT WALL REMOVALS AND NEW DOORS IN EXISTING WALLS TO ALLOW THE NEW FINISHES TO ALIGN BETWEEN ADJACENT ROOMS AND ADJACENT ROOMS THAT BECOME ONE ROOM.
- L ROOM NUMBERS INDICATED ARE EXISTING BUILDING NUMBERS. REFER TO NEW FLOOR PLANS FOR NEW ROOM NUMBERING (SEE SERIES A-1 DRAWINGS).
- M EXISTING BRICK VENEER SCHEDULED FOR DEMOLITION IS TO BE REMOVED WITH CARE, SALVAGED, CLEANED AND STORED FOR RE-USE (TOOTH-PATCHING) IN DIFFERENT LOCATIONS OF THE BUILDING AS REQUIRED.

**DEMOLITION NOTES:**

- D1 REMOVE STUD PARTITION COMPLETELY UP TO EXISTING DECK OR STRUCTURE ABOVE TO EXTENTS SHOWN ON PLAN. DEMOLITION TO INCLUDE BASE, DOORS, FRAMES GLAZING AND ALL WALL MOUNTED/RECESSED ACCESSORIES, CASEWORK AND EQUIPMENT. REPAIR DAMAGED WALLS, FLOORING, AND ADJACENT SURFACES SCHEDULED TO REMAIN IN PLACE AFTER DEMOLITION. PREPARE FOR NEW FINISHES.
- D2 REMOVE MASONRY PARTITIONS COMPLETELY UP TO EXISTING DECK OR STRUCTURE ABOVE TO EXTENTS SHOWN ON PLAN. DEMOLITION TO INCLUDE BASE, DOORS, FRAMES, GLAZING AND WALL MOUNTED/RECESSED ACCESSORIES, CASEWORK AND EQUIPMENT. REPAIR DAMAGED WALLS, FLOORING, AND ADJACENT SURFACES SCHEDULED TO REMAIN IN PLACE AFTER DEMOLITION. PREPARE FOR NEW FINISHES.
- D3 PROVIDE NEW OPENING IN MASONRY WALL FOR NEW PASSAGE, DOOR/WINDOW FRAME, BLOCKING, LINTEL OR STEEL COLUMN. REFER TO LINTEL SCHEDULE FOR SIZE AND TYPE. REPAIR DAMAGED WALL AND FLOOR SURFACES TO RECEIVE NEW FINISHES.
- D4 PROVIDE NEW OPENING IN STUD PARTITION WALL FOR NEW PASSAGE, DOOR/WINDOW FRAME, BLOCKING, OR STEEL COLUMN.
- D5 REMOVE DOOR, FRAME, AND HARDWARE IN THEIR ENTIRETY TO EXTENTS SHOWN ON PLAN. REPAIR DAMAGED SURFACES SCHEDULED TO REMAIN IN PLACE TO MATCH EXISTING CONSTRUCTION AND PREPARE SURFACES TO RECEIVE NEW FINISHES.
- D6 REMOVE WINDOW, FRAME, HARDWARE, AND WINDOW TREATMENT SYSTEMS IN THEIR ENTIRETY. REPAIR DAMAGED SURFACES SCHEDULED TO REMAIN IN PLACE TO MATCH EXISTING CONSTRUCTION AND PREPARE SURFACES TO RECEIVE NEW FINISHES. REFER TO "AB" DRAWINGS FOR ADDITIONAL INFORMATION.
- D7 REMOVE OVM FLOOR SYSTEM IN ITS ENTIRETY. PREPARE FOR NEW OVM FLOOR SYSTEM.
- D8 REMOVE TOILET PARTITIONS, ASSOCIATED BRACING, ACCESSORIES AND ALL WALL MOUNTED ITEMS INCLUDING, BUT NOT LIMITED TO MIRRORS, SOAP DISPENSERS, GRAB BARS, ETC. PREPARE FLOOR AND WALL SURFACES FOR NEW FINISHES.
- D9 REMOVE LOCKERS, BASE AND ASSOCIATED ACCESSORIES IN THEIR ENTIRETY. REPAIR DAMAGED WALL AND FLOOR SURFACES TO RECEIVE NEW FINISHES.
- D10 REMOVE SUSPENDED CEILING SYSTEMS AND SOFFITS IN THEIR ENTIRETY. REPAIR DAMAGED WALL SCHEDULED TO REMAIN IN PLACE. PREPARE SURFACES TO RECEIVE NEW FINISHES.
- D11 REMOVE ADHERED CEILING T.I.E. SOFFIT, CLOUD CEILING AND FRAMING SYSTEMS IN THEIR ENTIRETY. REPAIR DAMAGED WALL SCHEDULED TO REMAIN IN PLACE. PREPARE SURFACES TO RECEIVE NEW FINISHES.
- D12 REMOVE BUILT-IN CASEWORK/SHELVING UNITS, MARKER/DISPLAY BOARDS, MIRRORS AND WALL MOUNTED ACCESSORIES IN THEIR ENTIRETY. REPAIR DAMAGED WALL SCHEDULED TO REMAIN IN PLACE. PREPARE SURFACES TO RECEIVE NEW FINISHES.
- D13 REMOVE CARPET FLOORING IN ITS ENTIRETY. REPAIR DAMAGED SURFACES SCHEDULED TO REMAIN IN PLACE. PREPARE CONCRETE SLAB TO RECEIVE NEW FINISHES.
- D14 REMOVE VCT FLOORING IN ITS ENTIRETY. PREPARE EXISTING CONCRETE SLAB FOR NEW FLOORING. NOT USED.
- D15 REMOVE PORCELAIN FLOOR TILE BASE AND MORTAR BED IN THEIR ENTIRETY. PREPARE EXISTING CONCRETE SLAB TO RECEIVE NEW FINISHES.
- D16 REMOVE CERAMIC FLOOR TILE BASE AND MORTAR BED IN THEIR ENTIRETY. PREPARE EXISTING CONCRETE SLAB TO RECEIVE NEW FINISHES.
- D17 MODIFY MILLWORK WHERE SPECIFIED AS REQUIRED.
- D18 REMOVE PORTION OF EXISTING WALL AS REQUIRED TO ACCOMMODATE UV REPLACEMENT.
- D19 REMOVE SLIDING DOOR, FRAME, AND HARDWARE IN THEIR ENTIRETY TO EXTENTS SHOWN ON PLAN. REPLACE WITH NEW DOOR. SEE DOOR SCHEDULE.
- D20 REMOVE DRINKING FOUNTAIN AND REPLACE WITH NEW FIXTURE BY PLUMBING CONTRACTOR. REFER TO PLUMBING DRAWINGS. GENERAL CONTRACTOR TO REPAIR FINISHES AS REQUIRED.
- D21 REMOVE ASSOCIATED ITEMS AS REQUIRED TO PREPARE FOR NEW ELEVATOR MODERNIZATION. REFER TO SPECIFICATION SECTION 14 28 19.
- D22 REMOVE WALL PADS AND ASSOCIATED BLOCKING/HANGING SYSTEM IN ITS ENTIRETY FROM THE EXISTING WALL SYSTEM. REPAIR DAMAGED SURFACES SCHEDULED TO REMAIN IN PLACE TO MATCH EXISTING CONSTRUCTION.
- D23 REMOVE ALL WALL MOUNTED TECTUM ACOUSTIC PANELS AND ASSOCIATED ACCESSORIES IN THEIR ENTIRETY.
- D24 REMOVE BLEACHERS, MOTORS AND ALL ACCESSORIES IN THEIR ENTIRETY.
- D25 REMOVE EXISTING RUBBER FLOORING IN ITS ENTIRETY. PREPARE EXISTING CONCRETE SLAB TO RECEIVE NEW FINISHES.
- D26 REMOVE FREEZERS AND COOLERS IN THEIR ENTIRETY.
- D27 REMOVE ALL FLOORING FINISH DOWN TO CONCRETE SLAB; PREPARE FOR NEW FINISHES.
- D28 REMOVE LOADING DOCK BUMPER SYSTEM AND ALL ASSOCIATED ACCESSORIES.
- D29 REMOVE OVERHEAD SECTIONAL DOOR.
- D30 DEMOLISH ALL FINISHES DOWN TO STRUCTURE; PREPARE FOR NEW FINISHES.
- D31 REMOVE WALL FINISHES AND INSTALL BLOCKING FOR NEW WALL MOUNTED WATER FOUNTAIN. PREPARE NEW FINISHES.
- D32 REMOVE STAIR AND LANDING IN ITS ENTIRETY.
- D33 REMOVE ALL BUILT-IN WALL CABINETS/SHELVING UNITS AND WALL MOUNTED ACCESSORIES IN THEIR ENTIRETY. REPAIR DAMAGED WALL SCHEDULED TO REMAIN IN PLACE. PREPARE SURFACES TO RECEIVE NEW FINISHES.
- D34 REMOVE BILCO DOOR.
- D35 REMOVE CORRIDOR CEILING AND FLOORING TO EXTENTS SHOWN; MODIFY EXISTING CORRIDOR CEILING AND FLOORING TO RECEIVE NEW FINISHES.
- D36 REMOVE PORTIONS OF WINDOW AFTER DAMAGE IS ASSESSED. REMOVE SURROUNDING WALL SURFACE WHERE DAMAGE OCCURS.
- D37 PREPARE FLOOR FOR EXPANDED POLYSTYRENE INFILL.
- D38 REMOVE FIRE EXTINGUISHER CABINET. SALVAGE EXISTING EXTINGUISHER AND ASSOCIATED ACCESSORIES FOR REUSE; REMOVE WALL FINISHES AND PREPARE FOR NEW DRINKING FOUNTAIN.
- D39 REMOVE ISLAND BENCHES. STORE FOR REINSTALLATION.
- D40 ABATEMENT CONTRACTOR TO REMOVE ADHERED CEILING TILE GUE/MASTIC, GYPSUM SOFFITS AND ALL SUPPORT SYSTEMS IN THEIR ENTIRETY. REPAIR DAMAGED WALL SURFACES SCHEDULED TO REMAIN IN PLACE. PREPARE SURFACES TO RECEIVE NEW FINISHES. REFER TO SPECIFICATION 02 21 00 TO REMAIN IN PLACE. PREPARE SURFACES TO RECEIVE NEW FINISHES.
- D41 PARTIALLY REMOVE AND REINSTALL METAL MILLWORK FOR RPPING BY MC.
- D42 REMOVE ALL EXISTING WALL TILE FINISH. PROVIDE NEW CEMENTIOUS BACKER BOARD FOR NEW TILE FINISH.
- D43 REMOVE PORTION OF FLOOR WHERE SPECIFIED FOR ELEVATOR MODERNIZATION SCOPE.
- D44 REMOVE PORTION OF EXISTING FLOOR SLAB FOR TRENCHING. SEE "P" DWGS FOR ADDITIONAL INFORMATION.
- D45 REMOVE MOTORIZED CURTAIN IN ITS ENTIRETY. REFER TO "E" DWGS FOR MORE INFORMATION.

SED # MB-17-28-01-04-02-02-016-07-29-01-04-5-003-008

SECOND FLOOR DEMO PLAN - AREA B  
2025 CAPITAL IMPROVEMENTS PROJECT  
HAMMONDSPORT CENTRAL SCHOOL DISTRICT  
8272 MAIN STREET HAMMONDSPORT, NEW YORK, 14840


PROJECT NO: 1925.014

HUNT ENGINEERS ARCHITECTS | SURVEYORS  
HORSEHEADS, NY 607-563-4008  
ROCKY HILLS, CT 860-439-8888  
TOWANDA, PA 570-265-4666  
BINGHAMTON, NY 607-798-8881  
ALBANY, NY 607-798-4801  
WWW.HUNT-EAS.COM  
NY CERTIFICATE NO. 00109250 PA CERTIFICATE NO. TSC22020131464-1

DRAWN BY:	KLC
CHECKED BY:	JL
DATE:	10/27/2025
PHASE:	CD
# DATE:	1 10/27/25
DESCRIPTION OF REVISION:	ISSUE FOR BID

IT IS A VIOLATION OF THE LAW FOR ANY PERSON TO MAKE UNAUTHORIZED ALTERATIONS OR ADDITIONS TO PLANS DRAWING, CALCULATIONS, SPECIFICATIONS, INSTRUMENTS OR SURVEYORS SEAL.

KEY PLAN

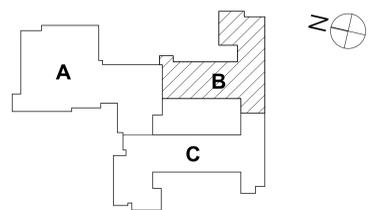


**GENERAL DEMO NOTES:**


- A ASBESTOS CONTAINING MATERIALS HAVE BEEN IDENTIFIED AS PART OF THIS PROJECT. THE OWNER HAS REPORTS IDENTIFYING ACM MATERIALS AND WILL HAVE THESE AVAILABLE FOR CONTRACTORS REFERENCE. IF SUSPECT MATERIAL NOT SCHEDULED IS ENCOUNTERED, STOP WORK IMMEDIATELY, DO NOT DISTURB THE MATERIAL AND NOTIFY THE OWNER'S REPRESENTATIVES.
- B CONTRACTOR TO PROVIDE PROTECTIVE BARRIER AT ALL AREAS OF DEMOLITION. KEEP ALL EXITS FREE AND CLEAR AT ALL TIMES DURING FACILITY OPERATIONS.
- C THE OWNER RESERVES THE RIGHT TO RETAIN ANY REMOVED ITEMS AFTER CONTRACTOR REMOVAL. THE CONTRACTOR SHALL REMOVE FROM THE SITE AND DISPOSE OF ALL REMOVED ITEMS THE OWNER DOES NOT WISH TO RETAIN.
- D CONTRACTOR SHALL PROTECT EXISTING CONSTRUCTION TO REMAIN AS REQUIRED DURING DEMOLITION. PATCH, REPAIR, PAINT OR RE-FINISH EXISTING CONSTRUCTION MATERIALS AND FINISHES DAMAGED DURING DEMOLITION TO THEIR ORIGINAL CONDITION.
- E CONTRACTOR TO COORDINATE THE WORK OF THIS CONTRACT WITH THE WORK OF ALL OTHER CONTRACTED WORK AND WORK PERFORMED BY THE OWNER.
- F DIMENSIONS SHOWN FOR ALL NEW OPENINGS IN EXISTING CONSTRUCTION SHOULD BE COORDINATED WITH THE NEW PLANS AND EXISTING CONDITIONS IN THE FIELD.
- G ITEMS SHOWN ARE INTENDED TO GIVE APPROXIMATE QUANTITY, LOCATION AND TYPE. CONTRACTOR IS RESPONSIBLE FOR VERIFYING ACTUAL QUANTITIES AND EXISTING FIELD CONDITIONS IN ORDER TO COMPLETE THE WORK.
- H COORDINATE ANY WALL/FLOOR REPAIR/INFILL THAT IS CAUSED BY THE REMOVAL OF EQUIPMENT BY OTHER PRIME CONTRACTORS AND PREPARE SURFACE TO RECEIVE NEW FINISHES.
- I REMOVE EXISTING WOOD BLOCKING FOR EXISTING WALL MOUNTED EQUIPMENT AND/OR DEVICES THAT INTERFERE WITH NEW WORK OR NEW ROOM FINISHES AND WALL TREATMENTS. TYPICAL FOR ALL AREAS.
- J MAINTAIN EXISTING STRUCTURAL SYSTEMS AT ALL TIMES. PROVIDE TEMPORARY SHORING AND BRACING AT LOCATIONS WHERE THE EXISTING STRUCTURE IS BEING MODIFIED. PROTECT THE EXISTING STRUCTURE SCHEDULED TO REMAIN FROM DAMAGE DURING DEMOLITION. MAINTAIN SHORING AND BRACING UNTIL THE NEW STRUCTURE IS INSTALLED AND READY TO ACCEPT LOADS.
- K GRINDING OF CONCRETE FLOORS AND SUBSTRATES OF DIFFERENT HEIGHTS IN THE SAME AREA IS REQUIRED AT WALL REMOVALS AND NEW DOORS IN EXISTING WALLS TO ALLOW THE NEW FINISHES TO ALIGN BETWEEN ADJACENT ROOMS AND ADJACENT ROOMS THAT BECOME ONE ROOM.
- L ROOM NUMBERS INDICATED ARE EXISTING BUILDING NUMBERS. REFER TO NEW FLOOR PLANS FOR NEW ROOM NUMBERING (SEE SERIES A-1 DRAWINGS).
- M EXISTING BRICK VENEER SCHEDULED FOR DEMOLITION IS TO BE REMOVED WITH CARE, SALVAGED, CLEANED AND STORED FOR RE-USE (TOOTH-IN PATCHING) IN DIFFERENT LOCATIONS OF THE BUILDING AS REQUIRED.

**DEMOLITION NOTES:**

- D1 REMOVE STUD PARTITION COMPLETELY UP TO EXISTING DECK OR STRUCTURE ABOVE TO EXTENTS SHOWN ON PLAN. DEMOLITION TO INCLUDE BASE, DOORS, FRAMES GLAZING AND ALL WALL MOUNTED/RECESSED ACCESSORIES, CASEWORK AND EQUIPMENT. REPAIR DAMAGED WALLS, FLOORING, AND ADJACENT SURFACES SCHEDULED TO REMAIN IN PLACE AFTER DEMOLITION. PREPARE FOR NEW FINISHES.
- D2 REMOVE MASONRY PARTITIONS COMPLETELY UP TO EXISTING DECK OR STRUCTURE ABOVE TO EXTENTS SHOWN ON PLAN. DEMOLITION TO INCLUDE BASE, DOORS, FRAMES, GLAZING AND WALL MOUNTED/RECESSED ACCESSORIES, CASEWORK AND EQUIPMENT. REPAIR DAMAGED WALLS, FLOORING, AND ADJACENT SURFACES SCHEDULED TO REMAIN IN PLACE AFTER DEMOLITION. PREPARE FOR NEW FINISHES.
- D3 PROVIDE NEW OPENING IN MASONRY WALL FOR NEW PASSAGE, DOOR/WINDOW FRAME, BLOCKING, LINTEL OR STEEL COLUMN. REFER TO LINTEL SCHEDULE FOR SIZE AND TYPE. REPAIR DAMAGED WALL AND FLOOR SURFACES TO RECEIVE NEW FINISHES.
- D4 PROVIDE NEW OPENING IN STUD PARTITION WALL FOR NEW PASSAGE, DOOR/WINDOW FRAME, BLOCKING, OR STEEL COLUMN.
- D5 REMOVE DOOR, FRAME, AND HARDWARE IN THEIR ENTIRETY TO EXTENTS SHOWN ON PLAN. REPAIR DAMAGED SURFACES SCHEDULED TO REMAIN IN PLACE TO MATCH EXISTING CONSTRUCTION AND PREPARE SURFACES TO RECEIVE NEW FINISHES.
- D6 REMOVE WINDOW, FRAME, HARDWARE, AND WINDOW TREATMENT SYSTEMS IN THEIR ENTIRETY. REPAIR DAMAGED SURFACES SCHEDULED TO REMAIN IN PLACE TO MATCH EXISTING CONSTRUCTION AND PREPARE SURFACES TO RECEIVE NEW FINISHES. REFER TO "AD" DRAWINGS FOR ADDITIONAL INFORMATION.
- D7 REMOVE GYM FLOOR SYSTEM IN ITS ENTIRETY. PREPARE FOR NEW GYM FLOOR SYSTEM.
- D8 REMOVE TOILET PARTITIONS, ASSOCIATED BRACING, ACCESSORIES AND ALL WALL MOUNTED ITEMS INCLUDING, BUT NOT LIMITED TO MIRRORS, SOAP DISPENSERS, GRAB BARS, ETC. PREPARE FLOOR AND WALL SURFACES FOR NEW FINISHES.
- D9 REMOVE LOCKERS, BASE AND ASSOCIATED ACCESSORIES IN THEIR ENTIRETY. REPAIR DAMAGED WALL AND FLOOR SURFACES TO RECEIVE NEW FINISHES.
- D10 REMOVE SUSPENDED CEILING SYSTEMS AND SOFFITS IN THEIR ENTIRETY. REPAIR DAMAGED WALL SCHEDULED TO REMAIN IN PLACE. PREPARE SURFACES TO RECEIVE NEW FINISHES.
- D11 REMOVE ADHERED CEILING TILE, SOFFIT, CLOUD CEILING AND FRAMING SYSTEM IN THEIR ENTIRETY. REPAIR DAMAGED WALL SCHEDULED TO REMAIN IN PLACE. PREPARE SURFACES TO RECEIVE NEW FINISHES.
- D12 REMOVE BUILT-IN CASEWORK/SHELVING UNITS, MARKER/DISPLAY BOARDS, MIRRORS AND WALL MOUNTED ACCESSORIES IN THEIR ENTIRETY. REPAIR DAMAGED WALL SCHEDULED TO REMAIN IN PLACE. PREPARE SURFACES TO RECEIVE NEW FINISHES.
- D13 REMOVE CARPET FLOORING IN ITS ENTIRETY. REPAIR DAMAGED SURFACES SCHEDULED TO REMAIN IN PLACE. PREPARE CONCRETE SLAB TO RECEIVE NEW FINISHES.
- D14 REMOVE VCT FLOORING IN ITS ENTIRETY. PREPARE EXISTING CONCRETE SLAB FOR NEW FLOORING. NOT USED.
- D15 REMOVE PORCELAIN FLOOR TILE BASE AND MORTAR BED IN THEIR ENTIRETY. PREPARE EXISTING CONCRETE SLAB TO RECEIVE NEW FINISHES.
- D16 REMOVE CERAMIC FLOOR TILE BASE AND MORTAR BED IN THEIR ENTIRETY. PREPARE EXISTING CONCRETE SLAB TO RECEIVE NEW FINISHES.
- D17 MODIFY MILLWORK WHERE SPECIFIED AS REQUIRED.
- D18 REMOVE PORTION OF EXISTING WALL AS REQUIRED TO ACCOMMODATE UV REPLACEMENT.
- D19 REMOVE SLIDING DOOR, FRAME, AND HARDWARE IN THEIR ENTIRETY TO EXTENTS SHOWN ON PLAN. REPLACE WITH NEW DOOR. SEE DOOR SCHEDULE.
- D20 REMOVE DRINKING FOUNTAIN AND REPLACE WITH NEW FIXTURE BY PUMING CONTRACTOR; REFER TO PLUMBING DRAWINGS. GENERAL CONTRACTOR TO REPAIR FINISHES AS REQUIRED.
- D21 REMOVE ASSOCIATED ITEMS AS REQUIRED TO PREPARE FOR NEW ELEVATOR MODERNIZATION. REFER TO SPECIFICATION SECTION 14.28.19.
- D22 REMOVE WALL PADS AND ASSOCIATED BLOCKING/HANGING SYSTEM IN ITS ENTIRETY FROM THE EXISTING WALL SYSTEM. REPAIR DAMAGED SURFACES SCHEDULED TO REMAIN IN PLACE TO MATCH EXISTING CONSTRUCTION.
- D23 REMOVE ALL WALL MOUNTED TECTUM ACOUSTIC PANELS AND ASSOCIATED ACCESSORIES IN THEIR ENTIRETY.
- D24 REMOVE BLEACHERS, MOTORS AND ALL ACCESSORIES IN THEIR ENTIRETY.
- D25 REMOVE EXISTING RUBBER FLOORING IN ITS ENTIRETY. PREPARE EXISTING CONCRETE SLAB TO RECEIVE NEW FINISHES.
- D26 REMOVE FREEZERS AND COOLERS IN THEIR ENTIRETY.
- D27 REMOVE ALL FLOORING FINISH DOWN TO CONCRETE SLAB. PREPARE FOR NEW FINISHES.
- D28 REMOVE LOADING DOCK BUMPER SYSTEM AND ALL ASSOCIATED ACCESSORIES.
- D29 REMOVE OVERHEAD SECTIONAL DOOR.
- D30 DEMOLISH ALL FINISHES DOWN TO STRUCTURE; PREPARE FOR NEW FINISHES.
- D31 REMOVE WALL FINISHES AND INSTALL BLOCKING FOR NEW WALL MOUNTED WATER FOUNTAIN. PREPARE NEW FINISHES.
- D32 REMOVE STAIR AND LANDING IN ITS ENTIRETY.
- D33 REMOVE ALL BUILT-IN WALL CABINETS/SHELVING UNITS AND WALL MOUNTED ACCESSORIES IN THEIR ENTIRETY. REPAIR DAMAGED WALL SCHEDULED TO REMAIN IN PLACE. PREPARE SURFACES TO RECEIVE NEW FINISHES.
- D34 REMOVE BILCO DOOR.
- D35 REMOVE CORRIDOR CEILING AND FLOORING TO EXTENTS SHOWN; MODIFY EXISTING CORRIDOR CEILING AND FLOORING TO RECEIVE NEW FINISHES.
- D36 REMOVE PORTIONS OF WINDOW AFTER DAMAGE IS ACCESSED. REMOVE SURROUNDING WALL SURFACE WHERE DAMAGE OCCURS.
- D37 PREPARE FLOOR FOR EXPANDED POLYSTYRENE INFILL.
- D38 REMOVE FIRE EXTINGUISHER CABINET, SALVAGE EXISTING EXTINGUISHER AND ASSOCIATED ACCESSORIES FOR REUSE; REMOVE WALL FINISHES AND PREPARE FOR NEW DRINKING FOUNTAIN.
- D39 REMOVE ISLAND BENCHES. STORE FOR REINSTALLATION.
- D40 ABATEMENT CONTRACTOR TO REMOVE ADHERED CEILING TILE GLUE/MASTIC, GYPSUM SOFFITS AND ALL SUPPORT SYSTEMS IN THEIR ENTIRETY. REPAIR DAMAGED WALL SURFACES SCHEDULED TO REMAIN IN PLACE. PREPARE SURFACES TO RECEIVE NEW FINISHES. REFER TO SPECIFICATION 02.21.00.
- D41 REMOVE A PORTION OF UV METAL SHELVING, AND COUNTERTOP. REPAIR DAMAGED WALL SCHEDULED TO REMAIN IN PLACE. PREPARE SURFACES TO RECEIVE NEW FINISHES.
- D42 PARTIALLY REMOVE AND REINSTALL METAL MILLWORK FOR PIPING BY MC.
- D43 REMOVE ALL EXISTING WALL TILE FINISH. PROVIDE NEW CEMENTIOUS BACKER BOARD FOR NEW TILE FINISH.
- D44 REMOVE PORTION OF FLOOR WHERE SPECIFIED FOR ELEVATOR MODERNIZATION SCOPE.
- D45 REMOVE PORTION OF EXISTING FLOOR SLAB FOR TRENCHING. SEE "TD" DWGS FOR ADDITIONAL INFORMATION.
- D47 REMOVE MOTORIZED CURTAIN IN ITS ENTIRETY. REFER TO "ED" DWGS FOR MORE INFORMATION.

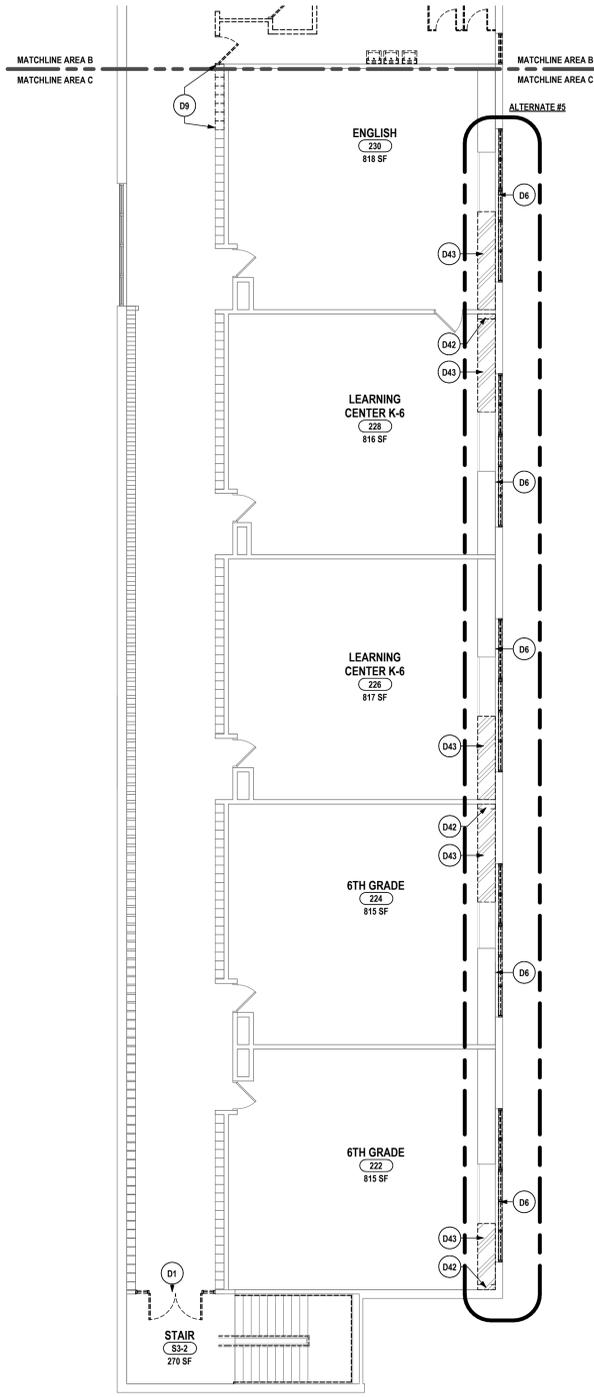

1 SECOND FLOOR DEMO PLAN - AREA C  
1/8" = 1'-0"

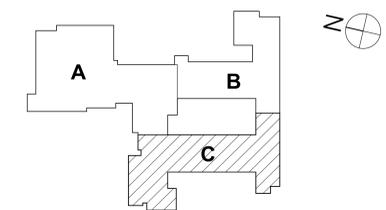

KEY PLAN

SED #: MB-17-28-01-04-02-025160-07-29-01-04-04-003-008

SECOND FLOOR DEMO PLAN - AREA C  
2025 CAPITAL IMPROVEMENTS PROJECT  
HAMMONDSPORT CENTRAL SCHOOL DISTRICT  
8272 MAIN STREET HAMMONDSPORT, NEW YORK, 14840


PROJECT NO: 1925.014

**HUNT ENGINEERS ARCHITECTS | SURVEYORS**  
HUNTSVILLE, NY 607-368-1008 ROCHESTER, NY 585-337-7568 TOYAHVALLEY, PA 670-265-4668  
BINGHAMTON, NY 607-798-8881 ALBANY, NY 607-798-4881  
WWW.HUNTEAS.COM  
NY CERTIFICATE NO. 0016250 PA CERTIFICATE NO. 15C2202031464-1


DRAWN BY:	KLC
CHECKED BY:	JJ
DATE:	10/27/2025
PHASE:	CD
# DATE:	1 10/27/2025
DESCRIPTION OF REVISION:	ISSUE FOR BID

IT IS A VIOLATION OF THE LAW FOR ANY PERSON TO MAKE UNAUTHORIZED ALTERATIONS OR ADDITIONS TO PLANS DRAWING, CALCULATIONS, SPECIFICATIONS, INSTRUMENTS OR SURVEYORS SEAL.

MB-A0.5

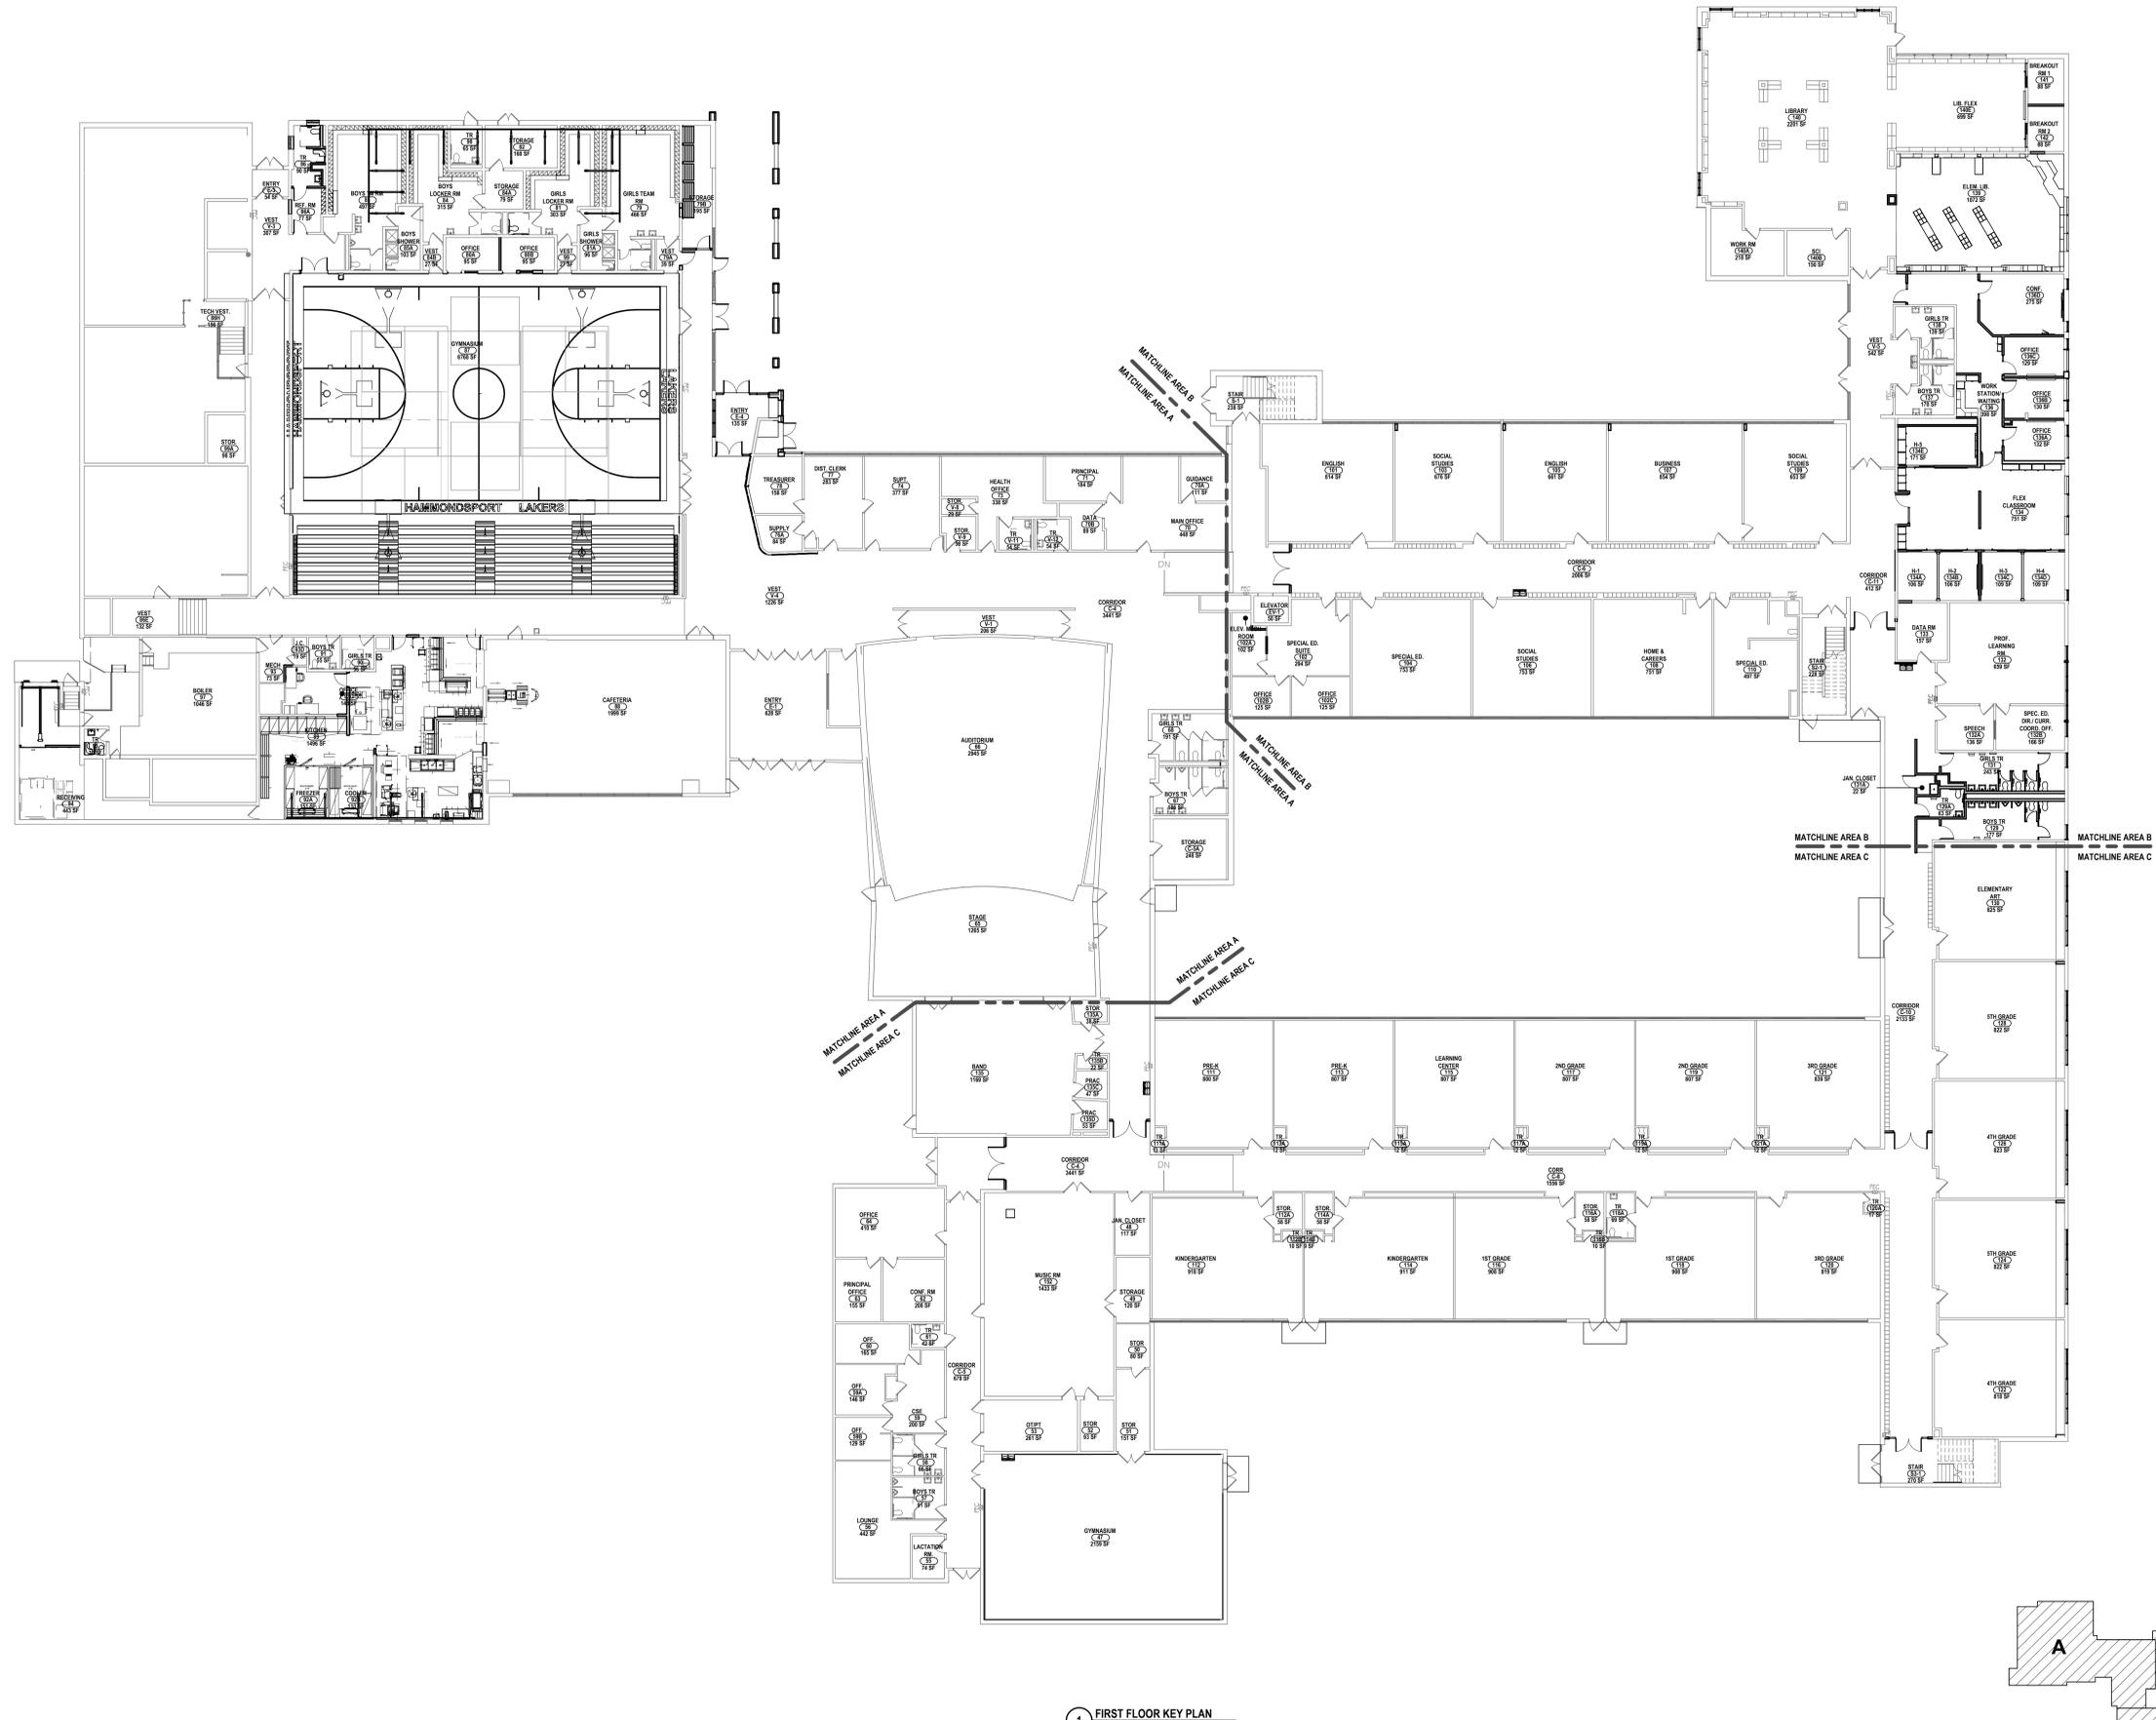

1 FIRST FLOOR KEY PLAN  
1/16" = 1'-0"

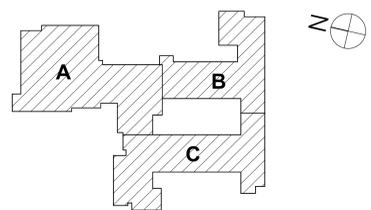

KEY PLAN

SET #: MB-57-28-01-04-02-02-03-06; 57-28-01-04-03-03-08

FIRST FLOOR KEY PLAN  
2025 CAPITAL IMPROVEMENTS PROJECT  
HAMMONDSPORT CENTRAL SCHOOL DISTRICT  
8272 MAIN STREET HAMMONDSPORT, NEW YORK, 14840

MB-A1.0A  
PROJECT NO: 1925.014


**HUNT ENGINEERS ARCHITECTS | SURVEYORS**  
HORSEHEADS, NY 807-458-1008    ROCKY HILLS, NY 866-337-7668    TOWANDA, PA 570-265-4668  
BINGHAMTON, NY 807-738-8881    ALBANY, NY 807-758-8801  
WWW.HUNTEAS.COM  
NY CERTIFICATE NO. 0016250    PA CERTIFICATE NO. TSC220313464-1

#	DATE:	DESCRIPTION OF REVISION:
1	10/27/2025	ISSUE FOR BID


DRAWN BY: KLC  
CHECKED BY: JJ  
DATE: 10/27/2025  
PHASE: CP

Copyright 2025

IT IS A VIOLATION OF THE LAW FOR ANY PERSON TO MAKE UNAUTHORIZED ALTERATIONS OR ADJUSTMENTS TO PLANS DRAWN BY LICENSED ENGINEERS, ARCHITECTS OR SURVEYORS.

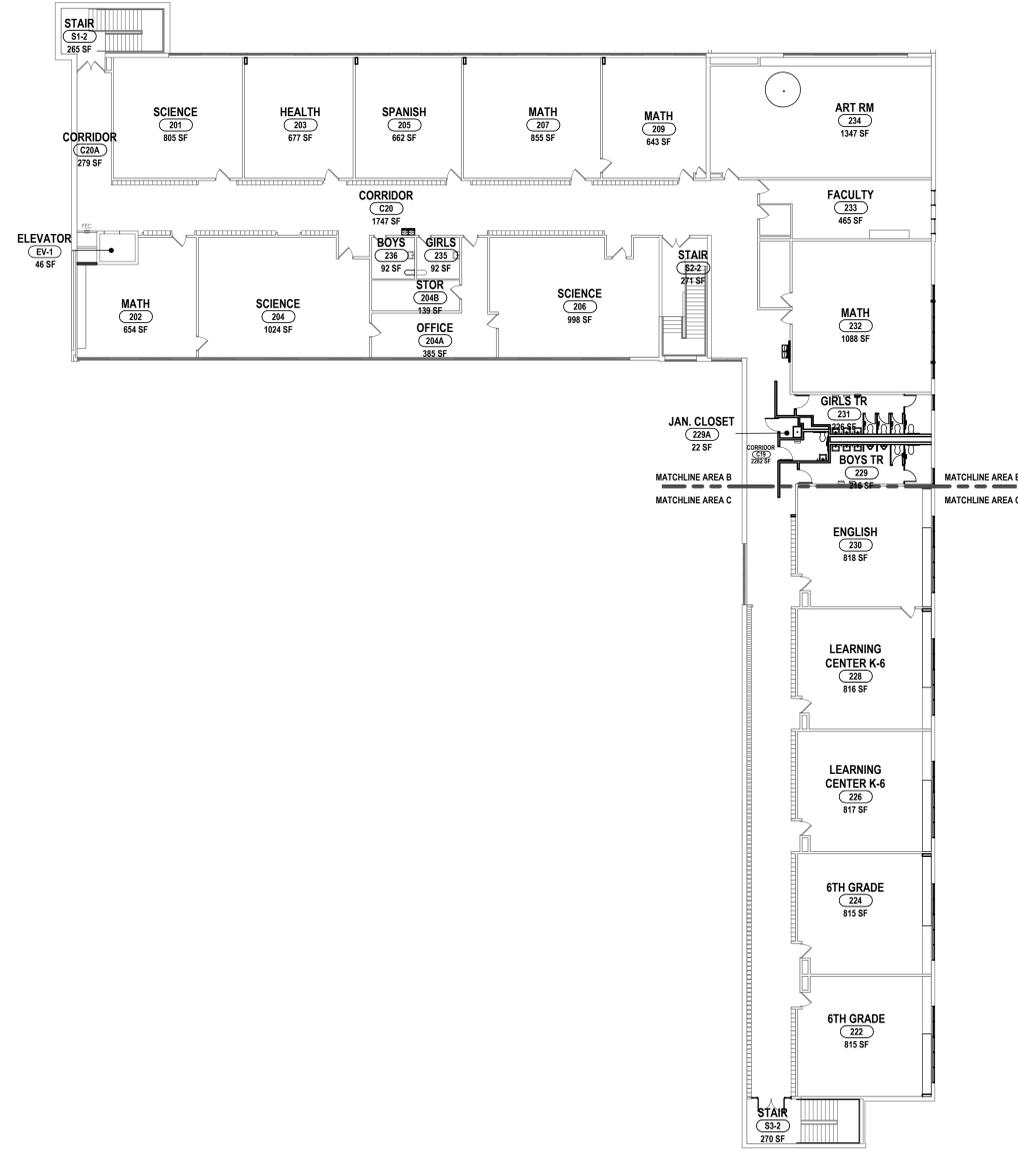

1 SECOND FLOOR KEY PLAN  
1/16" = 1'-0"

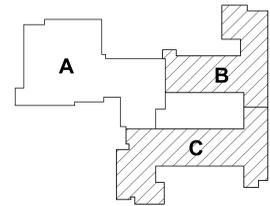

KEY PLAN

SET #: MB-57-28-01-04-02-02-03-06; 57-28-01-04-04-03-08

SECOND FLOOR KEY PLAN  
2025 CAPITAL IMPROVEMENTS PROJECT  
HAMMONDSPOUR CENTRAL SCHOOL DISTRICT  
8272 MAIN STREET HAMMONDSPOUR, NEW YORK, 14840

PROJECT NO: 1925.014

DRAWN BY: KLC  
CHECKED BY: J.J.  
DATE: 10/27/2025  
PHASE: CD

#	DATE	DESCRIPTION OF REVISION
1	10/10/2025	ISSUE FOR BID

**HUNT** ENGINEERS | ARCHITECTS | SURVEYORS  
HORSEHEADS, NY 607-458-1000 | P.O. BOX 1000 | POUGHKEEPSA, NY 607-837-7500 | TOWANDA, PA 570-265-4666  
BINGHAMTON, NY 607-798-8881 | ALBANY, NY 607-798-8881  
WWW.HUNTEAS.COM  
NY CERTIFICATE NO. 0016250 PA CERTIFICATE NO. TSC2202031464-1

IT IS A VIOLATION OF THE LAW FOR ANY PERSON TO MAKE UNAUTHORIZED ALTERATIONS OR ADDITIONS TO PLANS  
DRAWN BY: KLC  
CHECKED BY: J.J.  
DATE: 10/27/2025  
PHASE: CD

MB-A1.0B

**GENERAL NOTES:**

- A THE CONTRACTOR IS RESPONSIBLE FOR ALL WORK REQUIRED TO IMPLEMENT THE WORK OF THE CONTRACT, REGARDLESS OF WHETHER SPECIFICALLY INDICATED OR NOT, UNLESS NOTED OTHERWISE.
- B THE CONTRACTOR SHALL VERIFY ALL DIMENSIONS AND EXISTING CONDITIONS IN THE FIELD PRIOR TO COMMENCING ANY WORK AND NOTIFY ARCHITECT IMMEDIATELY IF ANY DISCREPANCIES ARE FOUND.
- C THE CONTRACTOR SHALL COORDINATE THE WORK OF THIS CONTRACT WITH THE WORK OF ALL OTHER CONTRACTED WORK AND WORK PERFORMED BY THE OWNER.
- D ALL NEW DOOR FRAMES INSTALLED IN METAL STUD OR MASONRY PARTITIONS SHALL BE MOUNTED 4" FROM ADJACENT WALLS (6" TO DOOR), TOOTH IN CMU BLOCK AND ANCHORS AT DOORS IN EXISTING CMU WALLS, UNLESS NOTED OR DETAILED OTHERWISE.
- E WHERE NEW DOORS ARE LOCATED IN EXISTING CORRIDOR WALLS, FLOORING, BASE AND WALL SHALL BE PATCHED TO MATCH EXISTING OR NEW CORRIDOR FINISHES. REFER TO FINISH KEY.
- F PROVIDE SOLID WOOD BLOCKING OR METAL STRAPPING AS REQUIRED IN METAL STUD WALLS AT ALL WALL MOUNTED EQUIPMENT AND ACCESSORIES INCLUDING FURNITURE FIXTURES AND EQUIPMENT. COORDINATE WITH THE WORK OF ALL OTHER CONTRACTED WORK AND WORK PERFORMED BY THE OWNER.
- G ITEMS SHOWN ARE INTENDED TO GIVE APPROXIMATE QUANTITY, LOCATION & TYPE. THE CONTRACTOR IS RESPONSIBLE FOR VERIFYING ACTUAL QUANTITY & EXISTING FIELD CONDITIONS.
- H ALL DIMENSIONS ARE TAKEN FROM FACE OF WALL TO FACE OF WALL UNLESS NOTED OTHERWISE.
- I THERE SHALL BE A MINIMUM OF 1'-4" CLEAR FLOOR SPACE ON THE FULL SIDE OF ALL NEW DOORS; THERE SHALL BE A MINIMUM OF 1'-0" CLEAR FLOOR SPACE ON THE PUSH SIDE OF ALL NEW DOORS.
- J THE WHEELCHAIR SYMBOL INDICATES HANDICAP ACCESSIBLE MOUNTED FIXTURE ELEVATION AND SHALL CONFORM WITH CASIANS A117.1 AND ADAAG.
- K EXTEND ALL NEW PARTITIONS TO DECK ABOVE, UNLESS NOTED OTHERWISE.
- L ALL FINISHED ASSEMBLIES ARE REQUIRED TO BE PROTECTED DURING THE COURSE OF CONSTRUCTION. ALL FINISHED ASSEMBLIES DAMAGED DURING THE COURSE OF CONSTRUCTION ARE REQUIRED TO BE REPLACED OR REPAIRED AT THE ARCHITECT'S DIRECTION.


**PLAN DRAWING NOTES:**

- 1 PROVIDE NEW BASKETBALL BACKSTOP SYSTEM. REFER TO SPECIFICATION 11 66 23 FOR ADDITIONAL INFORMATION.
- 2 PROVIDE NEW BLEACHER ASSEMBLY SYSTEM. REFER TO SPECIFICATION 12 66 13 FOR ADDITIONAL INFORMATION.
- 3 PROVIDE NEW LOADING DOCK BUMPERS. REFER TO SPECIFICATION 11 13 13 FOR ADDITIONAL INFORMATION.
- 4 EXISTING WALL SYSTEM DOES NOT GO TO DECK. SISTER COLD FORMED METAL FRAMING TO EXISTING WALL AND DECK STRUCTURE TO EXTEND WALL TO DECK ABOVE. PROVIDE REQUIRED SIZED UNFACED BATT INSULATION AND 5/8" TYPE X GYPSUM WALL BOARD BOTH SIDES. PROVIDE FIRE TAPE AND FIREPROOFING FOR ALL REQUIRED PENETRATIONS. REFER TO CODE COMPLIANCE SHEETS FOR RATING LOCATION. PARTIALLY REMOVE AND REINSTALL EXISTING CEILING SYSTEM AS REQUIRED.
- 5 INFILL EXISTING DOOR, WINDOW, OR WALL OPENING AS SHOWN ON PLAN TO MATCH EXISTING WALL THICKNESS AND PREPARE FOR NEW FINISHES.
- 6 PROVIDE WALL PADS ON EXPOSED WALLS AS INDICATED (NO WALL PADS BEHIND BLEACHERS). PROVIDE CUTOUTS FOR ALL WALL MOUNTED EQUIPMENT/FIXTURES AS REQUIRED.
- 7 PROVIDE CONCRETE PAD WITH FROST WALL AT DOOR. REFER TO 'S' DRAWINGS FOR ADDITIONAL DETAILS.
- 8 PROVIDE 4" SAFETY YELLOW FLOOR PAINT AT FLOOR TRANSITION AS PER SED CODE.
- 9 PROVIDE NEW WOOD WALL PANEL FINISHES. REFER TO FINISH SCHEDULE FOR ADDITIONAL INFORMATION. REMOVE EXISTING WALL MOSAIC TILE FINISH AND PREPARE FOR NEW FINISHES.
- 10 PROVIDE ADJUSTABLE WALL SHELVING, B.O.D GEAR BOSS MOUNTED ON WALL; 24" C25; STARTER BAY AS REQUIRED; 24" C26 ADD ON BAYS AS REQUIRED. PROVIDE (3) 24" C20; 30" 12" SHELF; (1) 24" C24; GARMENT PER BAY. ALL SHELF UNITS TO COME WITH OPTIONS SOLID TOP. QUANTITY OF BAYS AS SHOWN ON PLANS.
- 11 PROVIDE NEW GYM WOOD FLOOR SYSTEM & ALL ACCESSORIES. PAINT, & SEAL & FINISH FLOOR PER SPECIFICATION 09 64 66.
- 12 INFILL EXISTING MASONRY OPENING TO MATCH EXISTING WALL CONSTRUCTION & THICKNESS, UNLESS NOTED OTHERWISE. TOOTH IN NEW OR SALVAGED MASONRY WITH EXISTING. MATCH EXISTING FINISHES OR PREPARE SUBSTRATE AS REQUIRED TO ACCEPT NEW FINISHES.
- 13 PROVIDE LOCKERS, BASE AND ASSOCIATED ACCESSORIES IN THEIR ENTIRETY.
- 14 CFMF BENCH WITH SOLID SURFACE MATERIAL, HORIZONTAL SURFACE.
- 15 PROVIDE BLACK PVC BLOCKING AND 1" THICK SOLID COMPOSITE DECKING SYSTEM AROUND STRUCTURAL STEEL BEAM.
- 16 INFILL EXISTING MASONRY OPENING. PROVIDE BRICK VENEER, 2" OF POLYISO INSULATION, WEATHER BARRIER TO FURTHEST EXTENT POSSIBLE AND CONCRETE MASONRY INTERIOR. TOOTH IN NEW OR SALVAGED MASONRY WITH EXISTING. MATCH EXISTING FINISHES OR PREPARE SUBSTRATE AS REQUIRED TO ACCEPT NEW FINISHES.
- 17 REPAIR EXISTING STOREFRONT WINDOW. TO BE RE-GLAZED, RE-CAULKED, OR FRAME REPLACEMENT. REPAIR SURROUNDING WALL SURFACES WHERE DAMAGE OCCURS.
- 18 FOLDING WALL PARTITION; REFER TO SPECIFICATION 12 39 29 FOR ADDITIONAL INFORMATION.
- 19 WALL-MOUNTED ACOUSTIC STORAGE, MARKERBOARD, & DISPLAY SURROUND SYSTEM. PLATINUM VISUAL SYSTEMS P360 WALL SYSTEM. REFER TO MB-A8.8 FOR SYSTEM DETAILS.
- 20 NEW DRINKING FOUNTAIN FIXTURE; REFER TO 'P' DRAWINGS FOR ADDITIONAL INFORMATION. PATCH FINISHES TO MATCH AS REQUIRED.
- 21 PROVIDE NEW FIRE EXTINGUISHER HANGER/BRACKET AT LOCATION SHOWN; RELOCATE EXISTING FIRE EXTINGUISHER AND ACCESSORIES TO NEW LOCATION.
- 22 PATCH AND REPAIR EXISTING WALL SYSTEM AND FLOOR SYSTEM FROM HVAC REMOVALS AND PREPARE FOR NEW FINISHES AS REQUIRED.
- 23 PATCH TO MATCH CONCRETE FLOOR SLAB AND PORCELAIN MOSAIC FLOOR FINISH TO THE EXTENT OF REQUIRED LOCKER DEMO. TOOTH IN TILE AS REQUIRED.
- 24 PROVIDE BENCH INFILL TO CONNECT THE EXISTING BENCHES TO THE EXTENT SHOWN ON PLAN.
- 25 PROVIDE NEW WINDOW IN EXISTING OPENING. REUSE EXISTING SILL; INFILL SURROUNDING EXISTING OPENING TO MATCH EXISTING WALL CONSTRUCTION AND THICKNESS.
- 26 PROVIDE WALL CHASE(S) FOR UV PIPING. SEE 'H' DRAWINGS FOR MORE INFORMATION.
- 27 PATCH GYPSUM WALL BOARD AS REQUIRED TO RECEIVE NEW FINISHES.
- 28 HYDRAULIC PASSENGER ELEVATOR MODERNIZATION. REFER TO SPECIFICATION 14-28-19 FOR MORE INFORMATION.


DRAWN BY:	KLC
CHECKED BY:	JL
DATE:	10/27/2025
PHASE:	CD
DESCRIPTION OF REVISION:	
#	DATE
1	10/27/2025
ISSUE FOR BID	

**HUNT ENGINEERS ARCHITECTS | SURVEYORS**  
 HORSEHEADS, NY 607-568-1008  
 ROCKY HILLS, NY 607-567-7616  
 BINGHAMTON, NY 607-738-8881  
 ALBANY, NY 607-788-1801  
 WWW.HUNTEAS.COM  
 NY CERTIFICATE NO. 0016250 PA CERTIFICATE NO. TSC2200131464-1

**FIRST FLOOR PLAN - AREA A**  
 2025 CAPITAL IMPROVEMENTS PROJECT  
 HAMMONDSPORT CENTRAL SCHOOL DISTRICT  
 8272 MAIN STREET HAMMONDSPORT, NEW YORK, 14840  
**MB-A1.1**  
 PROJECT NO: 1925.014

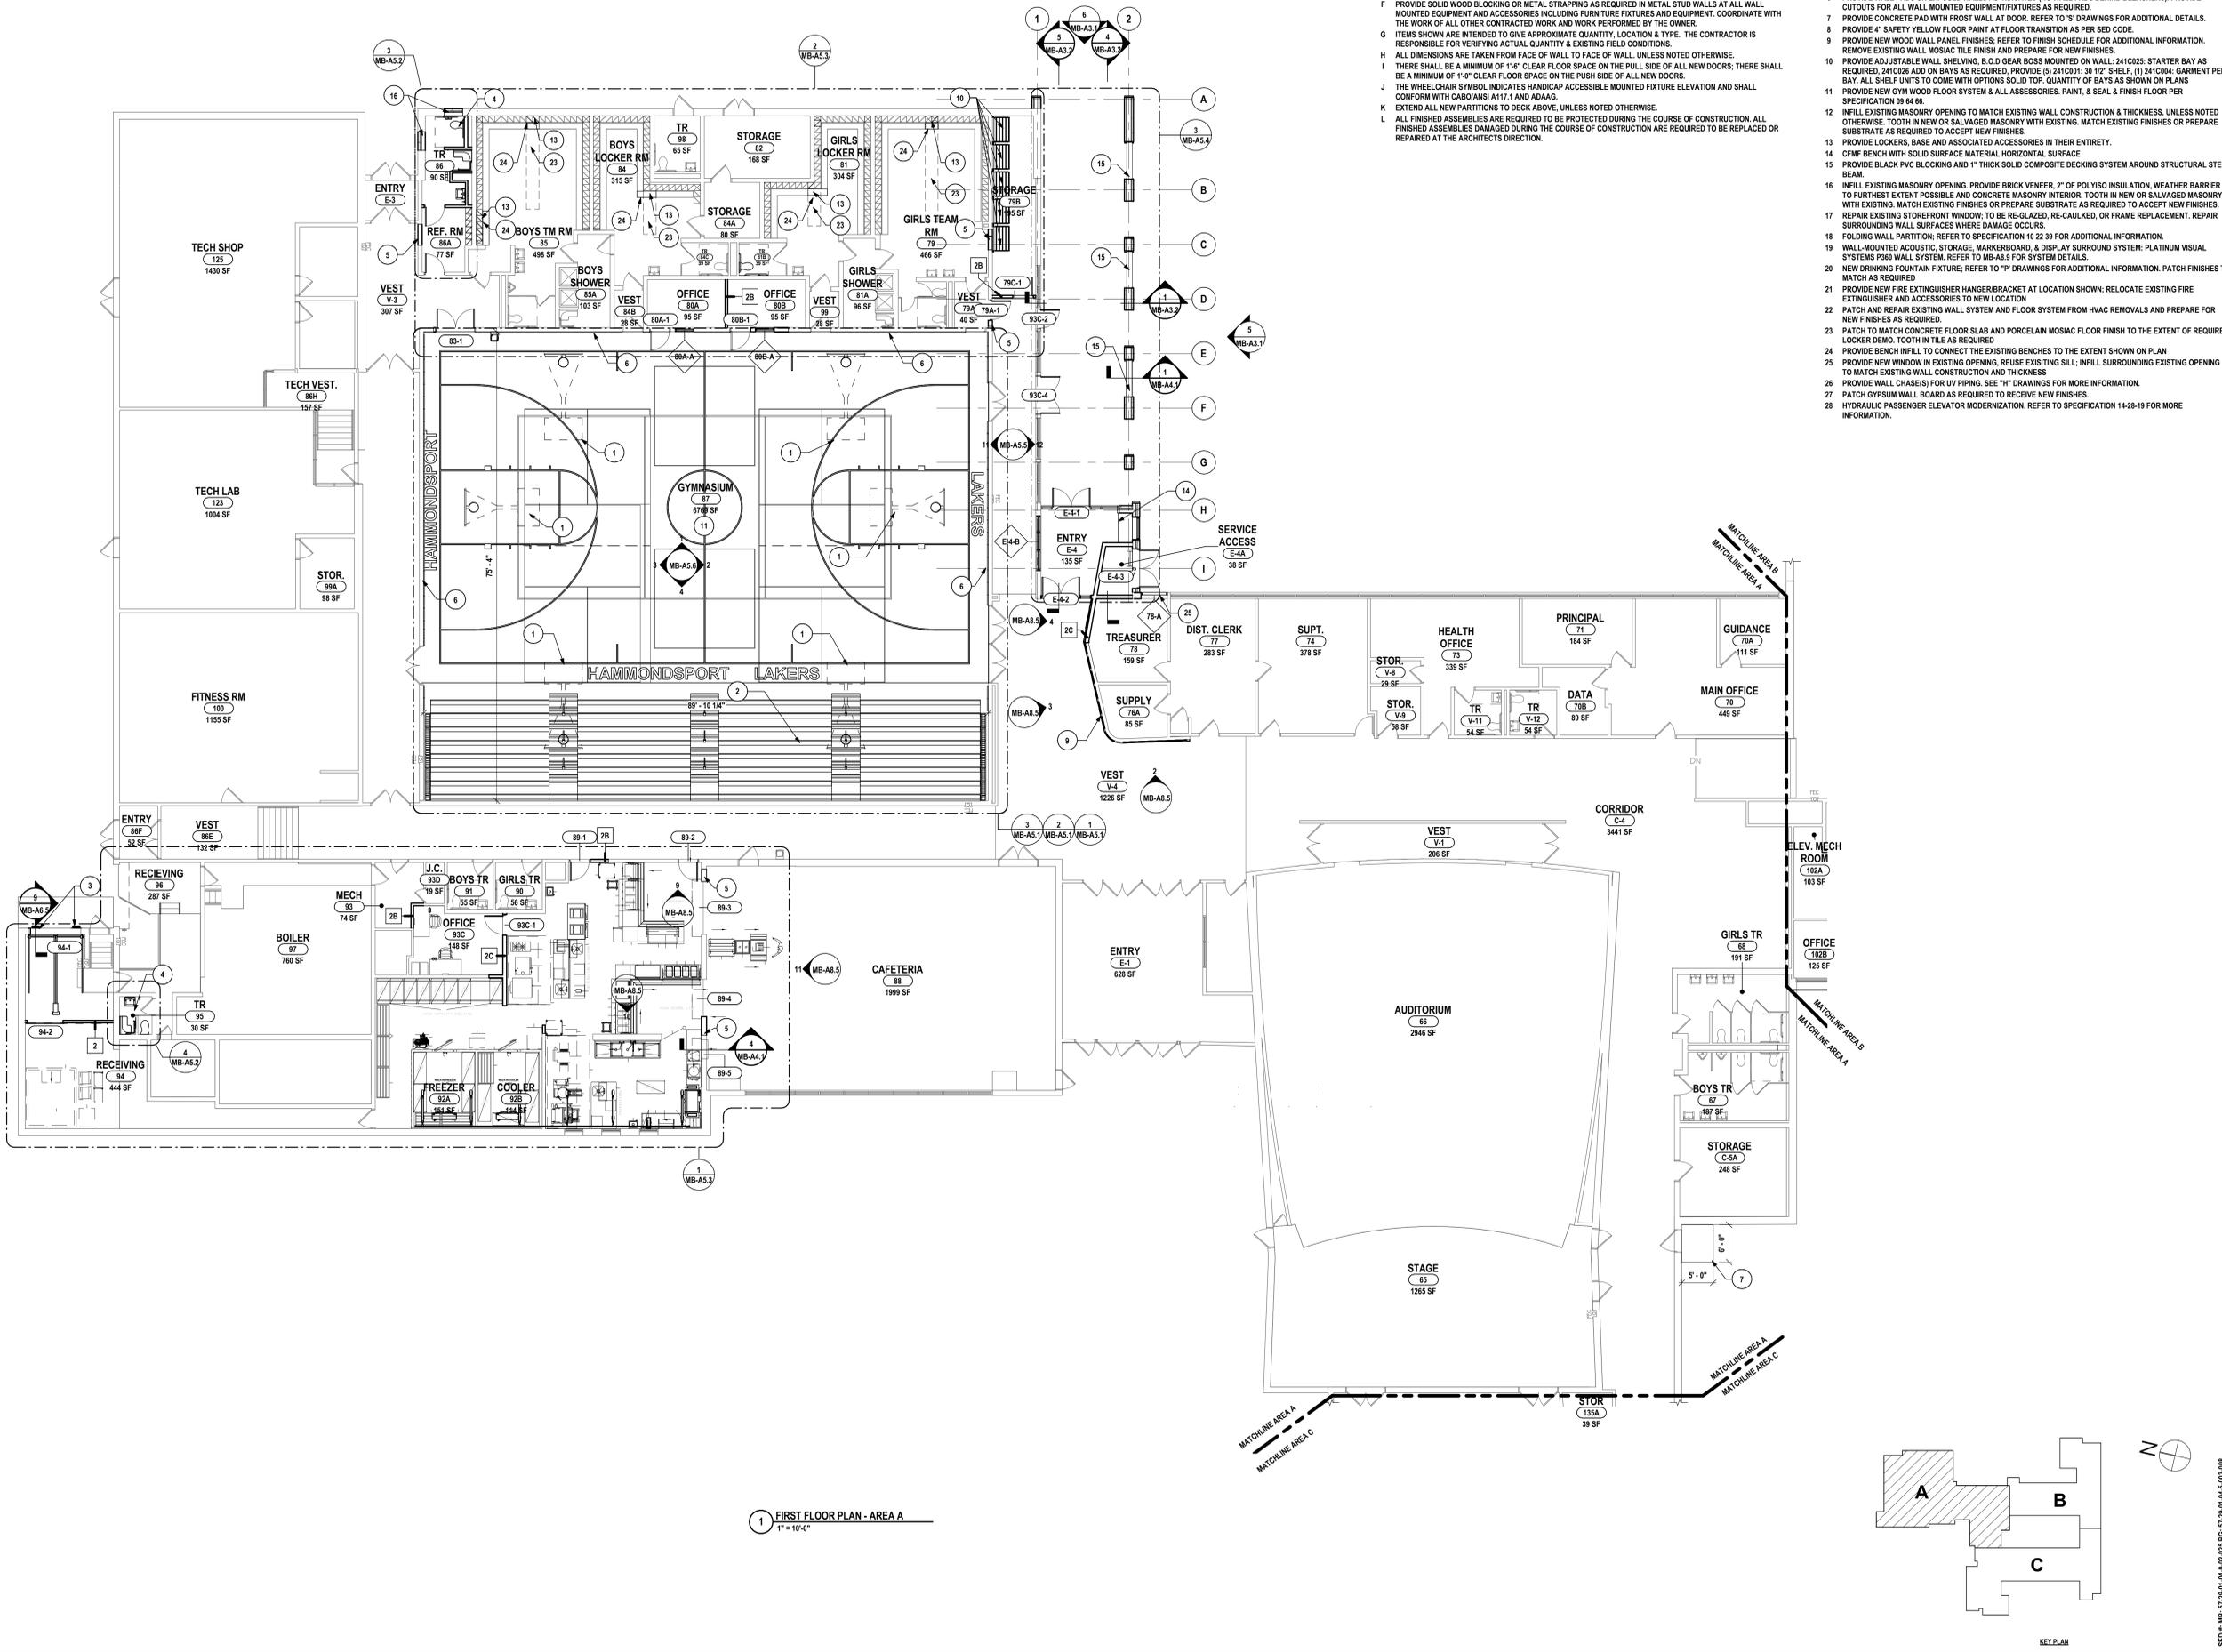

1 FIRST FLOOR PLAN - AREA A  
 1" = 10'-0"

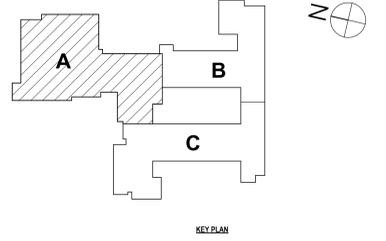

KEY PLAN




**GENERAL NOTES:**

- A THE CONTRACTOR IS RESPONSIBLE FOR ALL WORK REQUIRED TO IMPLEMENT THE WORK OF THE CONTRACT, REGARDLESS OF WHETHER SPECIFICALLY INDICATED OR NOT, UNLESS NOTED OTHERWISE.
- B THE CONTRACTOR SHALL VERIFY ALL DIMENSIONS AND EXISTING CONDITIONS IN THE FIELD PRIOR TO COMMENCING ANY WORK AND NOTIFY ARCHITECT IMMEDIATELY IF ANY DISCREPANCIES ARE FOUND.
- C THE CONTRACTOR SHALL COORDINATE THE WORK OF THIS CONTRACT WITH THE WORK OF ALL OTHER CONTRACTED WORK AND WORK PERFORMED BY THE OWNER.
- D ALL NEW DOOR FRAMES INSTALLED IN METAL STUD OR MASONRY PARTITIONS SHALL BE MOUNTED 4" FROM ADJACENT WALLS (6" TO DOOR); TOOTH IN CMU BLOCK AND ANCHORS AT DOORS IN EXISTING CMU WALLS, UNLESS NOTED OR DETAILED OTHERWISE.
- E WHERE NEW DOORS ARE LOCATED IN EXISTING CORRIDOR WALLS, FLOORING, BASE AND WALL SHALL BE PATCHED TO MATCH EXISTING OR NEW CORRIDOR FINISHES. REFER TO FINISH KEY.
- F PROVIDE SOLID WOOD BLOCKING OR METAL STRAPPING AS REQUIRED IN METAL STUD WALLS AT ALL WALL MOUNTED EQUIPMENT AND ACCESSORIES INCLUDING FURNITURE FIXTURES AND EQUIPMENT. COORDINATE WITH THE WORK OF ALL OTHER CONTRACTED WORK AND WORK PERFORMED BY THE OWNER.
- G ITEMS SHOWN ARE INTENDED TO GIVE APPROXIMATE QUANTITY, LOCATION & TYPE. THE CONTRACTOR IS RESPONSIBLE FOR VERIFYING ACTUAL QUANTITY & EXISTING FIELD CONDITIONS.
- H ALL DIMENSIONS ARE TAKEN FROM FACE OF WALL TO FACE OF WALL, UNLESS NOTED OTHERWISE.
- I THERE SHALL BE A MINIMUM OF 1'-0" CLEAR FLOOR SPACE ON THE PULL SIDE OF ALL NEW DOORS; THERE SHALL BE A MINIMUM OF 1'-0" CLEAR FLOOR SPACE ON THE PUSH SIDE OF ALL NEW DOORS.
- J THE WHEELCHAIR SYMBOL INDICATES HANDICAP ACCESSIBLE MOUNTED FIXTURE ELEVATION AND SHALL CONFORM WITH CASCIANS 4111.1 AND ADAAG.
- K EXTEND ALL NEW PARTITIONS TO DECK ABOVE, UNLESS NOTED OTHERWISE.
- L ALL FINISHED ASSEMBLIES ARE REQUIRED TO BE PROTECTED DURING THE COURSE OF CONSTRUCTION. ALL FINISHED ASSEMBLIES DAMAGED DURING THE COURSE OF CONSTRUCTION ARE REQUIRED TO BE REPLACED OR REPAIRED AT THE ARCHITECT'S DIRECTION.

**PLAN DRAWING NOTES:**

- 1 PROVIDE NEW BASKETBALL BACKSTOP SYSTEM. REFER TO SPECIFICATION 11 66 23 FOR ADDITIONAL INFORMATION.
- 2 PROVIDE NEW BLEACHER ASSEMBLY SYSTEM. REFER TO SPECIFICATION 12 66 13 FOR ADDITIONAL INFORMATION.
- 3 PROVIDE NEW LOADING DOCK BUMPERS. REFER TO SPECIFICATION 11 13 13 FOR ADDITIONAL INFORMATION.
- 4 EXISTING WALL SYSTEM DOES NOT GO TO DECK. SISTER COLD FORMED METAL FRAMING TO EXISTING WALL AND DECK STRUCTURE TO EXTEND WALL TO DECK ABOVE. PROVIDE REQUIRED SIZED UNFACED BATT INSULATION AND 5/8" TYPE X GYPSUM WALL BOARD BOTH SIDES. PROVIDE FIRE TAPE AND FIREPROOFING FOR ALL REQUIRED PENETRATIONS. REFER TO CODE COMPLIANCE SHEETS FOR RATING LOCATION. PARTIALLY REMOVE AND REINSTALL EXISTING CEILING SYSTEM AS REQUIRED.
- 5 INFILL EXISTING DOOR, WINDOW, OR WALL OPENING AS SHOWN ON PLAN TO MATCH EXISTING WALL THICKNESS AND PREPARE FOR NEW FINISHES.
- 6 PROVIDE WALL PADS ON EXPOSED WALLS AS INDICATED (NO WALL PADS BEHIND BLEACHERS). PROVIDE CUTOUPS FOR ALL WALL MOUNTED EQUIPMENT/FIXTURES AS REQUIRED.
- 7 PROVIDE CONCRETE PAD WITH FROST WALL AT DOOR. REFER TO 'S' DRAWINGS FOR ADDITIONAL DETAILS.
- 8 PROVIDE 4" SAFETY YELLOW FLOOR PAINT AT FLOOR TRANSITION AS PER SDG CODE.
- 9 PROVIDE NEW WOOD WALL PANEL FINISHES. REFER TO FINISH SCHEDULE FOR ADDITIONAL INFORMATION. REMOVE EXISTING WALL MOSAIC TILE FINISH AND PREPARE FOR NEW FINISHES.
- 10 PROVIDE ADJUSTABLE WALL SHELVEING, B.O.D GEAR BOSS MOUNTED ON WALL. 241C025; STARTER BAY AS REQUIRED. 241C026 ADD ON BAYS AS REQUIRED. PROVIDE (9) 241C001; 30 1/2" SHELF; (1) 241C004; GARMENT PER BAY. ALL SHELF UNITS TO COME WITH OPTIONS SOLD TOP. QUANTITY OF BAYS AS SHOWN ON PLANS.
- 11 PROVIDE NEW GYM WOOD FLOOR SYSTEM & ALL ACCESSORIES. PAINT, & SEAL & FINISH FLOOR PER SPECIFICATION 09 64 66.
- 12 INFILL EXISTING MASONRY OPENING TO MATCH EXISTING WALL CONSTRUCTION & THICKNESS. UNLESS NOTED OTHERWISE, TOOTH IN NEW OR SALVAGED MASONRY WITH EXISTING. MATCH EXISTING FINISHES OR PREPARE SUBSTRATE AS REQUIRED TO ACCEPT NEW FINISHES.
- 13 PROVIDE LOCKERS, BASE AND ASSOCIATED ACCESSORIES IN THEIR ENTIRETY.
- 14 CFMF BENCH WITH SOLID SURFACE MATERIAL HORIZONTAL SURFACE.
- 15 PROVIDE BLACK PVC BLOCKING AND 1" THICK SOLID COMPOSITE DECKING SYSTEM AROUND STRUCTURAL STEEL BEAM.
- 16 INFILL EXISTING MASONRY OPENING. PROVIDE BRICK VENEER, 2" OF POLYISO INSULATION, WEATHER BARRIER TO FURTHEST EXTENT POSSIBLE AND CONCRETE MASONRY INTERIOR. TOOTH IN NEW OR SALVAGED MASONRY WITH EXISTING. MATCH EXISTING FINISHES OR PREPARE SUBSTRATE AS REQUIRED TO ACCEPT NEW FINISHES.
- 17 REPAIR EXISTING STOREFRONT WINDOW, TO BE RE-GLAZED, RE-CAULKED, OR FRAME REPLACEMENT. REPAIR SURROUNDING WALL SURFACES WHERE DAMAGE OCCURS.
- 18 NEW DRINKING FOUNTAIN FIXTURE; REFER TO 'P' DRAWINGS FOR ADDITIONAL INFORMATION. PATCH FINISHES TO MATCH AS REQUIRED.
- 19 FOLDING WALL PARTITION; REFER TO SPECIFICATION 10 22 39 FOR ADDITIONAL INFORMATION.
- 20 WALL-MOUNTED ACOUSTIC STORAGE, MARKERBOARD, & DISPLAY SURROUND SYSTEM. PLATINUM VISUAL SYSTEMS P360 WALL SYSTEM. REFER TO MB-A8.9 FOR SYSTEM DETAILS.
- 21 PROVIDE NEW FIRE EXTINGUISHER HANGER/BRACKET AT LOCATION SHOWN; RELOCATE EXISTING FIRE EXTINGUISHER AND ACCESSORIES TO NEW LOCATION.
- 22 PATCH AND REPAIR EXISTING WALL SYSTEM AND FLOOR SYSTEM FROM HVAC REMOVALS AND PREPARE FOR NEW FINISHES AS REQUIRED.
- 23 PATCH TO MATCH CONCRETE FLOOR SLAB AND PORCELAIN MOSAIC FLOOR FINISH TO THE EXTENT OF REQUIRED LOCKER DEMO. TOOTH IN TILE AS REQUIRED.
- 24 PROVIDE BENCH INFILL TO CONNECT THE EXISTING BENCHES TO THE EXTENT SHOWN ON PLAN.
- 25 PROVIDE NEW WINDOW IN EXISTING OPENING, REUSE EXISTING SILL; INFILL SURROUNDING EXISTING OPENING TO MATCH EXISTING WALL CONSTRUCTION AND THICKNESS.
- 26 PROVIDE WALL CHASE(S) FOR UV PIPING. SEE 'H' DRAWINGS FOR MORE INFORMATION.
- 27 PATCH GYPSUM WALL BOARD AS REQUIRED TO RECEIVE NEW FINISHES.
- 28 HYDRAULIC PASSENGER ELEVATOR MODERNIZATION. REFER TO SPECIFICATION 14-28-19 FOR MORE INFORMATION.

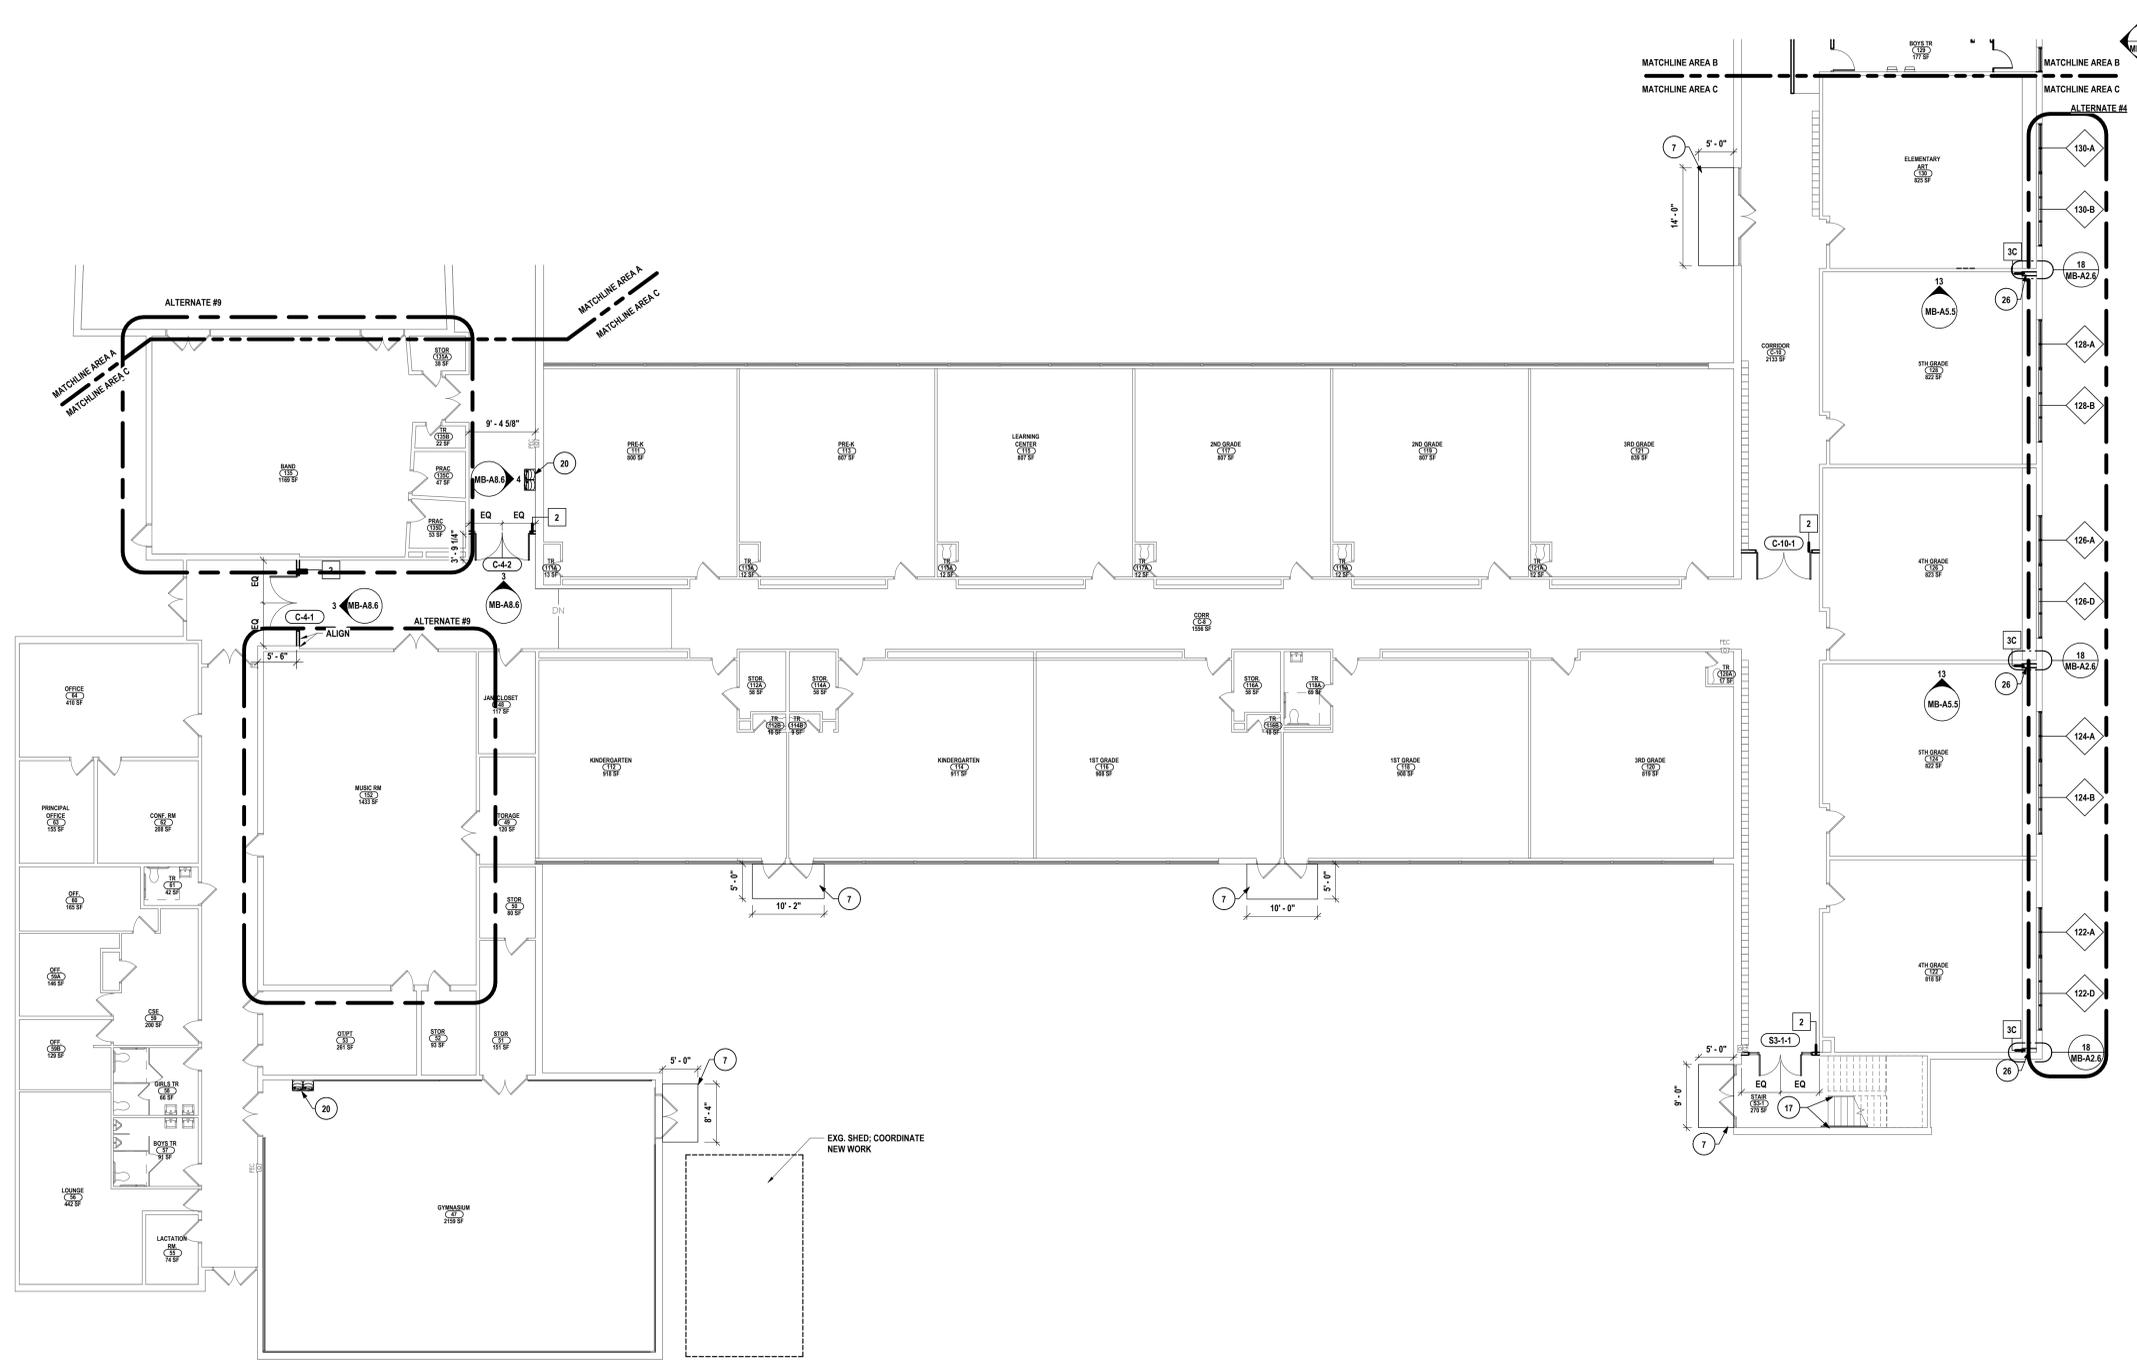

1 FIRST FLOOR PLAN - AREA C  
1" = 10'-0"

DRAWN BY:	KLG
CHECKED BY:	JL
DATE:	10/27/2025
PHASE:	CD

#	DATE:	DESCRIPTION OF REVISION:
1	10/10/2025	ISSUE FOR BID

**HUNT ENGINEERS ARCHITECTS | SURVEYORS**

HORSEHEADS, NY 607-268-1000    ROCHESTER, NY 585-327-7668    TOWANDA, PA 570-265-4668  
 BINGHAMTON, NY 607-798-8881    ALBANY, NY 607-798-1801  
 WWW.HUNTEAM.COM

NY CERTIFICATE NO. 0016920    PA CERTIFICATE NO. TSC2020131464-1

**FIRST FLOOR PLAN - AREA C**

**2025 CAPITAL IMPROVEMENTS PROJECT**


**HAMMONDSPORT CENTRAL SCHOOL DISTRICT**

8272 MAIN STREET HAMMONDSPORT, NEW YORK, 14840

**MB-A1.3**

PROJECT NO: 1925.014

SED #: MB-27-26-01-04-02-02516; 07-29-01-04-03-508

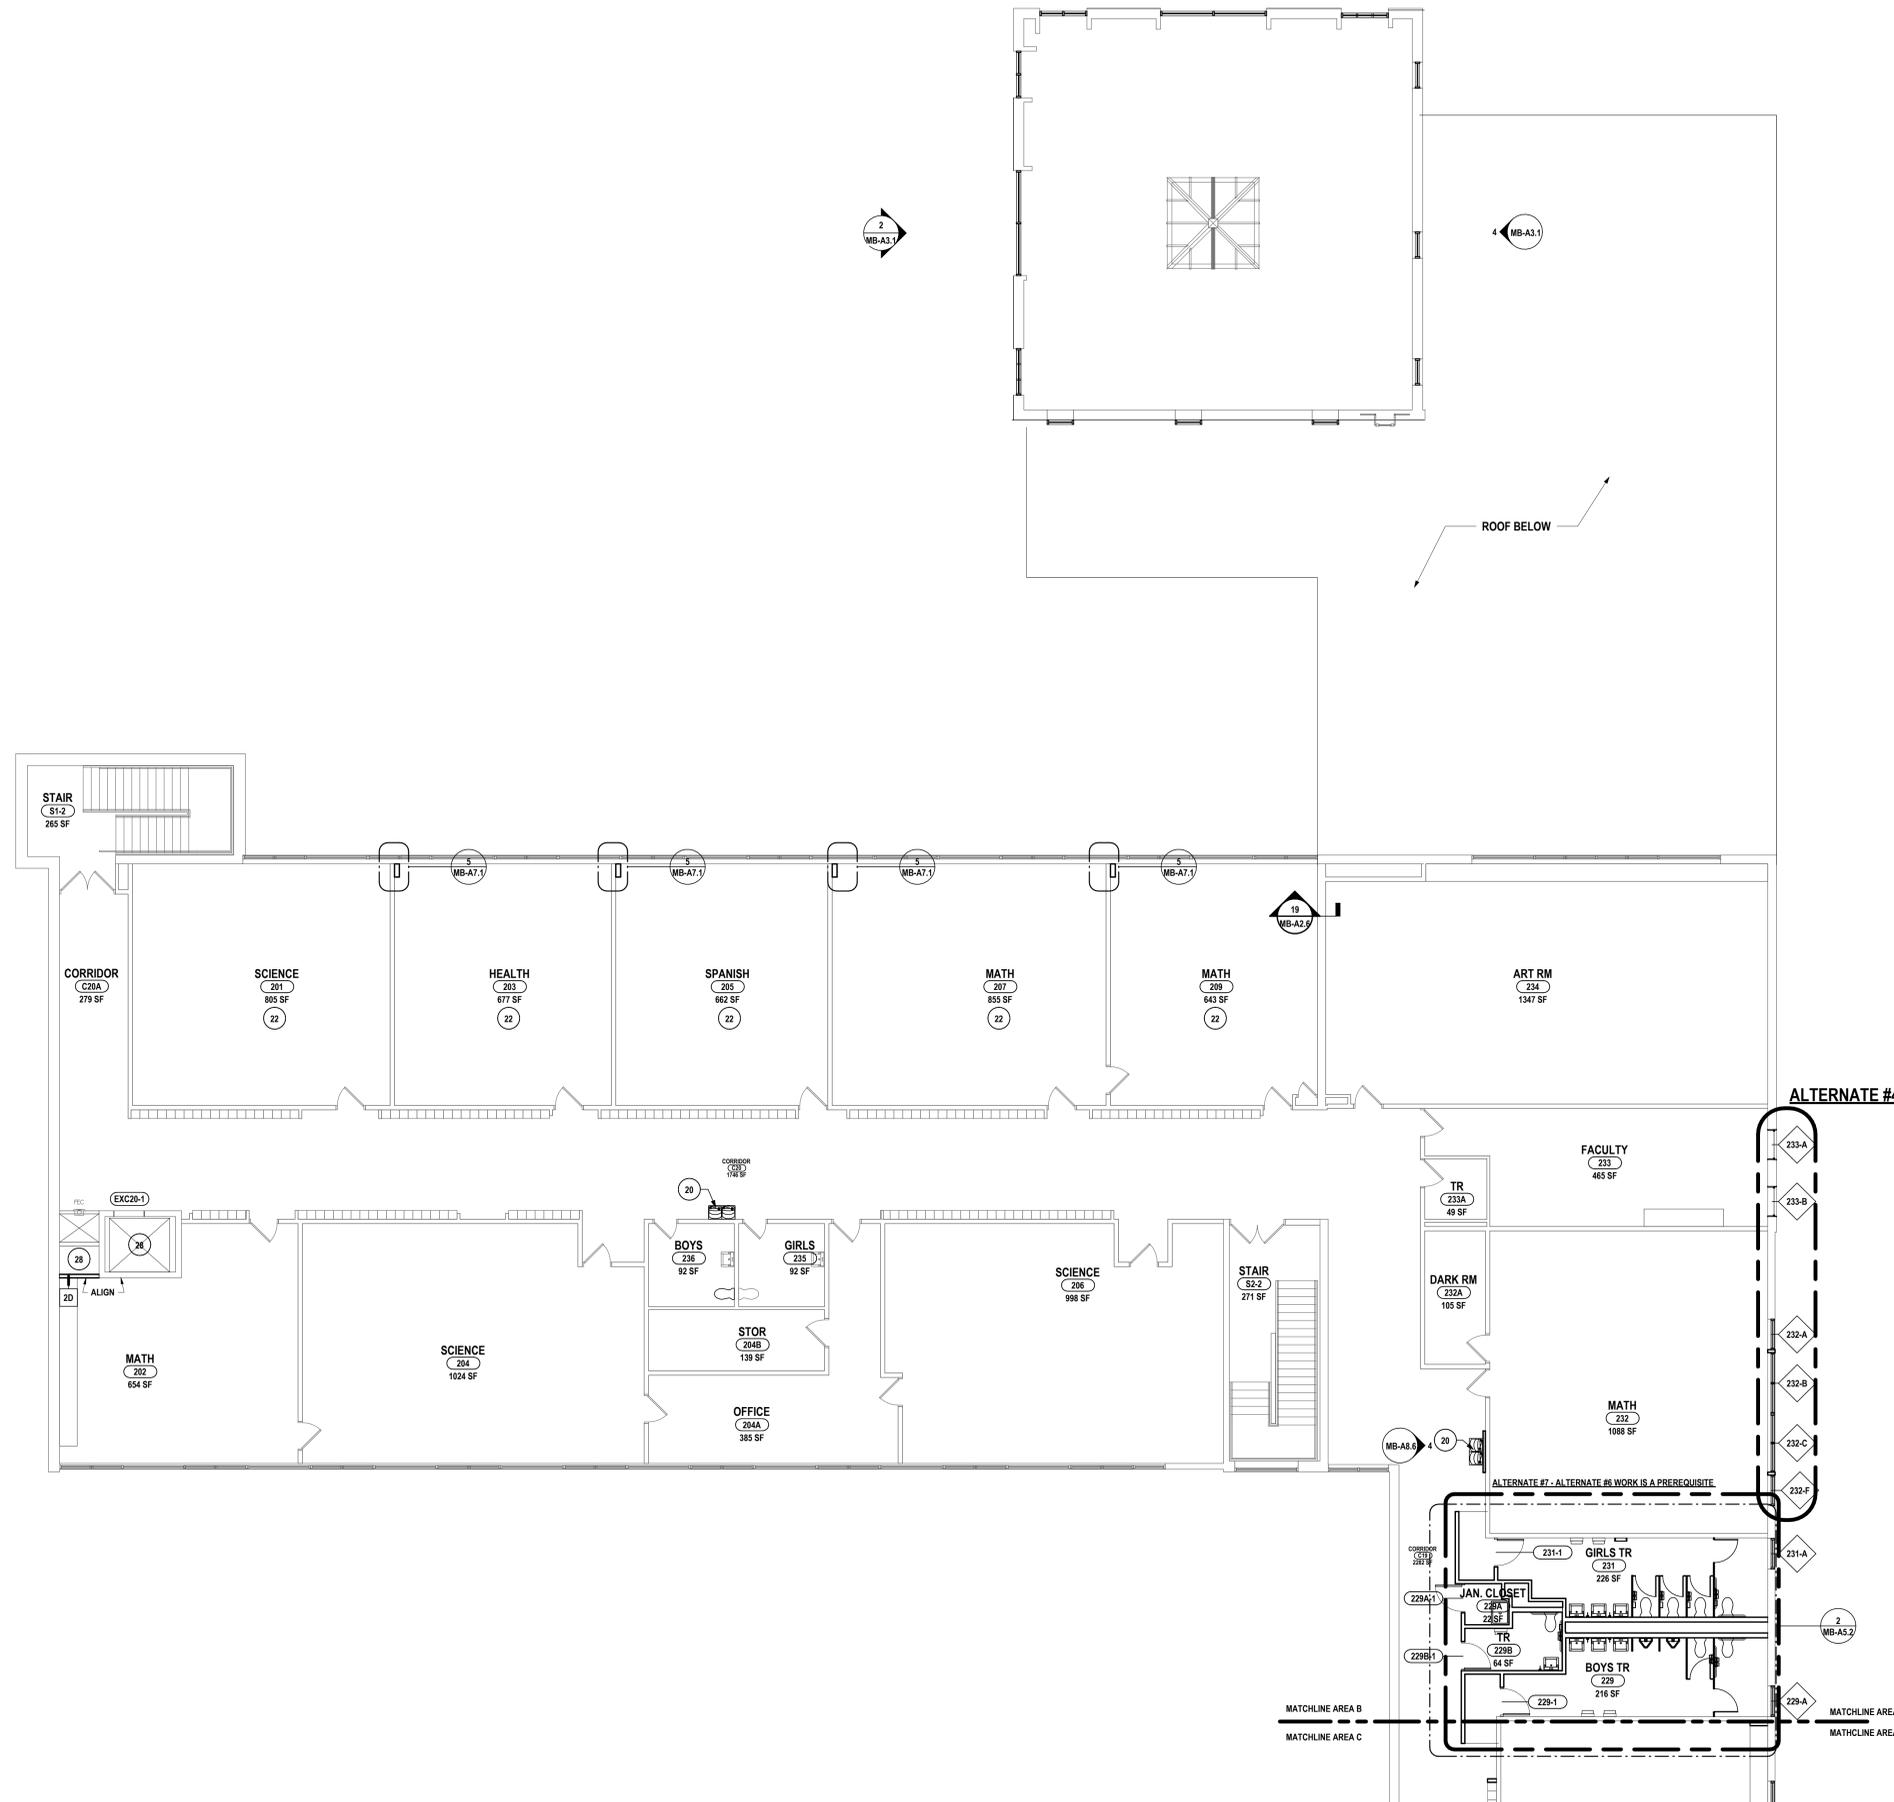

1 SECOND FLOOR PLAN - AREA B  
1/8" = 1'-0"

**GENERAL NOTES:**

- A THE CONTRACTOR IS RESPONSIBLE FOR ALL WORK REQUIRED TO IMPLEMENT THE WORK OF THE CONTRACT, REGARDLESS OF WHETHER SPECIFICALLY INDICATED OR NOT, UNLESS NOTED OTHERWISE.
- B THE CONTRACTOR SHALL VERIFY ALL DIMENSIONS AND EXISTING CONDITIONS IN THE FIELD PRIOR TO COMMENCING ANY WORK AND NOTIFY ARCHITECT IMMEDIATELY IF ANY DISCREPANCIES ARE FOUND.
- C THE CONTRACTOR SHALL COORDINATE THE WORK OF THIS CONTRACT WITH THE WORK OF ALL OTHER CONTRACTED WORK AND WORK PERFORMED BY THE OWNER.
- D ALL NEW DOOR FRAMES INSTALLED IN METAL STUD OR MASONRY PARTITIONS SHALL BE MOUNTED 4" FROM ADJACENT WALLS (6" TO DOOR), TOOTH IN CMU BLOCK AND ANCHORS AT DOORS IN EXISTING CMU WALLS, UNLESS NOTED OR DETAILED OTHERWISE.
- E WHERE NEW DOORS ARE LOCATED IN EXISTING CORRIDOR WALLS, FLOORING, GASE AND WALL SHALL BE PATCHED TO MATCH EXISTING OR NEW CORRIDOR FINISHES. REFER TO FINISH KEY.
- F PROVIDE SOLID WOOD BLOCKING OR METAL STRAPPING AS REQUIRED IN METAL STUD WALLS AT ALL WALL MOUNTED EQUIPMENT AND ACCESSORIES INCLUDING FURNITURE FIXTURES AND EQUIPMENT. COORDINATE WITH THE WORK OF ALL OTHER CONTRACTED WORK AND WORK PERFORMED BY THE OWNER.
- G ITEMS SHOWN ARE INTENDED TO GIVE APPROXIMATE QUANTITY, LOCATION & TYPE. THE CONTRACTOR IS RESPONSIBLE FOR VERIFYING ACTUAL QUANTITY & EXISTING FIELD CONDITIONS.
- H ALL DIMENSIONS ARE TAKEN FROM FACE OF WALL TO FACE OF WALL, UNLESS NOTED OTHERWISE.
- I THERE SHALL BE A MINIMUM OF 1'-4" CLEAR FLOOR SPACE ON THE PULL SIDE OF ALL NEW DOORS; THERE SHALL BE A MINIMUM OF 1'-2" CLEAR FLOOR SPACE ON THE PUSH SIDE OF ALL NEW DOORS.
- J THE WHEELCHAIR SYMBOL INDICATES HANDICAP ACCESSIBLE MOUNTED FIXTURE ELEVATION AND SHALL CONFORM WITH CABDIANS A117.1 AND ADAAG.
- K EXTEND ALL NEW PARTITIONS TO DECK ABOVE, UNLESS NOTED OTHERWISE.
- L ALL FINISHED ASSEMBLIES ARE REQUIRED TO BE PROTECTED DURING THE COURSE OF CONSTRUCTION. ALL FINISHED ASSEMBLIES DAMAGED DURING THE COURSE OF CONSTRUCTION ARE REQUIRED TO BE REPLACED OR REPAIRED AT THE ARCHITECT'S DIRECTION.

**PLAN DRAWING NOTES:**

- 1 PROVIDE NEW BASKETBALL BACKSTOP SYSTEM. REFER TO SPECIFICATION 11 66 23 FOR ADDITIONAL INFORMATION.
- 2 PROVIDE NEW BLEACHER ASSEMBLY SYSTEM. REFER TO SPECIFICATION 12 88 13 FOR ADDITIONAL INFORMATION.
- 3 PROVIDE NEW LOADING DOCK BUMPERS. REFER TO SPECIFICATION 11 13 13 FOR ADDITIONAL INFORMATION.
- 4 EXISTING WALL SYSTEM DOES NOT GO TO DECK. SISTER COLD FORMED METAL FRAMING TO EXISTING WALL AND DECK STRUCTURE TO EXTEND WALL TO DECK ABOVE. PROVIDE REQUIRED SIZED UNFACED BATT INSULATION AND 5/8" TYPE X GYPSUM WALL BOARD BOTH SIDES. PROVIDE FIRE TAPE AND FIREPROOFING FOR ALL REQUIRED PENETRATIONS. REFER TO CODE COMPLIANCE SHEETS FOR RATING LOCATION, PARTIALLY REMOVE AND REINSTALL EXISTING CEILING SYSTEM AS REQUIRED.
- 5 INFILL EXISTING DOOR, WINDOW, OR WALL OPENING AS SHOWN ON PLAN TO MATCH EXISTING WALL THICKNESS AND PREPARE FOR NEW FINISHES.
- 6 PROVIDE WALL PADS ON EXPOSED WALLS AS INDICATED (NO WALL PADS BEHIND BLEACHERS); PROVIDE CUTOUPS FOR ALL WALL MOUNTED EQUIPMENT/FIXTURES AS REQUIRED.
- 7 PROVIDE CONCRETE PAD WITH FROST WALL AT DOOR. REFER TO 'S' DRAWINGS FOR ADDITIONAL DETAILS.
- 8 PROVIDE 4" SAFETY YELLOW FLOOR PAINT AT FLOOR TRANSITION AS PER SED CODE.
- 9 PROVIDE NEW WOOD WALL PANEL FINISHES; REFER TO FINISH SCHEDULE FOR ADDITIONAL INFORMATION. REMOVE EXISTING WALL MOSAIC TILE FINISH AND PREPARE FOR NEW FINISHES.
- 10 PROVIDE ADJUSTABLE WALL SHELVING, 6.0 D GEAR BOSS MOUNTED ON WALL 24" O225. STARTER BAY AS REQUIRED. 24" O225 ADD ON BAYS AS REQUIRED. PROVIDE (3) 24" O225: 38 1/2" SHELF, (1) 24" O225: GARMENT PER BAY. ALL SHELF UNITS TO COME WITH OPTIONS SOLID TOP. QUANTITY OF BAYS AS SHOWN ON PLANS.
- 11 PROVIDE NEW GYM WOOD FLOOR SYSTEM & ALL ACCESSORIES. PAINT, & SEAL & FINISH FLOOR PER SPECIFICATION 09 64 56.
- 12 INFILL EXISTING MASONRY OPENING TO MATCH EXISTING WALL CONSTRUCTION & THICKNESS, UNLESS NOTED OTHERWISE. TOOTH IN NEW OR SALVAGED MASONRY WITH EXISTING. MATCH EXISTING FINISHES OR PREPARE SUBSTRATE AS REQUIRED TO ACCEPT NEW FINISHES.
- 13 PROVIDE LOCKERS, BASE AND ASSOCIATED ACCESSORIES IN THEIR ENTIRETY.
- 14 CFMF BENCH WITH SOLID SURFACE MATERIAL HORIZONTAL SURFACE.
- 15 PROVIDE BLACK PVC BLOCKING AND 1" THICK SOLID COMPOSITE DECKING SYSTEM AROUND STRUCTURAL STEEL BEAM.
- 16 INFILL EXISTING MASONRY OPENING. PROVIDE BRICK VENEER, 2" OF POLYISO INSULATION, WEATHER BARRIER TO FURTHEST EXTENT POSSIBLE AND CONCRETE MASONRY INTERIOR. TOOTH IN NEW OR SALVAGED MASONRY WITH EXISTING. MATCH EXISTING FINISHES OR PREPARE SUBSTRATE AS REQUIRED TO ACCEPT NEW FINISHES.
- 17 REPAIR EXISTING STOREFRONT WINDOW. TO BE RE-GLAZED, RE-CAULKED, OR FRAME REPLACEMENT. REPAIR SURROUNDING WALL SURFACES WHERE DAMAGE OCCURS.
- 18 FOLDING WALL PARTITION; REFER TO SPECIFICATION 10 22 39 FOR ADDITIONAL INFORMATION.
- 19 WALL-MOUNTED ACOUSTIC, STORAGE, MARKERBOARD, & DISPLAY SURROUND SYSTEM: PLATINUM VISUAL SYSTEMS P360 WALL SYSTEM. REFER TO MB-A8.9 FOR SYSTEM DETAILS.
- 20 NEW DRINKING FOUNTAIN FIXTURE. REFER TO 'P' DRAWINGS FOR ADDITIONAL INFORMATION. PATCH FINISHES TO MATCH AS REQUIRED.
- 21 PROVIDE NEW FIRE EXTINGUISHER HANGER/BRACKET AT LOCATION SHOWN; RELOCATE EXISTING FIRE EXTINGUISHER AND ACCESSORIES TO NEW LOCATION.
- 22 PATCH AND REPAIR EXISTING WALL SYSTEM AND FLOOR SYSTEM FROM HVAC REMOVALS AND PREPARE FOR NEW FINISHES AS REQUIRED.
- 23 PATCH TO MATCH CONCRETE FLOOR SLAB AND PORCELAIN MOSAIC FLOOR FINISH TO THE EXTENT OF REQUIRED LOCKER DEMO. TOOTH IN TILE AS REQUIRED.
- 24 PROVIDE BENCH INFILL TO CONNECT THE EXISTING BENCHES TO THE EXTENT SHOWN ON PLAN.
- 25 PROVIDE NEW WINDOW IN EXISTING OPENING. REUSE EXISTING SILL; INFILL SURROUNDING EXISTING OPENING TO MATCH EXISTING WALL CONSTRUCTION AND THICKNESS.
- 26 PROVIDE WALL CHASE(S) FOR LV PIPING. SEE 'H' DRAWINGS FOR MORE INFORMATION.
- 27 PATCH GYPSUM WALL BOARD AS REQUIRED TO RECEIVE NEW FINISHES.
- 28 HYDRAULIC PASSENGER ELEVATOR MODERNIZATION. REFER TO SPECIFICATION 14-28-19 FOR MORE INFORMATION.

DRAWN BY: KLG	
CHECKED BY: JJ	
DATE: 10/27/2025	ISSUE FOR BID
PHASE: CD	DESCRIPTION OF REVISION:
# DATE:	ISSUE FOR BID
1 10/10/2025	

**HUNT ENGINEERS ARCHITECTS | SURVEYORS**  
 HORSEHEADS, NY 607-568-1008 PROQUESTREE, NY 562-637-7668 TOWANDA, PA 570-265-4668  
 BINGHAMTON, NY 607-798-8081 ALBANY, NY 607-798-4801  
 WWW.HUNTEAS.COM  
 NY CERTIFICATE NO. 0016920 PA CERTIFICATE NO. TSC2203131464-1

SECOND FLOOR PLAN - AREA B  
 2025 CAPITAL IMPROVEMENTS PROJECT  
 HAMMONDSPORT CENTRAL SCHOOL DISTRICT  
 8272 MAIN STREET HAMMONDSPORT, NEW YORK, 14840

**MB-A1.4**  
 PROJECT NO: 1925.014


SED #: MB-57-26-01-04-02-025160-57-26-01-04-5-003-008

**GENERAL NOTES:**


- A THE CONTRACTOR IS RESPONSIBLE FOR ALL WORK REQUIRED TO IMPLEMENT THE WORK OF THE CONTRACT, REGARDLESS OF WHETHER SPECIFICALLY INDICATED OR NOT, UNLESS NOTED OTHERWISE.
- B THE CONTRACTOR SHALL VERIFY ALL DIMENSIONS AND EXISTING CONDITIONS IN THE FIELD PRIOR TO COMMENCING ANY WORK AND NOTIFY ARCHITECT IMMEDIATELY IF ANY DISCREPANCIES ARE FOUND.
- C THE CONTRACTOR SHALL COORDINATE THE WORK OF THIS CONTRACT WITH THE WORK OF ALL OTHER CONTRACTED WORK AND WORK PERFORMED BY THE OWNER.
- D ALL NEW DOOR FRAMES INSTALLED IN METAL STUD OR MASONRY PARTITIONS SHALL BE MOUNTED 4" FROM ADJACENT WALLS (6" TO DOOR), TOOTH IN CMU BLOCK AND ANCHORS AT DOORS IN EXISTING CMU WALLS, UNLESS NOTED OR DETAILED OTHERWISE.
- E WHERE NEW DOORS ARE LOCATED IN EXISTING CORRIDOR WALLS, FLOORING, BASE AND WALL SHALL BE PATCHED TO MATCH EXISTING OR NEW CORRIDOR FINISHES. REFER TO FINISH KEY.
- F PROVIDE SOLID WOOD BLOCKING OR METAL STRAPPING AS REQUIRED IN METAL STUD WALLS AT ALL WALL MOUNTED EQUIPMENT AND ACCESSORIES INCLUDING FURNITURE FIXTURES AND EQUIPMENT. COORDINATE WITH THE WORK OF ALL OTHER CONTRACTED WORK AND WORK PERFORMED BY THE OWNER.
- G ITEMS SHOWN ARE INTENDED TO GIVE APPROXIMATE QUANTITY, LOCATION & TYPE. THE CONTRACTOR IS RESPONSIBLE FOR VERIFYING ACTUAL QUANTITY & EXISTING FIELD CONDITIONS.
- H ALL DIMENSIONS ARE TAKEN FROM FACE OF WALL TO FACE OF WALL, UNLESS NOTED OTHERWISE.
- I THERE SHALL BE A MINIMUM OF 1'-0" CLEAR FLOOR SPACE ON THE PULL SIDE OF ALL NEW DOORS; THERE SHALL BE A MINIMUM OF 1'-0" CLEAR FLOOR SPACE ON THE PUSH SIDE OF ALL NEW DOORS.
- J THE WHEELCHAIR SYMBOL INDICATES HANDICAP ACCESSIBLE MOUNTED FIXTURE ELEVATION AND SHALL CONFORM WITH CABO/DIANSI A117.1 AND ADAAG.
- K EXTEND ALL NEW PARTITIONS TO DECK ABOVE, UNLESS NOTED OTHERWISE.
- L ALL FINISHED ASSEMBLIES ARE REQUIRED TO BE PROTECTED DURING THE COURSE OF CONSTRUCTION. ALL FINISHED ASSEMBLIES DAMAGED DURING THE COURSE OF CONSTRUCTION ARE REQUIRED TO BE REPLACED OR REPAIRED AT THE ARCHITECT'S DIRECTION.

**PLAN DRAWING NOTES:**

- 1 PROVIDE NEW BASKETBALL BACKSTOP SYSTEM. REFER TO SPECIFICATION 11 66 23 FOR ADDITIONAL INFORMATION.
- 2 PROVIDE NEW BLEACHER ASSEMBLY SYSTEM. REFER TO SPECIFICATION 12 66 13 FOR ADDITIONAL INFORMATION.
- 3 PROVIDE NEW LOADING DOCK BUMPERS. REFER TO SPECIFICATION 11 13 13 FOR ADDITIONAL INFORMATION.
- 4 EXISTING WALL SYSTEM DOES NOT GO TO DECK. SISTER COLD FORMED METAL FRAMING TO EXISTING WALL AND DECK STRUCTURE. EXTEND WALL TO DECK ABOVE. PROVIDE REQUIRED SIZED UNFACED BATT INSULATION AND 5/8" TYPE X GYPSUM WALL BOARD BOTH SIDES. PROVIDE FIRE TAPE AND FIREPROOFING FOR ALL REQUIRED PENETRATIONS. REFER TO CODE COMPLIANCE SHEETS FOR RATING LOCATION. PARTIALLY REMOVE AND REINSTALL EXISTING CEILING SYSTEM AS REQUIRED.
- 5 INFILL EXISTING DOOR, WINDOW, OR WALL OPENING AS SHOWN ON PLAN TO MATCH EXISTING WALL THICKNESS AND PREPARE FOR NEW FINISHES.
- 6 PROVIDE WALL PADS ON EXPOSED WALLS AS INDICATED (NO WALL PADS BEHIND BLEACHERS). PROVIDE CUTOUTS FOR ALL WALL MOUNTED EQUIPMENT/FIXTURES AS REQUIRED.
- 7 PROVIDE CONCRETE PAD WITH FROST WALL AT DOOR. REFER TO 'S' DRAWINGS FOR ADDITIONAL DETAILS.
- 8 PROVIDE 4" SAFETY YELLOW FLOOR PAINT AT FLOOR TRANSITION AS PER SED CODE.
- 9 PROVIDE NEW WOOD WALL PANEL FINISHES. REFER TO FINISH SCHEDULE FOR ADDITIONAL INFORMATION. REMOVE EXISTING WALL MOSAIC TILE FINISH AND PREPARE FOR NEW FINISHES.
- 10 PROVIDE ADJUSTABLE WALL SHELVING, B.O.D GEAR BOSS MOUNTED ON WALL: 241C025; STARTER BAY AS REQUIRED, 241C026 ADD ON BAYS AS REQUIRED, PROVIDE (5) 241C001; 30 1/2" SHELF, (1) 241C004; GARMENT PER BAY. ALL SHELF UNITS TO COME WITH OPTIONS SOLID TOP. QUANTITY OF BAYS AS SHOWN ON PLANS.
- 11 PROVIDE NEW GYM WOOD FLOOR SYSTEM & ALL ACCESSORIES. PAINT, & SEAL & FINISH FLOOR PER SPECIFICATION 09 64 66.
- 12 INFILL EXISTING MASONRY OPENING TO MATCH EXISTING WALL CONSTRUCTION & THICKNESS, UNLESS NOTED OTHERWISE. TOOTH IN NEW OR SALVAGED MASONRY WITH EXISTING. MATCH EXISTING FINISHES OR PREPARE SUBSTRATE AS REQUIRED TO ACCEPT NEW FINISHES.
- 13 PROVIDE LOCKERS, BASE AND ASSOCIATED ACCESSORIES IN THEIR ENTIRETY.
- 14 CFMF BENCH WITH SOLID SURFACE MATERIAL HORIZONTAL SURFACE.
- 15 PROVIDE BLACK PVC BLOCKING AND 1" THICK SOLID COMPOSITE DECKING SYSTEM AROUND STRUCTURAL STEEL BEAM.
- 16 INFILL EXISTING MASONRY OPENING. PROVIDE BRICK VENEER, 2" OF POLYISO INSULATION, WEATHER BARRIER TO FURTHEST EXTENT POSSIBLE AND CONCRETE MASONRY INTERIOR. TOOTH IN NEW OR SALVAGED MASONRY WITH EXISTING. MATCH EXISTING FINISHES OR PREPARE SUBSTRATE AS REQUIRED TO ACCEPT NEW FINISHES.
- 17 REPAIR EXISTING STOREFRONT WINDOW; TO BE RE-GLAZED, RE-CAULKED, OR FRAME REPLACEMENT. REPAIR SURROUNDING WALL SURFACES WHERE DAMAGE OCCURS.
- 18 FOLDING WALL PARTITION; REFER TO SPECIFICATION 10 22 39 FOR ADDITIONAL INFORMATION.
- 19 WALL MOUNTED ACOUSTIC STORAGE MARKERBOARD, & DISPLAY SURROUND SYSTEM. PLATINUM VISUAL SYSTEMS P360 WALL SYSTEM. REFER TO MB-A8.9 FOR SYSTEM DETAILS.
- 20 NEW DRINKING FOUNTAIN FIXTURE; REFER TO 'P' DRAWINGS FOR ADDITIONAL INFORMATION. PATCH FINISHES TO MATCH AS REQUIRED.
- 21 PROVIDE NEW FIRE EXTINGUISHER HANGER/BRACKET AT LOCATION SHOWN; RELOCATE EXISTING FIRE EXTINGUISHER AND ACCESSORIES TO NEW LOCATION.
- 22 PATCH AND REPAIR EXISTING FLOOR SYSTEM AND FLOOR SYSTEM FROM HVAC REMOVALS AND PREPARE FOR NEW FINISHES AS REQUIRED.
- 23 PATCH TO MATCH CONCRETE FLOOR SLAB AND PORCELAIN MOSAIC FLOOR FINISH TO THE EXTENT OF REQUIRED LOCKER DEMO. TOOTH IN TILE AS REQUIRED.
- 24 PROVIDE BENCH INFILL TO CONNECT THE EXISTING BENCHES TO THE EXTENT SHOWN ON PLAN.
- 25 PROVIDE NEW WINDOW IN EXISTING OPENING. REUSE EXISTING SILL; INFILL SURROUNDING EXISTING OPENING TO MATCH EXISTING WALL CONSTRUCTION AND THICKNESS.
- 26 PROVIDE WALL CHASE(S) FOR UV PIPING. SEE 'H' DRAWINGS FOR MORE INFORMATION.
- 27 PATCH GYPSUM WALL BOARD AS REQUIRED TO RECEIVE NEW FINISHES.
- 28 HYDRAULIC PASSENGER ELEVATOR MODERNIZATION. REFER TO SPECIFICATION 14-28-19 FOR MORE INFORMATION.

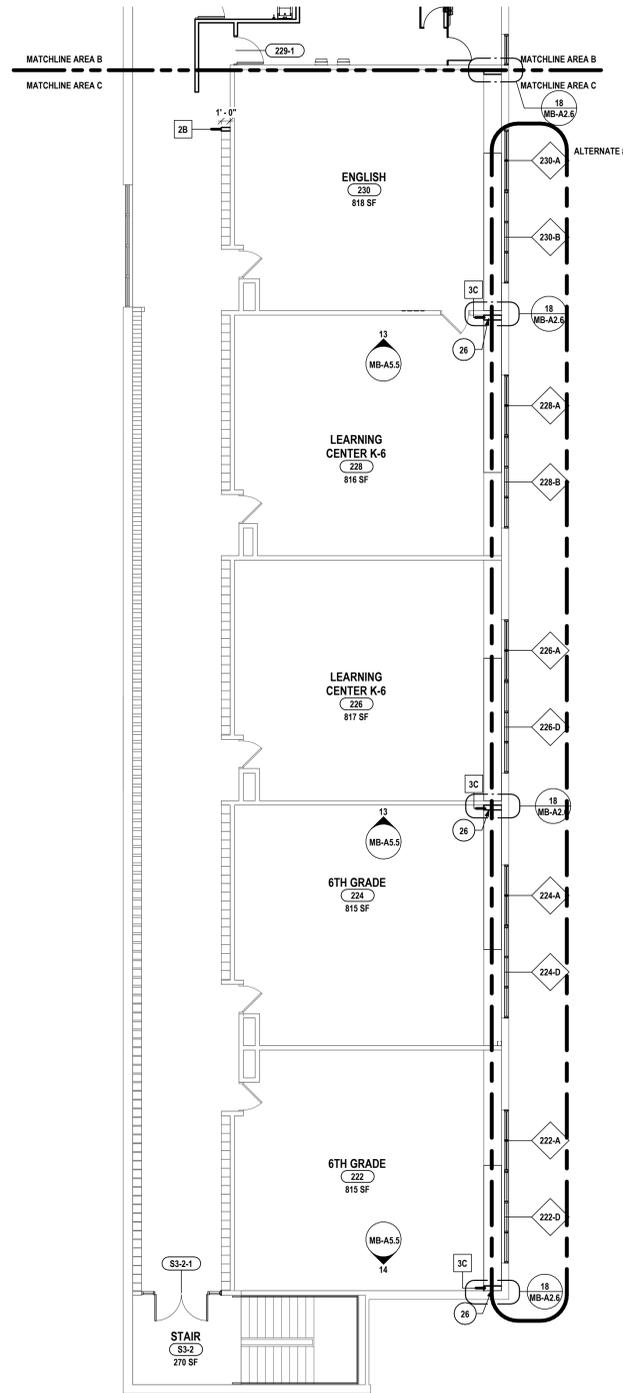

1 SECOND FLOOR PLAN - AREA C  
1/8" = 1'-0"

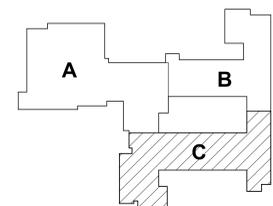

KEY PLAN

DRAWN BY:	KLC
CHECKED BY:	JL
DATE:	10/27/2025
PHASE:	CD

#	DATE:	DESCRIPTION OF REVISION:
	1	10/10/2025

**HUNT ENGINEERS ARCHITECTS | SURVEYORS**

HORSEHEADS, NY 807-798-1000    ROCHESTER, NY 585-637-7668    TOWANDA, PA 570-265-4668  
 BINGHAMTON, NY 807-798-8881    ALBANY, NY 807-798-8881  
 WWW.HUNTEAS.COM  
 NY CERTIFICATE NO. 0016250    PA CERTIFICATE NO. TSC22020131464-1

**SECOND FLOOR PLAN - AREA C**  
**2025 CAPITAL IMPROVEMENTS PROJECT**  
**HAMMONDSPORT CENTRAL SCHOOL DISTRICT**  
 8272 MAIN STREET HAMMONDSPORT, NEW YORK, 14840

**MB-A1.5**  
 PROJECT NO: 1925.014

SED #: MB-17-28-01-04-02-02-03-03-06-07-29-01-04-5-003-008  
 NY CERTIFICATE NO. 0016250





**GENERAL ROOF NOTES:**


- A THE CONTRACTOR SHALL PROTECT EXISTING CONSTRUCTION TO REMAIN. ALL EXISTING ROOFING SYSTEMS DAMAGED DURING THE COURSE OF CONSTRUCTION SHALL BE RESTORED TO THEIR ORIGINAL CONDITION.
- B A TAPERED INSULATION SHOP DRAWING SUBMISSION IS REQUIRED TO IDENTIFY INSULATION LAYOUT, DRAINAGE PATTERN, SLOPE AND MINIMUM "R" VALUE.
- C PROVIDE ALL MATERIALS TO MAKE SMOOTH TRANSITIONS AT ROOF EDGES AND INTERSECTIONS.
- D PROVIDE FLASHING AT ALL PENETRATIONS.
- E PROVIDE ADDITIONAL SLOTTING AT ALL ROOF PENETRATIONS WHERE REQUIRED TO PROVIDE A MINIMUM CURB HEIGHT OF 12" ABOVE THE FINISHED ROOF SURFACE.
- F PROVIDE ALL ROOF OPENINGS REQUIRED FOR ALL PENETRATIONS, COORDINATE WITH ALL OTHER CONTRACTED WORK FOR EXACT SIZE AND LOCATION.
- G PREVENT DIRT AND ROOFING DEBRIS FROM ENTERING THE ROOF DRAINS AND DRAIN LINES (LEADERS) DURING CONSTRUCTION. THE CONTRACTOR SHALL SNAKE DRAIN LINES AT COMPLETION OF WORK IN THE PRESENCE OF THE OWNER'S REPRESENTATIVE.
- H IF EXISTING ROOF DECK OR STRUCTURAL SYSTEM DAMAGE IS SUSPECTED OR EXPOSED DURING THE COURSE OF CONSTRUCTION, NOTIFY THE OWNER'S REPRESENTATIVE IMMEDIATELY.

**ROOF DRAWING NOTES:**


- 1 PROVIDE CRICKETS AT ALL CURBS, RAILS, ETC. WHICH RUN IN LENGTH GREATER THAN 24" PERPENDICULAR TO THE SLOPE OF ROOF INSULATION. SLOPE OF CRICKETS SHALL BE 1/2" VERTICAL PER 12" HORIZONTAL.
- 2 SERVICE WALKWAY: 34" x 50" WALKWAY PADS WITH DIAMOND PLATE PATTERN. HEAT WELDED TO ROOF MEMBRANE.
- 3 SERVICE WALKWAY: PROVIDE 24" x 24" EPDM WALKWAY PADS FULLY ADHERED TO EXISTING ROOF MEMBRANE.
- 4 PATCH ROOF AT REMOVED PENETRATION, EQUIPMENT, CURB, EQUIPMENT RAILS. NEW ROOF INSULATION SHALL BE FLUSH WITH EXISTING. PATCH AND MEMBRANE TIE IN SHALL NOT VOID THE WARRANTY OF THE EXISTING ROOF. REFER TO DETAIL 61A.9
- 5 EXISTING ROOF LADDER: PROVIDE NEW FASTENERS AND SECURE TO EXISTING FACADE
- 6 PATCH ROOF AT REMOVED SECTION TO FACILITATE STRUCTURAL MODIFICATIONS. REFER TO STRUCTURAL DRAWINGS FOR DECK TYPE. NEW ROOF INSULATION SHALL BE FLUSH WITH EXISTING ROOF ASSEMBLY AT TRANSITION, AND TAPERED AS REQUIRED TO MATCH EXISTING DRAINAGE PATTERN. PATCH AND MEMBRANE TIE IN SHALL NOT VOID THE WARRANTY OF THE EXISTING ROOF. REFER TO DETAIL 61A.9
- 7 ROOF DUNAGE W/ WALK PLATFORM: REFER TO STRUCTURAL "S" DRAWINGS
- 8 STEEL SHIPS LADDER: REFER TO PLAN SECTION DETAIL
- 9 PROVIDE TYPICAL CURB DETAIL AROUND VERTICAL DUCTWORK FROM ROOFTOP UNIT THROUGH ROOF STRUCTURE; V.I.F. EXACT DIMENSIONS
- 10 MECHANICAL SCREEN AS SPECIFIED.

**ROOF LEGEND:**

- FULLY ADHERED EPDM MEMBRANE ON TAPERED RIGID INSULATION, MINIMUM THICKNESS OF 4". INSULATION TO BE FULLY ADHERED TO ONE LAYER OF A 40 MIL RUBBERIZED ASPHALTIC VAPOR RETARDER OVER METAL DECK SYSTEM TO ACHIEVE AN AVERAGE R VALUE OF 28. SLOPED STRUCTURE BELOW.
- EXISTING ROOF SYSTEM TO REMAIN
- NEW ROOF DRAIN
- VENT PIPE
- ARROW INDICATES DIRECTION OF SLOPE FOR THE ROOF STRUCTURE OR TAPERED INSULATION (SEE STRUCTURAL DRAWINGS)
- \*8" HP INSULATION THK @ HIGH POINT
- \*2" LP INSULATION THK @ LOW POINT

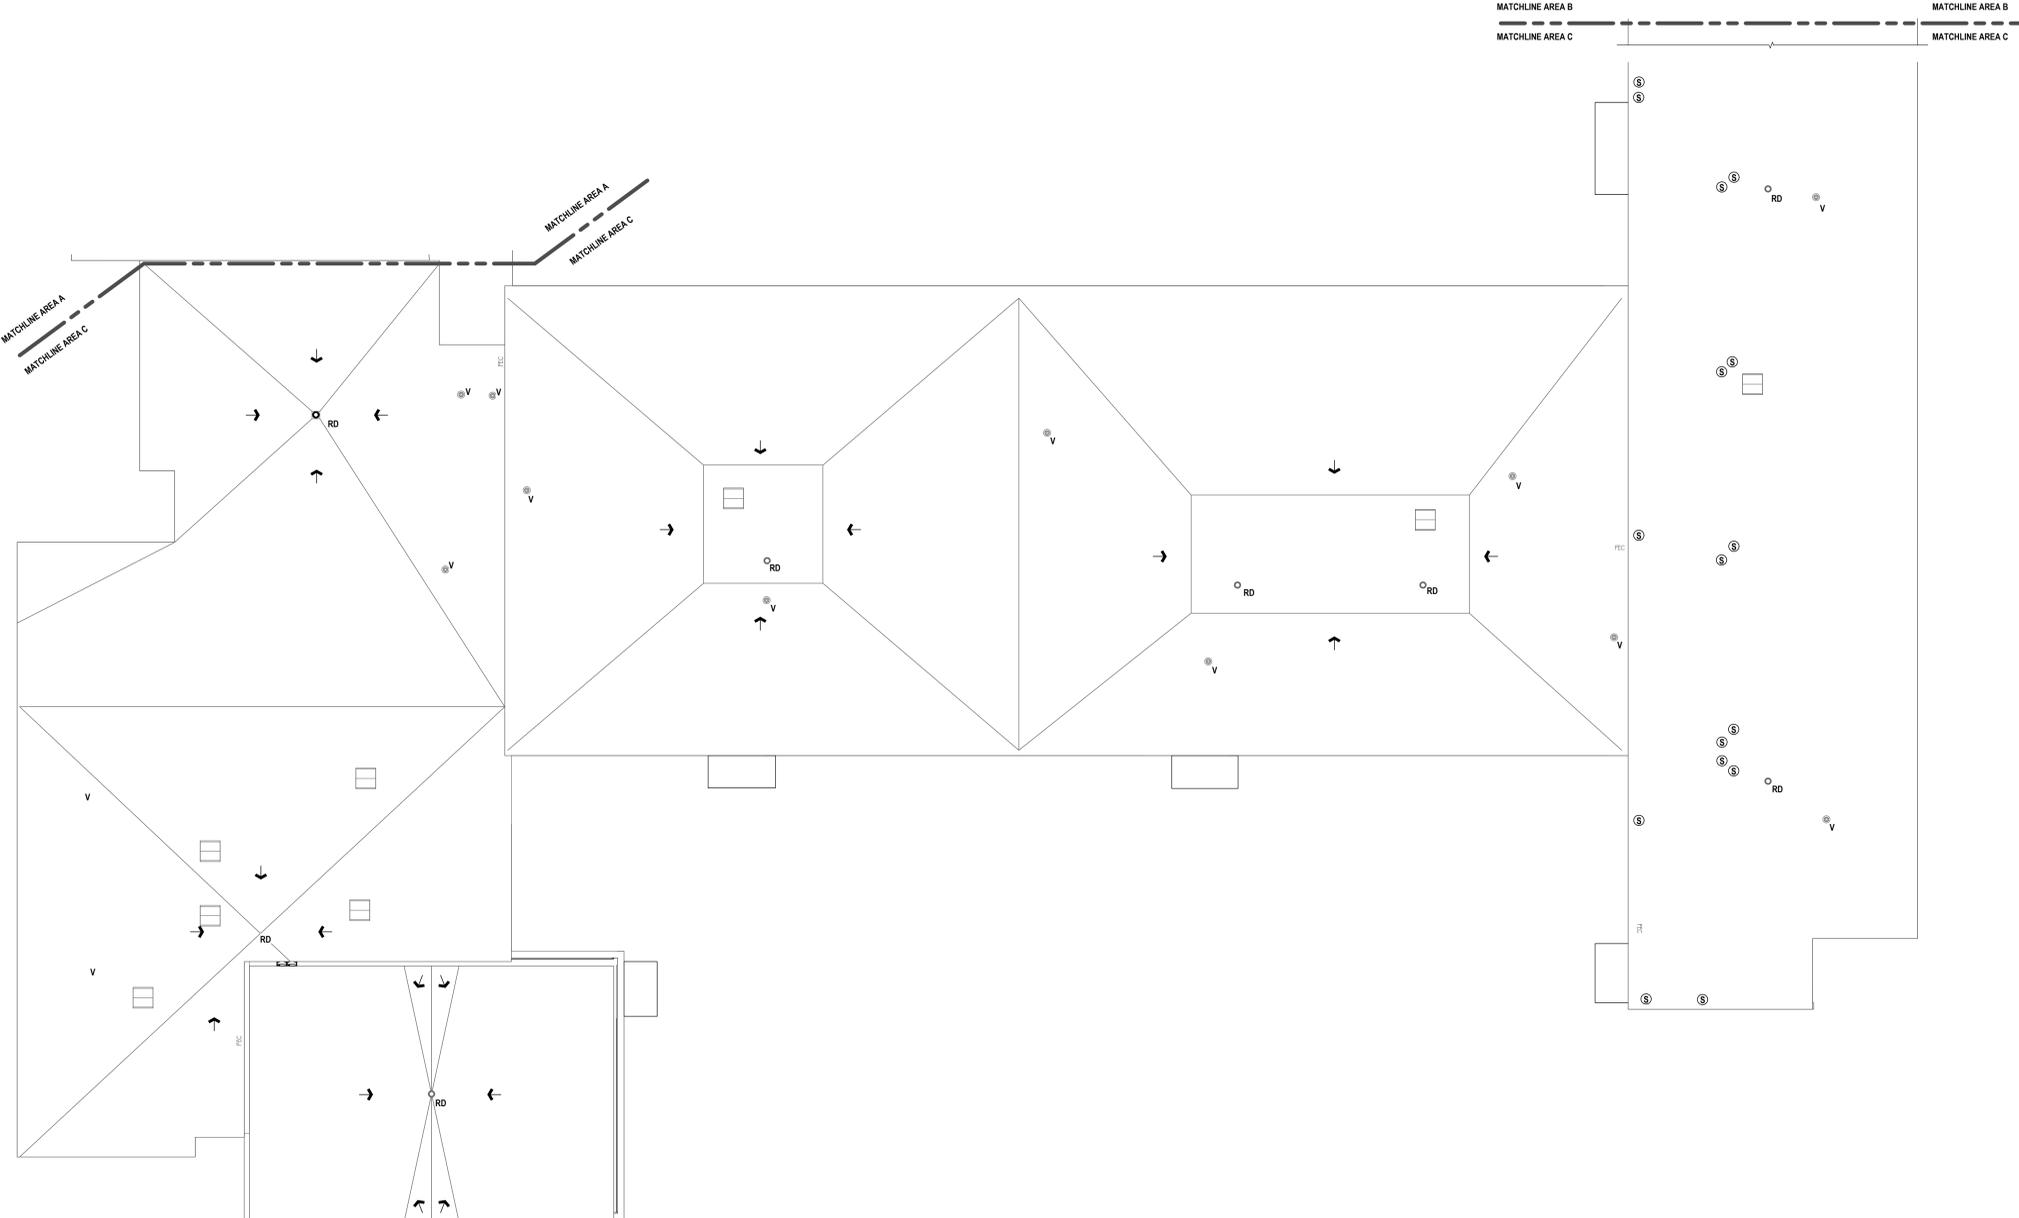

1 ROOF PLAN - AREA C  
3/32" = 1'-0"

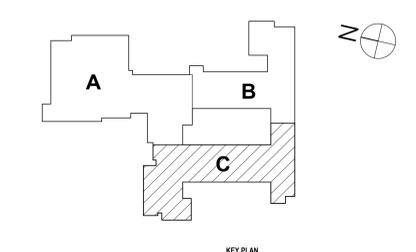

DRAWN BY:	KLJ	
CHECKED BY:	JL	
DATE:	10/27/2025	
PHASE:	CD	
DESCRIPTION OF REVISION:		
#	DATE	ISSUE FOR BID
1	10/10/2025	

**HUNT ENGINEERS ARCHITECTS | SURVEYORS**  
 HORSEHEADS, NY 607-458-1000    ROCKY HILLS, NY 562-337-7668    TOYAHVALLEY, PA 470-265-4668  
 BINGHAMTON, NY 607-798-8881    ALBANY, NY 607-798-8881    WWW.HUNTEAS.COM  
 NY CERTIFICATE NO. 0016250    PA CERTIFICATE NO. TSC220313464-1

ROOF PLAN - AREA C  
 2025 CAPITAL IMPROVEMENTS PROJECT  
 HAMMONDSPORT CENTRAL SCHOOL DISTRICT  
 8272 MAIN STREET HAMMONDSPORT, NEW YORK, 14840

**MB-A1.8**  
 PROJECT NO: 1925.014


SED #: MB-17-28-01-04-02-03-06-07-28-01-04-03-08

Copyright 2025

IT IS A VIOLATION OF THE LAW FOR ANY PERSON TO MAKE UNAUTHORIZED ALTERATIONS OR ADDITIONS TO PLANS DRAWING, CALCULATIONS, ENGINEERING, ARCHITECTURE OR SURVEYING.



ALTERNATE #3

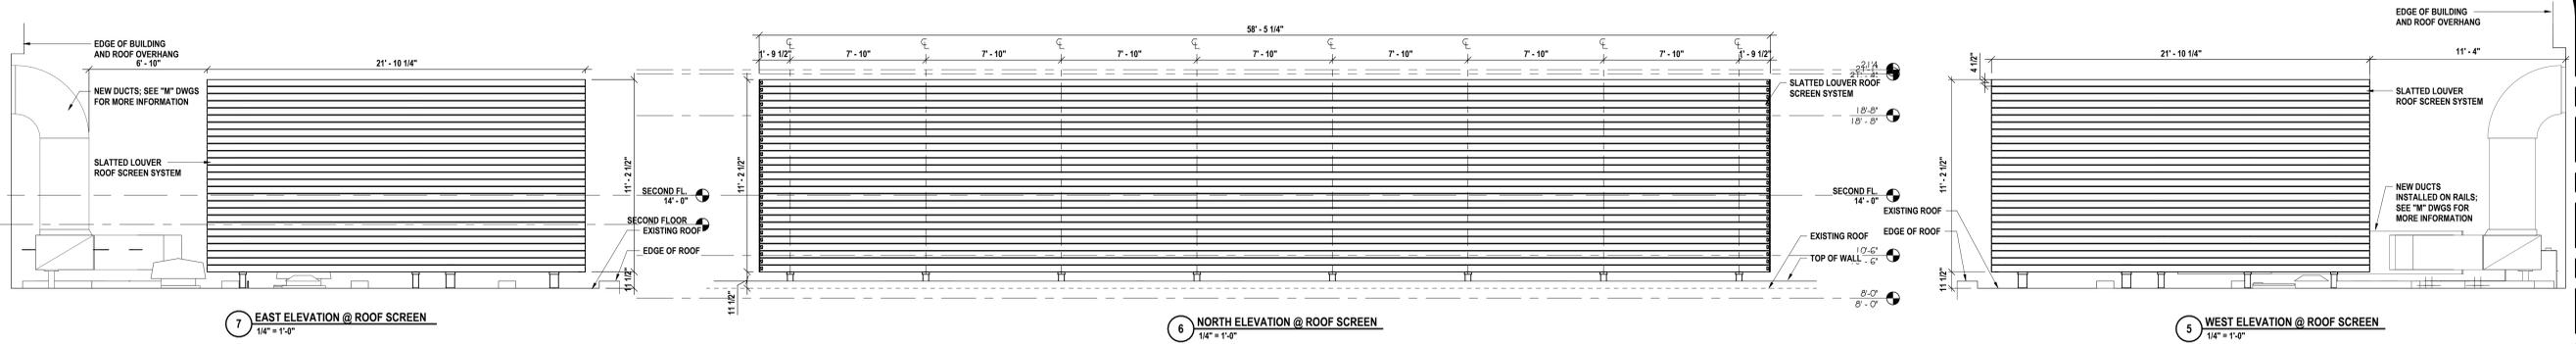


7 EAST ELEVATION @ ROOF SCREEN  
1/4" = 1'-0"


6 NORTH ELEVATION @ ROOF SCREEN  
1/4" = 1'-0"

5 WEST ELEVATION @ ROOF SCREEN  
1/4" = 1'-0"


4 ROOF SCREEN LOUVER DETAIL  
3" = 1'-0"

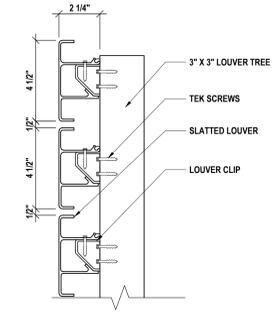


3 ROOF SCREEN SC3 FRAME DETAIL  
3/4" = 1'-0"

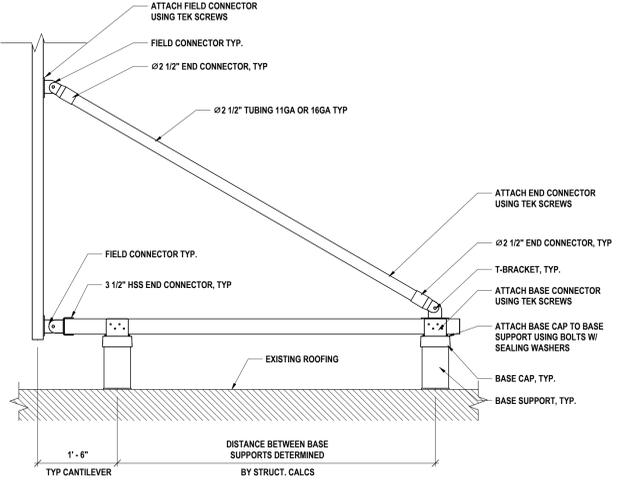


2 SECTION @ MECHANICAL ROOF SCREEN  
3/8\"/>

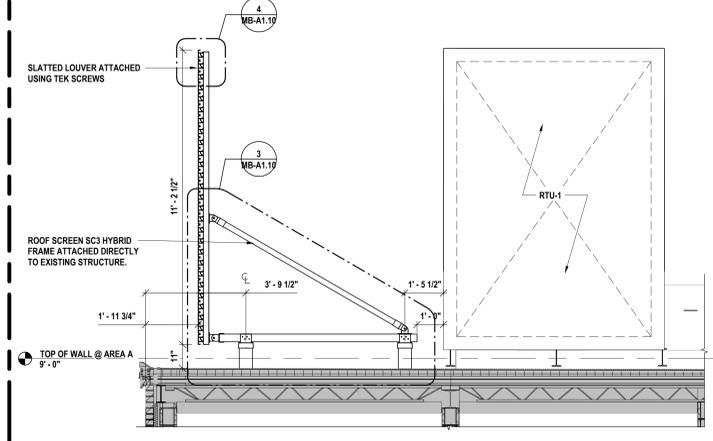

8 ENLARGED ROOF PLAN @ KITCHEN SCREEN  
3/8\"/>

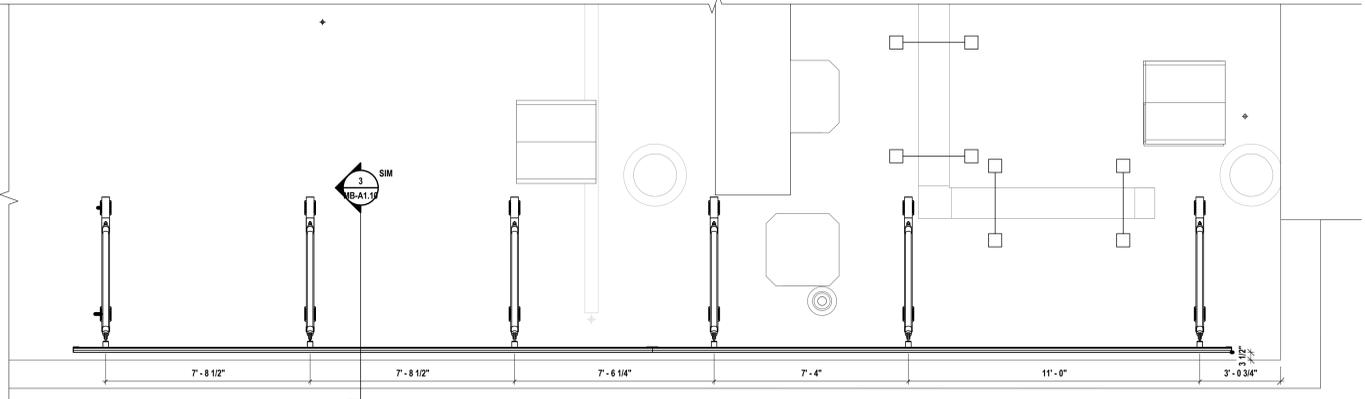

1 ENLARGED ROOF PLAN @ LOCKER ROOM SCREEN  
3/8\"/>

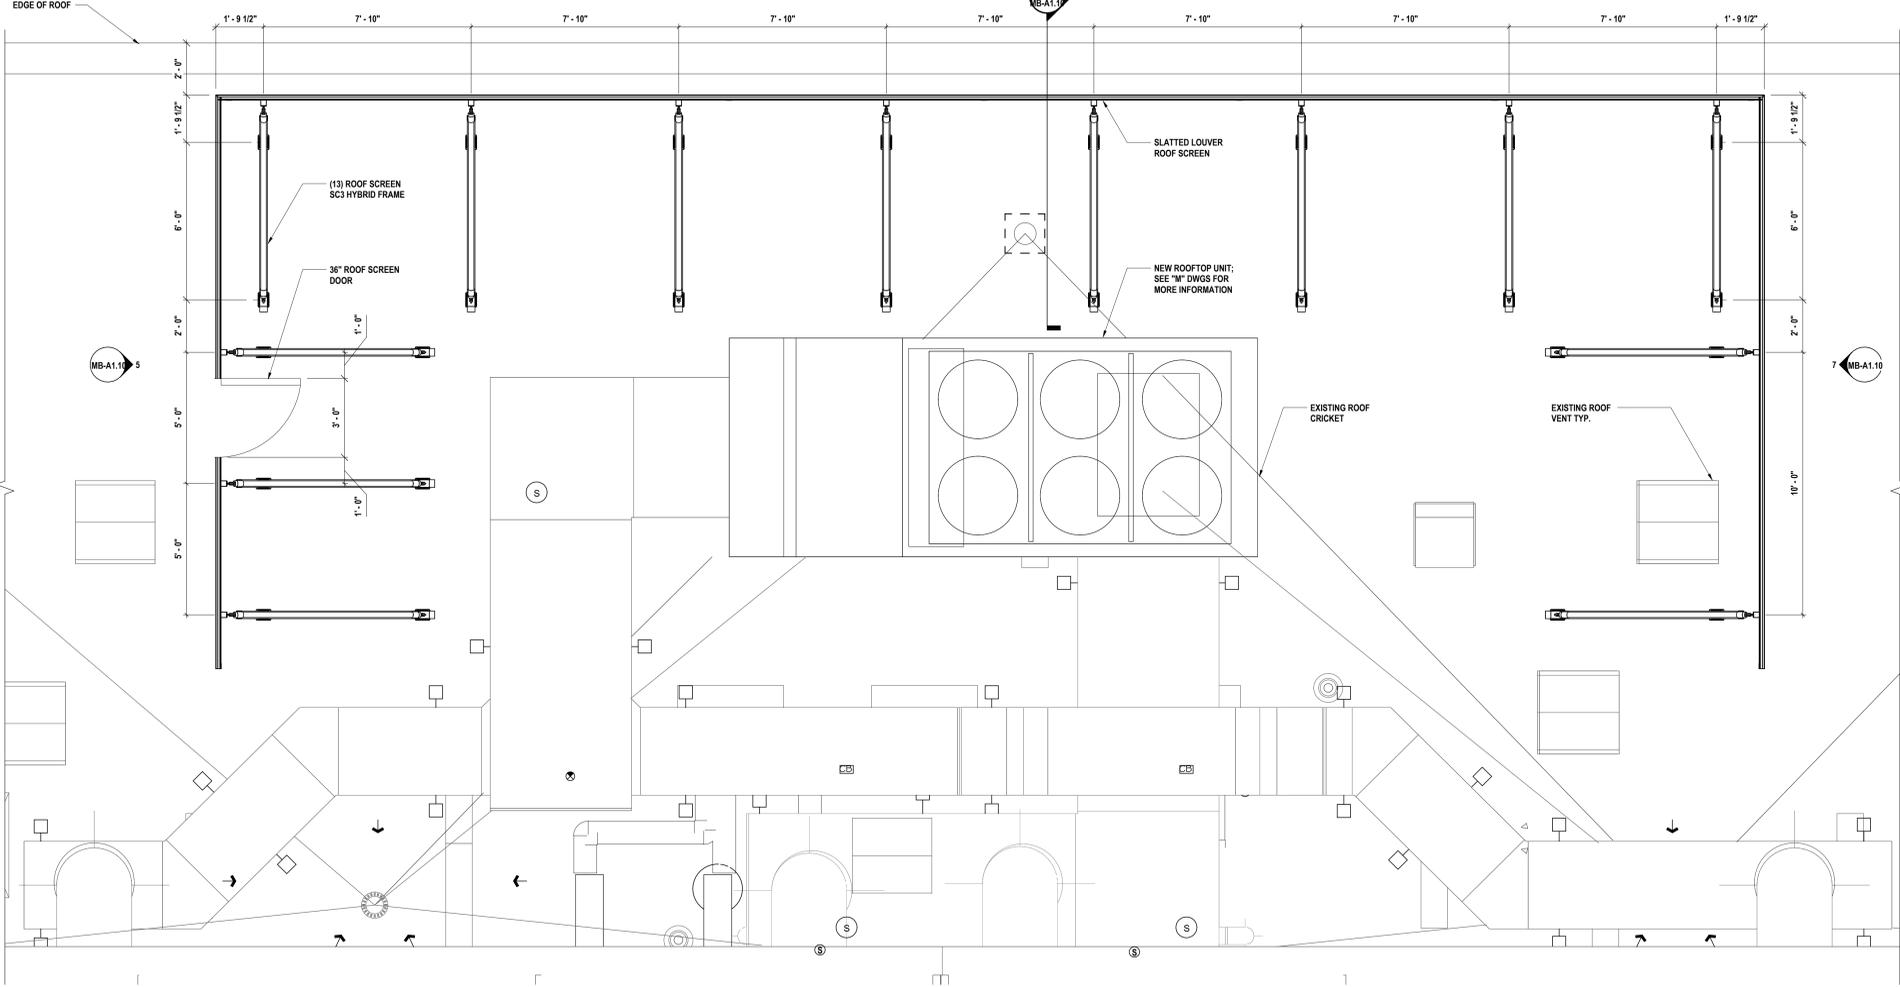


DATE:	10/27/2025	ISSUE FOR BID
DESCRIPTION OF REVISION:		
#	DATE	DESCRIPTION OF REVISION
1	10/27/2025	ISSUE FOR BID

**HUNT ENGINEERS ARCHITECTS | SURVEYORS**  
 HORSEHEADS, NY 807-265-1000  
 ROSHARON, NY 807-265-7500  
 BINGHAMTON, NY 807-798-8881  
 ALBANY, NY 807-798-8881  
 WWW.HUNTEAS.COM  
 NY CERTIFICATE NO. 0016250 PA CERTIFICATE NO. TSC2202031464-1



**ROOF SCREEN PLAN, SECTION, ELEVATIONS & DETAILS**  
**2025 CAPITAL IMPROVEMENTS PROJECT**  
**HAMMONDSPOORT CENTRAL SCHOOL DISTRICT**  
 8272 MAIN STREET HAMMONDSPOORT, NEW YORK, 14840

**MB-A1.10**  
 PROJECT NO: 1925.014



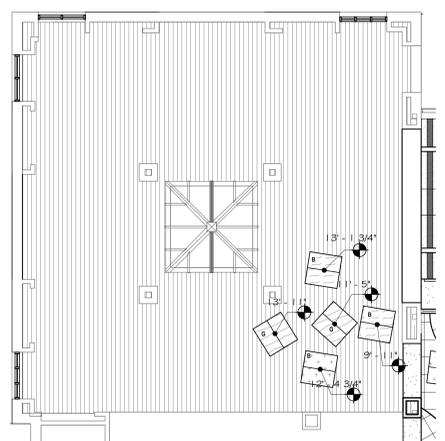

2 SECOND FLOOR REFLECTED CEILING PLAN - AREA B LIBRARY  
1/8" = 1'-0"

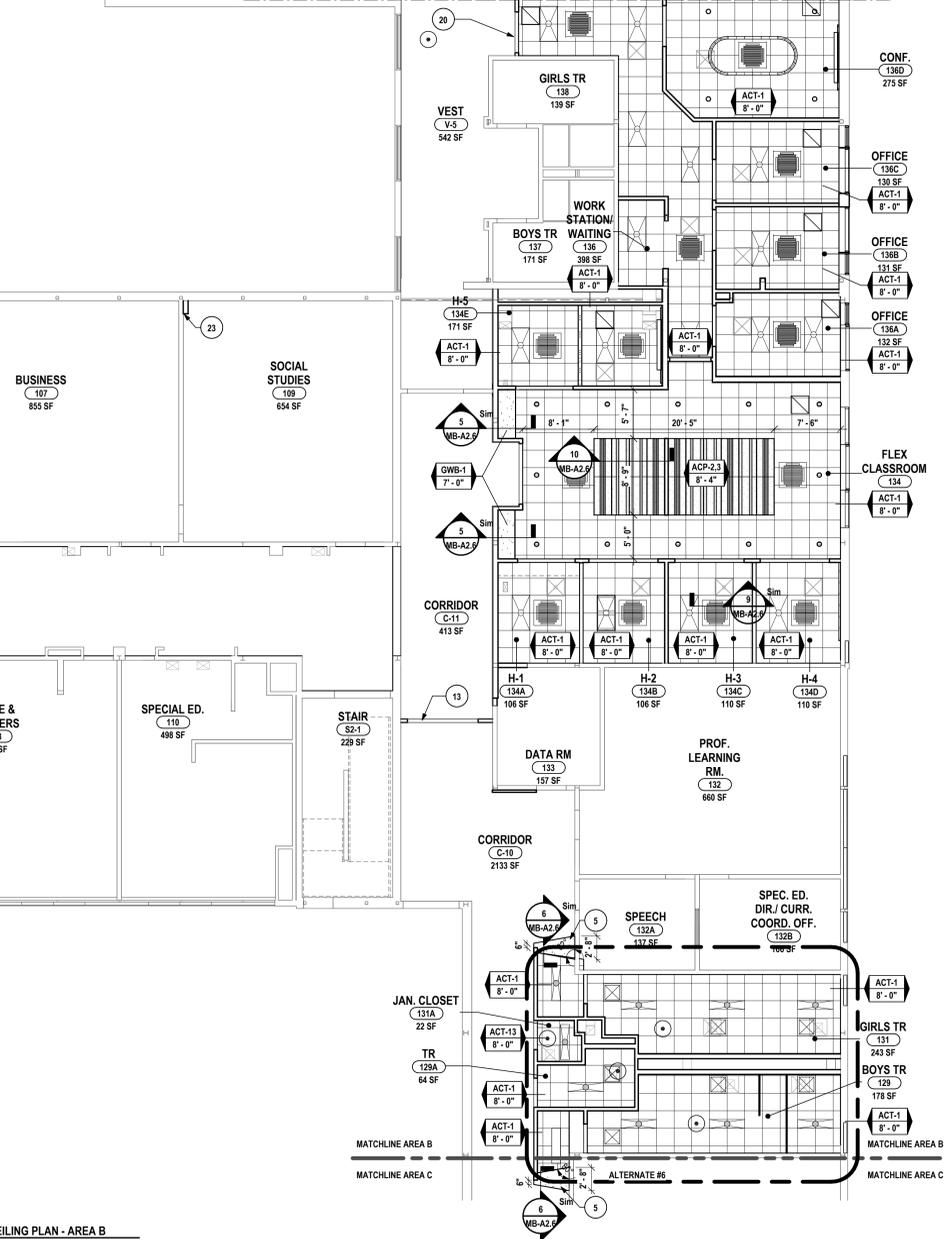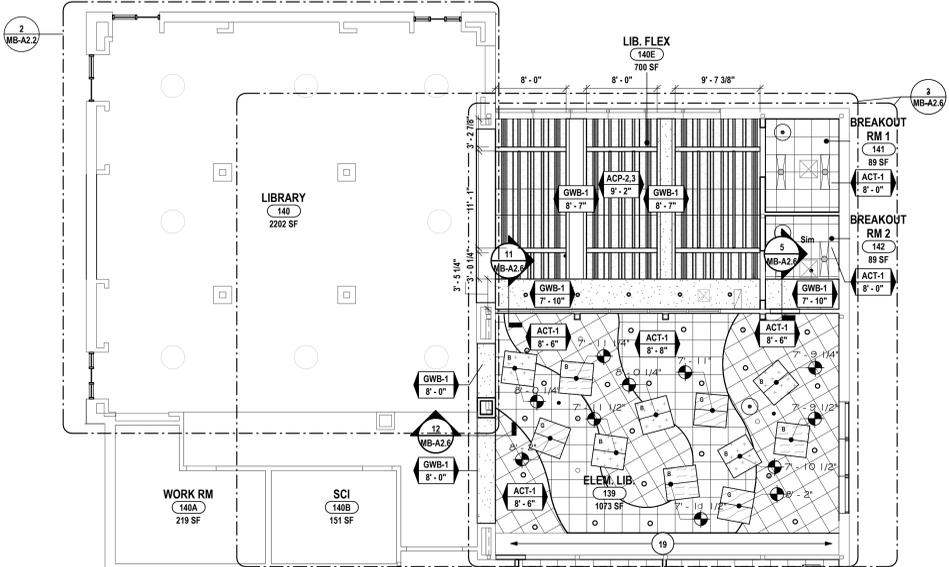

1 FIRST FLOOR REFLECTED CEILING PLAN - AREA B  
1/8" = 1'-0"

**GENERAL CEILING NOTES:**


- A ALL EXPOSED GYPSUM WALL BOARD SHALL BE PAINTED, UNLESS NOTED OTHERWISE.
- B REFER TO FINISH KEY AND SCHEDULE FOR INDIVIDUAL CEILING TYPES AND SPECIFIED LOCATIONS.
- C ALL NEW CEILING SYSTEMS TO BE INSTALLED DIRECTLY TO STRUCTURE. SUPPORT WIRES FOR SUSPENDED CEILING ASSEMBLY SHALL NOT BE TIED TO ANY MECHANICAL, ELECTRICAL, PLUMBING OR FIRE PROTECTION PIPING OR EQUIPMENT.
- D CENTER ALL DEVICES WITHIN CEILING GRID. COORDINATE WITH THE WORK OF ALL PRIME CONTRACTORS.
- E ARCHITECTURAL DRAWINGS TAKE PRECEDENCE OVER ENGINEERING DRAWINGS FOR LOCATION OF LIGHT FIXTURES AND MECHANICAL EQUIPMENT. COORDINATE WITH ALL OTHER PRIME CONTRACTORS.
- F CEILING GRID TO BE CENTERED WITHIN ROOMS, UNLESS NOTED OTHERWISE.
- G INSTALL TRIMLESS ACCESS PANELS FURNISHED BY OTHER PRIME CONTRACTORS FOR GYPSUM WALL BOARD CEILING AREAS. COORDINATE SIZE, LOCATION, AND QUANTITY OF ACCESS PANELS WITH OTHER PRIME CONTRACTORS FOR ACCESS REQUIRED ABOVE HARD CEILING.
- H PAINT ALL EXPOSED CONDUITS, JUNCTION BOXES, ELECTRICAL ITEMS (NOT FACTORY FINISHED), SPRINKLER LINES, MECHANICAL DUCTWORK AND PIPING UNLESS NOTED OTHERWISE. REFER TO FINISH KEY FOR COLORS.

**RCP DRAWING NOTE:**

- 1 OPEN TO STRUCTURE ABOVE; PAINT EXPOSED STRUCTURE, AND ALL CEILING MOUNTED ELEMENTS (NOT FACTORY FINISHED); REFER TO FINISH KEY FOR COLORS.
- 2 REINSTALL STORED EXISTING CEILING SYSTEM AND ALL FIXTURES. MATCH EXISTING LAYOUT AND CONFIGURATION.
- 3 EXTERIOR LINEAR METAL CEILING SYSTEM.
- 4 PROVIDE NEW ACOUSTIC CEILING TILES AND SOFFIT
- 5 3/8" COLD FORMED METAL FRAMING WITH 5/8" GYPSUM WRAPPED SOFFITS TO BE 2" LOWER THAN ADJACENT ACT CEILING HEIGHT. REFER TO FINISH KEY FOR PAINT COLOR.
- 6 SLOPED ACT CEILING SYSTEM.
- 7 SLOPED GYPSUM CEILING SYSTEM.
- 8 INSTALL 2'-0" x 2'-0" x 1" THICK TECTUM OR EQUAL CEILING TILES. ALL FOUR SIDES TO HAVE PAINTED BEVELED EDGE. INSTALL TIGHT TO DECK.
- 9 INSTALL 2'-0" x 4'-0" ACT TO MATCH ADJACENT CEILING HEIGHT. GRID LINES ARE TO ALIGN WITH EXISTING GRID LINES. CONNECT NEW CEILING SYSTEM BACK INTO EXISTING CEILING SYSTEM.
- 10 1 HR/2 HR RATED SHAFTWALL ASSEMBLY ABOVE ACT CEILING (HORIZONTAL ASSEMBLY); REFER TO PARTITION TYPES
- 11 METAL PANEL SYSTEM TO EXTEND VERTICALLY AT ROOF EDGE AND OVER TOP OF ROOF EDGE. ALUCORBOND OR EQUAL
- 12 PAINT EXISTING EXPOSED DECK AND STRUCTURE
- 13 MODIFY EXISTING CEILING SYSTEM AS REQUIRED TO INSTALL NEW DOORWALL SYSTEM. EXISTING ACT ADJACENT TO REMAIN.
- 14 PROVIDE AND INSTALL CORO REEL PLENUM BOXES AT EXISTING REEL LOCATIONS. REINSTALL REELS IN NEW PLENUM BOXES. SEE "E" DWGS FOR MORE INFORMATION.
- 15 PARTIALLY REMOVE FULL HEIGHT BUILT IN FOR HVAC PIPING ACCESS AND REPAIR
- 16 PROVIDE SPECIALTY CEILING. REFER TO INTERIOR FINISH KEY AND SCHEDULE FOR ADDITIONAL DETAILS.
- 17 PROVIDED AND INSTALL 2X2 GEOMETRIC SOUND DIFFUSER PANELS AS SHOWN.
- 18 GYPSUM PIPE SOFFITS TO BE 1'-0" LOWER THAN ADJACENT EXISTING CEILINGS. SEE SECTION 19A.2.6 FOR MORE INFORMATION.
- 19 SKIM COAT AND PAINT HORIZONTAL AND VERTICAL SURFACES OF EXISTING SOFFIT. MATCH TO LOOK LIKE NEW.
- 20 PATCH EXISTING GYPSUM BOARD CEILING AS REQUIRED FOR NEW DOOR LOCATION.
- 21 PATCH EXISTING GYPSUM AND FLOOR WHERE BASEBOARD AND PIPING IS REMOVED.
- 22 KITCHEN HOOD REFER TO FOOD SERVICE EQUIPMENT DRAWINGS FOR ADDITIONAL INFORMATION.
- 23 PARTIALLY REMOVE & REINSTALL EXISTING ACT SYSTEM AS REQUIRED FOR NEW HVAC SYSTEM. REF TO MEP DWGS FOR MORE INFORMATION.

**CEILING LEGEND:**

- WCP 1A2: WOOD CEILING PANELS
  - WCP 3: WOOD CEILING PLANK
  - ACT 3-12: ARMSTRONG DESIGNFLEX SQUARES & RECTANGLES PATTERN
  - ACP-1: ACOUSTIC PANEL (ALTERNATE #10)
  - ACP-2: TURF "BARCODE" CEILING PANEL A
  - ACP-3: TURF "BARCODE" CEILING PANEL B
  - ACT-1: 2X2 ACOUSTIC CEILING TILE AND GRID
  - GWB-1: 5/8" GYPSUM WALL BOARD CEILING OR SOFFIT
  - ACC-1: SUSPENDED 3 DIMENSIONAL PET FELT ACOUSTIC CEILING CLOUD.
  - ACC-2: SUSPENDED 3 DIMENSIONAL PET FELT ACOUSTIC CEILING CLOUD.
  - ACC-3: SUSPENDED 3 DIMENSIONAL PET FELT ACOUSTIC CEILING CLOUD.
- "G" = GABLE  
"B" = BUTTERFLY

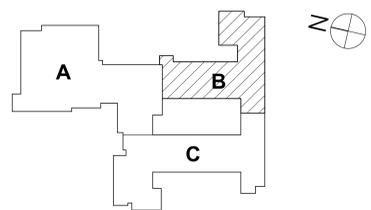

KEY PLAN

DATE:	10/27/2025	ISSUE FOR:	CD
DESCRIPTION OF REVISION:	ISSUE FOR BID		
# DATE:	1 10/27/2025	ISSUE FOR:	CD

**HUNT ENGINEERS ARCHITECTS | SURVEYORS**  
 HORSEHEADS, NY 607-568-1008 | PISCATAWAY, NY 562-507-7568 | TOWANDA, PA 570-265-4668  
 BINGHAMTON, NY 607-738-8881 | ALBANY, NY 607-738-1801  
 WWW.HUNTEAS.COM  
 NY CERTIFICATE NO. 0016250 PA CERTIFICATE NO. TSC220313464-1

**FIRST FLOOR REFLECTED CEILING PLAN - AREA B**  
**2025 CAPITAL IMPROVEMENTS PROJECT**  
**HAMMONDSPORT CENTRAL SCHOOL DISTRICT**  
 8272 MAIN STREET HAMMONDSPORT, NEW YORK, 14840

**MB-A2.2**  
 PROJECT NO: 1925.014

SED #: MB-27-28-01-04-02-02-03-03-06-07-29-01-04-5-003-008

**GENERAL CEILING NOTES:**


- A ALL EXPOSED GYPSUM WALL BOARD SHALL BE PAINTED, UNLESS NOTED OTHERWISE.
- B REFER TO FINISH KEY AND SCHEDULE FOR INDIVIDUAL CEILING TYPES AND SPECIFIED LOCATIONS.
- C ALL NEW CEILING SYSTEMS TO BE INSTALLED DIRECTLY TO STRUCTURE. SUPPORT WIRES FOR SUSPENDED CEILING ASSEMBLY SHALL NOT BE TIED TO ANY MECHANICAL, ELECTRICAL, PLUMBING OR FIRE PROTECTION PIPING OR EQUIPMENT.
- D CENTER ALL DEVICES WITHIN CEILING GRID. COORDINATE WITH THE WORK OF ALL PRIME CONTRACTORS. ARCHITECTURAL DRAWINGS TAKE PRECEDENCE OVER ENGINEERING DRAWINGS FOR LOCATION OF LIGHT FIXTURES AND MECHANICAL EQUIPMENT. COORDINATE WITH ALL OTHER PRIME CONTRACTORS.
- E CEILING GRID TO BE CENTERED WITHIN ROOMS, UNLESS NOTED OTHERWISE.
- F INSTALL TRIMLESS ACCESS PANELS FURNISHED BY OTHER PRIME CONTRACTORS FOR GYPSUM WALL BOARD CEILING AREAS. COORDINATE SIZE, LOCATION, AND QUANTITY OF ACCESS PANELS WITH OTHER PRIME CONTRACTORS FOR ACCESS REQUIRED ABOVE HARD CEILING.
- G PAINT ALL EXPOSED CONDUITS, JUNCTION BOXES, ELECTRICAL ITEMS (NOT FACTORY FINISHED), SPRINKLER LINES, MECHANICAL DUCTWORK AND PIPING UNLESS NOTED OTHERWISE. REFER TO FINISH KEY FOR COLORS.

**RCP DRAWING NOTE:**

- 1 OPEN TO STRUCTURE ABOVE; PAINT EXPOSED STRUCTURE, AND ALL CEILING MOUNTED ELEMENTS (NOT FACTORY FINISHED). REFER TO FINISH KEY FOR COLORS.
- 2 REINSTALL STORED EXISTING CEILING SYSTEM AND ALL FIXTURES. MATCH EXISTING LAYOUT AND CONFIGURATION.
- 3 EXTERIOR LINEAR METAL CEILING SYSTEM.
- 4 PROVIDE NEW ACOUSTIC CEILING TILES AND SOFFIT.
- 5 3 8" COLD FORMED METAL FRAMING WITH 5/8" GYPSUM WRAPPED SOFFITS TO BE 2" LOWER THAN ADJACENT ACT CEILING HEIGHT. REFER TO FINISH KEY FOR PAINT COLOR.
- 6 SLOPED ACT CEILING SYSTEM.
- 7 SLOPED GYPSUM CEILING SYSTEM.
- 8 INSTALL 2'-0" x 2'-0" x 1" THICK TECTUM OR EQUAL CEILING TILES. ALL FOUR SIDES TO HAVE PAINTED BEVELED EDGE. INSTALL TIGHT TO DECK.
- 9 INSTALL 2'-0" x 4'-0" ACT TO MATCH ADJACENT CEILING HEIGHT. GRID LINES ARE TO ALIGN WITH EXISTING GRID LINES. CONNECT NEW CEILING SYSTEM BACK INTO EXISTING CEILING SYSTEM.
- 10 1 HR2 HR RATED SHAFTWALL ASSEMBLY ABOVE ACT CEILING (HORIZONTAL ASSEMBLY). REFER TO PARTITION TYPES.
- 11 METAL PANEL SYSTEM TO EXTEND VERTICALLY AT ROOF EDGE AND OVER TOP OF ROOF EDGE. ALUCOBOND OR EQUAL.
- 12 PAINT EXISTING EXPOSED DECK AND STRUCTURE.
- 13 MODIFY EXISTING CEILING SYSTEM AS REQUIRED TO INSTALL NEW DOORWALL SYSTEM. EXISTING ACT ADJACENT TO REMAIN.
- 14 PROVIDE AND INSTALL CORO REEL PLENUM BOXES AT EXISTING REEL LOCATIONS. REINSTALL REELS IN NEW PLENUM BOXES. SEE "C" DWGS FOR MORE INFORMATION.
- 15 PARTIALLY REMOVE FULL HEIGHT BUILT IN FOR HVAC PIPING ACCESS AND REPAIR.
- 16 PROVIDE SPECIALTY CEILING. REFER TO INTERIOR FINISH KEY AND SCHEDULE FOR ADDITIONAL DETAILS.
- 17 PROVIDED AND INSTALL 2X2 GEOMETRIC SOUND DIFFUSER PANELS AS SHOWN.
- 18 GYPSUM PIPE SOFFITS TO BE 1'-0" LOWER THAN ADJACENT EXISTING CEILINGS. SEE SECTION 19A2.6 FOR MORE INFORMATION.
- 19 SKIM COAT AND PAINT HORIZONTAL AND VERTICAL SURFACES OF EXISTING SOFFIT. MATCH TO LOOK LIKE NEW.
- 20 PATCH EXISTING GYPSUM BOARD CEILING AS REQUIRED FOR NEW DOOR LOCATION.
- 21 PATCH EXISTING GYPSUM AND FLOOR WHERE BASEBOARD AND PIPING IS REMOVED.
- 22 KITCHEN HOOD REFER TO HOOD SERVICE EQUIPMENT DRAWINGS FOR ADDITIONAL INFORMATION.
- 23 PARTIALLY REMOVE & REINSTALL EXISTING ACT SYSTEM AS REQUIRED FOR NEW HVAC SYSTEM. REF TO MEP DWGS FOR MORE INFORMATION.

**CEILING LEGEND:**

- WCP 1&2: WOOD CEILING PANELS
  - WCP 3: WOOD CEILING PLANK
  - ACT 3-12: ARMSTRONG DESIGNFLEX SQUARES & RECTANGLES PATTERN
  - ACP-1: ACOUSTIC PANEL (ALTERNATE #10)
  - ACP-2: TURF "BARCODE" CEILING PANEL A
  - ACP-3: TURF "BARCODE" CEILING PANEL B
  - ACT-1: 2X2 ACOUSTIC CEILING TILE AND GRID
  - GWB-1: 5/8" GYPSUM WALL BOARD CEILING OR SOFFIT
  - ACC-1: SUSPENDED 3 DIMENSIONAL PET FELT ACOUSTIC CEILING CLOUD.
  - ACC-2: SUSPENDED 3 DIMENSIONAL PET FELT ACOUSTIC CEILING CLOUD.
  - ACC-3: SUSPENDED 3 DIMENSIONAL PET FELT ACOUSTIC CEILING CLOUD.
- "G" = GABLE  
"B" = BUTTERFLY

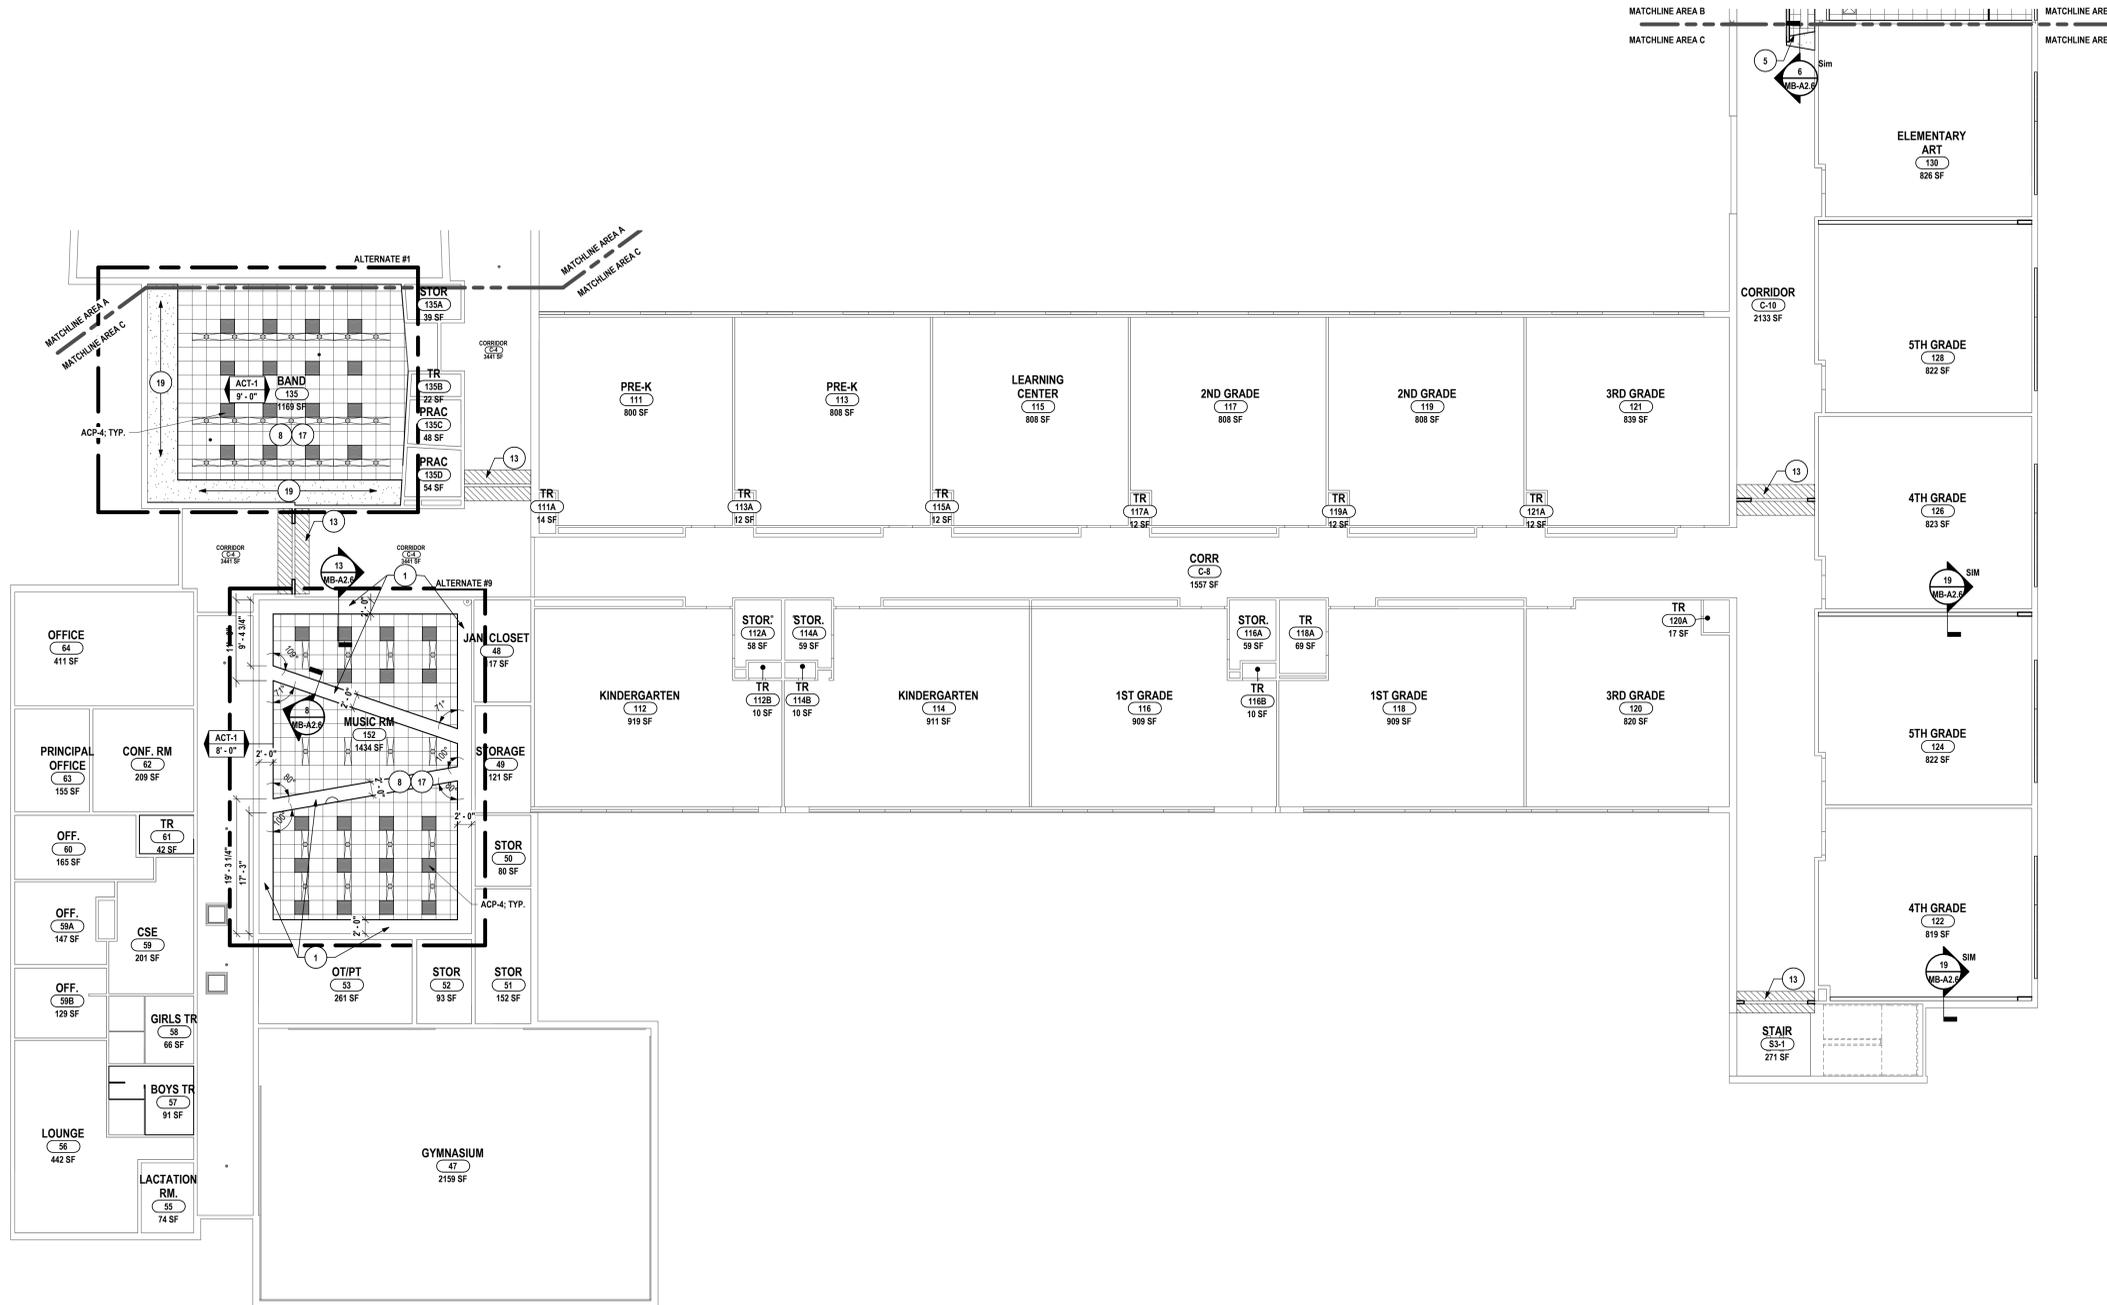

1 FIRST FLOOR REFLECTED CEILING PLAN - AREA C  
1" = 10'-0"

DATE:	10/27/2025	ISSUE FOR:	ISSUE FOR BID
DESCRIPTION OF REVISION:			
#	DATE	DESCRIPTION OF REVISION	ISSUE FOR
1	10/27/2025	ISSUE FOR BID	ISSUE FOR BID

**HUNT ENGINEERS ARCHITECTS | SURVEYORS**  
 HORSEHEADS, NY 807-858-1058 PROQUEST/ESTES, NY 562-837-7658 TOWANDA, PA 570-265-4668  
 BINGHAMTON, NY 807-798-8881 ALBANY, NY 807-798-1808  
 WWW.HUNTEAS.COM  
 NY CERTIFICATE NO. 0016250 PA CERTIFICATE NO. TSC220313464-1

FIRST FLOOR REFLECTED CEILING PLAN - AREA C  
 2025 CAPITAL IMPROVEMENTS PROJECT  
 HAMMONDSPORT CENTRAL SCHOOL DISTRICT  
 8272 MAIN STREET HAMMONDSPORT, NEW YORK, 14840  
**MB-A2.3**  
 PROJECT NO: 1925.014

SET #: MB-27-28-01-04-02-03-06-07-29-01-04-05-06-08  
 SHEET NO: 23 OF 24

**GENERAL CEILING NOTES:**


- A ALL EXPOSED GYPSUM WALL BOARD SHALL BE PAINTED, UNLESS NOTED OTHERWISE.
- B REFER TO FINISH KEY AND SCHEDULE FOR INDIVIDUAL CEILING TYPES AND SPECIFIED LOCATIONS.
- C ALL NEW CEILING SYSTEMS TO BE INSTALLED DIRECTLY TO STRUCTURE. SUPPORT WIRES FOR SUSPENDED CEILING ASSEMBLY SHALL NOT BE TIED TO ANY MECHANICAL, ELECTRICAL, PLUMBING OR FIRE PROTECTION PIPING OR EQUIPMENT.
- D CENTER ALL DEVICES WITHIN CEILING GRID. COORDINATE WITH THE WORK OF ALL PRIME CONTRACTORS.
- E ARCHITECTURAL DRAWINGS TAKE PRECEDENCE OVER ENGINEERING DRAWINGS FOR LOCATION OF LIGHT FIXTURES AND MECHANICAL EQUIPMENT. COORDINATE WITH ALL OTHER PRIME CONTRACTORS.
- F CEILING GRID TO BE CENTERED WITHIN ROOMS, UNLESS NOTED OTHERWISE.
- G INSTALL TRIMLESS ACCESS PANELS FURNISHED BY OTHER PRIME CONTRACTORS FOR GYPSUM WALL BOARD CEILING AREAS. COORDINATE SIZE, LOCATION, AND QUANTITY OF ACCESS PANELS WITH OTHER PRIME CONTRACTORS FOR ACCESS REQUIRED ABOVE HARD CEILING.
- H PAINT ALL EXPOSED CONDUITS, JUNCTION BOXES, ELECTRICAL ITEMS (NOT FACTORY FINISHED), SPRINKLER LINES, MECHANICAL DUCTWORK AND PIPING UNLESS NOTED OTHERWISE. REFER TO FINISH KEY FOR COLORS.

**RCP DRAWING NOTE:**


- 1 OPEN TO STRUCTURE ABOVE; PAINT EXPOSED STRUCTURE, AND ALL CEILING MOUNTED ELEMENTS (NOT FACTORY FINISHED). REFER TO FINISH KEY FOR COLORS.
- 2 REINSTALL, STORED EXISTING CEILING SYSTEM AND ALL FIXTURES. MATCH EXISTING LAYOUT AND CONFIGURATION.
- 3 EXTERIOR LINEAR METAL CEILING SYSTEM.
- 4 PROVIDE NEW ACOUSTIC CEILING TILES AND SOFFIT.
- 5 3/8" COLD FORMED METAL FRAMING WITH 5/8" GYPSUM WRAPPED SOFFITS TO BE 2" LOWER THAN ADJACENT ACT CEILING HEIGHT. REFER TO FINISH KEY FOR PAINT COLOR.
- 6 SLOPED ACT CEILING SYSTEM.
- 7 SLOPED GYPSUM CEILING SYSTEM.
- 8 INSTALL 2'-0" x 2'-0" x 1" THICK TECTUM OR EQUAL CEILING TILES. ALL FOUR SIDES TO HAVE PAINTED BEVELED EDGE. INSTALL TIGHT TO DECK.
- 9 INSTALL 2'-0" x 4'-0" ACT TO MATCH ADJACENT CEILING HEIGHT. GRID LINES ARE TO ALIGN WITH EXISTING GRID LINES. CONNECT NEW CEILING SYSTEM BACK INTO EXISTING CEILING SYSTEM.
- 10 1 HR2 RATED SHAFTWALL ASSEMBLY ABOVE ACT CEILING (HORIZONTAL ASSEMBLY). REFER TO PARTITION TYPES.
- 11 METAL PANEL SYSTEM TO EXTEND VERTICALLY AT ROOF EDGE AND OVER TOP OF ROOF EDGE. ALUCOBOND OR EQUAL.
- 12 PAINT EXISTING EXPOSED DECK AND STRUCTURE.
- 13 MODIFY EXISTING CEILING SYSTEM AS REQUIRED TO INSTALL NEW DOORWALL SYSTEM. EXISTING ACT ADJACENT TO REMAIN.
- 14 PROVIDE AND INSTALL CORO REEL PLENUM BOXES AT EXISTING REEL LOCATIONS. REINSTALL REELS IN NEW PLENUM BOXES. SEE "C" DWGS FOR MORE INFORMATION.
- 15 PARTIALLY REMOVE FULL HEIGHT BUILT IN FOR HVAC PIPING ACCESS AND REPAIR.
- 16 PROVIDE SPECIALTY CEILING. REFER TO INTERIOR FINISH KEY AND SCHEDULE FOR ADDITIONAL DETAILS.
- 17 PROVIDED AND INSTALL 2X2 GEOMETRIC SOUND DIFFUSER PANELS AS SHOWN.
- 18 GYPSUM PIPE SOFFITS TO BE 1'-0" LOWER THAN ADJACENT EXISTING CEILINGS. SEE SECTION 19/AZ.6 FOR MORE INFORMATION.
- 19 SKIM COAT AND PAINT HORIZONTAL AND VERTICAL SURFACES OF EXISTING SOFFIT. MATCH TO LOOK LIKE NEW.
- 20 PATCH EXISTING GYPSUM BOARD CEILING AS REQUIRED FOR NEW DOOR LOCATION.
- 21 PATCH EXISTING GYPSUM AND FLOOR WHERE BASEBOARD AND PIPING IS REMOVED.
- 22 KITCHEN HOOD REFER TO FOOD SERVICE EQUIPMENT DRAWINGS FOR ADDITIONAL INFORMATION.
- 23 PARTIALLY REMOVE & REINSTALL EXISTING ACT SYSTEM AS REQUIRED FOR NEW HVAC SYSTEM. REF TO MEP DWGS FOR MORE INFORMATION.

**CEILING LEGEND:**

- WCP 1&2: WOOD CEILING PANELS
  - WCP 3: WOOD CEILING PLANK
  - ACT 3-12: ARMSTRONG DESIGNFLEX SQUARES & RECTANGLES PATTERN
  - ACP-1: ACOUSTIC PANEL (ALTERNATE #10)
  - ACP-2: TURF "BARCODE" CEILING PANEL A
  - ACP-3: TURF "BARCODE" CEILING PANEL B
  - ACT-1: 2X2 ACOUSTIC CEILING TILE AND GRID
  - GWB-1: 5/8" GYPSUM WALL BOARD CEILING OR SOFFIT
  - ACC-1: SUSPENDED 3 DIMENSIONAL PET FELT ACOUSTIC CEILING CLOUD.
  - ACC-2: SUSPENDED 3 DIMENSIONAL PET FELT ACOUSTIC CEILING CLOUD.
  - ACC-3: SUSPENDED 3 DIMENSIONAL PET FELT ACOUSTIC CEILING CLOUD.
- "G" = GABLE  
"B" = BUTTERFLY

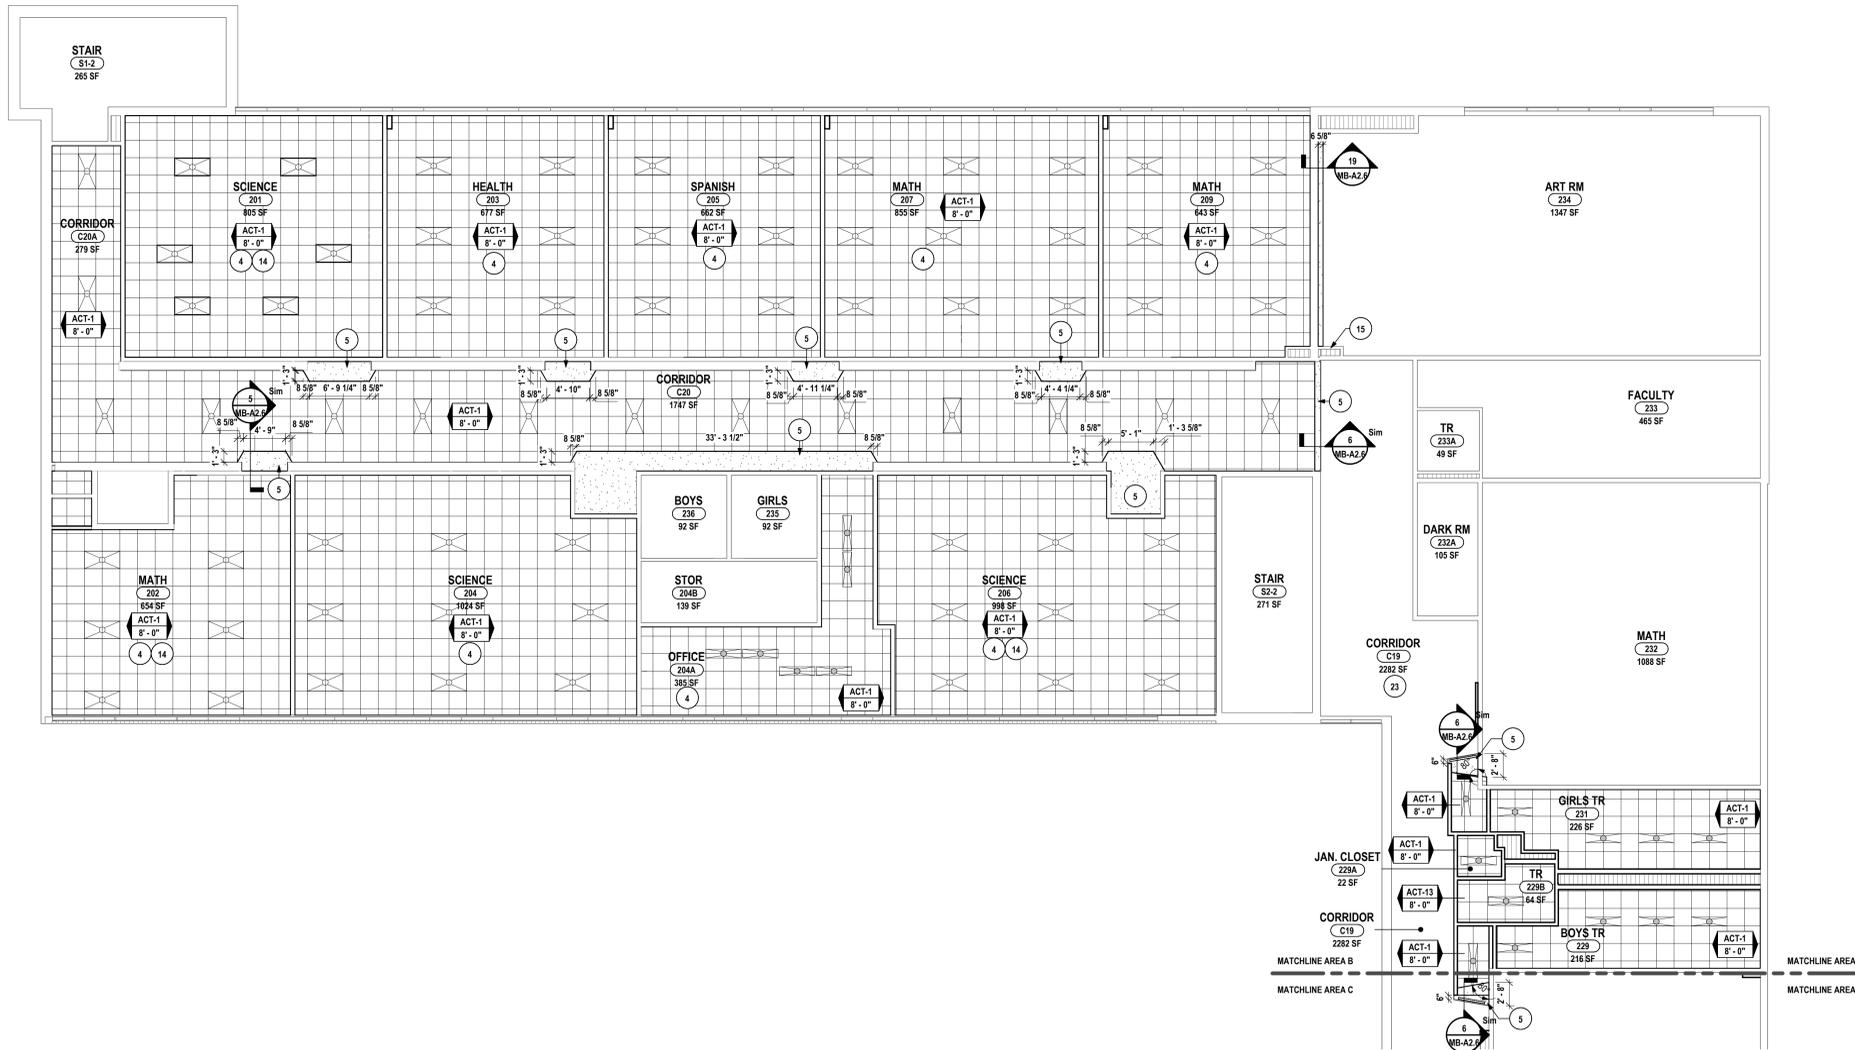

1 SECOND FLOOR REFLECTED CEILING PLAN - AREA B  
1/8" = 1'-0"

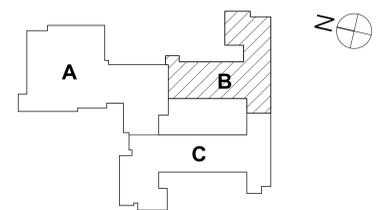

KEY PLAN

SET #: MB-17-26-01-04-02-02-03-06-07-29-01-04-03-08

SECOND FLOOR REFLECTED CEILING PLAN - AREA B  
2025 CAPITAL IMPROVEMENTS PROJECT  
HAMMONDSPORT CENTRAL SCHOOL DISTRICT  
8272 MAIN STREET HAMMONDSPORT, NEW YORK, 14840

**MB-A2.4**

PROJECT NO: 1925.014

**HUNT ENGINEERS ARCHITECTS | SURVEYORS**  
HORSEREGULS, NY 807-468-1000  
ROCKY HILLS, CT 860-776-8000  
BINGHAMTON, NY 807-798-8881  
ALBANY, NY 807-798-8881  
WWW.HUNTEAM.COM  
NY CERTIFICATE NO. 0016250 PA CERTIFICATE NO. TSC22020131464-1

# DATE: 1 10/12/25

DESCRIPTION OF REVISION:  
ISSUE FOR BID

DATE: 10/27/2025

CHECKED BY: JJ

DRAWN BY: KLC

PHASE: CP

THIS IS A VALIDATION OF THE IAP FOR ANY PERSON TO MAKE UNAUTHORIZED ALTERATIONS OR ADDITIONS TO PLANS  
DRAWING NUMBER: MB-A2.4 PROJECT NUMBER: 1925.014


**GENERAL CEILING NOTES:**


- A ALL EXPOSED GYPSUM WALL BOARD SHALL BE PAINTED, UNLESS NOTED OTHERWISE.
- B REFER TO FINISH KEY AND SCHEDULE FOR INDIVIDUAL CEILING TYPES AND SPECIFIED LOCATIONS.
- C ALL NEW CEILING SYSTEMS TO BE INSTALLED DIRECTLY TO STRUCTURE. SUPPORT WIRES FOR SUSPENDED CEILING ASSEMBLY SHALL NOT BE TIED TO ANY MECHANICAL, ELECTRICAL, PLUMBING OR FIRE PROTECTION PIPING OR EQUIPMENT.
- D CENTER ALL DEVICES WITHIN CEILING GRID. COORDINATE WITH THE WORK OF ALL PRIME CONTRACTORS.
- E ARCHITECTURAL DRAWINGS TAKE PRECEDENCE OVER ENGINEERING DRAWINGS FOR LOCATION OF LIGHT FIXTURES AND MECHANICAL EQUIPMENT. COORDINATE WITH ALL OTHER PRIME CONTRACTORS.
- F CEILING GRID TO BE CENTERED WITHIN ROOMS, UNLESS NOTED OTHERWISE.
- G INSTALL TRIMLESS ACCESS PANELS FURNISHED BY OTHER PRIME CONTRACTORS FOR GYPSUM WALL BOARD CEILING AREAS. COORDINATE SIZE, LOCATION, AND QUANTITY OF ACCESS PANELS WITH OTHER PRIME CONTRACTORS FOR ACCESS REQUIRED ABOVE HARD CEILING.
- H PAINT ALL EXPOSED CONDUITS, JUNCTION BOXES, ELECTRICAL ITEMS (NOT FACTORY FINISHED), SPRINKLER LINES, MECHANICAL DUCTWORK AND PIPING UNLESS NOTED OTHERWISE. REFER TO FINISH KEY FOR COLORS.

**RCP DRAWING NOTE:**


- 1 OPEN TO STRUCTURE ABOVE; PAINT EXPOSED STRUCTURE, AND ALL CEILING MOUNTED ELEMENTS (NOT FACTORY FINISHED). REFER TO FINISH KEY FOR COLORS.
- 2 REINSTALL, STORED EXISTING CEILING SYSTEM AND ALL FIXTURES. MATCH EXISTING LAYOUT AND CONFIGURATION.
- 3 EXTERIOR LINEAR METAL CEILING SYSTEM.
- 4 PROVIDE NEW ACOUSTIC CEILING TILES AND SOFFIT.
- 5 3 8" COLD FORMED METAL FRAMING WITH 5/8" GYPSUM WRAPPED SOFFITS TO BE 2" LOWER THAN ADJACENT ACT CEILING HEIGHT. REFER TO FINISH KEY FOR PAINT COLOR.
- 6 SLOPED ACT CEILING SYSTEM.
- 7 SLOPED GYPSUM CEILING SYSTEM.
- 8 INSTALL 2'-0" x 2'-0" x 1" THICK TECTUM OR EQUAL CEILING TILES. ALL FOUR SIDES TO HAVE PAINTED BEVELED EDGE. INSTALL TIGHT TO DECK.
- 9 INSTALL 2'-0" x 4'-0" ACT TO MATCH ADJACENT CEILING HEIGHT. GRID LINES ARE TO ALIGN WITH EXISTING GRID LINES. CONNECT NEW CEILING SYSTEM BACK INTO EXISTING CEILING SYSTEM.
- 10 1 HR2 RATED SHAFTWALL ASSEMBLY ABOVE ACT CEILING (HORIZONTAL ASSEMBLY). REFER TO PARTITION TYPES.
- 11 METAL PANEL SYSTEM TO EXTEND VERTICALLY AT ROOF EDGE AND OVER TOP OF ROOF EDGE. ALUCOBOND OR EQUAL.
- 12 PAINT EXISTING EXPOSED DECK AND STRUCTURE.
- 13 MODIFY EXISTING CEILING SYSTEM AS REQUIRED TO INSTALL NEW DOOR/WALL SYSTEM. EXISTING ACT ADJACENT TO REMAIN.
- 14 PROVIDE AND INSTALL CORO REEL PLENUM BOXES AT EXISTING REEL LOCATIONS. REINSTALL REELS IN NEW PLENUM BOXES. SEE "C" DWGS FOR MORE INFORMATION.
- 15 PARTIALLY REMOVE FULL HEIGHT BUILT IN FOR HVAC PIPING ACCESS AND REPAIR.
- 16 PROVIDE SPECIALTY CEILING. REFER TO INTERIOR FINISH KEY AND SCHEDULE FOR ADDITIONAL DETAILS.
- 17 PROVIDED AND INSTALL 2X2 GEOMETRIC SOUND DIFFUSER PANELS AS SHOWN.
- 18 GYPSUM PIPE SOFFITS TO BE 1'-0" LOWER THAN ADJACENT EXISTING CEILINGS. SEE SECTION 19A2.6 FOR MORE INFORMATION.
- 19 SKIM COAT AND PAINT HORIZONTAL AND VERTICAL SURFACES OF EXISTING SOFFIT. MATCH TO LOOK LIKE NEW.
- 20 PATCH EXISTING GYPSUM BOARD CEILING AS REQUIRED FOR NEW DOOR LOCATION.
- 21 PATCH EXISTING GYPSUM AND FLOOR WHERE BASEBOARD AND PIPING IS REMOVED.
- 22 KITCHEN HOOD REFER TO FOOD SERVICE EQUIPMENT DRAWINGS FOR ADDITIONAL INFORMATION.
- 23 PARTIALLY REMOVE & REINSTALL EXISTING ACT SYSTEM AS REQUIRED FOR NEW HVAC SYSTEM. REF TO MEP DWGS FOR MORE INFORMATION.

**CEILING LEGEND:**

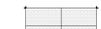-  WCP 182: WOOD CEILING PANELS
-  WCP 3: WOOD CEILING PLANK
-  ACT 3-12: ARMSTRONG DESIGNFLEX SQUARES & RECTANGLES PATTERN
-  ACP-1: ACOUSTIC PANEL (ALTERNATE #10)
-  ACP-2: TURF "BARCODE" CEILING PANEL A
-  ACP-3: TURF "BARCODE" CEILING PANEL B
-  ACT-1: 2X2 ACOUSTIC CEILING TILE AND GRID
-  GWB-1: 5/8' GYPSUM WALL BOARD CEILING OR SOFFIT
-  ACC-1: SUSPENDED 3 DIMENSIONAL PET FELT ACOUSTIC CEILING CLOUD.
-  ACC-2: SUSPENDED 3 DIMENSIONAL PET FELT ACOUSTIC CEILING CLOUD.
-  ACC-3: SUSPENDED 3 DIMENSIONAL PET FELT ACOUSTIC CEILING CLOUD.
- "G" = GABLE
- "B" = BUTTERFLY

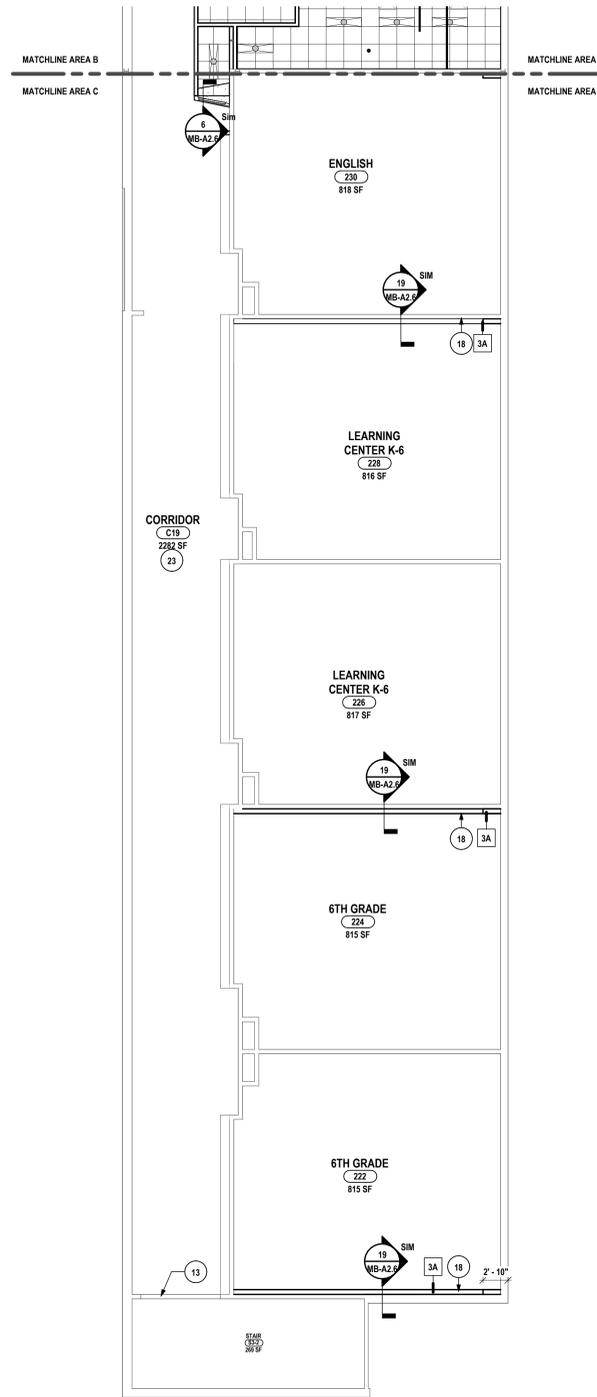

1 SECOND FLOOR REFLECTED CEILING PLAN - AREA C  
1/8" = 1'-0"

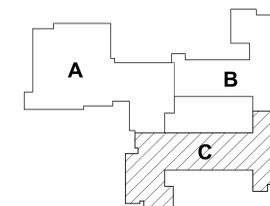

KEY PLAN

DRAWN BY:	KLC
CHECKED BY:	JJ
DATE:	10/27/2025
PHASE:	CD

#	DATE	DESCRIPTION OF REVISION:
1	10/10/2025	ISSUE FOR BID

**HUNT ENGINEERS | ARCHITECTS | SURVEYORS**  
 HORSEHEADS, NY 607-458-1000    ROCKY HILLS, NY 860-337-7616    TOYAHVALLEY, PA 670-265-4668  
 BINGHAMTON, NY 607-798-8881    ALBANY, NY 607-798-8881  
 WWW.HUNTEAS.COM    NY CERTIFICATE NO. 0016250    PA CERTIFICATE NO. TSC22020131464-1
























SECOND FLOOR REFLECTED CEILING PLAN - AREA C  
 2025 CAPITAL IMPROVEMENTS PROJECT  
 HAMMONDSPORT CENTRAL SCHOOL DISTRICT  
 8272 MAIN STREET HAMMONDSPORT, NEW YORK, 14840

MB-A2.5  
 PROJECT NO: 1925.014

SET #: MB-57-28-01-04-02-02-03-06-07-29-01-04-04-03-08

NOTE:  
 1. DE-BURR PANELS AS NEEDED FOR INSTALLATION OF PENDANT LIGHTING FEATURES.  
 2. CENTER FIXTURES ON PANELS OR AS NOTED BY ARCHITECT.  
 3. PROVIDE OPENING LARGER THAN PENDANT DIA. COORDINATE WITH LIGHTING FIXTURE MODEL FOR FLANGE OR FLANGELESS LIGHTING FIXTURE AT NEW OPENING.  
 4. PROVIDE INDIVIDUAL WIRE SUPPORT AT EACH PENDANT; INDEPENDENT OF WOOD PANEL CEILING.

ALTERNATE #10: DECK MOUNTED ACOUSTIC PANELS MOUNTED OFFSET FROM EXISTING DECK WITH FRAMEALL DRYWALL GRID AND UPLIGHT CLIPS OR EQUAL PER MANUFACTURE RECOMMENDATIONS. FIELD VERIFY OFFSET REQUIREMENT TO AVOID EXISTING INFRASTRUCTURE. OFFSET MINIMUM 5".  
 ALTERNATE #10 PROVIDE SURFACE MOUNTED ACOUSTIC PANEL SYSTEM ACP-1, STANDARD 4'-0" WIDE TYPICAL FOR ENTIRE LENGTH OF STRUCTURAL BAY AS SHOWN ON PLAN. REFER TO FINISH SCHEDULE FOR ADDITIONAL INFORMATION

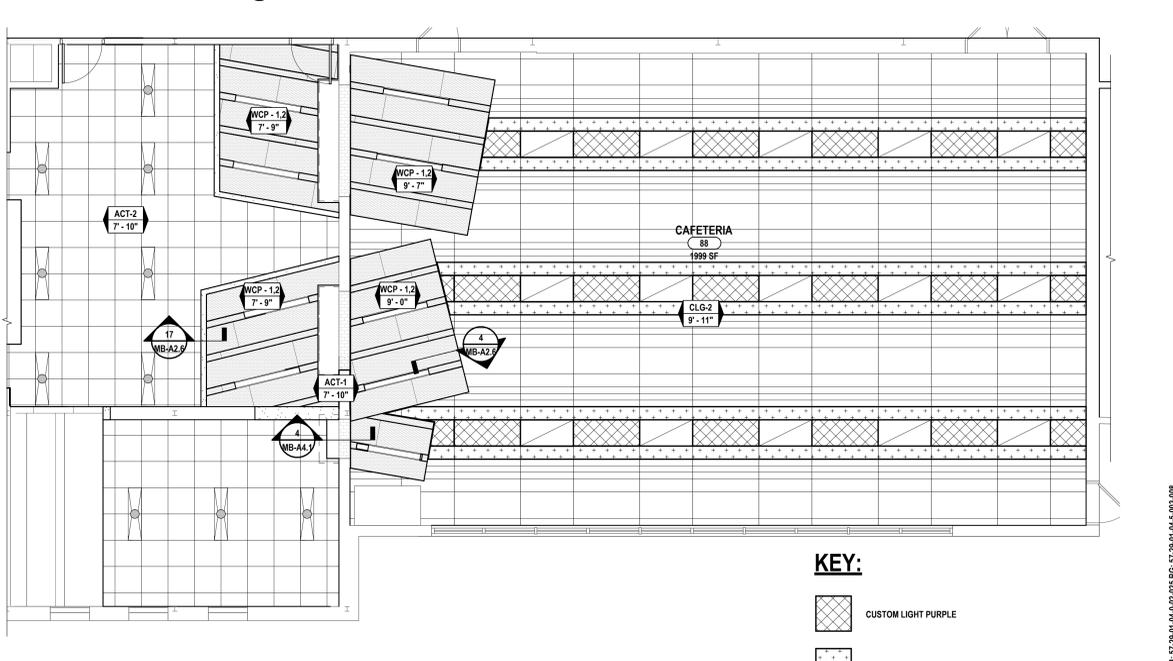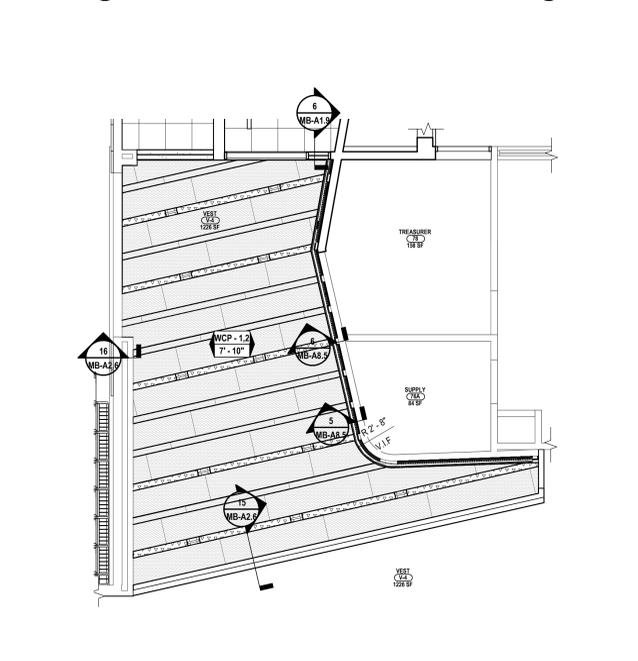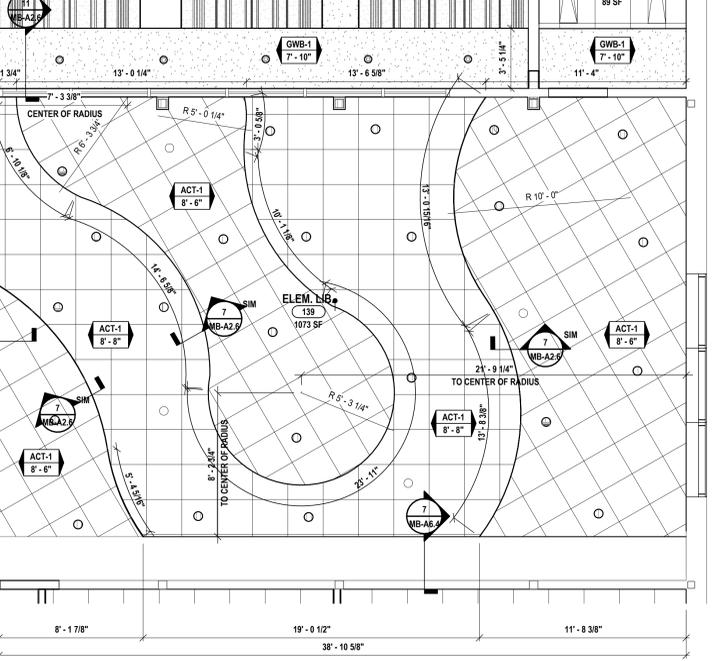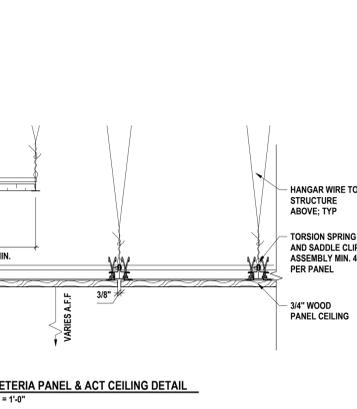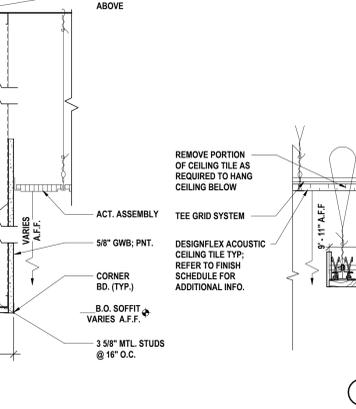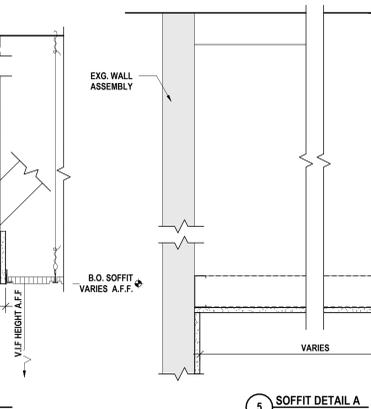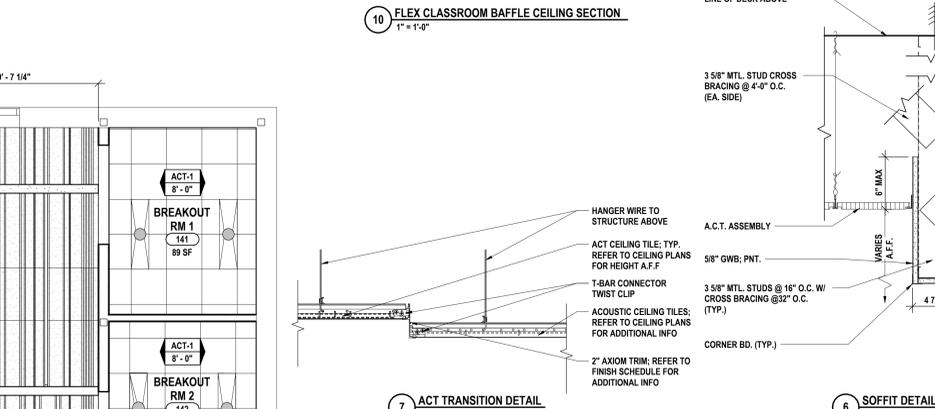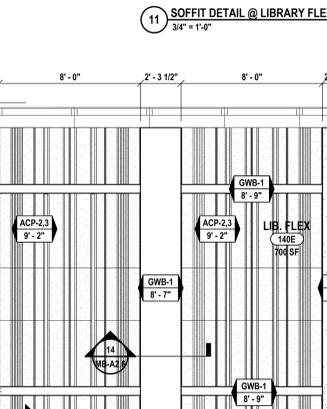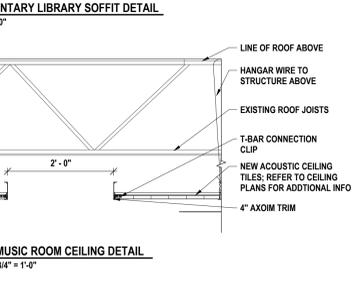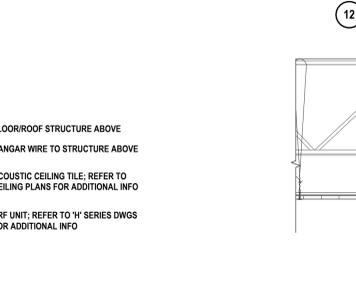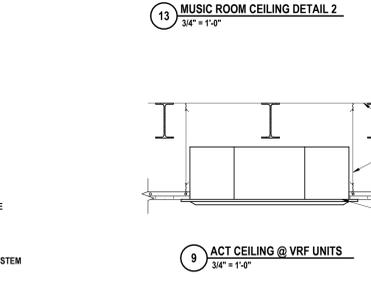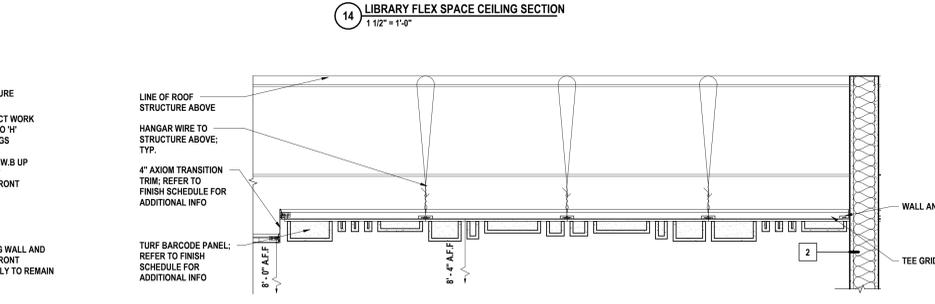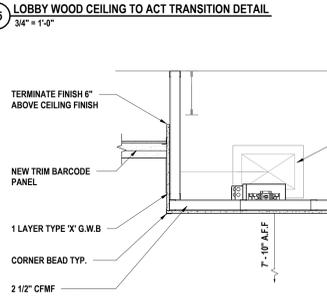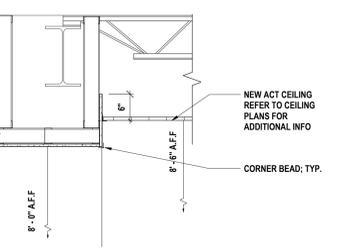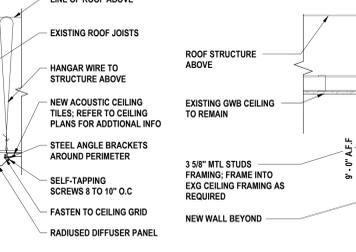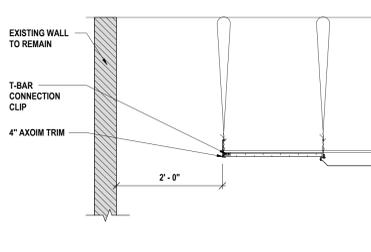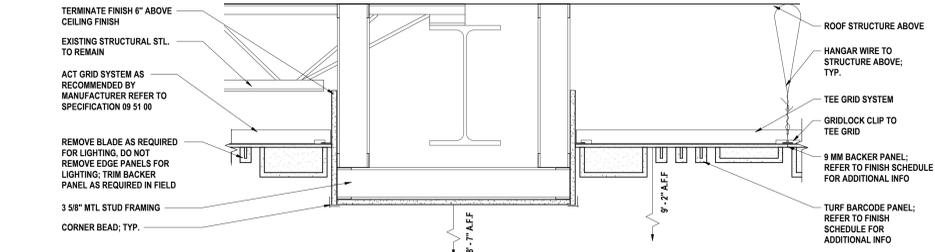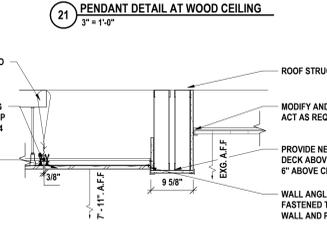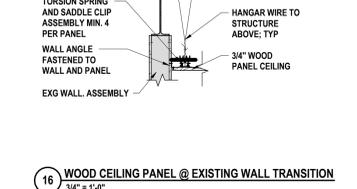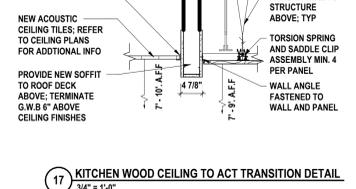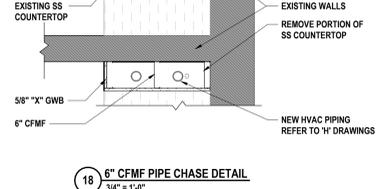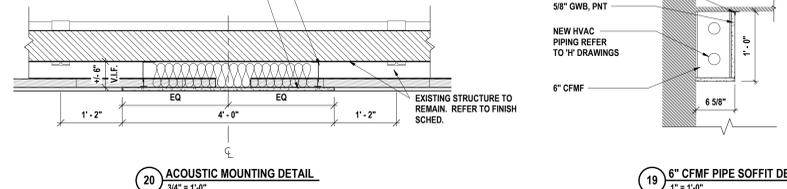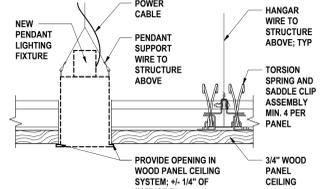


KEY:  
 [Symbol] CUSTOM LIGHT PURPLE  
 [Symbol] CUSTOM DARK PURPLE

DRAWN BY: KLC  
 CHECKED BY: JJC  
 DATE: 10/27/2025  
 PHASE: CD  
 # DATE: 1 10/10/2025  
 DESCRIPTION OF REVISION:  
 ISSUE FOR BID  
 IT IS A VIOLATION OF THE LAW FOR ANY PERSON TO MAKE UNAUTHORIZED ALTERATIONS OR ADDITIONS TO PLANS DRAWING, CONTRACT, SPECIFICATIONS, INSTRUMENTS OF SERVICE OR ANY OTHER DOCUMENT.


HUNT ENGINEERS ARCHITECTS | SURVEYORS  
 HORSEHEADS, NY 607-268-1000  
 ROSCHESSETTES, NY 607-337-7768  
 BANGHAMTON, NY 607-798-8881  
 ALBANY, NY 607-798-8881  
 WWW.HUNTEAS.COM  
 NY CERTIFICATE NO. 0016250 PA CERTIFICATE NO. TSC202031464-1

ENLARGED CEILING PLANS & DETAILS  
 2025 CAPITAL IMPROVEMENTS PROJECT  
 HAMMONDSPORT CENTRAL SCHOOL DISTRICT  
 8272 MAIN STREET HAMMONDSPORT, NEW YORK, 14840  
 MB-A2.6  
 PROJECT NO. 1925.014




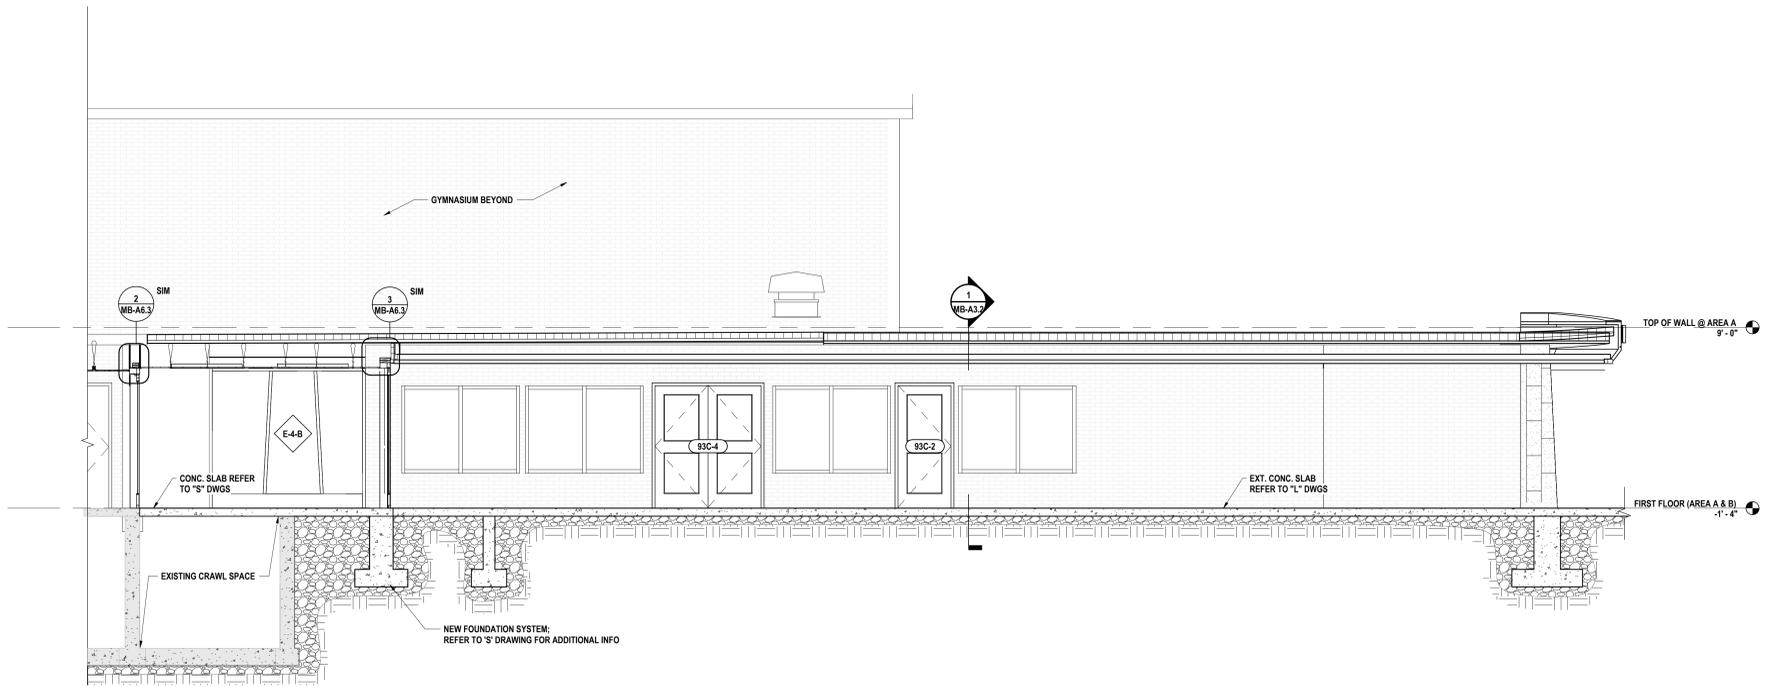


5 CANOPY BUILDING SECTION N/S 2  
1/4" = 1'-0"

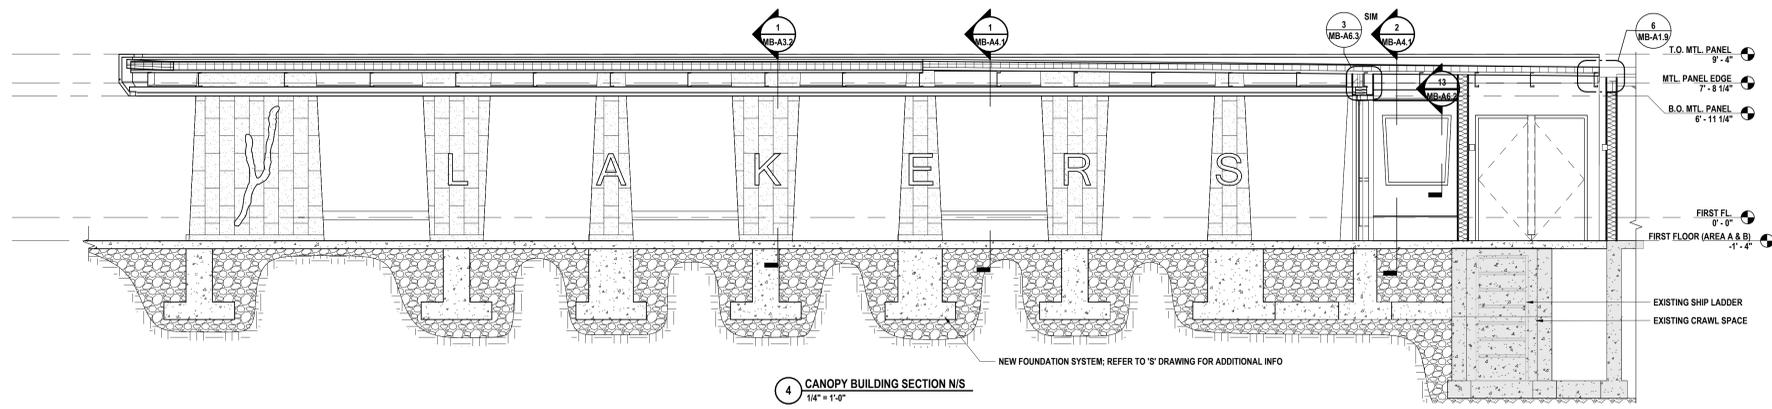


4 CANOPY BUILDING SECTION N/S  
1/4" = 1'-0"

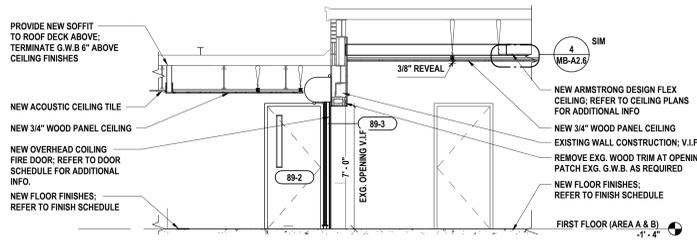

3 KITCHEN SECTION @ NEW FIRE DOOR  
1/4" = 1'-0"

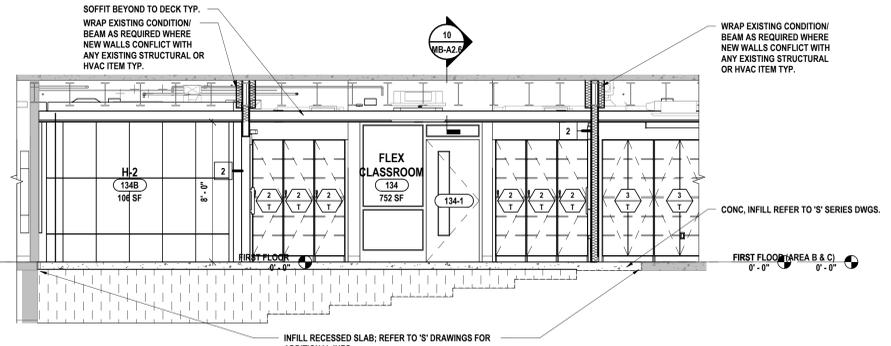

2 LGI TIERED STEPS INFILL  
1/4" = 1'-0"

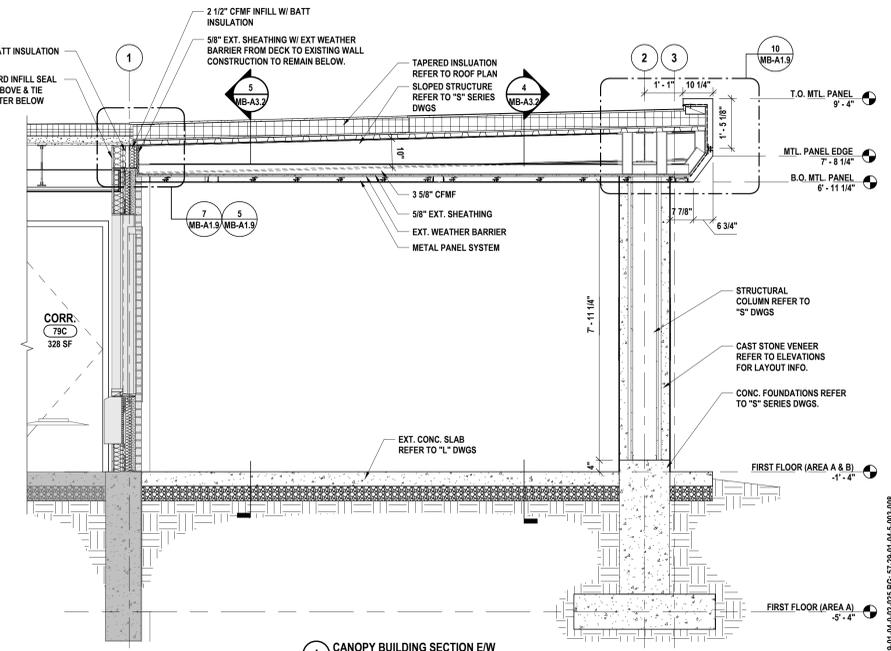

1 CANOPY BUILDING SECTION E/W  
1/2" = 1'-0"

DRAWN BY:	KLG
CHECKED BY:	JL
DATE:	10/27/2025
PHASE:	CD


#	DATE:	DESCRIPTION OF REVISION:
1	10/10/2025	ISSUE FOR BID

**HUNT ENGINEERS ARCHITECTS | SURVEYORS**  
 HORSEHEADS, NY 807-258-1088 | ROCHESTER, NY 585-337-7568 | TOWANDA, PA 570-265-4668  
 BINGHAMTON, NY 807-798-8881 | ALBANY, NY 807-798-8881  
 WWW.HUNTHEAS.COM  
 NY CERTIFICATE NO. 0016250 | PA CERTIFICATE NO. TSC2202031464-1


**BUILDING & WALL SECTIONS**  
 2025 CAPITAL IMPROVEMENTS PROJECT  
 HAMMONDSPORT CENTRAL SCHOOL DISTRICT  
 8272 MAIN STREET HAMMONDSPORT, NEW YORK, 14840

**MB-A3.2**  
 PROJECT NO: 1925.014




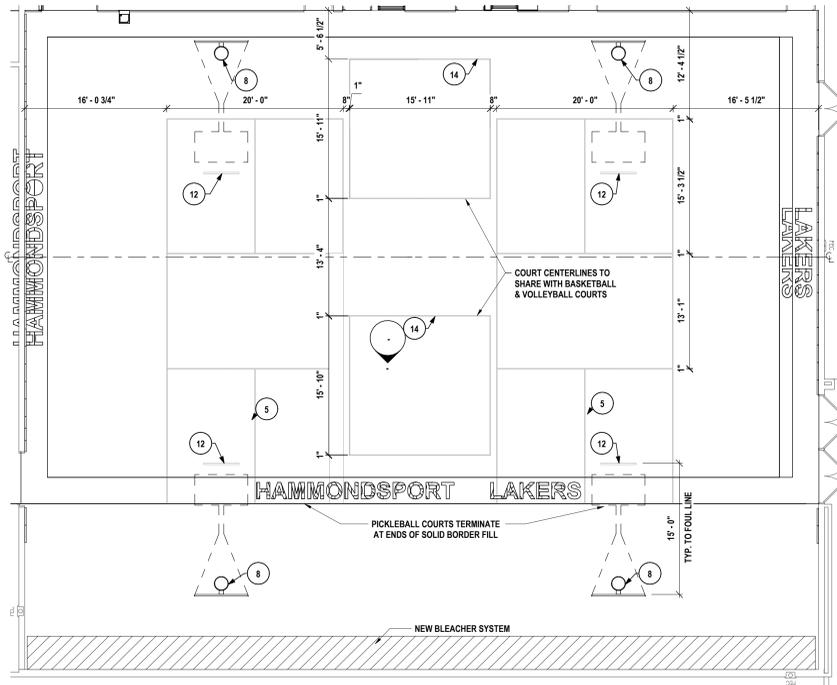


2 ENLARGED GYMNASIUM BADMINTON & FOUR SQUARE LINWORK PLAN  
1/8" = 1'-0"

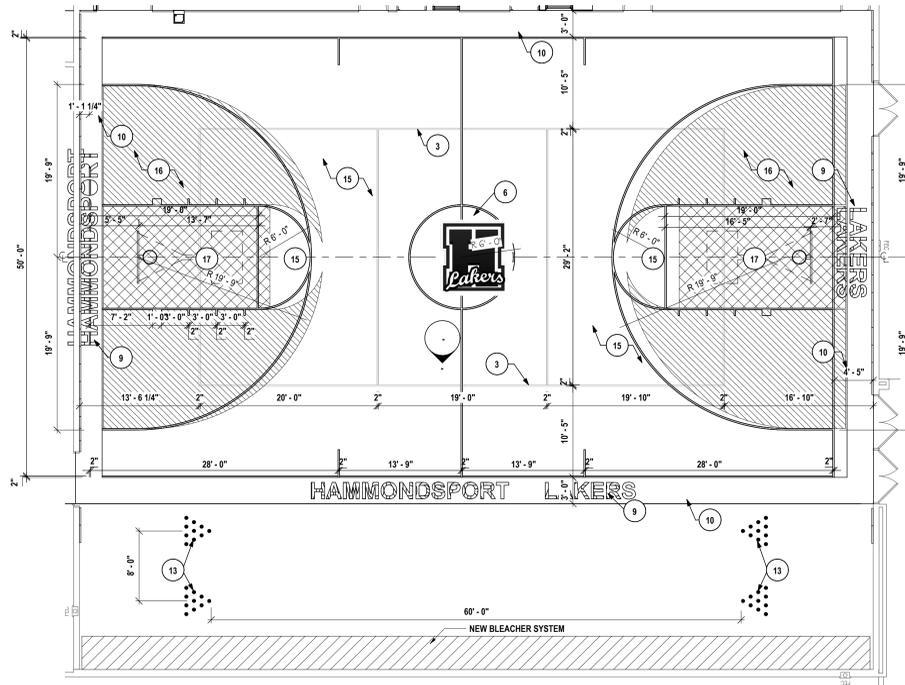

1 ENLARGED GYMNASIUM BASKETBALL & VOLLEYBALL LINWORK FLOOR PLAN  
1/8" = 1'-0"

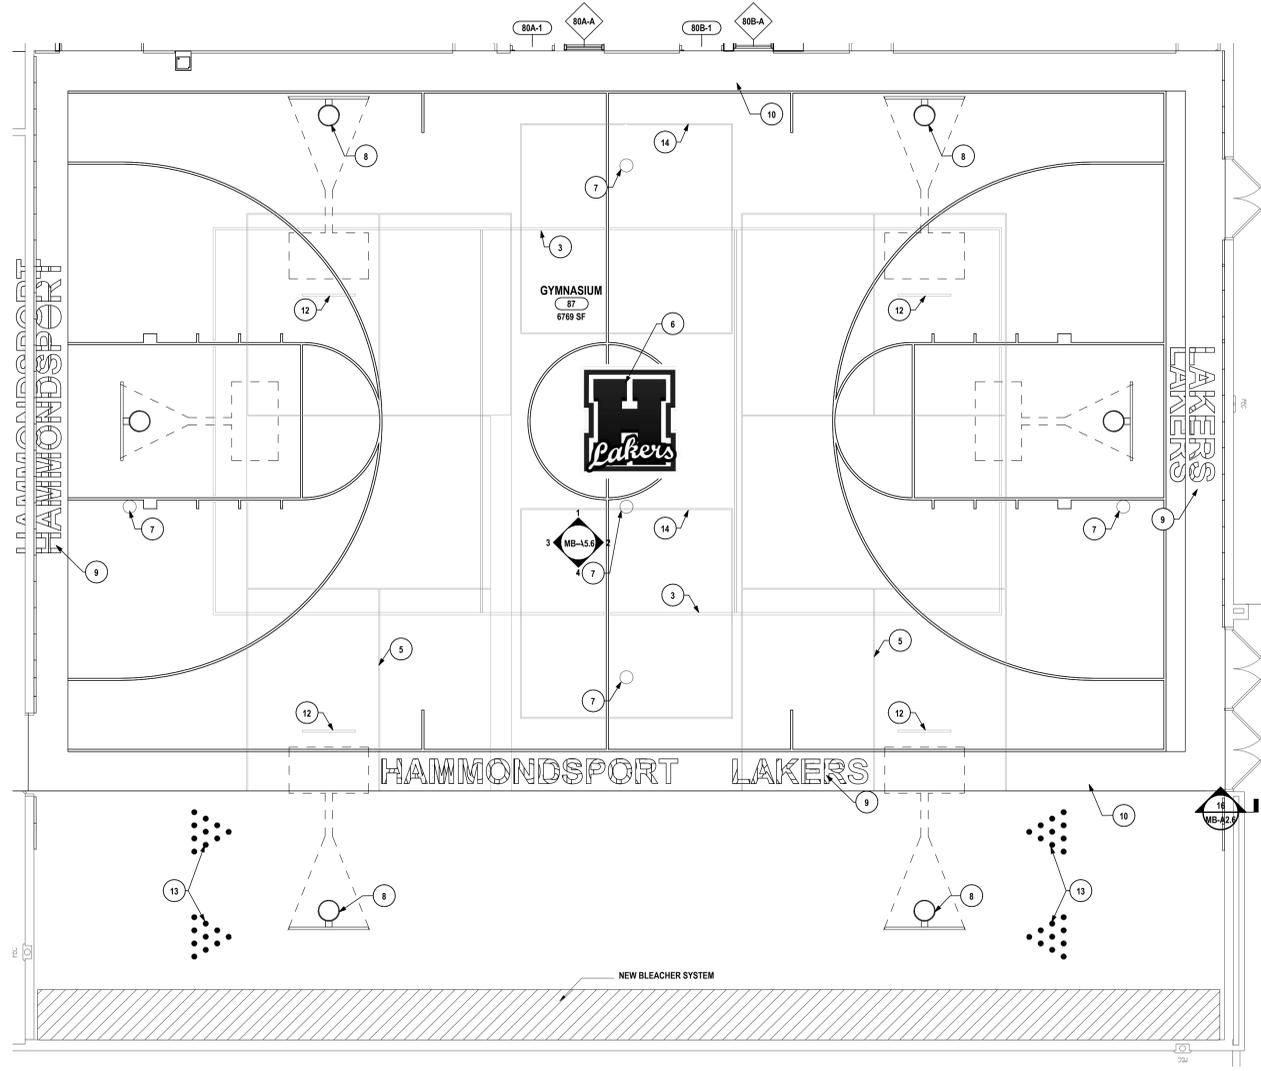

3 ENLARGED GYMNASIUM LINWORK OVERALL PLAN  
3/16" = 1'-0"

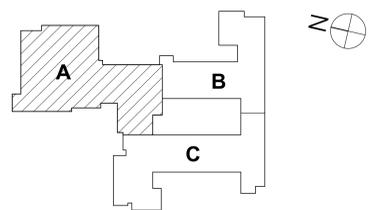

KEY PLAN

**GYMNASIUM PLAN GENERAL NOTES:**

- CENTER LINEWORK TO EXISTING EQUIPMENT SLEEVE LOCATIONS
- PROVIDE 2" GAP AT ALL LINE INTERSECTIONS IN ORDER OF PRIORITY AS FOLLOWS, BASKETBALL COURT, VOLLEY BALL COURT, BADMINTON COURT, FOUR SQUARE COURT

**PLAN DRAWING NOTES:**

- BASKETBALL COURT 50'-0" X 84'-0", 1 COURT, 2" LINES, COLOR TO BE BLACK
- PRACTICE BASKETBALL COURT 50'-0" X 84'-0", 2 COURTS, 1" LINES, COLOR TO BE BLUE
- MAN VOLLEYBALL COURT 29'-6" X 59'-6", 1 COURT, 2" LINES, COLOR TO BE WHITE
- PRACTICE VOLLEYBALL COURT 29'-6" X 59'-6", 2 COURTS, 1" LINES, COLOR TO BE DARK GREY
- PICKLEBALL COURT 20'-0" X 44'-0", 2 COURTS, 1" LINES, COLOR TO BE TAN
- PROVIDE CUSTOM DISTRICT LOGOS AS INDICATED ON DRAWINGS, (3) COLORS BLACK, WHITE, CUSTOM PURPLE
- EQUIPMENT SLEEVE, REFER TO SPECIFICATION SECTION 11 66 23
- BASKETBALL RIM ABOVE, TYP.
- 2'-0" HIGH LETTERING, COLOR TO BE WHITE, FONT TBD
- SOLID PAINTED BORDER, COLOR TO BE CUSTOM PURPLE
- 3'-2" HIGH LETTERING, COLOR TO BE WHITE, FONT TBD
- BASKETBALL FOUL LINE, 1" THICK X 4' LONG LINE, COLOR YELLOW
- BOWLING PINS SPOTS 2 1/2" DIAMETER TYPICAL, COLOR TO BE BLACK
- FOUR SQUARE COURT 16'-0" X 16'-0", CENTER LINES TO BE SHARED WITH BASKETBALL AND VOLLEYBALL LINEWORK, COLOR TO BE LIGHT GRAY
- GYM FLOOR AREA TO BE STN-2
- GYM FLOOR AREA INSIDE OF 3 POINT ARC TO BE STN-3
- GYM FLOOR AREA INSIDE KEY TO BE CUSTOM PURPLE STAIN, STN-4, PROVIDE PHYSICAL SAMPLES FOR OWNER/ARCHITECT APPROVAL

DATE:	1/20/2025	DESCRIPTION OF REVISION:	ISSUE FOR BID
#	1		


**HUNT ENGINEERS ARCHITECTS | SURVEYORS**  
 HORSEHEADS, NY 607-265-1000  
 ROCHESTER, NY 585-537-7500  
 BINGHAMTON, NY 607-798-8881  
 ALBANY, NY 607-788-8881  
 WWW.HUNTEAS.COM  
 NY CERTIFICATE NO. 0016250 PA CERTIFICATE NO. TSC22020313464-1

**ENLARGED GYMNASIUM PLAN**  
**2025 CAPITAL IMPROVEMENTS PROJECT**  
**HAMMONDSPORT CENTRAL SCHOOL DISTRICT**  
 8272 MAIN STREET HAMMONDSPORT, NEW YORK, 14840


**MB-A5.1**  
 PROJECT NO: 1925.014

SED #: MB-5728-01-04-0-020506 5728-01-04-0-005308



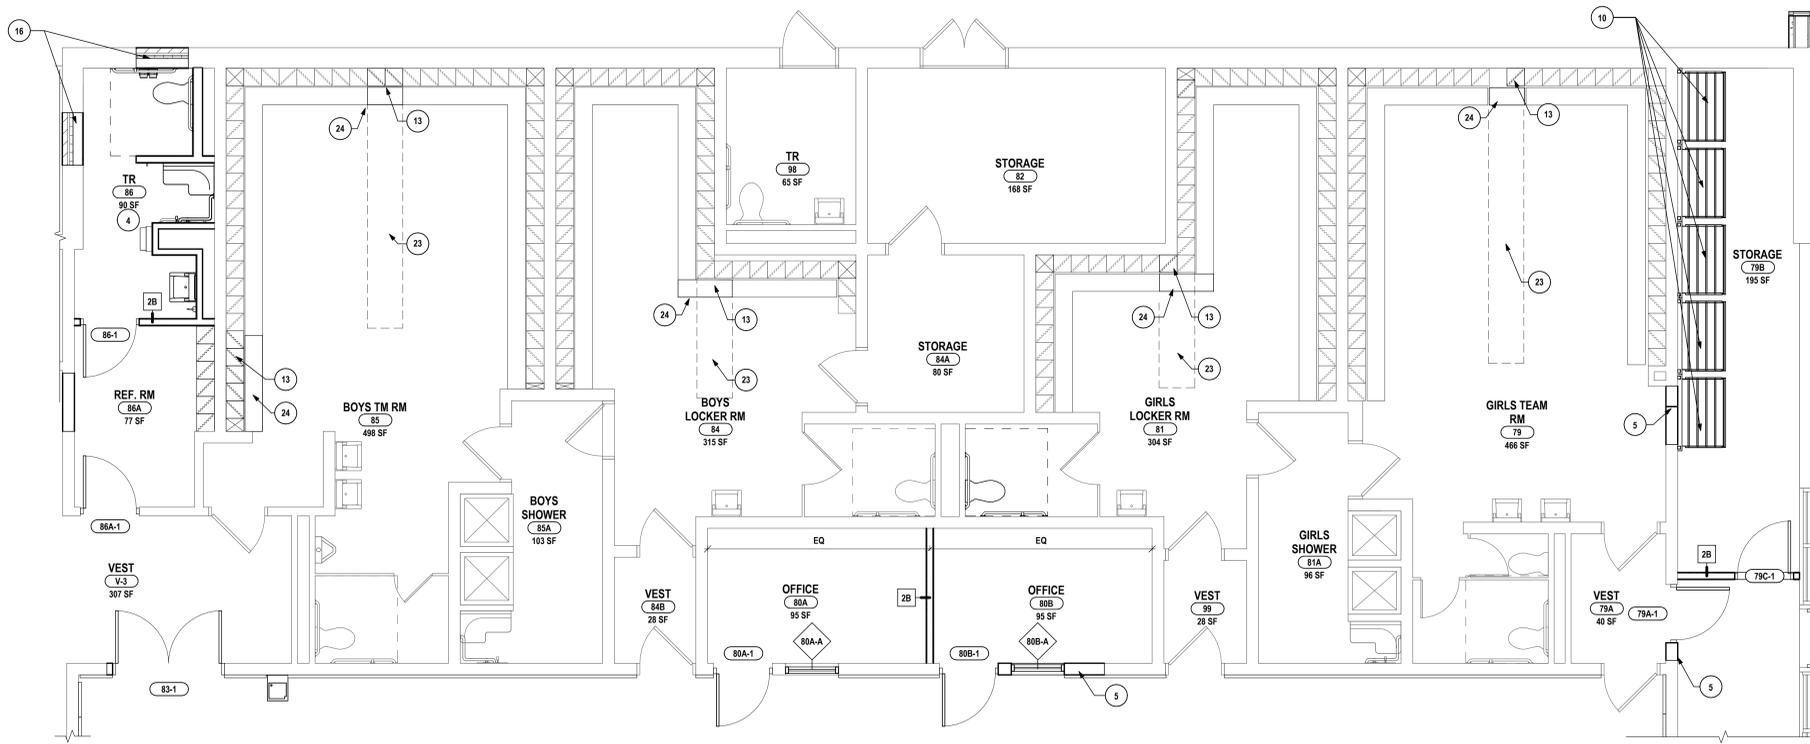

2 ENLARGED LOCKER ROOMS PLAN  
1/4" = 1'-0"

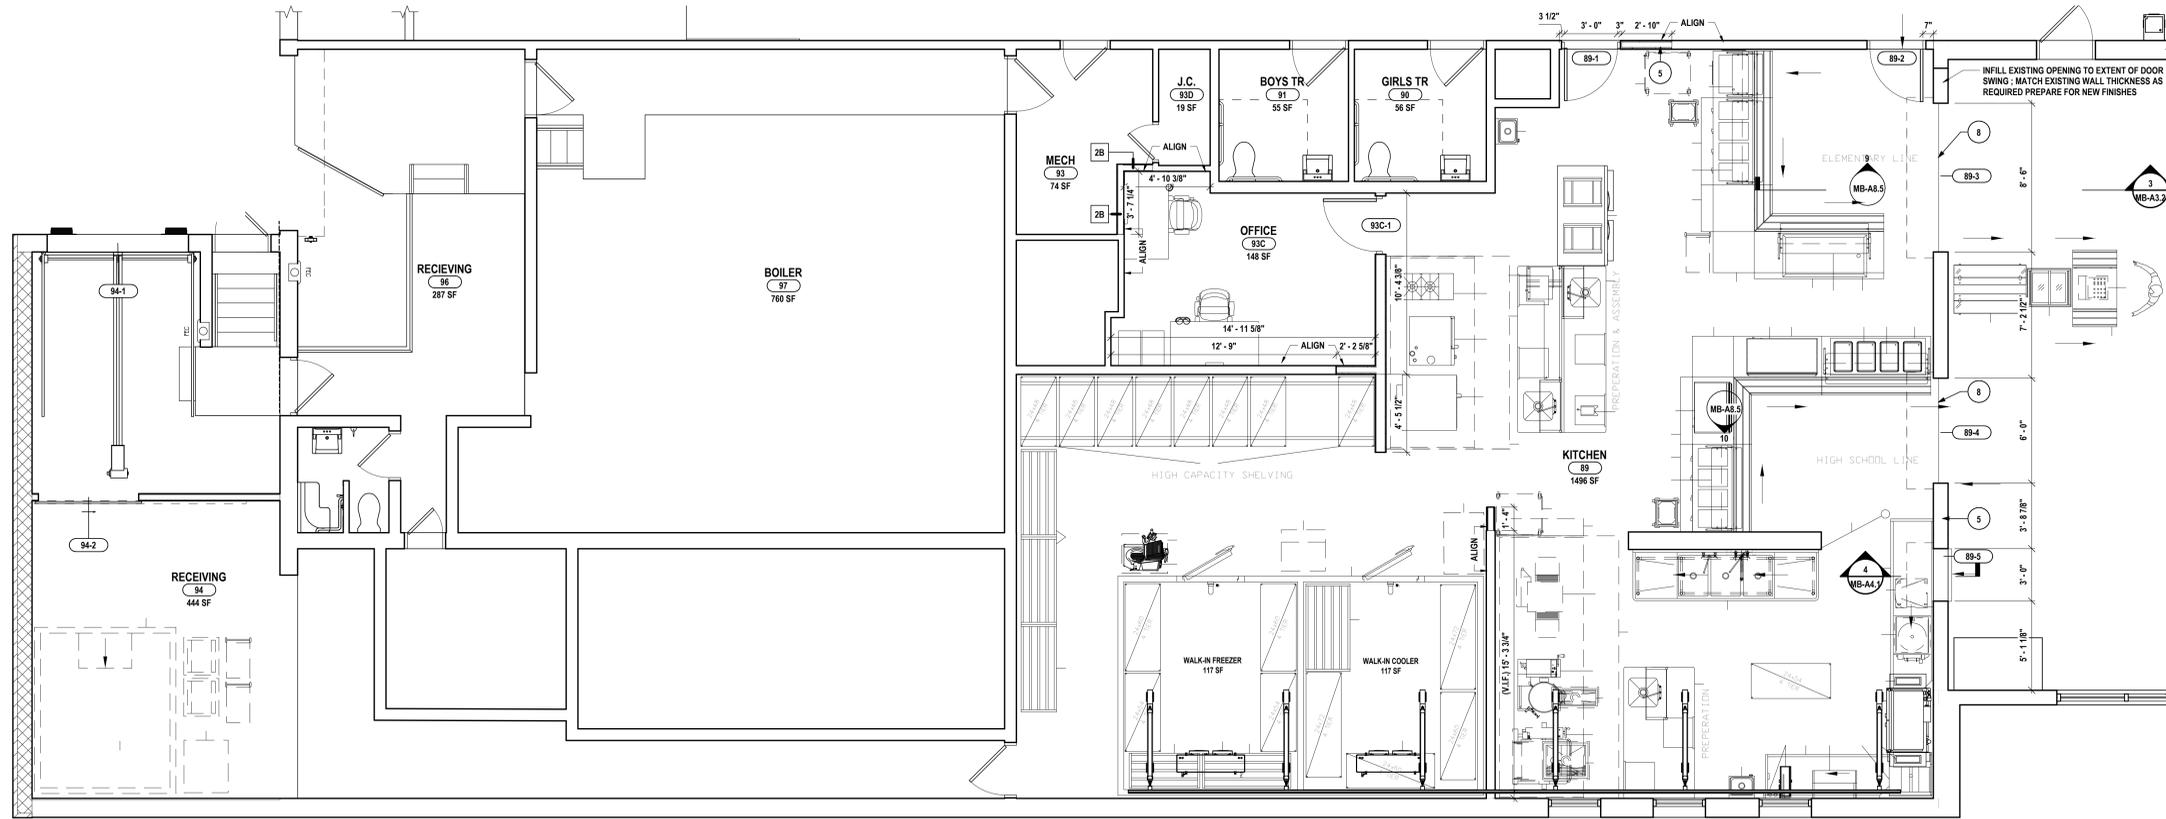

1 ENLARGED KITCHEN/REIVING PLAN  
1/4" = 1'-0"

**GENERAL NOTES:**

- A THE CONTRACTOR IS RESPONSIBLE FOR ALL WORK REQUIRED TO IMPLEMENT THE WORK OF THE CONTRACT, REGARDLESS OF WHETHER SPECIFICALLY INDICATED OR NOT, UNLESS NOTED OTHERWISE.
- B THE CONTRACTOR SHALL VERIFY ALL DIMENSIONS AND EXISTING CONDITIONS IN THE FIELD PRIOR TO COMMENCING ANY WORK AND NOTIFY ARCHITECT IMMEDIATELY IF ANY DISCREPANCIES ARE FOUND.
- C THE CONTRACTOR SHALL COORDINATE THE WORK OF THIS CONTRACT WITH THE WORK OF ALL OTHER CONTRACTED WORK AND WORK PERFORMED BY THE OWNER.
- D ALL NEW DOOR FRAMES INSTALLED IN METAL STUD OR MASONRY PARTITIONS SHALL BE MOUNTED 4" FROM ADJACENT WALLS (6" TO DOOR), TOOTH IN CMU BLOCK AND ANCHORS AT DOORS IN EXISTING CMU WALLS, UNLESS NOTED OR DETAILED OTHERWISE.
- E WHERE NEW DOORS ARE LOCATED IN EXISTING CORRIDOR WALLS, FLOORING, BASE AND WALL SHALL BE PATCHED TO MATCH EXISTING OR NEW CORRIDOR FINISHES. REFER TO FINISH KEY.
- F PROVIDE SOLID WOOD BLOCKING OR METAL STRAPPING AS REQUIRED IN METAL STUD WALLS AT ALL WALL MOUNTED EQUIPMENT AND ACCESSORIES INCLUDING FURNITURE FIXTURES AND EQUIPMENT. COORDINATE WITH THE WORK OF ALL OTHER CONTRACTED WORK AND WORK PERFORMED BY THE OWNER.
- G ITEMS SHOWN ARE INTENDED TO GIVE APPROXIMATE QUANTITY, LOCATION & TYPE. THE CONTRACTOR IS RESPONSIBLE FOR VERIFYING ACTUAL QUANTITY & EXISTING FIELD CONDITIONS.
- H ALL DIMENSIONS ARE TAKEN FROM FACE OF WALL TO FACE OF WALL UNLESS NOTED OTHERWISE.
- I THERE SHALL BE A MINIMUM OF 1'-4" CLEAR FLOOR SPACE ON THE PULL SIDE OF ALL NEW DOORS; THERE SHALL BE A MINIMUM OF 1'-0" CLEAR FLOOR SPACE ON THE PUSH SIDE OF ALL NEW DOORS.
- J THE WHEEL CHAIR SYMBOL INDICATES HANDICAP ACCESSIBLE MOUNTED FIXTURE ELEVATION AND SHALL CONFORM WITH CASCIANSI 117.1 AND ADAAG.
- K EXTEND ALL NEW PARTITIONS TO DECK ABOVE, UNLESS NOTED OTHERWISE.
- L ALL FINISHED ASSEMBLIES ARE REQUIRED TO BE PROTECTED DURING THE COURSE OF CONSTRUCTION. ALL FINISHED ASSEMBLIES DAMAGED DURING THE COURSE OF CONSTRUCTION ARE REQUIRED TO BE REPLACED OR REPAIRED AT THE ARCHITECT'S DIRECTION.

**PLAN DRAWING NOTES:**

- 1 PROVIDE NEW BASKETBALL BACKSTOP SYSTEM. REFER TO SPECIFICATION 11 66 23 FOR ADDITIONAL INFORMATION.
- 2 PROVIDE NEW BLEACHER ASSEMBLY SYSTEM. REFER TO SPECIFICATION 12 66 13 FOR ADDITIONAL INFORMATION.
- 3 PROVIDE NEW LOADING DOCK BUMPERS. REFER TO SPECIFICATION 11 13 13 FOR ADDITIONAL INFORMATION.
- 4 EXISTING WALL SYSTEM DOES NOT GO TO DECK. SISTER COLD FORMED METAL FRAMING TO EXISTING WALL AND DECK STRUCTURE TO EXTEND WALL TO DECK ABOVE. PROVIDE REQUIRED SIZED UNFACED BATT INSULATION AND 5/8" TYPE 'X' GYPSUM WALL BOARD TO BOTH SIDES. PROVIDE FIRE TAPE AND FIREPROOFING FOR ALL REQUIRED PENETRATIONS. REFER TO CODE COMPLIANCE SHEETS FOR RATING LOCATION. PARTIALLY REMOVE AND REINSTALL EXISTING CEILING SYSTEM AS REQUIRED.
- 5 INFILL EXISTING DOOR, WINDOW, OR WALL OPENING AS SHOWN ON PLAN TO MATCH EXISTING WALL THICKNESS AND PREPARE FOR NEW FINISHES.
- 6 PROVIDE WALL PADS ON EXPOSED WALLS AS INDICATED (NO WALL PADS BEHIND BLEACHERS). PROVIDE CUTOUPS FOR ALL WALL MOUNTED EQUIPMENT/FIXTURES AS REQUIRED.
- 7 PROVIDE CONCRETE PAD WITH FROST WALL AT DOOR. REFER TO 'S' DRAWINGS FOR ADDITIONAL DETAILS.
- 8 PROVIDE 4" SAFETY YELLOW FLOOR PAINT AT FLOOR TRANSITION AS PER SED CODE.
- 9 PROVIDE NEW WOOD WALL PANEL FINISHES. REFER TO FINISH SCHEDULE FOR ADDITIONAL INFORMATION. REMOVE EXISTING WALL MOSAIC TILE FINISH AND PREPARE FOR NEW FINISHES.
- 10 PROVIDE ADJUSTABLE WALL SHELVING, 8.0.0 GEAR BOSS MOUNTED ON WALL, 241C025; STARTER BAY AS REQUIRED, 241C026; ADD ON BAYS AS REQUIRED, PROVIDE (5) 241C001; 30 1/2" SHELF, (1) 241C004; GARMENT PER BAY. ALL SHELF UNITS TO COME WITH OPTIONS SOLID TOP. QUANTITY OF BAYS AS SHOWN ON PLANS.
- 11 PROVIDE NEW GYM WOOD FLOOR SYSTEM & ALL ACCESSORIES. PAINT, & SEAL & FINISH FLOOR PER SPECIFICATION 09 64 66.
- 12 INFILL EXISTING MASONRY OPENING TO MATCH EXISTING WALL CONSTRUCTION & THICKNESS, UNLESS NOTED OTHERWISE. TOOTH IN NEW OR SALVAGED MASONRY WITH EXISTING. MATCH EXISTING FINISHES OR PREPARE SUBSTRATE AS REQUIRED TO ACCEPT NEW FINISHES.
- 13 PROVIDE LOCKERS, BASE AND ASSOCIATED ACCESSORIES IN THEIR ENTIRETY.
- 14 CMF BENCH WITH SOLID SURFACE MATERIAL HORIZONTAL SURFACE.
- 15 PROVIDE BLACK PVC BLOCKING AND 1" THICK SOLID COMPOSITE DECKING SYSTEM AROUND STRUCTURAL STEEL BEAM.
- 16 INFILL EXISTING MASONRY OPENING. PROVIDE BRICK VENEER, 2" OF POLYISO INSULATION, WEATHER BARRIER TO FURTHEST EXTENT POSSIBLE AND CONCRETE MASONRY INTERIOR. TOOTH IN NEW OR SALVAGED MASONRY WITH EXISTING. MATCH EXISTING FINISHES OR PREPARE SUBSTRATE AS REQUIRED TO ACCEPT NEW FINISHES.
- 17 REPAIR EXISTING STOREFRONT WINDOW, TO BE RE-GLAZED, RE-CALKED, OR FRAME REPLACEMENT. REPAIR SURROUNDING WALL SURFACES WHERE DAMAGE OCCURS.
- 18 FOLDING WALL PARTITION; REFER TO SPECIFICATION 10 22 39 FOR ADDITIONAL INFORMATION.
- 19 WALL-MOUNTED ACOUSTIC, STORAGE, MARKERBOARD, & DISPLAY SURROUND SYSTEM; PLATINUM VISUAL SYSTEMS P180 WALL SYSTEM. REFER TO MB-A5.8 FOR SYSTEM DETAILS.
- 20 NEW DRINKING FOUNTAIN FIXTURE; REFER TO 'P' DRAWINGS FOR ADDITIONAL INFORMATION. PATCH FINISHES TO MATCH AS REQUIRED.
- 21 PROVIDE NEW FIRE EXTINGUISHER HANGER/BRACKET AT LOCATION SHOWN; RELOCATE EXISTING FIRE EXTINGUISHER AND ACCESSORIES TO NEW LOCATION.
- 22 PATCH AND REPAIR EXISTING WALL SYSTEM AND FLOOR SYSTEM FROM HVAC REMOVALS AND PREPARE FOR NEW FINISHES AS REQUIRED.
- 23 PATCH TO MATCH CONCRETE FLOOR SLAB AND PORCELAIN MOSAIC FLOOR FINISH TO THE EXTENT OF REQUIRED LOCKER DEMO. TOOTH IN TILE AS REQUIRED.
- 24 PROVIDE BENCH INFILL TO CONNECT THE EXISTING BENCHES TO THE EXTENT SHOWN ON PLAN.
- 25 PROVIDE NEW WINDOW IN EXISTING OPENING. REUSE EXISTING SILL; INFILL SURROUNDING EXISTING OPENING TO MATCH EXISTING WALL CONSTRUCTION AND THICKNESS.
- 26 PROVIDE WALL CHASE(S) FOR UV PIPING. SEE 'H' DRAWINGS FOR MORE INFORMATION.
- 27 PATCH GYPSUM WALL BOARD AS REQUIRED TO RECEIVE NEW FINISHES.
- 28 HYDRAULIC PASSENGER ELEVATOR MODERNIZATION. REFER TO SPECIFICATION 14-28-19 FOR MORE INFORMATION.

DRAWN BY:	KLC
CHECKED BY:	JL
DATE:	10/27/2025
PHASE:	CD

**HUNT ENGINEERS ARCHITECTS | SURVEYORS**

HORSEHEADS, NY 607-268-1008    ROCHESTER, NY 585-337-7668    TOWANDA, PA 570-265-4668  
 BINGHAMTON, NY 607-798-8881    ALBANY, NY 607-798-8881

WWW.HUNTEAS.COM  
 NY CERTIFICATE NO. 0016250    PA CERTIFICATE NO. TSC2203131464-1

**ENLARGED KITCHEN & LOCKER ROOMS PLANS**


**2025 CAPITAL IMPROVEMENTS PROJECT**

**HAMMONDSPORT CENTRAL SCHOOL DISTRICT**


8272 MAIN STREET HAMMONDSPORT, NEW YORK, 14840

**MB-A5.3**


PROJECT NO: 1925.014

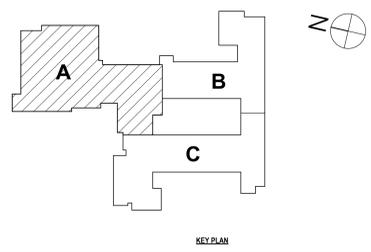


SED #: MB-57-26-01-04-02-02-516; 57-26-01-04-04-003-008

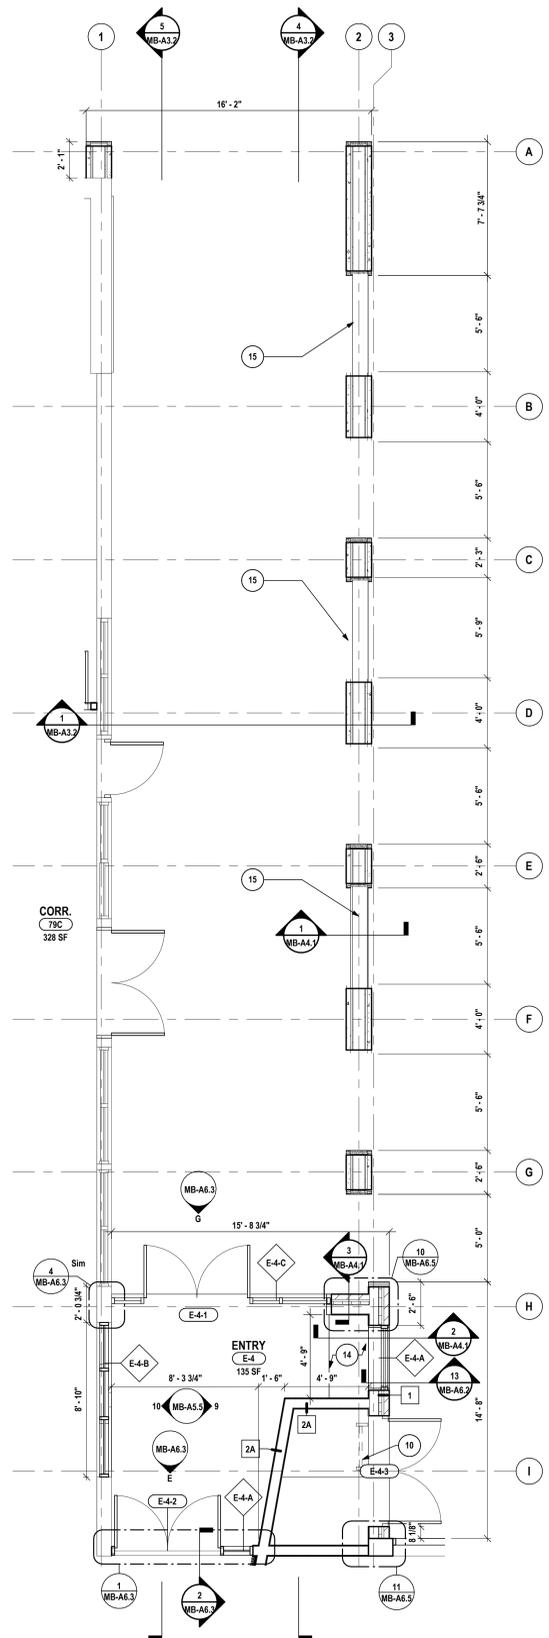


3 ENLARGED CANOPY FLOOR PLAN  
1/4" = 1'-0"

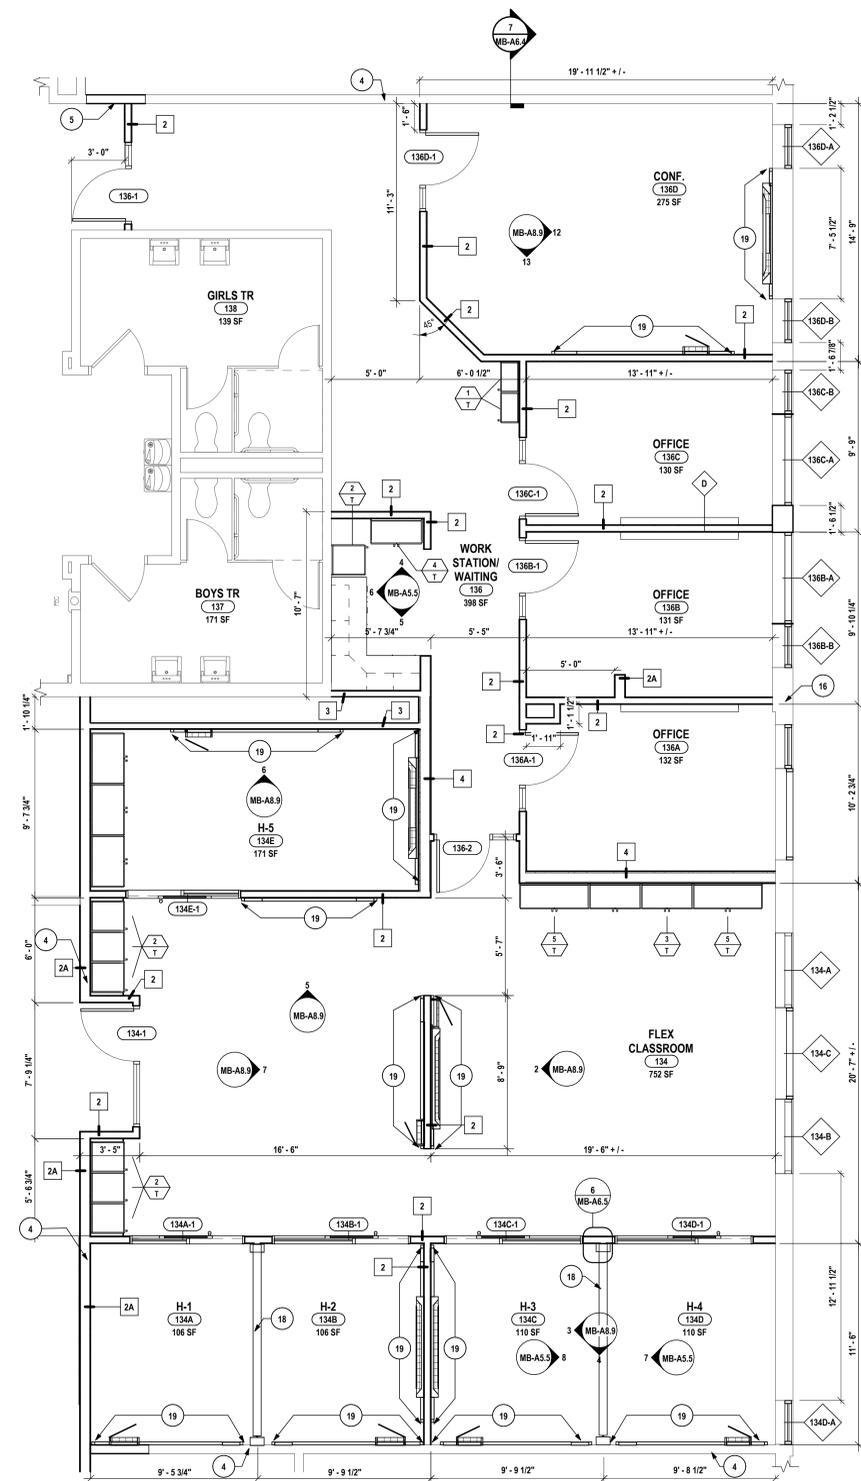

2 ENLARGED STUDENT SUPPORT SERVICES FLOOR PLAN  
1/4" = 1'-0"

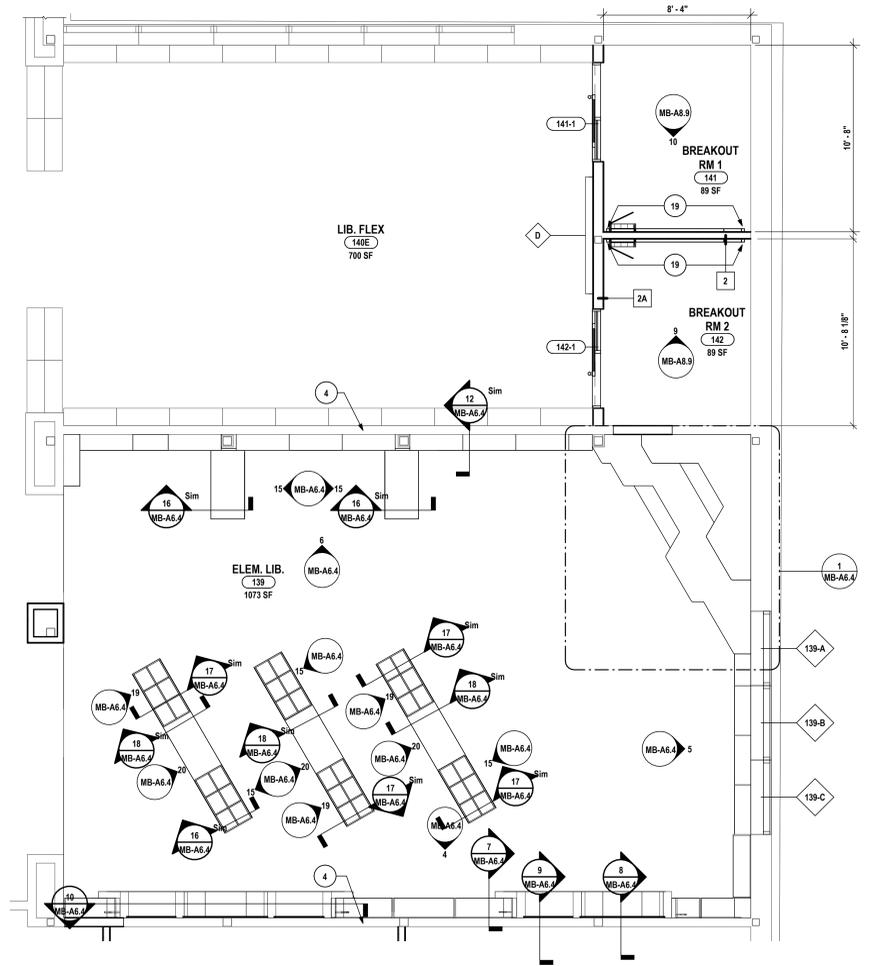

1 ENLARGED LIBRARY FLOOR PLAN  
1/4" = 1'-0"

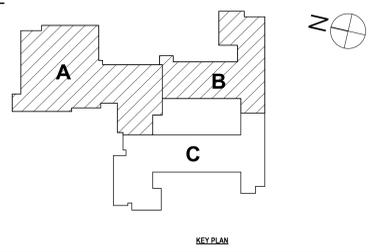

**PLAN DRAWING NOTES:**

- 1 PROVIDE NEW BASKETBALL BACKSTOP SYSTEM. REFER TO SPECIFICATION 11 66 23 FOR ADDITIONAL INFORMATION.
- 2 PROVIDE NEW BLEACHER ASSEMBLY SYSTEM. REFER TO SPECIFICATION 12 66 13 FOR ADDITIONAL INFORMATION.
- 3 PROVIDE NEW LOADING DOCK BUMPERS. REFER TO SPECIFICATION 11 13 13 FOR ADDITIONAL INFORMATION.
- 4 EXISTING WALL SYSTEM DOES NOT GO TO DECK. SISTER COLD FORMED METAL FRAMING TO EXISTING WALL AND DECK STRUCTURE TO EXTEND WALL TO DECK ABOVE. PROVIDE REQUIRED SIZED UNFACED BATT INSULATION AND 5/8" TYPE X GYPSUM WALL BOARD BOTH SIDES. PROVIDE FIRE TAPE AND FIREPROOFING FOR ALL REQUIRED PENETRATIONS. REFER TO CODE COMPLIANCE SHEETS FOR RATING LOCATION. PARTIALLY REMOVE AND REINSTALL EXISTING CEILING SYSTEM AS REQUIRED.
- 5 INFILL EXISTING DOOR, WINDOW, OR WALL OPENING AS SHOWN ON PLAN TO MATCH EXISTING WALL THICKNESS AND PREPARE FOR NEW FINISHES.
- 6 PROVIDE WALL PADS ON EXPOSED WALLS AS INDICATED (NO WALL PADS BEHIND BLEACHERS); PROVIDE CUTOUTS FOR ALL WALL MOUNTED EQUIPMENT/FIXTURES AS REQUIRED.
- 7 PROVIDE CONCRETE PAD WITH FROST WALL AT DOOR. REFER TO 'S' DRAWINGS FOR ADDITIONAL DETAILS.
- 8 PROVIDE 4" SAFETY YELLOW FLOOR PAINT AT FLOOR TRANSITION AS PER SED CODE.
- 9 PROVIDE NEW WOOD WALL PANEL FINISHES; REFER TO FINISH SCHEDULE FOR ADDITIONAL INFORMATION. REMOVE EXISTING WALL MOSAIC TILE FINISH AND PREPARE FOR NEW FINISHES.
- 10 PROVIDE ADJUSTABLE WALL SHELVING, B.O.D GEAR BOSS MOUNTED ON WALL; 241C025; STARTER BAY AS REQUIRED, 241C026 ADD ON BAYS AS REQUIRED, PROVIDE (3) 241C001; 30 1/2" SHELF, (1) 241C004; GARMENT PER BAY. ALL SHELF UNITS TO COME WITH OPTIONS SOLID TOP. QUANTITY OF BAYS AS SHOWN ON PLANS.
- 11 PROVIDE NEW OVM WOOD FLOOR SYSTEM & ALL ACCESSORIES. PAINT, & SEAL & FINISH FLOOR PER SPECIFICATION 09 64 66.
- 12 INFILL EXISTING MASONRY OPENING TO MATCH EXISTING WALL CONSTRUCTION & THICKNESS, UNLESS NOTED OTHERWISE. TOOTH IN NEW OR SALVAGED MASONRY WITH EXISTING. MATCH EXISTING FINISHES OR PREPARE SUBSTRATE AS REQUIRED TO ACCEPT NEW FINISHES.
- 13 PROVIDE LOCKERS, BASE AND ASSOCIATED ACCESSORIES IN THEIR ENTIRETY.
- 14 CFMF BENCH WITH SOLID SURFACE MATERIAL HORIZONTAL SURFACE.
- 15 PROVIDE BLACK PVC BLOCKING AND 1" THICK SOLID COMPOSITE DECKING SYSTEM AROUND STRUCTURAL STEEL BEAM.
- 16 INFILL EXISTING MASONRY OPENING. PROVIDE BRICK VENEER, 2" OF POLYISO INSULATION, WEATHER BARRIER TO FURTHEST EXTENT POSSIBLE AND CONCRETE MASONRY INTERIOR. TOOTH IN NEW OR SALVAGED MASONRY WITH EXISTING. MATCH EXISTING FINISHES OR PREPARE SUBSTRATE AS REQUIRED TO ACCEPT NEW FINISHES.
- 17 REPAIR EXISTING STOREFRONT WINDOW. TO BE RE-GLAZED, RE-CAULKED, OR FRAME REPLACEMENT. REPAIR SURROUNDING WALL SURFACES WHERE DAMAGE OCCURS.
- 18 FOLDING WALL PARTITION. REFER TO SPECIFICATION 10 22 39 FOR ADDITIONAL INFORMATION.
- 19 WALL-MOUNTED ACOUSTIC STORAGE, MARKERBOARD, & DISPLAY SURROUND SYSTEM; PLATINUM VISUAL SYSTEMS P380 WALL SYSTEM. REFER TO MB-A8.9 FOR SYSTEM DETAILS.
- 20 NEW DRINKING FOUNTAIN FIXTURE. REFER TO 'P' DRAWINGS FOR ADDITIONAL INFORMATION. PATCH FINISHES TO MATCH AS REQUIRED.
- 21 PROVIDE NEW FIRE EXTINGUISHER HANGER/BRACKET AT LOCATION SHOWN; RELOCATE EXISTING FIRE EXTINGUISHER AND ACCESSORIES TO NEW LOCATION.
- 22 PATCH AND REPAIR EXISTING WALL SYSTEM AND FLOOR SYSTEM FROM HVAC REMOVALS AND PREPARE FOR NEW FINISHES AS REQUIRED.
- 23 PATCH TO MATCH CONCRETE FLOOR SLAB AND PORCELAIN MOSAIC FLOOR FINISH TO THE EXTENT OF REQUIRED LOCKER DEMO. TOOTH IN TILE AS REQUIRED.
- 24 PROVIDE BENCH INFILL TO CONNECT THE EXISTING BENCHES TO THE EXTENT SHOWN ON PLAN.
- 25 PROVIDE NEW WINDOW IN EXISTING OPENING. REUSE EXISTING SILL; INFILL SURROUNDING EXISTING OPENING TO MATCH EXISTING WALL CONSTRUCTION AND THICKNESS.
- 26 PROVIDE WALL CHASE(S) FOR UV PIPING. SEE 'H' DRAWINGS FOR MORE INFORMATION.
- 27 PATCH GYPSUM WALL BOARD AS REQUIRED TO RECEIVE NEW FINISHES.
- 28 HYDRAULIC PASSENGER ELEVATOR MODERNIZATION. REFER TO SPECIFICATION 14-28-19 FOR MORE INFORMATION.

**GENERAL NOTES:**

- A THE CONTRACTOR IS RESPONSIBLE FOR ALL WORK REQUIRED TO IMPLEMENT THE WORK OF THE CONTRACT, REGARDLESS OF WHETHER SPECIFICALLY INDICATED OR NOT, UNLESS NOTED OTHERWISE.
- B THE CONTRACTOR SHALL VERIFY ALL DIMENSIONS AND EXISTING CONDITIONS IN THE FIELD PRIOR TO COMMENCING ANY WORK AND NOTIFY ARCHITECT IMMEDIATELY IF ANY DISCREPANCIES ARE FOUND.
- C THE CONTRACTOR SHALL COORDINATE THE WORK OF THIS CONTRACT WITH THE WORK OF ALL OTHER CONTRACTED WORK AND WORK PERFORMED BY THE OWNER.
- D ALL NEW DOOR FRAMES INSTALLED IN METAL STUD OR MASONRY PARTITIONS SHALL BE MOUNTED 4" FROM ADJACENT WALLS (6" TO DOOR), TOOTH IN CMU BLOCK AND ANCHORS AT DOORS IN EXISTING CMU WALLS, UNLESS NOTED OR DETAILED OTHERWISE.
- E WHERE NEW DOORS ARE LOCATED IN EXISTING CORRIDOR WALLS, FLOORING, BASE AND WALL SHALL BE PATCHED TO MATCH EXISTING OR NEW CORRIDOR FINISHES. REFER TO FINISH KEY.
- F PROVIDE SOLID WOOD BLOCKING OR METAL STRAPPING AS REQUIRED IN METAL STUD WALLS AT ALL WALL MOUNTED EQUIPMENT AND ACCESSORIES INCLUDING FURNITURE FIXTURES AND EQUIPMENT. COORDINATE WITH THE WORK OF ALL OTHER CONTRACTED WORK AND WORK PERFORMED BY THE OWNER.
- G ITEMS SHOWN ARE INTENDED TO GIVE APPROXIMATE QUANTITY, LOCATION & TYPE. THE CONTRACTOR IS RESPONSIBLE FOR VERIFYING ACTUAL QUANTITY & EXISTING FIELD CONDITIONS.
- H ALL DIMENSIONS ARE TAKEN FROM FACE OF WALL TO FACE OF WALL, UNLESS NOTED OTHERWISE.
- I THERE SHALL BE A MINIMUM OF 1'-0" CLEAR FLOOR SPACE ON THE PUSH SIDE OF ALL NEW DOORS; THERE SHALL BE A MINIMUM OF 1'-0" CLEAR FLOOR SPACE ON THE PULL SIDE OF ALL NEW DOORS.
- J THE WHEELCHAIR SYMBOL INDICATES HANDICAP ACCESSIBLE MOUNTED FIXTURE ELEVATION AND SHALL CONFORM WITH CAROANS A117.1 AND ADAAG.
- K EXTEND ALL NEW PARTITIONS TO DECK ABOVE, UNLESS NOTED OTHERWISE.
- L ALL FINISHED ASSEMBLIES ARE REQUIRED TO BE PROTECTED DURING THE COURSE OF CONSTRUCTION. ALL FINISHED ASSEMBLIES DAMAGED DURING THE COURSE OF CONSTRUCTION ARE REQUIRED TO BE REPLACED OR REPAIRED AT THE ARCHITECT'S DIRECTION.

DRAWN BY:	KLC
CHECKED BY:	JL
DATE:	10/27/2025
PHASE:	CD

DESCRIPTION OF REVISION:  
ISSUE FOR BID

# DATE: 1 10/10/2025


IT IS A VIOLATION OF THE LAW FOR ANY PERSON TO MAKE UNAUTHORIZED ALTERATIONS OR ADDITIONS TO ANY DRAWING, SPECIFICATION, CONTRACT, INSTRUMENT OF SERVICE, OR SUBMITTALS DATE.

**HUNT ENGINEERS ARCHITECTS | SURVEYORS**  
 HORSEHEADS, NY 607-268-1000    ROCKY HILLS, CT 860-268-7668    TOWANDA, PA 870-265-4668  
 BINGHAMTON, NY 607-798-8881    ALBANY, NY 607-798-8881  
 WWW.HUNTEAS.COM  
 NY CERTIFICATE NO. 0016250    PA CERTIFICATE NO. TSC22020131464-1

**ENLARGED PLANS**  
**2025 CAPITAL IMPROVEMENTS PROJECT**  
**HAMMONDSPORT CENTRAL SCHOOL DISTRICT**  
 8272 MAIN STREET HAMMONDSPORT, NEW YORK, 14840

**MB-A5.4**  
 PROJECT NO. 1925.014


**MARKERBOARD ELEVATIONS:**

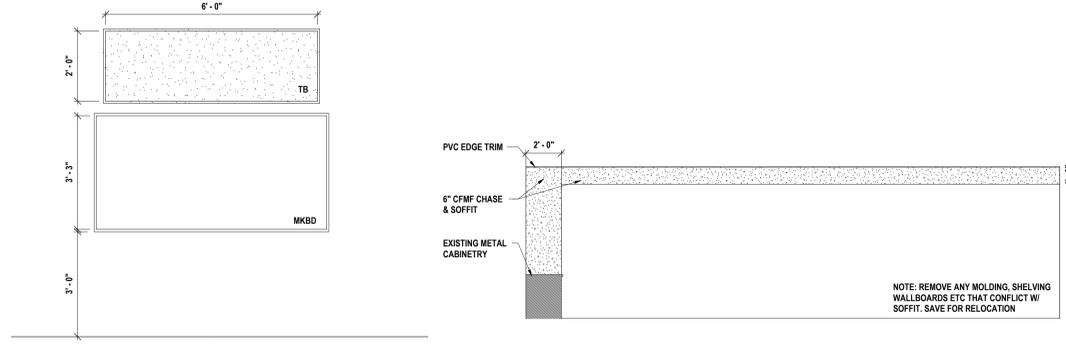


**14 TYPICAL PIPE CHASE ELEVATION PLAN SOUTH**  
1/4" = 1'-0"

MARK	SIZE			MODEL NUMBER	DOOR CONFIGURATION	TYPE COMMENTS
	HEIGHT	WIDTH	DEPTH			
<b>BASE CABINET</b>						
B-1	32 1/2"	15 5/16"	22 1/2"	3604	1 DOOR	
B-2	32 1/2"	24"	22 1/2"	3606	1 DOOR	
B-3	32 1/2"	30"	22 1/2"	3683C	1 DOOR, 1 DRAWER	
B-4	32 1/2"	47 1/4"	22 1/2"	3780P	1 DOOR	BLIND CORNER CABINET
<b>TALL CABINET</b>						
T-1	84"	21"	12"	5600	2 DOOR	
T-2	84"	21"	22 1/2"	5606	1 DOOR	
T-3	84"	35 1/4"	<varies>	5688	2 DOOR	
T-4	84"	35 1/4"	16"	5680	2 DOOR	
T-5	84"	47 1/4"	16 1/2"	5692	2 DOOR	
<b>WALL CABINET</b>						
W-1	36"	24 1/32"	12"	5292	1 DOOR	CORNER CABINET
W-2	36"	24"	12"	5348	1 DOOR	
W-3	36"	18"	12"	5364	1 DOOR	

**CASEWORK SCHEDULE**

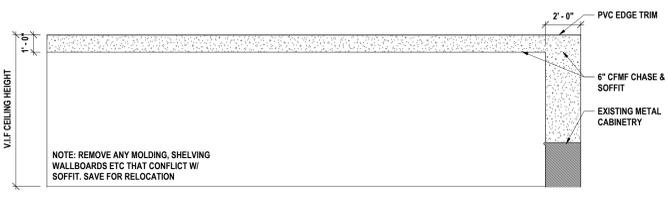


**13 TYPICAL ELEVATION FOR PIPE CHASE PLAN NORTH**  
1/4" = 1'-0"

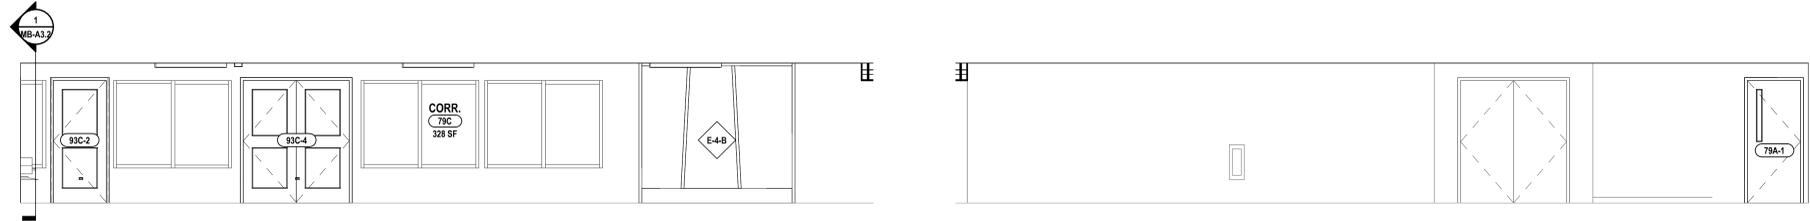


**12 ELEV @ CORR. 79C DROP OFF SIDE**  
1/4" = 1'-0"


**11 ELEV. @ CORR. 79C GYM SIDE**  
1/4" = 1'-0"

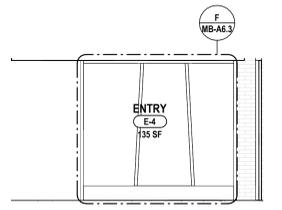


**10 NEW ENTRY - WEST ELEVATION**  
1/4" = 1'-0"

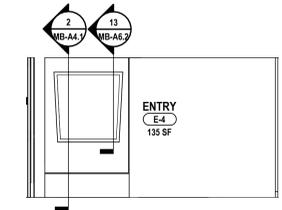


**9 NEW ENTRY - EAST ELEVATION**  
1/4" = 1'-0"

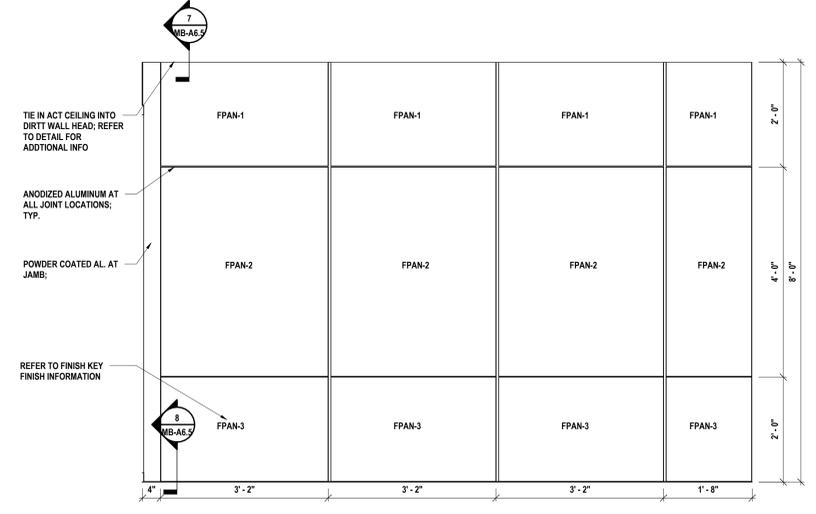


**8 DIRT FOLDING LEAF WALL ELEVATION 2**  
3/4" = 1'-0"

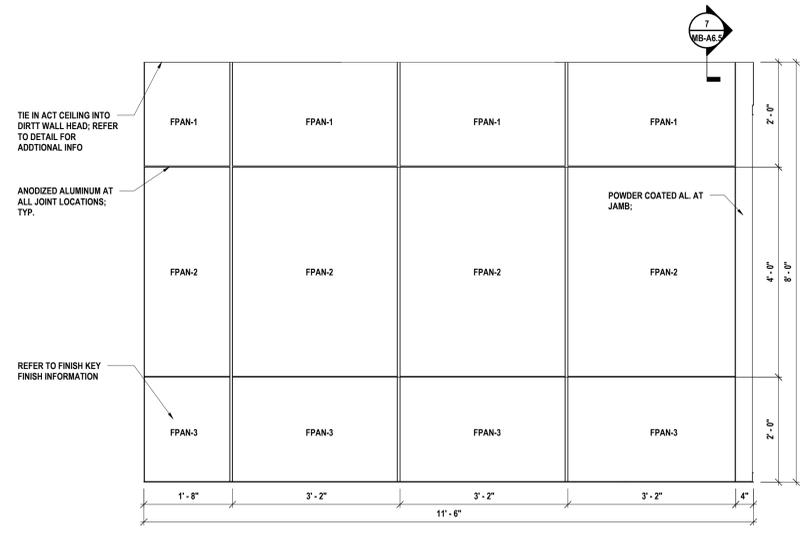


**7 DIRT FOLDING LEAF WALL ELEVATION 1**  
3/4" = 1'-0"

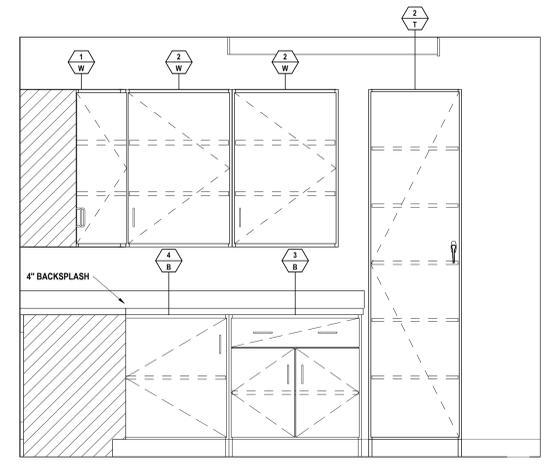


**6 136 WORK STATION - WEST**  
3/4" = 1'-0"

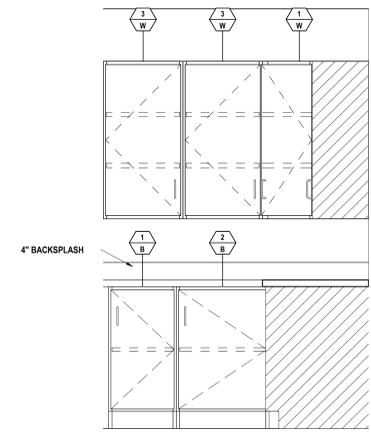


**5 136 WORK STATION - SOUTH**  
3/4" = 1'-0"

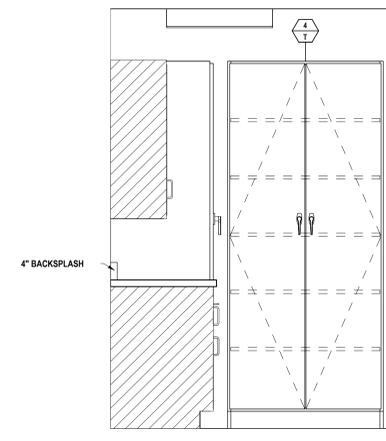


**4 136 WORK STATION - NORTH**  
3/4" = 1'-0"

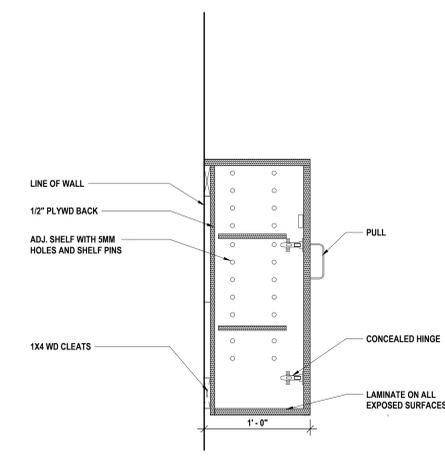

**3 TYPICAL WALL CABINET**  
1 1/2" = 1'-0"

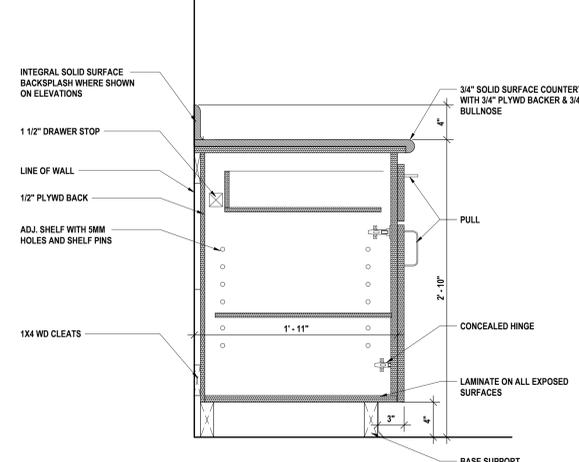

**2 TYPICAL DRAWER CABINET DETAIL**  
1 1/2" = 1'-0"

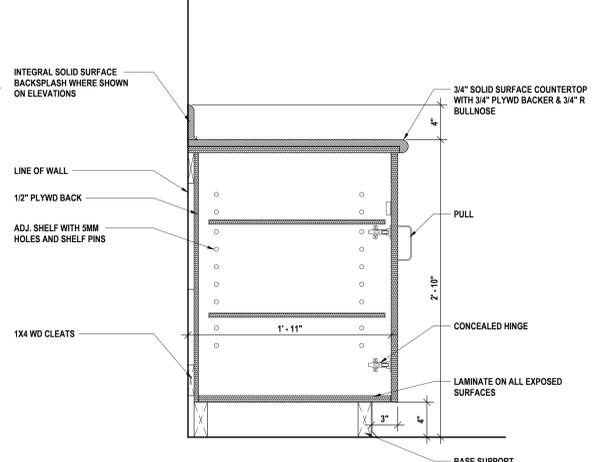

**1 TYPICAL BASE CABINET DETAIL**  
1 1/2" = 1'-0"

DATE: 10/27/2025  
ISSUE FOR BID

DESCRIPTION OF REVISION:  
1

DRAWN BY: KLO  
CHECKED BY: JJ  
DATE: 10/27/2025  
PHASE: CD

PROJECT NO. 1925.014


IT IS A VIOLATION OF THE LAW FOR ANY PERSON TO MAKE UNAUTHORIZED ALTERATIONS OR ADDITIONS TO PLANS DRAWN BY A LICENSED ARCHITECT, ENGINEER, PROFESSIONAL SURVEYOR OR PROFESSIONAL LANDSCAPE ARCHITECT.

**HUNT ENGINEERS ARCHITECTS | SURVEYORS**  
HORSEHEADS, NY 607-268-1000 | PROSPECTS, NY 562-637-7668 | TOWANDA, PA 570-265-4668  
BINGHAMTON, NY 607-798-8881 | ALBANY, NY 607-798-8881  
WWW.HUNTEAS.COM  
NY CERTIFICATE NO. 0016250 | PA CERTIFICATE NO. TSC22020131464-1

**INTERIOR ELEVATIONS & CASEWORK SCHEDULE**  
**2025 CAPITAL IMPROVEMENTS PROJECT**  
**HAMMONDSPORT CENTRAL SCHOOL DISTRICT**  
8272 MAIN STREET HAMMONDSPORT, NEW YORK, 14840



**MB-A5.5**  
PROJECT NO. 1925.014

SET #: MB-57-26-01-04-02-02-03-03-04-05-06-07-29-01-04-05-03-08

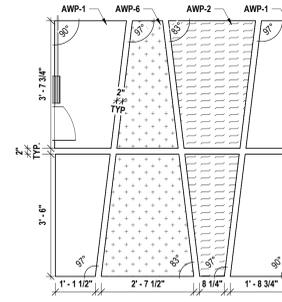


5 GYMNASIUM - TYPICAL WALL PANELS  
1/2" = 1'-0"


**GYMNASIUM FINISH LEGEND**

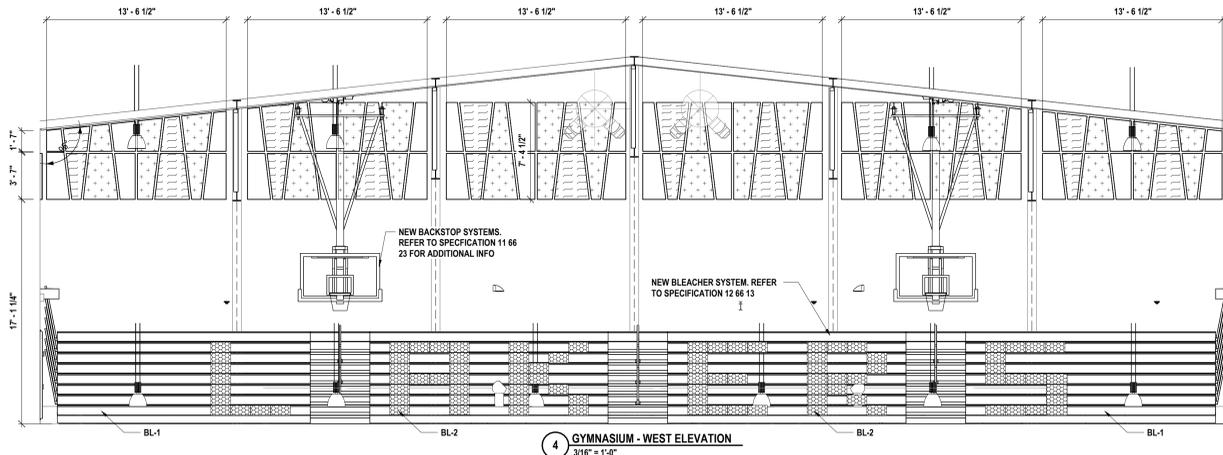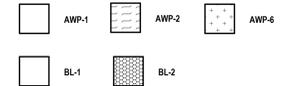


4 GYMNASIUM - WEST ELEVATION  
3/16" = 1'-0"

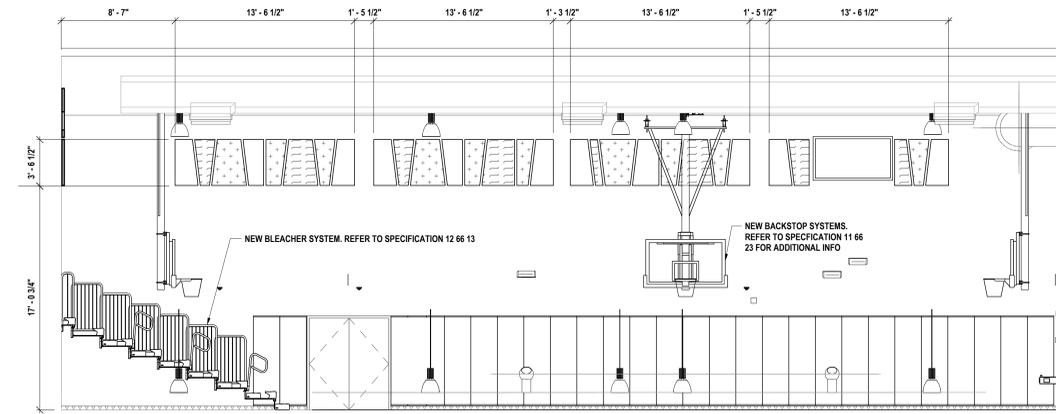


3 GYMNASIUM - NORTH ELEVATION  
3/16" = 1'-0"

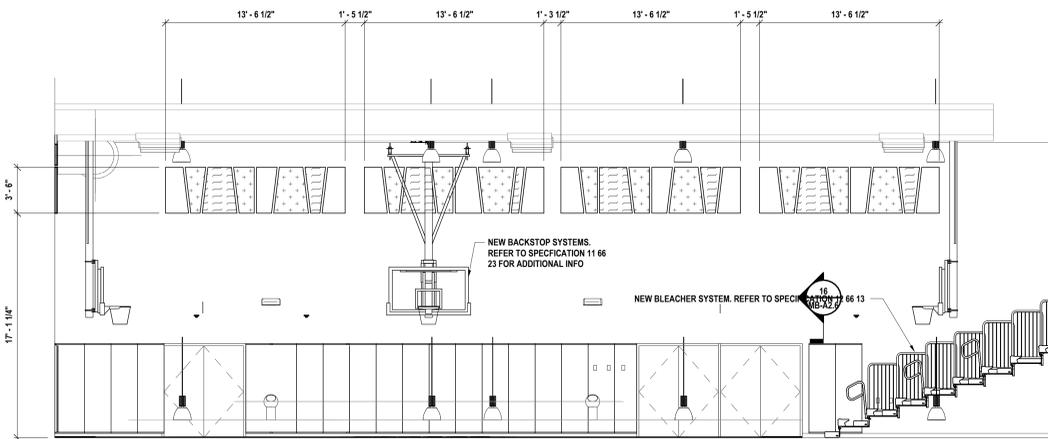

2 GYMNASIUM - SOUTH ELEVATION  
3/16" = 1'-0"

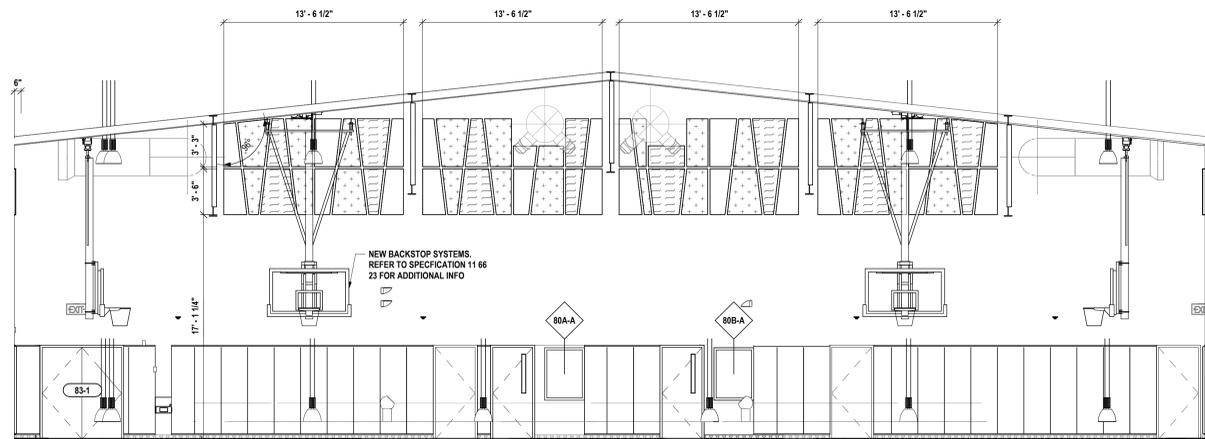

1 GYMNASIUM - EAST ELEVATION  
3/16" = 1'-0"

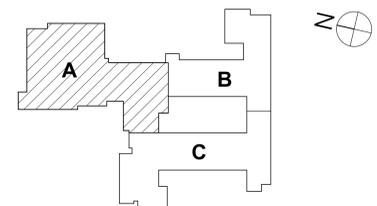

KEY PLAN

DATE:	10/27/2025	DESCRIPTION OF REVISION:	ISSUE FOR BID
#	1		

**HUNT ENGINEERS ARCHITECTS | SURVEYORS**  
 HORSEHEADS, NY 607-268-1000  
 ROCHESTER, NY 585-637-7668  
 BINGHAMTON, NY 607-798-8881  
 WWW.HUNTEAS.COM  
 NY CERTIFICATE NO. 0016250 PA CERTIFICATE NO. TSC220313464-1

**GYMNASIUM INTERIOR ELEVATIONS**  
**2025 CAPITAL IMPROVEMENTS PROJECT**  
**HAMMONDSPORT CENTRAL SCHOOL DISTRICT**  
 8272 MAIN STREET HAMMONDSPORT, NEW YORK, 14840

**MB-A5.6**  
 PROJECT NO: 1925.014


SED #: MB-21-28-01-04-02-02-03-06; 07-29-01-04-03-03-08

#	DOOR					ASSEMBLY LABEL	GLAZING		HDWR SET	FRAME			DETAIL	NOTES	
	TYPE	SIZE	THICK.	MATL.	FINISH		MATL.	MARKING		TYPE	MATL.	FINISH			HEAD
79A-1	2	3'-0" x 7'-0"	1 3/4"	HM	PNT	45 MIN	FRG-1		A	HM	PNT	3MB-A6.1	2MB-A6.1	1MB-A6.1	
79C-1	1	3'-0" x 7'-0"	1 3/4"	HM	PNT	45 MIN			A	HM	PNT	3MB-A6.1	2MB-A6.1	1MB-A6.1	
80A-1	1	3'-0" x 7'-0"	1 3/4"	HM	PNT	45 MIN			A	HM	PNT	3MB-A6.1	2MB-A6.1	1MB-A6.1	
80B-1	2	3'-0" x 7'-0"	1 3/4"	HM	PNT	45 MIN			A	HM	PNT	3MB-A6.1	2MB-A6.1	1MB-A6.1	
83-1	4	PR @ 3'-0" x 7'-0"	1 3/4"	HM	PNT	45 MIN			D	HM	PNT	3MB-A6.1	2MB-A6.1	1MB-A6.1	
86-1	1	3'-0" x 7'-0"	1 3/4"	HM	PNT	45 MIN			A	HM	PNT	3MB-A6.1	2MB-A6.1	1MB-A6.1	
88A-1	1	3'-0" x 7'-0"	1 3/4"	HM	PNT	45 MIN			A	HM	PNT	3MB-A6.1	2MB-A6.1	1MB-A6.1	
88-1	2	3'-0" x 7'-0"	1 3/4"	HM	PNT	45 MIN	FRG-1		A	HM	PNT	3MB-A6.1	2MB-A6.1	1MB-A6.1	
89-2	2	3'-0" x 7'-0"	1 3/4"	HM	PNT	45 MIN	FRG-1		A	HM	PNT	3MB-A6.1	2MB-A6.1	1MB-A6.1	
89-3	6	8'-0" x 7'-0"	3/4"	STL	PNT	90 MIN			--	STL	STAINLESS	14MB-A6.1	15MB-A6.1	14MB-A6.1	OVERHEAD COILING FIRE DOOR. PROVIDE 4" SAFETY YELLOW FLOOR PAINT AT FLOOR TRANSITION AS PER SEED CODE.
89-4	6	6'-0" x 7'-0"	3/4"	STL	PNT	90 MIN			--	STL	STAINLESS	14MB-A6.1	15MB-A6.1	14MB-A6.1	OVERHEAD COILING FIRE DOOR. PROVIDE 4" SAFETY YELLOW FLOOR PAINT AT FLOOR TRANSITION AS PER SEED CODE.
89-5	6	3'-0" x 4'-0"	3/4"	STL	PNT	90 MIN			--	STL	STAINLESS	3MB-A4.1	16MB-A6.1	3MB-A4.1	COUNTER OVERHEAD COILING FIRE DOOR
93C-1	2	3'-0" x 7'-0"	1 3/4"	HM	PNT	45 MIN	FRG-1		A	HM	PNT	3MB-A6.1	2MB-A6.1	1MB-A6.1	
93C-2	9	3'-0" x 7'-0"	1 3/4"	HM	PNT	45 MIN	IG-A		A	HM	PNT	9MB-A6.1	10MB-A6.1	1MB-A6.1	
93C-4	5	PR @ 3'-0" x 7'-0"	1 3/4"	HM	PNT	45 MIN	IG-A		D	HM	PNT	9MB-A6.1	10MB-A6.1	1MB-A6.1	
94-1	6	7'-0" x 7'-0"	1 3/4"	HM	PNT	45 MIN			STL	GALVANIZED				OVERHEAD TRACK DOOR	
94-2	8	7'-0" x 7'-0"	1 3/4"	HM	PNT	45 MIN			AL	ANOD.				FACE MOUNTED SLIDING TRACK DOOR	
129-1	1	3'-0" x 7'-0"	1 3/4"	HM	PNT	45 MIN			A	HM	PNT	3MB-A6.1	2MB-A6.1	1MB-A6.1	
129A-1	1	3'-0" x 7'-0"	1 3/4"	HM	PNT	45 MIN			A	HM	PNT	3MB-A6.1	2MB-A6.1	1MB-A6.1	
131-1	1	3'-0" x 7'-0"	1 3/4"	HM	PNT	45 MIN			A	HM	PNT	3MB-A6.1	2MB-A6.1	1MB-A6.1	
131A-1	1	3'-0" x 7'-0"	1 3/4"	HM	PNT	45 MIN			A	HM	PNT	3MB-A6.1	2MB-A6.1	1MB-A6.1	
134-1	3	3'-0" x 7'-0"	1 3/4"	HM	PNT	45 MIN	FRG-1		C	HM	PNT	6MB-A6.1	2MB-A6.1	1MB-A6.1	
134A-1	10	3'-0" x 7'-0"	1 3/4"	AL	ANOD.	45 MIN			G	AL	ANOD.	19MB-A6.1	18MB-A6.1	19MB-A6.1	FLUSH SLIDER DOOR
134B-1	10	3'-0" x 7'-0"	1 3/4"	AL	ANOD.	45 MIN			F	AL	ANOD.	19MB-A6.1	18MB-A6.1	19MB-A6.1	FLUSH SLIDER DOOR
134B-2	7	8'-0" x 7'-0"	1 3/4"	AL	ANOD.	45 MIN			G	AL	ANOD.	6MB-A6.6	5MB-A6.6	7MB-A6.6	DIRTT FOLDING LEAF WALL
134C-1	10	3'-0" x 7'-0"	1 3/4"	AL	ANOD.	45 MIN			F	AL	ANOD.	19MB-A6.1	18MB-A6.1	19MB-A6.1	FLUSH SLIDER DOOR
134D-1	10	3'-0" x 7'-0"	1 3/4"	AL	ANOD.	45 MIN			F	AL	ANOD.	19MB-A6.1	18MB-A6.1	19MB-A6.1	FLUSH SLIDER DOOR
134D-2	7	8'-0" x 7'-0"	1 3/4"	AL	ANOD.	45 MIN			G	AL	ANOD.	6MB-A6.6	5MB-A6.6	7MB-A6.6	DIRTT FOLDING LEAF WALL
134E-1	10	3'-0" x 7'-0"	1 3/4"	AL	ANOD.	45 MIN			G	AL	ANOD.	19MB-A6.1	18MB-A6.1	19MB-A6.1	FLUSH SLIDER DOOR
136-1	3	3'-0" x 7'-0"	1 3/4"	HM	PNT	45 MIN	FRG-1		B	HM	PNT	6MB-A6.1	2MB-A6.1	1MB-A6.1	
136-2	3	3'-0" x 7'-0"	1 3/4"	HM	PNT	45 MIN			B	HM	PNT	6MB-A6.1	2MB-A6.1	1MB-A6.1	
136A-1	3	3'-0" x 7'-0"	1 3/4"	HM	PNT	45 MIN			B	HM	PNT	6MB-A6.1	2MB-A6.1	1MB-A6.1	
136B-1	3	3'-0" x 7'-0"	1 3/4"	HM	PNT	45 MIN			B	HM	PNT	6MB-A6.1	2MB-A6.1	1MB-A6.1	
136C-1	3	3'-0" x 7'-0"	1 3/4"	HM	PNT	45 MIN			B	HM	PNT	6MB-A6.1	2MB-A6.1	1MB-A6.1	
136D-1	3	3'-0" x 7'-0"	1 3/4"	HM	PNT	45 MIN			B	HM	PNT	6MB-A6.1	2MB-A6.1	1MB-A6.1	
141-1	10	3'-0" x 7'-0"	1 3/4"	AL	ANOD.	45 MIN			H	AL	ANOD.	20MB-A6.1	17MB-A6.1	20MB-A6.1	OFFSET SLIDER DOOR
142-1	10	3'-0" x 7'-0"	1 3/4"	AL	ANOD.	45 MIN			H	AL	ANOD.	20MB-A6.1	17MB-A6.1	20MB-A6.1	OFFSET SLIDER DOOR
229-1	1	3'-0" x 7'-0"	1 3/4"	HM	PNT	45 MIN			A	HM	PNT	3MB-A6.1	2MB-A6.1	1MB-A6.1	
229A-1	1	3'-0" x 7'-0"	1 3/4"	HM	PNT	45 MIN			A	HM	PNT	3MB-A6.1	2MB-A6.1	1MB-A6.1	
229B-1	1	3'-0" x 7'-0"	1 3/4"	HM	PNT	45 MIN			A	HM	PNT	3MB-A6.1	2MB-A6.1	1MB-A6.1	
231-1	1	3'-0" x 7'-0"	1 3/4"	HM	PNT	45 MIN			A	HM	PNT	3MB-A6.1	2MB-A6.1	1MB-A6.1	
C11-1	5	PR @ 3'-10" x 7'-0"	1 3/4"	HM	PNT	45 MIN	FRG-1		D	HM	PNT	3MB-A6.1	2MB-A6.1	1MB-A6.1	
C11-2	5	PR @ 3'-10" x 7'-0"	1 3/4"	HM	PNT	45 MIN	FRG-1		D	HM	PNT	3MB-A6.1	2MB-A6.1	1MB-A6.1	
C-4-1	5	PR @ 3'-10" x 7'-0"	1 3/4"	HM	PNT	45 MIN	FRG-1		D	HM	PNT	3MB-A6.1	2MB-A6.1	1MB-A6.1	
C-4-2	5	PR @ 3'-10" x 7'-0"	1 3/4"	HM	PNT	45 MIN	FRG-1		D	HM	PNT	3MB-A6.1	2MB-A6.1	1MB-A6.1	
C-10-1	5	PR @ 3'-10" x 7'-0"	1 3/4"	HM	PNT	45 MIN	FRG-1		D	HM	PNT	3MB-A6.1	2MB-A6.1	1MB-A6.1	
E-4-1	5	PR @ 3'-0" x 8'-0"	1 3/4"	AL	ANOD.	45 MIN			D	AL	ANOD.	6MB-A6.1	8MB-A6.1	7MB-A6.1	STOREFRONT ASSEMBLY
E-4-2	5	PR @ 3'-0" x 8'-0"	1 3/4"	AL	ANOD.	45 MIN			D	AL	ANOD.	6MB-A6.1	8MB-A6.1	7MB-A6.1	STOREFRONT ASSEMBLY
E-4-3	4	PR @ 3'-0" x 7'-0"	1 3/4"	HM	PNT	45 MIN			D	HM	PNT	9MB-A6.1	10MB-A6.1	1MB-A6.1	
83-1-1	4	PR @ 3'-0" x 7'-0"	1 3/4"	HM	PNT	90 MIN	FRG-1		E	HM	PNT	6MB-A6.1	8MB-A6.1	1MB-A6.1	
83-2-1	4	PR @ 3'-0" x 7'-0"	1 3/4"	HM	PNT	90 MIN	FRG-1		E	HM	PNT	6MB-A6.1	8MB-A6.1	1MB-A6.1	



**GENERAL NOTES - DOOR**

- A CENTERLINE OF PANIC BARS SHALL BE 3'-4" ABOVE FINISH FLOOR. AND CENTERLINE OF LOCKSETS OF NEW DOORS SHALL BE 3'-4" ABOVE FINISH FLOOR.
- B NEW HOLLOW METAL FRAMES IN MASONRY OPENINGS TO HAVE 4" HEAD, NEW HOLLOW METAL FRAMES IN STUD OPENINGS TO HAVE 2" HEAD. VERIFY FRAME HEAD CONDITIONS WITH WALL TYPES.
- C COORDINATE ELECTRIFIED HARDWARE WITH OTHER PRIME CONTRACTORS FOR TYPE AND LOCATION.
- D CORRIDOR DOORS WITH VISION LITES ARE TO RECEIVE 30 MINUTE RATED GLAZING. TRANSOMS AND SIDE LITES ASSOCIATED WITH CORRIDOR DOORS TO RECEIVE 45 MINUTE RATED GLAZING.
- E REFER TO FINISH KEY AND ROOM FINISH SCHEDULE FOR ALL DOOR AND DOOR FRAME FINISHES.


**DOOR LEGEND:**

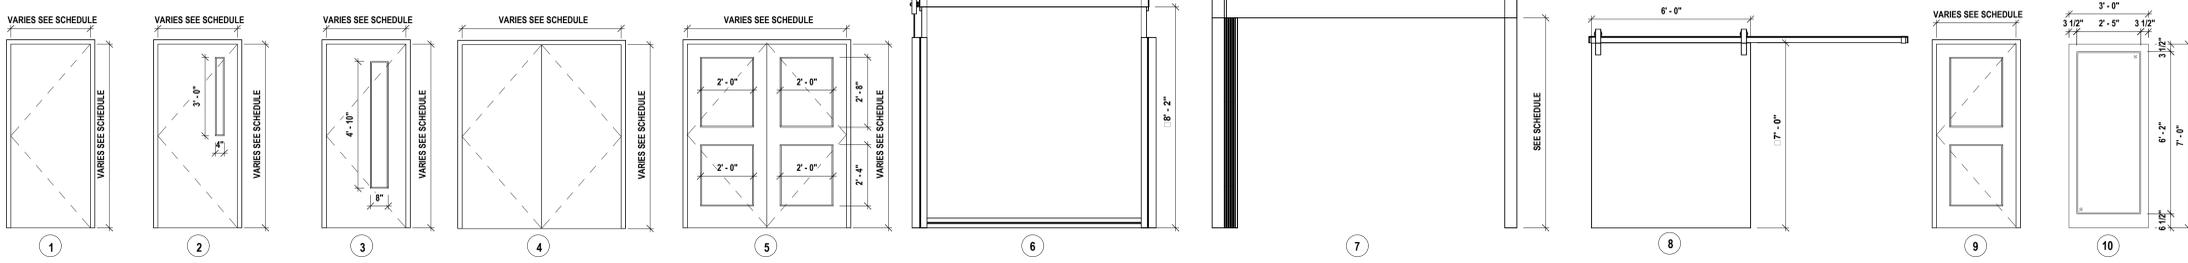


**DOOR FRAME LEGEND:**

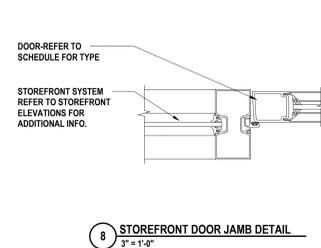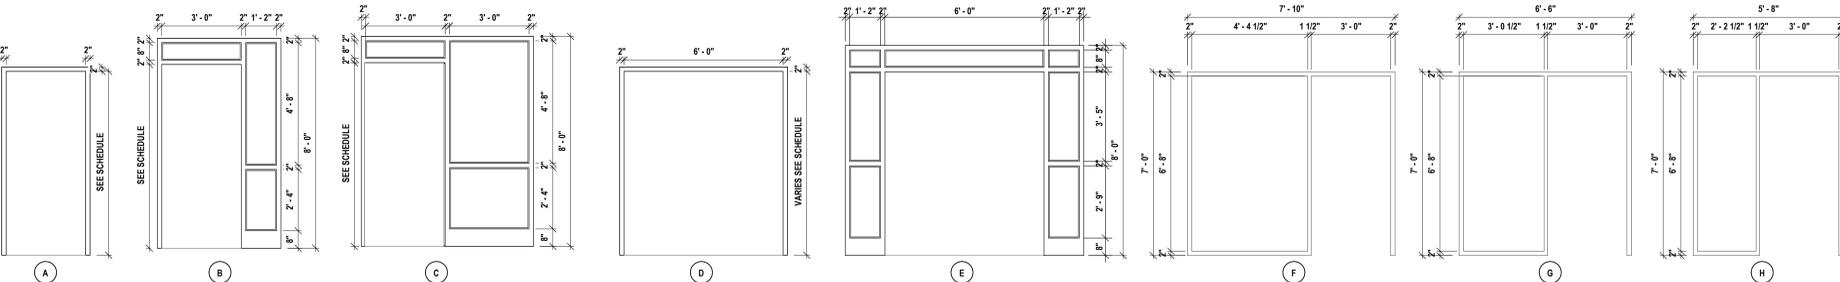


8 STOREFRONT DOOR JAMB DETAIL  
3" = 1'-0"

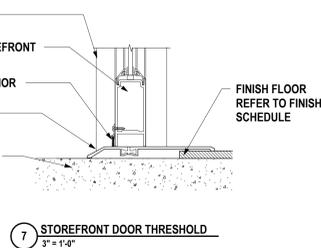


7 STOREFRONT DOOR THRESHOLD  
3" = 1'-0"

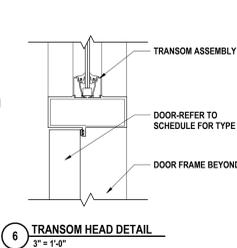


6 TRANSOM HEAD DETAIL  
3" = 1'-0"

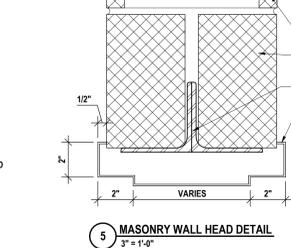


5 MASONRY WALL HEAD DETAIL  
3" = 1'-0"

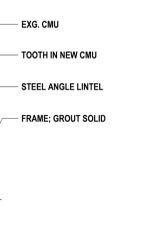


4 MASONRY WALL JAMB DETAIL  
3" = 1'-0"

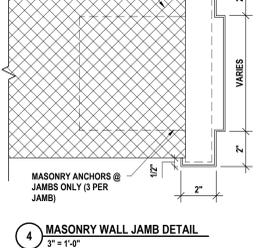


3 METAL STUD WALL HEAD DETAIL  
3" = 1'-0"

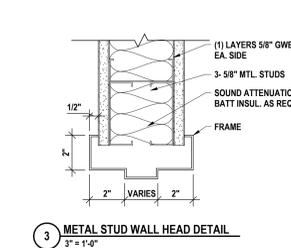

2 METAL STUD WALL JAMB DETAIL  
3" = 1'-0"

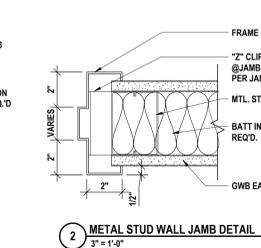


1 THRESHOLD DETAIL 'A'  
3" = 1'-0"

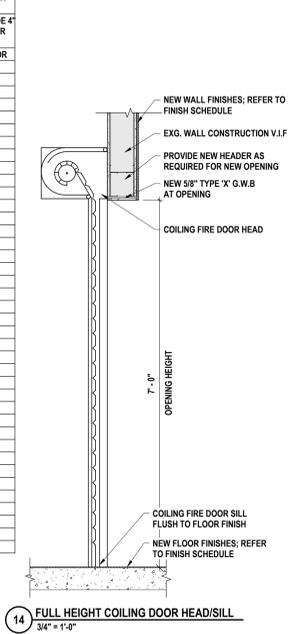


14 FULL HEIGHT COILING DOOR HEAD/SILL  
3/4" = 1'-0"


20 OFFSET SLIDER HEAD AND SILL DETAIL  
3" = 1'-0"

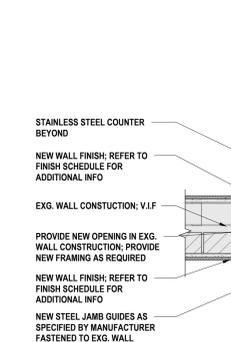


19 FLUSH SLIDER HEAD AND SILL DETAIL  
3" = 1'-0"

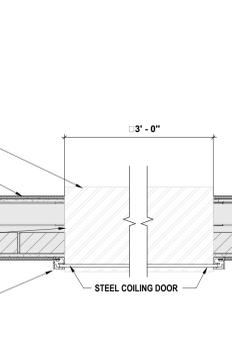


18 FLUSH SLIDER JAMB DETAIL  
3" = 1'-0"

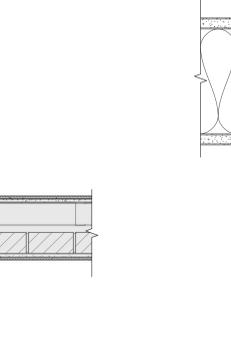


17 OFFSET SLIDER JAMB DETAIL  
3" = 1'-0"

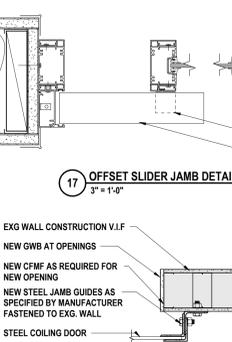

16 COILING COUNTER DOOR JAMBS  
1" = 1'-0"

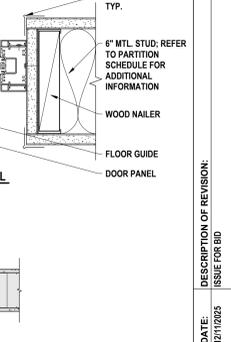

15 FULL HEIGHT COILING DOOR JAMB  
1" = 1'-0"

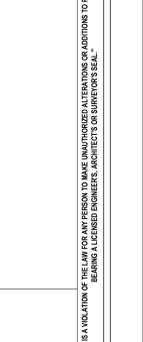

12 OVERHEAD DOOR HEAD DETAIL  
1" = 1'-0"



11 FACE MOUNTED SLIDING DOOR HEAD AND SILL DETAIL  
3" = 1'-0"



10 MASONRY WALL JAMB DETAIL 'B'  
3" = 1'-0"



9 MASONRY WALL HEAD DETAIL 'B'  
3" = 1'-0"



8 STOREFRONT DOOR THRESHOLD  
3" = 1'-0"



7 STOREFRONT DOOR THRESHOLD  
3" = 1'-0"


**HUNT ENGINEERS ARCHITECTS | SURVEYORS**  
 HORSEHEADS, NY 807-268-1000 | ROCHESTER, NY 585-337-7668 | TOWANDA, PA 570-265-4668  
 BINGHAMTON, NY 607-798-8881 | ALBANY, NY 607-798-8881 | WWW.HUNT-EAS.COM  
 NY CERTIFICATE NO. 0016250 | PA CERTIFICATE NO. RSC220313464-1

**DOOR SCHEDULE & TYPES**  
**2025 CAPITAL IMPROVEMENTS PROJECT**  
**HAMMONDSPORT CENTRAL SCHOOL DISTRICT**  
 8272 MAIN STREET HAMMONDSPORT, NEW YORK, 14840

**MB-A6.1**  
 PROJECT NO: 1925.014

WINDOW SCHEDULE										
NUMBER	FRAME		FRAME			DETAIL			NOTES	
	WINDOW TYPE	WIDTH	HEIGHT	MATERIAL	FINISH	GLAZING	HEAD	JAMB		SILL
78-A	6	4'-0"	5'-0"	AL	ANOD.	IG-A	5HS-A6.2	6HS-A6.2	5HS-A6.2	SLIDER
80A-A	1	3'-0"	4'-0"	AL	ANOD.	IG-A	5HS-A6.2	6HS-A6.2	5HS-A6.2	
80B-A	1	3'-0"	4'-0"	AL	ANOD.	IG-A	5HS-A6.2	6HS-A6.2	5HS-A6.2	
122-A	4	7'-0"	4'-6"	AL	ANOD.	IG-A	1HS-A6.2	2HS-A6.2	1HS-A6.2	SLIDER, ALTERNATE #4
122-B	1	10'-6"	4'-6"	AL	ANOD.	IG-A	1HS-A6.2	2HS-A6.2	1HS-A6.2	ALTERNATE #4
124-A	4	7'-0"	4'-6"	AL	ANOD.	IG-A	1HS-A6.2	2HS-A6.2	1HS-A6.2	ALTERNATE #4
124-B	3	10'-6"	4'-6"	AL	ANOD.	IG-A	1HS-A6.2	2HS-A6.2	1HS-A6.2	SLIDER, ALTERNATE #4
126-A	4	7'-0"	4'-6"	AL	ANOD.	IG-A	1HS-A6.2	2HS-A6.2	1HS-A6.2	ALTERNATE #4
126-D	3	10'-6"	4'-6"	AL	ANOD.	IG-A	1HS-A6.2	2HS-A6.2	1HS-A6.2	SLIDER, ALTERNATE #4
128-A	4	7'-0"	4'-6"	AL	ANOD.	IG-A	1HS-A6.2	2HS-A6.2	1HS-A6.2	ALTERNATE #4
128-B	3	10'-6"	4'-6"	AL	ANOD.	IG-A	1HS-A6.2	2HS-A6.2	1HS-A6.2	SLIDER, ALTERNATE #4
129-A	1	3'-6"	4'-6"	AL	ANOD.	IG-B	1HS-A6.2	2HS-A6.2	1HS-A6.2	ALTERNATE #6
130-A	4	7'-0"	4'-6"	AL	ANOD.	IG-A	1HS-A6.2	2HS-A6.2	1HS-A6.2	ALTERNATE #4
130-B	3	10'-6"	4'-6"	AL	ANOD.	IG-A	1HS-A6.2	2HS-A6.2	1HS-A6.2	SLIDER, ALTERNATE #4
131-A	1	3'-6"	4'-6"	AL	ANOD.	IG-B	1HS-A6.2	2HS-A6.2	1HS-A6.2	ALTERNATE #6
132-A	1	3'-6"	4'-6"	AL	ANOD.	IG-A	1HS-A6.2	2HS-A6.2	1HS-A6.2	ALTERNATE #4
132-B	4	6'-8"	4'-6"	AL	ANOD.	IG-A	1HS-A6.2	2HS-A6.2	1HS-A6.2	ALTERNATE #4
132B-A	4	7'-0"	4'-6"	AL	ANOD.	IG-A	1HS-A6.2	2HS-A6.2	1HS-A6.2	ALTERNATE #4
132B-B	1	3'-6"	4'-6"	AL	ANOD.	IG-A	1HS-A6.2	2HS-A6.2	1HS-A6.2	ALTERNATE #4
134-A	2	4'-3"	5'-3"	AL	ANOD.	IG-A	7HS-A6.2	8HS-A6.2	7HS-A6.2	
134-B	2	4'-3"	5'-3"	AL	ANOD.	IG-A	7HS-A6.2	8HS-A6.2	7HS-A6.2	
134-C	6	5'-0"	5'-0"	AL	ANOD.	IG-A	7HS-A6.2	8HS-A6.2	7HS-A6.2	SLIDER
134D-A	1	2'-6"	4'-6"	AL	ANOD.	IG-A	7HS-A6.2	8HS-A6.2	7HS-A6.2	
136A-A	6	5'-0"	5'-0"	AL	ANOD.	IG-A	9HS-A6.2	11HS-A6.2	9HS-A6.2	SLIDER
136A-B	1	2'-6"	5'-3"	AL	ANOD.	IG-A	9HS-A6.2	10HS-A6.2	9HS-A6.2	
136B-A	6	5'-0"	5'-0"	AL	ANOD.	IG-A	9HS-A6.2	11HS-A6.2	9HS-A6.2	SLIDER
136B-B	1	2'-6"	5'-3"	AL	ANOD.	IG-A	9HS-A6.2	10HS-A6.2	9HS-A6.2	
136C-A	6	5'-0"	5'-0"	AL	ANOD.	IG-A	9HS-A6.2	11HS-A6.2	9HS-A6.2	SLIDER
136C-B	1	2'-6"	5'-3"	AL	ANOD.	IG-A	9HS-A6.2	10HS-A6.2	9HS-A6.2	
136D-A	1	2'-6"	4'-0"	AL	ANOD.	IG-A	7HS-A6.2	8HS-A6.2	7HS-A6.2	SLIDER
136D-B	1	2'-6"	4'-0"	AL	ANOD.	IG-A	7HS-A6.2	8HS-A6.2	7HS-A6.2	SLIDER
139-A	1	4'-3"	3'-11"	AL	ANOD.	IG-A	9HS-A6.2	10HS-A6.2	9HS-A6.2	
139-B	1	4'-3"	3'-11"	AL	ANOD.	IG-A	9HS-A6.2	10HS-A6.2	9HS-A6.2	
139-C	1	4'-3"	3'-11"	AL	ANOD.	IG-A	9HS-A6.2	10HS-A6.2	9HS-A6.2	
222-A	4	7'-0"	4'-6"	AL	ANOD.	IG-A	1HS-A6.2	2HS-A6.2	1HS-A6.2	ALTERNATE #5
222-D	1	10'-6"	4'-6"	AL	ANOD.	IG-A	1HS-A6.2	2HS-A6.2	1HS-A6.2	ALTERNATE #5
224-A	4	7'-0"	4'-6"	AL	ANOD.	IG-A	1HS-A6.2	2HS-A6.2	1HS-A6.2	ALTERNATE #5
224-D	3	10'-6"	4'-6"	AL	ANOD.	IG-A	1HS-A6.2	2HS-A6.2	1HS-A6.2	ALTERNATE #5
226-A	4	7'-0"	4'-6"	AL	ANOD.	IG-A	1HS-A6.2	2HS-A6.2	1HS-A6.2	ALTERNATE #5
226-D	3	10'-6"	4'-6"	AL	ANOD.	IG-A	1HS-A6.2	2HS-A6.2	1HS-A6.2	ALTERNATE #5
228-A	4	7'-0"	4'-6"	AL	ANOD.	IG-A	1HS-A6.2	2HS-A6.2	1HS-A6.2	ALTERNATE #5
228-B	3	10'-6"	4'-6"	AL	ANOD.	IG-A	1HS-A6.2	2HS-A6.2	1HS-A6.2	SLIDER, ALTERNATE #5
229-A	4	3'-6"	4'-6"	AL	ANOD.	IG-B	1HS-A6.2	2HS-A6.2	1HS-A6.2	ALTERNATE #7
232-A	4	7'-0"	4'-6"	AL	ANOD.	IG-A	1HS-A6.2	2HS-A6.2	1HS-A6.2	ALTERNATE #5
232-B	4	6'-8"	4'-6"	AL	ANOD.	IG-A	1HS-A6.2	2HS-A6.2	1HS-A6.2	ALTERNATE #5
232-C	4	6'-8"	4'-6"	AL	ANOD.	IG-A	1HS-A6.2	2HS-A6.2	1HS-A6.2	ALTERNATE #5
232-E	1	3'-6"	4'-6"	AL	ANOD.	IG-A	1HS-A6.2	2HS-A6.2	1HS-A6.2	ALTERNATE #5
233-A	5	3'-6"	5'-0"	AL	ANOD.	IG-A	3HS-A6.2	4HS-A6.2	3HS-A6.2	SINGLE HUNG, ALTERNATE #5
233-B	5	3'-6"	5'-0"	AL	ANOD.	IG-A	3HS-A6.2	4HS-A6.2	3HS-A6.2	SINGLE HUNG, ALTERNATE #5
E-4-A	7	3'-6"	4'-0"	AL	ANOD.	IG-A	13HS-A6.2	14HS-A6.2	13HS-A6.2	

**WINDOW LEGEND:**

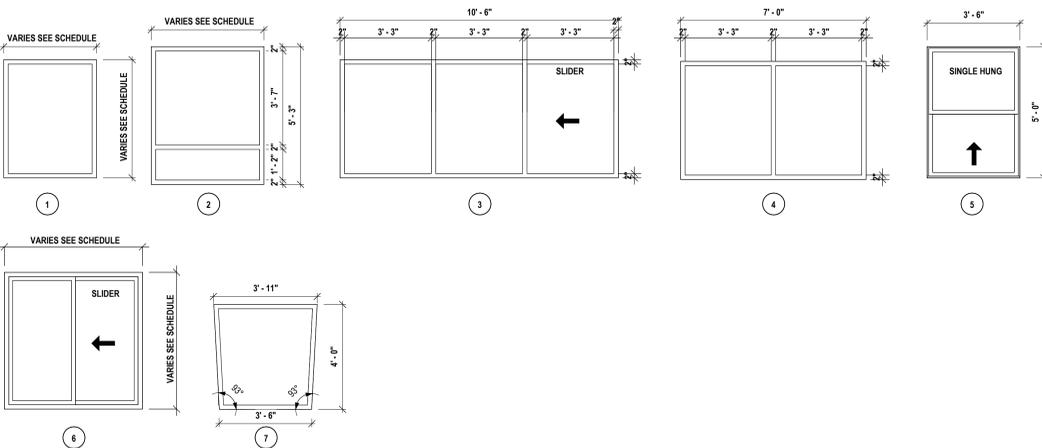


**GENERAL NOTES - WINDOW**

A ALL OPERABLE WINDOWS DESIGNATED AS RESCUE WINDOWS MUST BE OF ESCAPE WINDOW DIMENSIONS. PROVIDE A CLEAR UNOBSTRUCTED OPENING OF AT LEAST TWO (2) FEET IN THE LESSER DIMENSION, AND SIX (6) SQUARE FEET TOTAL AREA. EACH CLASSROOM TO HAVE AT LEAST ONE RESCUE WINDOW. ALL OPERATING HARDWARE TO BE INSTALLED AT A MAX. HEIGHT OF 54" ABOVE FINISH FLOOR. PROVIDE AN RESCUE WINDOW LABEL AS SPECIFIED.  
 B VERIFY IN FIELD ALL WINDOW MASONRY OPENINGS AND/OR ROUGH OPENINGS PRIOR TO ORDERING WINDOWS.


DRAWN BY: JLC  
 CHECKED BY: KJ  
 DATE: 10/27/2025  
 PHASE: CD

# DATE: 1 10/12/25  
 DESCRIPTION OF REVISION:  
 ISSUE FOR BID


**HUNT ENGINEERS ARCHITECTS | SURVEYORS**  
 HORSEHEADS, NY 807-268-1008  
 PROSPERITY, NY 562-337-7568  
 BINGHAMTON, NY 607-798-8881  
 WWW.HUNTEAS.COM  
 NY CERTIFICATE NO. 0016250 PA CERTIFICATE NO. 15C202031464-1

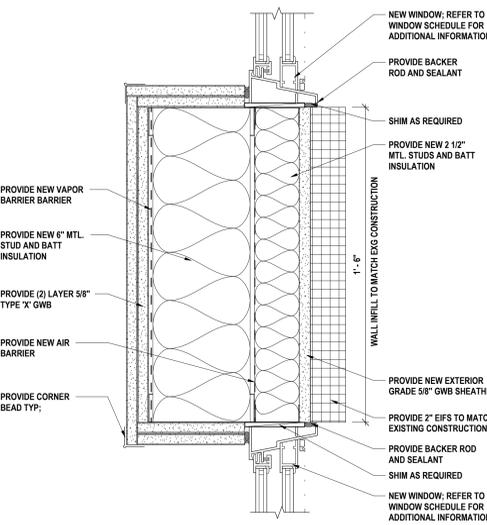


11 JAMB DETAIL - 136B-A & 136C-B  
 3" x 1'-0"

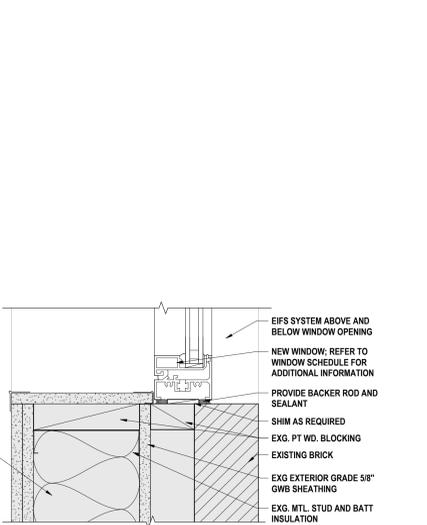


10 JAMB DETAIL @ BRICK WITH E.I.F.S ABOVE & BELOW  
 3" x 1'-0"

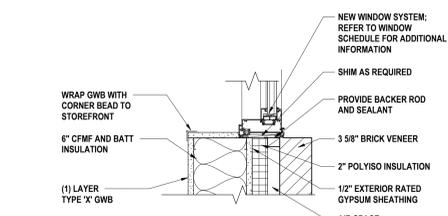


14 JAMB DETAIL @ NEW VESTIBULE  
 1 1/2" x 1'-0"

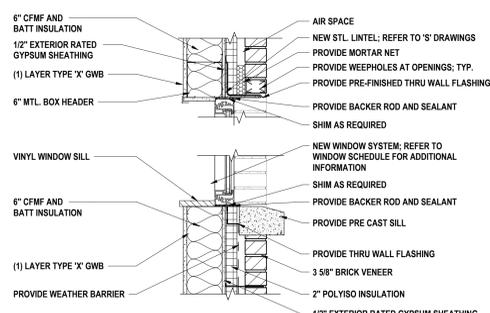


13 HEAD AND SILL DETAIL @ NEW VESTIBULE  
 1" x 1'-0"

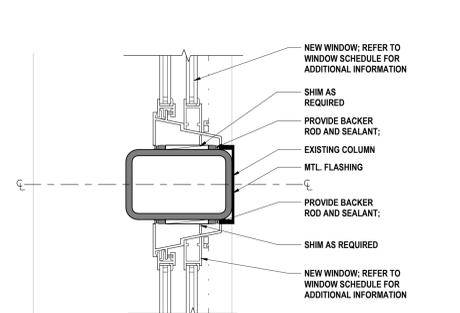


12 TYPICAL JAMB DETAIL @ COLUMNS  
 3" x 1'-0"

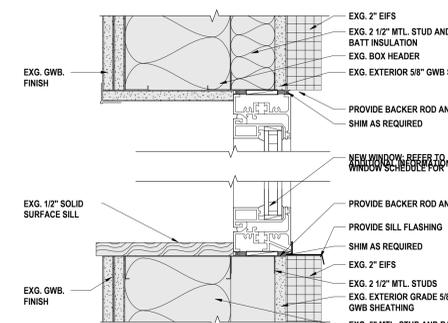


9 HEAD AND SILL DETAIL @ E.I.F.S  
 3" x 1'-0"

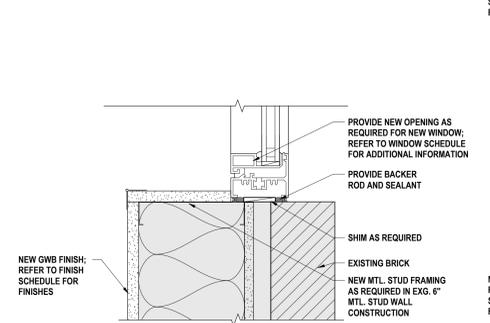


8 JAMB DETAIL @ NEW BRICK OPENING  
 3" x 1'-0"

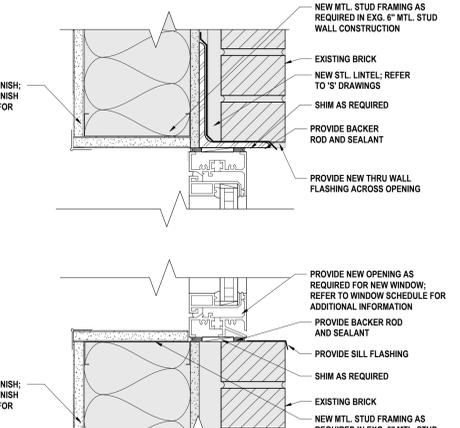


7 HEAD AND SILL DETAIL @ NEW BRICK OPENING  
 3" x 1'-0"

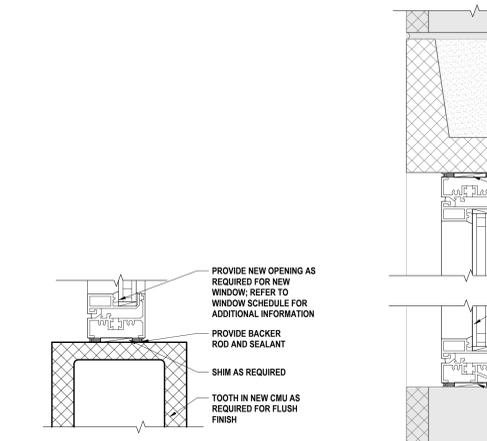


6 JAMB DETAIL @ CMU  
 3" x 1'-0"

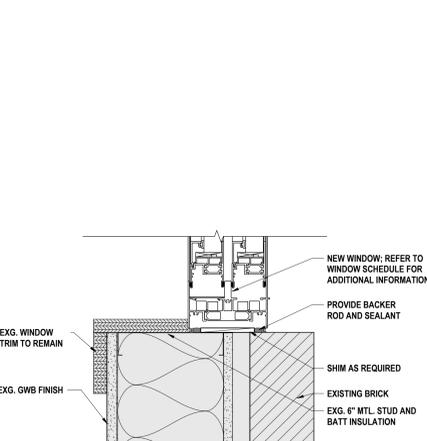


4 JAMB DETAIL @ EXISTING BRICK OPENING  
 3" x 1'-0"

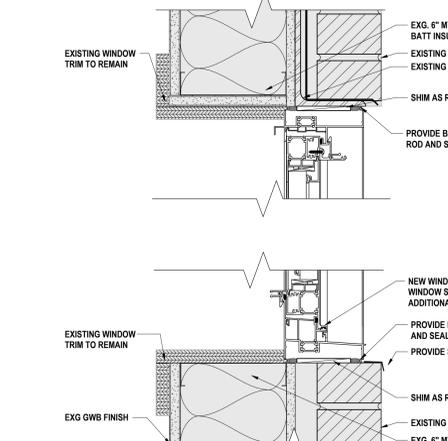

3 HEAD AND SILL DETAIL @ EXISTING BRICK OPENING  
 3" x 1'-0"

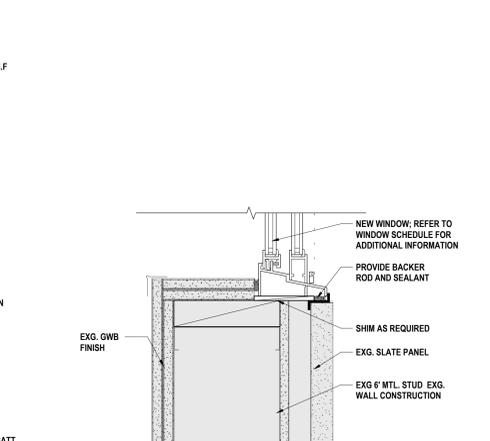

2 JAMB DETAIL @ SLATE PANELS  
 3" x 1'-0"

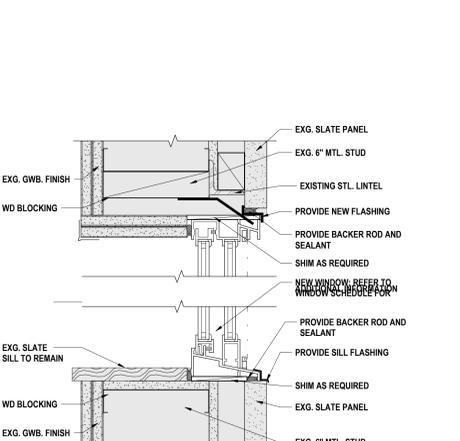


1 HEAD AND SILL DETAIL @ SLATE PANELS  
 3" x 1'-0"

**WINDOW SCHEDULE & TYPES**  
 2025 CAPITAL IMPROVEMENTS PROJECT  
 HAMMONDSPORT CENTRAL SCHOOL DISTRICT  
 8272 MAIN STREET HAMMONDSPORT, NEW YORK, 14840


**MB-A6.2**  
 PROJECT NO: 1925.014






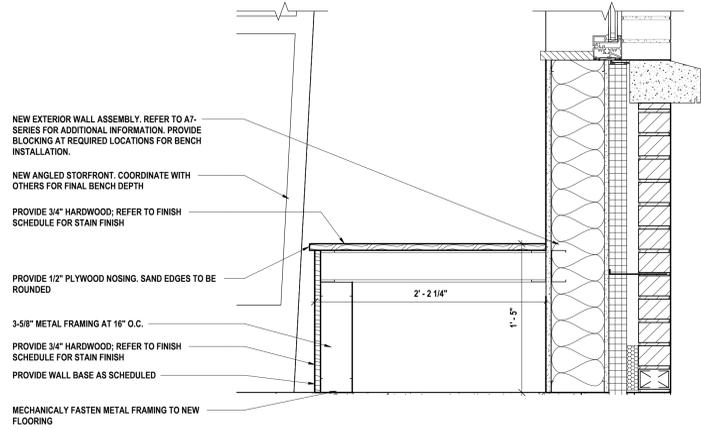


13 BENCH CONSTRUCTION DETAIL AT ENTRY E-4  
1 1/2" = 1'-0"

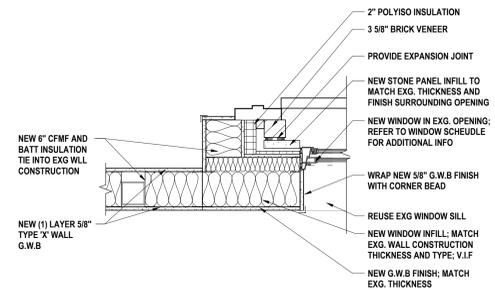


11 WALL CONNECTION AT NEW ENTRY  
1" = 1'-0"

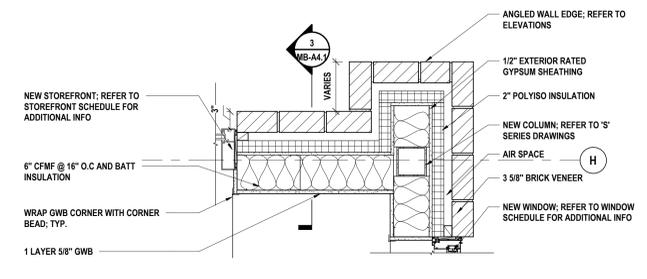


10 CANOPY WALL JOIN DETAIL  
1" = 1'-0"

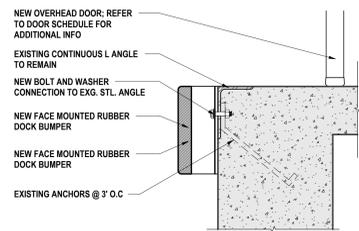


9 LOADING DOCK BUMPER DETAIL  
1 1/2" = 1'-0"

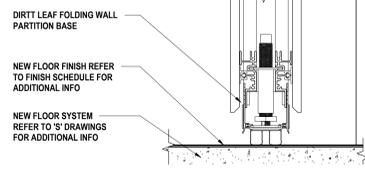


8 FOLDING PARTITION BASE DETAIL  
3" = 1'-0"

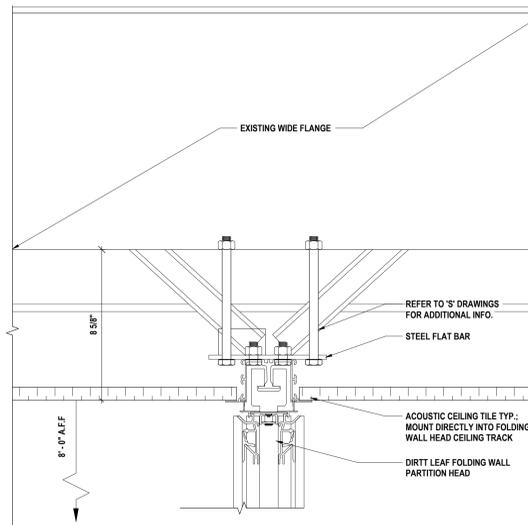


7 FOLDING PARTITION HEAD DETAIL  
3" = 1'-0"

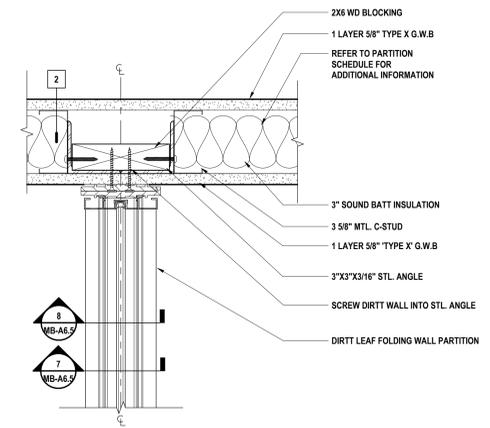


6 FOLDING PARTITION WALL CONNECTION DETAIL  
3" = 1'-0"

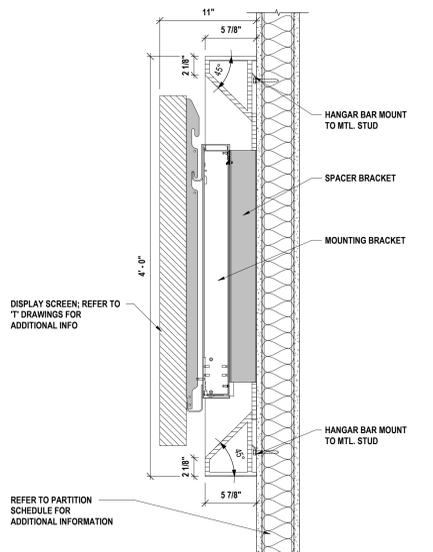


5 DISPLAY SCREEN ACOUSTIC HOOD BOX MOUNTING DETAIL  
1 1/2" = 1'-0"

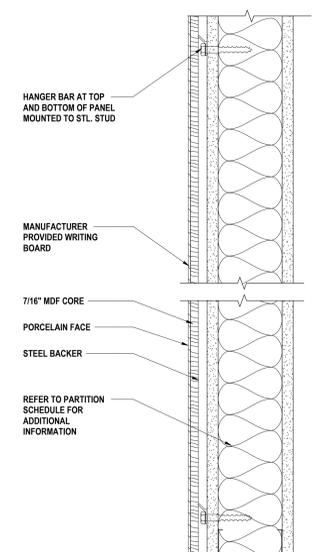


4 MARKERBOARD MOUNTING DETAIL  
3" = 1'-0"

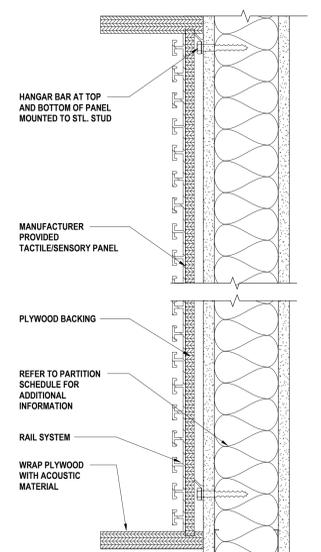

3 CUBBY MOUNTING DETAIL  
3" = 1'-0"

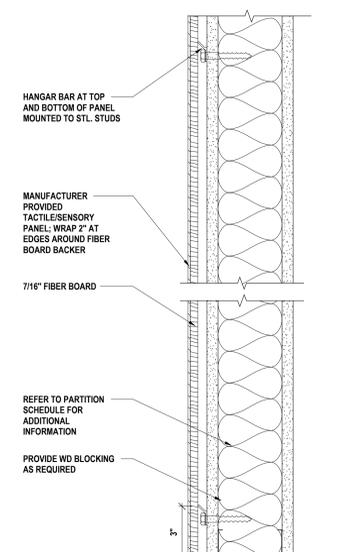

2 TACTILE/SENSORY PANEL MOUNTING DETAIL  
3" = 1'-0"

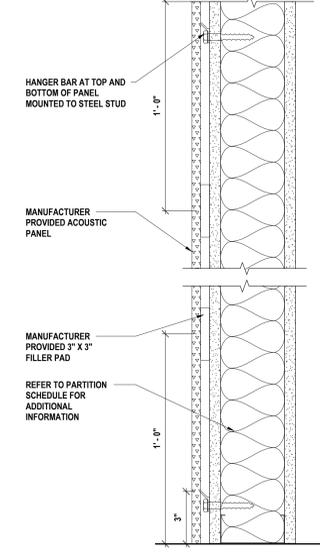

1 ACOUSTIC PANEL MOUNTING DETAIL  
3" = 1'-0"

DRAWN BY: K.L.G.  
CHECKED BY: J.J.  
DATE: 10/27/2025  
PHASE: CD

#	DATE	DESCRIPTION OF REVISION
1	10/10/2025	ISSUE FOR BID


**HUNT ENGINEERS ARCHITECTS | SURVEYORS**  
 HORSEHEADS, NY 807-858-1000 | ROCKY HILLS, CT 860-765-7668 | TOMAHAWK, PA 610-265-4668  
 BINGHAMTON, NY 807-798-8881 | ALBANY, NY 807-798-8881  
 WWW.HUNT-EAS.COM  
 NY CERTIFICATE NO. 0016250 | PA CERTIFICATE NO. TSC2202031464-1

**PLAN DETAILS**  
 2025 CAPITAL IMPROVEMENTS PROJECT  
 HAMMONDSPORT CENTRAL SCHOOL DISTRICT  
 8272 MAIN STREET HAMMONDSPORT, NEW YORK, 14840

MB-A6.5  
 PROJECT NO. 1925.014

SED #: MB-57-28-01-04-02-025 BKG: 57-28-01-04-04-5-003-008




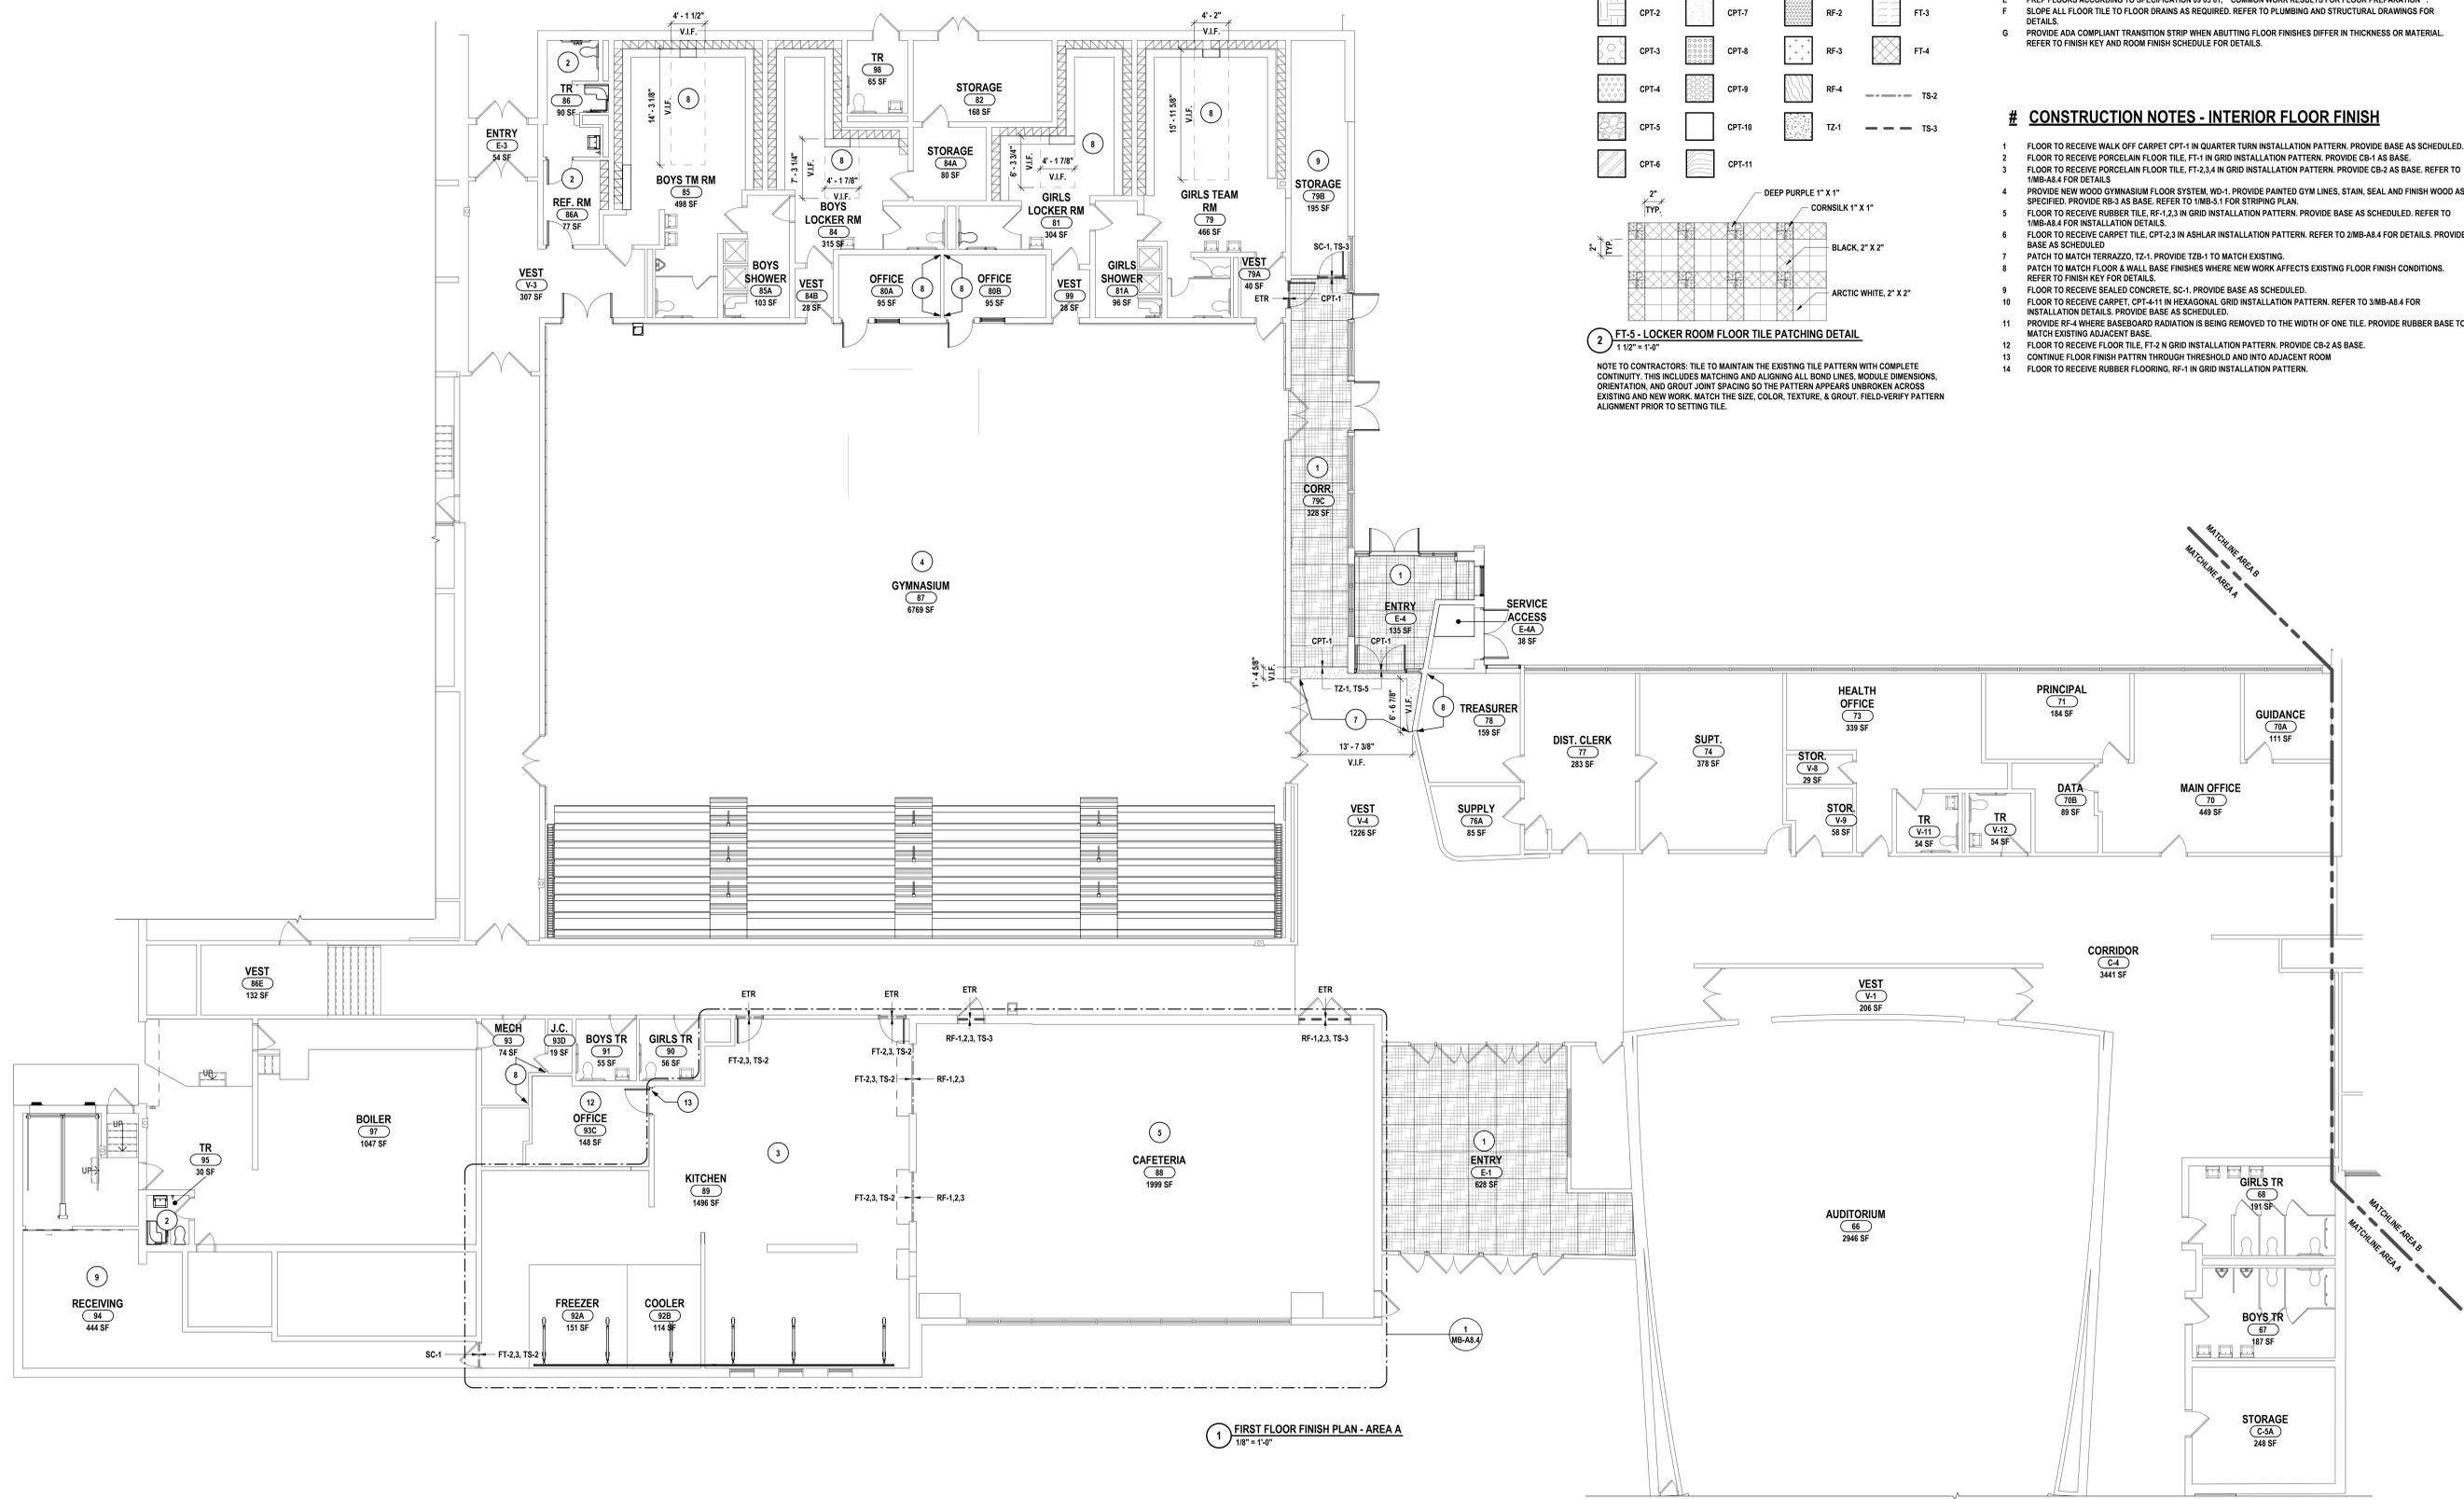

1 FIRST FLOOR FINISH PLAN - AREA A  
1/8" = 1'-0"

**FLOOR FINISH LEGEND**

CPT-1	CPT-7	RF-1	FT-2
CPT-2	CPT-8	RF-2	FT-3
CPT-3	CPT-9	RF-3	FT-4
CPT-4	CPT-10	RF-4	TS-2
CPT-5	CPT-11	TZ-1	TS-3
CPT-6			

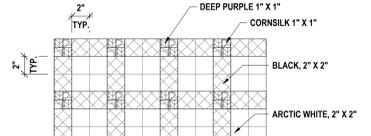

2 FT-5 - LOCKER ROOM FLOOR TILE PATCHING DETAIL  
1 1/2" = 1'-0"

NOTE TO CONTRACTORS: TILE TO MAINTAIN THE EXISTING TILE PATTERN WITH COMPLETE CONTINUITY. THIS INCLUDES MATCHING AND ALIGNING ALL BOND LINES, MODULE DIMENSIONS, ORIENTATION, AND GROUT JOINT SPACING SO THE PATTERN APPEARS UNBROKEN ACROSS EXISTING AND NEW WORK. MATCH THE SIZE, COLOR, TEXTURE, & GROUT. FIELD-VERIFY PATTERN ALIGNMENT PRIOR TO SETTING TILE.

**GENERAL NOTES - INTERIOR FLOOR FINISH:**

- A ALL FLOOR FINISHES SHALL BE INSTALLED ABUTTING NEW BUILT-IN CASEWORK UNLESS NOTED OTHERWISE ON FLOOR FINISH PLANS, EVEN WHEN NOT SHOWN ON FLOOR FINISH PLANS.
- B ALL FLOOR FINISHES TO TRANSITION AT CENTERLINE OF DOOR JAMB UNLESS OTHERWISE NOTED ON FLOOR FINISH PLANS.
- C FLOOR FINISHES TO EXTEND UNDERNEATH COUNTERTOPS WHERE FLOORING WOULD OTHERWISE BE EXPOSED.
- D REFER TO FINISH KEY AND ROOM FINISH SCHEDULE FOR ALL FINISHES NOT INDICATED ON FLOOR FINISH PLANS.
- E PREP FLOORS ACCORDING TO SPECIFICATION 09 05 01, "COMMON WORK RESULTS FOR FLOOR PREPARATION".
- F SLOPE ALL FLOOR TILE TO FLOOR DRAINS AS REQUIRED. REFER TO PLUMBING AND STRUCTURAL DRAWINGS FOR DETAILS.
- G PROVIDE ADA COMPLIANT TRANSITION STRIP WHEN ABUTTING FLOOR FINISHES DIFFER IN THICKNESS OR MATERIAL. REFER TO FINISH KEY AND ROOM FINISH SCHEDULE FOR DETAILS.


**# CONSTRUCTION NOTES - INTERIOR FLOOR FINISH**

- 1 FLOOR TO RECEIVE WALK OFF CARPET CPT-1 IN QUARTER TURN INSTALLATION PATTERN. PROVIDE BASE AS SCHEDULED.
- 2 FLOOR TO RECEIVE PORCELAIN FLOOR TILE, FT-1 IN GRID INSTALLATION PATTERN. PROVIDE CB-1 AS BASE.
- 3 FLOOR TO RECEIVE PORCELAIN FLOOR TILE, FT-2,3,4 IN GRID INSTALLATION PATTERN. PROVIDE CB-2 AS BASE. REFER TO 1MB-A8.4 FOR DETAILS.
- 4 PROVIDE NEW WOOD GYMNASIUM FLOOR SYSTEM, MD-1. PROVIDE PAINTED GYM LINES, STAIN, SEAL AND FINISH WOOD AS SPECIFIED. PROVIDE AB-3 AS BASE. REFER TO 1MB-A8.1 FOR STRIPING PLAN.
- 5 FLOOR TO RECEIVE RUBBER TILE, RF-1,2,3 IN GRID INSTALLATION PATTERN. PROVIDE BASE AS SCHEDULED. REFER TO 1MB-A8.4 FOR INSTALLATION DETAILS.
- 6 FLOOR TO RECEIVE CARPET TILE, CPT-2,3 IN ASHLAR INSTALLATION PATTERN. REFER TO 2MB-A8.4 FOR DETAILS. PROVIDE BASE AS SCHEDULED.
- 7 PATCH TO MATCH TERRAZZO, TZ-1. PROVIDE TZB-1 TO MATCH EXISTING.
- 8 PATCH TO MATCH FLOOR & WALL BASE FINISHES WHERE NEW WORK AFFECTS EXISTING FLOOR FINISH CONDITIONS. REFER TO FINISH KEY FOR DETAILS.
- 9 FLOOR TO RECEIVE SEALED CONCRETE, SC-1. PROVIDE BASE AS SCHEDULED.
- 10 FLOOR TO RECEIVE CARPET, CPT-4-11 IN HEXAGONAL GRID INSTALLATION PATTERN. REFER TO 3MB-A8.4 FOR INSTALLATION DETAILS. PROVIDE BASE AS SCHEDULED.
- 11 PROVIDE RF-4 WHERE BASEBOARD RADIATION IS BEING REMOVED TO THE WIDTH OF ONE TILE. PROVIDE RUBBER BASE TO MATCH EXISTING ADJACENT BASE.
- 12 FLOOR TO RECEIVE FLOOR TILE, FT-2 IN GRID INSTALLATION PATTERN. PROVIDE CB-2 AS BASE.
- 13 CONTINUE FLOOR FINISH PATTERN THROUGH THRESHOLD AND INTO ADJACENT ROOM.
- 14 FLOOR TO RECEIVE RUBBER FLOORING, RF-1 IN GRID INSTALLATION PATTERN.

DATE:	10/27/2025	JHR
CHECKED BY:	JJD	JHR
PHASE:	CD	JHR
DESCRIPTION OF REVISION:	ISSUE FOR BID	JHR
# DATE:	1 10/27/2025	JHR

**HUNT ENGINEERS ARCHITECTS | SURVEYORS**  
 HORSEHEADS, NY 607-268-1000  
 ROCHESTER, NY 585-337-7600  
 BINGHAMTON, NY 607-738-8881  
 WWW.HUNTEAM.COM  
 NY CERTIFICATE NO. 0016250 PA CERTIFICATE NO. TSC220313464-1

**FIRST FLOOR FINISH PLAN - AREA A**  
**2025 CAPITAL IMPROVEMENTS PROJECT**  
**HAMMONDSPORT CENTRAL SCHOOL DISTRICT**  
 8272 MAIN STREET HAMMONDSPORT, NEW YORK, 14840  
**MB-A8.1**  
 PROJECT NO: 1925.014

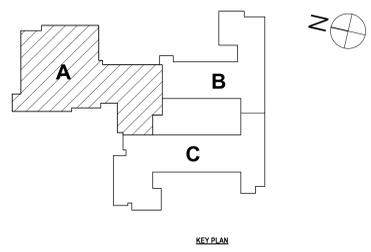

SED #: MB-21-28-01-04-02-02516; 07-29-01-04-03-208



**GENERAL NOTES - INTERIOR FLOOR FINISH:**

- A ALL FLOOR FINISHES SHALL BE INSTALLED ABUTTING NEW BUILT-IN CASEWORK UNLESS NOTED OTHERWISE ON FLOOR FINISH PLANS, EVEN WHEN NOT SHOWN ON FLOOR FINISH PLANS.
- B ALL FLOOR FINISHES TO TRANSITION AT CENTERLINE OF DOOR JAMB UNLESS OTHERWISE NOTED ON FLOOR FINISH PLANS.
- C FLOOR FINISHES TO EXTEND UNDERNEATH COUNTERTOPS WHERE FLOORING WOULD OTHERWISE BE EXPOSED. REFER TO FINISH KEY AND ROOM FINISH SCHEDULE FOR ALL FINISHES NOT INDICATED ON FLOOR FINISH PLANS.
- D PREP FLOORS ACCORDING TO SPECIFICATION 09 05 01, "COMMON WORK RESULTS FOR FLOOR PREPARATION".
- E SLOPE ALL FLOOR TILE TO FLOOR DRAINS AS REQUIRED. REFER TO PLUMBING AND STRUCTURAL DRAWINGS FOR DETAILS.
- F PROVIDE ADA COMPLIANT TRANSITION STRIP WHEN ABUTTING FLOOR FINISHES DIFFER IN THICKNESS OR MATERIAL. REFER TO FINISH KEY AND ROOM FINISH SCHEDULE FOR DETAILS.

**# CONSTRUCTION NOTES - INTERIOR FLOOR FINISH**

- 1 FLOOR TO RECEIVE WALK OFF CARPET CPT-1 IN QUARTER TURN INSTALLATION PATTERN. PROVIDE BASE AS SCHEDULED.
- 2 FLOOR TO RECEIVE PORCELAIN FLOOR TILE, FT-1 IN GRID INSTALLATION PATTERN. PROVIDE CB-1 AS BASE.
- 3 FLOOR TO RECEIVE PORCELAIN FLOOR TILE, FT-2,3,4 IN GRID INSTALLATION PATTERN. PROVIDE CB-2 AS BASE. REFER TO 1MB-A8.4 FOR DETAILS.
- 4 PROVIDE NEW WOOD GYMNASIUM FLOOR SYSTEM, WD-1. PROVIDE PAINTED GYM LINES, STAIN, SEAL AND FINISH WOOD AS SPECIFIED. PROVIDE RB-3 AS BASE. REFER TO 1MB-5.1 FOR STRIPING PLAN.
- 5 FLOOR TO RECEIVE RUBBER TILE, RF-1,2,3 IN GRID INSTALLATION PATTERN. PROVIDE BASE AS SCHEDULED. REFER TO 1MB-A8.4 FOR INSTALLATION DETAILS.
- 6 FLOOR TO RECEIVE CARPET TILE, CPT-2,3 IN ASHLAR INSTALLATION PATTERN. REFER TO 2MB-A8.4 FOR DETAILS. PROVIDE BASE AS SCHEDULED.
- 7 PATCH TO MATCH TERRAZZO, TZ-1. PROVIDE TZB-1 TO MATCH EXISTING.
- 8 PATCH TO MATCH FLOOR & WALL BASE FINISHES WHERE NEW WORK AFFECTS EXISTING FLOOR FINISH CONDITIONS. REFER TO FINISH KEY FOR DETAILS.
- 9 FLOOR TO RECEIVE SEALED CONCRETE, SC-1. PROVIDE BASE AS SCHEDULED.
- 10 FLOOR TO RECEIVE CARPET, CPT-4 IN HEXAGONAL GRID INSTALLATION PATTERN. REFER TO 3MB-A8.4 FOR INSTALLATION DETAILS. PROVIDE BASE AS SCHEDULED.
- 11 PROVIDE RF-4 WHERE BASEBOARD RADIATION IS BEING REMOVED TO THE WIDTH OF ONE TILE. PROVIDE RUBBER BASE TO MATCH EXISTING ADJACENT BASE.
- 12 FLOOR TO RECEIVE FLOOR TILE, FT-2 N GRID INSTALLATION PATTERN. PROVIDE CB-2 AS BASE.
- 13 CONTINUE FLOOR FINISH PATTERN THROUGH THRESHOLD AND INTO ADJACENT ROOM.
- 14 FLOOR TO RECEIVE RUBBER FLOORING, RF-1 IN GRID INSTALLATION PATTERN.


DRAWN BY:	JHR
CHECKED BY:	JDC
DATE:	10/27/2025
PHASE:	CD

#	DATE	DESCRIPTION OF REVISION: ISSUE FOR BID
1	10/10/2025	


**HUNT ENGINEERS ARCHITECTS | SURVEYORS**  
 HORSEHEADS, NY 607-458-1000  
 ROCKY HILLS, NY 562-337-7668  
 BINGHAMTON, NY 607-798-8881  
 ALBANY, NY 607-798-1801  
 WWW.HUNTEAS.COM  
 NY CERTIFICATE NO. 0016250 PA CERTIFICATE NO. TSC22020131464-1

**SECOND FLOOR FINISH PLAN - AREA B**  
 2025 CAPITAL IMPROVEMENTS PROJECT  
 HAMMONDSPORT CENTRAL SCHOOL DISTRICT  
 8272 MAIN STREET HAMMONDSPORT, NEW YORK, 14840

**MB-A8.3**  
 PROJECT NO: 1925.014

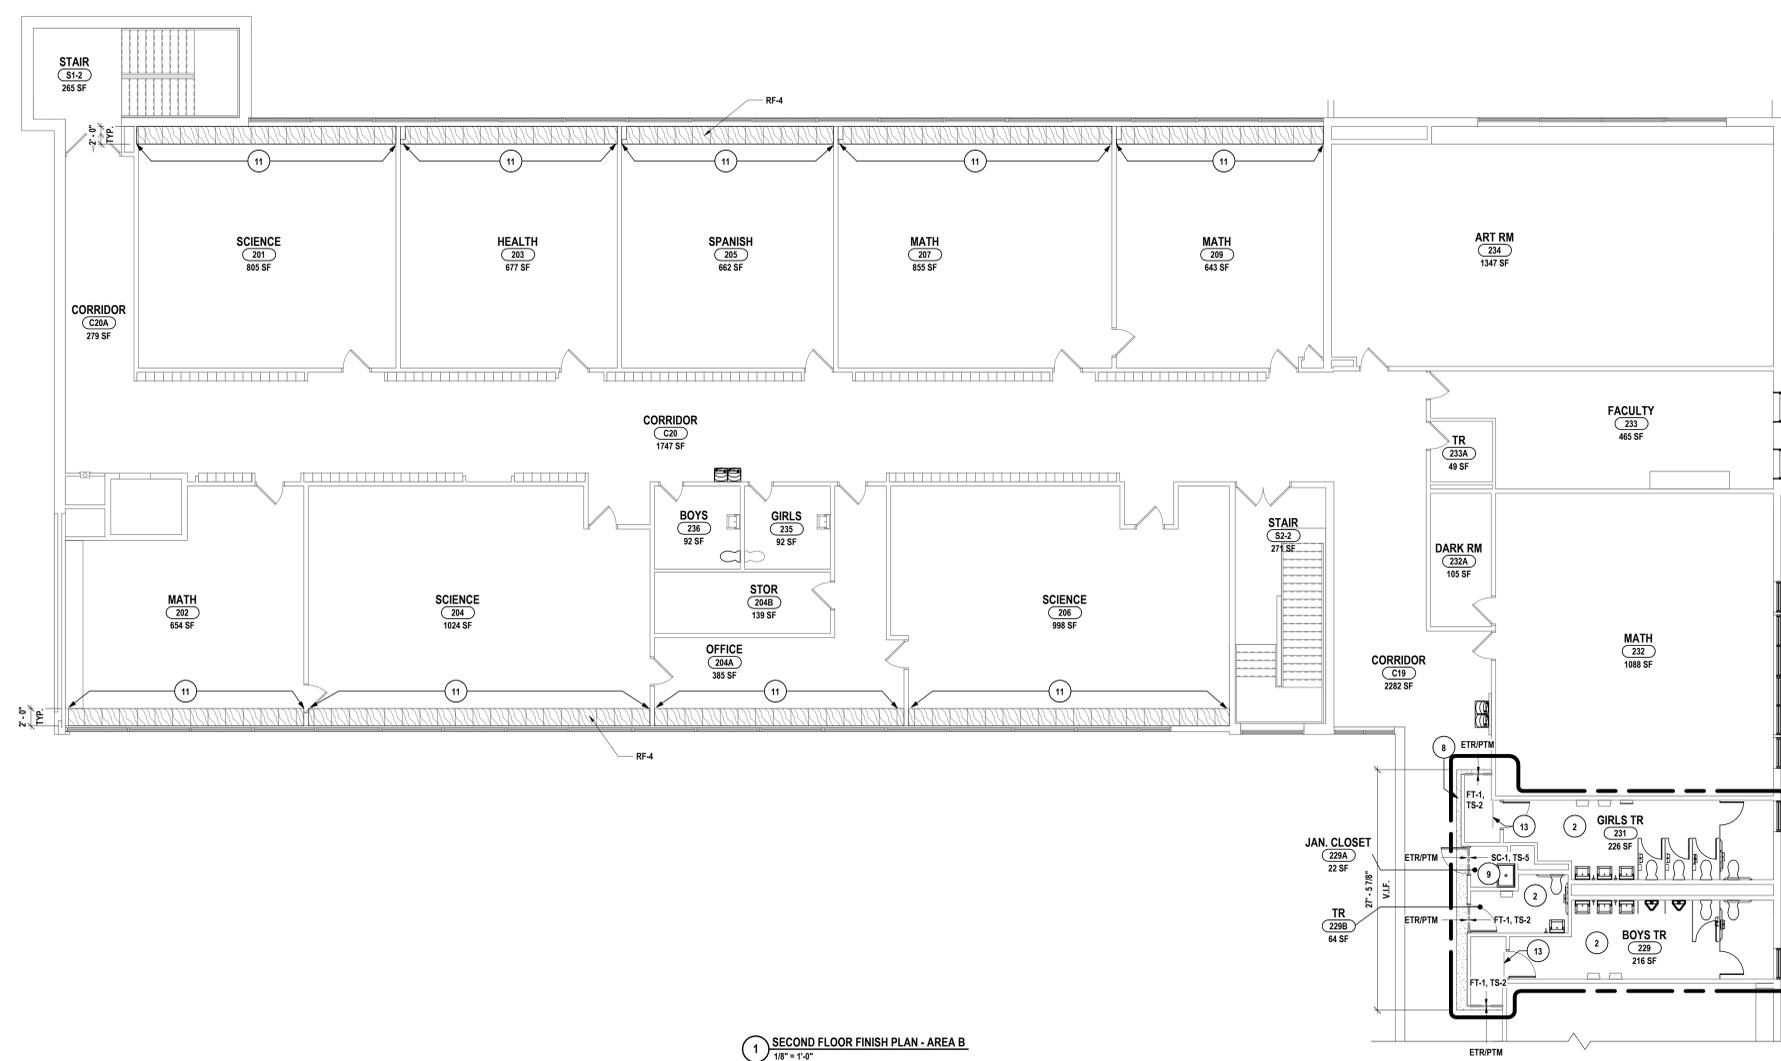


1 SECOND FLOOR FINISH PLAN - AREA B  
 1/8" = 1'-0"

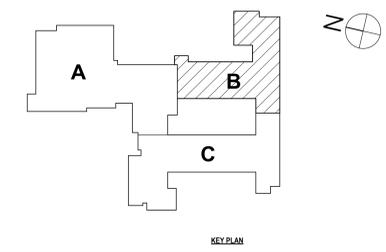


SET #: MB-17-28-01-04-02-02-03-06-07-28-01-04-03-03-08


IT IS A VIOLATION OF THE LAW FOR ANY PERSON TO MAKE UNAUTHORIZED ALTERATIONS OR ADDITIONS TO PLANS DRAWN BY LICENSED ENGINEERS, ARCHITECTS OR SURVEYORS.

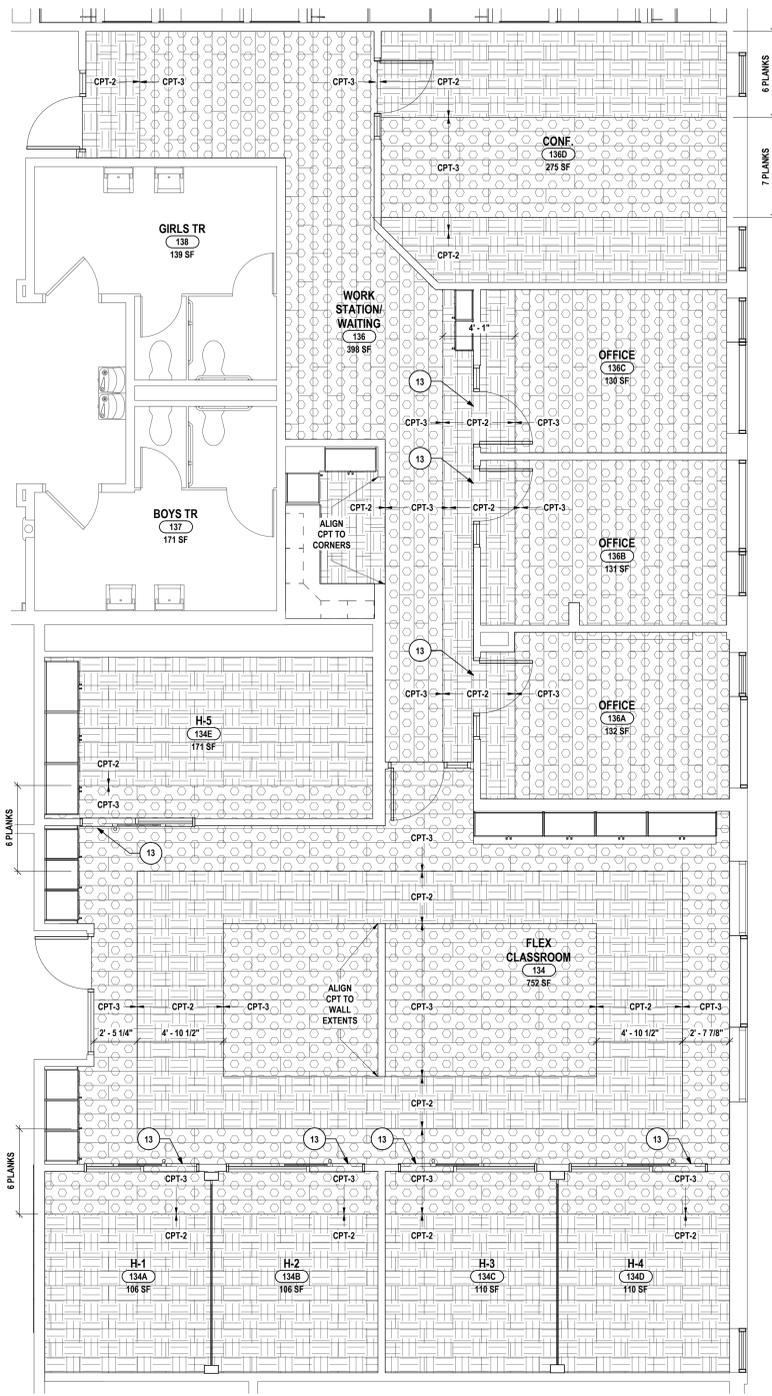

2 ENLARGED STUDENT SUPPORT SERVICES SUITE FLOOR FINISH PLAN  
1/4" = 1'-0"

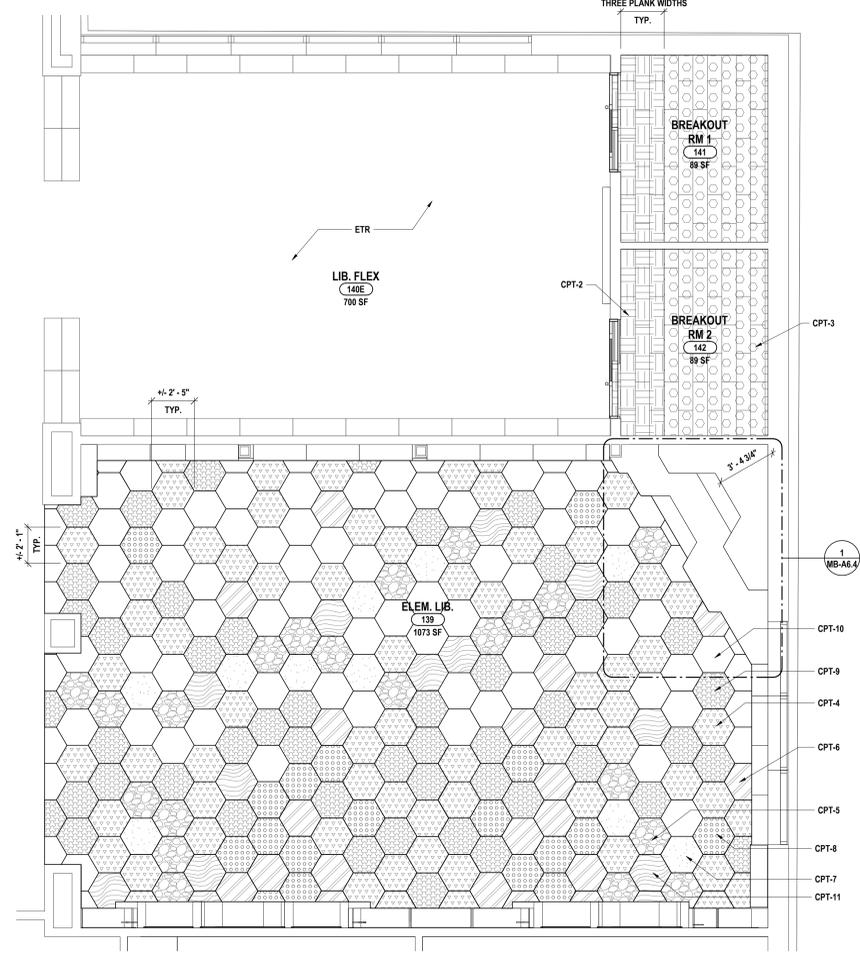

3 ENLARGED LIBRARY FLOOR FINISH PLAN  
1/4" = 1'-0"

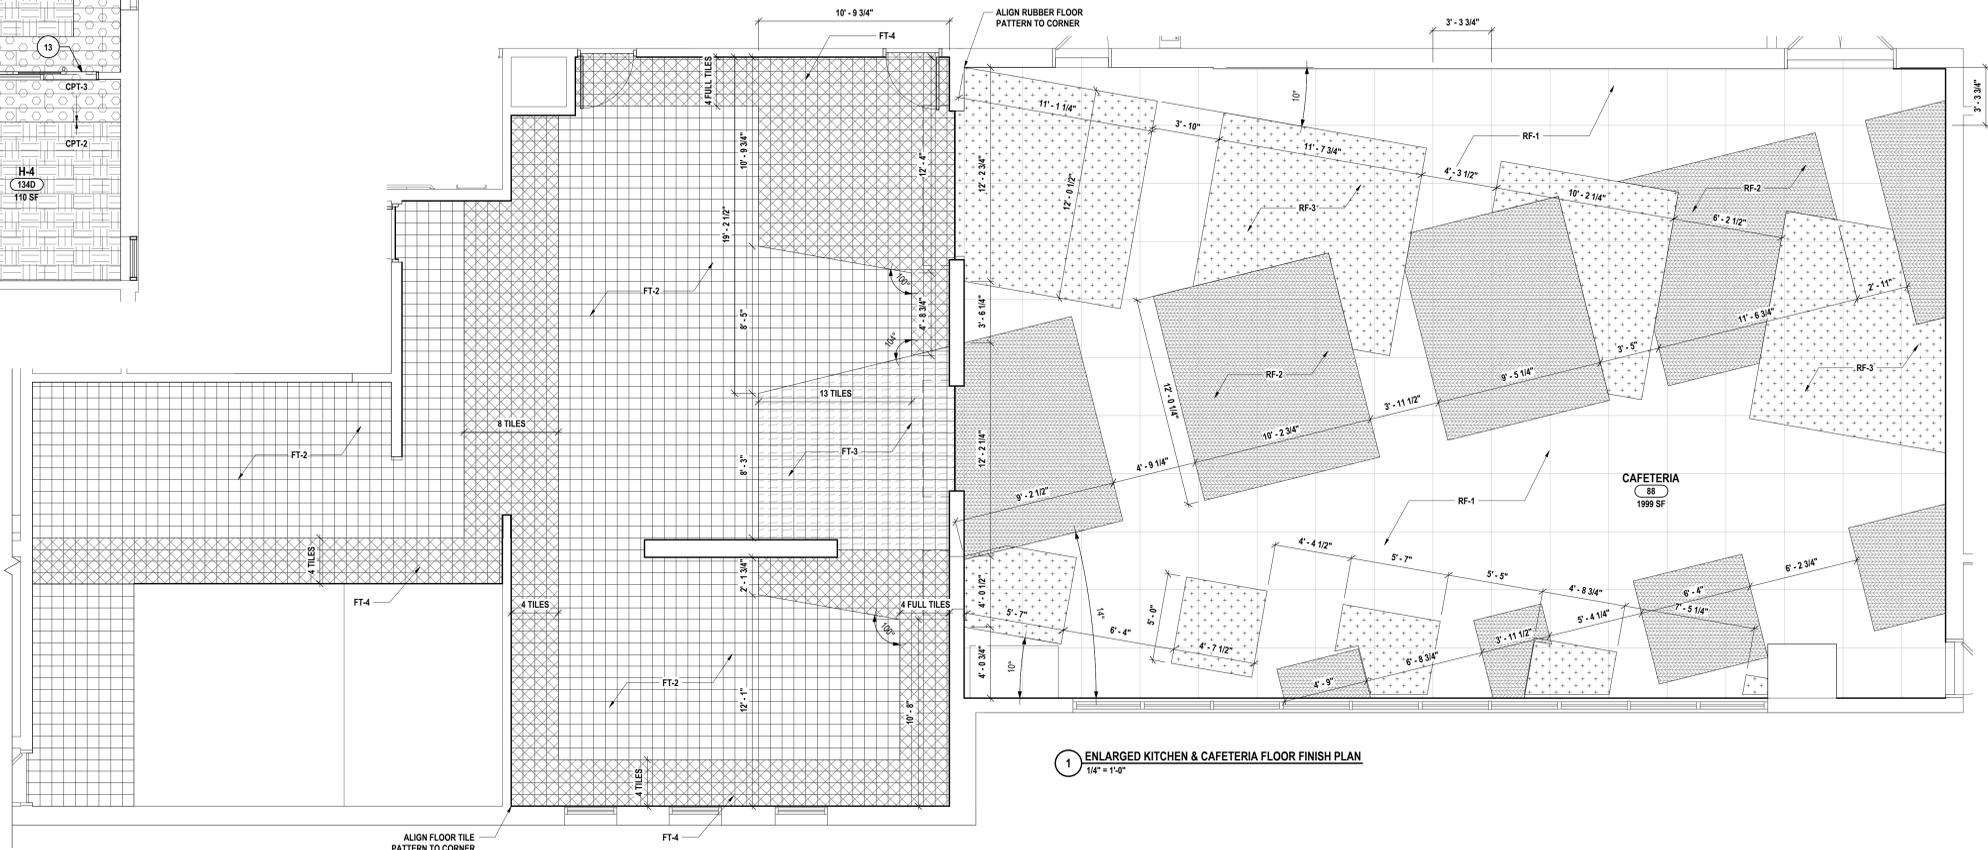

1 ENLARGED KITCHEN & CAFETERIA FLOOR FINISH PLAN  
1/4" = 1'-0"

**GENERAL NOTES - INTERIOR FLOOR FINISH:**

- A ALL FLOOR FINISHES SHALL BE INSTALLED ABUTTING NEW BUILT-IN CASEWORK UNLESS NOTED OTHERWISE ON FLOOR FINISH PLANS, EVEN WHEN NOT SHOWN ON FLOOR FINISH PLANS.
- B ALL FLOOR FINISHES TO TRANSITION AT CENTERLINE OF DOOR JAMB UNLESS OTHERWISE NOTED ON FLOOR FINISH PLANS.
- C FLOOR FINISHES TO EXTEND UNDERNEATH COUNTERTOPS WHERE FLOORING WOULD OTHERWISE BE EXPOSED.
- D REFER TO FINISH KEY AND ROOM FINISH SCHEDULE FOR ALL FINISHES NOT INDICATED ON FLOOR FINISH PLANS.
- E PREP FLOORS ACCORDING TO SPECIFICATION 09 05 01, "COMMON WORK RESULTS FOR FLOOR PREPARATION".
- F SLOPE ALL FLOOR TILE TO FLOOR DRAINS AS REQUIRED. REFER TO PLUMBING AND STRUCTURAL DRAWINGS FOR DETAILS.
- G PROVIDE ADA COMPLIANT TRANSITION STRIP WHEN ABUTTING FLOOR FINISHES DIFFER IN THICKNESS OR MATERIAL. REFER TO FINISH KEY AND ROOM FINISH SCHEDULE FOR DETAILS.

**# CONSTRUCTION NOTES - INTERIOR FLOOR FINISH**

- 1 FLOOR TO RECEIVE WALK OFF CARPET CPT-1 IN QUARTER TURN INSTALLATION PATTERN. PROVIDE BASE AS SCHEDULED.
- 2 FLOOR TO RECEIVE PORCELAIN FLOOR TILE, FT-1 IN GRID INSTALLATION PATTERN. PROVIDE CB-1 AS BASE.
- 3 FLOOR TO RECEIVE PORCELAIN FLOOR TILE, FT-2,3,4 IN GRID INSTALLATION PATTERN. PROVIDE CB-2 AS BASE. REFER TO 1MB-A8.4 FOR DETAILS.
- 4 PROVIDE NEW WOOD GYMNASIUM FLOOR SYSTEM, WD-1. PROVIDE PAINTED GYM LINES, STAIN, SEAL AND FINISH WOOD AS SPECIFIED. PROVIDE RB-3 AS BASE. REFER TO 1MB-S.1 FOR STRIPING PLAN.
- 5 FLOOR TO RECEIVE RUBBER TILE, RF-1,2,3 IN GRID INSTALLATION PATTERN. PROVIDE BASE AS SCHEDULED. REFER TO 1MB-A8.4 FOR INSTALLATION DETAILS.
- 6 FLOOR TO RECEIVE CARPET TILE, CPT-2,3 IN ASHLAR INSTALLATION PATTERN. REFER TO 2MB-A8.4 FOR DETAILS. PROVIDE BASE AS SCHEDULED.
- 7 PATCH TO MATCH TERRAZZO, TZ-1. PROVIDE TZB-1 TO MATCH EXISTING.
- 8 PATCH TO MATCH FLOOR & WALL BASE FINISHES WHERE NEW WORK AFFECTS EXISTING FLOOR FINISH CONDITIONS. REFER TO FINISH KEY FOR DETAILS.
- 9 FLOOR TO RECEIVE SEALED CONCRETE, SC-1. PROVIDE BASE AS SCHEDULED.
- 10 FLOOR TO RECEIVE CARPET, CPT-4,11 IN HEXAGONAL GRID INSTALLATION PATTERN. REFER TO 3MB-A8.4 FOR INSTALLATION DETAILS. PROVIDE BASE AS SCHEDULED.
- 11 PROVIDE RF-4 WHERE BASEBOARD RADIATION IS BEING REMOVED TO THE WIDTH OF ONE TILE. PROVIDE RUBBER BASE TO MATCH EXISTING ADJACENT BASE.
- 12 FLOOR TO RECEIVE FLOOR TILE, FT-2 N GRID INSTALLATION PATTERN. PROVIDE CB-2 AS BASE.
- 13 CONTINUE FLOOR FINISH PATTERN THROUGH THRESHOLD AND INTO ADJACENT ROOM.
- 14 FLOOR TO RECEIVE RUBBER FLOORING, RF-1 IN GRID INSTALLATION PATTERN.

**FLOOR FINISH LEGEND**


DATE:	1/21/2025	ISSUE FOR BID
DESCRIPTION OF REVISION:		
# DATE:	1	1/21/2025
DRAWN BY:	JHR	DATE:
CHECKED BY:	JDZ	PHASE:
		CD

**HUNT ENGINEERS ARCHITECTS | SURVEYORS**  
 HORSEHEADS, NY 807-263-1000 | PISCATAWAY, NY 562-327-7668 | TOWANNA, PA 670-265-4668  
 BINGHAMTON, NY 607-798-8881 | ALBANY, NY 607-798-8881  
 WWW.HUNTEAS.COM  
 NY CERTIFICATE NO. 0016250 | PA CERTIFICATE NO. TSC220313464-1


**ENLARGED FLOOR FINISH PLANS AND DETAILS**  
**2025 CAPITAL IMPROVEMENTS PROJECT**  
**HAMMONDSPORT CENTRAL SCHOOL DISTRICT**  
 8272 MAIN STREET HAMMONDSPORT, NEW YORK, 14840











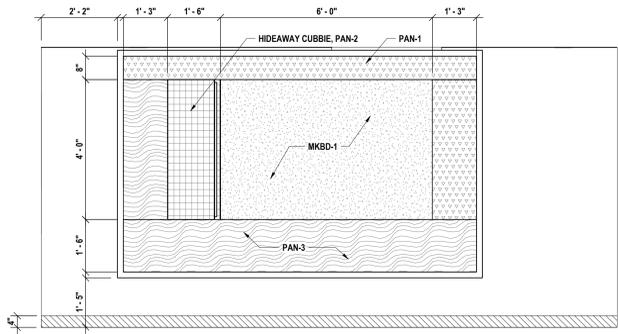


13 CONFERENCE ROOM - WALL SYSTEM I  
1/2" = 1'-0"

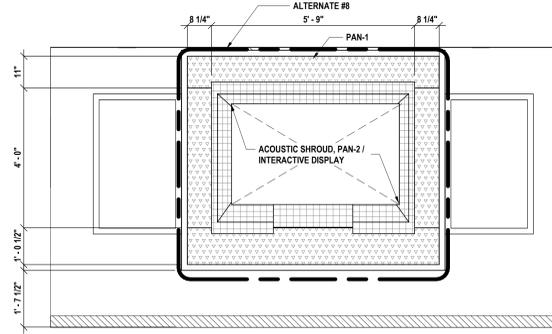


12 CONFERENCE ROOM - WALL SYSTEM H  
1/2" = 1'-0"

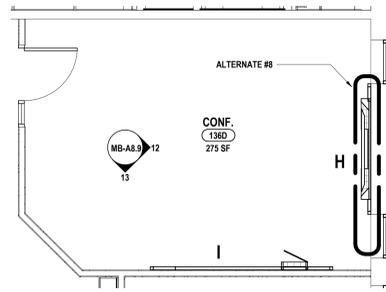


11 CONFERENCE ROOM - WALL SYSTEM PLAN  
1/4" = 1'-0"

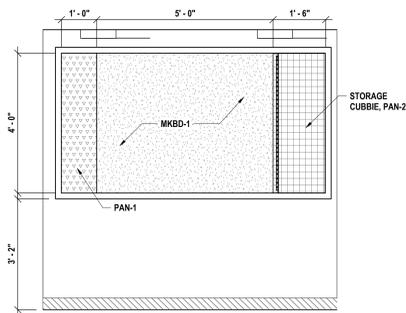

10 LIBRARY BREAKOUT ROOM - WALL SYSTEM TYPE G1  
1/2" = 1'-0"

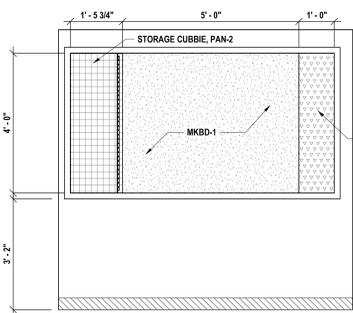


9 LIBRARY BREAKOUT ROOM - WALL SYSTEM TYPE G2  
1/2" = 1'-0"

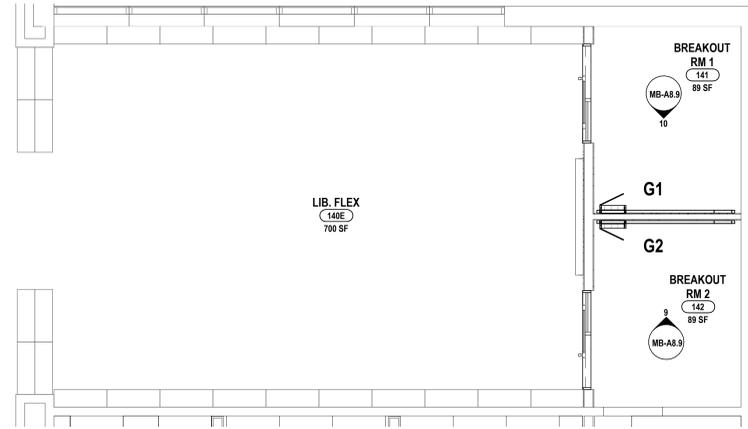


8 LIBRARY BREAKOUT ROOMS - WALL SYSTEM PLAN  
1/4" = 1'-0"

**WALL SYSTEM MATERIALS KEY**


- ACOUSTIC SURFACES, PAN-1
- STORAGE SOLUTIONS: HIDEAWAY CUBBY, PAN-2
- TACTILE/SENSORY SURFACES, PAN-3
- MAGNETIC WRITABLE SURFACES, MKBD-1
- ACOUSTIC SHROUD, PAN-2 / INTERACTIVE DISPLAY
- RUBBER BASE, RB-2

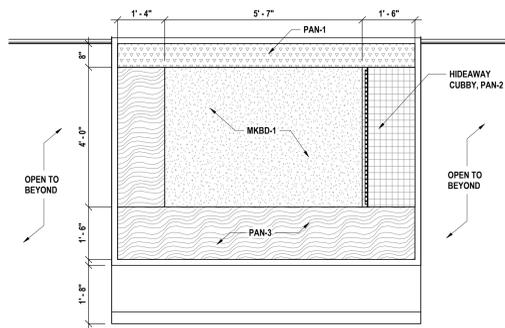


7 FLEX CLASSROOM - WALL SYSTEM TYPE F  
1/2" = 1'-0"

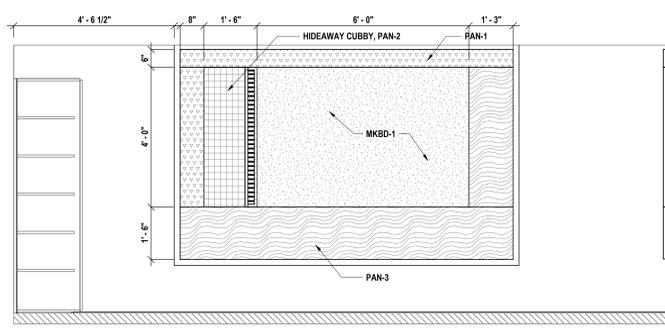


6 HUDDLE ROOMS - WALL SYSTEM TYPE E  
1/2" = 1'-0"

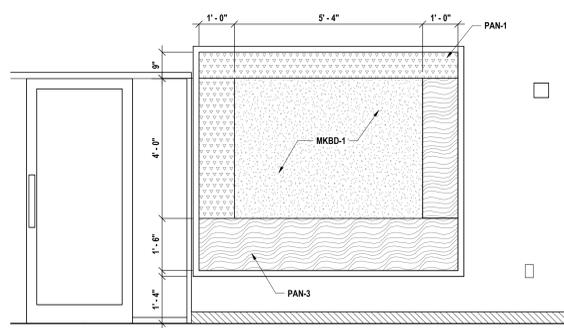


5 FLEX CLASSROOM - WALL SYSTEM TYPE D  
1/2" = 1'-0"

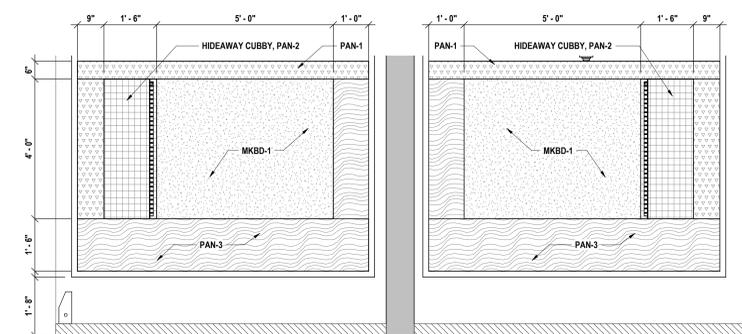


4 HUDDLE ROOMS - WALL SYSTEM TYPE C  
1/2" = 1'-0"

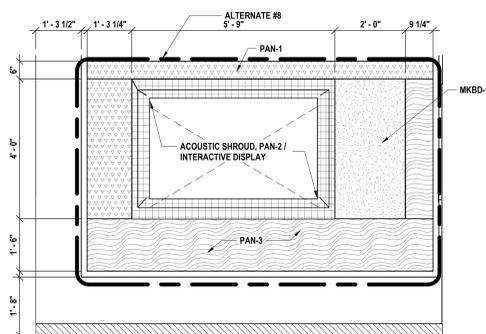

3 HUDDLE ROOMS - WALL SYSTEM TYPE B  
1/2" = 1'-0"

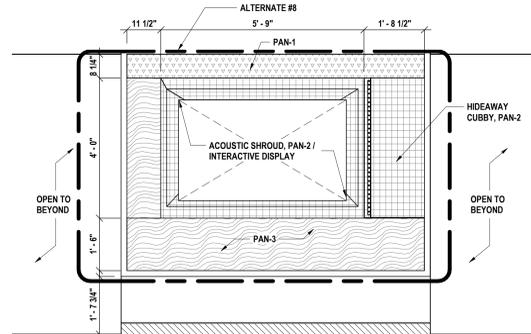

2 FLEX CLASSROOM - WALL SYSTEM TYPE A  
1/2" = 1'-0"

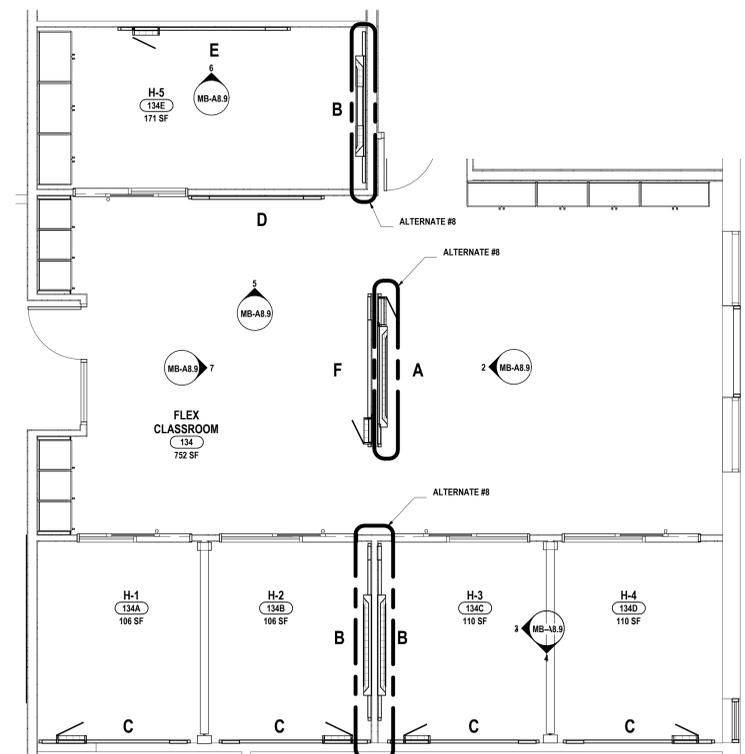

1 FLEX CLASSROOM & HUDDLE ROOMS - WALL SYSTEM PLAN  
1/4" = 1'-0"

#	DATE:	DESCRIPTION OF REVISION:	DRAWN BY:
1	10/27/2025	ISSUE FOR BID	JHR
			CHECKED BY: JDC
			DATE: 10/27/2025
			PHASE: CD

COPYRIGHT © 2025  
IT IS A VIOLATION OF THE LAW FOR ANY PERSON TO MAKE UNAUTHORIZED ALTERATIONS OR ADJUSTMENTS TO PLANS DRAWN BY HUNTT ENGINEERS ARCHITECTS | SURVEYORS.

**HUNT ENGINEERS ARCHITECTS | SURVEYORS**

HORSEHEADS, NY 607-458-1000    PROSPECTS, NY 562-837-7668    TOWANDA, PA 570-265-4668  
BINGHAMTON, NY 607-798-8881    ALBANY, NY 607-798-8881    WWW.HUNTEAS.COM  
NY CERTIFICATE NO. 0016250    PA CERTIFICATE NO. TSC2202031464-1

**P360 WALL SYSTEM ELEVATIONS**

**2025 CAPITAL IMPROVEMENTS PROJECT**

**HAMMONDSPORT CENTRAL SCHOOL DISTRICT**

8272 MAIN STREET HAMMONDSPORT, NEW YORK, 14840

**MB-A8.9**

PROJECT NO: 1925.014

SET #: MB-57-28-01-04-02-02-03-03-04-05-1955-1

FINISH KEY										
ABBR.	MATERIAL TYPE	MANUFACTURER	SERIES	SIZE	NUMBER	COLOR	SECTION #	LOCATION/REMARKS		
ACOUSTIC CEILING CLOUDS										
ACC-1	PET FELT	ACOUFELT	ROOFTOP, GABLE	44" X 44"	BE06	BERRY	09 84 30	LIBRARY CEILING CLOUDS		
ACC-2	PET FELT	ACOUFELT	ROOFTOP, BUTTERFLY	44" X 44"	AZ05	AZURE	09 84 30	LIBRARY CEILING CLOUDS		
ACC-3	PET FELT	ACOUFELT	ROOFTOP, BUTTERFLY	44" X 44"	LH13	LILAC	09 84 30	LIBRARY CEILING CLOUDS		
ACOUSTIC CEILING TILE										
ACT-1	ACOUSTICAL TILE	ARMSTRONG COMMERCIAL CEILING	ULTIMA HIGH NRC BEVELED TEGULAR	24" X 24"	1842HRC	WHITE	09 51 00	GENERAL		
ACT-2	ACOUSTICAL TILE	ARMSTRONG COMMERCIAL CEILING	KITCHEN ZONE	24" X 24"	673	WHITE	09 51 00	KITCHEN		
ACT-3	FIBERGLASS ACOUSTIC CEILING TILE	ARMSTRONG COMMERCIAL CEILING	LYRA PB SHAPES FOR DESIGNFLEX	24" X 48" X 1"	8332PB	WHITE	09 51 00	CAFETERIA CEILING		
ACT-4	FIBERGLASS ACOUSTIC CEILING TILE	ARMSTRONG COMMERCIAL CEILING	LYRA PB SHAPES FOR DESIGNFLEX	24" X 60" X 1"	8363PB	WHITE	09 51 00	CAFETERIA CEILING		
ACT-5	FIBERGLASS ACOUSTIC CEILING TILE	ARMSTRONG COMMERCIAL CEILING	LYRA PB SHAPES FOR DESIGNFLEX	12" X 48" X 1"	8377PB	WHITE	09 51 00	CAFETERIA CEILING		
ACT-6	FIBERGLASS ACOUSTIC CEILING TILE	ARMSTRONG COMMERCIAL CEILING	LYRA PB SHAPES FOR DESIGNFLEX	12" X 60" X 1" - CUSTOM MADE TO ORDER SIZE	CUSTOM	WHITE	09 51 00	CAFETERIA CEILING		
ACT-7	FIBERGLASS ACOUSTIC CEILING TILE	ARMSTRONG COMMERCIAL CEILING	LYRA PB SHAPES FOR DESIGNFLEX	12" X 48" X 1"	8377PB	CUSTOM COLOR: MATCH SW6552 DEWBERRY	09 51 00	CAFETERIA CEILING		
ACT-8	FIBERGLASS ACOUSTIC CEILING TILE	ARMSTRONG COMMERCIAL CEILING	LYRA PB SHAPES FOR DESIGNFLEX	12" X 60" X 1" - CUSTOM MADE TO ORDER SIZE	CUSTOM	CUSTOM COLOR: MATCH SW6552 DEWBERRY	09 51 00	CAFETERIA CEILING		
ACT-9	FIBERGLASS ACOUSTIC CEILING TILE	ARMSTRONG COMMERCIAL CEILING	LYRA PB SHAPES FOR DESIGNFLEX	6" X 48" X 1"	8346PB	WHITE	09 51 00	CAFETERIA CEILING		
ACT-10	FIBERGLASS ACOUSTIC CEILING TILE	ARMSTRONG COMMERCIAL CEILING	LYRA PB SHAPES FOR DESIGNFLEX	6" X 60" X 1"	8347PB	WHITE	09 51 00	CAFETERIA CEILING		
ACT-11	FIBERGLASS ACOUSTIC CEILING TILE	ARMSTRONG COMMERCIAL CEILING	LYRA PB SHAPES FOR DESIGNFLEX	6" X 48" X 1"	8346PB	CUSTOM COLOR: MATCH SW968 BERRY FRAPPE	09 51 00	CAFETERIA CEILING		
ACT-12	FIBERGLASS ACOUSTIC CEILING TILE	ARMSTRONG COMMERCIAL CEILING	LYRA PB SHAPES FOR DESIGNFLEX	6" X 60" X 1"	8347PB	CUSTOM COLOR: MATCH SW968 BERRY FRAPPE	09 51 00	CAFETERIA CEILING		
ACT-13	ACOUSTICAL TILE	ARMSTRONG COMMERCIAL CEILING	CERAMAGUARD FINE FISSURED	24" X 24"	607	WHITE	09 51 00	LOCKER ROOMS, JANITOR ROOMS		
ACOUSTIC WALLS										
AWP-1	RIGID FIBERGLASS WITH ACOUSTICALLY TRANSPARENT TEXTILE	KINETICS NOISE CONTROL / DUVALTEX	VERSATUNE - 2-1/8" THICKNESS / FR701	AS SHOWN	798	IRIS	09 84 30	GYMNASIUM		
AWP-2	RIGID FIBERGLASS WITH ACOUSTICALLY TRANSPARENT TEXTILE	KINETICS NOISE CONTROL / DUVALTEX	VERSATUNE - 2-1/8" THICKNESS / FR701	AS SHOWN	795	FLANNEL	09 84 30	GYMNASIUM		
AWP-3	PET FELT	ACOUFELT	SOLID PANEL - 1/2MM	AS SHOWN	AZ05	AZURE	09 84 30	ES LIBRARY WALL PANELS		
AWP-4	PET FELT	ACOUFELT	SOLID PANEL - 1/2MM	AS SHOWN	BE06	BERRY	09 84 30	ES LIBRARY WALL PANELS		
AWP-5	PET FELT	ACOUFELT	SOLID PANEL - 1/2MM	AS SHOWN	83	FRASCH	09 84 30	ES LIBRARY WALL PANELS		
AWP-6	RIGID FIBERGLASS WITH ACOUSTICALLY TRANSPARENT TEXTILE	KINETICS NOISE CONTROL / DUVALTEX	VERSATUNE - 2-1/8" THICKNESS / FR701	AS SHOWN	538	SILVER PAPER	09 84 30	GYMNASIUM		
BLEACHERS										
BL-1	PLASTIC BLEACHER SEATS	INTERKAL	CONTOUR SEAT MODULES	AS SHOWN	09	PURPLE	12 66 13	GYMNASIUM		
BL-2	PLASTIC BLEACHER SEATS	INTERKAL	CONTOUR SEAT MODULES	AS SHOWN	22	WHITE	12 66 13	GYMNASIUM		
CARPET										
CPT-1	WALK-OFF CARPET TILE	INTERFACE	STEP REPEAT SR999	19.7" X 19.7"	10845	ONYX	09 68 13	VESTIBULE 1158, ENTRY E-1, E-4, AND CORR 79C - FIELD		
CPT-2	CARPET TILE	INTERFACE	OPEN ROAD - FREE REGION	9.845" X 39.38"	108398	MIST	09 68 13	STUDENT SUPPORT SERVICES FIELD		
CPT-3	CARPET TILE	INTERFACE	OPEN ROAD - FREE REGION	9.845" X 39.38"	108403	AMETHYST	09 68 13	STUDENT SUPPORT SERVICES ACCENT		
CPT-4	CARPET TILE	SHAW CONTRACT	CONFIGURE - BASE HEX	28.8" X 24.9"	59580	PROGRESSION	09 68 13	LIBRARY FIELD		
CPT-5	CARPET TILE	SHAW CONTRACT	CONFIGURE - COLOR SHIFT HEX	28.8" X 24.9"	59429	ELECTRIC	09 68 13	LIBRARY ACCENT		
CPT-6	CARPET TILE	SHAW CONTRACT	CONFIGURE - COLOR SHIFT HEX	28.8" X 24.9"	59991	IRIDIUM	09 68 13	LIBRARY ACCENT		
CPT-7	CARPET TILE	SHAW CONTRACT	CONFIGURE - PLANE HEX	28.8" X 24.9"	54432	WAVE	09 68 13	LIBRARY ACCENT		
CPT-8	CARPET TILE	SHAW CONTRACT	CONFIGURE - PLANE HEX	28.8" X 24.9"	54992	PURPLE	09 68 13	LIBRARY ACCENT		
CPT-9	CARPET TILE	SHAW CONTRACT	CONFIGURE - PLANE HEX	28.8" X 24.9"	54580	STEEL	09 68 13	LIBRARY FIELD		
CPT-10	CARPET TILE	SHAW CONTRACT	CONFIGURE - PLANE HEX	28.8" X 24.9"	54592	URBAN	09 68 13	LIBRARY FIELD		
CPT-11	CARPET TILE	SHAW CONTRACT	CONFIGURE - PLANE HEX	28.8" X 24.9"	54436	CYAN	09 68 13	LIBRARY ACCENT		
CEILING SYSTEM										
ACP-1	FIBERGLASS ACOUSTIC PANEL	ARMSTRONG COMMERCIAL CEILING	INVISACOUSTICS	1212WH	24" x 48"	WHITE	09 51 53	GYMNASIUM CEILING		
ACP-2	PET FELT	TURF	BARCODE	24" X 48", PANEL A	82 / D06	BACKING - BARLEY, BLADES - PLANCKED OAK	09 84 30	LIBRARY FLEX & FFLEX CLASSROOM		
ACP-3	PET FELT	TURF	BARCODE	24" X 48", PANEL B	82 / D06	BACKING - BARLEY, BLADES - PLANCKED OAK	09 84 30	LIBRARY FLEX & FFLEX CLASSROOM		
ACP-4	THERMOPLASTIC DIFFUSER PANEL	KINETICS NOISE CONTROL	GEOMETRIC DIFFUSERS - RADIUS	24" X 24" X 5.25"D	-	WHITE	09 84 16	BAND & CHORAL ROOM		
CEILING TRIM										
AXT-1	ACT STRAIGHT PERIMETER TRIM	ARMSTRONG COMMERCIAL CEILING	AXIOM CLASSIC TRIM	AS SHOWN ON DRAWINGS	-	WHITE	09 51 00	GENERAL CEILING TRIM		
AXT-2	ACT CURVED PERIMETER TRIM	ARMSTRONG COMMERCIAL CEILING	AXIOM CLASSIC TRIM	AS SHOWN ON DRAWINGS	-	CUSTOM COLOR: MATCH SW6552 DEWBERRY	09 51 00	E.S. LIBRARY CEILING TRIM		
CERAMIC WALL TILE										
WT-1	GLAZED CERAMIC	AMERICAN OLEAN	COLOR STORY WALL	3" X 6"	0025	ICE WHITE	09 30 00	CORRIDOR & TOILET ROOM FIELD		
WT-2	GLAZED CERAMIC	AMERICAN OLEAN	COLOR STORY WALL	6" X 6"	0025	ICE WHITE	09 30 00	TOILET ROOM FIELD		
WT-3	GLAZED CERAMIC	AMERICAN OLEAN	COLOR STORY WALL	3" X 6"	0086	DEVOTION	09 30 00	CORRIDOR & TOILET ROOM PURPLE ACCENT		
WT-4	GLAZED CERAMIC	AMERICAN OLEAN	COLOR STORY WALL	3" X 6"	0040	STORM GRAY	09 30 00	CORRIDOR GRAY ACCENT		
WT-5	GLAZED CERAMIC	AMERICAN OLEAN	COLOR STORY WALL	4" X 16"	0049	CAFETERIA BLACK FIELD	09 30 00	CAFETERIA BLACK FIELD		
WT-6	GLAZED CERAMIC	AMERICAN OLEAN	COLOR STORY WALL	4" X 16"	0025	ICE WHITE	09 30 00	CAFETERIA WHITE FIELD		
WT-7	GLAZED CERAMIC	AMERICAN OLEAN	COLOR STORY WALL	4" X 16"	0006	SHADOW	09 30 00	CAFETERIA DARK GRAY FIELD		
WT-8	GLAZED CERAMIC	AMERICAN OLEAN	COLOR STORY WALL	4" X 16"	0086	DEVOTION	09 30 00	CAFETERIA PURPLE ACCENT		
CONCRETE FLOORING										
SC-1	SEALED CONCRETE	ARMORSEAL 8100	SHERWIN WILLIAMS	-	TBD	TBD	09 91 23	GENERAL SEALED CONCRETE		
DIRTT SYSTEM WALL FINISHES										
FPAN-1	POLYESTER PANEL FABRIC WITH MAGNETIC BACKER	DIRTT / MOMENTUM	PACT	-	-	MIDNIGHT	10 22 39	FOLDING PARTITION WALLS		
FPAN-2	THERMOFOIL LAMINATE	DIRTT	GRADE 2	-	-	LINEAR ASH	10 22 39	FOLDING PARTITION WALLS		
FPAN-3	BACK PAINTED GLASS	DIRTT	BACK PAINTED GLASS	-	-	POLAR WHITE	10 22 39	FOLDING PARTITION WALLS		
MT-1	POWDER COATED ALUMINUM	DIRTT	METAL TRIM	-	-	BLACK	10 22 39	FOLDING PARTITION TRIM		
FLOOR TILE										
FT-1	PORCELAIN FLOOR TILE	DALTE	KEYSTONES MOSAIC	2" X 2"	CUSTOM BLEND - RANDOM MIX	72% ARCTIC WHITE 15% DEEP PURPLE, 13% SUEDE GRAY,	09 30 00	TOILET ROOM / LOCKER ROOM FIELD		
FT-2	PORCELAIN FLOOR TILE	CROSSVILLE / TILE WHOLESALERS	CROSS-COLORS MINGLES - UPS FINISH	8" X 8"	A800	NICA	09 30 00	KITCHEN / SERVING		
FT-3	PORCELAIN FLOOR TILE	CROSSVILLE / TILE WHOLESALERS	CROSS-COLORS MINGLES - UPS FINISH	8" X 8"	A850	GRAPHITE	09 30 00	KITCHEN / SERVING		
FT-4	PORCELAIN FLOOR TILE	CROSSVILLE / TILE WHOLESALERS	CROSS-COLORS MINGLES - UPS FINISH	8" X 8"	A880	ONYX	09 30 00	KITCHEN / SERVING		
FT-5	PORCELAIN FLOOR TILE	DALTE	KEYSTONES MOSAIC	2" X 2" & 1" X 1"	CUSTOM BLEND	44% ARCTIC WHITE, 44% BLACK, 6% DEEP PURPLE, 6% CORNSILK	09 30 00	PTM LOCKER ROOMS - REFER TO 2MB-AS.1 FOR MOSAIC PATTERN		
GROUT										
G-1	PREMIXED GROUT WITH EPOXY PERFORMANCE	LATICRETE	SPECTRALOCK ONE	-	44	BRIGHT WHITE	09 30 00	WALLS		
G-2	EPOXY GROUT	LATICRETE	SPECTRALOCK PRO PREMIUM	-	42	PLATINUM	09 30 00	FLOORS		
LOCKERS										
LK-1	METAL LOCKERS	ASI STORAGE SOLUTIONS	TRADITIONAL PLUS COLLECTION	-	04	PLUM	10 51 29	LOCKER ROOMS, TEAM ROOM, & REFEREE ROOM		
METAL WALL PANEL										
MWP-1	METAL COMPOSITE WALL PANEL	TAKEFORM	MOXIE GRAPHIC WALL PANELS	3' X 6'	-	CUSTOM DIGITAL PRINTED WALL PANELS	10 11 43	CORRIDOR C11 - ARCHITECT TO PROVIDE GRAPHICS		
MIRRORED FINISHES										
MIRROD-1	PORCELAIN ENAMEL WHITEBOARD	PLATINUM VISUAL SOLUTIONS	P360 SYSTEM - WRITAMOUNT SURFACES	AS SHOWN	-	RAIN	10 11 00.13	P360 WALL SYSTEM WRITABLE SURFACES		
PAN-1	PET FELT	PLATINUM VISUAL SOLUTIONS	P360 SYSTEM - SOMASOUND	AS SHOWN	SL30	SOFT LAVENDER	10 11 00.13	P360 WALL SYSTEM ACOUSTIC PANELS		
PAN-2	PET FELT	PLATINUM VISUAL SOLUTIONS	P360 SYSTEM - SOMASOUND	AS SHOWN	-	BOLD GREY	10 11 00.13	P360 WALL SYSTEM ACOUSTIC SHROU / ENCLOSED CUBBY SLATS		
PAN-3	TEXTILE	PLATINUM VISUAL SOLUTIONS - FORBO	TOUCHTONE PANEL	AS SHOWN	-	SMOKE	10 11 00.13	P360 WALL SYSTEM TACKLE/TACTILE SURFACES		
PAINT										
PNT-1	PAINT	SHERWIN WILLIAMS	-	-	SW7666	FLEUR DE SEL	09 91 23	LIBRARY GENERAL		
PNT-2	PAINT	SHERWIN WILLIAMS	-	-	SW6552	DEWBERRY	09 91 23	STUDENT SUPPORT SERVICES SUITE ACCENT / E.S. LIBRARY GWS SOFFIT FACIA / GYM OFFICES		
PNT-3	PAINT	SHERWIN WILLIAMS	-	-	SW9165	GOSSAMER VEIL	09 91 23	STUDENT SUPPORT SERVICES SUITE GENERAL		
PNT-4	PAINT	SHERWIN WILLIAMS	-	-	SW7068	GRIZZLE GRAY	09 91 23	HM DOOR FRAMES GENERAL		
PNT-5	PAINT	SHERWIN WILLIAMS	-	-	SW7757	HIGH REFLECTIVE WHITE	09 91 23	CEILING / GWS SOFFITS		
PNT-6	PAINT	SHERWIN WILLIAMS	-	-	SW9068	BERRY FRAPPE	09 91 23	E.S. LIBRARY ACCENT COLUMNS		
PNT-7	PAINT	SHERWIN WILLIAMS	-	-	SW7066	GRAY MATTERS	09 91 23	STUDENT SUPPORT SERVICES SUITE HM DOOR FRAMES		
PNT-8	PAINT	SHERWIN WILLIAMS	-	-	SW 6825	IZMIR PURPLE	09 91 23	GYMNASIUM ACCENT		
PNT-9	PAINT	SHERWIN WILLIAMS	-	-	TBD	MATCH EXISTING CLASSROOM PAINT COLOR	09 91 23	PTM PAINT		
PRE-CAST TERRAZZO BASE										
TZB-1	PRE-CAST EPOXY TERRAZZO BASE	TERRAZZO & MARBLE SUPPLY	TERRAZY EPOXY TERRAZZO	4" H	-	MATCH EXISTING	09 66 23	MAIN LOBBY - MATCH EXISTING		
RESILIENT BASE										
RB-1	RUBBER BASE	JOHNSONITE / TARKETT	STANDARD COVE BASE	4" H	VL4	COOL METAL CG	09 65 00	GENERAL		
RB-2	RUBBER BASE	JOHNSONITE / TARKETT	STANDARD COVE BASE	4" H	TA5	COLONIAL GREY CG	09 65 00	STUDENT SUPPORT SERVICES SUITE		
RB-3	RUBBER BASE	JOHNSONITE / TARKETT	VENT COVE BASE	4" H	40	BLACK	09 64 66	GYMNASIUM		
RB-4	RUBBER BASE	JOHNSONITE / TARKETT	STANDARD COVE BASE	4" H	TBD	MATCH EXISTING	09 65 00	MATCH EXISTING CLASSROOM BASE		
RB-5	RUBBER BASE	JOHNSONITE / TARKETT	STANDARD 2 1/2" TOILESS BASE	2 1/2" H	VL4	COOL METAL CG	09 65 00	EXISTING WALLS AT VESTIBULE		
RESILIENT FLOORING										
RF-1	RUBBER TILE	NORA FLOORING	NORAMENT GRANO - 3.5 MM - ART. 1880	39.53" X 39.53"	5303	FRANKINCENSE	09 65 00	CAFETERIA / CORRIDOR GENERAL		
RF-2	RUBBER TILE	NORA FLOORING	NORAMENT GRANO - 3.5 MM - ART. 1880	39.53" X 39.53"	5304	BLACK PEPPER	09 65 00	CAFETERIA / CORRIDOR - ACCENT		
RF-3	RUBBER TILE	NORA FLOORING	NORAMENT GRANO - 3.5 MM - ART. 1880	39.53" X 39.53"	5308	MYRSH	09 65 00	CAFETERIA / CORRIDOR - ACCENT		
RF-4	RUBBER TILE	ROPPE	SYMMETRY TILE - 993 TEXTURED	19-11/16" X 19-11/16"	S618	AUBERGINE	09 65 00	CLASSROOM ACCENT		
RESIN PANEL										
RP-1	ACRYLIC RESIN PANEL	LUMICORE	LUMINOUS, SATIN FINISH	1/2" THICKNESS	-	SANTORINI	06 20 00	E.S. LIBRARY - CUSTOM MILLWORK		

FINISH KEY										
ABBR.	MATERIAL TYPE	MANUFACTURER	SERIES	SIZE	NUMBER	COLOR	SECTION #	LOCATION/REMARKS		
RP-2	ACRYLIC RESIN PANEL	LUMICORE	LUMINOUS, SATIN FINISH	1/2" THICKNESS	-	ORCHID	06 20 00	E.S. LIBRARY - CUSTOM MILLWORK		
RP-3	ACRYLIC RESIN PANEL	LUMICORE	LUMINOUS, SATIN FINISH	1/2" THICKNESS	-	AUBERGINE	06 20 00	E.S. LIBRARY - CUSTOM MILLWORK		
RP-4	ACRYLIC RESIN PANEL	LUMICORE	LUMINOUS, GALVANIZED FINISH, WITH METALLIC FLAKES	1/2" THICKNESS	-	SANTORINI / DARK MATTER	06 20 00	LOBBY WALL PANEL		
SHOWER CURTAIN										
SHWC-1	POLYESTER PRIVACY CURTAIN	INPRO	ALOPT	72" W	-	TIMBER	10 28 00	REFEREE ROOM SHOWER		
SOLID SURFACE										
SSM-1	SIMULATED STONE	WILSONART	-	-	9236SS	BEIGE TRAVERTINE	12 36 00	COUNTERTOPS		
SSM-2	SIMULATED STONE	CORIAN	COLORS BY DUPONT - GROUB B	-	-	CARRON AGGREGATE	12 36 00	WINDOW SILLS		
SUSPENDED WOOD CEILINGS										
WCP-1	WOOD CEILING PANEL	RULON	ALURATONE 700	24" X 96"	-	WHITE OAK - LATTE	09 54 26	SERVING, CAFETERIA, & LOBBY		
WCP-2	WOOD CEILING PANEL	RULON	FLAT PANEL	6" X 96"	-	WHITE OAK - LATTE	09 54 26	SERVING, CAFETERIA, & LOBBY		
WCP-3	WOOD CEILING PANEL	RULON	FLAT PANEL	6" X 96"	-	ASH BLACK	09 54 26	LO		

ROOM FINISH SCHEDULE										
ROOM #	ROOM NAME	FLOOR FINISH	BASE FINISH	WALL FINISH	DOOR FRAME COLOR	CEILING FINISH	CASEWORK/MILLWORK FINISHES	WINDOW TREATMENTS	REMARKS	
FIRST FLOOR AREA A										
78	TREASURER	ETR / PTM	ETR / PTM	PNT-1	ETR	ETR / PTM	-	SSM-1 / WS-2	-	
79	GIRLS TEAM RM	ETR / PTM (FT-5)	ETR / PTM	ETR / PTM TILE	ETR	ETR	-	-	-	PROVIDE LOCKER, LK-1 TO MATCH EXISTING LOCKERS. PROVIDE BENCH TO MATCH EXISTING.
79B	STORAGE	SC-1	RB-1	PNT-1	PNT-4	ACT-13	-	-	-	
79C	CORR.	OPT-1 / TS-3	CB-2	WT-6.8	ETR / PNT-4	ACT-1	-	-	-	EXTERIOR DOORS TO BE CLEAR.
80A	OFFICE	ETR / PTM	ETR / PTM (RB-4)	PNT-2 / ETR	PNT-4	ACT-1	-	-	-	
80B	OFFICE	ETR / PTM	ETR / PTM (RB-4)	PNT-2 / ETR	PNT-4	ACT-1	-	-	-	
81	GIRLS LOCKER RM	ETR / PTM (FT-5)	ETR / PTM	ETR / PTM TILE	ETR	ETR	-	-	-	PROVIDE LOCKERS, LK-1, TO MATCH EXISTING LOCKERS. PROVIDE BENCH TO MATCH EXISTING.
84	BOYS LOCKER RM	ETR / PTM (FT-5)	ETR / PTM	ETR / PTM TILE	ETR	ETR	-	-	-	PROVIDE BENCH TO MATCH EXISTING.
85	BOYS TM RM	ETR / PTM (FT-9)	ETR / PTM	ETR / PTM TILE	ETR	ETR	-	-	-	PROVIDE LOCKERS, LK-1, TO MATCH EXISTING LOCKERS. PROVIDE BENCH TO MATCH EXISTING.
86	TR	FT-1	CB-1	WT-1,2,3,4	PNT-4	ACT-13	-	-	-	PROVIDE SHOWER CURTAIN, SHWC-1
86A	REF. RM	FT-1	CB-1	WT-1,2,3,4	PNT-4	ACT-13	-	-	-	PROVIDE LOCKERS, LK-1
87	GYMNASIUM	WD-1 / STN-2,3	RB-3	WP-1 / PNT-1,2 / AWP-1,2,6	PNT-4	BASE BID: PNT-5.8 ALTERNATE #4: ACP-1	-	-	-	PROVIDE ALUMINUM THRESHOLD AT GYMNASIUM DOORS.
88	CAFETERIA	RF-1,2,3	ETR	ETR / WT-5,6,7,8 / TS-1,6	ETR	ACT-2	-	-	-	PROVIDE CAULK JOINT AT NEW WALL TILE TO FLOOR TRANSITIONS.
89	KITCHEN	FT-2,3,4	CB-2	WT-6.8 / TS-1	PNT-4	ACT-2	-	-	-	
92A	FREEZER	-	-	-	-	-	-	-	-	FINISHES TO BE SELECTED BY ARCHITECT FROM MANUFACTURER STANDARD
92B	COOLER	-	-	-	-	-	-	-	-	FINISHES TO BE SELECTED BY ARCHITECT FROM MANUFACTURER STANDARD
93	MECH	ETR / PTM	ETR / PTM	PNT-1	ETR	ETR	-	-	-	
93C	OFFICE	FT-2	CB-2	PNT-1	PNT-4	ACT-1	-	-	-	
94	RECEIVING	SC-1	RB-1	PNT-1	PNT-4	PNT-5	-	-	-	
95	TR	FT-1	CB-1	WT-1,2,3,4	PNT-4	ACT-1	-	-	-	
E-1	ENTRY	OPT-1	RB-5	ETR	ETR	ETR	-	-	-	
E-4	ENTRY	OPT-1	RB-1 / CB-2	ETR / WT-6.8 / TS-1,6 / PNT-1	-	ACT-1	-	STN-1	-	BENCH TO RECEIVE STN-1. DO NOT TILE OVER EXISTING EXPOSED BRICK. EXTERIOR DOORS TO BE CLEAR ANODIZED
E-4A	SERVICE ACCESS	-	-	-	-	PNT-5	-	-	-	
V-4	VEST	ETR / PTM (TZ-1)	ETR / PTM (TZB-1)	ETR / WWP-2,3 / RP-4	ETR	ETR / WCP-1,2,3 / PNT-2	-	-	-	PROVIDE CUSTOM PAINTED WOOD GRILLES.
FIRST FLOOR AREA B										
101	ENGLISH	ETR / RF-4	ETR / RB-4	ETR	ETR	ETR	-	-	-	
102A	ELEV. MECH ROOM	ETR	ETR / RB-4	ETR / PTM (PNT-9)	ETR	ETR / PTM	-	-	-	
103	SOCIAL STUDIES	ETR / RF-4	ETR / RB-4	ETR / PTM (PNT-9)	ETR	ETR	-	-	-	
104	SPECIAL ED.	ETR / RF-4	ETR / RB-4	ETR	ETR	ETR	-	-	-	
105	ENGLISH	ETR / RF-4	ETR / RB-4	ETR / PTM (PNT-9)	ETR	ETR	-	-	-	
106	SOCIAL STUDIES	ETR / RF-4	ETR / RB-4	ETR	ETR	ETR	-	-	-	
107	BUSINESS	ETR / RF-4	ETR / RB-4	ETR / PTM (PNT-9)	ETR	ETR	-	-	-	
108	HOME & CAREERS	ETR / RF-4	ETR / RB-4	ETR	ETR	ETR	-	-	-	
109	SOCIAL STUDIES	ETR / RF-4	ETR / RB-4	ETR / PTM (PNT-9)	ETR	ETR	-	-	-	
110	SPECIAL ED.	ETR / RF-4	ETR / RB-4	ETR	ETR	ETR	-	-	-	
129	BOYS TR	BASE BID: NO WORK. ALTERNATE #6: FT-1	BASE BID: NO WORK. ALTERNATE #6: CB-1	BASE BID: NO WORK. ALTERNATE #6: WT-1,2,3,4 / TS-1	BASE BID: NO WORK. ALTERNATE #6: PNT-4	BASE BID: NO WORK. ALTERNATE #6: ACT-1 / PNT-5	-	BASE BID: NO WORK. ALTERNATE #6: SSM-2	-	ALTERNATE #6: PROVIDE TOILET PARTITIONS, TP-1
129A	TR	BASE BID: NO WORK. ALTERNATE #6: FT-1	BASE BID: NO WORK. ALTERNATE #6: CB-1	BASE BID: NO WORK. ALTERNATE #6: WT-1,2,3,4 / TS-1	BASE BID: NO WORK. ALTERNATE #6: PNT-4	BASE BID: NO WORK. ALTERNATE #6: ACT-1 / PNT-5	-	BASE BID: NO WORK. ALTERNATE #6: SSM-2	-	ALTERNATE #6: PROVIDE TOILET PARTITIONS, TP-1
131	GIRLS TR	BASE BID: NO WORK. ALTERNATE #6: FT-1	BASE BID: NO WORK. ALTERNATE #6: CB-1	BASE BID: NO WORK. ALTERNATE #6: WT-1,2,3,4 / TS-1	BASE BID: NO WORK. ALTERNATE #6: PNT-4	BASE BID: NO WORK. ALTERNATE #6: ACT-1 / PNT-5	-	BASE BID: NO WORK. ALTERNATE #6: SSM-2	-	ALTERNATE #6: PROVIDE TOILET PARTITIONS, TP-1
131A	JAN. CLOSET	BASE BID: NO WORK. ALTERNATE #6: SC-1 / TS-5	BASE BID: NO WORK. ALTERNATE #6: RB-1 / CB-1	BASE BID: NO WORK. ALTERNATE #6: PNT-1 / WT-1 / TS-6	BASE BID: NO WORK. ALTERNATE #6: PNT-4	BASE BID: NO WORK. ALTERNATE #6: ACT-13	-	-	-	
132	PROF. LEARNING RM.	ETR	ETR	ETR	ETR	ETR	-	BASE BID: NO WORK. ALTERNATE #4: SSM-2 / WS-1	-	
132B	SPEC. ED. DIR./CURR. COORD. OFF.	ETR	ETR	ETR	ETR	ETR	-	BASE BID: NO WORK. ALTERNATE #4: SSM-2 / WS-1	-	
133	DATA RM	ETR / PTM	ETR / PTM	PNT-1	ETR	ETR	-	-	-	
134	FLEX CLASSROOM	OPT-2,3	RB-2	PNT-3 / PAN-1,2,3 / MKBD-1	PNT-7	ACT-1 / ACP-5,6,7 / AXT-1 / PNT-5	STN-1	SSM-2 / WS-2	-	BASE BIDE: PROVIDE WALL MOUNTED ACOUSTIC, STORAGE, & MARKERBOARD SYSTEM TYPES D & F. ALTERNATE #8: PROVIDE WALL MOUNTED ACOUSTIC, STORAGE, & DISPLAY SURROUND SYSTEM, TYPE A. REFER TO MB-A9.9 FOR SYSTEM DETAILS.
134A	H-1	OPT-2,3	RB-2	PNT-3 / PAN-1,2,3 / MKBD-1 / FPAN-1,2,3 / MT-1	-	ACT-1	-	-	-	PROVIDE WALL MOUNTED ACOUSTIC, STORAGE, & MARKERBOARD SYSTEM, TYPE C. REFER TO MB-A9.9 FOR SYSTEM DETAILS.
134B	H-2	OPT-2,3	RB-2	PNT-3 / PAN-1,2,3 / MKBD-1 / FPAN-1,2,3 / MT-1	-	ACT-1	-	-	-	BASE BIDE: PROVIDE WALL MOUNTED ACOUSTIC, STORAGE, & MARKERBOARD SYSTEM TYPES D & F. ALTERNATE #8: PROVIDE WALL MOUNTED ACOUSTIC, DISPLAY SURROUND SYSTEM, TYPE B. REFER TO MB-A9.9 FOR SYSTEM DETAILS.
134C	H-3	OPT-2,3	RB-2	PNT-3 / PAN-1,2,3 / MKBD-1 / FPAN-1,2,3 / MT-1	-	ACT-1	-	-	-	BASE BIDE: PROVIDE WALL MOUNTED ACOUSTIC, STORAGE, & MARKERBOARD SYSTEM TYPES D & F. ALTERNATE #8: PROVIDE WALL MOUNTED ACOUSTIC, DISPLAY SURROUND SYSTEM, TYPE B. REFER TO MB-A9.9 FOR SYSTEM DETAILS.
134D	H-4	OPT-2,3	RB-2	PNT-3 / PAN-1,2,3 / MKBD-1 / FPAN-1,2,3 / MT-1	-	ACT-1	-	SSM-2 / WS-2	-	PROVIDE WALL MOUNTED ACOUSTIC, STORAGE, & MARKERBOARD SYSTEM, TYPE C. REFER TO MB-A9.9 FOR SYSTEM DETAILS.
134E	H-5	OPT-2,3	RB-2	PNT-3 / PAN-1,2,3 / MKBD-1	-	ACT-1	-	-	-	BASE BIDE: PROVIDE WALL MOUNTED ACOUSTIC, STORAGE, & MARKERBOARD SYSTEM TYPE E. ALTERNATE #8: PROVIDE WALL MOUNTED ACOUSTIC, DISPLAY SURROUND SYSTEM, TYPE B. REFER TO MB-A9.9 FOR SYSTEM DETAILS.
136	WORK STATION/ WAITING	OPT-2,3	RB-2	PNT-1,2 / WC-3	PNT-7	ACT-1	-	-	-	
136A	OFFICE	OPT-2,3	RB-2	PNT-2,3	PNT-7	ACT-1	-	SSM-2 / WS-1	-	
136B	OFFICE	OPT-2,3	RB-2	PNT-2,3	PNT-7	ACT-1	-	SSM-2 / WS-1	-	
136C	OFFICE	OPT-2,3	RB-2	PNT-2,3	PNT-7	ACT-1	-	SSM-2 / WS-1	-	
136D	CONF.	OPT-2,3	RB-2	PNT-3 / PAN-1,2,3 / MKBD-1	PNT-7	ACT-1	-	SSM-2 / WS-1	-	BASE BIDE: PROVIDE WALL MOUNTED ACOUSTIC, STORAGE, & MARKERBOARD SYSTEM TYPE I. ALTERNATE #8: PROVIDE WALL MOUNTED ACOUSTIC, DISPLAY SURROUND SYSTEM, TYPE H. REFER TO MB-A9.9 FOR SYSTEM DETAILS.
139	ELEM. LIB.	OPT-4,11	RB-1	PNT-1,2,6 / AWP-3,4,5 / WC-1	-	ACT-1 / ACC-1,2,3 / AXT-2	STN-1 / RP-1,2,3 / UP-1,2,3,4	SSM-2 / WS-1	-	
140	LIBRARY	ETR	ETR / PTM (PNT)	ETR	ETR	ETR / ACC-1,2,3	-	SSM-2	-	
140E	LIB. FLEX	ETR	ETR / PTM (RB-1)	ETR / PNT-1	-	ACP-2,3 / PNT-5	-	-	-	
141	BREAKOUT RM 1	OPT-2,3	RB-1	PNT-1 / PAN-1,2,3 / MKBD-1	-	ACT-1	-	-	-	PROVIDE WALL MOUNTED ACOUSTIC, STORAGE, & MARKERBOARD SYSTEM TYPE G1. REFER TO MB-A9.9 FOR SYSTEM DETAILS.
142	BREAKOUT RM 2	OPT-2,3	RB-1	PNT-1 / PAN-1,2,3 / MKBD-1	-	ACT-1 / PNT-5	-	-	-	PROVIDE WALL MOUNTED ACOUSTIC, STORAGE, & MARKERBOARD SYSTEM TYPE G2. REFER TO MB-A9.9 FOR SYSTEM DETAILS.
C-6	CORRIDOR	ETR	ETR / PTM / CB-1	ETR / WT-6.8 / TS-6	ETR	ETR	-	-	-	
C-11	CORRIDOR	ETR / PTM	ETR / CB-1,2	ETR / WT-4,6,8 / MWP-1	ETR / PNT-7	-	-	-	-	
EV-1	ELEVATOR	RF-1	-	-	-	-	-	-	-	ELEVATOR WALL, BASE, AND CEILING FINISHES TO BE SELECTED BY ARCHITECT FROM MANUFACTURER'S STANDARD LINE.
V-5	VEST	ETR / PTM	ETR / PTM (CB-2)	ETR / WT-6.8 / TS-1,6	ETR / PNT-7	ETR	-	-	-	
FIRST FLOOR AREA C										
122	4TH GRADE	ETR	ETR	ETR / PTM	ETR	ETR / PTM (PNT-9)	-	BASE BID: NO WORK. ALTERNATE #4: SSM-2 / WS-2	-	PAINT WALL CHASE TO MATCH EXISTING ADJACENT WALLS
124	5TH GRADE	ETR	ETR	ETR / PTM	ETR	ETR / PTM (PNT-9)	-	BASE BID: NO WORK. ALTERNATE #4: SSM-2 / WS-2	-	PAINT WALL CHASE TO MATCH EXISTING ADJACENT WALLS
126	4TH GRADE	ETR	ETR	ETR	ETR	ETR	-	BASE BID: NO WORK. ALTERNATE #4: SSM-2 / WS-2	-	
128	5TH GRADE	ETR	ETR	ETR / PTM	ETR	ETR / PTM (PNT-9)	-	BASE BID: NO WORK. ALTERNATE #4: SSM-2 / WS-2	-	PAINT WALL CHASE TO MATCH EXISTING ADJACENT WALLS
130	ELEMENTARY ART	ETR	ETR	ETR / PTM	ETR	ETR	-	BASE BID: NO WORK. ALTERNATE #4: SSM-2 / WS-2	-	
135	BAND	ETR	ETR	ETR	ETR	BASE BID: NO WORK. ALTERNATE #9: ACT-1 / ACP-4 / PNT-2	-	-	-	
152	MUSIC RM	ETR	ETR	ETR	ETR	BASE BID: NO WORK. ALTERNATE #9: ACT-1 / ACP-4 / PNT-2 / AXT-1	-	-	-	
C-4	CORRIDOR	ETR	ETR / CB-1	ETR / WT-6.8 / TS-6	ETR / PNT-4	ETR	-	-	-	REINSTALL STORED ACT CEILING AT DOOR
C-10	CORRIDOR	ETR	ETR / CB-1, 2	ETR / WT-1,3,4,6,8 / TS-1,6	ETR / PNT-4	ETR / ACT-1 / PNT-2	-	-	-	PAINT SOFFITS AT NEW TOILET ROOMS PNT-2. REINSTALL STORED ACT CEILING AT DOOR
CS-1	STAIR	ETR	ETR / CB-1	ETR / WT-4	ETR	ETR	-	-	-	REINSTALL STORED ACT CEILING AT DOOR
SECOND FLOOR AREA B										
201	SCIENCE	ETR / RF-4	ETR / RB-4	ETR	ETR	ACT-1	-	-	-	PAINT WALL CHASE TO MATCH EX. ADJ WALLS
202	MATH	ETR / RF-4	ETR / RB-4	ETR	ETR	ACT-1	-	-	-	
203	HEALTH	ETR / RF-4	ETR / RB-4	ETR / PTM (PNT-9)	ETR	ACT-1	-	-	-	PAINT WALL CHASE TO MATCH EX. ADJ WALLS
204	SCIENCE	ETR / RF-4	ETR / RB-4	ETR	ETR	ACT-1	-	-	-	
204A	OFFICE	ETR / RF-4	ETR / RB-4	ETR	ETR	ACT-1	-	-	-	
205	SPANISH	ETR / RF-4	ETR / RB-4	ETR / PTM (PNT-9)	ETR	ACT-1	-	-	-	PAINT WALL CHASE TO MATCH EX. ADJ WALLS
206	SCIENCE	ETR / RF-4	ETR / RB-4	ETR	ETR	ACT-1	-	-	-	
207	MATH	ETR / RF-4	ETR / RB-4	ETR / PTM (PNT-9)	ETR	ACT-1	-	-	-	PAINT WALL CHASE TO MATCH EX. ADJ WALLS
209	MATH	ETR / RF-4	ETR / RB-4	ETR / PTM (PNT-9)	ETR	ACT-1	-	-	-	PAINT WALL CHASE TO MATCH EX. ADJ WALLS
229	BOYS TR	BASE BID: NO WORK. ALTERNATE #7: FT-1	BASE BID: NO WORK. ALTERNATE #7: CB-1	BASE BID: NO WORK. ALTERNATE #7: WT-1,2,3,4 / TS-1	BASE BID: NO WORK. ALTERNATE #7: PNT-4	BASE BID: NO WORK. ALTERNATE #7: ACT-1 / PNT-5	-	BASE BID: NO WORK. ALTERNATE #7: SSM-2	-	ALTERNATE #7: PROVIDE TOILET PARTITIONS, TP-1
229A	JAN. CLOSET	BASE BID: NO WORK. ALTERNATE #7: SC-1	BASE BID: NO WORK. ALTERNATE #7: RB-1 / CB-1	BASE BID: NO WORK. ALTERNATE #7: PNT-1 / WT-1 / TS-6	BASE BID: NO WORK. ALTERNATE #7: PNT-4	BASE BID: NO WORK. ALTERNATE #7: ACT-13	-	-	-	
229B	TR	BASE BID: NO WORK. ALTERNATE #7: FT-1	BASE BID: NO WORK. ALTERNATE #7: CB-1	BASE BID: NO WORK. ALTERNATE #7: WT-1,2,3,4 / TS-1	BASE BID: NO WORK. ALTERNATE #7: PNT-4	BASE BID: NO WORK. ALTERNATE #7: ACT-1 / PNT-5	-	BASE BID: NO WORK. ALTERNATE #7: SSM-2	-	ALTERNATE #7: PROVIDE TOILET PARTITIONS, TP-1
231	GIRLS TR	BASE BID: NO WORK. ALTERNATE #7: FT-1	BASE BID: NO WORK. ALTERNATE #7: CB-1	BASE BID: NO WORK. ALTERNATE #7: WT-1,2,3,4 / TS-1	BASE BID: NO WORK. ALTERNATE #7: PNT-4	BASE BID: NO WORK. ALTERNATE #7: ACT-1 / PNT-5	-	BASE BID: NO WORK. ALTERNATE #7: SSM-2	-	ALTERNATE #7: PROVIDE TOILET PARTITIONS, TP-1
232	MATH	ETR	ETR	ETR	ETR	ETR	-	BASE BID: NO WORK. ALTERNATE #5: SSM-2 / WS-2	-	
233	FACULTY	ETR	ETR	ETR	ETR	ETR	-	BASE BID: NO WORK. ALTERNATE #5: SSM-2 / WS-2	-	
C19	CORRIDOR	ETR / PTM	ETR / CB-1	ETR / WT-1,3,4,6,8 / TS-1,6	ETR / PNT-4	ETR / PNT-9	-	-	-	REINSTALL STORED ACT CEILING
C20	CORRIDOR	ETR	ETR / CB-1	ETR / WT-4,6,8 / TS-6	ETR	ACT-2 / PNT-2,5	-	-	-	PAINT VERTICAL FACES OF GWB SOFFITS PNT-2. PAINT HORIZONTAL FACES OF SOFFITS PNT-5.
SECOND FLOOR AREA C										
222	6TH GRADE	ETR	ETR	ETR / PTM (PNT-9)	ETR	ETR / PTM (PNT-9)	-	BASE BID: NO WORK. ALTERNATE #5: SSM-2 / WS-2	-	PAINT WALL CHASE TO MATCH EX. ADJ WALLS
224	6TH GRADE	ETR	ETR	ETR / PTM (PNT-9)	ETR	ETR / PTM (PNT-9)	-	BASE BID: NO WORK. ALTERNATE #5: SSM-2 / WS-2	-	PAINT WALL CHASE TO MATCH EX. ADJ WALLS
226	LEARNING CENTER K-6	ETR	ETR	ETR / PNT-1	ETR	ETR / PTM (PNT-9)	-	BASE BID: NO WORK. ALTERNATE #5: SSM-2 / WS-2	-	PAINT WALL CHASE TO MATCH EX. ADJ WALLS
228	LEARNING CENTER K-6	ETR	ETR	ETR / PTM (PNT-9)	ETR	ETR	-	BASE BID: NO WORK. ALTERNATE #5: SSM-2 / WS-2	-	PAINT WALL CHASE TO MATCH EX. ADJ WALLS
230	ENGLISH	ETR	ETR	ETR / PTM (PNT-9)	ETR	ETR	-	BASE BID: NO WORK. ALTERNATE #5: SSM-2 / WS-2	-	PAINT WALL CHASE TO MATCH EX. ADJ WALLS
SS-2	STAIR	ETR	ETR	ETR / PTM	ETR	ETR	-	-	-	REINSTALL STORED ACT CEILING AT DOOR

SED # MB-25-26-01-04-02-025 B0: 07-29-01-04-5-003-008

ROOM FINISH SCHEDULE

2025 CAPITAL IMPROVEMENTS PROJECT  
HAMMONDSPORT CENTRAL SCHOOL DISTRICT  
8272 MAIN STREET HAMMONDSPORT, NEW YORK, 14840

HUNT ENGINEERS ARCHITECTS | SURVEYORS  
HORSEHEADS, NY 607-658-1000  
ROCKY HILLS, CT 860-432-7666  
TOWANDA, PA 870-265-4668  
BINGHAMTON, NY 607-738-8881  
ALBANY, NY 607-738-8881  
WWW.HUNTEAS.COM

NY CERTIFICATE NO. 0016250 PA CERTIFICATE NO. TSC2020131464-1

DESCRIPTION OF REVISION:  
ISSUE FOR BID  
#

