

ELMIRA CIVIL WAR VISITOR CENTER

PHASE I

ELMIRA, NEW YORK

CONTRACT NOTES

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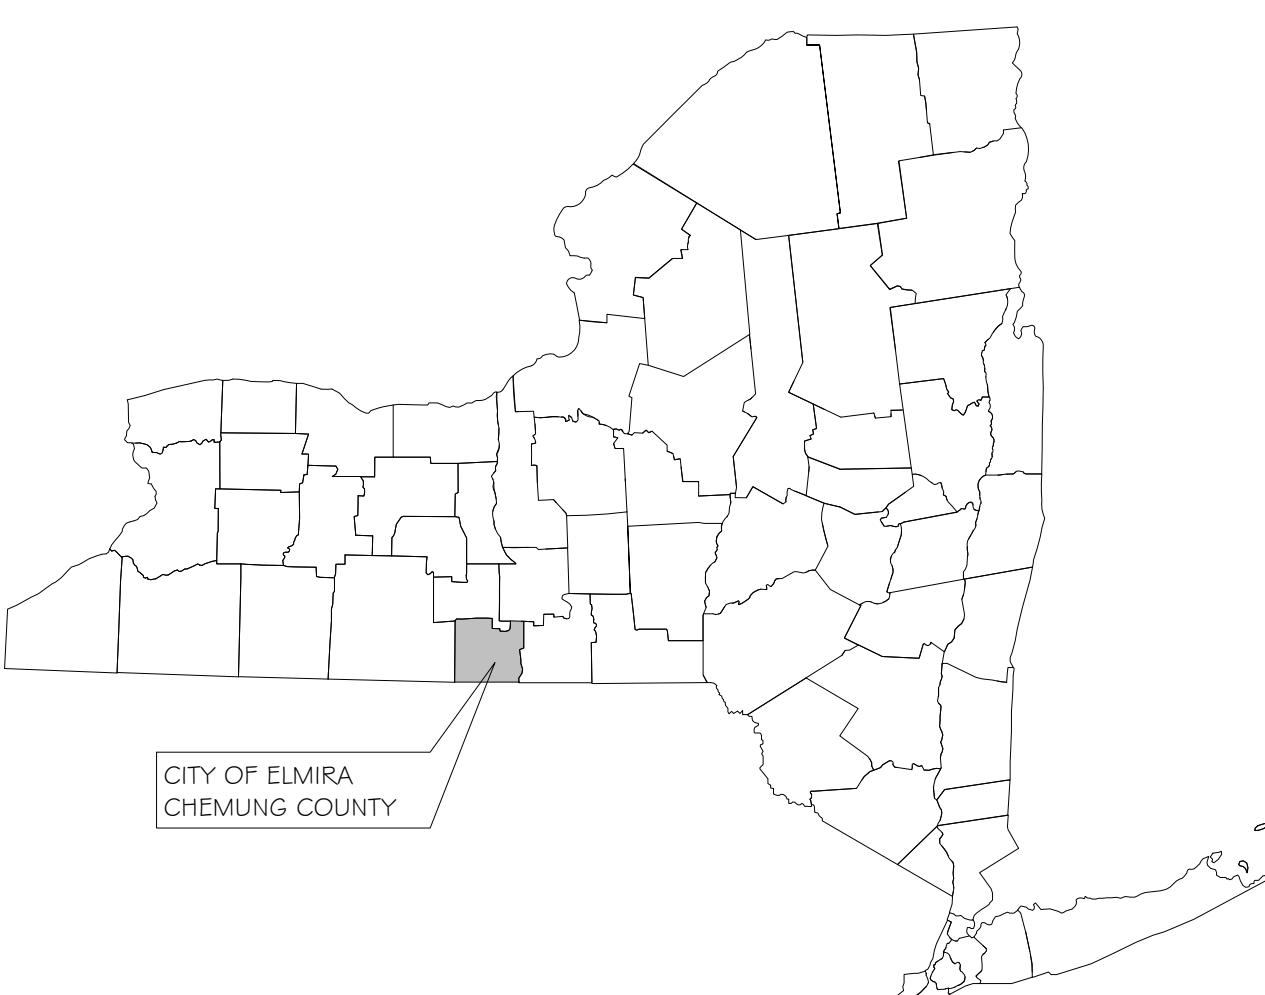
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| | |
|------------------------------------|--|
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| CS | COVER SHEET |
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PROJECT LOCATION MAPS

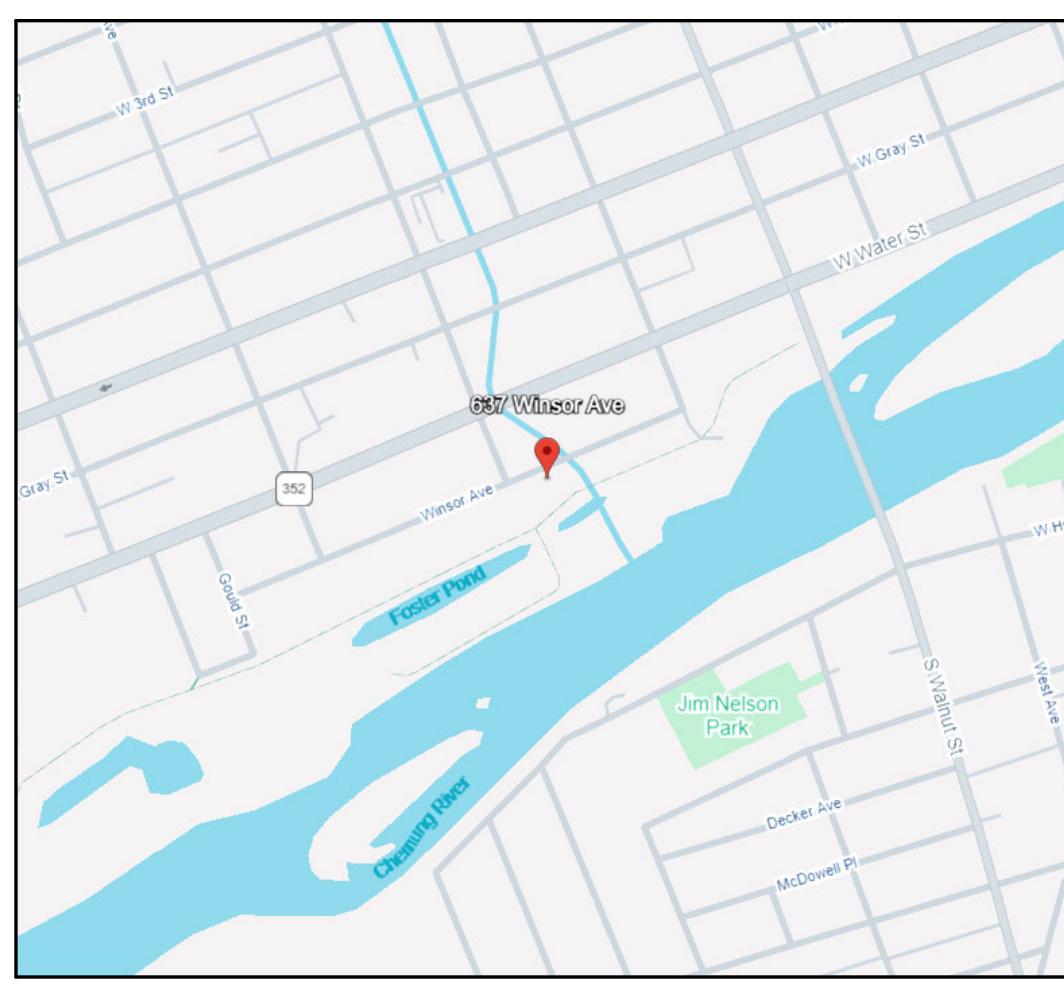
STATE/COUNTY

FIMIRA CHEMUNG NEW YORK



LOCATION MAP

637-639 WINSOR AVE FL MIRA NY 14901



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NOT APPROVED

| | | | |
|--|--|---|------------------|
| PROJECT ELMIRA CIVIL WAR VISITOR CENTER | | ISSUED / REVISIONS 0 | DATE 01-05-26 |
| DRAWING SCALE AS NOTED | | TITLE OF DRAWING COVER SHEET | |
| ISSUE DATE: 01.05.26 | | OWNER/CLIENT | |
| PROJECT NO. 25-086 | | FRIENDS OF ELMIRA CIVIL WAR PRISON CAMP | |
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| SITWORK | | PLUMBING | | HVAC | | ELECTRICAL & TECHNOLOGY | | | | | | ARCHITECTURAL | | FIRE & LIFE SAFETY | | | |
|-------------------------------------|-------------------------------|----------|--|--------|--|-------------------------|----------------------------------|---|---------------------------|---|----------------------------------|--|--|--|---|--|------------------------|
| SYMBOL | DESCRIPTION | SYMBOL | DESCRIPTION | SYMBOL | DESCRIPTION | SYMBOL | DESCRIPTION | MFC./NO. & REMARKS | SYMBOL | DESCRIPTION | MFC./NO. & REMARKS | SYMBOL | DESCRIPTION | SYMBOL | DESCRIPTION | | |
| | CONTROL POINT | | VOLUME DAMPER | | DUCT W/ MANUAL VOLUME DAMPER | | CEILING MOUNT SPEAKER | INTERIOR: BOSCH LBC308G/41 EXTERIOR: POLY PLANER MA4056-6" | | MULTI COMPARTMENT SURFACE RACEWAY | | | ROOM NAME, #, & APPROXIMATE AREA | | EARTH / COMPACT FILL | | |
| | UTILITY POLE W ANCHOR | | NATURAL GAS PIPING | | SUPPLY AIR DIFFUSER | | WALL MOUNT SPEAKER | | | WALL MOUNT STYLE CAT. 6 TELEPHONE OUTLET | | | BUILDING SECTION CALLOUT | | POROUS FILL / GRAVEL | | |
| | SIGN | | BELLOW SLAB SANITARY PIPING | | GRILLE OR REG. | | CEILING MOUNTED OCCUPANCY SENSOR | | | CATEGORY 6 TELEPHONE OUTLET # = QTY. OF OUTLETS IF GREATER THAN ONE | | | WALL SECTION / DETAIL SECTION | | CONCRETE / STRUCTURAL CONCRETE | | |
| | EX. WATER VALVE | | ABOVE SLAB SANITARY PIPING | | FIRE DAMPER | | SINGLE POLE SWITCH | PASS & SEYMOUR CS20AC1 | | IP TELEPHONE LOCATION #### = PHONE TYPE | | | INTERIOR ELEVATION CALLOUT | | SAND / ARCHITECTURAL PRECAST CONCRETE | | |
| | NEW WATER VALVE | | BELLOW SLAB STORM (ROOF DRAINAGE) PIPING | | THERMOSTAT | | 3 WAY SWITCH | PASS & SEYMOUR CS20AC3 | | 4 WAY SWITCH | PASS & SEYMOUR CS20AC4 | | HORN TYPE SPEAKER | | EXTERIOR ELEVATION CALLOUT | | |
| | UTILITY POLE W/ LIGHT | | ABOVE SLAB STORM (ROOF DRAINAGE) PIPING | | THERMOSTAT W/ GUARD | | SENSOR | | | OCCUPANCY SENSOR SWITCH | SENSOR SWITCH WSD-PDT | | SPEAKER VOLUME CONTROL | | DETAIL / TITLE NUMBER | | |
| | STREET LIGHT | | SANITARY VENT PIPING | | MITERED ELBOW W/ TURNING VANES | | LOW VOLTAGE SWITCH | DUAL TECHNOLOGY | | DUPLEX RECEPTACLE | PASS & SEYMOUR PS5362 20A RATING | | GFI RECEPTACLE | PASS & SEYMOUR PS2095 20A RATING, 120V | | WEATHERPROOF RECEPTACLE PASS & SEYMOUR PS2094 20A RATING, INSTALLED W/ WATER TIGHT HOUSING | |
| | EX. FIRE HYDRANT | | CONDENSATE DRAIN PIPING | | EXISTING PIPING TO REMAIN | | FIRST # IS DUCT WIDTH SIZE | | | POINT OF CONNECTION | | | PROJECTOR | | | INTERACTIVE BOARD | |
| | NEW FIRE HYDRANT | | EXISTING PIPING & EQUIP. TO BE REMOVED | | CHECK VALVE | | DUCT DOWN | | | DUCT UP | | | INTERACTIVE BOARD | | ELEVATION INDICATOR | | |
| | CATCH BASIN / DRYWELL | | FLOOR PENETRATION | | DUCT PENETRATION THRU FLOOR OR ROOF ABOVE SUPPLY | | QUADPLEX | PASS & SEYMOUR PS52G2 | | SPECIAL PURPOSE RECEPTACLE | PROVIDE 30A RECEPTACLE FOR DRYER | | AUDIO / VIDEO CONNECTIONS TO PROJECTOR | | CASEWORK NUMBER & TYPE - REFER TO CASEWORK SCHEDULE | | |
| | EXISTING DECIDUOUS TREE | | ACID WASTE | | ACID VENT | | FUSED DISCONNECT | CULTER-HAMMER/ SQUARED | | JUNCTION BOX | | | INTERCOM | | SECURITY CAMERA # = CAM NUMBER | | |
| | EXISTING CONIFEROUS TREE | | EX. ELEVATION | | HOT WATER SUPPLY PIPING | | HOT WATER RETURN PIPING | | | AUTOMATIC DAMPER | | | MOTOR | | COMMUNICATIONS RACEWAY DEVICE LOCATION | | |
| | NEW ELEVATION | | CONDENSATE DRAIN PIPING | | REFRIGERANT SUCTION PIPING | | REFRIGERANT LIQUID PIPING | | GRILLE NUMBER CFM | | REGISTER NUMBER CFM | | DATA/TELEPHONE NETWORK JACK | PROVIDE BOX & 3/4" CONDUIT TO 6" ABOVE FIN. CEILING/ CONCEALED SPACE | | DATA #=QUANTITY DATA DROPS | CATEGORY 6 DATA OUTLET |
| | EXISTING CULVERT | | EX. PIPING & EQUIPMENT TO REMAIN | | (OR) ◀ | | | | CARD/PROXIMITY READER | MOUNT AT 4'-6" AFF. PROVIDE CONDUIT & BACK BOX. | | DOOR CONTACT | REFER TO DOOR HARDWARE SPECIFICATIONS | | EMERGENCY LIGHTING | SEE LIGHTING FIXTURE SCHEDULE | |
| | NEW CULVERTS WITH END SECTION | | TEST PIT | | TEST HOLE | | RIP RAP | | COORDINATE POINT LOCATION | | | BALANCING VALVE/ AUTO. FLOW CONTROL FITTING/ SPRINKLER UPRIGHT | | | COAXIAL CABLE TV OUTLET | PROVIDE BOX & 3/4" CONDUIT TO 6" ABOVE FIN. CEILING/ CONCEALED SPACE | |
| | 5/8" REBAR W/ SURVEY CAP SET | | LINES SHOWN AS SCREENED (GRAY) DENOTE EXISTING | | NEW CONTOUR* | | EXISTING ELECTRIC* | | WATER LINE* | | SANITARY LINE* | | TELEPHONE LINE* | | STORM SEWER* | | |
| | OVERHEAD ELECTRIC* | | UNDERGROUND ELECTRIC* | | ROAD CENTER LINE* | | GAS LINE | | ORIGINAL LOT LINE | | DEED LINE | | PROPERTY LINE | | EXISTING FENCE | | NEW FENCE |
| | GUARD RAIL | | EASEMENT LINE | | CONCRETE MONUMENT | | EXISTING IRON ROD | | EXISTING IRON PIPE | | UTILITY POLE | | | | | | |
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AJH DESIGN

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PH: (607) 737-4638 WEB:AJH-DESIGN.COM

OWNER/CLIENT

PROJECT
LMIRA CIVIL WAR VISITOR CENTER
337-6339 WINSOR AVE
LMIRA, NY 14901

PRO EL 637 EL
DRAWING SCALE
AS NOTE
ISSUE DATE:
01.05.26
PROJECT NO.
25-086
DRAWING NO.

G-1

ABBREVIATIONS

| | | |
|---------|-------|-----------------------|
| A | CLG | CEILING |
| A/C | CLO | CLOSET |
| AB | CLR | CLEAR(ANCE) |
| ABV | CMP | CORRUGATED METAL PIPE |
| AC | CMU | CONCRETE MASONRY UNIT |
| ACT | CO | CLEANOUT, COMPANY |
| ACW | COL | COLUMN |
| AD | FD | FLOOR DRAIN |
| ADD | COMB | COMBINATION |
| ADH | COMP | COMPACT(ED) |
| ADJ | CONC | CONCRETE |
| ADO | CON | CONNECTOR, CONNECTION |
| AE | CONST | CONSTRUCTION |
| AFS | CONT | CONTINUOUS, CONTINUE |
| AFF | CONTR | CONTRACT(OR) |
| AFG | COORD | COORDINATE |
| AGG | CP | CLAY PIPE |
| AH | CPG | COPING |
| AL | CPR | COPPER |
| ALM | CPT | CARPET(ED) |
| AMP | CR | COLD ROLLED |
| ANC | CRS | COURSE(S) |
| ANOD. | CS | COVER SHEET |
| APPROX. | C5MT | CASEMENT |
| ARCH | CST | CAST STONE |
| ASB | CT | CERAMIC TILE |
| ASBC | CTR | COUNTER |
| ASPH | CU | CUBIC |
| AWG | CULV | CULVERT |
| AWN | CV | CHECK VALVE |
| AUX | CW | COLD WATER |
| | CY | CUBIC YARD |

B

| | |
|-------|---------------------------------|
| BCU | BLower Control Unit |
| BCJ | BRICK CONTROL JOINT |
| BCNYS | BUILDING CODE OF NEW YORK STATE |
| BD | BOARD |
| BEJ | BRICK EXPANSION JOINT |
| BEL | BELOW |
| BEV | BEVELED |
| BEF | BOARD FEET |
| BEL | BELOW |
| BF | BOARD FEET |
| BIT | BITUMINOUS |
| BL | BUILDING LINE |
| BLDG | BUILDING |
| BLK | BLOCK |
| BLKG | BLOCKING |
| BM | BENCH MARK |
| BO | BOTTOM OF |
| BOF | BOTTOM OF FOOTING |
| BOT | BOTTOM |
| BSMT | BASEMENT |
| BTU | BRITISH THERMAL UNIT |
| BTUH | BRITISH THERMAL UNIT PER HOUR |
| BPL | BEARING PLATE |
| BRD | BOARD |
| BRG | BEARING |
| BRK | BRICK |
| BRM | BEDROOM |
| BS | BOTH SIDES |
| BUR | BUILT-UP ROOF |
| BW | BOTH WAYS |

C

| | |
|------|---------------------------|
| C | CHANNEL |
| C-C | CENTER TO CENTER |
| CAB | CABINET |
| CAP | CAPACITY |
| CB | CATCH BASIN |
| CBF | HUNDRED BOARD FEET |
| CD | COLD DRAIN |
| CEM | CEMENT |
| CER | CERAMIC |
| CF | CUBIC FOOT |
| CFLG | COUNTER FLASHING |
| CFM | CUBIC FEET PER MINUTE |
| CFMF | COLD-FORMED METAL FRAMING |
| CF5 | CUBIC FEET PER SECOND |
| CH | CABINET HEATER |
| CHBD | CHALKBOARD |
| CI | CAST IRON |
| CIP | CAST-IN-PLACE CONCRETE |
| CIR | CIRCLE |
| CJ | CONTROL JOINT |
| CK | CAULK(ING) |
| CL | CENTERLINE |
| CLAD | ALUMINUM CLAD |

E

| | |
|-----|-----------------------|
| FA | FIRE ALARM, FRESH AIR |
| FAB | FABRICATE |

| | |
|-------|---------------------------|
| FAI | FRESH AIR INTAKE |
| FAS | FASTENER |
| CLR | FACE BRICK |
| CLS | FINISHED BY OTHERS |
| FBO | FIBERBOARD |
| FC | FAN COIL |
| FCU | FAN COIL UNIT |
| FD | FLOOR DRAIN |
| FDN | FOUNDATION |
| FDR | FOLDING DOOR |
| FE | FIRE EXTINGUISHER |
| FEC | FIRE EXTINGUISHER CABINET |
| FF | FINISHED FLOOR |
| FFE | FINISH FLOOR ELEVATION |
| FG | FIBERGLASS |
| FGL | FIGURE |
| FIN | FINISH(ED) |
| FLCO | FLOOR CLEANOUT |
| FLEX | FLEXIBLE |
| FLG | FLASHING |
| FLOUR | FLOURESCENT |
| FLR | FLOOR(ING) |
| FO | FRAMED OPENING |
| FOC | FACE OF CONCRETE |
| FOF | FACE OF FINISH |
| FOM | FACE OF MASONRY |
| FOS | FACE OF STUDS |
| FP | FIRE PROOF |
| FPL | FLOOR PLATE |
| FR | FRAME(D), FRAMING |
| FRT | FIRE-RETARDANT |
| FS | FRAME SIZE |
| FT | FOOT, FEET |
| FTG | FOOTING |
| FUR | FURRED, FURRING |
| FURN | FURNITURE |
| FXT | FIXTURE |

G

| | |
|------|--------------------------|
| G | GAS |
| GA | GAGE, GAUGE |
| GALV | GALVANIZD |
| GB | GRAB BAR |
| GC | GENERAL CONTRACT(OR) |
| GCMU | GLAZED CMU |
| GD | GRADE, GRADING |
| GF | GRANULAR FILL |
| GFI | GROUND FAULT INTERRUPTER |
| GI | GALVANIZED IRON |
| GL | GLASS, GLAZING |
| GP | GALVANIZED PIPING |
| GPM | GALLONS PER MINUTE |
| GSS | GALVANIZED STEEL SHEET |
| GST | GLAZED STRUCTURAL TILE |
| GVL | GRAVEL |
| GWB | GYPSUM WALL BOARD |
| GYP | GYPSUM |

E

| | |
|--------|--|
| EBCNYS | EXISTING BUILDING CODE OF NEW YORK STATE |
| EC | ELECTRICAL CONTRACTOR |
| EF | EACH FACE |
| EIFS | EXTERIOR INSULATED FASCIA SYSTEM |
| EJ | EXPANSION JOINT |
| EL | ELEVATION |
| ELEC | ELECTRICAL |
| ELEV | ELEVATOR |
| EMER | EMERGENCY |
| ENC | ENCLOSE, ENCLOSURE |
| ENG | ENGINEER |
| ENT | ENTRANCE |
| EOC | EVERY OTHER COURSE |
| EOD | EDGE OF DECK |
| EOS | EDGE OF SLAB |
| EP | ELECTRICAL PANEL |
| EQ | EQUAL |
| ES | EACH SIDE |
| EST | ESTIMATED(D) |
| EW | EACH WAY |
| EWC | ELECTRIC WATER COOLER |
| EWF | ELECTRIC WALL FAN |
| EXC | EXCAVATE |
| EXG | EXISTING |
| EXH | EXHAUST |
| EXP | EXPOSED |
| EXT | EXTERNAL, EXTERIOR |

F

| | |
|-----|-----------------------|
| FA | FIRE ALARM, FRESH AIR |
| FAB | FABRICATE |

| | |
|--------|----------------------------|
| INFO | INFORMATION |
| INS | INSULATE(D) |
| INSMTL | INSULATED METAL |
| INT | INTERIOR |
| INTERM | INTERMEDIATE |
| INV | INVERT (ELEVATION) |
| IP | IRON PIPE / IRON PIPE SIZE |

| | |
|-----|------------------|
| J | JANITOR'S CLOSET |
| JF | JOINT FILLER |
| JNT | JOINT |
| JST | JOIST |

| | |
|-----|-----------|
| K | KITCHEN |
| KO | KNOCKOUT |
| KPL | KICKPLATE |

| | |
|------|--------------------------------|
| L | LENGTH |
| LAB | LABORATORY |
| LAD | LADDER |
| LAM | LAMINATED |
| LAT | LATITUDE, LATITUDINAL |
| LAV | LAVATORY |
| LBL | LABEL |
| LED | LIGHT EMITTING DIODE |
| LF | LINEAR FOOT |
| LGMF | LIGHT GAUGE METAL FRAMING |
| LH | LEFT HAND |
| LIC | LICENSE(D) |
| LIN | LINEAR |
| LINO | LINOLEUM |
| LIQ | LIQUID |
| LKR | LOCKER |
| LL | LIVE LOAD |
| LLH | LONG LEG HORIZONTAL |
| LLV | LONG LEG VERTICAL |
| LMS | LIMESTONE |
| LONG | LONGITUDE, LONGITUDINAL |
| LP | LIGHT PLATE |
| LPT | LOW POINT |
| LRG | LARGE |
| LS | LANDSCAPE |
| LT | LIGHT |
| LTG | LIGHTING |
| LTL | LINTEL |
| LVL | LAMINATED VENEER LUMBER, LEVEL |
| LVR | LOUVER |

| | |
|-------|---------------------------|
| M | MACHINE |
| MAH | MAHOGANY |
| MAINT | MAINTENANCE |
| MANUF | MANUFACTURER |
| MAS | MASONRY |
| MATL | MATERIAL |
| MAX | MAXIMUM |
| MBF | MEMBER |
| MC | MECHANICAL CONTRACT(OR) |
| MDF | MEDIUM DENSITY FIBERBOARD |
| MDO | MEDIUM DENSITY OVERLAY |
| MED | MEDIUM |
| MECH | MECHANICAL |
| MEM | MEMBRANE |
| MFD | MANUFACURED |
| MFG | MANUFACTURING |
| MFR | MANUFACTUR(ER) |
| MGMT | MANAGEMENT |
| MGR | MANAGER |
| MH | MANHOLE |
| MIN | MINIMUM |
| MIR | MIRROR |
| MKBD | MARKERBOARD |
| MLD | MOULDING, MOLDING |
| MMB | MEMBRANE |

FIRE & LIFE SAFETY SYMBOLS

| | | | |
|--|--|---|---------------------------------|
| | EXIT SIGN W/DOOR HEAD EMERGENCY LIGHTS | | ACCESSIBLE ENTRANCE |
| | WALL MOUNTED PORTABLE FIRE EXTINGUISHER W/SIGNAGE | | FIRE PULL |
| | EGRESS PATH | | FIRE ALARM W/STROBE |
| | ALTERNATE EGRESS PATH | | HARD WIRED SMOKE DETECTOR |
| | AUDIOVISUAL DEVICE | | CARBON MONOXIDE DETECTOR |
| | FIRE ALARM PULL BOX STATION | | HEAT DETECTOR |
| | FIRE ALARM CONTROL PANEL | | RECESSED SPRINKLER HEAD |
| | DENOTES FUTURE PHASE WALLS | * | SEMI-RECESSED SPRINKLER HEAD |

PROJECT CODE INFORMATION

THE BUILDING SHALL BE IN COMPLIANCE WITH THE MOST RECENT VERSION OF THE FOLLOWING CODES:

- 2020 BUILDING CODE OF NEW YORK STATE (NYSC)
- 2020 ENERGY CONSERVATION CODE OF NEW YORK STATE (NYSECC)
- 2020 FIRE CODE OF NEW YORK STATE (NYSCF)
- 2020 MECHANICAL CODE OF NEW YORK STATE (NYSMC)
- 2020 PLUMBING CODE OF NEW YORK STATE (NYSPC)
- 2014 NATIONAL ELECTRICAL CODE (NEC)
- 2013 ICC/ANSI A117.1
- CURRENT NATIONAL FIRE PROTECTION ASSOCIATION (NFPA)

| EXISTING BUILDING INFO | | | | |
|------------------------------------|------------------|-------------|-----------------------|------------------|
| DESCRIPTION | NOTES | SECTION | | |
| CLASSIFICATION OF WORK | NEW CONSTRUCTION | -- | | |
| OCCUPANCY CLASS AND SQUARE FOOTAGE | NOTES | SECTION | | |
| ASSEMBLY (A-3) | A-3 | 5,295 | | NYSC 302-3.12 |
| | | 5,295 | TOTAL BUILDING | |
| CONSTRUCTION TYPE | NOTES | SECTION | | |
| A-3 | VB | -- | NYSBC G02 | |
| CONSTRUCTION TYPE REQUIREMENTS | | | | |
| BUILDING ELEMENT | RATING | CONST. TYPE | NOTES | SECTION |
| STRUCTURAL FRAME | O | VB | | |
| BEARING WALLS (EXT.) | O | VB | | NYSC TABLE G01 |
| BEARING WALLS (INT.) | O | VB | | |
| NON-BEARING WALLS (EXT.) | O | VB | | NYSC TABLE G02 |
| NON-BEARING WALLS (INT.) | O | VB | | |
| ROOF CONSTRUCTION | O | VB | | NYSC TABLE G01 |
| ALLOWABLE HEIGHTS AND AREA | | | | |
| BUILDING HEIGHT | ALLOWABLE | ACTUAL | NOTES | SECTION |
| ASSEMBLY (A-3) | 60 FT | 32 FT 1 IN | | NYSC TABLE 504.3 |
| NUMBER OF STORIES | NOTES | SECTION | | |
| ASSEMBLY (A-3) | 3 STORIES | 1 STORIES | | NYSC TABLE 504.4 |
| SQUARE FOOTAGE | NOTES | SECTION | | |
| ASSEMBLY (A-3) | 18,000 | 5,295 | | NYSC TABLE 506.2 |
| FIRE PROTECTION SYSTEMS | | | | |
| ELEMENT | REQUIRED | PROVIDED | NOTES | SECTION |
| SPRINKLER SYSTEM | NO | NO | | NYSC 903 |
| YARD HYDRANTS | N/A | NO | | NYSC 903 |
| STANDPIPE SYSTEMS | NO | NO | | NYSC 905 |
| PORTABLE FIRE EXTINGUISHERS | YES | YES | | NYSC 906 |
| FIRE ALARM/DETECTION SYSTEMS | NO | YES | SMOKE ALARMS PROVIDED | NYSC 907 |
| SMOKE AND HEAT VENTS | NO | NO | | NYSC 910 |

| CORRIDORS AND INCIDENTAL USE AREAS | | | | |
|------------------------------------|----------------------|----------------------------|-------------------|---------------------------------------|
| ELEMENT | RATING | NOTES | SECTION | |
| | | | | |
| OCCUPANT LOAD | | | | |
| FUNCTION OF SPACE | SQ. FT. | RATIO | OCCUPANTS | NOTES |
| ASSEMBLY, A-3 | 5,295 | 30 NET | 176 | |
| | | | | NYSC TABLE 1004.5 |
| | | | TOTAL OCCUPANTS | 176 |
| MEANS OF EGRESS | | | | |
| ELEMENTS | REQUIREMENT | NOTES | SECTION | |
| OCCUPANTS | 176 | RE: OCCUPANT LOAD ABOVE | | |
| DOORS & CORRIDORS | 0.2" x OCC LOAD | 36" WIDTH MINIMUM REQUIRED | | NYSC 1005 NYSC 1010 NYSC 1011.2 |
| STAIRS | 0.3" x OCC LOAD | | | NYSC TABLE 1017.2 |
| TRAVEL DISTANCE | 200 FT MAX | | | |
| TOTAL EXITS | | | FIRST FLOOR EXITS | 2 |
| | | | | NYSC 1006.3 |
| ENERGY COMPLIANCE | | | | |
| APPLICABILITY | CHANGE IN OCCUPANCY | MUST COMPLY WITH IECC | IECC 101 | |
| CLIMATE ZONE | 5A | | | NYSECC TABLE 301.1 |
| BUILDING ELEMENT | TYPE OF CONSTRUCTION | INSULATION REQUIREMENT | NOTES | SECTION |
| ROOF | ATTIC AND OTHER | R3.6 | | |
| WALLS, ABOVE GRADE | WOOD FRAMED | R-13 + R-3.8 CI OR R20 | | |
| WALLS, BELOW GRADE | BELOW GRADE WALL | R-7.5 CI | | |
| SLAB-ON-GRADE FLOORS | UNHEATED | R-10 FOR 24" BELOW | | |
| OPAQUE DOORS | SWING | U-.37 | | NYSECC 502 |

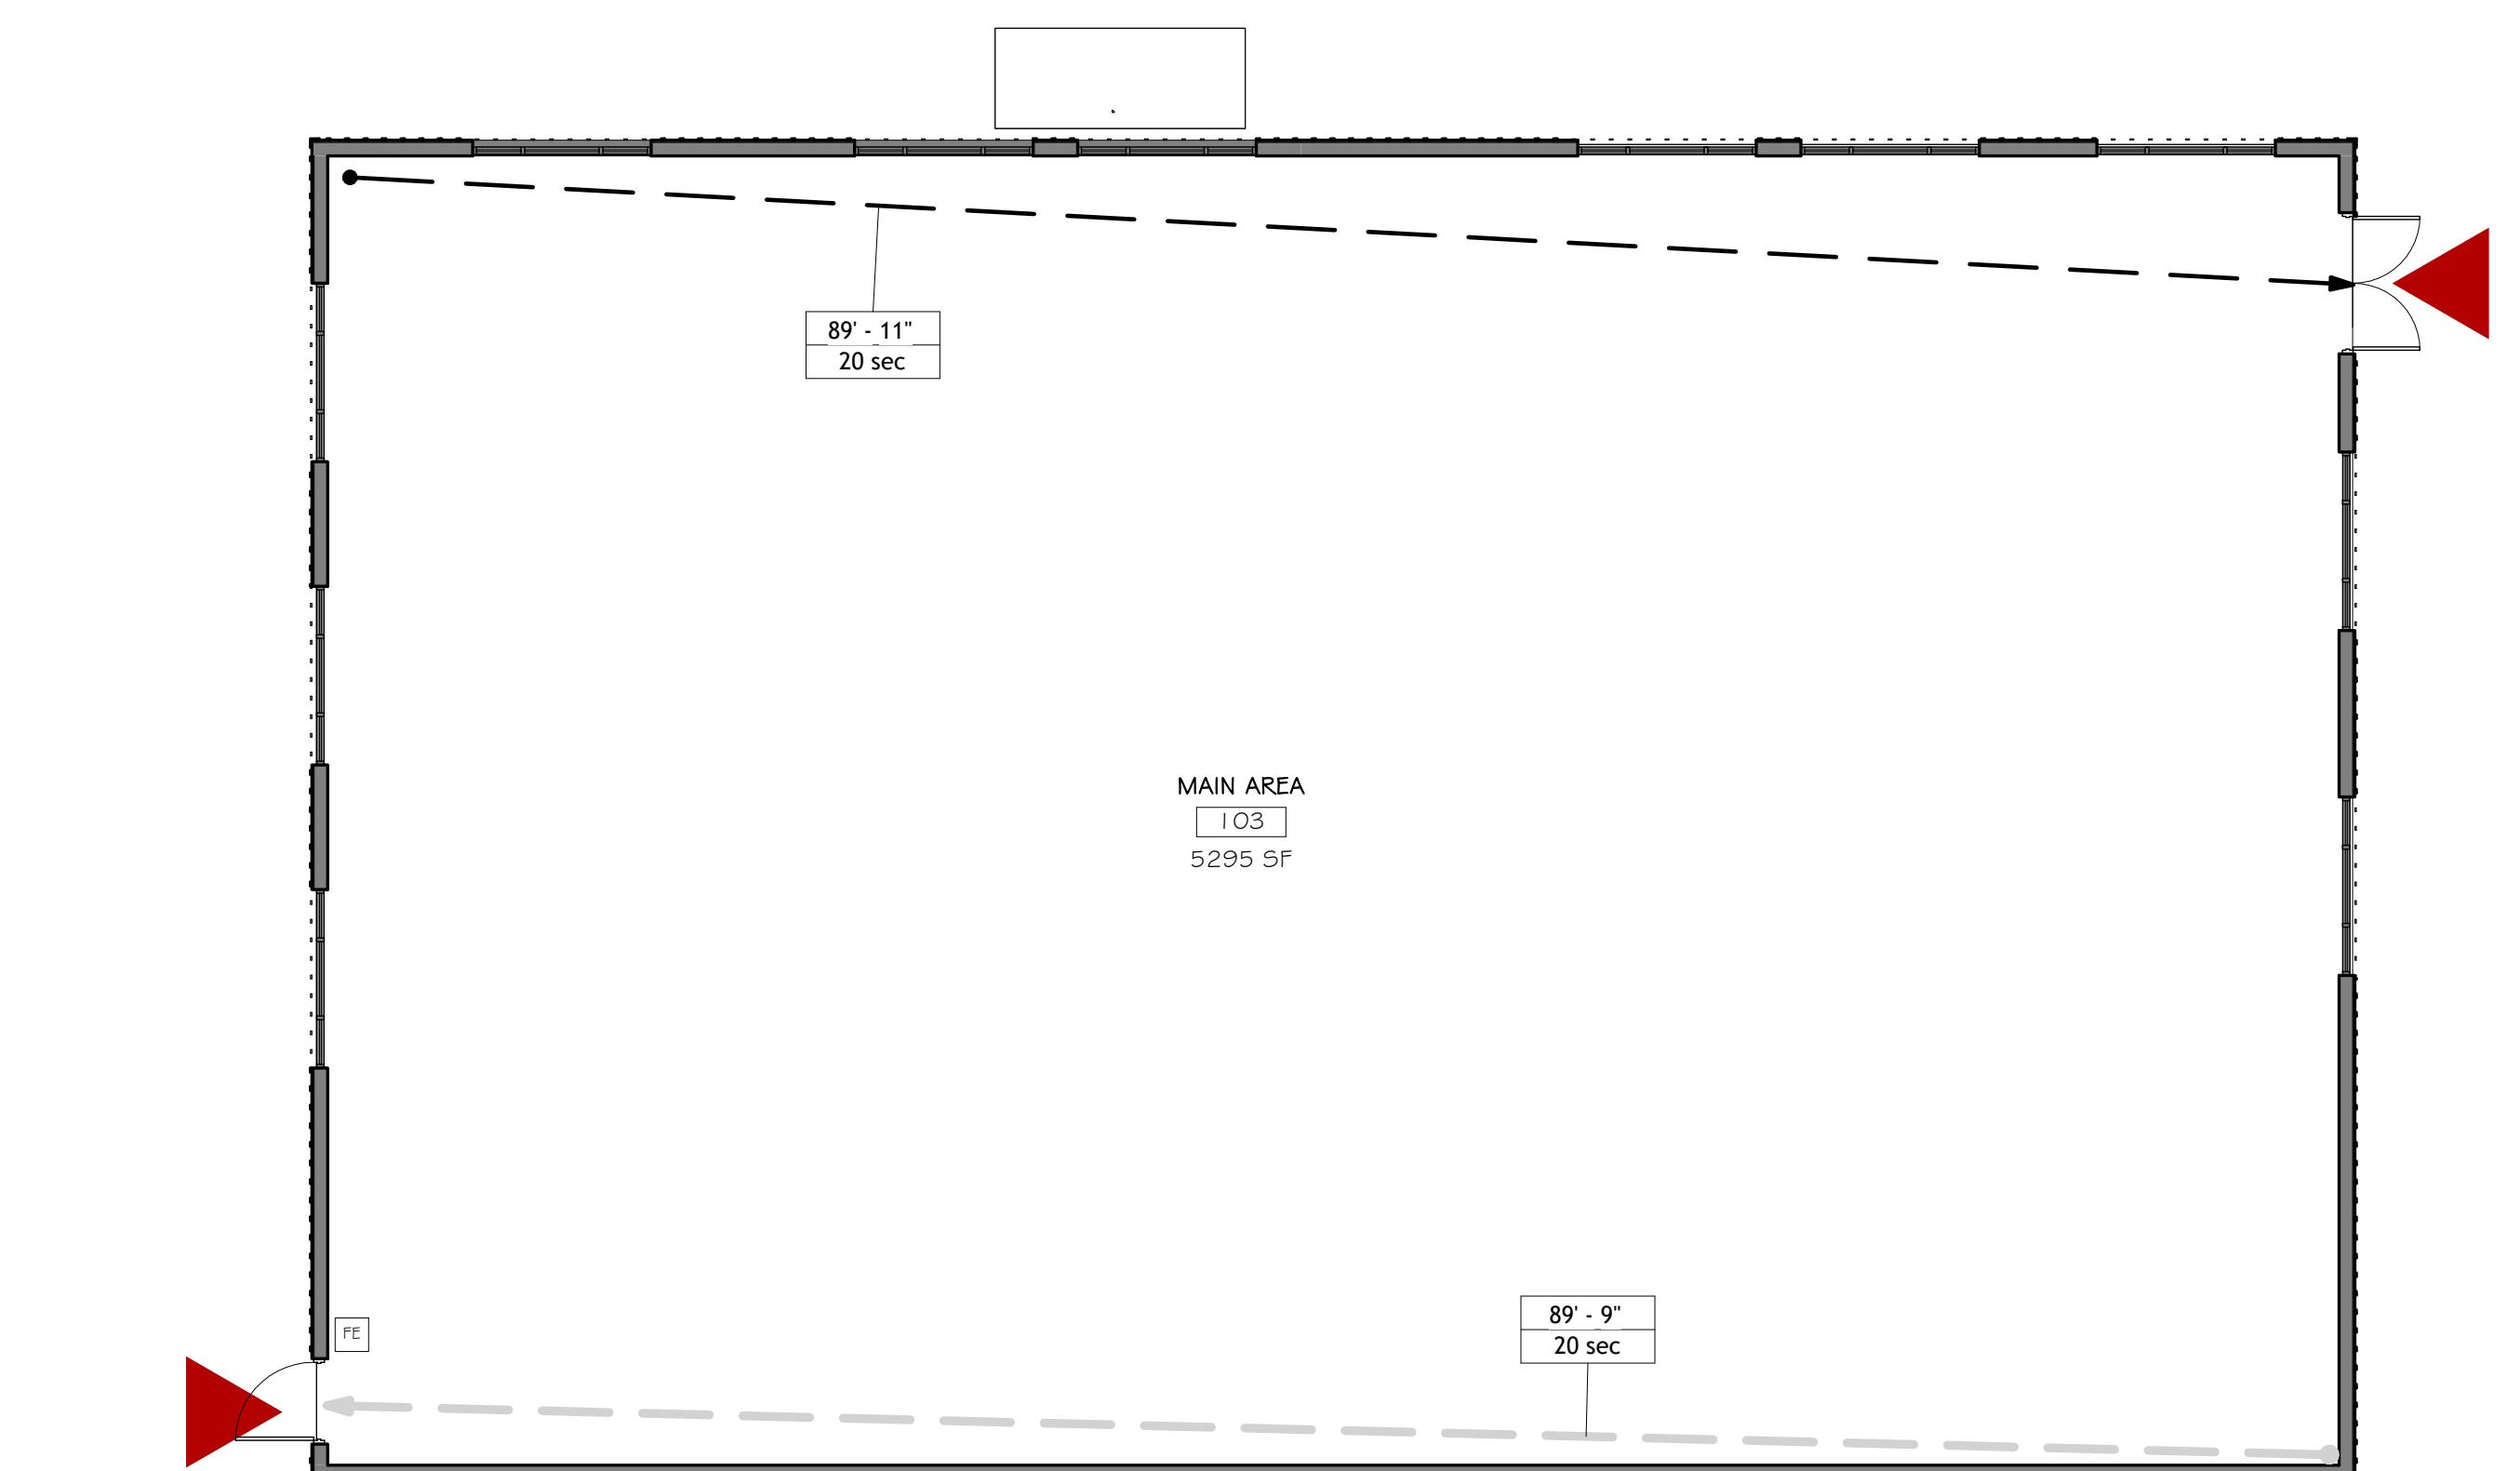
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| | 0 | 01-05-26 |

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|--|---------------------------|
| PROJECT ELMIRA CIVIL WAR VISITOR CENTER 637-639 WINSOR AVE ELMIRA, NY 14901 | DRAWING SCALE AS NOTED |
| | ISSUE DATE: 01.05.26 |

NOT APPROVED
THIS PLAN HAS NOT RECEIVED FINAL APPROVAL BY THE STATE OF NEW YORK. THE PLAN IS SUBJECT TO REVISIONS UNTIL ALL APPROVALS ARE OBTAINED AND SHOULD NOT BE USED FOR CONSTRUCTION PURPOSES.

PRELIMINARY
NOT FOR CONSTRUCTION
01.05.26
25-086
DRAWING NO.
C-1.1



ARCHITECTURAL SPECIFICATIONS

DIVISION 1 / GENERAL REQUIREMENTS

1.1 RE: CIVIL, STRUCT. MECH & ELEC FOR SPECIFICATIONS IN ADDITION TO THOSE DESCRIBED BELOW:

1.2 THE LOCALLY ADOPTED STATE BUILDING CODE (W/LEAST AMENDMENTS, BULLETINS, AND INTERPRETATIONS AN ALL ADOPTED & REFERENCED SUB-CODES, PUBLICATIONS, REPORTS (THE "CODE") APPLIES TO ALL CONSTRUCTION ACTIVITIES (THE "WORK") OF A NATURE AND INTENT INDICATED BY THESE CONSTRUCTION DRAWINGS, SPECIFICATIONS, APPENDA, ETC. (THE "DOCUMENTS") AT THE STRUCTURE, BUILDING, AND/OR PROJECT/SITE (THE "WORK AREA") REFERENCED HEREIN. THE GENERAL CONTRACTOR (THE "CONTRACTOR" OR "G.C.") SHALL VERIFY ALL CODE REQUIREMENTS BEFORE COMMENCEMENT OF WORK AND BRING ANY DISCREPANCIES BETWEEN CODE REQUIREMENTS AND THE CONSTRUCTION DOCUMENTS TO THE ATTENTION OF THE ARCHITECT/ENGINEER. ALL TRADES, I.E. MECHANICAL, ELECTRICAL, AND PLUMBING SUBCONTRACTORS OR INDEPENDENTLY CONTRACTED INDIVIDUAL TRADE CONTRACTORS (THE "CONTRACTORS"), SHALL PERFORM ALL WORK IN ACCORDANCE WITH ANY AND ALL APPLICABLE CODES CURRENTLY IN EFFECT AT THE TIME OF CONSTRUCTION. CONSTRUCTION "ELEMENTS" OR "COMPONENTS" ARE SPECIFIC PORTIONS OF THE PROJECT SCOPE OF WORK OR SITE CONDITIONS ADDRESSED BY THE DRAWING NOTATION.

1.3 OSHA REGULATIONS SHALL APPLY WHERE REQUIRED DURING THE COURSE OF THE WORK AS IT APPLIES TO WORKER SAFETY. CONTRACTOR SHALL DESIGNATE A SAFETY DIRECTOR WHO SHALL BE RESPONSIBLE FOR ALL OSHA SAFETY REQUIREMENTS, NOTHING CONTAINED IN THESE DOCUMENTS IN ANY WAY REQUIRES THE ARCHITECT, ENGINEER, OR OWNER TO BE RESPONSIBLE FOR ANY ASPECT OF SAFETY DURING CONSTRUCTION OR TO ENSURE THAT THE CONTRACTOR FOLLOWS WHATEVER SAFETY REGULATIONS MAY BE APPLICABLE.

1.4 ALL WORK SHALL BE IN CONFORMANCE WITH ALL FEDERAL, STATE, AND LOCAL CODES AND ACTS, MANUFACTURER'S RECOMMENDATIONS AND INDUSTRY STANDARDS OF GOOD PRACTICE.

1.5 ALL MATERIALS SHALL BE AS SPECIFIED AND/OR DETAILED, AND STORED AND INSTALLED IN A WORKMANLIKE MANNER, IN ACCORDANCE WITH APPLICABLE CODES, MANUFACTURERS' RECOMMENDATIONS, AND INDUSTRY STANDARDS OF GOOD PRACTICE ("AS REQUIRED").

1.6 ALL CONTRACTOR SHALL MAINTAIN THE PREMISES CLEAN AND FREE OF ALL TRASH, DEBRIS AND SHALL PROTECT ALL ADJACENT WORK FROM DAMAGE, SOILING, PAINT OVER SPRAY, ETC. ALL FIXTURES, EQUIPMENT, GLAZING, FLOORS, ETC., SHALL BE LEFT CLEAN AND READY FOR OWNER'S INTENDED USE UPON COMPLETION OF THE PROJECT.

1.7 THE CONTRACTORS SHALL BRING ERRORS AND OMISSIONS WHICH MAY OCCUR IN CONTRACT DOCUMENTS TO THE ATTENTION OF THE ARCHITECT/ENGINEER AND INSTRUCTIONS SHALL BE OBTAINED BEFORE PROCEEDING WITH AFFECTED WORK. THE GENERAL CONTRACTOR SHALL BE RESPONSIBLE FOR RECTIFYING UNACCEPTABLE RESULTS OF ANY ERRORS, DISCREPANCIES, OR OMISSIONS IN THE CONTRACT DOCUMENTS WHICH CAN READILY OR REASONABLY BE DETERMINED AND FOR WHICH THE CONTRACTOR FAILED TO NOTIFY THE ARCHITECT/ENGINEER BEFORE CONSTRUCTION AND/OR FABRICATION OF SUBJECT WORK. THE GENERAL CONTRACTOR SHALL VERIFY ALL CONDITIONS AND DIMENSIONS WITHIN THE CONTRACT LIMITS. DEVIATIONS FROM THE CONTRACT DOCUMENTS NECESSITATED BY FIELD CONDITIONS SHALL BE BROUGHT TO THE ATTENTION OF AND REVIEWED BY THE ARCHITECT/ENGINEER AND INSTRUCTIONS SHALL BE OBTAINED BEFORE PROCEEDING WITH WORK.

1.8 CONTRACTOR TO COORDINATE ALL DIMENSIONS ON PREFABRICATED ITEMS WITH MANUFACTURERS' INSTRUCTIONS.

1.9 CONTRACTOR RESPONSIBLE FOR SUPPLYING ALL RELATED ITEMS REQUIRED FOR CONSTRUCTION, UNLESS OTHER ARRANGEMENTS ARE MADE WITH OWNER. SPECIFIC ITEMS TO BE FURNISHED BY OWNER OR OTHERS ARE NOTED IN THESE DOCUMENTS.

1.10 CIVIL ENGINEERING AND SITE IMPROVEMENTS, GEOTECHNICAL, ENVIRONMENTAL, TELECOM, AUDIO-VISUAL, COMPUTER, AND SECURITY SYSTEMS, INTERIOR DESIGN & DOCUMENTATION PROVISIONS ARE NOT INCLUDED AS PART OF THE SCOPE OF THESE CONSTRUCTION DOCUMENTS UNLESS SPECIFICALLY NOTED HEREIN. THE GENERAL CONTRACTOR SHALL CONSULT WITH THE OWNER REGARDING THE COORDINATION OF THESE PROVISIONS WITH THE SCOPE OF WORK IDENTIFIED BY THESE DOCUMENTS AND ANY OTHER WORK REQUIRED BY THE OWNER RELATED TO THIS PROJECT AND/OR SUPPLEMENTAL OWNER PROVIDED DOCUMENTATION.

1.11 THE ARCHITECT, ENGINEER AND OWNER ARE NOT RESPONSIBLE FOR WORK COMPLETED BY CONTRACTOR(S) THAT DEVIATES FROM ADOPTED APPLICABLE CODES, OR THE INTENT OF THESE DOCUMENTS. THE G.C. SHALL RECTIFY ALL NON-COMPLIANCE ISSUES IN ORDER TO COMPLY WITH CODE AND THE INTENT OF THESE DOCUMENTS AT NO ADDITIONAL COST TO THE OWNER. ATTAINMENT OF A CERTIFICATE OF OCCUPANCY FOR THE OWNER IS REQUIRED BUT MAY NOT REPRESENT THE ENTIRETY OF THE SCOPE OF WORK THAT IS TO BE COMPLETED BY THE G.C. FOR THIS PROJECT.

1.12 ENLARGED DRAWINGS/DETAILS SHALL TAKE PRECEDENCE OVER SMALLER SCALE DRAWINGS.

1.13 DO NOT SCALE DRAWINGS, MATERIALS, GRAPHIC CONDITIONS AND DISTANCES SHOWN SHALL BE SUPERSEDED BY WRITTEN TEXT AND DIMENSIONS.

1.14 DETAILS AND SECTION ON THE DRAWINGS ARE TAKEN AT SPECIFIC LOCATIONS AND ARE INTENDED TO SERVE AS A REPRESENTATION OF TYPICAL CONSTRUCTION METHODOLOGY FOR ALL SIMILAR CONDITIONS. MODIFICATIONS SHALL BE MADE BY THE CONTRACTORS TO ACCOMMODATE MINOR VARIATIONS. IF MAJOR VARIATIONS FROM TYPICAL DETAILS AND SECTION ARE REQUIRED, G.C. SHALL NOTIFY ARCHITECT PRIOR TO PERFORMING SUCH WORK.

1.15 CONTRACTOR TO INSURE STABILITY AND SAFETY OF STRUCTURE AT ALL TIMES DURING THE CONSTRUCTION PERIOD. CONTRACTOR SHALL NOT OCCUPY ADJACENT PROPERTIES WITHOUT FIRST OBTAINING WRITTEN PERMISSION FROM PROPERTY OWNERS AND SUBMITTING A RECORD OF THIS PERMISSION TO THE OWNER FOR REVIEW AND APPROVAL.

1.16 SPECIAL PROVISIONS FOR RADON CONTROL HAVE NOT BEEN INCLUDED IN THE DESIGN OF THIS PROJECT. CONTRACTOR TO NOTIFY OWNER IF SITE CONDITIONS WARRANT THE INCLUSION OF POSITIVE RADON CONTROL SYSTEM IN THE SCOPE OF WORK FOR THIS PROJECT.

1.17 CONTRACTOR IS TO PROVIDE AN ENTIRELY FINISHED PRODUCT UPON COMPLETION OF CONSTRUCTION INCLUDING ANY FINAL REPAIRS OR WORK IDENTIFIED BY PUNCHLIST ITEMS TO THE SATISFACTION OF THE OWNER AND ENGINEER/ARCHITECT.

1.18 THE GENERAL CONTRACTOR SHALL GUARANTEE ALL WORKMANSHIP AND MATERIALS FOR A PERIOD OF ONE (1) YEAR MINIMUM OR AS OTHERWISE AGREED BY THE OWNER.

DIVISION 2 / SITE CONSTRUCTION

2.1 RE: CIVIL & STRUCTURAL FOR SPECIFICATIONS IN ADDITION TO THOSE DESCRIBED BELOW:

2.2 CONSULT THE CIVIL ENGINEERING DOCUMENTS CREATED FOR THIS SPECIFIC PROJECT. FOR ADDITIONAL SITE UTILITIES CONSTRUCTION INFORMATION, WHERE INFORMATION CONTAINED THEREIN DIFFERS FROM INFORMATION PROVIDED IN THESE DOCUMENTS, CONTRACTOR SHALL OBTAIN CLARIFICATION FROM THE CIVIL ENGINEER, NOTIFY THE ARCHITECT/ENGINEER, AND CONTINUE TO PERFORM THE WORK IN ACCORDANCE WITH THE MOST STRINGENT REQUIREMENTS UNLESS OTHERWISE DIRECTED.

2.3 GENERAL CONTRACTOR SHALL BE RESPONSIBLE FOR VERIFYING THE EXISTENCE AND LOCATION OF ALL UNDERGROUND UTILITIES AND SERVICES USING 'ONE-CALL' PROTOCOLS OR OTHER METHODS AS PER LOCAL JURISDICTION. UTILITIES SHALL BE VERIFIED PRIOR TO CONSTRUCTION AND THE G.C. SHALL COORDINATE THE CONNECTION INTO, REMOVAL OF AND/OR RELOCATION OF ABOVE-GROUND OR UNDERGROUND UTILITIES WITH OWNER AND LOCAL MUNICIPAL UTILITY AUTHORITIES / PUBLIC UTILITY COMPANIES AS REQUIRED TO MEET THE INTENT OF THIS PROJECT.

DIVISION 3 / CONCRETE

3.1 RE: STRUCTURAL

3.2 RE: MASONRY

DIVISION 4 / METALS

5.1 RE: STRUCTURAL FOR SPECIFICATIONS IN ADDITION TO THOSE DESCRIBED BELOW:

5.2 WHERE ALUMINUM IS ADJACENT TO STEEL, PROVIDE ADEQUATE BARRIER TO PREVENT OXIDATION OF ALUM.

DIVISION 6 / WOOD, PLASTICS, AND COMPOSITES

6.1 RE: STRUCTURAL FOR SPECIFICATIONS IN ADDITION TO THOSE DESCRIBED BELOW:

6.2 ALL MISCELLANEOUS WOOD SHALL BE DRY LUMBER (SEASONED TO A MOISTURE CONTENT OF 19% OR LESS), UNLESS PRESERVATIVE PRESSURE-TREATED. ALL WOOD PRODUCTS AND MATERIALS SHALL BE STORED, STAGED, AND INSTALLED DRY AND SHALL BE PROTECTED FROM MOISTURE TO GREATEST EXTENT PRACTICABLE. STANDING WATER SHALL BE IMMEDIATELY REMOVED FROM WOOD MATERIALS EXPOSED TO MOISTURE DURING CONSTRUCTION. PRESERVATIVE PRESSURE-TREATED LUMBER SHALL BE "ARSENIC-FREE".

6.3 ALL METAL AND/OR WOOD FRAMING MATERIALS SHALL BE FREE OF VISUALLY OBSERVABLE WARPING, CUPPING, CHECKING, AND OTHER SUBSTANTIVE IMPERFECTIONS THAT ADVERSELY AFFECT STRUCTURAL PERFORMANCE OR THE PROVISION OF PLUMB AND TRUE CONNECTIONS WITH OTHER FRAMING MEMBERS.

6.4 ALL WOOD TRIM EXPOSED TO THE ELEMENTS, OR IN CONTACT WITH EARTH, CONCRETE, OR MASONRY, SHALL BE ARSENIC-FREE PRESSURE-TREATED LUMBER.

6.5 THE CONTRACTOR SHALL PROVIDE ADEQUATE SUPPORTS AND/OR BACKING MATERIAL IN NEW OR EXISTING WALLS FOR EQUIPMENT AND/OR ACCESSORIES ATTACHED THERETO.

DIVISION 7 / THERMAL & MOISTURE PROTECTION

7.1 INSTALL EXTERIOR PAINTABLE URETHANE SEALANTS AND INTERIOR PAINTABLE SILICONE CAULKING (WITH BACKER ROD AND PRIMER TAPE WHERE INDICATED) AT ALL JOINTS WHERE SHOWN ON THE DRAWINGS AND ELSEWHERE AS REQUIRED (UNLESS NOTED OTHERWISE) TO PROVIDE A POSITIVE BARRIER AGAINST MOISTURE AND PASSAGE OF AIR. ELASTOMERIC SEALANTS SHALL COMPLY WITH ASTM C920 AND ASTM C1193.

7.2 BACKPAINT METAL FLASHINGS WITH BITUMINOUS PAINT WHERE IN CONTACT WITH CEMENTITIOUS MATERIALS OR DISSIMILAR METALS.

7.4 PROVIDE AND INSTALL VAPORMOISTURE RETARDER AS PER CODE, AS INDICATED ON DRAWINGS AND AS PER MANUFACTURER'S INSTRUCTIONS WITH CLASS A FLAME SPREAD AND SMOKE DEVELOPED VALUES.

7.5 EXTRUDED POLYSTYRENE BOARD INSULATION SHALL CONFORM TO ASTM C 578, OF TYPE IV, 1.50LB/CU.FT., DENSITY WITH A MAXIMUM FLAME SPREAD AND SMOKE DEVELOPED INDICES OF 75 AND 450 RESPECTIVELY.

7.7 PROTECT ALL INSULATION MATERIALS FROM PHYSICAL DAMAGE FROM DETERIORATION BY MOISTURE, SOILING, AND OTHER SOURCES. STORE INSIDE AND IN A DRY LOCATION.

7.8 CONCEALED INSULATION SHALL HAVE A FLAME SPREAD INDEX OF NO MORE THAN 25 AND A SMOKE-DEVELOPED INDEX OF NOT MORE THAN 450 IN ACCORDANCE WITH E 84.

7.9 METAL GUTTER AND RAINWATER CONDUCTOR COMPONENTS SHALL BE PROVIDED AND INSTALLED AS INDICATED ON DRAWINGS, AS PER CODE AND AS PER MANUFACTURER DIRECTIONS. ALL GUTTERS SHALL BE INSTALLED SO AS TO POSITIVELY DIRECT WATER TO CONDUCTORS. INSTALL LONGEST GUTTER LENGTHS AS PRACTICABLE AND PROVIDE APPROPRIATE SEALANTS AT SEAMS. POSITION GUTTERS SO THAT ICE THAT MAY SLIDE FROM ADJACENT SLOPED ROOFING BYPASSES TOP LEADING EDGE OF GUTTER.

7.10 PROVIDE AND INSTALL RAINWATER CONDUCTORS PLUMB AND TRUE AND FASTEN TO SUBSTRATE AS REQUIRED FOR SECURE ATTACHMENT CONSIDERING POTENTIAL DYNAMIC THRUST CREATED BY STORMWATER FLOW AND VOLUME. ALL FASTENERS AND SUPPORT ACCESSORIES SHALL BE OF THE SAME MATERIAL AS THE CONDUCTOR AND SHALL BE PROVIDED TO ELIMINATE THE POSSIBILITY OF GALVANIC CORROSION DUE TO DISSIMILAR METALS, PROVIDE PROTECTION OF CONDUCTOR AT BOTTOM RUNDOWN WHERE ADJACENT TO PAVING AS PER PLUMBING CODE PROVISIONS IN A METHOD ACCEPTABLE TO OWNER. COORDINATE LOCATION OF CONDUCTORS WITH UNDERGROUND STORMWATER PIPING SYSTEMS AS PER THE CIVIL ENGINEERING DESIGN AS APPLICABLE.

DIVISION 8 / DOORS AND WINDOWS

8.1 DOOR UNITS AND FRAMES SHALL BE PROTECTED DURING CONSTRUCTION. THE GENERAL CONTRACTOR SHALL REPAIR/ REPLACE ANY DAMAGE TO SUCH MATERIALS AND PRODUCTS AT NO ADDITIONAL COST TO THE OWNER.

8.2 ALL DOOR HEIGHTS TO BE AS INDICATED ON DOOR SCHEDULE. DOOR HEIGHT TO BE MODIFIED BY G.C. AS REQUIRED TO ACCOMMODATE VARIOUS FLOOR FINISHES, THRESHOLDS, ROUGH OPENINGS AND MECHANICAL DESIGN UNDERCUTS.

8.3 CONTRACTOR SHALL CONFORM TO THE ADOPTED ENERGY CODE AND VERIFY THAT MAXIMUM WINDOW AND DOOR INFILTRATION RATES ARE NOT EXCEEDED.

8.4 ALL DOORS, WINDOW, TRANSOMS, SIDELIGHTS, ETC. OPENING TO THE EXTERIOR OR TO UNCONDITIONED AREAS SHALL BE FULLY WEATHER STRIPPED, GASKETED OR OTHERWISE TREATED TO LIMIT AIR INFILTRATION.

8.5 GLAZING IN LOCATIONS WHICH MAY BE SUBJECT TO HUMAN IMPACT SUCH AS GLASS ENTRANCE DOORS, FIXED GLASS PANELS, DOOR LIGHTS, ETC. SHALL MEET THE REQUIREMENTS SET FORTH IN THE ADOPTED CONSTRUCTION CODE AND THE SAFETY STANDARD FOR ARCHITECTURAL GLAZING MATERIALS (16 CFR 1201). ALL GLAZED PANELS LOCATED WITHIN 12" OF A DOOR SHALL BE TEMPERED GLASS UNLESS SUCH PANELS ARE PROVIDED WITH A HORIZONTAL MEMBER 1-1/2" MINIMUM WIDTH LOCATED BETWEEN 24" AND 36" ABOVE THE ADJACENT WALKING SURFACE.

8.6 PROTECT ALL GLAZING MATERIALS ACCORDING TO MANUFACTURER'S WRITTEN SPECIFICATIONS AND AS REQUIRED TO PREVENT DAMAGE FROM CONDENSATION, TEMPERATURE CHANGES, DIRECT EXPOSURE TO SUN, OR ANY OTHER HARMFUL CONDITIONS.

8.7 GLAZING SHALL BE AS NOTED OR SCHEDULED ON THE DRAWINGS AND SHALL BE INSTALLED AS PER MANUFACTURER'S INSTRUCTION AND COORDINATED WITH THE ALUMINUM DOOR AND GLAZING FRAMING SYSTEMS. USE TEMPERED SAFETY GLAZING AS PER CODE. PROVIDE WINDLOAD DESIGN SUPPORT DATA FROM GLASS MANUFACTURER FOR ARCHITECT REVIEW PRIOR TO ORDERING GLAZING FOR THIS PROJECT. ALL EXTERIOR GLAZING SHALL BE INSULATED TYPE, FULLY GASKETED.

8.8 ALL EXTERIOR DOOR HARDWARE TO COMPLY WITH AMERICANS WITH DISABILITIES ACT (ADA) "ACCESSIBILITY GUIDELINES FOR BUILDINGS AND FACILITIES (ADAAG)" AND NFPA 101.

8.9 REFER TO DRAWINGS FOR DOOR TYPES, SIZES, FRAME DETAILS, AND HARDWARE SET DESIGNATIONS.

8.10 ALL DOORS SHALL BE STORED IN A THERMALLY CONTROLLED ENVIRONMENT ON SITE UNTIL INSTALLED. STORE DOORS UPRIGHT WITH HEADS UP AND BLOCKING BETWEEN DOORS TO PREVENT DAMAGE OR WARPING.

8.11 ALL LOCKS AND LOCKSETS SHALL BE COORDINATED WITH THIRD PARTY SECURITY CONTRACTOR AND/OR OWNER. VERIFY KEY QUANTITIES AND COPIES NEEDED AND ADHERE TO OWNER'S SECURITY POLICY FOR DOOR LOCKING ACCESSORIES.

8.12 ALL ALUMINUM STOREFRONT DOORS SHALL BE MANUFACTURED BY KAWNEER OR APPROVED EQUAL.

8.13 INTERIOR AND EXTERIOR STL DOORS SHALL BE MANUFACTURED BY STEELCRAFT OR APPROVED.

DIVISION 9 / FINISHES AND FINISH TREATMENTS

9.1 PRIOR TO PAINT APPLICATION, CLEAN WALL AND ENSURE ALL SURFACES ARE SOUND, LIGHTLY SAND AND PREPARE SURFACES AS NECESSARY.

9.2 APPLICATION OF PAINT OR OTHER COATING SHALL BE IN STRICT ACCORDANCE WITH MANUFACTURERS' DIRECTIONS. READY-MIXED PAINT SHALL NOT BE THINNED, EXCEPT AS PERMITTED IN THE APPLICATION INSTRUCTIONS.

9.3 ALL SURFACE TO BE FINISHED SHALL BE CLEAN AND FREE OF FOREIGN MATERIALS (DIRT, GREASE, ASPHALT, RUST, ETC.). APPLICATION SHALL BE IN A WORKMANLIKE MANNER PROVIDING A SMOOTH SURFACE. APPLICATION RATE SHALL BE THAT RECOMMENDED BY THE MANUFACTURER. APPLICATION MAY BE BY BRUSH OR ROLLER OR BY SPRAY IF PAINT IS FORMULATED FOR SPRAY APPLICATION. EXPOSED STEEL TO BE FINISHED AS INDICATED ON DRAWINGS.

9.4 SOLVENT-BASED COATINGS (IF APPLICABLE) - MANUFACTURER TO BE SELECTED BY OWNER - USE VOC-COMPLIANT MATERIALS THAT CONFORM TO THE LAWS IN THE JURISDICTION WHERE THE PROJECT IS LOCATED. CONTRACTOR TO PROVIDE AND INSTALL AS PER MANUFACTURER'S INSTALLATION INSTRUCTIONS, GENERAL PAINT USAGE PER SUBSTRATE;

9.5 DOORS: EXTERIOR FACES OF HOLLOW METAL FRAMES AND DOORS; 2 COATS SPRAY-APPLIED LOW VOC SOLVENT-BASED SEMI-GLOSS ENAMEL TOPCOAT ON FACTORY-PRIMED COATING.

INTERIOR FACES OF HOLLOW METAL FRAMES AND DOORS: 2 COATS SPRAY-APPLIED LATEX SEMI-GLOSS ENAMEL TOPCOAT ON FACTORY-PRIMED COATING. LATEX MATERIAL: USE "SHERWIN-WILLIAMS" "SUPERPAINT" (OR APPROVED EQUAL) G.C. TO PROVIDE AND INSTALL AS PER MANUFACTURER'S INSTALLATION INSTRUCTIONS.

STRUCTURAL STEEL: ONE COAT OF SHOP APPLIED APPROVED PRIME PAINT.

9.11 ALL FINISHES SPECIFIED SHALL BE INSTALLED AND/OR APPLIED PER MANUFACTURER'S SPECIFICATIONS PROVIDED AND ALL RELATED ACCESSORIES OR MATERIALS AS NEEDED FOR PROPER AND COMPLETE INSTALLATION.

DIVISION 10 / SPECIALTIES

10.3 PROVIDE FIRE EXTINGUISHERS DURING CONSTRUCTION AND AS OTHERWISE REQUIRED BY CODE FOR PERMANENT INSTALLATION AFTER CONSTRUCTION IS COMPLETE AND IN ACCORDANCE WITH THE REQUIREMENTS OF THE LOCAL FIRE OFFICIAL.

DIVISION 11 / EQUIPMENT

11.1 NO SPECIALIZED EQUIPMENT IS PROPOSED UNDER THIS CONTRACT. COORDINATE WITH OWNER OR THIRD PARTY CONTRACTORS AND RELATED N.I.C. EQUIPMENT FOR ANY SCHEDULING OR CONTRACTIBILITY CONCERN AS NEEDED.

DIVISION 12 / FURNISHINGS / CASEWORK

12.7 CONCEALED MATERIALS SHALL BE SOLID WOOD OR PLYWOOD, OF ANY HARDWOOD OR SOFTWOOD SPECIES WITH NO DEFECTS, AFFECTING STRENGTH OR UTILITY; PARTICLEBOARD, MDF, OR HARBORD.

12.8 HINGES SHALL BE CONCEALED EUROPEAN STYLE CLOSING HINGES. CASEWORK PULLS SHALL BE SELECTED BY OWNER AND ARCHITECT. PROVIDE PRODUCT DATA SUBMITTALS FOR FULL RANGE OF MANUFACTURERS PRODUCT LINE. DRAWER GUIDES SHALL BE EPOXY COATED METAL, SELF CLOSING, WITH BALL BEARING ROLLERS.

DIVISION 22 / PLUMBING

RE: PLUMBING

DIVISION 23 / HVAC - MECHANICAL

RE: MECHANICAL

DIVISION 26 / ELECTRICAL

RE: ELECTRICAL

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PROJECT
ELMIRA CIVIL WAR VISITOR CENTER
637-639 WINSOR AVE
ELMIRA, NY 14901
TITLE OF DRAWING
3
ARCHITECTURAL SPECIFICATIONS
DRAWING SCALE
AS NOTED
ISSUE DATE:
01.05.26
PROJECT NO.
25-086
DRAWING NO.
C-1.3

NOT APPROVED
THIS PLAN HAS NOT RECEIVED FINAL APPROVAL. IT IS THE RESPONSIBILITY OF THE OWNER TO ENSURE THAT THE PLAN IS SUBJECT TO REVISIONS UNTIL ALL APPROVALS ARE OBTAINED AND SHOULD NOT BE USED FOR CONSTRUCTION PURPOSES.

PRELIMINARY
NOT FOR CONSTRUCTION

NOT APPROVED
THIS PLAN HAS NOT RECEIVED FINAL APPROVAL. IT IS THE RESPONSIBILITY OF THE OWNER TO ENSURE THAT THE PLAN IS SUBJECT TO REVISIONS UNTIL ALL APPROVALS ARE OBTAINED AND SHOULD NOT BE USED FOR CONSTRUCTION PURPOSES.

1. GENERAL

- 1.1 BUILDING CODES & STANDARDS
 - A. NEW YORK BUILDING CODE - INTERNATIONAL BUILDING CODE (IBC), 2018 EDITION
 - B. AMERICAN SOCIETY OF CIVIL ENGINEERS (ASCE) - MINIMUM DESIGN LOADS FOR BUILDINGS & OTHER STRUCTURES, 2010 EDITION (ASCE 7).

1.4 GENERAL REQUIREMENTS

- C. VERIFY EXISTING CONDITIONS & DIMENSIONS PRIOR TO BEGINNING WORK, OR FABRICATING MATERIALS, NOTIFY STRUCTURAL ENGINEER OF RECORD (SER) OF ANY DISCREPANCIES BEFORE PROCEEDING WITH ANY PHASE OF WORK.
- D. DO NOT SCALE DRAWINGS FOR THE PURPOSE OF ESTABLISHING DIMENSIONS.
- E. DETAILS LABELED "TYPICAL DETAILS" ON DRAWINGS APPLY TO SITUATIONS OCCURRING ON THE PROJECT THAT ARE THE SAME OR SIMILAR TO THOSE SPECIFICALLY DETAILED. SUCH DETAILS APPLY WHETHER OR NOT DETAILS ARE REFERENCED AT EACH LOCATION. NOTIFY SER OF CONFLICT REGARDING APPLICABILITY OF "TYPICAL DETAILS".

- F. DO NOT LOAD THE SLAB ON GRADE OR SUPPORTED SLAB WITH ERECTION CRANES OR ERECTION EQUIPMENT. THE SLABS HAVE NOT BEEN DESIGNED FOR CRANE LOADS & WILL NOT INCREASE IN THICKNESS & OR REINFORCEMENT. OBTAIN SER APPROVAL ON PROPOSED CRANE SUPPORT PLAN FOR SLABS PRIOR TO COMMENCING WORK.
- G. DO NOT STORE OR STACK CONSTRUCTION MATERIALS ON Poured OR ERECTED FLOORS/ROOFS IN EXCESS OF 80 PERCENT OF LIVE LOAD. GENERAL CONTRACTOR SHALL ENSURE THAT ALL SUB-CONTRACTORS ARE INFORMED OF LOADING RESTRICTIONS. AVOID IMPACT WHEN PLACING MATERIALS ON Poured OR ERECTED FLOORS OR ROOFS.
- H. BEFORE PROCEEDING WITH ANY WORK WITHIN THE PROJECT AREA, THE CONTRACTOR SHALL FAMILIARIZE THEMSELVES WITH EXISTING STRUCTURE & OTHER CONDITIONS. IT SHALL BE THE CONTRACTOR'S RESPONSIBILITY TO PROVIDE ALL NECESSARY BRACINGS, SHORINGS & OTHER AFE GUARDS TO MAINTAIN ALL PARTS OF EXISTING STRUCTURES & FACILITIES IN A SAFE CONDITION DURING THE PROCESS OF DEMOLITION & CONSTRUCTION & TO PROTECT FROM DAMAGE THOSE PORTIONS OF EXISTING STRUCTURES & FACILITIES WHICH ARE TO REMAIN.

- I. THESE DRAWINGS REPRESENT THE COMPLETED PROJECT WHICH HAS BEEN DESIGNED FOR THE WEIGHTS OF MATERIALS INDICATED ON THE DRAWINGS & FOR THE SUPERIMPOSED LOADS INDICATED IN THE DESIGN LOADS. IT IS THE CONTRACTOR'S RESPONSIBILITY TO DETERMINE APPROPRIATE CONSTRUCTION LOADS & TO PROVIDE PROPER DESIGN & CONSTRUCTION OF FALSE WORK, STAGINGS, BRACING, SHEETING & SHORING, ETC.
- 1. THE CONTRACT STRUCTURAL DOCUMENTS REPRESENT THE FINISHED STRUCTURE. THE CONTRACTOR IS RESPONSIBLE FOR THE MEANS & METHODS OF CONSTRUCTION. PROVIDE ALL MEASURES REQUIRED TO PROTECT THE STRUCTURE, WORKMEN, & OTHER PERSONS DURING CONSTRUCTION; INCLUDING BRACING, SHORING FOR CONSTRUCTION EQUIPMENT, SHORING FOR THE BUILDING, FORMS & SCAFFOLDING, SHORING OF RETAINING WALLS & OTHER TEMPORARY SUPPORTS AS REQUIRED. COMPLY WITH APPLICABLE REQUIREMENTS OF OSHA & OTHER GOVERNING BODIES HAVING JURISDICTION AT THE SITE.
- 2. IMPLEMENTING JOB SITE SAFETY & CONSTRUCTION PROCEDURES ARE THE SOLE RESPONSIBILITY OF THE CONTRACTOR.
- 3. THE CONTRACTOR SHALL PROVIDE DRAWINGS & CALCULATIONS SIGNED & SEALED BY A STRUCTURAL ENGINEER REGISTERED IN THE STATE OF NEW YORK FOR THE FOLLOWING ASSEMBLIES. THE DESIGN OF THESE ASSEMBLIES IS THE RESPONSIBILITY OF THE ENGINEER WHO HAS SIGNED & SEALED THESE DRAWINGS & CALCULATIONS.
- a. WOOD TRUSS ROOF SYSTEM IN ITS ENTIRETY INCLUDING BUT NOT LIMITED TO TRUSSES, PURLINS, & BRACING, THESE ASSEMBLIES SHALL BE DESIGNED TO SUPPORT ALL GRAVITY & LATERAL LOADS REQUIRED IN THE DRAWINGS & INTERNATIONAL BUILDING CODE.

- J. PRINCIPAL OPENINGS THROUGH THE FRAMING ARE SHOWN ON DRAWINGS. COORDINATE WITH THE ARCHITECTURAL DRAWINGS FOR THE REQUIRED OPENINGS & PROVIDE FOR REQUIRED OPENINGS WHETHER SHOWN ON THE STRUCTURAL DRAWINGS OR NOT. DEVIATIONS FROM THE OPENINGS SHOWN ON THE STRUCTURAL DRAWINGS MUST BE APPROVED BY THE SER PRIOR TO IMPLEMENTING THE CHANGES.
- L. SEE ARCHITECTURAL DRAWINGS FOR STRUCTURE ELEVATIONS NOT INDICATED ON STRUCTURAL DRAWINGS & FOR ADDITIONAL INFORMATION FOR ALL SLAB DEPRESSIONS. THE CONTRACTOR SHALL REPORT ANY DISCREPANCIES TO THE SER PRIOR TO FABRICATING OR INSTALLING STRUCTURAL MEMBERS.

2. EARTHWORK & FOUNDATIONS

- 2.1 DESIGN DATA
 - A. FOUNDATION DESIGN IS BASED UPON IBC TABLE 1806.2 & AN ASSUMED ALLOWABLE BEARING CAPACITY OF 1,500 PSF.
 - B. ALL EXTERIOR FOUNDATIONS SHALL BEAR A MINIMUM OF 4'-0" BELOW GRADE.
 - C. BUILDING SPREAD FOOTINGS SHALL BEAR ON UNDISTURBED SOILS ON PROPERLY PLACED & COMPACTED STRUCTURAL FILL WITH AN ASSUMED ALLOWABLE BEARING PRESSURE OF 1,500 PSF.

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3. CONCRETE

3.1 FORMWORK

- A. STANDARDS
 - 1. AMERICAN CONCRETE INSTITUTE (ACI) - GUIDE TO FORMWORK FOR CONCRETE, ACI 347-04
 - 2. ACI - FORMWORK FOR CONCRETE SP-4, FIFTH EDITION.

- B. FORMWORK MAY BE OMITTED FOR FOUNDATIONS PROVIDED EARTH IS FIRM AND STABLE AND CONCRETE SURFACES WILL NOT BE EXPOSED TO PUBLIC VIEW.

- C. BEARING ELEVATIONS INDICATED ON THE DRAWINGS ARE ESTIMATED FROM EXPECTED SITE CONDITIONS. AN EXPERIENCED, QUALIFIED GEOTECHNICAL ENGINEER SHALL MAKE DETERMINATION OF FINAL BEARING ELEVATIONS & VERIFICATION OF ALLOWABLE BEARING PRESSURE.

- D. CONCRETE FOR FOUNDATIONS SHALL BE Poured ON THE SAME DAY SUBGRADE APPROVAL IS GIVEN BY THE GEOTECHNICAL ENGINEER.

- E. FOLLOWING REQUIRED STRIPPING OPERATIONS, ANY PROOFROLLING SHALL BE AS DIRECTED BY AN EXPERIENCED, QUALIFIED GEOTECHNICAL ENGINEER. THE PURPOSE OF THE PROOFROLLING WILL BE TO LOCATE ANY ISOLATED AREAS OF SOFT OR LOOSE SOILS REQUIRING IMPROVEMENT OR REPLACEMENT. SOFT AREAS SHALL BE UNDERCUT & REPLACED BY PROPERLY COMPACTED MATERIALS.

- F. ALL SHORING, SHEETING, & DEWATERING SHALL BE THE TOTAL RESPONSIBILITY OF THE CONTRACTOR. THE CONTRACTOR'S ENGINEER REGISTERED IN THE PROJECT'S JURISDICTION SHALL DESIGN SHEETING & SHORING. ALL SUBMITTALS SHALL BEAR THE ENGINEER'S SEAL & SIGNATURE.

- G. THE CONTRACTOR SHALL PROVIDE & OPERATE DEWATERING EQUIPMENT & BE RESPONSIBLE FOR MAINTAINING EXCAVATIONS & WORK AREAS IN A DRY CONDITION SATISFACTORY TO THE SER. WATER SHALL BE DISCHARGED TO A LOCATION SUITABLE TO THE SER & IN ACCORDANCE WITH APPLICABLE LOCAL STATE & FEDERAL LAWS & REGULATIONS.

- H. ARRANGE FOR OWNER'S INDEPENDENT TESTING AGENCY TO MONITOR CUT & FILL OPERATIONS & PERFORM FIELD DENSITY & MOISTURE CONTENT TEST TO VERIFY COMPACTION & APPROVE FOOTING SUBGRADE PRIOR TO PLACING CONCRETE.
- I. BACKFILL
 - A. ALL BACKFILL & TRENCHING OPERATIONS SHALL COMPLY WITH ALL CURRENT & APPLICABLE LOCAL, STATE, & FEDERAL SAFETY CODES, INCLUDING THE OCCUPATIONAL SAFETY & HEALTH ADMINISTRATION.
 - B. THE CONTRACTOR IS RESPONSIBLE FOR PROVIDING ADEQUATE SHORING OF THE NEW & EXISTING CONSTRUCTION DURING CONSTRUCTION OPERATIONS IN ORDER TO PREVENT ANY DAMAGE DUE TO BACKFILLING & TRENCHING.
 - C. ALL BACKFILL SHALL BE ACCOMPLISHED USING MATERIAL APPROVED BY THE GEOTECHNICAL ENGINEER, WITH OPTIMUM MOISTURE CONTENT FOR COMPACTING & SHALL BE FREE OF DEBRIS.
 - D. WHERE THE FINAL GRADE ELEVATIONS ARE APPROXIMATELY EQUAL ON BOTH SIDES OF A WALL, BACKFILL IN LISTS TO MAINTAIN LEVEL ELEVATIONS WITHIN 10" ON BOTH SIDES AT ANY TIME.

- J. 2.6 STRUCTURAL FILL

- A. COMPACTED STRUCTURAL FILL SHALL MEET N.Y.S. D.O.T. TYPE 4 REQUIREMENTS. INSPECTION OF THE PLACEMENT OF COMPACTED STRUCTURAL FILL SHALL BE BY AN EXPERIENCED, QUALIFIED GEOTECHNICAL ENGINEER.

- I. COMMONWEALTH OF PENNSYLVANIA DEPARTMENT OF TRANSPORTATION (PENNDOT) PUBLICATION 408, LATEST EFFECTIVE VERSION.

- B. INSPECTION OF THE PLACEMENT OF COMPACTED STRUCTURAL FILL SHALL BE BY AN EXPERIENCED, QUALIFIED GEOTECHNICAL ENGINEER.

- 1. GENERAL AGGREGATE...PENNDOT NO. 2A

- 2. CONTROLLED LOW STRENGTH MATERIAL... TYPE C (PUB 408) SECTION 220.
- C. EXECUTION
 - 1. AFTER ACHIEVING FINISHED SUBGRADE IN CUT AREAS & PRIOR TO PLACING STRUCTURAL FILL IN AREAS BELOW FINISHED SUBGRADE, THE EXPOSED SUBGRADE SHALL BE EVALUATED BY THE GEOTECHNICAL ENGINEER OF RECORD TO CONFIRM THAT ALL UNSUITABLE OR UNSTABLE MATERIALS HAVE BEEN REMOVED.
 - 2. ALL STRUCTURAL FILL SHALL BE PLACED IN HORIZONTAL LISTS NOT EXCEEDING EIGHT (8) INCHES IN LOOSE THICKNESS & WITHIN TWO (2) PERCENT OF OPTIMUM MOISTURE FOR COMPACTION. THE STRUCTURAL FILL SHALL BE COMPACTED TO 95 PERCENT OF MAXIMUM DRY DENSITY AS DETERMINED BY MODIFIED PROCTOR (ASTM D 557).
 - 3. MAINTAIN SUBGRADE & STRUCTURAL FILL MOISTURE CONTENT UNTIL FOUNDATIONS ARE PLACED.
 - 4. PROVIDE CLASS "B" REINFORCEMENT SPLICES FOR CONTINUOUS REINFORCEMENT. REINFORCEMENT SPLICES SHALL BE IN ACCORDANCE WITH THE FOLLOWING TABLE UNLESS NOTED OTHERWISE.

- 2.7 GRANULAR BASE MATERIAL

- A. A MINIMUM OF SIX (6) INCHES OF GRANULAR SUBBASE SHALL BE PLACED UNDER ALL CONCRETE SLABS-ON-GRADE.

- B. 2.8 FOUNDATIONS
 - A. ALL BEARING AREAS FOR FOUNDATIONS SHALL HAVE BEEN INSPECTED AND APPROVED BY THE GEOTECHNICAL ENGINEER OF RECORD PRIOR TO ANY PLACEMENT OF CONCRETE. IF BEARING AREAS ARE NOT SUITABLE, AS DETERMINED BY THE GEOTECHNICAL ENGINEER, THE CONTRACTOR MAY BE REQUESTED TO CARRY THE EXCAVATION DEEPER TO MORE SUITABLE BEARING MATERIAL. SUCH ADDITIONAL EXCAVATION WILL BE PAID FOR BY A LUMP SUM OR UNIT PRICE BASIS.
 - B. DO NOT PLACE FOOTINGS OR SLABS AGAINST SUBGRADE CONTAINING FREE WATER, FROST OR ICE.

- C. 3.3 CAST - IN - PLACE CONCRETE
 - A. STANDARDS
 - 1. ACI 301-16 - SPECIFICATIONS FOR STRUCTURAL CONCRETE.
 - 2. BUILDING CODE REQUIREMENTS FOR STRUCTURAL CONCRETE, ACI 318-08 & COMMENTARY, ACI 318R-08.
 - 3. RECOMMENDED PRACTICE FOR CONCRETE FLOOR & SLAB CONSTRUCTION, ACI 302.2-06.
 - B. MATERIALS
 - 1. PRIOR TO THE PLACEMENT OF ANY CONCRETE, CONTRACTOR SHALL SUBMIT CONCRETE MIX DESIGN(S) PERFORMED BY A QUALIFIED TESTING LABORATORY FOR SER'S REVIEW & APPROVAL. NO CALCIUM CHLORIDE OR ADMIXTURES CONTAINING CHLORIDES SHALL BE USED IN ANY CONCRETE. MIX MATERIALS SHALL BE PLACED WITH THE FOLLOWING:
 - a. PORTLAND CEMENT.....ASTM C 150
 - b. FLY ASH.....ASTM CG 18 CLASS C OR F
 - c. SILICA FUME.....ASTM C 1240
 - d. NORMAL WEIGHT AGGREGATE ASTM C33 CLASS 35
 - e. WATER.....ASTM C 94 POTABLE
 - f. AIR-ENTRAINING.....ASTM C 260
 - g. WATER-REDUCING.....ASTM C 494 TYPE A

- D. 4.1 STANDARDS
 - A. BUILDING CODE REQUIREMENTS FOR MASONRY STRUCTURES, ACI 530-08.
 - B. STANDARDS SPECIFICATION FOR MASONRY JOINT REINFORCEMENT, ASTM A95 1-02.

- E. 4.2 MATERIALS
 - A. LOAD-BEARING CONCRETE MASONRY UNITS (CMU).....ASTM C90 TYPE I, GRADE N, NET AREA COMPRESSIVE STRENGTH.....2,000 PSI

- F. 4.3 EXECUTION
 - A. ALL LOAD BEARING CMU WALLS REQUIRE INSPECTION. INSPECTION CONTROL SHALL BE ESTABLISHED TO ASSURE THAT THE MASONRY MATERIALS & CONSTRUCTION PRACTICES COMPLY WITH THE REQUIREMENTS OF THE CONTRACT DOCUMENTS.
 - B. ALL CMU WALLS ARE TO BE LAID IN RUNNING BOND, ALIGN ALL CELLS VERTICALLY TO MAINTAIN A CLEAR, UNBLOCKED SYSTEM OF FLUES.
 - C. WHEN PLACING CMU, FULLY MORTAR FACE SHELLS OF BED & HEAD JOINTS, EXCEPT AT FIRST COURSE ON TOP OF FOUNDATION WALL OR FOOTING, WHICH SHALL BE FULLY BEDDED IN MORTAR AT LEAST 1/4 INCH THICK BUT NOT MORE THAN 3/4 INCH THICK. TOOL ALL JOINTS, INSIDE & OUTSIDE, TO A CONCAVE, DENSE SMOOTH SURFACE.
 - D. ALL CMU WALLS SHALL HAVE GALVANIZED, STANDARDS WEIGHT (MINIMUM) TRUSS TYPE REINFORCEMENT SPACED VERTICALLY AT 16" OC MAXIMUM. PROVIDE CORNER & "TEE" SECTIONS OF REINFORCEMENT AT ALL WALL INTERSECTIONS. LAP ALL JOINT REINFORCEMENT 6 INCHES MINIMUM.
 - E. ALL CMU WALLS SHALL BE REINFORCED AS SHOWN ON THE DRAWINGS FOR THE FULL HEIGHT OF THE WALL. ALL LAP SPlices SHALL HAVE A MINIMUM LAP EQUAL TO 40 TIMES THE BAR DIAMETER. AVOID LAP SPlices AT POINTS OF MAXIMUM STRESS. GROUT ALL VERTICALLY REINFORCED CELLS SOLID BY PLACING GROUT IN LIFTS NOT EXCEEDING FIVE (5) FEET HIGH. REINFORCING SHALL BE LOCATED IN CENTER OF CELLS UNLESS NOTED OTHERWISE ON DRAWINGS. POSITION #1 HOLD REINFORCING IN PLACE BY THE USE OF PREFABRICATED STEEL WIRE BAR POSITIONERS. CONSOLIDATE GROUT WHEN PLACING BY USING A MECHANICAL VIBRATOR. RECONSOLIDATE BY MECHANICAL VIBRATION AFTER INITIAL WATER LOSS & SETTLEMENT HAS OCCURRED.
 - F. LINTELS BEARING ON CMU SHALL HAVE A MINIMUM BEARING LENGTH OF (8) INCHES UNLESS OTHERWISE NOTED. A MINIMUM OF TWO (2) MASONRY COURSES, 24 INCHES WIDE SHALL BE FULLY GROUTED FOR LINTEL BEARING.
 - G. ALL BOND BEAMS INDICATED ON DRAWINGS SHALL BE GROUTED SOLID.
 - H. FOR MASONRY OPENINGS EQUAL TO & GREATER THAN TWO (2) FEET IN EITHER DIRECTION, PROVIDE TWO (2) #5 BARS, FULLY GROUTED ON ALL SIDES OF THE OPENING. BARS SHALL EXTEND A MINIMUM OF TWO (2) FEET BEYOND EDGE OF OPENING. MECHANICAL OPENINGS THROUGH CMU WALLS FOR EQUIPMENT, PIPES, ETC. ARE TO BE PROVIDED WITH STEEL PIPE SLEEVES OR LINTELS, WHICH ARE PRE-INSTALLED IN THE CMU WALLS.
 - I. PROVIDE ADJUSTABLE MASONRY-VEENER ANCHORS THAT ALLOW VERTICAL ADJUSTMENT BUT RESIST TENSION & COMPRESSION FORCES PERPENDICULAR TO THE PLANE OF THE WALL, FOR ATTACHMENT OVER SHEATHING TO WOOD STUDS.
 - K. FOR CMU WALL ANCHORS TO STRUCTURAL STEEL MEMBERS, PROVIDE A HOMANN & BARNARD 351, 352 WIRE ANCHORS AT A MAXIMUM OF 32 INCHES O.C.
 - L. ALL EXPOSED MASONRY SPOTS & DROPPINGS, MASONRY WORK SHALL BE PROTECTED FROM DAMAGE DURING SUBSEQUENT CONSTRUCTION OPERATIONS. ALL COSTS NECESSARY TO REPAIR DAMAGED WALLS SHALL BE BORNE BY THE CONTRACTOR & SHALL BE DONE TO THE SATISFACTION OF THE SER.

- M. 4.4 WOOD PANELS
 - A. FACTORY-MARK EACH CONSTRUCTION PANEL WITH APA TRADEMARK EVIDENCING COMPLIANCE WITH GRADE REQUIREMENTS.
 - B. INSTALL PANELS WITH FACE GRAIN PERPENDICULAR TO THE SUPPORTING MEMBERS, UNLESS SHOWN OTHERWISE.

- N. 4.5 WOOD PRESERVATIVE TREATMENT
 - A. WHERE LUMBER OR PLYWOOD IS INDICATED AS "TREATED" OR "PRESSURE TREATED", COMPLY WITH APPLICABLE REQUIREMENTS OF AMERICAN WOOD PRESERVERS ASSOCIATION (AWPA) STANDARDS C2 (LUMBER) & C9 (PLYWOOD) & WITH AWPA STANDARDS LISTED BELOW. MARK EACH TREATED ITEM WITH THE AWPA QUALITY MARK REQUIREMENTS.
 - B. PRESSURE TREAT ABOVE-GROUND ITEMS WITH WATER-BORNE PRESERVATIVES TO COMPLY WITH AMERICAN WOOD PRESERVERS BUREAU (AWPB) LP-2. AFTER TREATMENT, KILN-DRY LUMBER & PLYWOOD TO A MAXIMUM MOISTURE CONTENT, RESPECTIVELY, OF 10 PERCENT & 15 PERCENT.
 - C. TREAT INDICATED ITEMS & WOOD SILLS, SLEEPERS, BLOCKING, & SIMILAR CONCEALED MEMBERS IN CONTACT WITH MASONRY OR CONCRETE.

- O. 5. METALS
 - A. SECTION NOT USED

- P. 5.1 METALS
 - A. SECTION NOT USED

- Q. 5.2 METALS
 - A. SECTION NOT USED

- R. 5.3 METALS
 - A. SECTION NOT USED

- S. 5.4 METALS
 - A. SECTION NOT USED

- T. 5.5 METALS
 - A. SECTION NOT USED

- U. 5.6 METALS
 - A. SECTION NOT USED

- V. 5.7 METALS
 - A. SECTION NOT USED

- W. 5.8 METALS
 - A. SECTION NOT USED

- X. 5.9 METALS
 - A. SECTION NOT USED

- Y. 5.10 METALS
 - A. SECTION NOT USED

- Z. 5.11 METALS
 - A. SECTION NOT USED

- A. 5.12 METALS
 - A. SECTION NOT USED

- B. 5.13 METALS
 - A. SECTION NOT USED

- C. 5.14 METALS
 - A. SECTION NOT USED

- D. 5.15 METALS
 - A. SECTION NOT USED

- E. 5.16 METALS
 - A. SECTION NOT USED

- F. 5.17 METALS
 - A. SECTION NOT USED

- G. 5.18 METALS
 - A. SECTION NOT USED

- H. 5.19 METALS
 - A. SECTION NOT USED

- I. 5.20 METALS
 - A. SECTION NOT USED

- J. 5.21 METALS
 - A. SECTION NOT USED

- K. 5.22 METALS
 - A. SECTION NOT USED

- L. 5.23 METALS
 - A. SECTION NOT USED

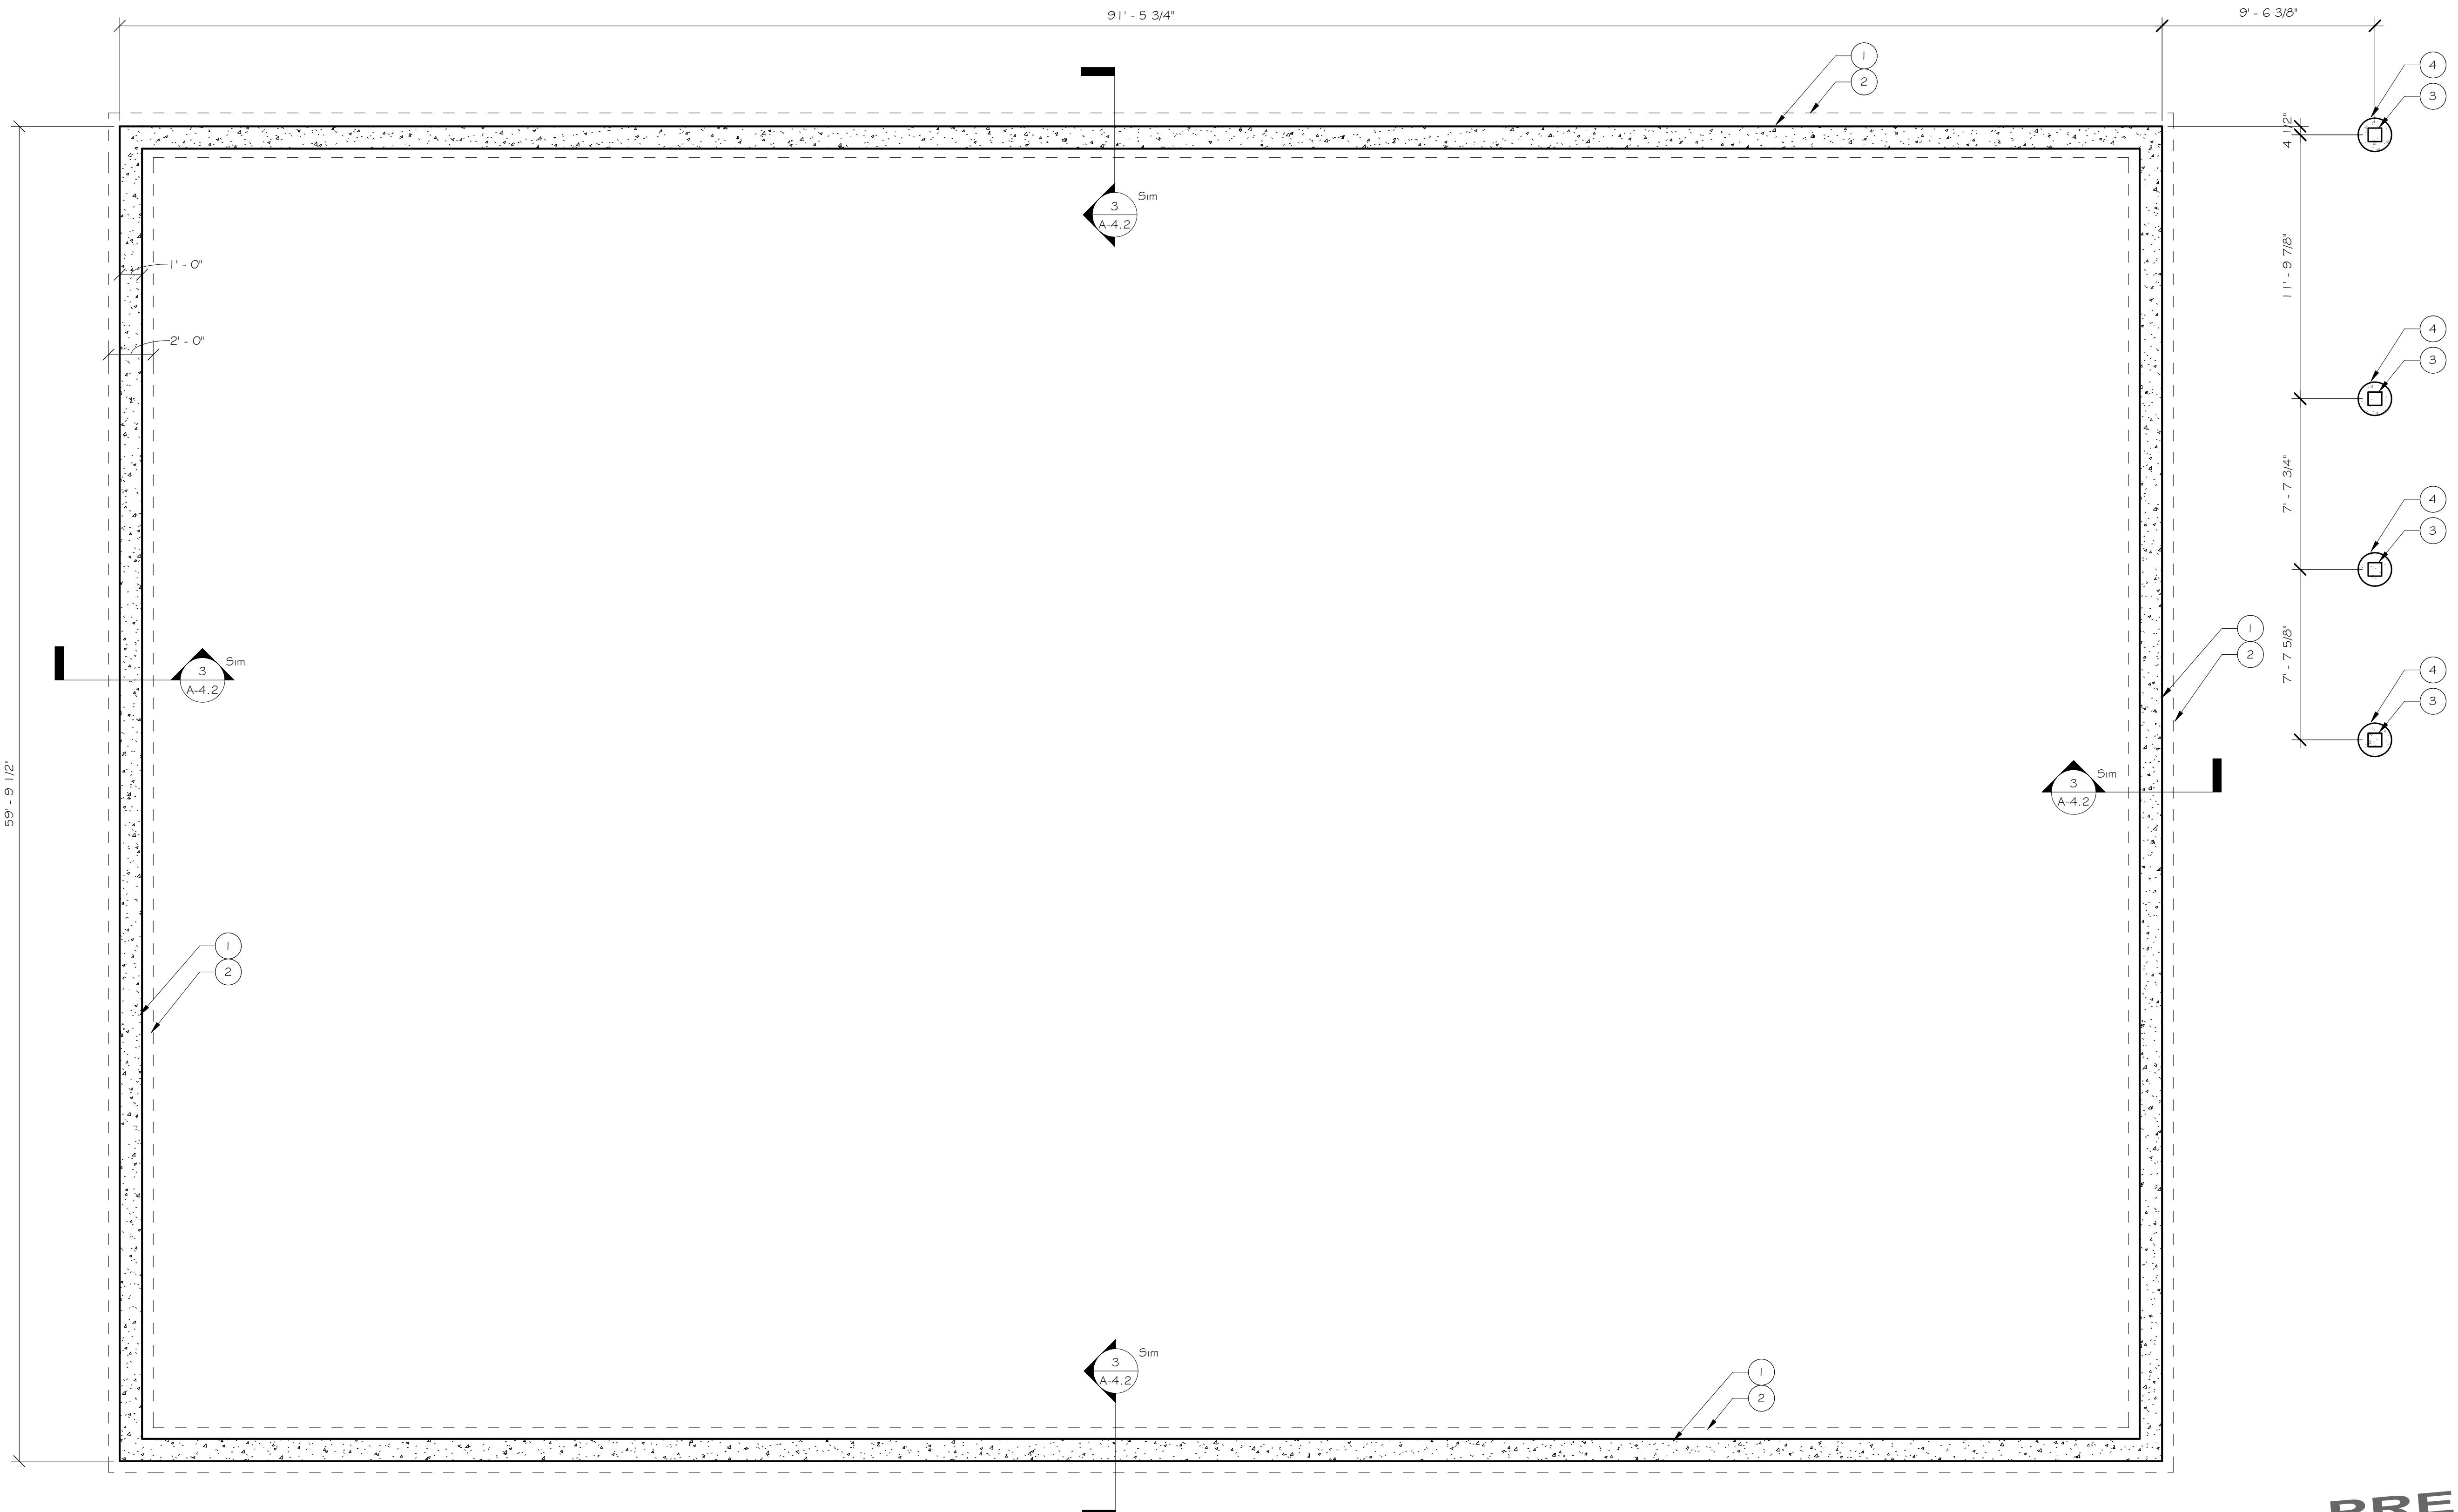
FOUNDATION PLAN KEYNOTES

- 1 8" CONC. ICF FOUNDATION WALL WITH #4 BAR VERTICAL @48" O.C. AND #4 BAR HORIZONTAL @24" O.C.
- 2 CONCRETE FOOTING 12" DEEP BY 24" WIDE WITH (3) #4 BAR CONTINUOUS
- 3 8 X 8 P.T. POST
- 4 18" SONOTUBE 4'-0" DEEP MIN.

GENERAL FOUNDATION NOTES

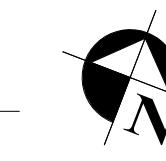
1. ALL DIMENSIONS ARE TO FACE OF ICF FOUNDATION WALL.
2. BOTTOM OF FOOTING SHALL BE A MINIMUM OF 4'-0" BELOW FINISHED GRADE ELEVATION.
3. FOUNDATIONS SHALL NOT BE CONSTRUCTED OVER EXISTING FILL MATERIALS UNLESS SPECIFICALLY APPROVED BY A GEOTECHNICAL ENGINEER.
4. ALL FOOTINGS SHALL BEAR ON PROPERLY PLACED STRUCTURAL FILL OR ON FIRM NATURALLY OCCURRING SOIL WITH A MINIMUM BEARING CAPACITY OF 1,500 PSI.
5. FINISHED FIRST FLOOR ELEVATION SHALL BE 100'-0".
6. TYPICAL 8" CONCRETE ICF WALL REINFORCEMENT SHALL BE #4 BARS AT 24" O.C. VERTICAL AND #4 BARS AT 18" O.C. HORIZONTAL. PROVIDE STIRRUPS OF #3 REINFORCEMENT BARS AS INDICATED ON DRAWINGS. PROVIDE LINTEL REINFORCEMENT AS SCHEDULED.

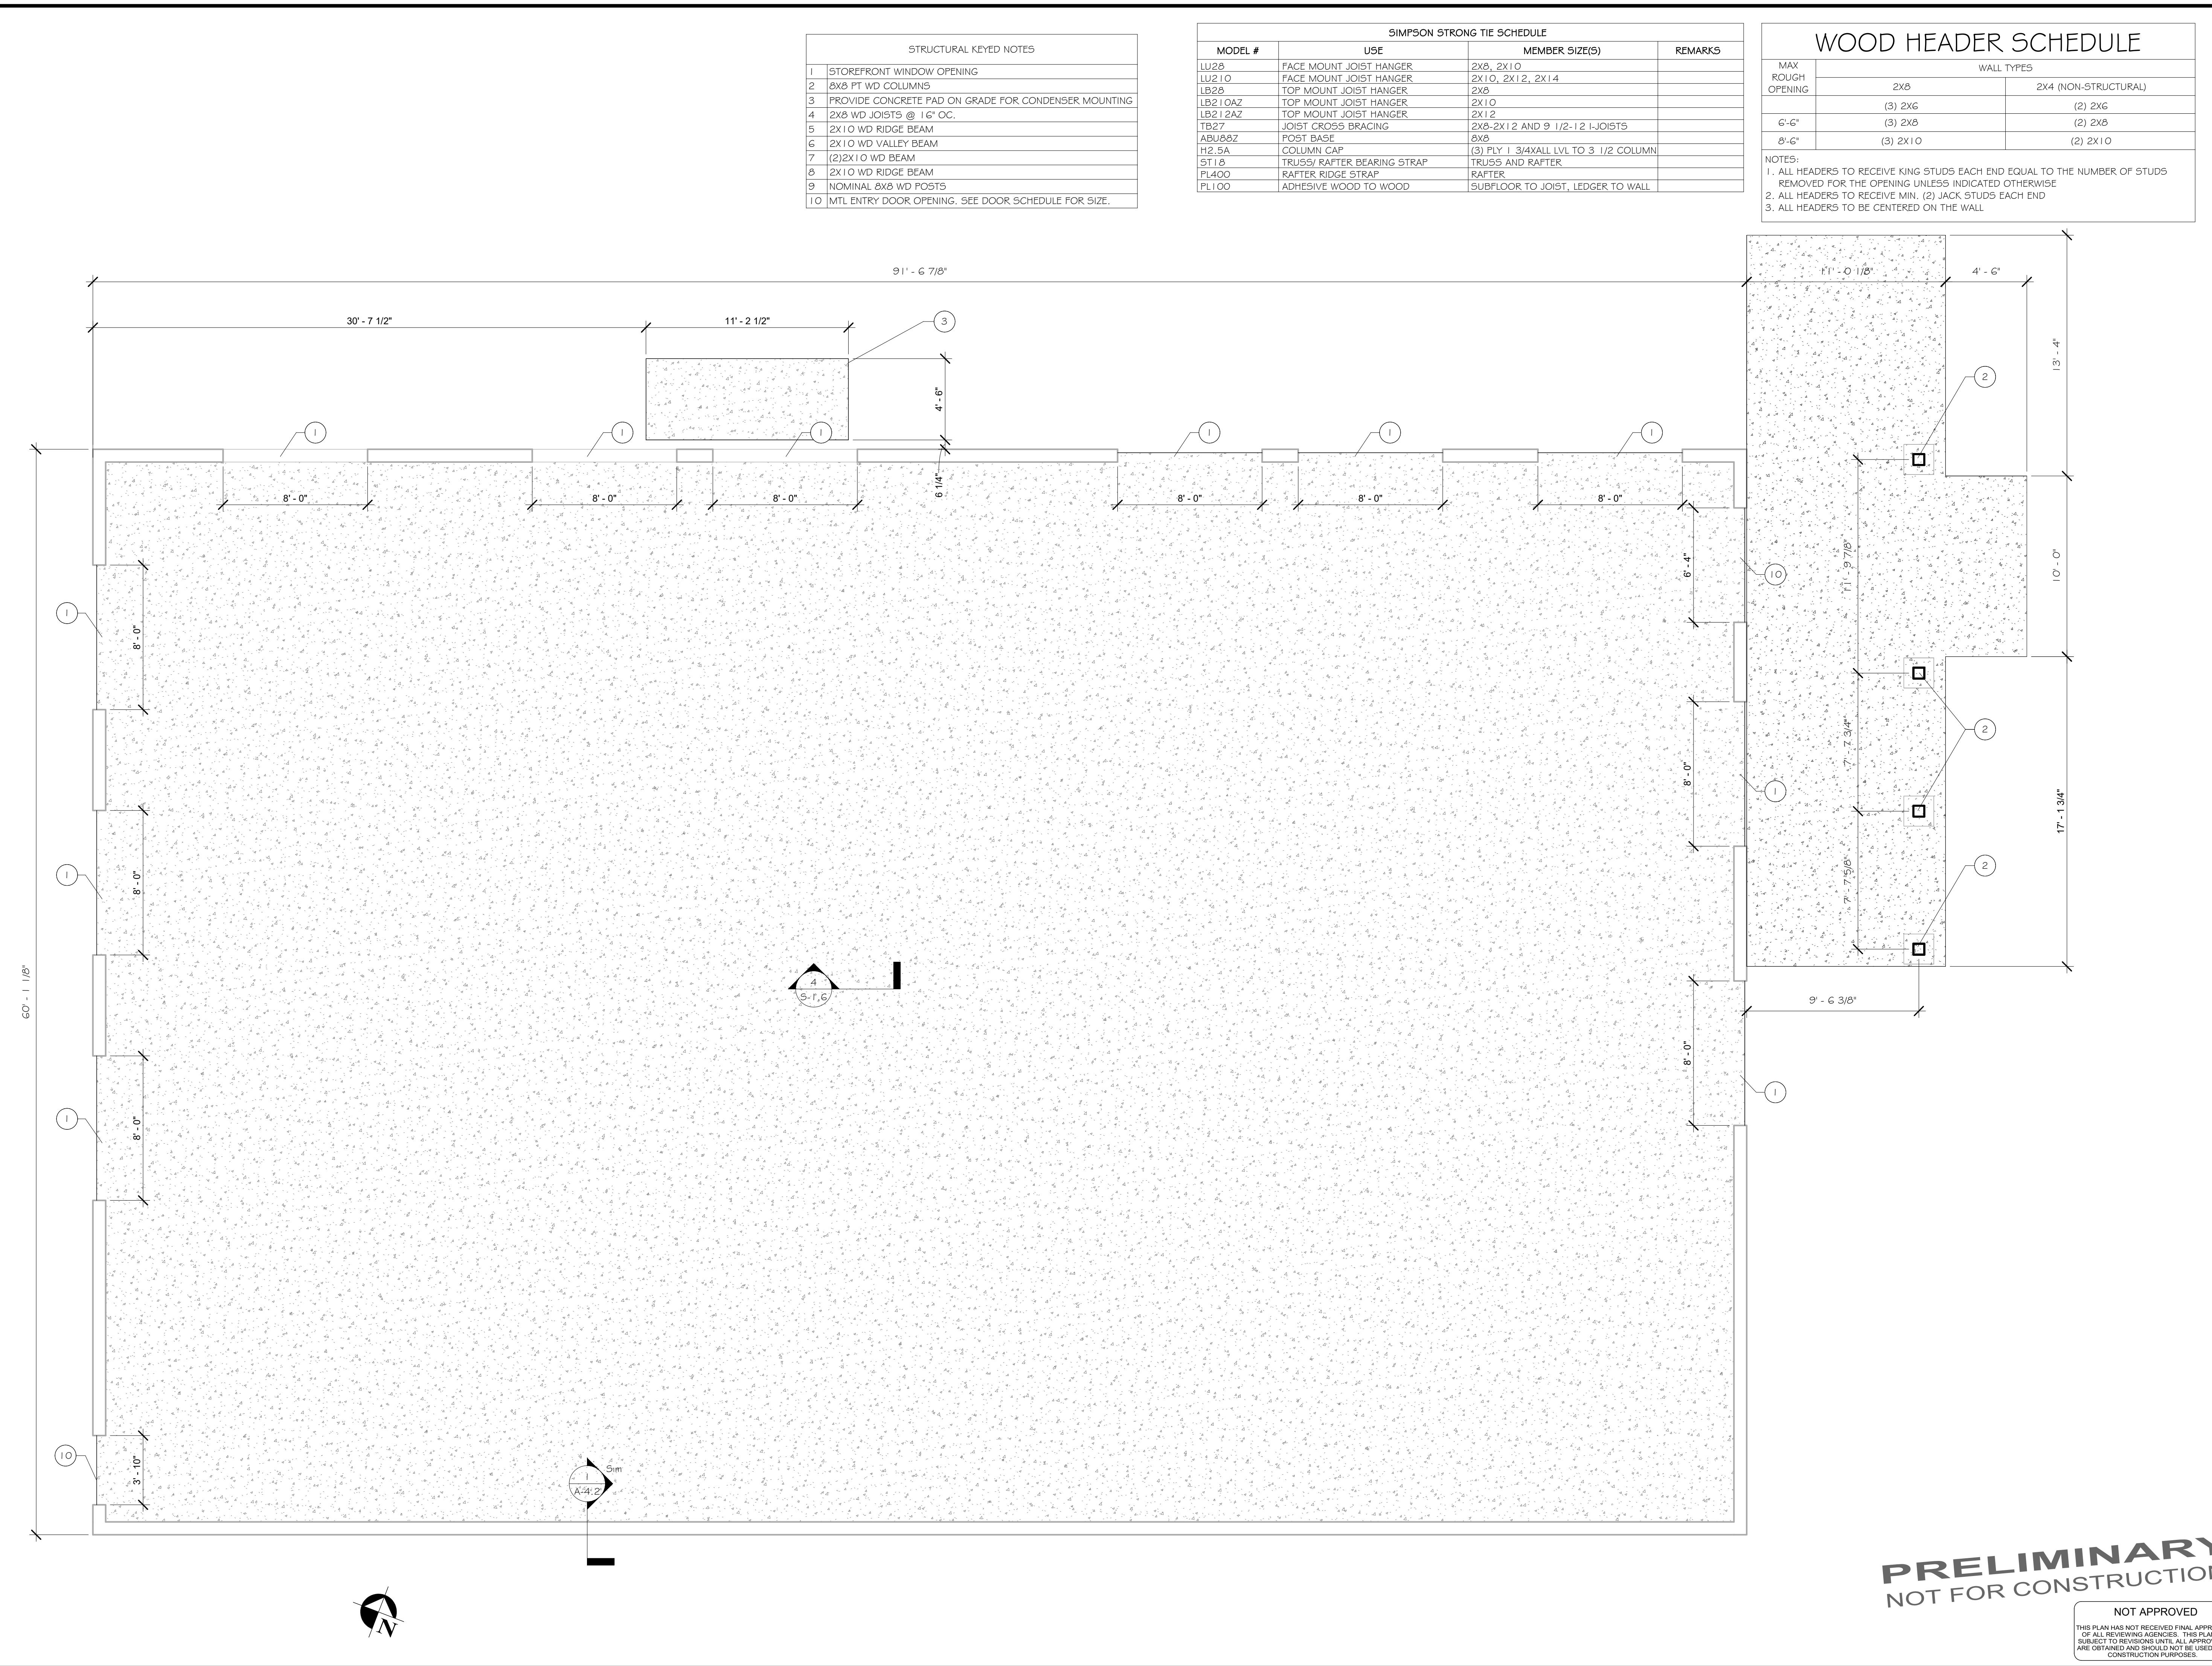
| SIMPSON STRONG TIE SCHEDULE | | | |
|-----------------------------|-----------------------------|---------------------------------------|---------|
| MODEL # | USE | MEMBER SIZE(S) | REMARKS |
| LU28 | FACE MOUNT JOIST HANGER | 2X6, 2X10 | |
| LU210 | FACE MOUNT JOIST HANGER | 2X10, 2X12, 2X14 | |
| LB28 | TOP MOUNT JOIST HANGER | 2X6 | |
| LB210AZ | TOP MOUNT JOIST HANGER | 2X10 | |
| LB212AZ | TOP MOUNT JOIST HANGER | 2X12 | |
| TB27 | JOIST CROSS BRACING | 2X6-2X12 AND 9 1/2-12 I-JOISTS | |
| ABU82 | POST BASE | 6X6 | |
| H2.5A | COLUMN CAP | (3) PLY 1 3/4XALL LVL TO 3 1/2 COLUMN | |
| ST18 | TRUSS/ RAFTER BEARING STRAP | TRUSS AND RAFTER | |
| PL400 | RAFTER RIDGE STRAP | RAFTER | |
| PL100 | ADHESIVE WOOD TO WOOD | SUBFLOOR TO JOIST, LEDGER TO WALL | |



**PRELIMINARY
NOT FOR CONSTRUCTION**

NOT APPROVED
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SUBJECT TO REVISIONS UNTIL ALL APPROVALS
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PROJECT
ELMIRA CIVIL WAR VISITOR CENTER
637-639 WINSTON AVE
ELMIRA, NY 14901

DRAWING SCALE
AS NOTED

ISSUE DATE:
01.05.26

PROJECT NO.
25-086

DRAWING NO.

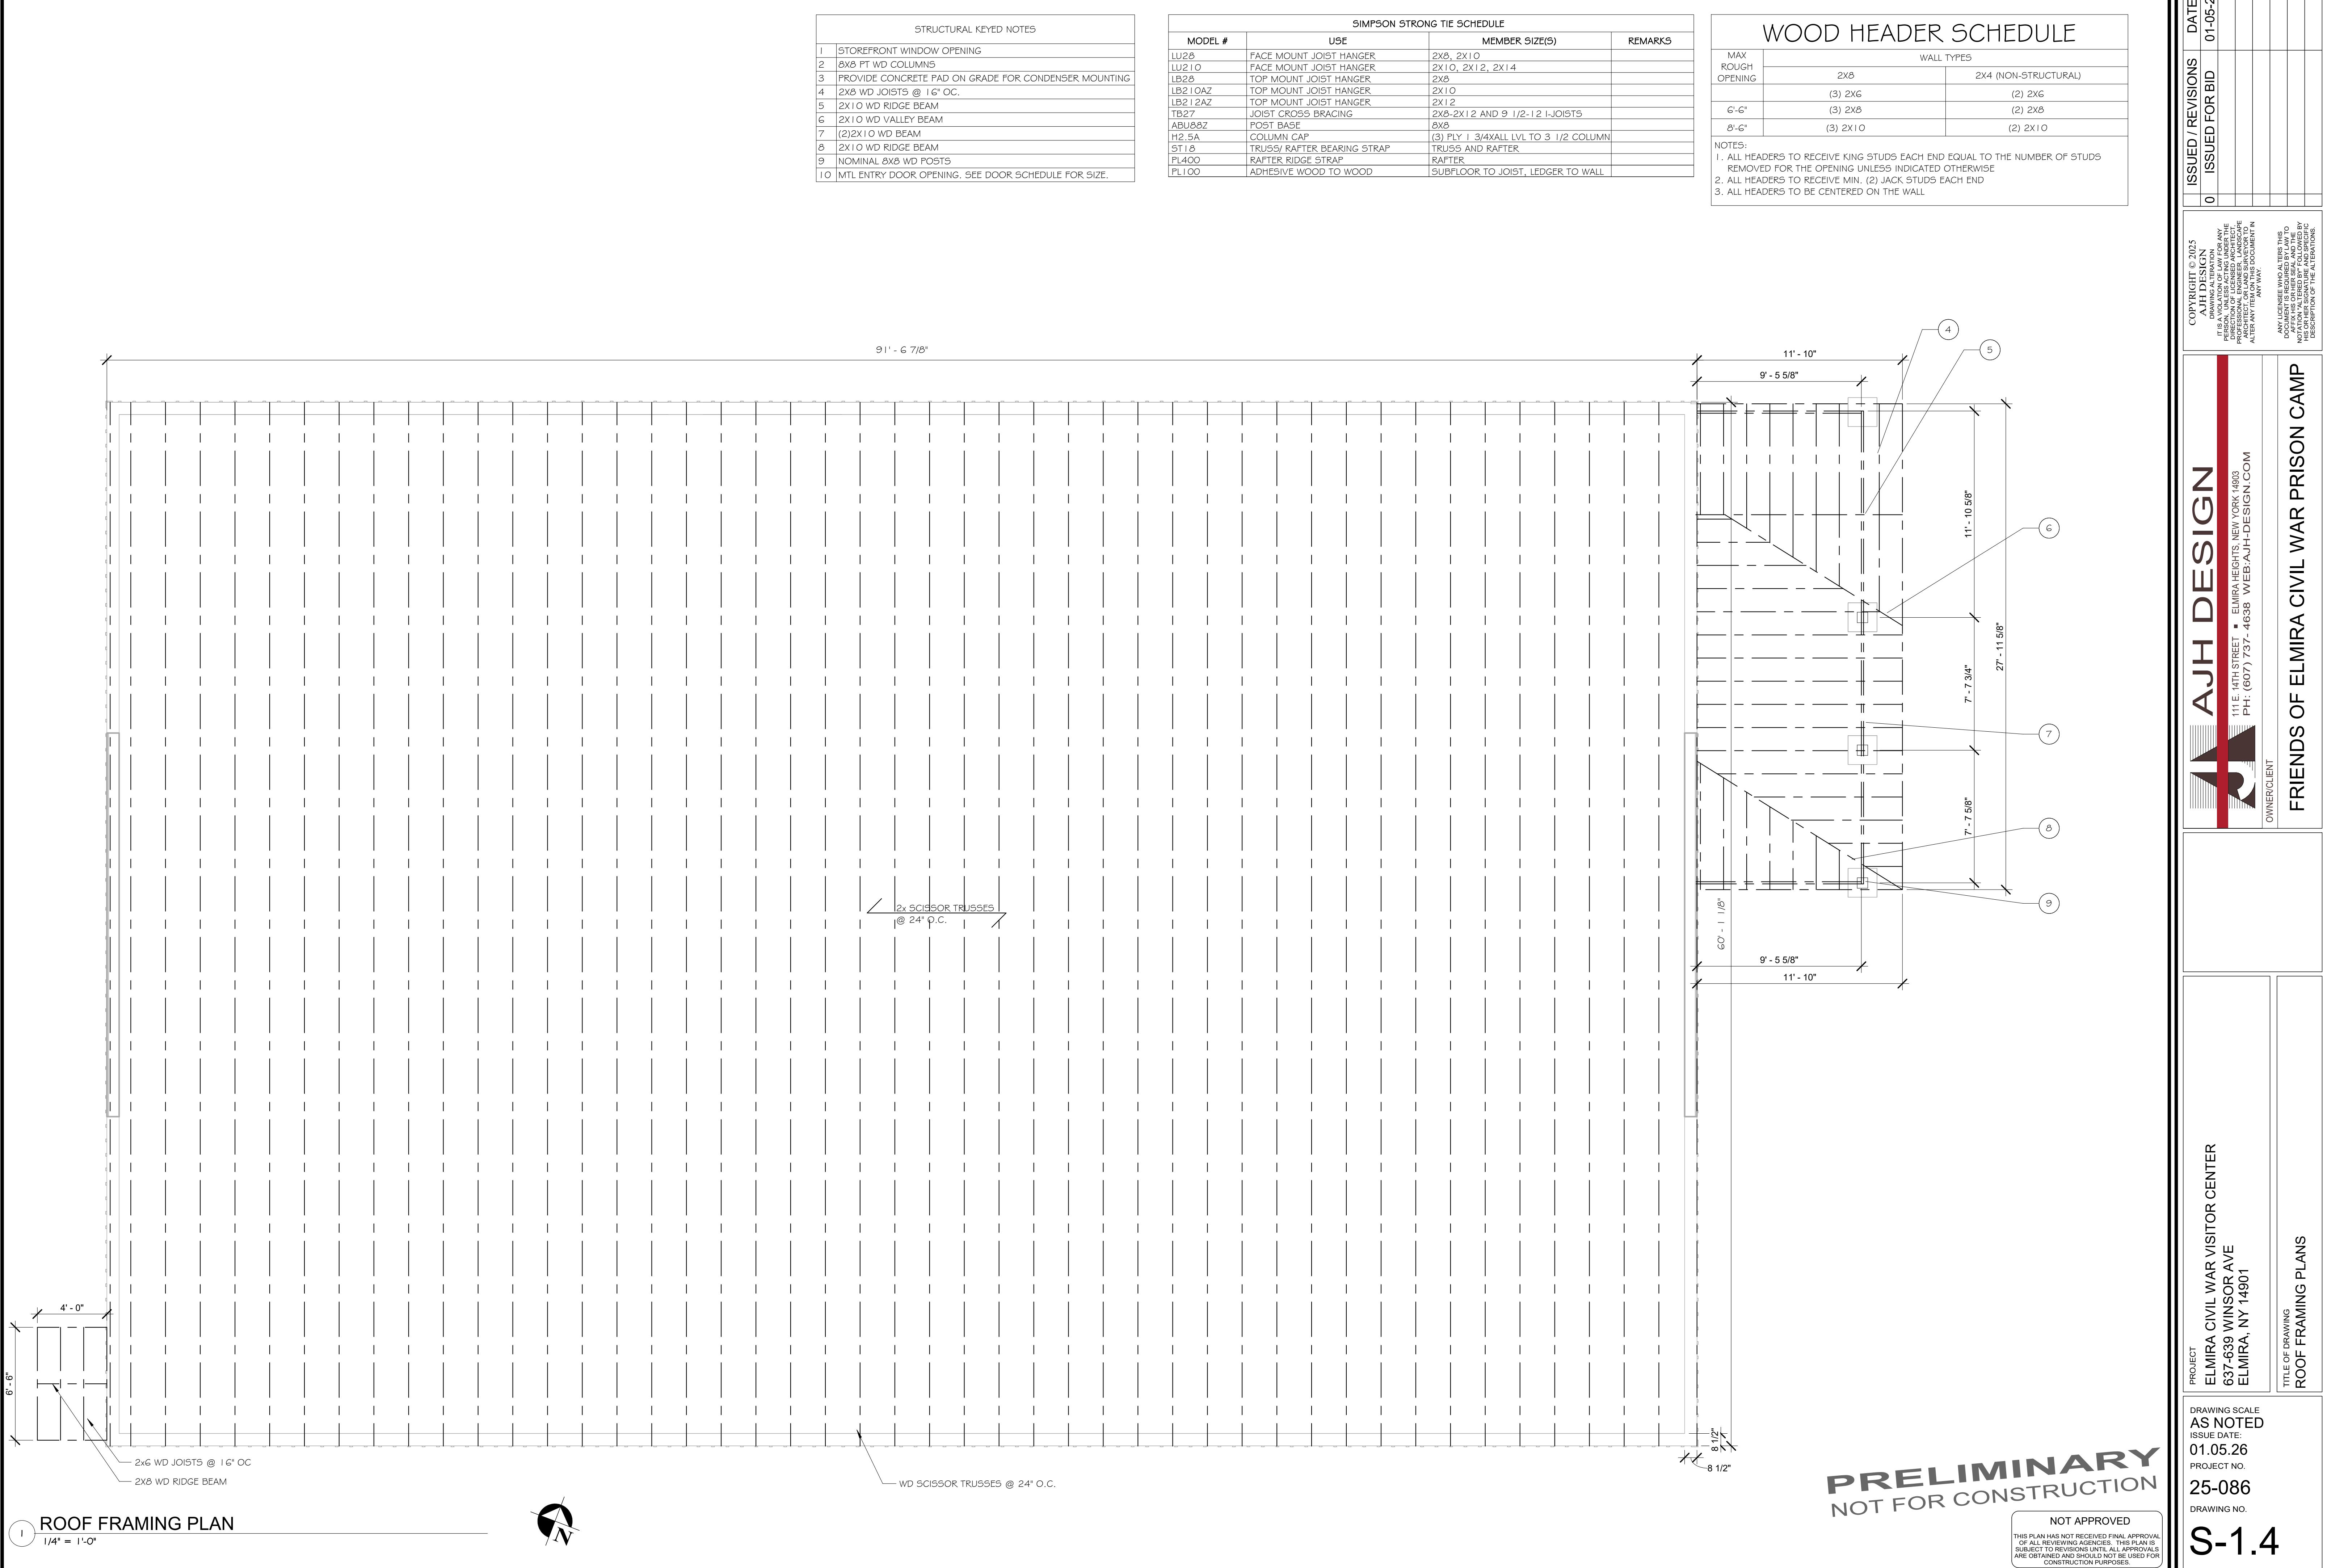
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FIRST FLOOR STRUCTURAL PLAN

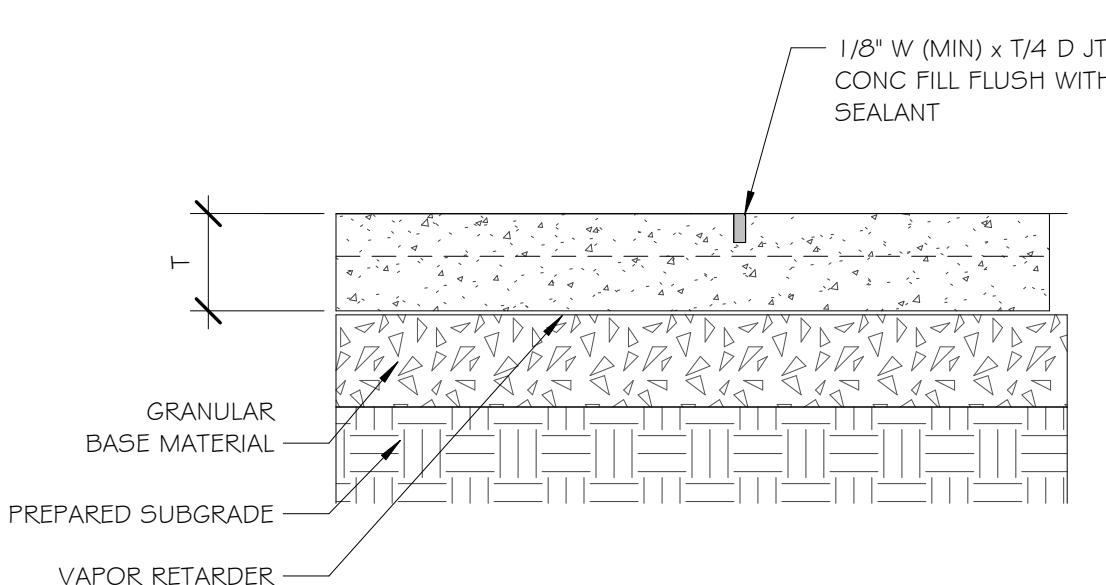
AJH DESIGN
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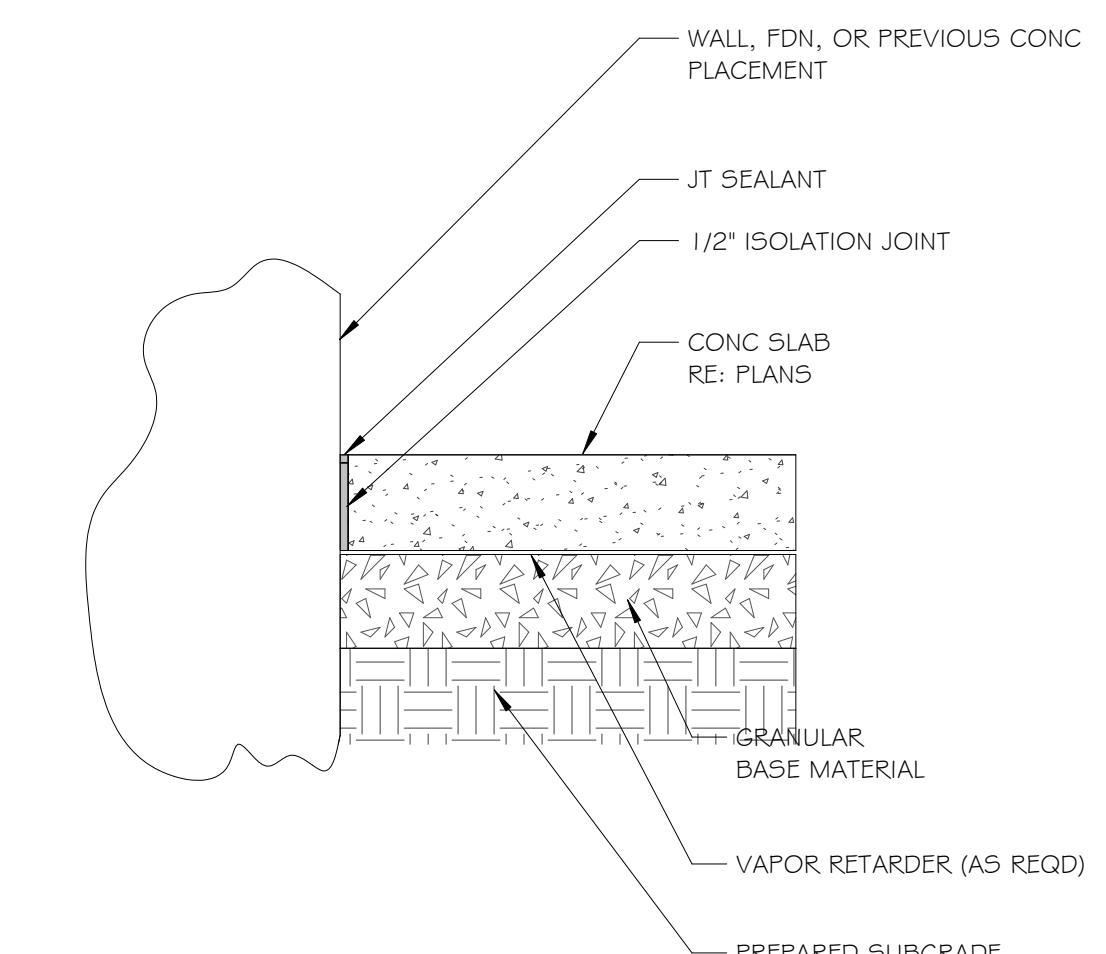
FRIENDS OF ELMIRA CIVIL WAR PRISON CAMP

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ARCHITECT OR ENGINEER
SHOULD BE NOTIFIED.
ANY LICENSEE WHO ALTERS THIS
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THE OWNER/CLIENT OR THE
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NOTIFICATION OF THE
ALTERATION SHOULD BE MADE
IN WRITING.
A DESCRIPTION OF THE
ALTERATION SHOULD BE
MADE IN WRITING.

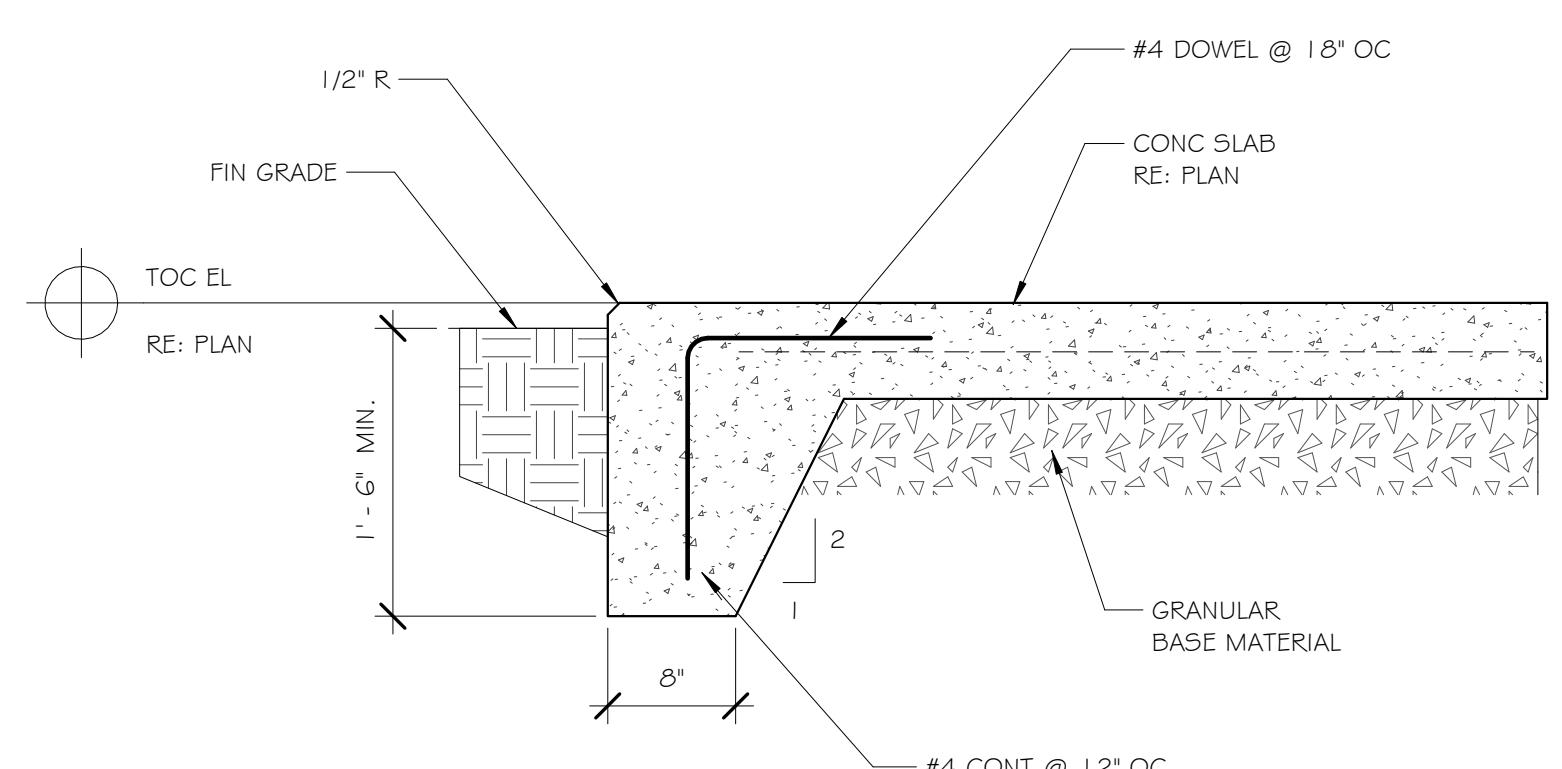




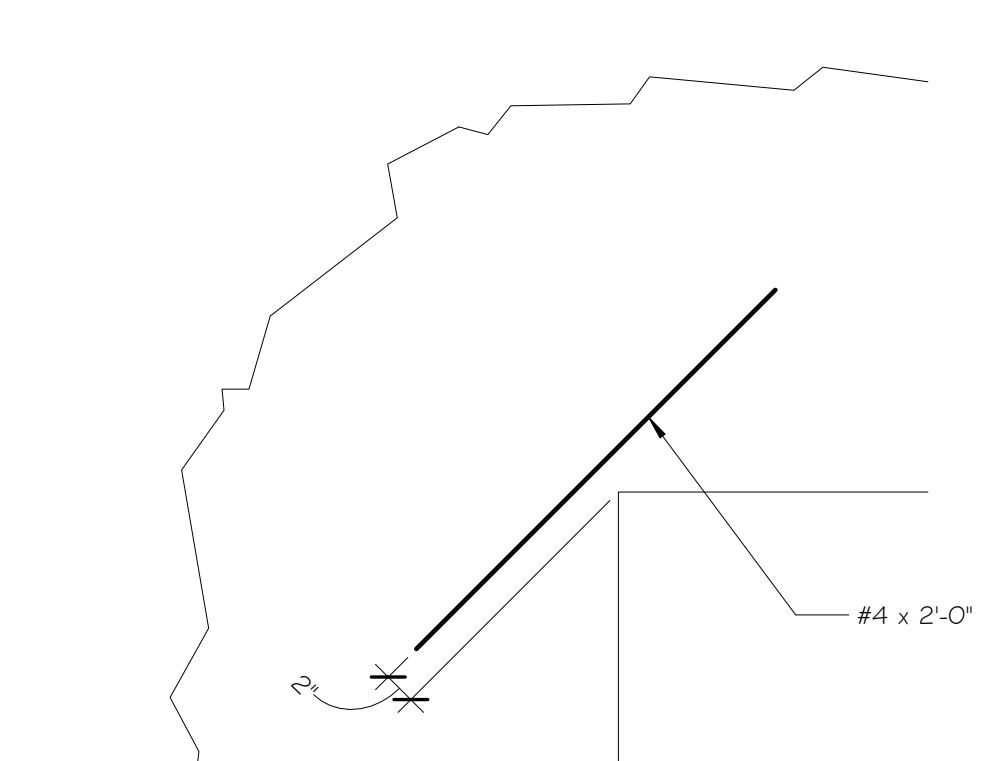
8 TYP. CONTROL JOINT
1" = 1'-0"



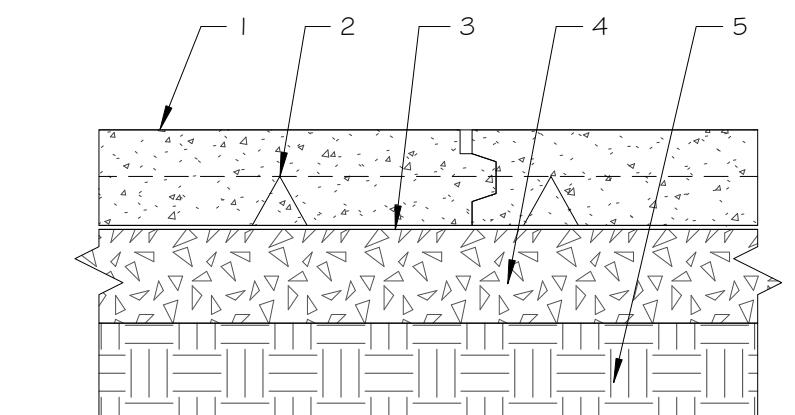
7 TYP. ISOLATION JOINT (IJ)
1" = 1'-0"



6 TYP. TURN-DOWN SLAB DETAIL
1" = 1'-0"

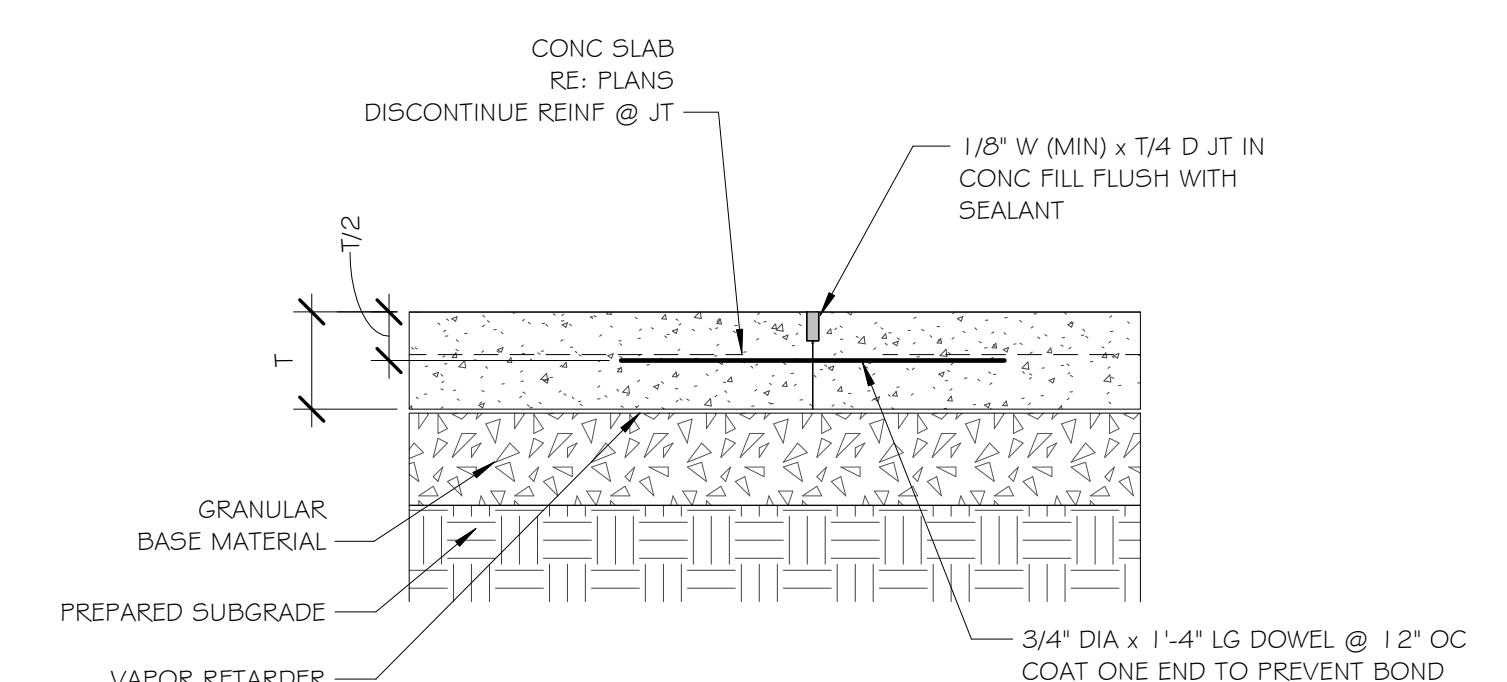


5 TYP. SLAB RE-ENTRANT CORNER DETAIL
1" = 1'-0"

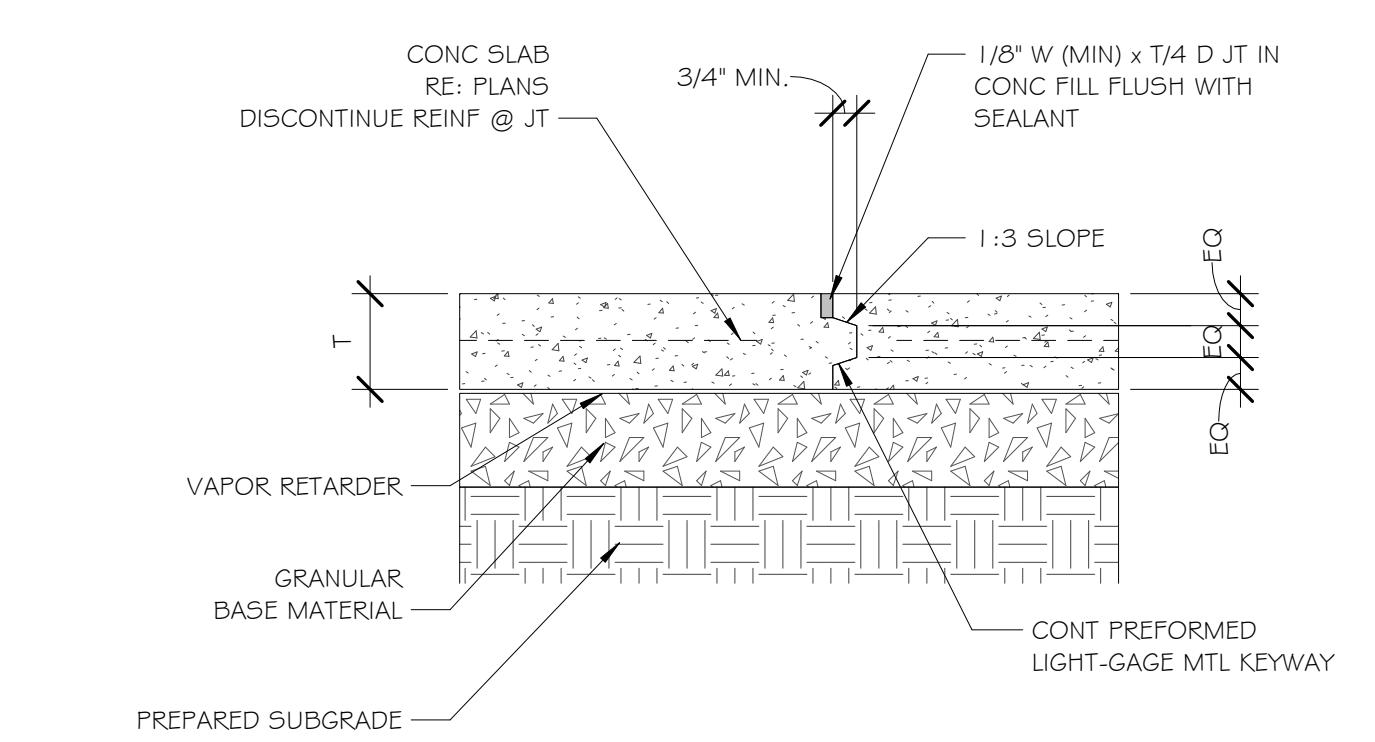


1. CONC SLAB, RE: PLAN FOR THK.
2. REINF, RE: PLAN FOR SIZE AND SPACING.
3. VAPOR RETARDER, 6 MIL THK NOT REQD AT EXT.
4. 6" GRANULAR BASE MATERIAL.
5. PREPARED SUBGRADE.

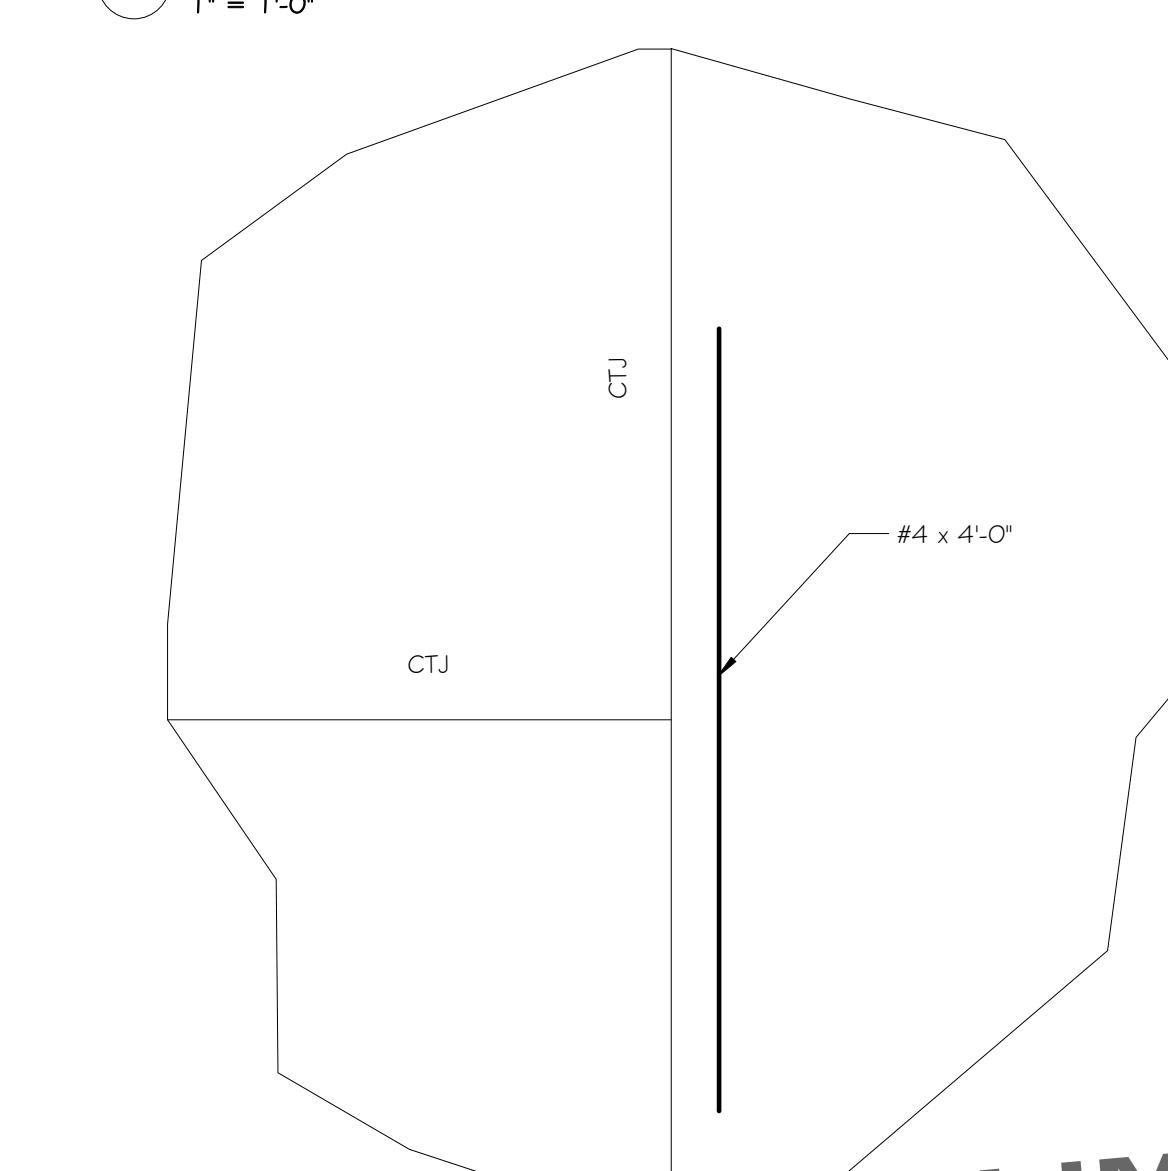
4 TYP. SLAB CONSTRUCTION
1" = 1'-0"



3 TYP. DOWELED CONSTRUCTION JOINT (CJ)
1" = 1'-0"



2 TYP. CONSTRUCTION JOINT (CJ)
1" = 1'-0"
NOTE: LOCATE CJ TO CONFORM WITH SLAB JOINTING PATTERN.



1 CONTRACTION JOINT (CTJ) @ DISCONTINUOUS JOINT
1" = 1'-0"

THIS PLAN HAS NOT RECEIVED FINAL APPROVAL BY THE STATE OF NEW YORK. THE PLAN IS SUBJECT TO REVISIONS UNTIL ALL APPROVALS ARE OBTAINED AND SHOULD NOT BE USED FOR CONSTRUCTION PURPOSES.

PROJECT: ELMIRA CIVIL WAR VISITOR CENTER
637-639 WINSOR AVE
ELMIRA, NY 14901

TITLE OF DRAWING: FOUNDATION DETAILS

DRAWING SCALE: AS NOTED
ISSUE DATE: 01.05.26
PROJECT NO. 25-086

DRAWING NO.

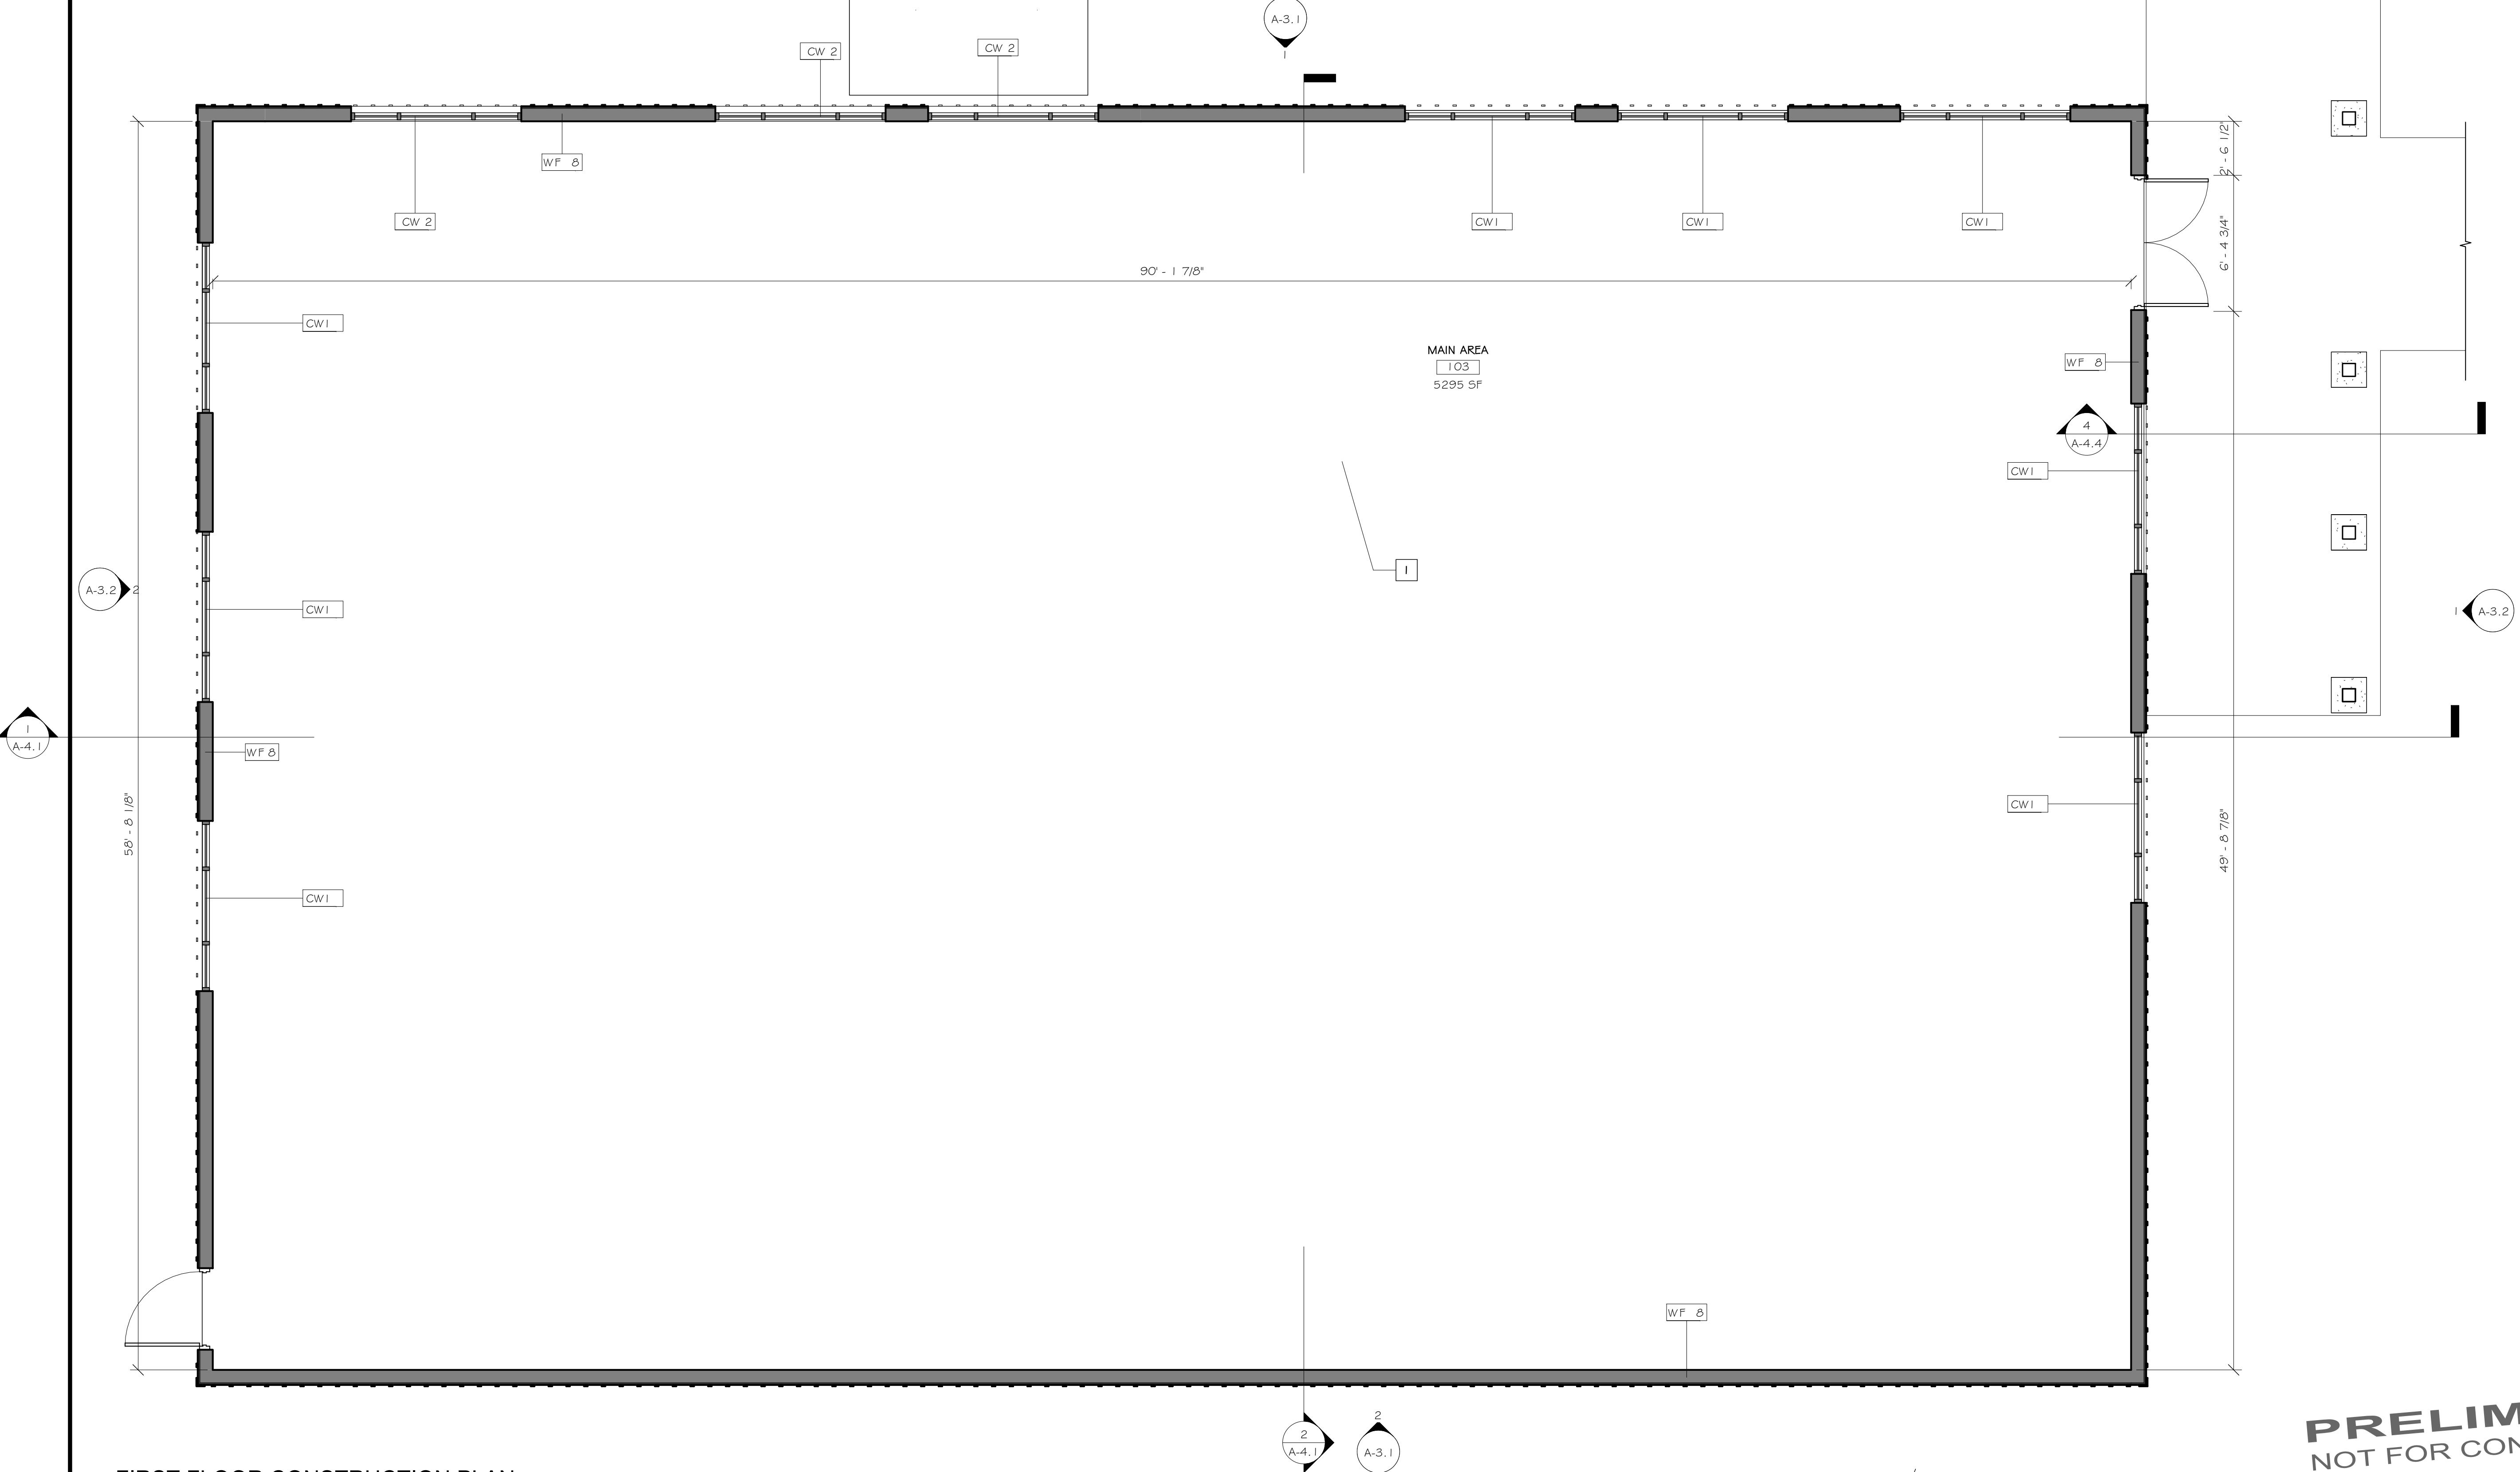
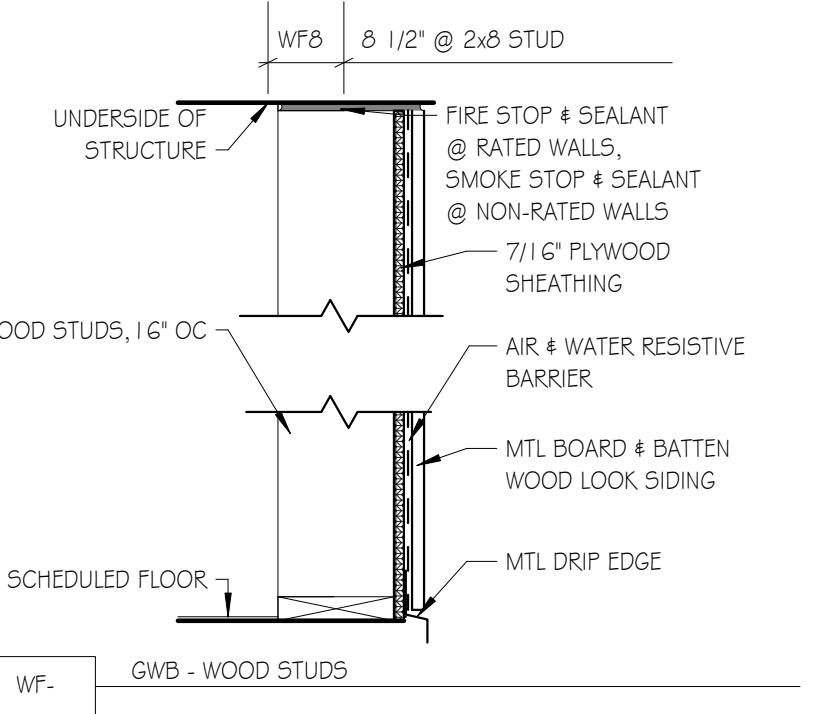
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DESCRIPTION OF THE ALTERATIONS

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GENERAL NOTES

1. ALL WORK INDICATED ON THE ARCHITECTURAL SITE & STRUCTURAL DRAWINGS IS TO BE BY THE GENERAL TRADES CONTRACTOR UNLESS NOTED OTHERWISE. THE GENERAL TRADES CONTRACTOR IS RESPONSIBLE FOR ALL WORK REQUIRED TO IMPLEMENT THE WORK OF THE GENERAL TRADES CONTRACT, REGARDLESS OF WHETHER SPECIFICALLY INDICATED OR NOT, UNLESS NOTED OTHERWISE.
2. ALL DIMENSIONS ARE FROM THE FACE OF STUDS, UNLESS NOTED OTHERWISE.
3. ITEMS SHOWN ARE INTENDED TO GIVE APPROXIMATE QUANTITY, LOCATION AND TYPE. THE CONTRACTOR IS RESPONSIBLE FOR VERIFYING ACTUAL QUANTITY & EXISTING FIELD CONDITIONS.
4. THE OWNER RESERVES THE RIGHT TO RETAIN ANY REMOVED ITEMS AFTER CONTRACTOR REMOVAL. THE CONTRACTOR SHALL REMOVE FROM THE SITE, & DISPOSE OF ANY ITEMS THE OWNER DOES NOT WISH TO RETAIN.
5. THE CONTRACTOR SHALL RESTORE ALL EXCAVATIONS TO EXISTING GRADE ELEVATION UNLESS NOTED OTHERWISE.
6. VERIFY WITH THE OWNER THE EXACT SIZE OF ALL EQUIPMENT FURNISHED BY OWNER FOR PROPER FIT WITH CONTRACTOR SUPPLIED COMPONENTS.
7. PROVIDE AN APPROVED GALVANIC BARRIER BETWEEN ALL DISSIMILAR METALS IN CONTACT WITH ONE ANOTHER.
8. THE WHEELCHAIR SYMBOL INDICATES HANDICAPPED ACCESSIBLE MOUNTED FIXTURE ELEVATION AND SHALL CONFORM WITH CABO/ANSI A117.1 & ADAAG REQUIREMENTS.
9. THE HVAC, PLUMBING, & ELECTRICAL TRADES CONTRACTORS SHALL COORDINATE ROOF & WALL OPENINGS WITH THE GENERAL TRADES CONTRACTOR. THE GENERAL TRADES CONTRACTOR SHALL PROVIDE ALL ROOF & WALL OPENINGS FOR DUCTWORK/HVAC EQUIPMENT UNLESS NOTED OTHERWISE.
10. THIS CONTRACT REQUIRES COMPLETE & WORKABLE SYSTEMS & ALL COMPONENTS NECESSARY FOR SUCH SYSTEMS. ALL MATERIALS & LABOR SHALL BE PROVIDED AS INDICATED & REASONABLY INFERRED BY THE CONTRACT DOCUMENTS.
11. CONTRACTORS SHALL NOT SCALE DRAWINGS FOR CONSTRUCTION PURPOSES. IN THE EVENT OF OMISSION OF NECESSARY DIMENSIONS OR INFORMATION THE CONTRACTOR SHALL NOTIFY THE ARCHITECT.
12. THE CONTRACTOR SHALL COORDINATE THE WORK OF THIS CONTRACT WITH THE WORK OF OTHER TRADES. VERIFY SIZE & LOCATION OF ALL OPENINGS FOR MECHANICAL & ELECTRICAL EQUIPMENT & RELATED WORK WITH CONTRACTORS INVOLVED PRIOR TO INSTALLATION.
13. THE GENERAL TRADES CONTRACTOR SHALL PROVIDE ALL BLOCKING FOR THE SUPPORT OF ALL ITEMS OR EQUIPMENT SHOWN OR SPECIFIED.
14. THE CONTRACTOR SHALL VERIFY ALL DIMENSIONS & EXISTING CONDITIONS IN THE FIELD BEFORE COMMENCING ANY WORK & NOTIFY THE ARCHITECT IMMEDIATELY IF ANY DISCREPANCIES ARE FOUND.
15. THE CONTRACTOR IS RESPONSIBLE FOR ALL DEMOLITION REQUIRED TO IMPLEMENT THE WORK OF THEIR RESPECTIVE CONTRACT, REGARDLESS OF WHETHER SPECIFICALLY INDICATED OR NOT, UNLESS NOTED OTHERWISE.
16. ALL PENETRATIONS & PERIMETER OF FIRE RATED PARTITIONS ARE TO BE SEALED WITH APPROVED U.L. FIRE RATED ASSEMBLIES.
17. THE GENERAL TRADES CONTRACTOR SHALL BE RESPONSIBLE FOR SEALANT AT THE PERIMETER OF ALL MECHANICAL, PLUMBING, & ELECTRICAL PENETRATIONS. EACH RESPECTIVE TRADE SHALL BE RESPONSIBLE FOR PROPER WATER SEALS AT PENETRATIONS REQUIRING SEALS IN EXCESS OF CAULKING.
18. FINISHED DOOR OPENINGS SHALL BE NOMINAL 6' FROM FINISHED CORNER OF ROOM AT HINGE SIDE, EXCEPT WHERE DIMENSIONED OTHERWISE. DOOR STRIKES SHALL BE 1'-6" MINIMUM FROM A PERPENDICULAR WALL ON THE PULL SIDE OF A DOOR AND 1'-0" ON THE PUSH SIDE OF A DOOR WITH BOTH A CLOSER AND LATCH.
19. ALL EXTERIOR CONCRETE SLABS SHALL SLOPE AWAY FROM BUILDING AT 1/8 INCH PER FOOT UNLESS OTHERWISE NOTED.
20. ALL PARTITIONS SHALL BE BRACED TO STRUCTURE ABOVE. SEE SHEET C-1.1 FOR BUILDING CODE COMPLIANCE AND SPECIFICATIONS.
21. GENERAL NOTES AND BUILDING ASSEMBLIES SHALL APPLY TO ALL CONTRACTORS.
22. PROVIDE A MINIMUM OF 6' OF CLEAR SPACE AT THE HINGE SIDE OF DOORS, UNLESS NOTED OR INFEASIBLE.



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| PROJECT | ISSUED / REVISIONS | DATE |
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| ELMIRA CIVIL WAR VISITOR CENTER 637-639 WINSOR AVE ELMIRA, NY 14901 | 0 ISSUED FOR BID | 01-05-26 |

PROJECT: ELMIRA CIVIL WAR VISITOR CENTER
DRAWING SCALE: AS NOTED
ISSUE DATE: 01-05-26
PROJECT NO.: 25-086
DRAWING NO.:

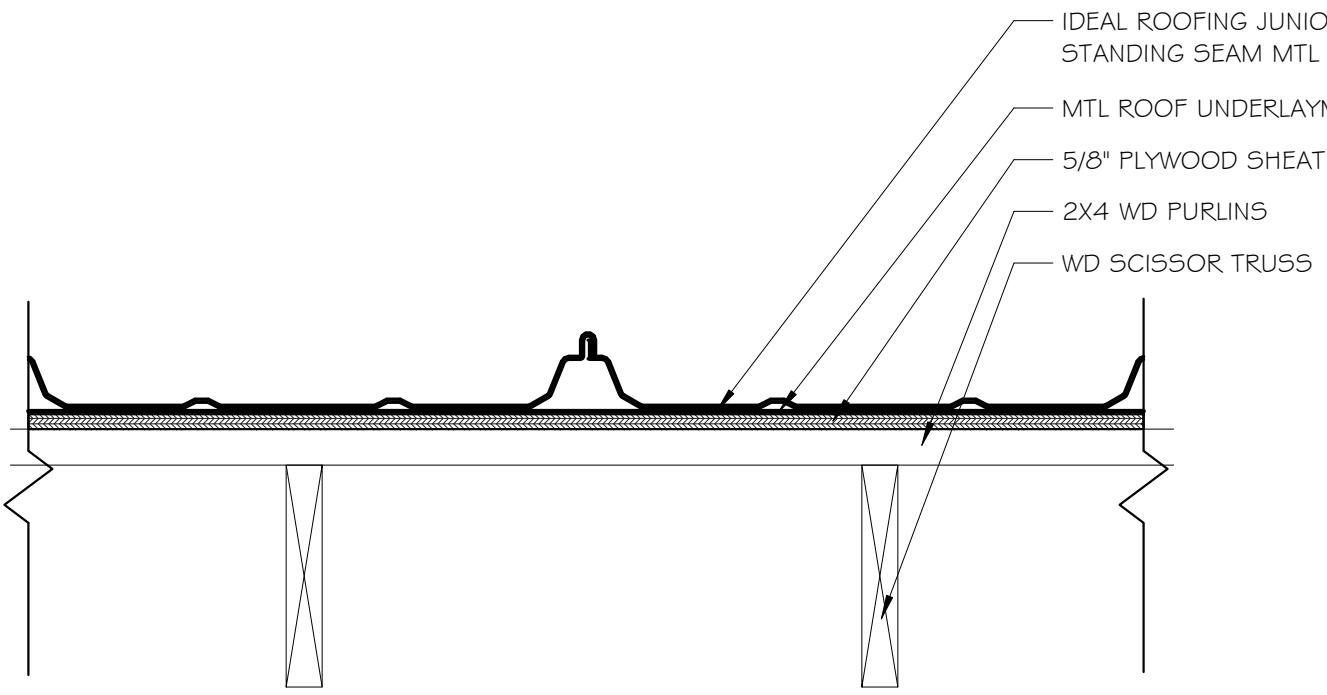
TITLE OF DRAWING: FIRST FLOOR AND LOFT CONSTRUCTION PLANS

ROOF PLAN KEYNOTES

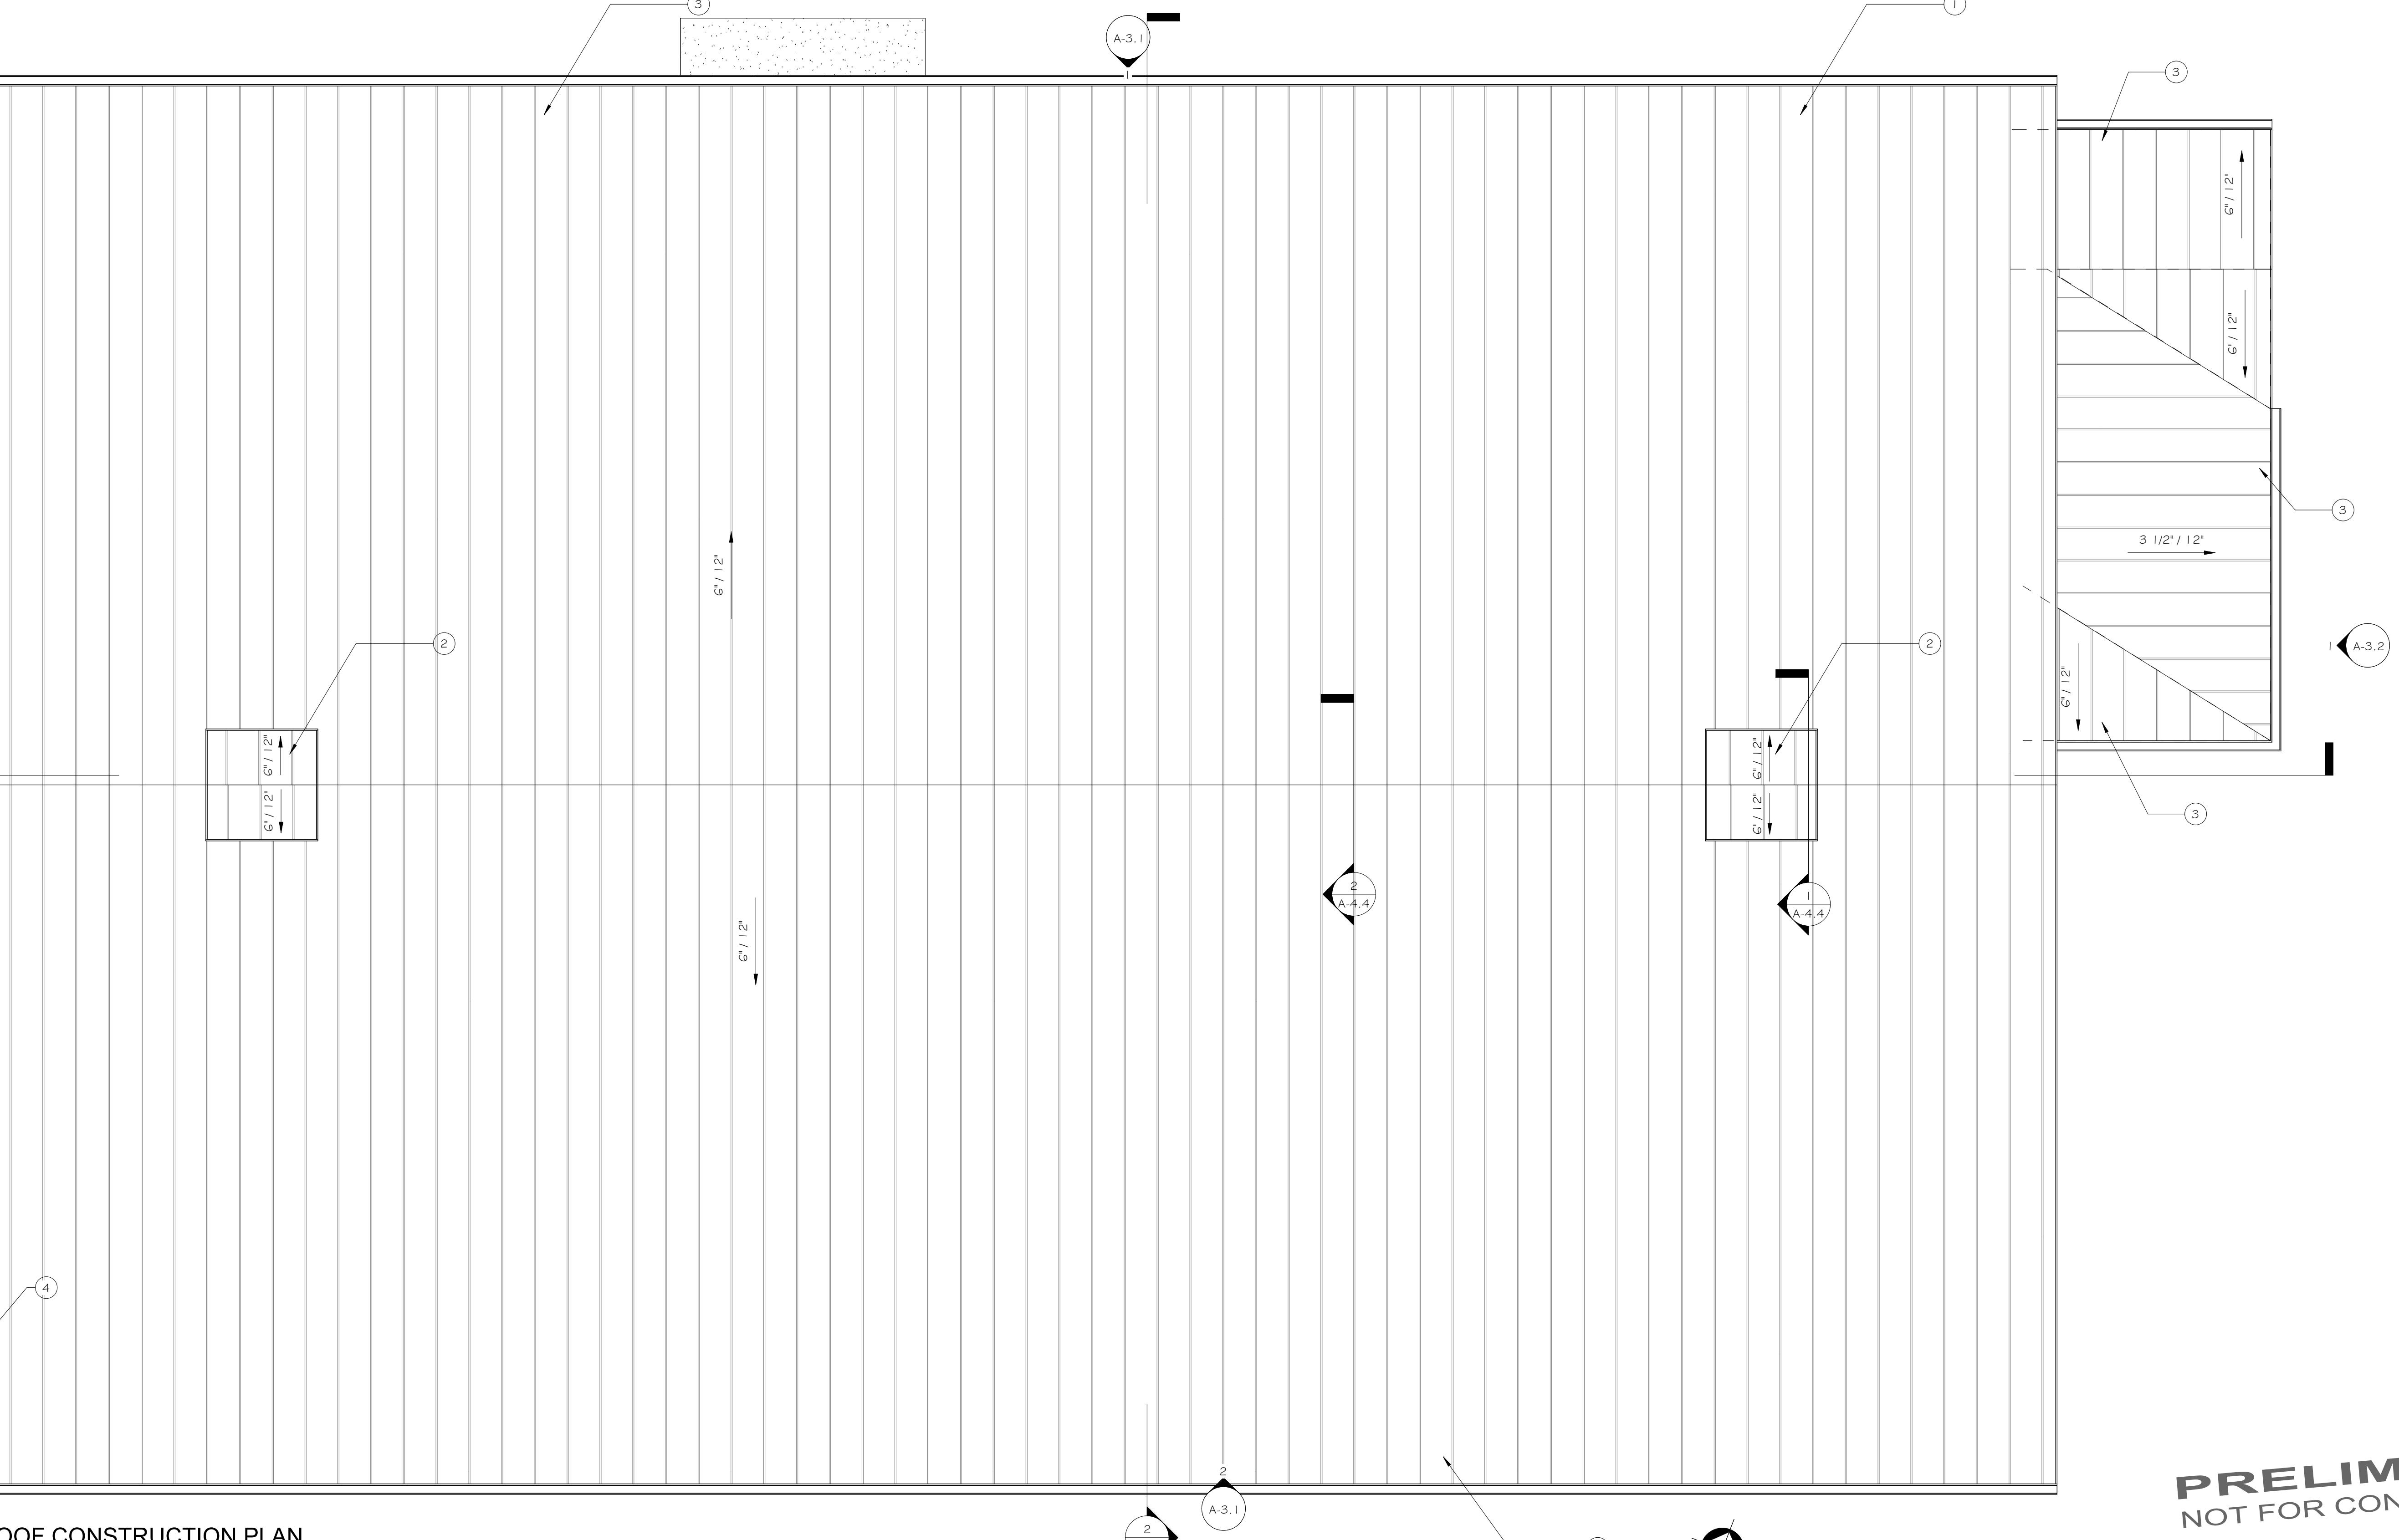
1. PROVIDE IDEAL ROOFING JUNIOR HF METAL ROOF COMPLETE
2. PROVIDE CUPOLA COMPLETE
3. PROVIDE GUTTERS AND DOWNSPOUTS COMPLETE
4. PROVIDE ENTRY COVERING COMPLETE

GENERAL ROOFING NOTES

1. ALL WORK SHALL CONFORM TO THE NEW YORK STATE BUILDING CODE AND ADOPTED REFERENCE STANDARDS.
2. THE GENERAL TRADES CONTRACTOR SHALL INSTALL AND MAINTAIN TEMPORARY ROOFING TO ENSURE WEATHER TIGHT CONDITIONS UNTIL SUCH TIME THE PERMANENT ROOFING SYSTEM IS INSTALLED.
3. THE CONTRACTOR SHALL PROVIDE AND INSTALL ALL MATERIALS TO MAKE SMOOTH TRANSITIONS AT ROOF EDGES AND INTERSECTIONS. TAPERED EDGE STRIPS ARE REQUIRED AT PERIMETER.
4. THE GENERAL TRADES CONTRACTOR SHALL REFER TO THE HVAC DRAWINGS AND COORDINATE WITH THE HVAC CONTRACTOR FOR QUANTITY AND LOCATIONS OF PENETRATIONS THROUGH ROOF FOR EQUIPMENT RAILS, CURBS, AND BOOTS.
5. THE GENERAL TRADES CONTRACTOR SHALL PROVIDE FLASHING AT ALL PENETRATIONS.
6. THE GENERAL TRADES CONTRACTOR IS TO PROVIDE ANY ADDITIONAL BLOCKING, AND ANY ASSOCIATED ACCESSORIES REQUIRED.



3 DETAIL - TYPICAL METAL ROOF



1 T.O. ROOF CONSTRUCTION PLAN
1/4" = 1'-0"

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NOTES:

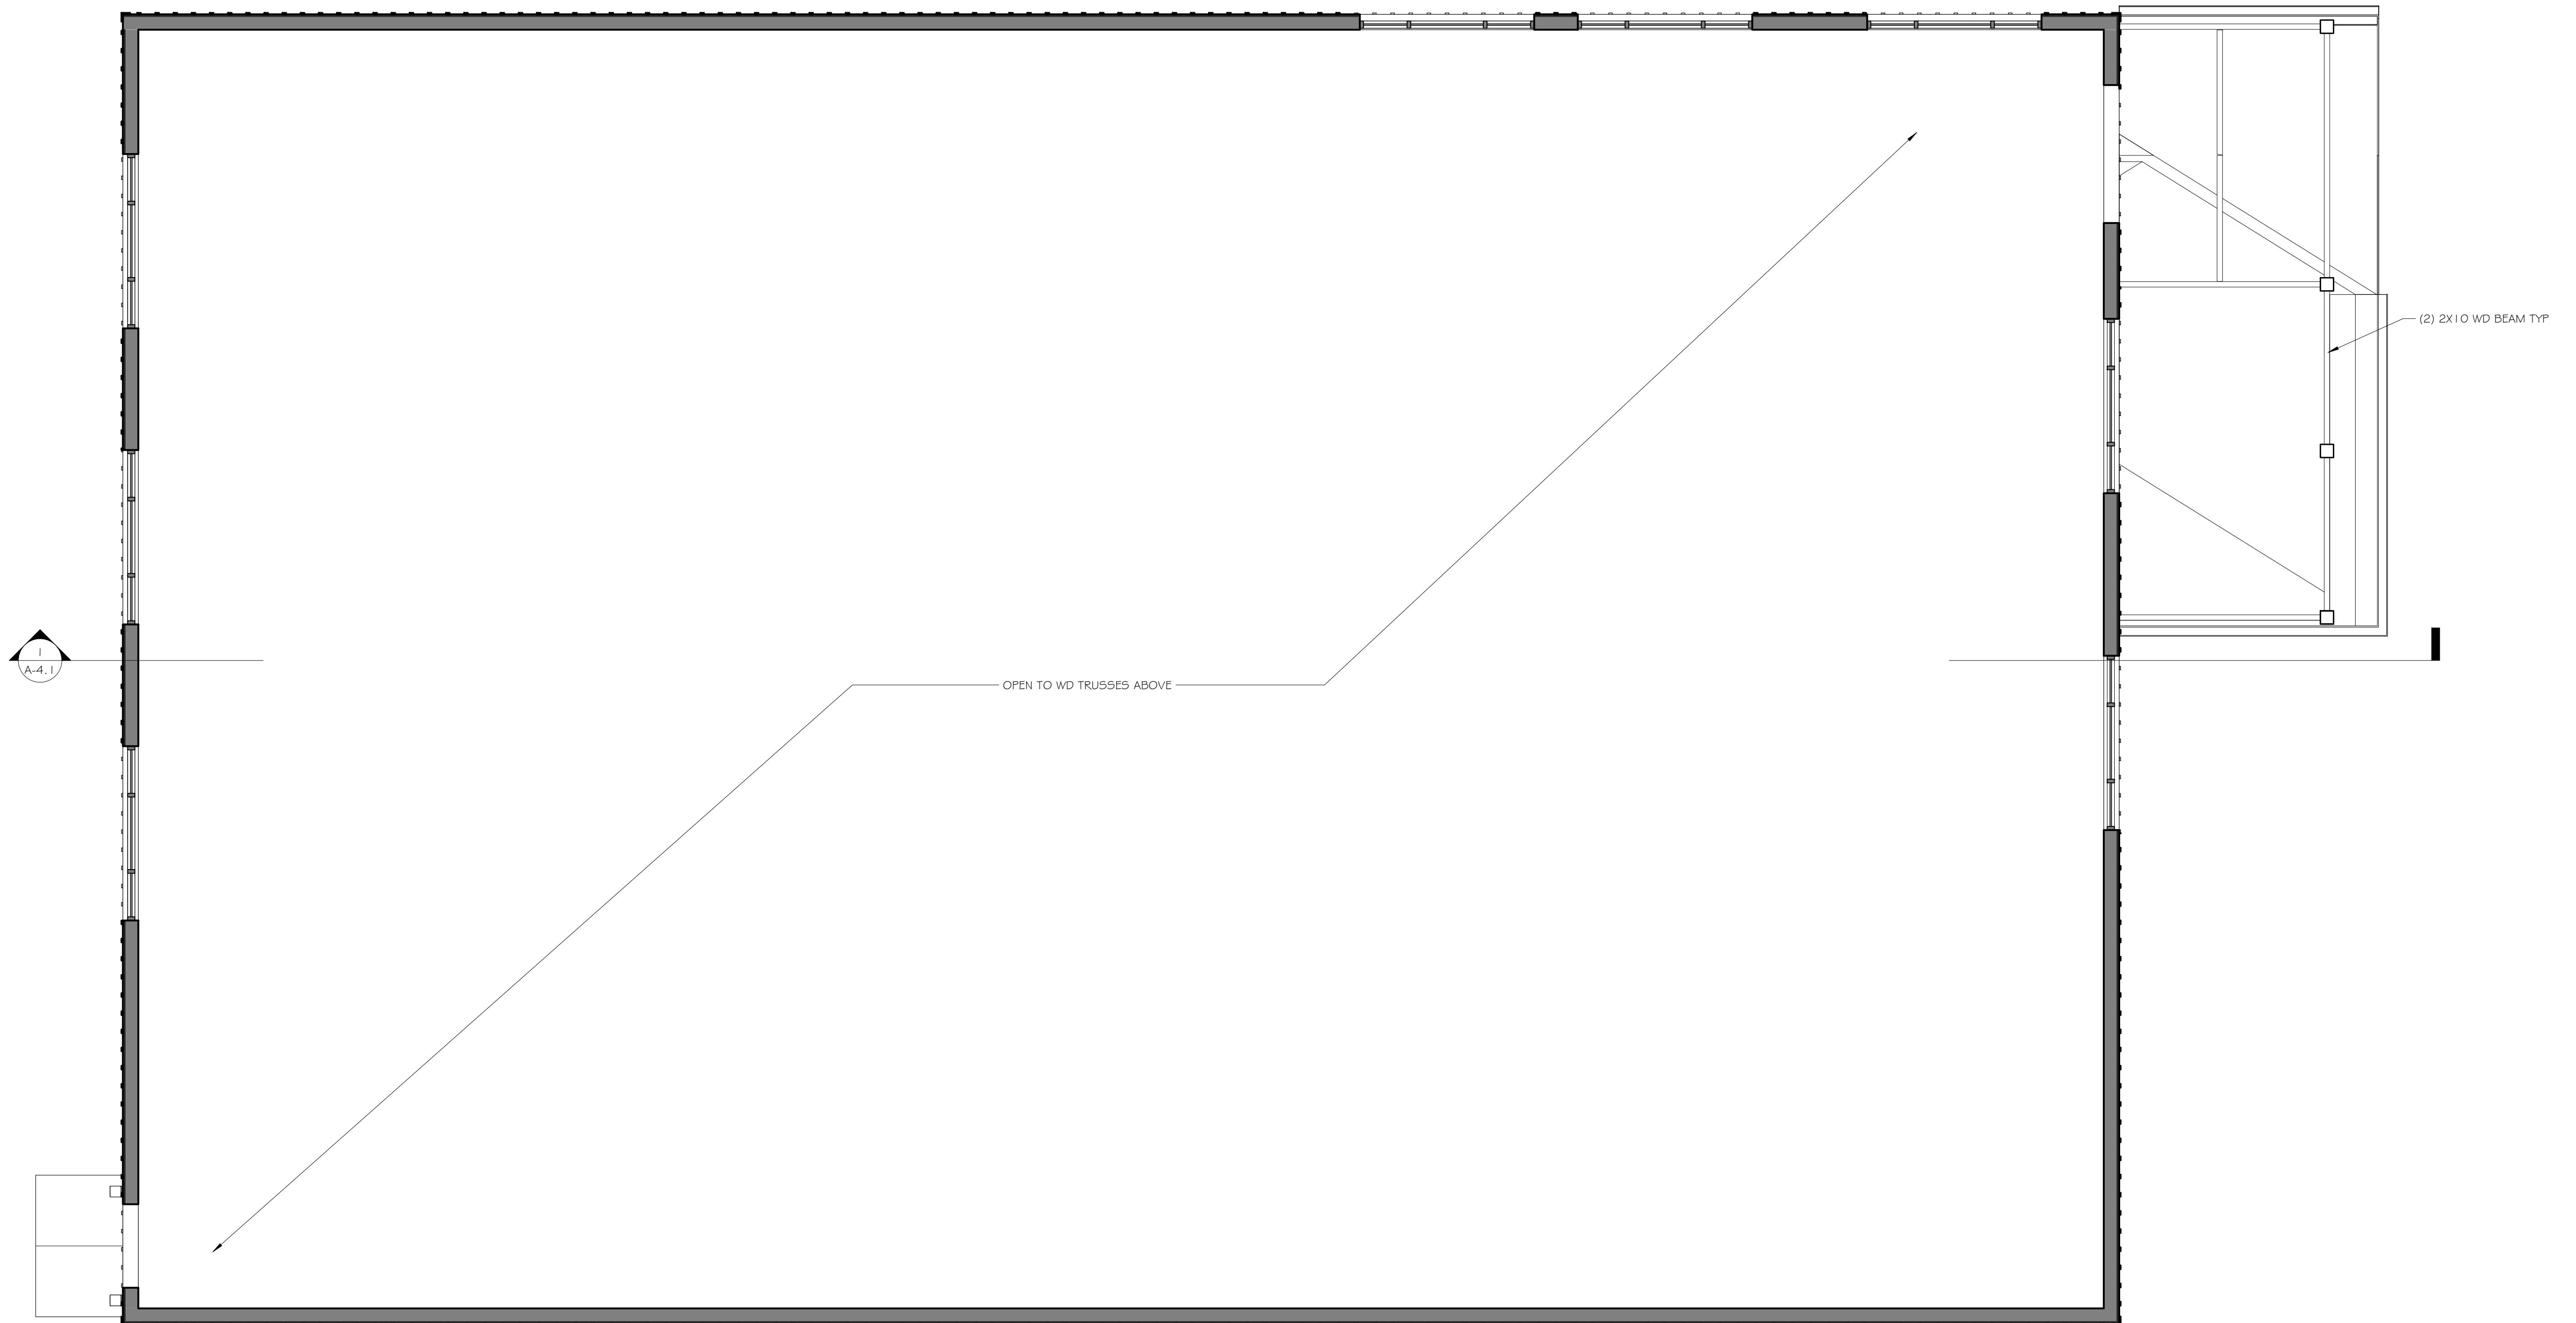
A. CEILING SHALL BE OPEN TO TRUSSES ABOVE.
B. NO LIGHTING NOR POWER SHALL BE INSTALLED IN THIS PHASE.

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FIRST FLOOR REFLECTED CEILING PLAN

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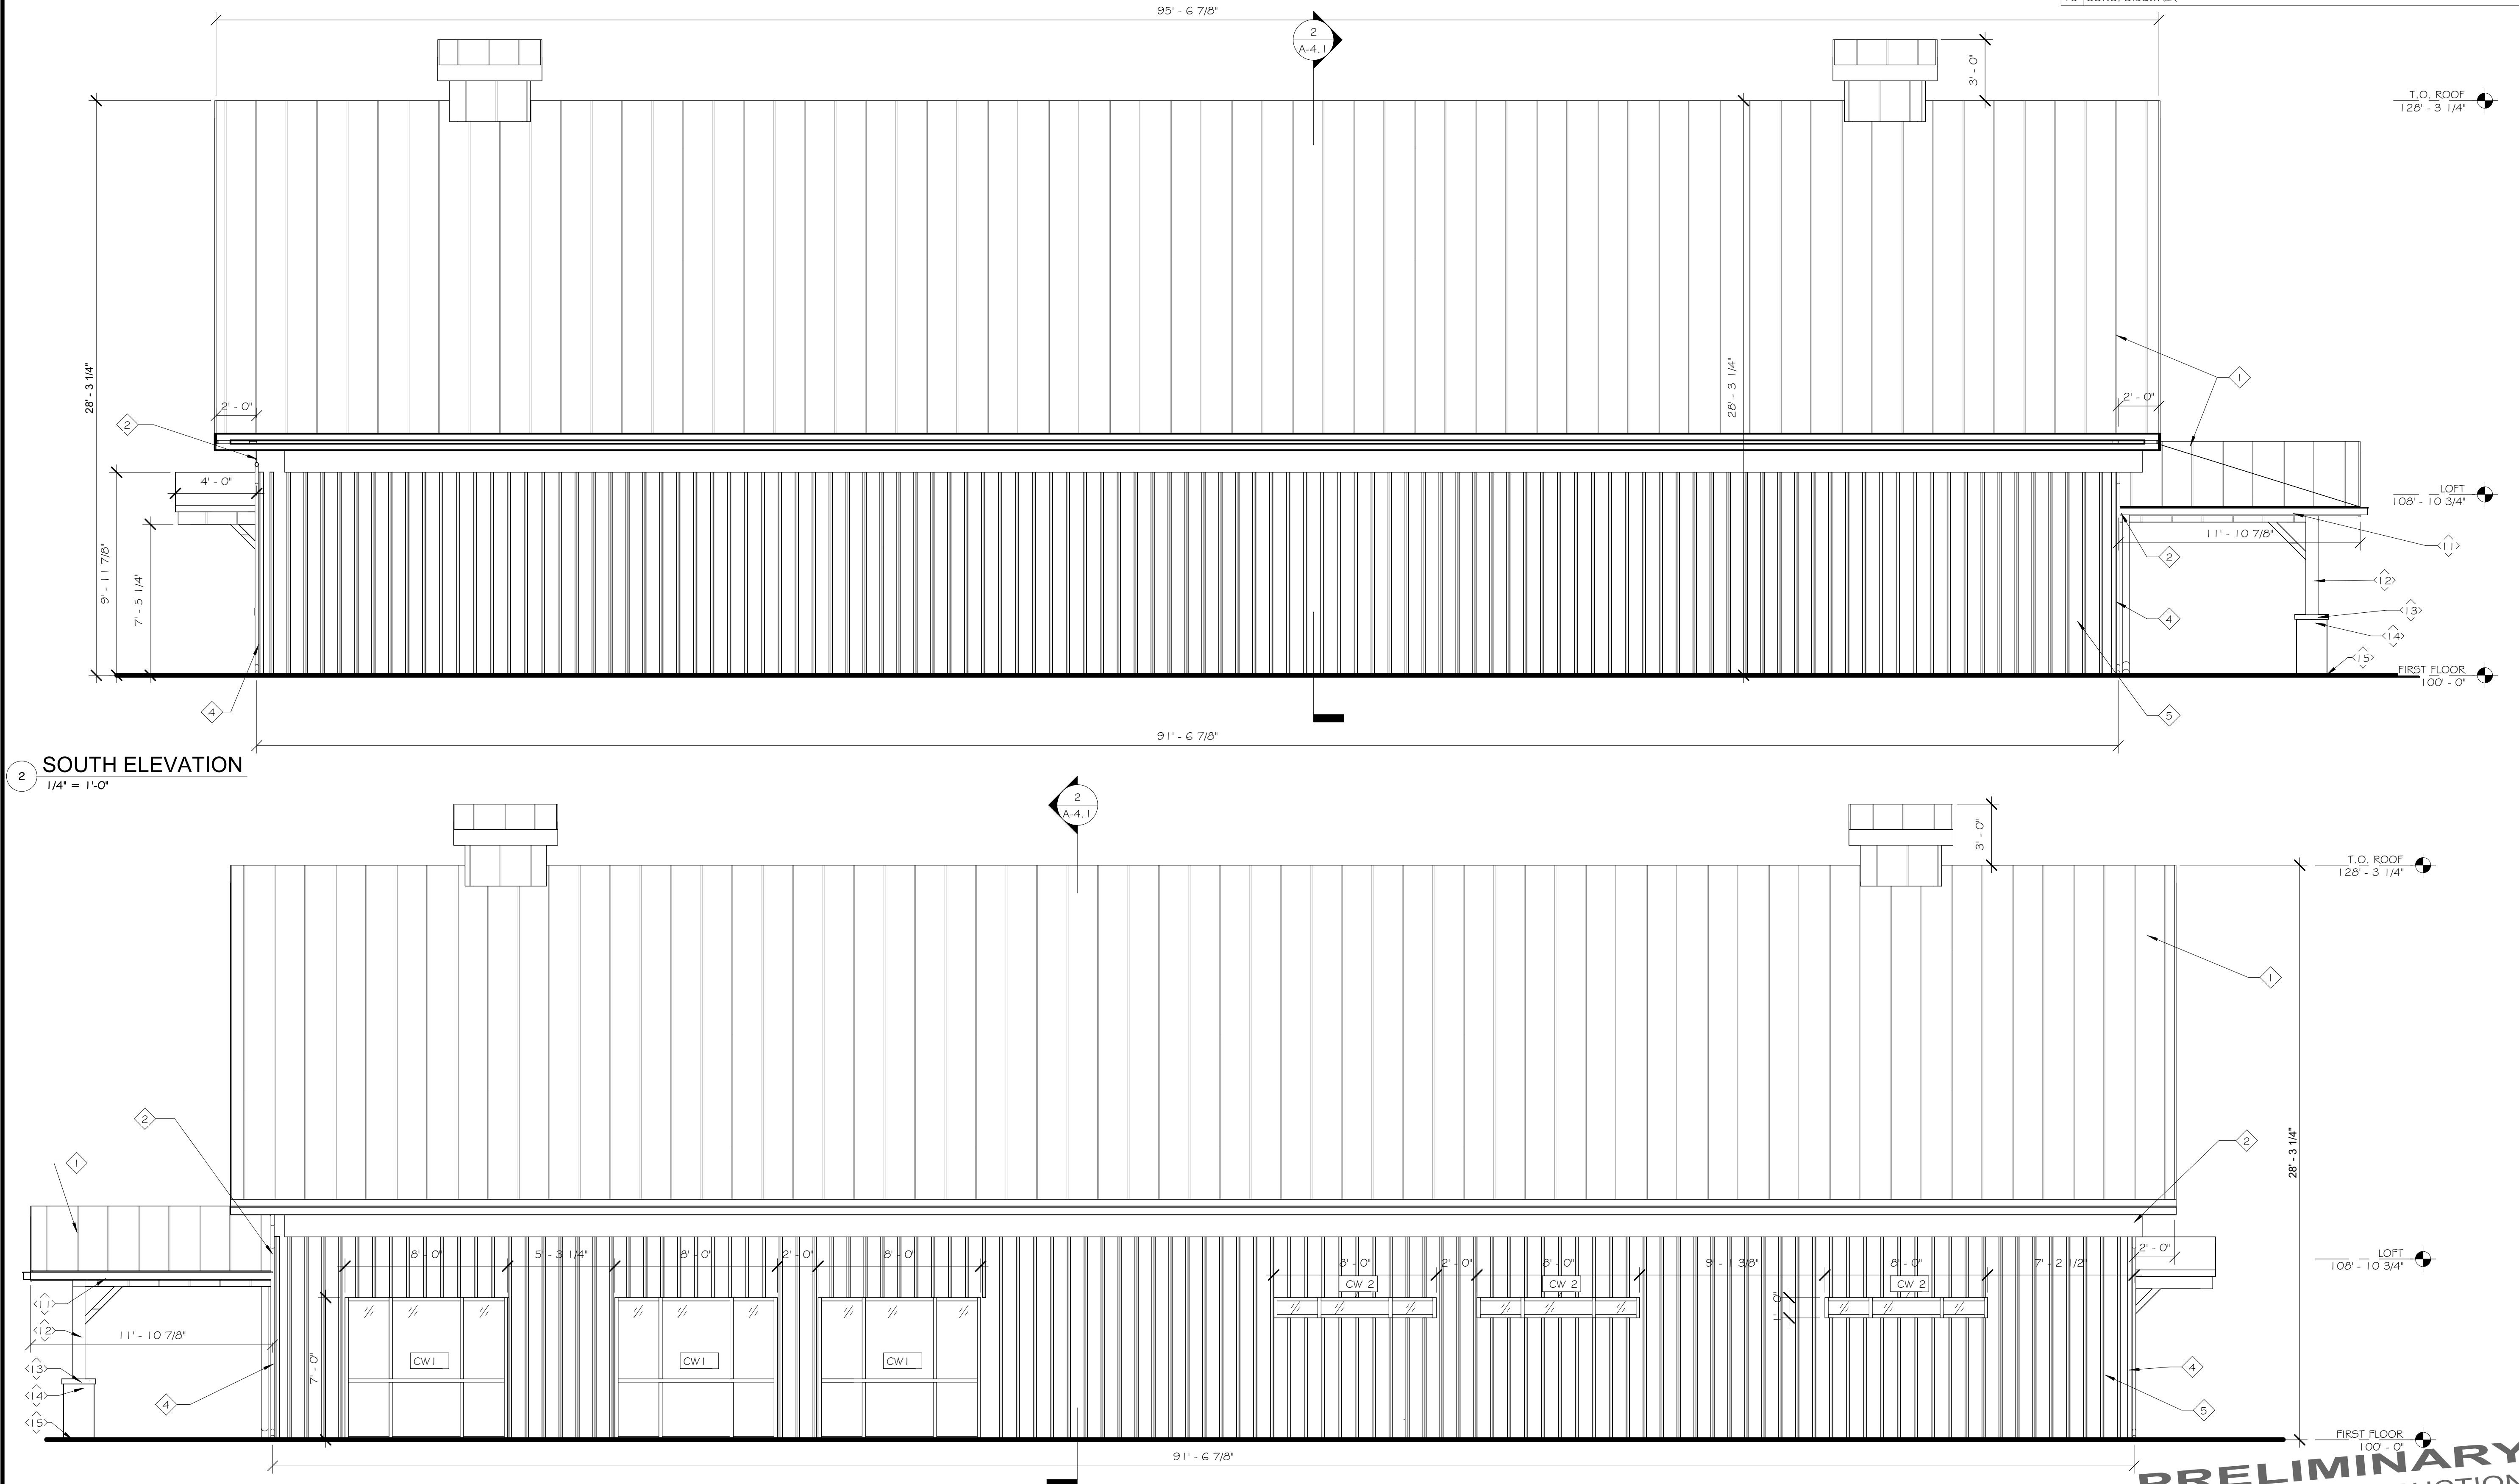
FIRST FLOOR REFLECTED CEILING PLAN
1/4" = 1'-0"



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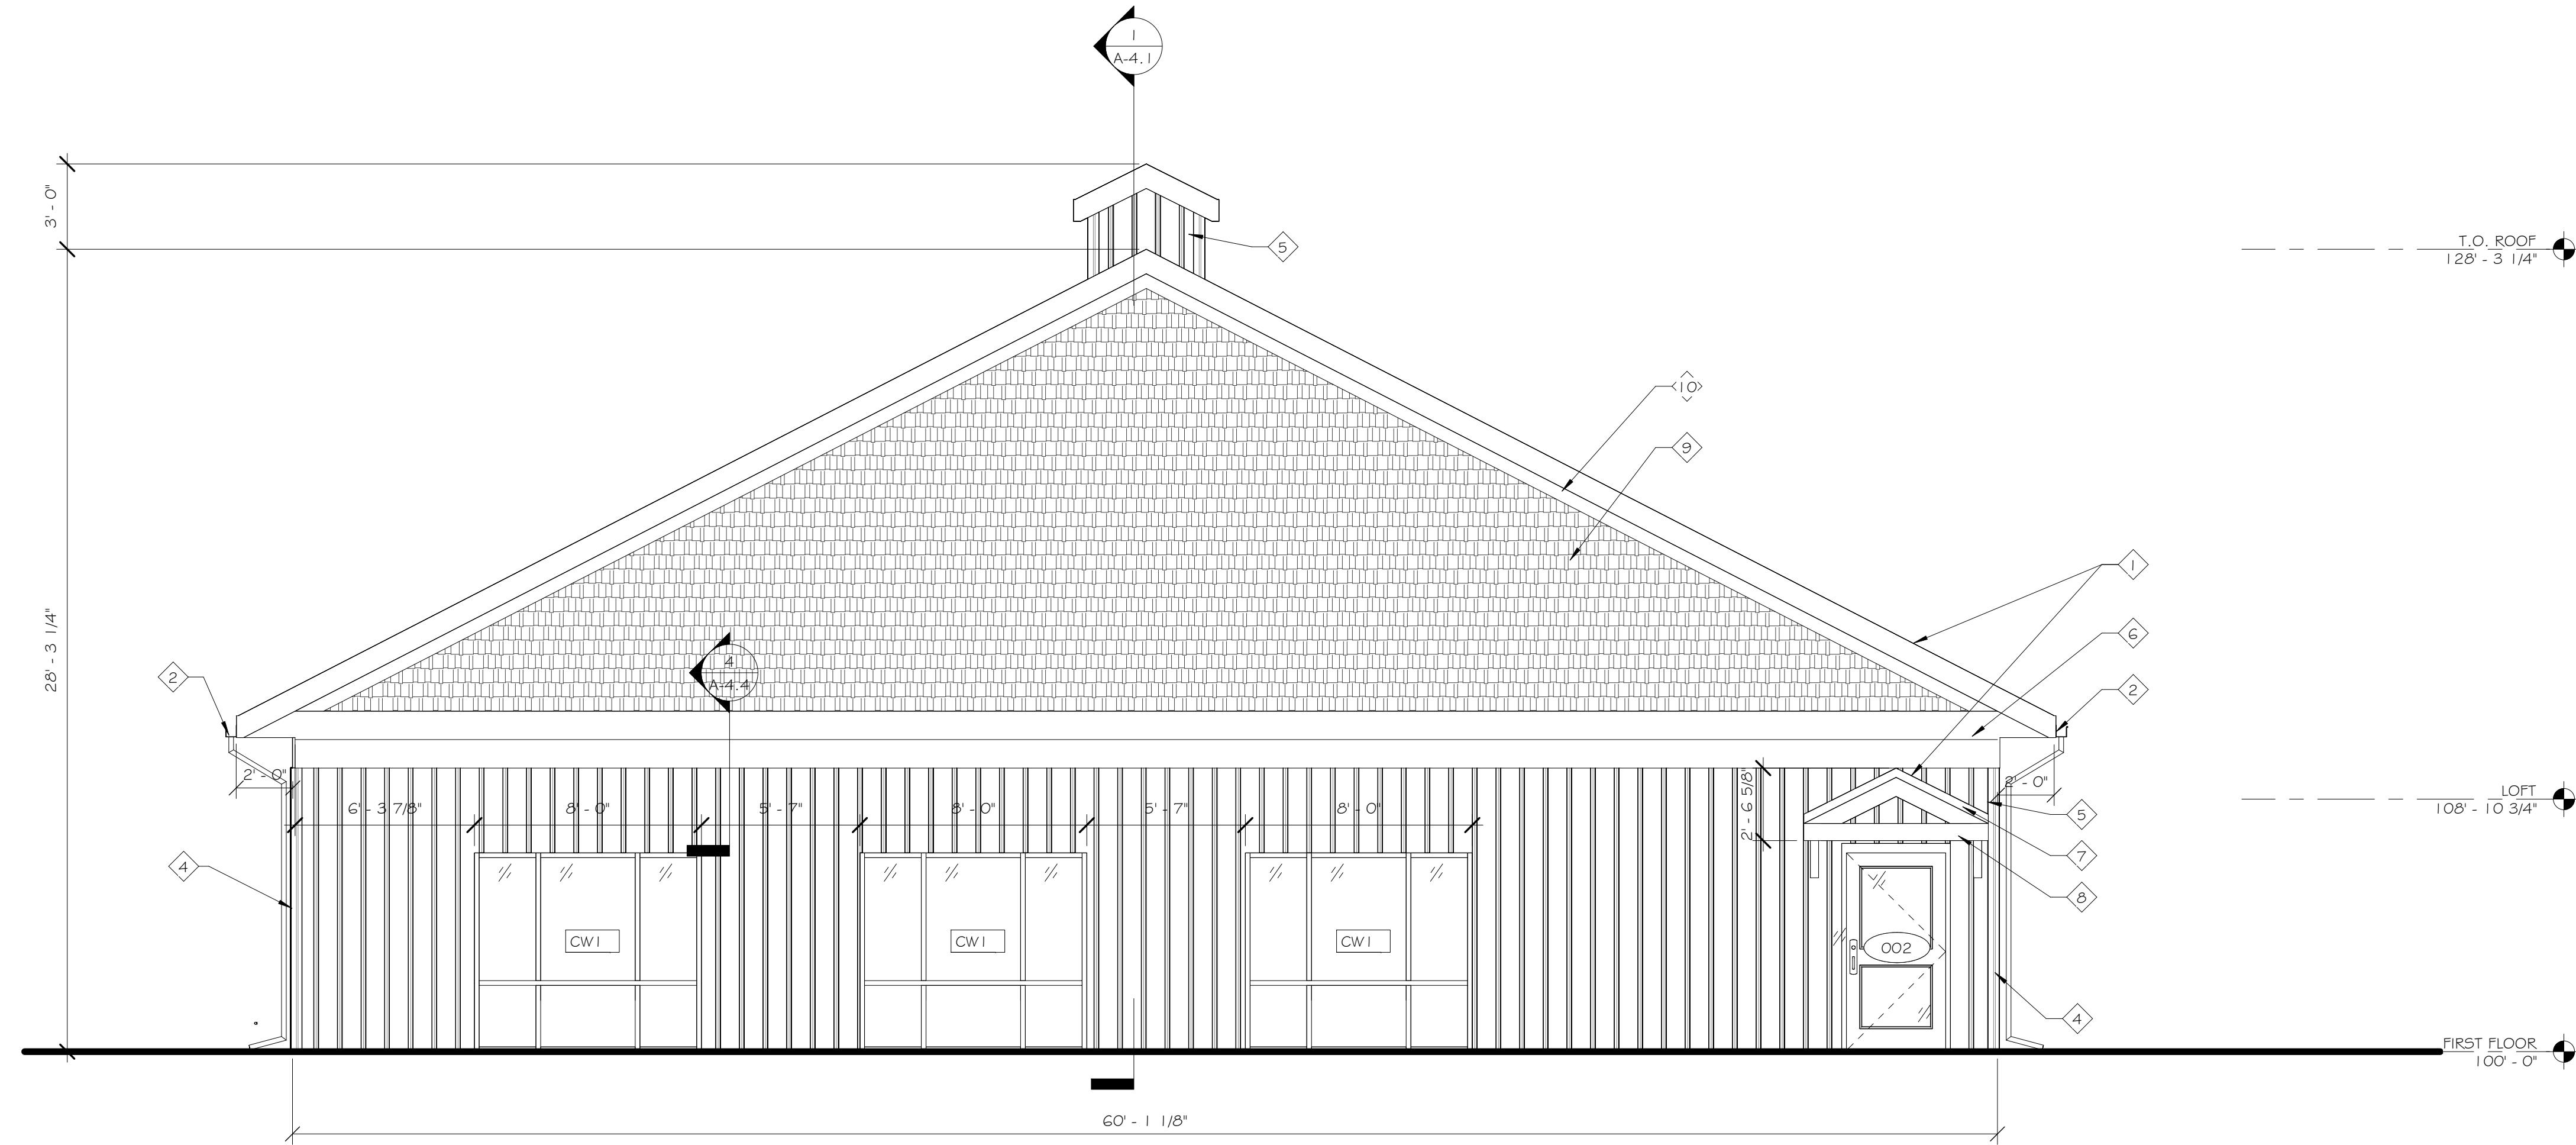
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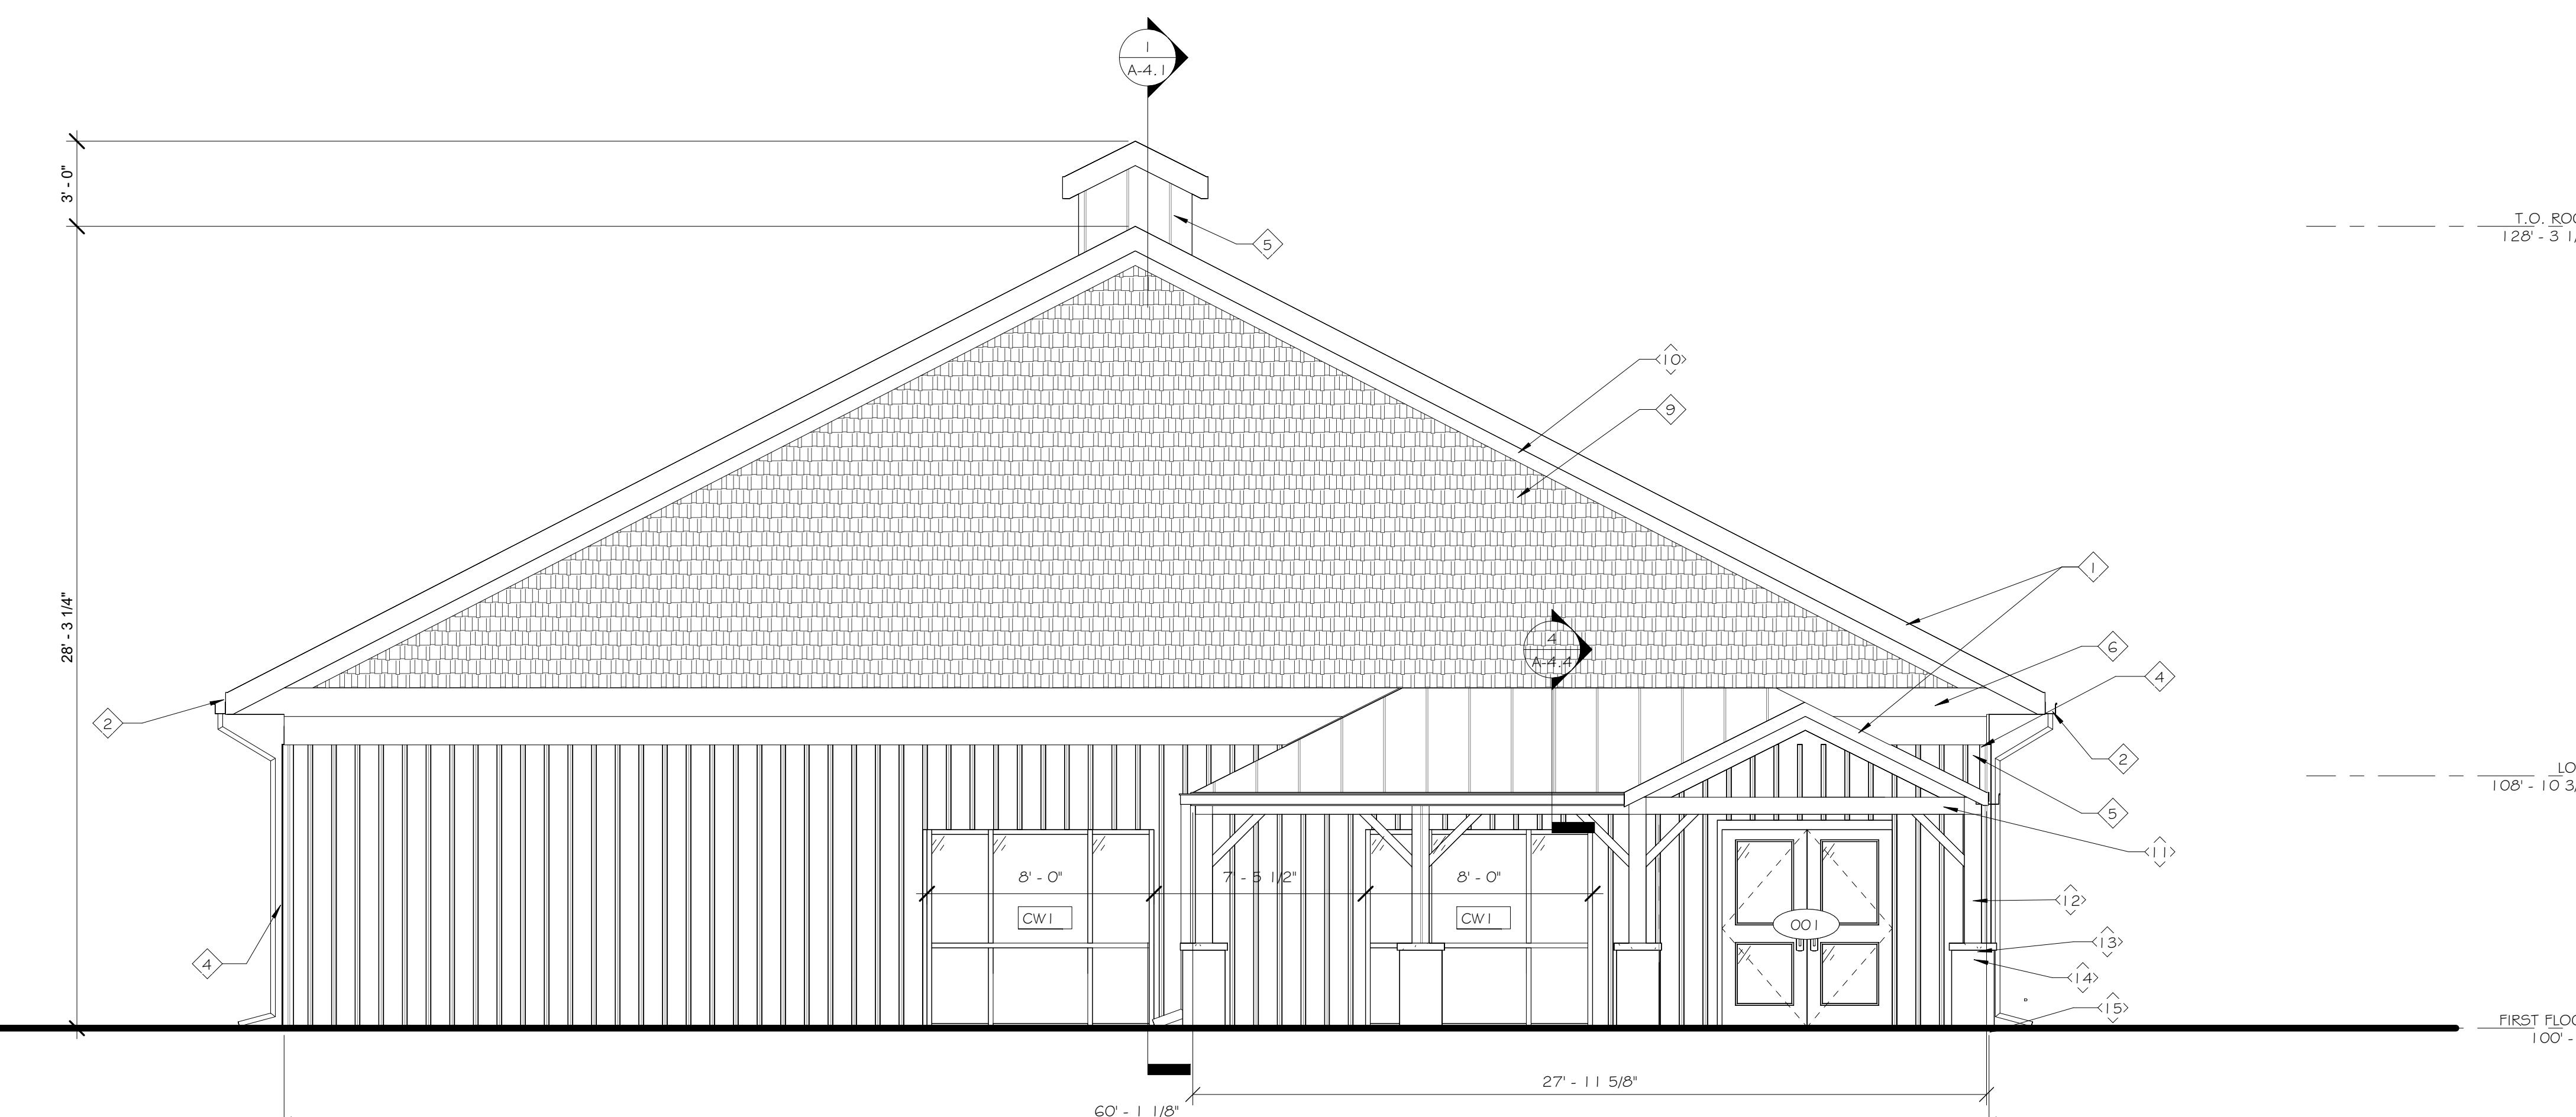
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 ELMIRA, NY 14901
 TITLE OF DRAWING
 EXTERIOR ELEVATIONS - EAST/WEST

DRAWING SCALE
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A-3.2

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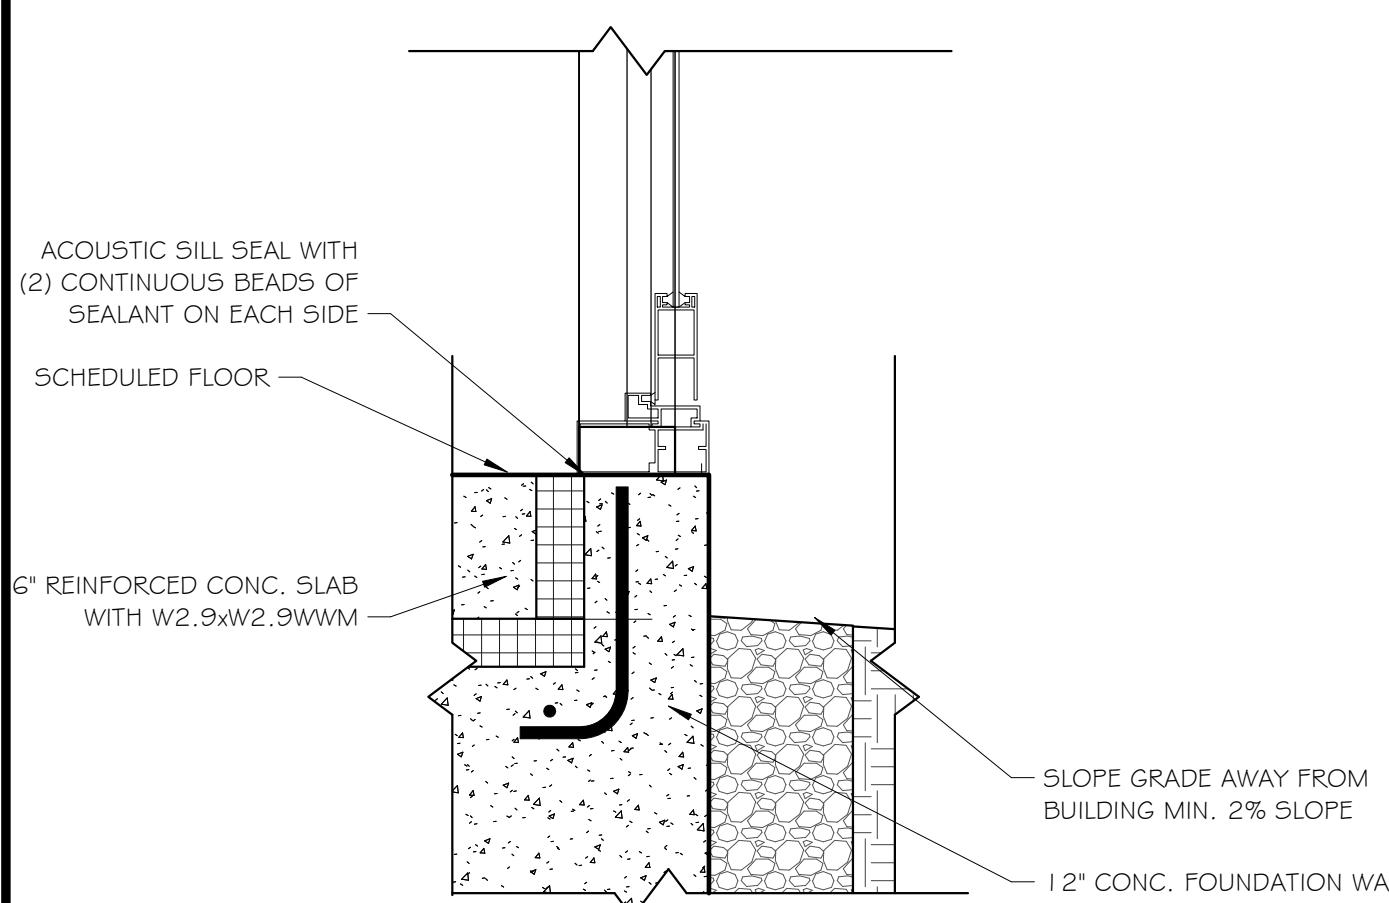
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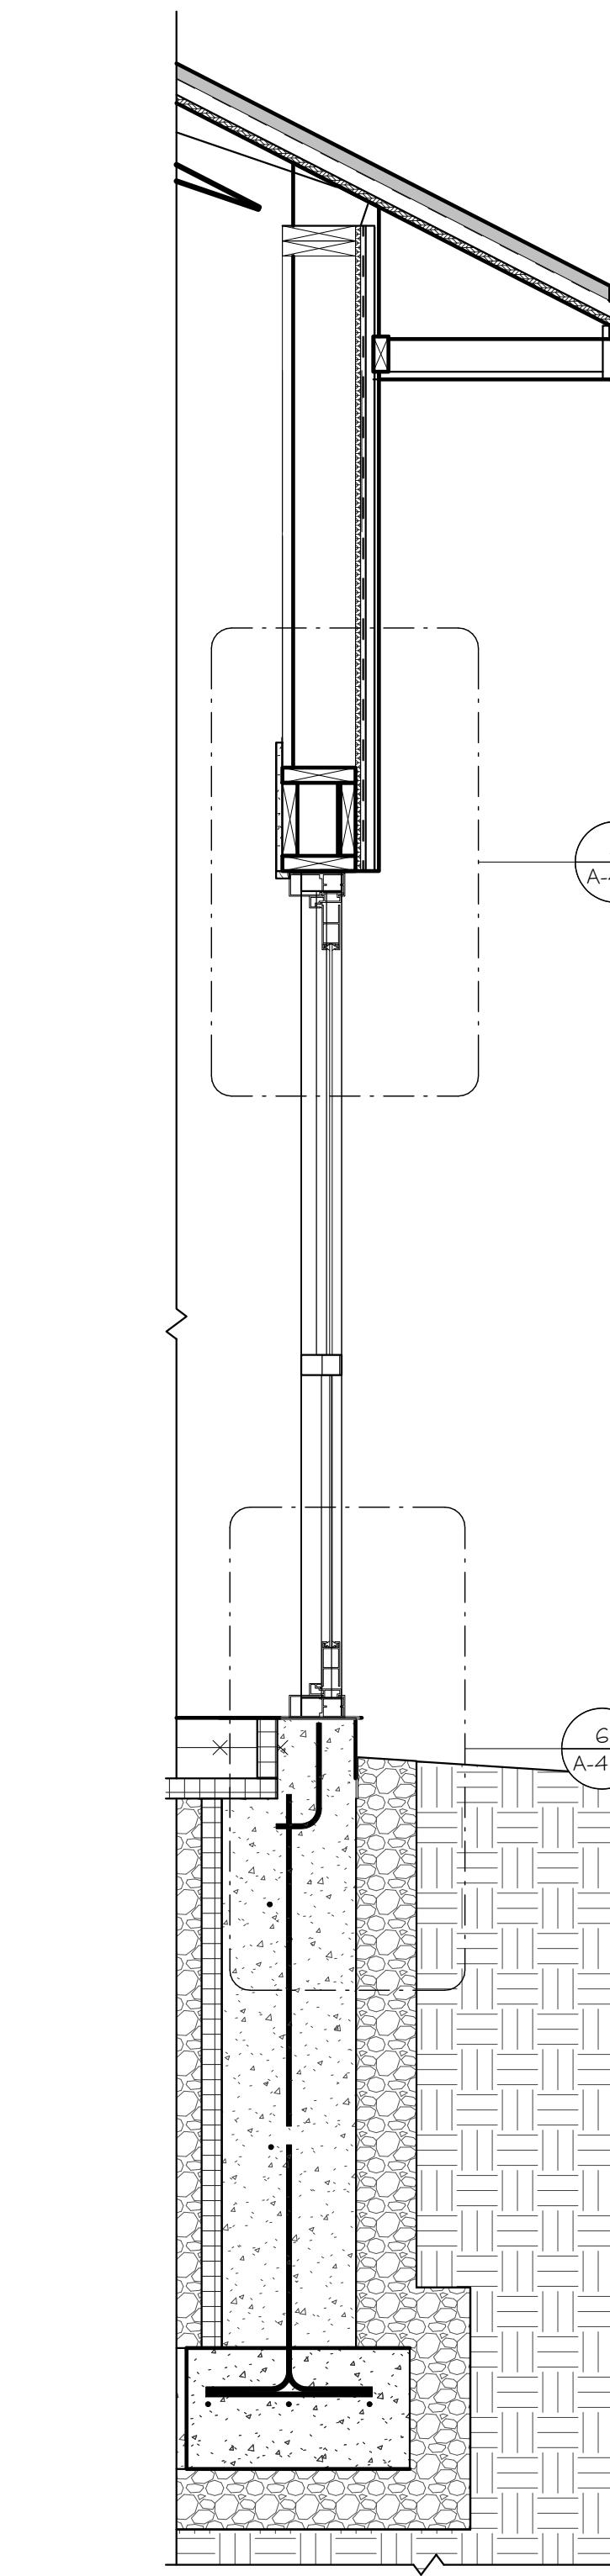
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A-4.2

5 TYP. DETAIL @ CURTAIN WALL HEADER
1 1/2" = 1'-0"

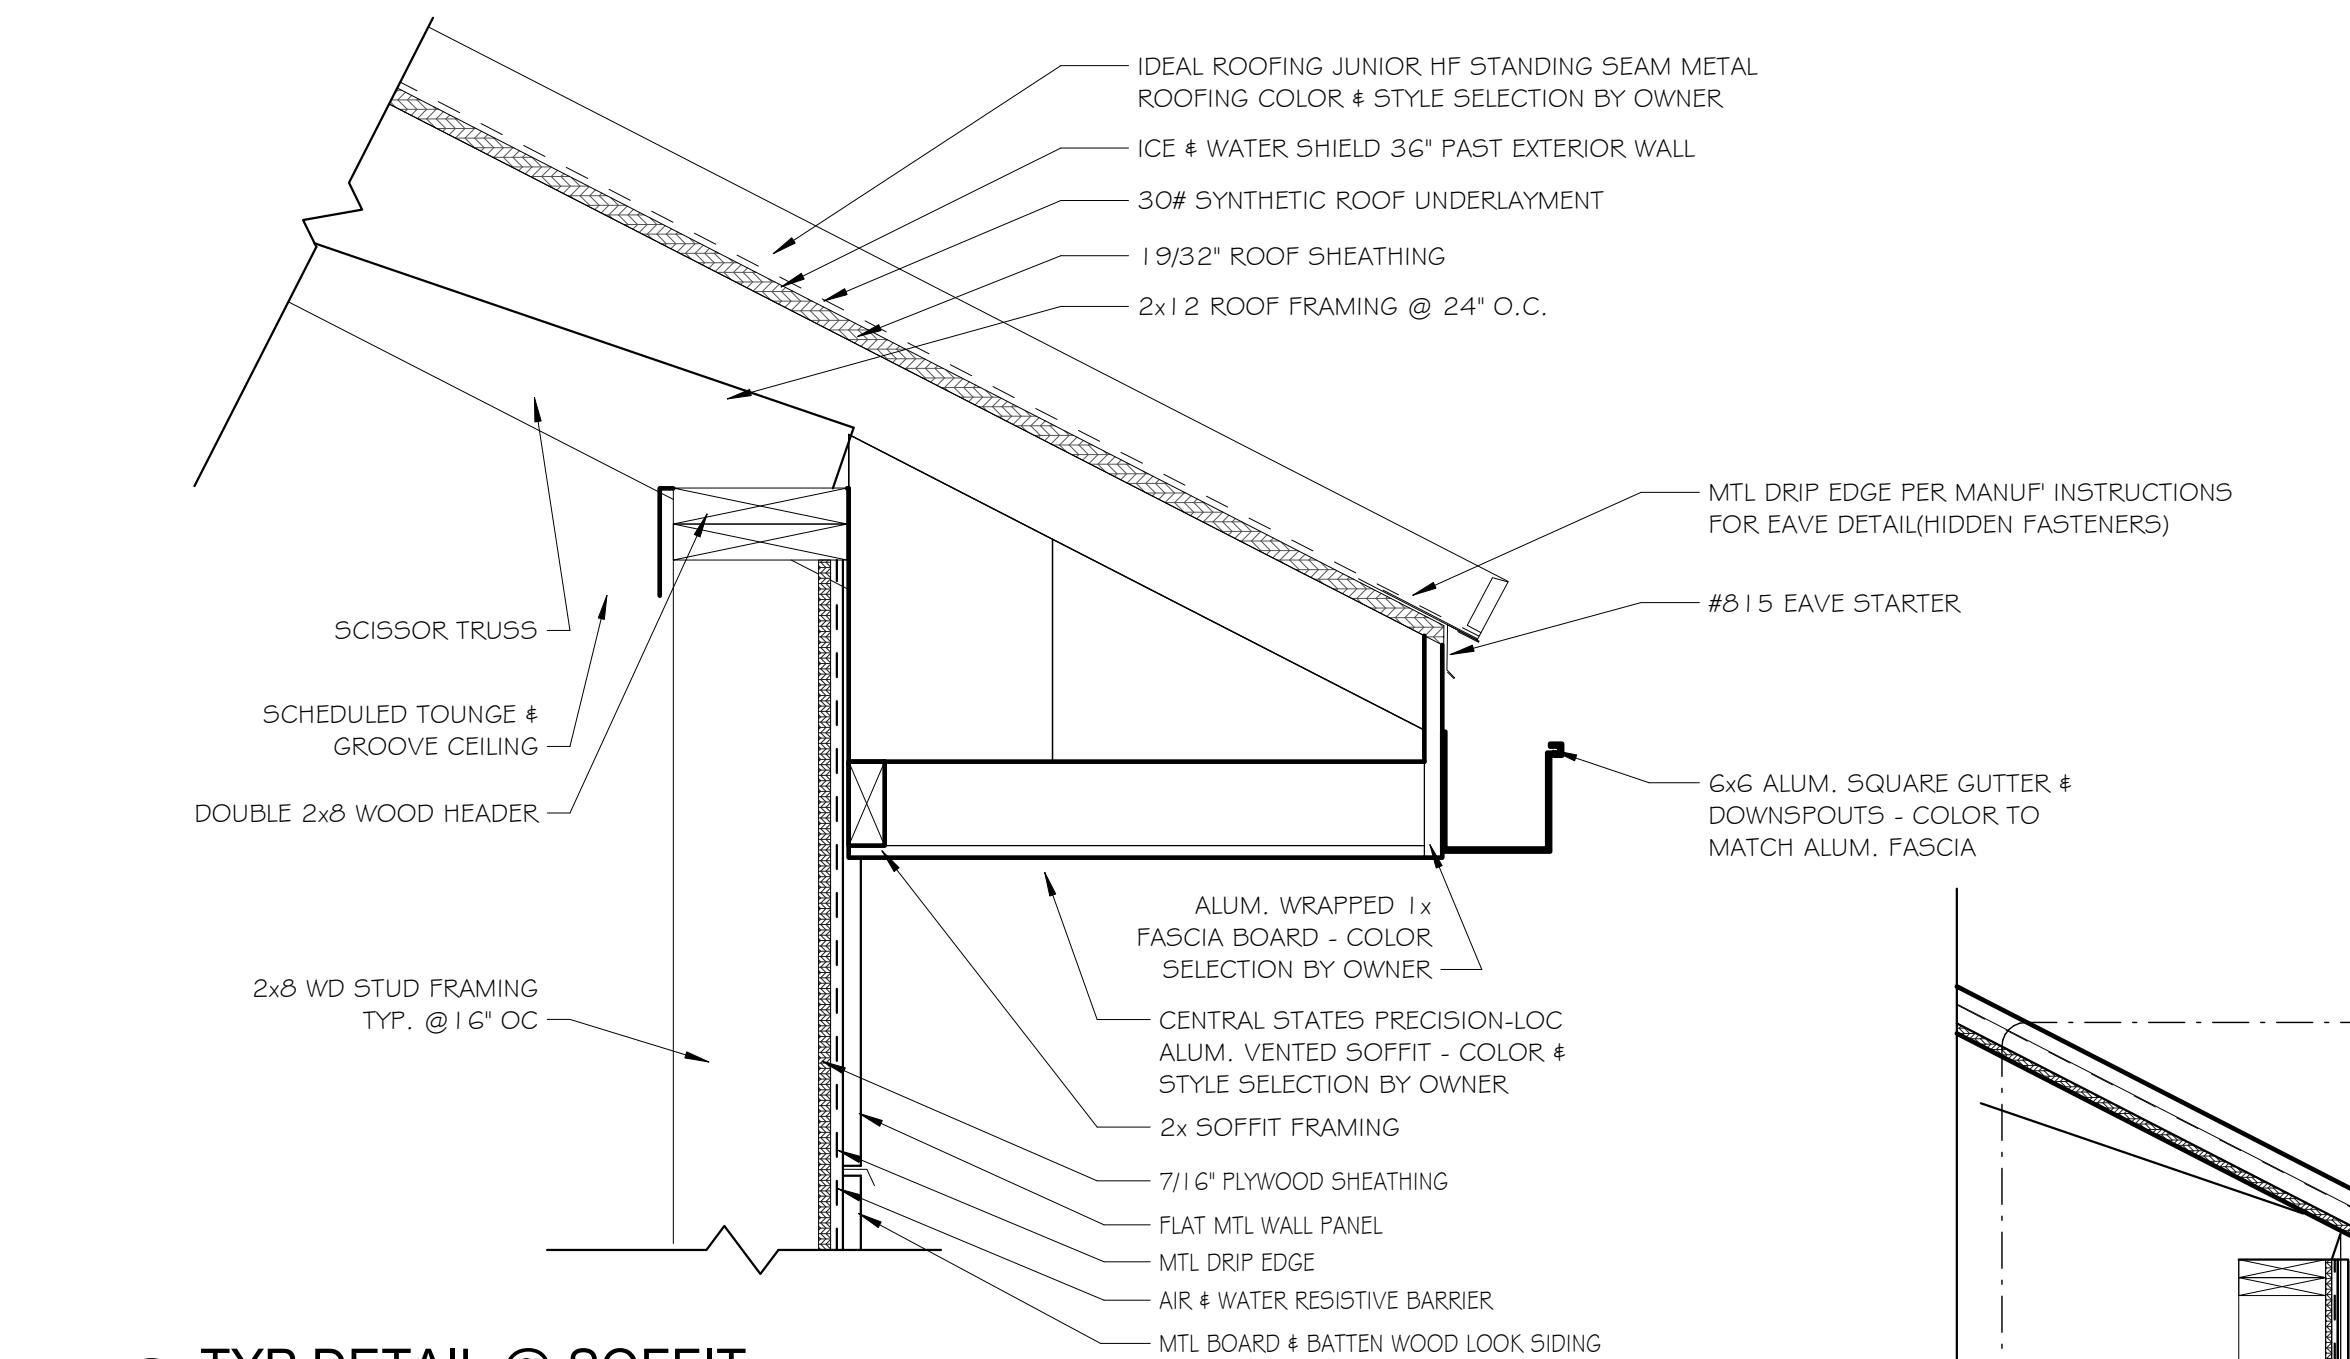


6 TYP. DETAIL @ EXTERIOR CURTAIN WALL BASE
1 1/2" = 1'-0"

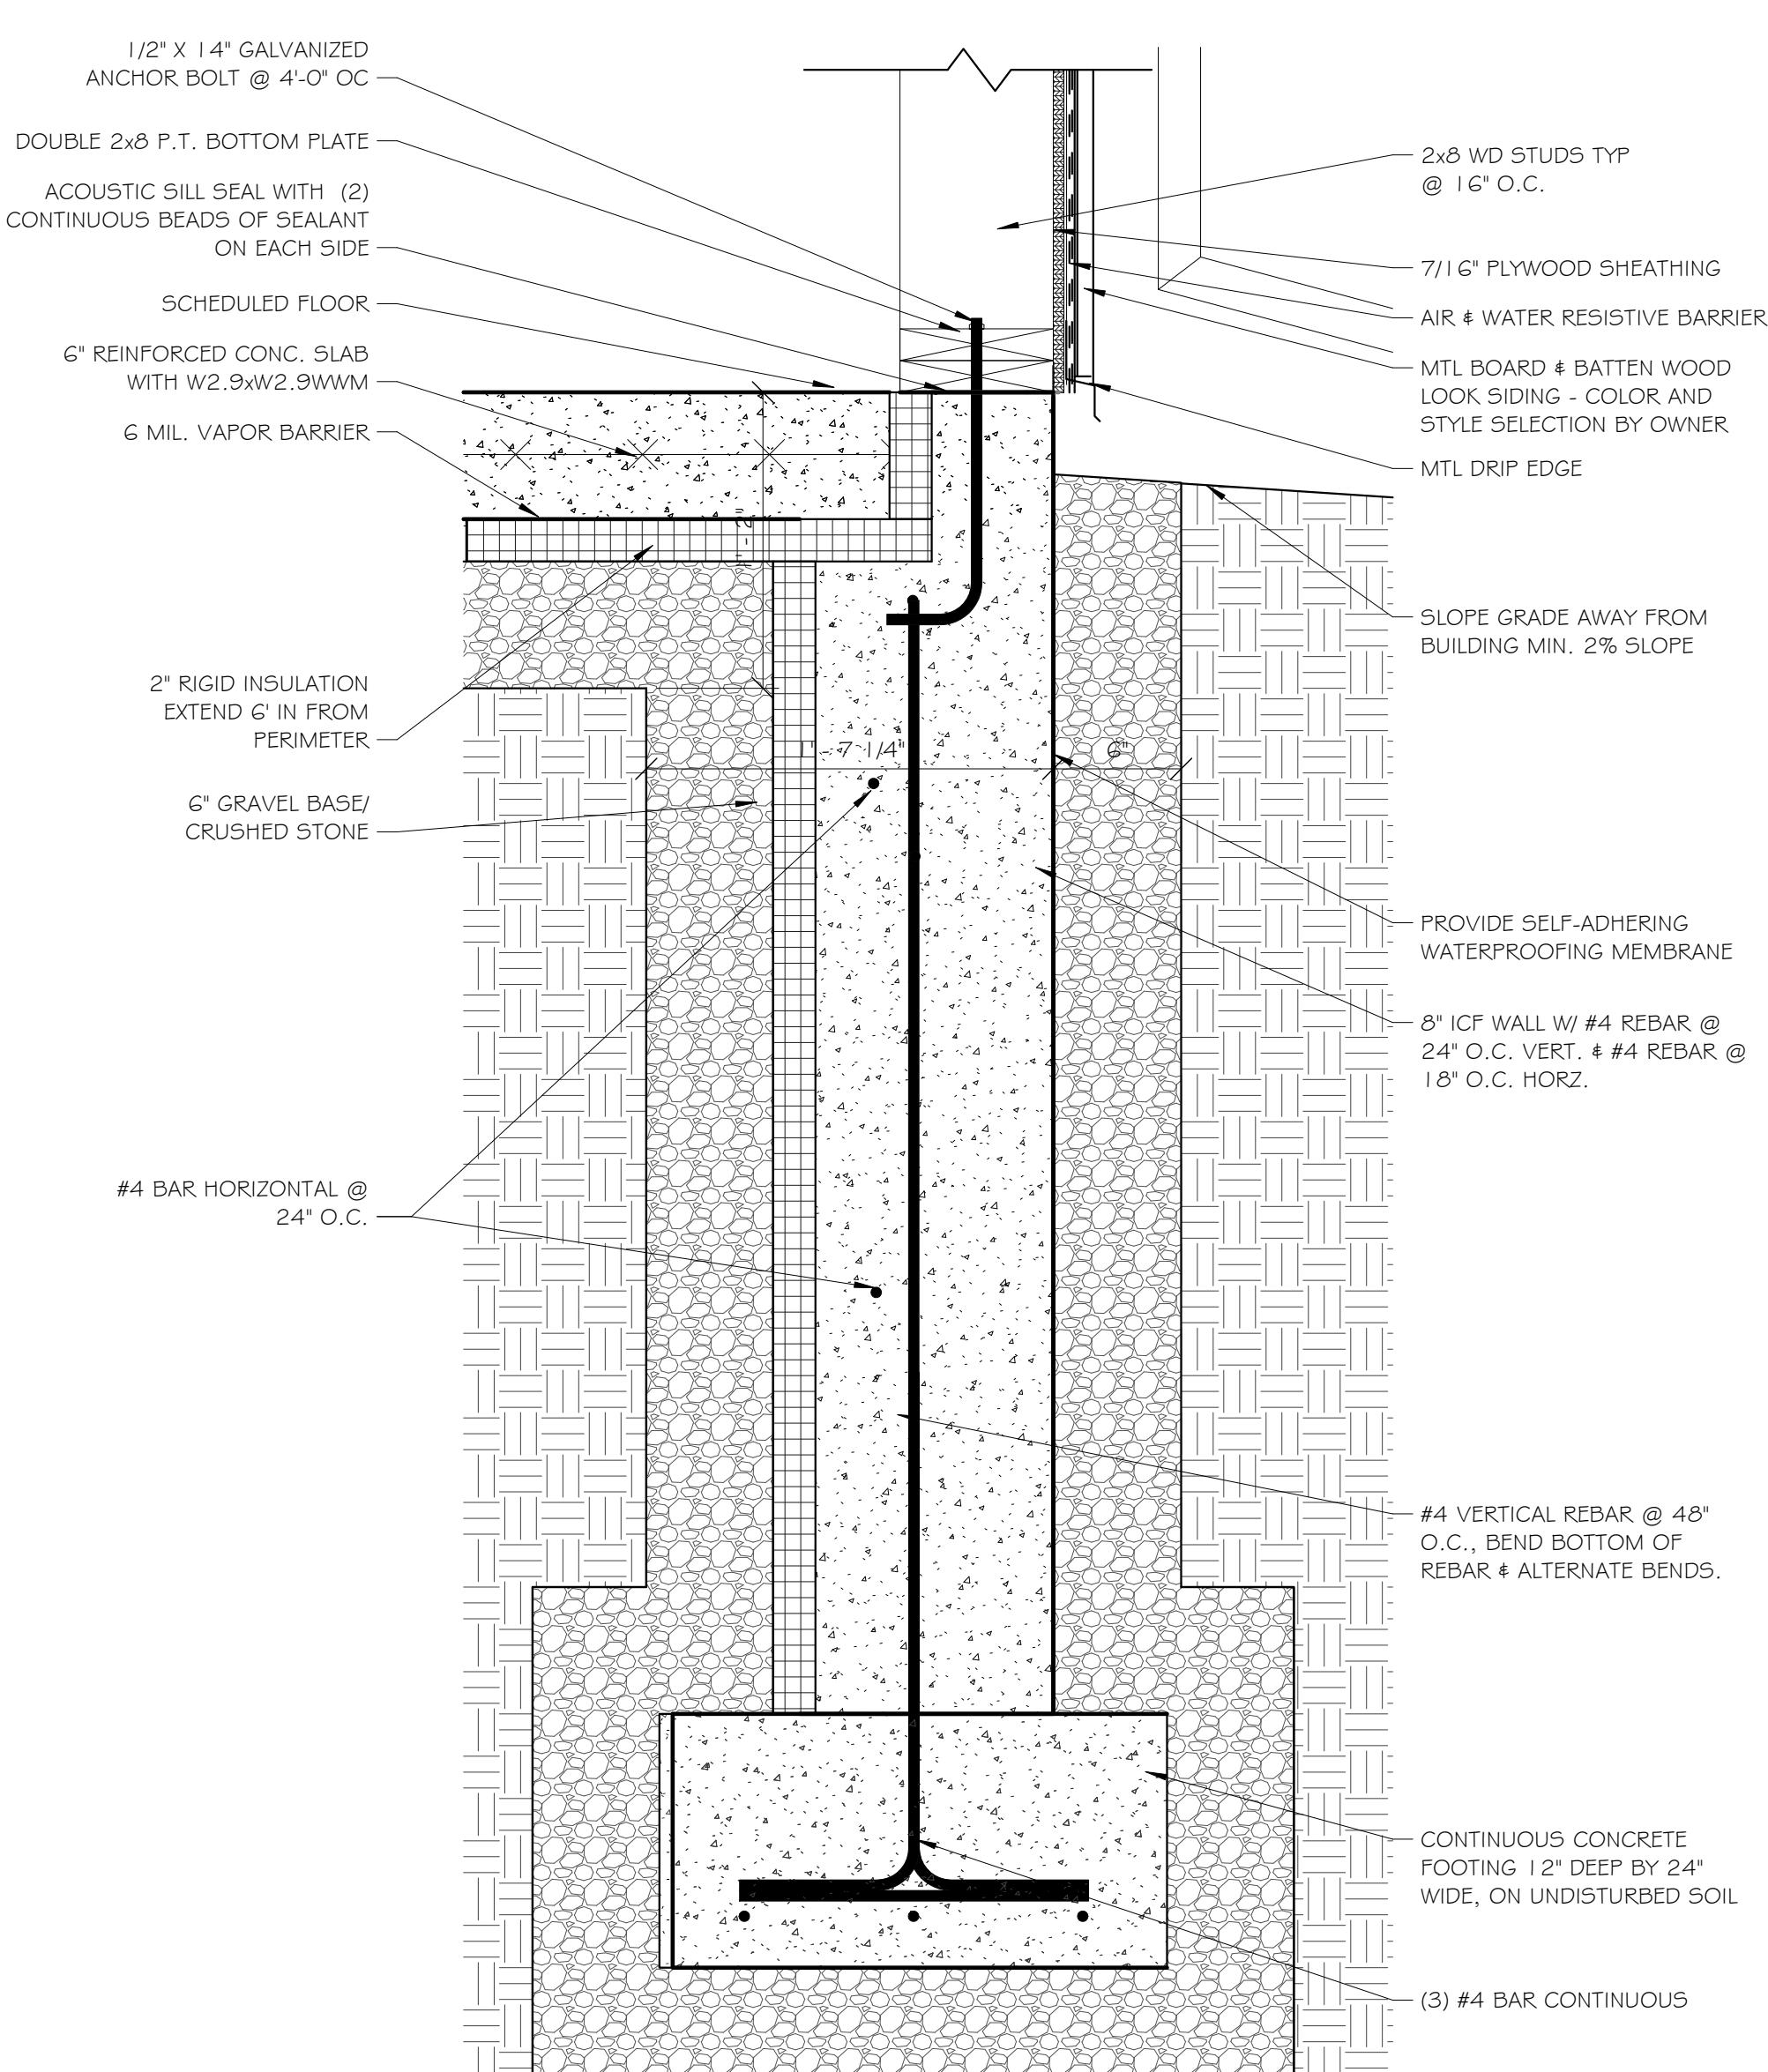


4 WALL SECTION @ CURTAIN WALL
3/4" = 1'-0"

3 TYP. DETAIL @ EXTERIOR WALL BASE
1 1/2" = 1'-0"

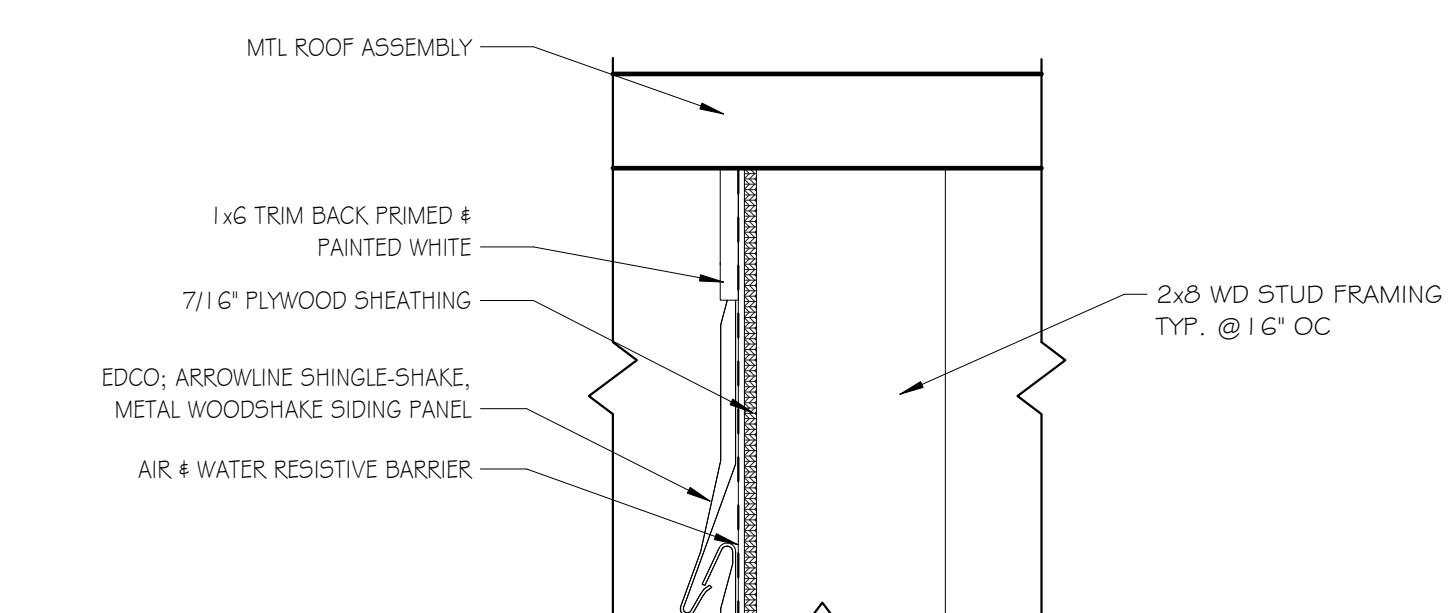


2 TYP. DETAIL @ SOFFIT
1 1/2" = 1'-0"

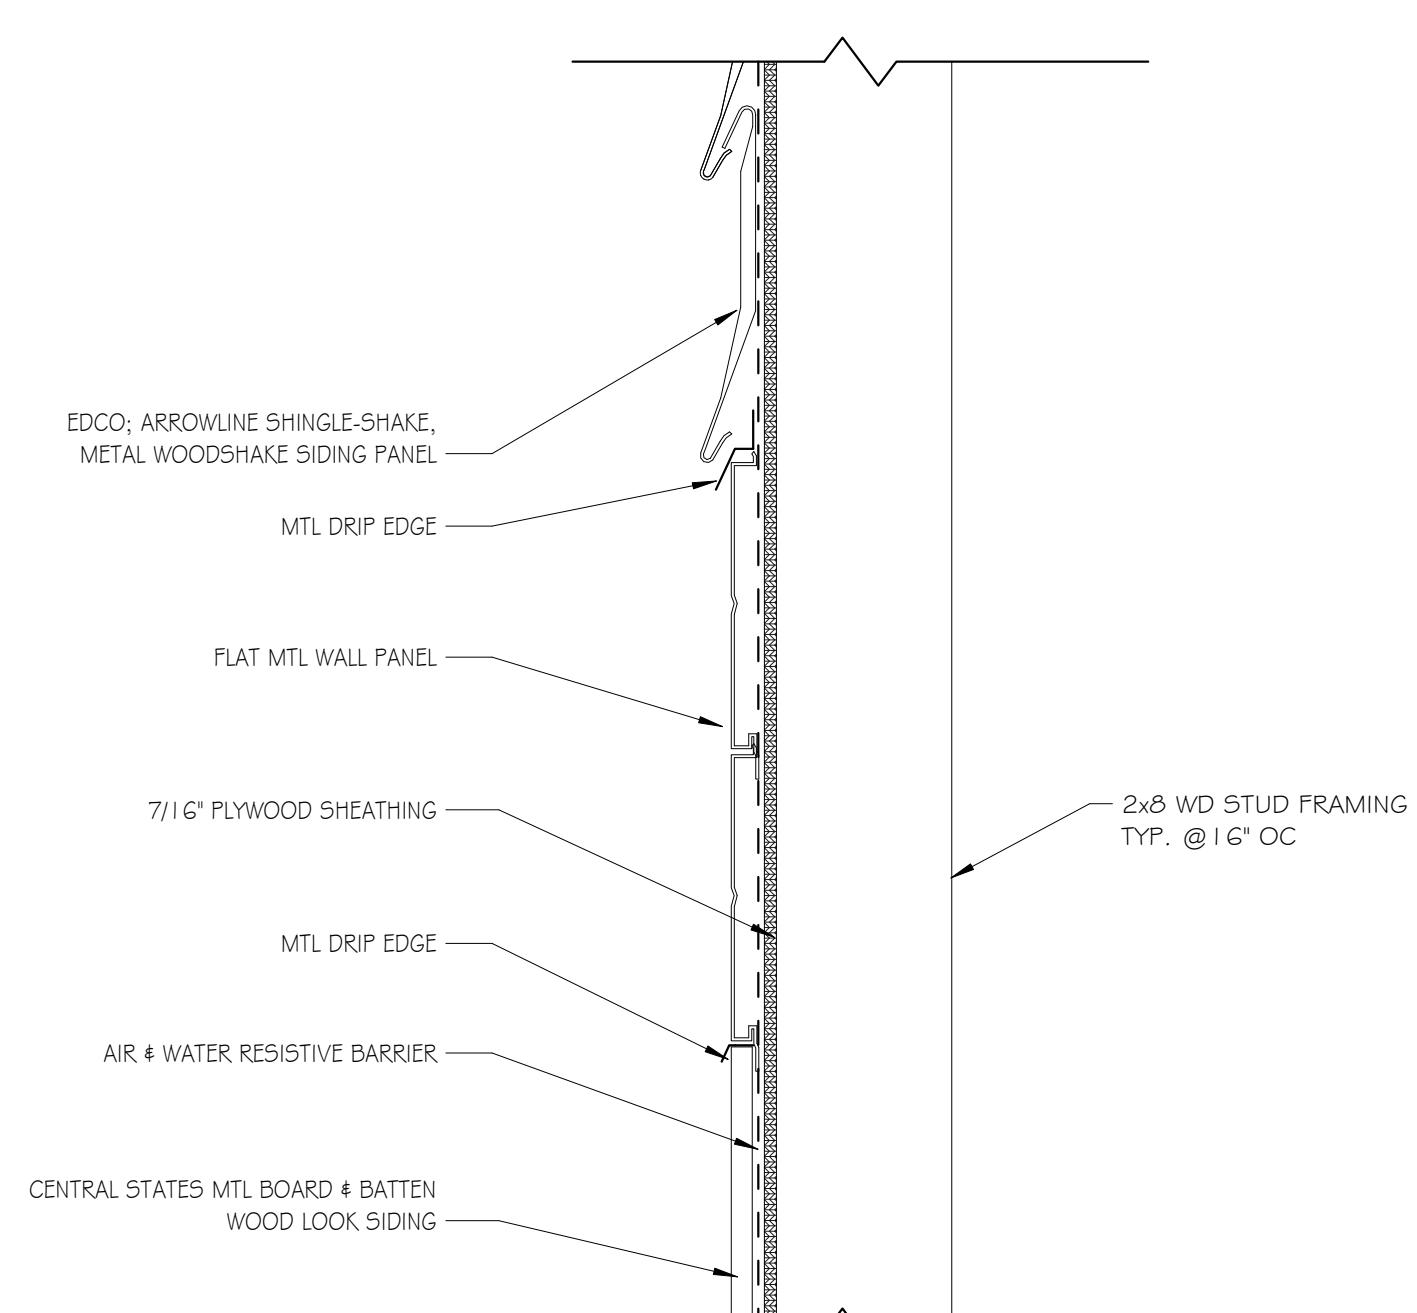


1 TYP. WALL SECTION
3/4" = 1'-0"

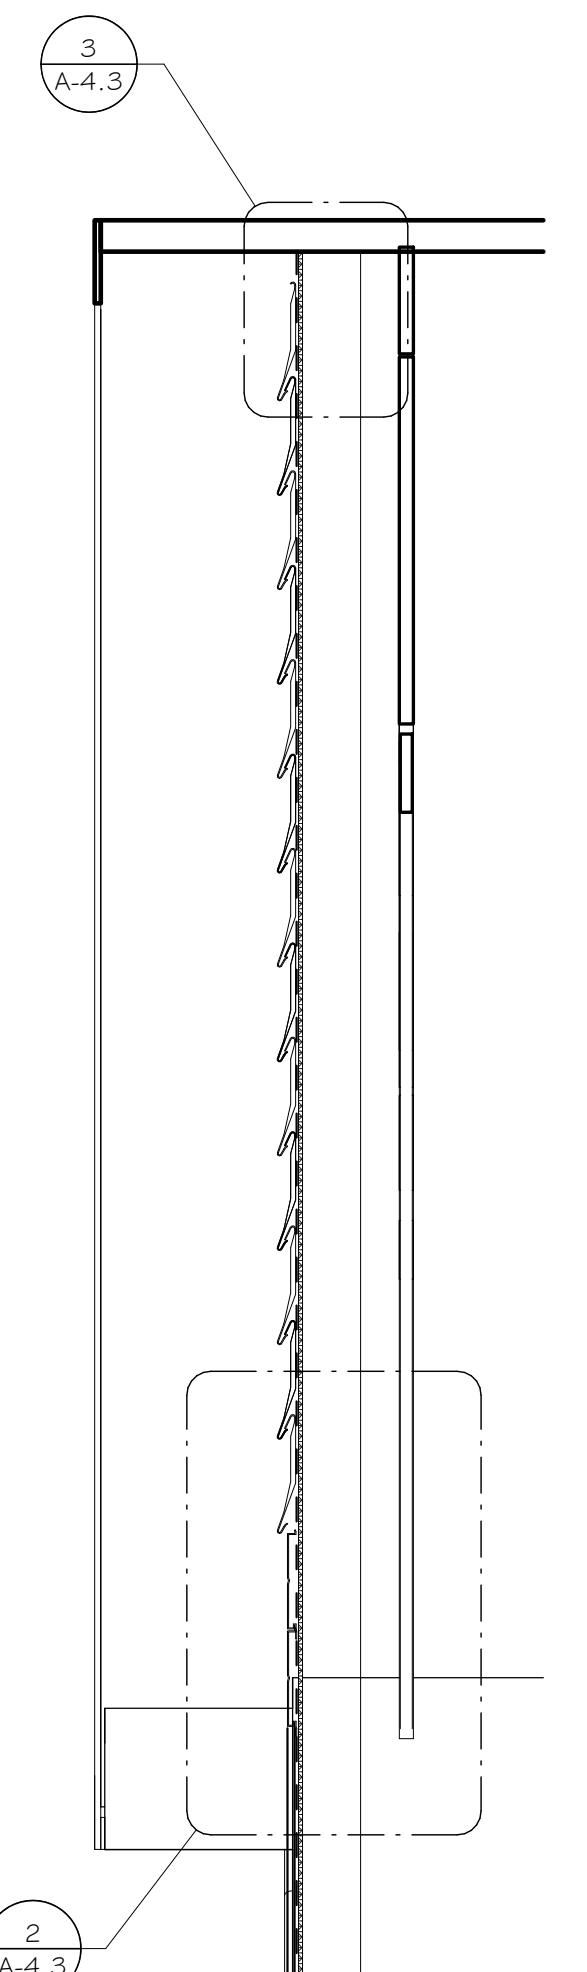
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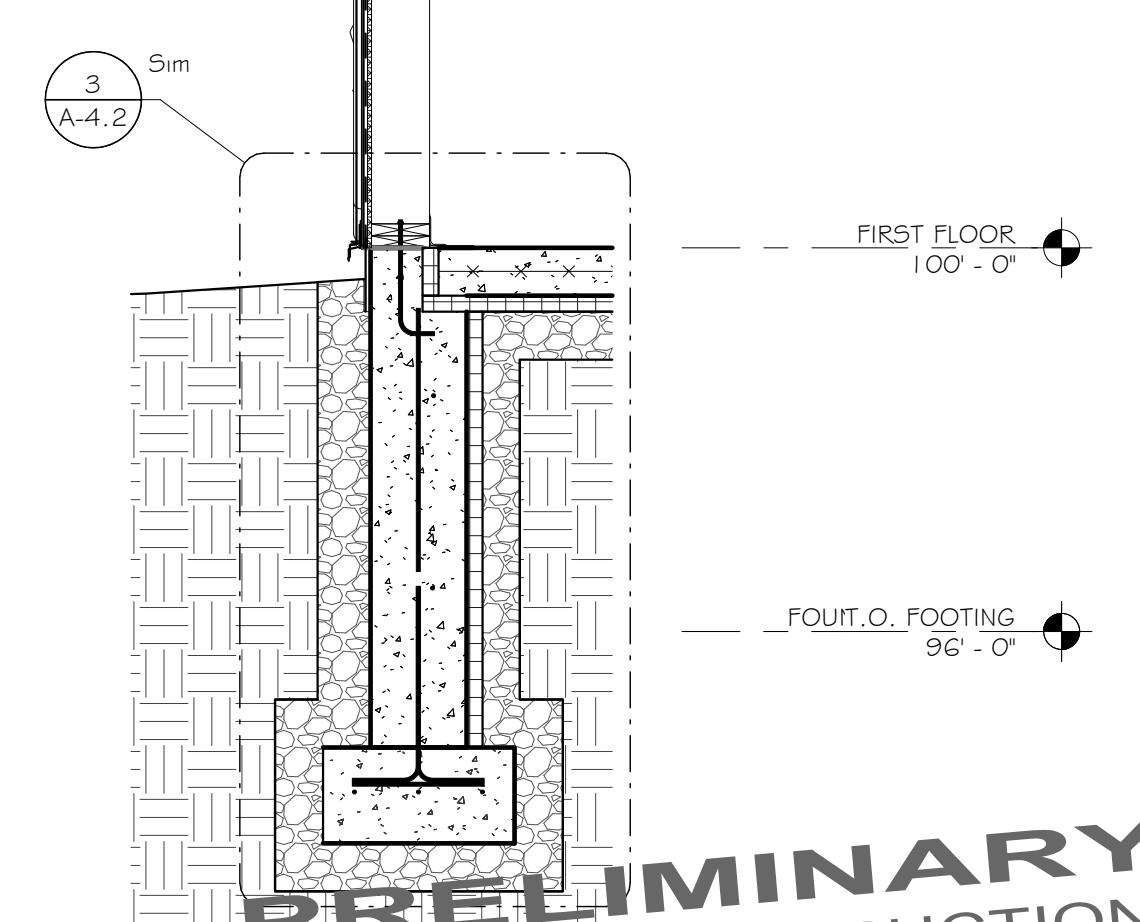
3 TYP SECTION @ EAST/WEST WALL TOP
1 1/2" = 1'-0"



2 TYP SECTION @ EXTERIOR WALL FINISHES
1 1/2" = 1'-0"



2 A-4.3
LOFT
108" - 10 3/4"



1 TYP SECTION @ EAST/WEST WALL
1/2" = 1'-0"

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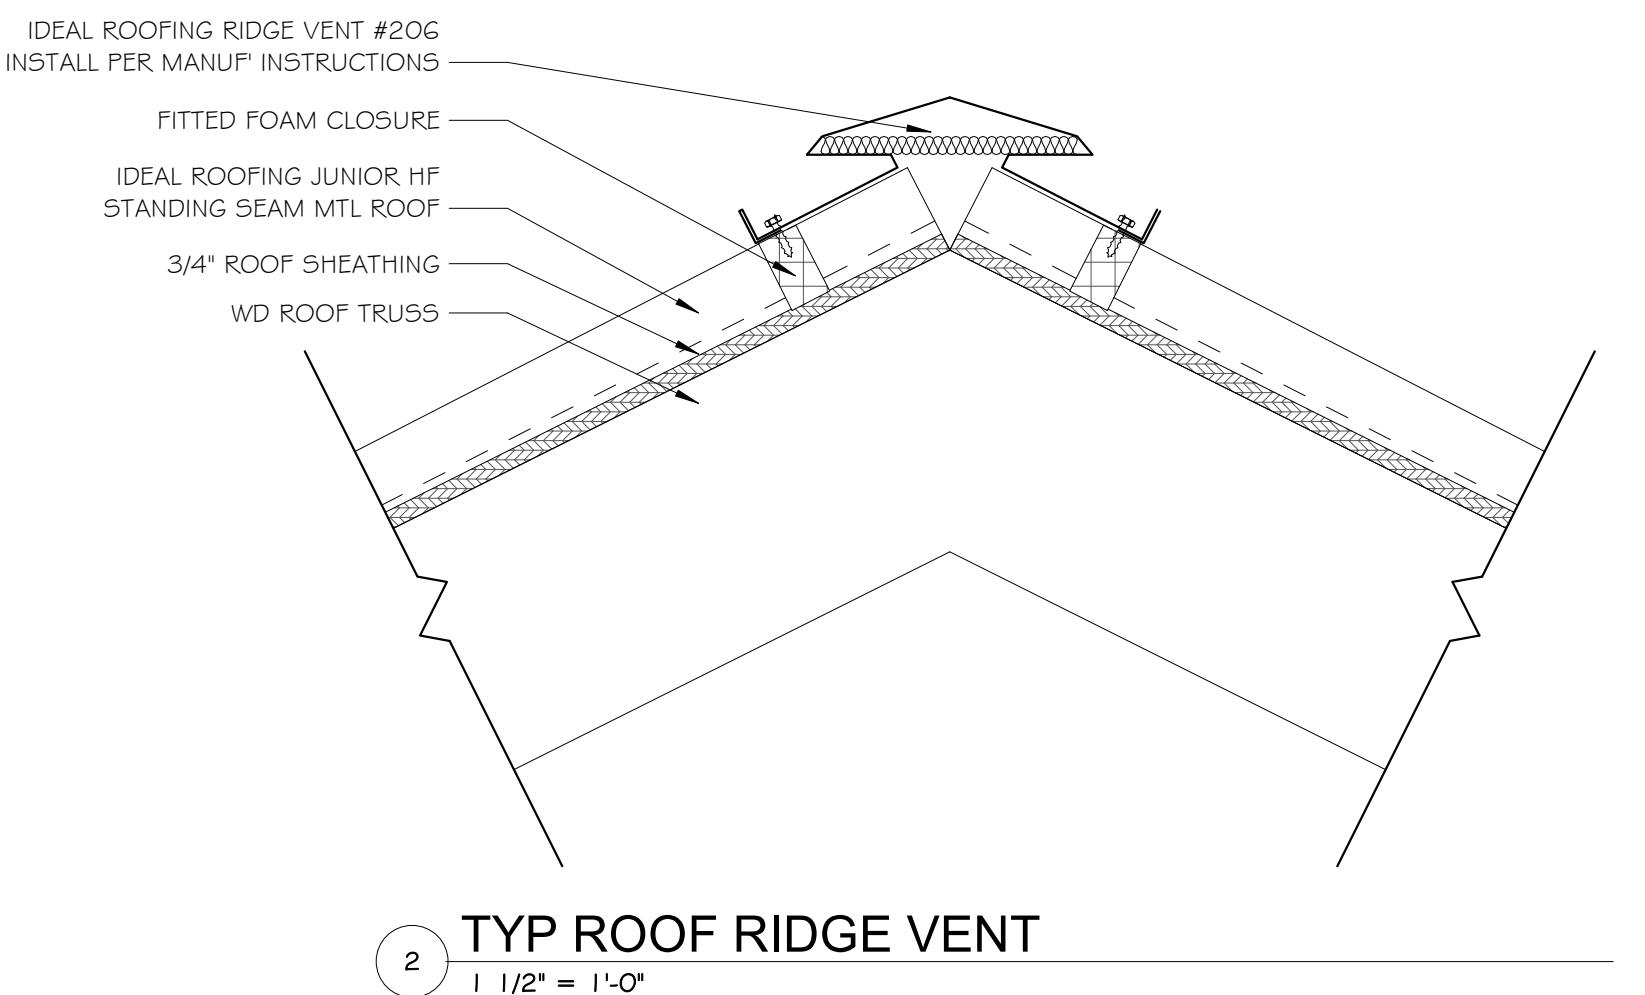
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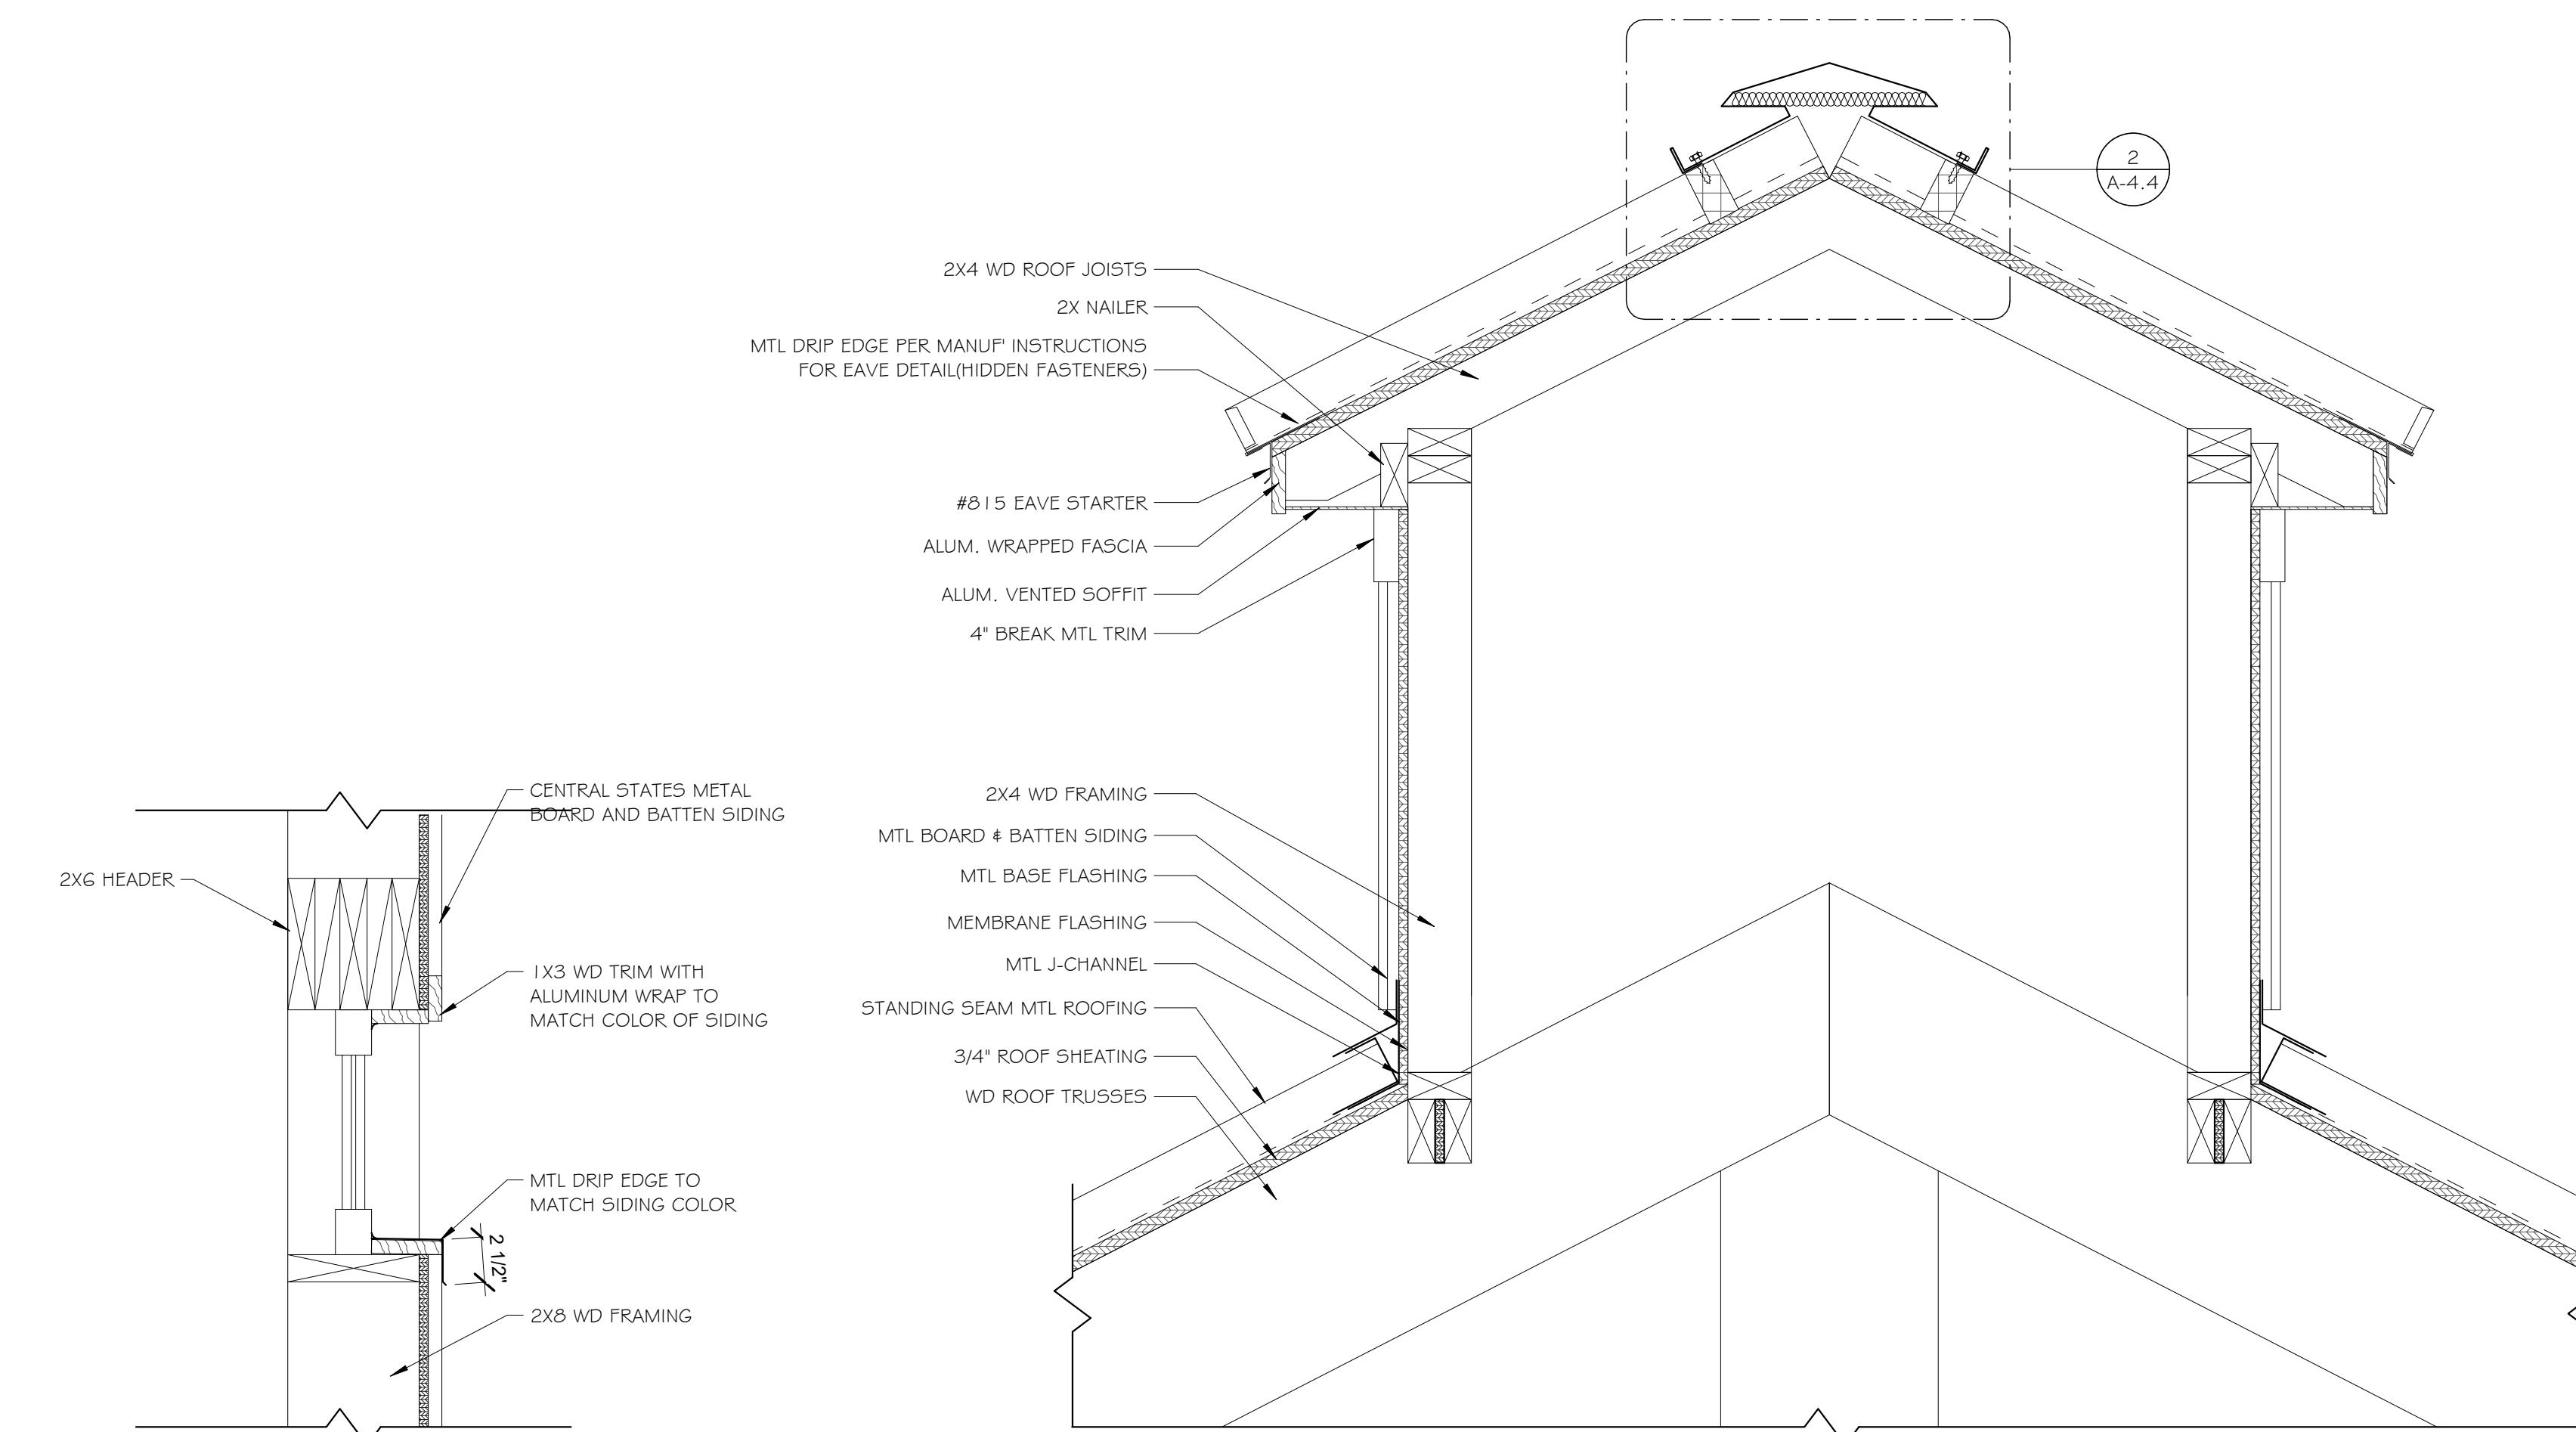
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2 TYP ROOF RIDGE VENT
1 1/2" = 1'-0"



1 SECTION @ CUPOLA
1 1/2" = 1'-0"

3 SECTION @ EXTERIOR TRANSMON
1 1/2" = 1'-0"

4 SECTION @ FRONT CANOPY
1 1/2" = 1'-0"

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A-4.4

DOOR SCHEDULE

| TAG | DOOR | | | FRAME | | | | | | FIRE RATING | HARDWARE SET | REMARKS | |
|-----|---------|---------|-------------|--------|-------|------------|-----------|--------------|------|-------------|--------------|---------|---|
| | SIZE | TYPE | MATERIAL | FINISH | GLASS | FRAME TYPE | FRAME MAT | FRAME FINISH | HEAD | JAMB | SILL | | |
| 101 | 6' - 0" | 7' - 0" | 0' - 1 3/4" | 1 | ALUM | PNT-1 | * | A | ALUM | PNT-1 | --- | 1 | EXTERIOR: STOREFRONT ENTRY - DOUBLE DOORS |
| 102 | 3' - 6" | 7' - 0" | 0' - 1 3/4" | 2 | ALUM | PNT-1 | * | B | ALUM | PNT-1 | --- | 2 | EXTERIOR: STOREFRONT ENTRY - SINGLE DOOR |

- 1" INSULATED LOW-E CATEGORY II TEMPERED SAFETY GLASS
- NOT APPLICABLE

CURTAIN WALL SCHEDULE

| TYPE | MARK | SIZE | | SIZE | | TYPE | MAT | GLASS | THERMAL | DETAILS | | | MFR | COUNT | REMARKS |
|--------------------|------|---------|---------|-------|--------|------|-----|-------|---------|---------|------|------|-----|-------|---------|
| | | WIDTH | HEIGHT | WIDTH | HEIGHT | | | | | HEAD | JAMB | SILL | | | |
| Curtain Wall: CW-1 | CW1 | 8' - 0" | 7' - 0" | A | ALUM | * | | | | | | | | 8 | |
| Curtain Wall: CW-2 | CW2 | 8' - 0" | 1' - 0" | B | ALUM | * | | | | | | | | 3 | |

- 1" INSULATED LOW-E GLAZING

DOOR HARDWARE SETS:

GENERAL DOOR NOTES:

- INSTALL ADA APPROVED HARDWARE FOR ALL DOORS
- LOCATE DOORS HANDLES BETWEEN 35" & 48" ABOVE FLOOR LEVEL
- DOORS SHALL HAVE 6" MINIMUM CLEAR SPACE @ THE HINGE SIDE, WHILE THE REMAINDER SHALL BE AT THE PUSH/PULL SIDE, UNLESS OTHERWISE NOTED OR TECHNICALLY INFEASIBLE.
- ANY DOORS THAT OPEN PARALLEL TO A WALL SHALL HAVE A DOOR STOP.

HARDWARE SET 1 (EXTERIOR - DOUBLE DOOR)

- (2) 1/2 PAIR OF HINGES
- (2) PANIC EXIT DEVICE (INTERIOR)
- KEYED CYLINDER LOCKSET
- SURFACE-MOUNTED CLOSER
- SURFACE-MOUNTED STOP AND BUMP
- SILENCERS
- DOOR GASKETING
- ADA THRESHOLD
- (2) EXTERIOR PULL HANDLES
- (2) KICK PLATES

HARDWARE SET 2 (EXTERIOR)

- 1/2 PAIR OF HINGES
- PANIC EXIT DEVICE (INTERIOR)
- KEYED CYLINDER LOCKSET
- SURFACE-MOUNTED CLOSER
- SURFACE-MOUNTED STOP AND BUMP
- SILENCERS
- DOOR GASKETING
- ADA THRESHOLD
- EXTERIOR PULL HANDLES
- KICK PLATES

GENERAL CURTAIN WALL NOTES:

- CURTAIN WALL ASSEMBLY SHALL HAVE A WATER-TIGHT SEAL. THE EXTERIOR SHALL BE CAULKED WITH MANUFACTURER APPROVED CAULK. COLOR SHALL MATCH WINDOW.
- ALL GLAZING LOWER THAN 1'-6" SHALL BE TEMPERED.
- ALL CURTAIN WALL SHIMS SHALL BE LOW EXPANSION FOAM.

| | | | |
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| DRAWING NO. | DOOR AND WINDOW SCHEDULES AND DETAILS |

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A-7.1

PLUMBING - GENERAL NOTES

1. VERIFY ALL DIMENSIONS AND EXISTING CONDITIONS IN FIELD BEFORE ORDERING EQUIPMENT OR FABRICATING COMPONENTS.
2. UNLESS NOTED OTHERWISE, CONSTRUCTION MATERIAL AND EQUIPMENT REMOVED SHALL BECOME THE PROPERTY OF THE CONTRACTOR AND SHALL BE LEGALLY DISPOSED OF OFF THE SITE.
3. COORDINATE WORK WITH EXISTING STRUCTURAL AND ARCHITECTURAL FEATURES AND PROVIDE OFFSETS AND FITTINGS AS REQUIRED.
4. COORDINATE WORK WITH ALL OTHER TRADES. REFER TO ARCHITECTURAL PLANS FOR CEILING ELEVATIONS.
5. CONTRACTOR SHALL VERIFY LOCATION OF EXISTING UNDERGROUND UTILITIES AND PIPING BEFORE COMMENCING WORK AND AGREES TO BE FULLY RESPONSIBLE FOR ALL DAMAGES WHICH MIGHT OCCUR BY THE FAILURE TO EXACTLY LOCATE AND PRESERVE ANY UNDERGROUND UTILITIES.
6. INSTALL ALL WORK IN ACCORDANCE WITH ALL APPLICABLE CODES AND REGULATIONS.
7. CONTRACTOR IS REQUIRED TO NOTIFY FACILITY OWNERS NOT LESS THAN 3 AND NOT MORE THAN 10 WORKING DAYS PRIOR TO EXCAVATION OR DEMOLITION WORK WHEN USING POWERED EQUIPMENT.
8. COORDINATE LOCATION OF ALL PIPING AND FITTINGS BEFORE INSTALLATION WITH THE WORK OF OTHER TRADES, WHERE A CONFLICT IN AVAILABLE CLEARANCES OCCURS, OBTAIN CLARIFICATION FROM PRINCIPAL CONTRACTOR, AND PROVIDE WHATEVER ADDITIONAL PIPING, FITTINGS, ETC., ARE REQUIRED TO INSTALL PLUMBING SYSTEM WITHOUT ANY ADDITIONAL COST TO THE CONTRACT.
9. VERIFY MOUNTING HEIGHTS OF EQUIPMENT FIXTURES W/ARCHITECT DRAWING BEFORE ROUGH-IN.
10. BUILDING STORM WATER, DOMESTIC WATER, SANITARY, & GAS PIPING SHALL BE EXTENDED TO 5 FT OUTSIDE OF BUILDING.
11. THE PLUMBING CONTRACTOR SHALL MAKE COMPLETE WASTE, VENT, HOT & COLD WATER CONNECTIONS TO ALL OWNER FURNISHED EQUIPMENT.
12. INSTALL ALL EQUIPMENT AND MATERIALS IN STRICT ACCORDANCE WITH RESPECTIVE MANUFACTURER'S WRITTEN INSTRUCTIONS.
13. DIMENSIONS AND PIPE SIZES ARE IN INCHES UNLESS NOTED OTHERWISE.
14. RUN PIPING CONCEALED EXCEPT IN MECHANICAL ROOMS OR WHERE NOTED OTHERWISE.
15. ALL EXPOSED PIPING SHALL BE CLEANED AND HAVE THE SURFACE PREPARED TO RECEIVE PAINTED FINISH, PRIME AND PAINT THE EXPOSED PIPING IN COLOR AS SELECTED BY THE ARCHITECT.
16. RUN 2" MINIMUM SIZE WASTE PIPING BELOW GROUND INSIDE BUILDING REGARDLESS OF SIZE NOTED ON FIXTURE SCHEDULE. SLOPE ALL SOIL, WASTE AND STORM WATER LINES PER CODE.
17. CONNECT WATER, WASTE, AND VENT PIPING TO FIXTURES IN ACCORDANCE WITH SIZES INDICATED ON FIXTURE SCHEDULE.
18. CONTRACTOR SHALL PROVIDE PIPE SLEEVES IN ALL FOUNDATION WALLS FOR PIPING PENETRATIONS.
19. MAKE ALL FINAL CONNECTIONS TO THE EQUIPMENT AS SHOWN ON THE DRAWINGS. PROVIDE SHUT-OFF VALVES IN ALL INDIVIDUAL WATER CONNECTIONS, IF APPLICABLE, PROVIDE SHUT-OFF VALVES IN ALL INDIVIDUAL GAS CONNECTIONS.
20. RUN ALL PIPING ABOVE CEILING UNDER BUILDING INSULATION OR CONCEALED IN WALLS, UNLESS NOTED OTHERWISE. ALL WASTE LINES AS SHOWN SHALL BE BELOW FLOOR, UNLESS NOTED OTHERWISE.
21. FURNISH AND INSTALL ACCESS PANELS (FIRE-RATED) WHERE REQUIRED, WHERE SHOWN, OR REQUIRED FOR ACCESS TO ALL CONCEALED VALVES, TRAPS OR OTHER EQUIPMENT FURNISHED UNDER THIS CONTRACT WHERE NO OTHER MEANS IS PROVIDED.
- A. COORDINATE ACCESS PANELS AND DOORS WITH ARCHITECT FEATURES.
22. INSTALL UNIONS ON PIPING TO PERMIT EASY DISCONNECTING.
23. CONCEAL ALL PIPING, VALVES AND FITTINGS ABOVE CEILINGS AND IN CHASES WHERE THEY OCCUR, UNLESS NOTED OTHERWISE.
24. THE CONTRACTOR SHALL RIGIDLY SUPPORT ALL EQUIPMENT.
25. ALL SANITARY AND STORM SEWER PIPING SHALL BE RUN AT 1/8" PER FOOT SLOPE UNLESS OTHERWISE NOTED, ALL SANITARY SEWER PIPING 2" AND SMALLER SHALL BE RUN AT 1/4" PER FOOT SLOPE. ALL SANITARY SEWER PIPING 3" AND LARGER SHALL BE RUN AT 1/8" PER FOOT SLOPE.
26. PROVIDE AND INSTALL ANGLE SHUTOFF VALVES AT EACH FIXTURE. WATER VALVES FOR WALL MOUNTED FIXTURES SHALL BE CHROME PLATED, THREADED, HEAVY DUTY TYPE AND HAVE LOOSE KEY STOPS. VALVES FOR COUNTERTOP FIXTURES SHALL BE 1/4 TURN BALL VALVES. PROVIDE SHUT-OFF VALVE IN ALL HOT WATER SUPPLY BRANCHES AND COMBINATION SHUT-OFF AND BALANCE VALVE IN ALL HOT WATER RETURN BRANCHES, LOCATE IN ACCESSIBLE CEILING SPACE OR IF INSIDE EQUIPMENT ENCLOSURES, PROVIDE ACCESS DOOR.
27. HOT & COLD-WATER PIPING SHALL BE COPPER/PEX.
28. SEAL ALL FLOOR AND WALL PENETRATION IN FIRE RATED CEILING & PARTITIONS TO MAINTAIN FIRE RATING.
29. PROVIDE PIPE COVERING INSULATION, 1" THICK FOR HOT WATER PIPING, AND 1/2" THICK FOR COLD WATER PIPING.

PLUMBING SPECIFICATIONS

1. GENERAL NOTES

1.1 BUILDING CODES & STANDARDS

- A. CONFORM TO ALL APPLICABLE CODES (LOCAL, STATE, NATIONAL CODES, NFPA, OSHA, ETC.), GOVERNMENT REGULATIONS, UTILITY COMPANY REQUIREMENTS, AND APPLICABLE STANDARDS.
- B. ARRANGE FOR ALL REQUIRED INSPECTIONS AND APPROVALS.

1.2 GENERAL REQUIREMENTS

- A. CONFORM TO ALL GENERAL AND SPECIAL CONDITIONS OF CONTRACT AS SPECIFIED BY SITE ENGINEER'S AND/OR OWNER.
- B. VISIT SITE, CHECK FACILITIES AND CONDITIONS AND MAKE ALL NECESSARY OBSERVATIONS AND MEASUREMENTS. NOTE CONDITIONS UNDER WHICH WORK IS TO BE PERFORMED AND TAKE ALL ITEMS INTO CONSIDERATION IN SCOPE OF WORK.
- C. SYSTEMS ARE TO BE COMPLETE AND WORKABLE IN ALL RESPECTS, PLACED IN OPERATION AND PROPERLY ADJUSTED.
- D. CONTRACTOR SHALL PROVIDE THEIR OWN CLEAN-UP, REMOVAL AND LEGAL DISPOSAL OF ALL RUBBISH DAILY.
- E. CONTRACTOR SHALL PROTECT THEIR WORK, EXISTING AND ADJACENT PROPERTY AGAINST WEATHER.
- F. CONTRACTOR SHALL PROTECT THEIR WORK, MATERIALS, APPARATUS AND FIXTURES FROM DAMAGE, ANY WORK DAMAGED BY FAILURE TO PROVIDE PROTECTION REQUIRED SHALL BE REMOVED AND REPLACED WITH NEW MATERIAL AT THE CONTRACTOR'S EXPENSE.
- G. ARRANGE FOR AND OBTAIN OWNER'S REPRESENTATIVE'S PERMISSION FOR ANY SERVICE SHUT-DOWNS.
- H. THE CONTRACTOR SHALL BE SOLELY RESPONSIBLE FOR CONSTRUCTION MEANS, METHODS, SEQUENCES OF CONSTRUCTION AND THE SAFETY OF WORKMEN.
- I. NO PIPING, DUCTWORK, WIRING, ETC. SHALL BE INSTALLED OR ROUTED ABOVE ELECTRICAL PANELS AND EQUIPMENT.

1.3 DRAWINGS

- A. THE SYSTEM AS SHOWN ON PLUMBING DRAWINGS ARE DIAGRAMMATIC. CONFIRM ALL DIMENSIONS BY FIELD MEASUREMENT.
- B. THE EXACT LOCATIONS FOR FIXTURES, EQUIPMENT AND PIPING WHICH IS NOT COVERED BY DRAWINGS, SHALL BE OBTAINED FROM THE SITE ENGINEERS OR THEIR REPRESENTATIVE IN THE FIELD AND THE WORK SHALL BE LAID OUT ACCORDINGLY.

1.4 BASE EQUIPMENT, MATERIALS AND SUBSTITUTIONS

- A. ALL EQUIPMENT AND MATERIALS SHALL BE NEW, FREE OF DEFECTS.
- B. BASE BID MANUFACTURERS ARE INCLUDED IN THE SPECIFICATIONS OR LISTED IN THE NAME OR MAKE OF ANY ARTICLE, DEVICE, MATERIAL, FORM OF CONSTRUCTION, FIXTURE, ETC. ARE INCLUDED AS A BASIS OF DESIGN, WHETHER OR NOT THE WORDS "OR APPROVED EQUAL" ARE USED, SHALL BE KNOWN AS A "STANDARD".
- C. ALL PROPOSALS SHALL BE BASED ON "STANDARDS" SPECIFIED.
- D. THE EQUIPMENT SCHEDULES ON THE DRAWINGS INDICATE MANUFACTURERS EQUIPMENT MODEL NUMBERS THAT THIS DESIGN HAS BEEN BASED ON. THE USE OF OTHER MANUFACTURERS EQUIPMENT THAT IS LISTED AS ACCEPTABLE ALTERNATES AND REFLECTS ANY ADDITIONAL COST OF SUCH CHANGES SHALL BE PAID BY THE CONTRACTOR.
- E. SUBSTITUTIONS ARE SUBJECT TO THE APPROVAL OF THE OWNER. IF A SUBSTITUTION IS SUBMITTED, IT IS THE CONTRACTOR'S RESPONSIBILITY TO EVALUATE IT AND CERTIFY THAT THE SUBSTITUTION IS EQUIVALENT IN ALL RESPECTS TO THE BASE SPECIFICATIONS.
- F. COORDINATE ALL APPROVED SUBSTITUTIONS, ANY COSTS RESULTING FROM SUBSTITUTION SHALL BE THE RESPONSIBILITY OF THE CONTRACTOR. APPROVED SHOP DRAWINGS DO NOT ABSOLVE THIS CONTRACTOR FROM THIS RESPONSIBILITY.

1.5 WARRANTY

- A. FULLY WARRANT ALL MATERIALS, EQUIPMENT AND WORKMANSHIP FOR (1) YEAR FROM DATE OF ACCEPTANCE.
- B. EXTEND ALL MANUFACTURERS' WARRANTIES TO OWNER.
- C. REPAIR OR REPLACE WITHOUT CHARGE TO THE OWNER ALL ITEMS FOUND DEFECTIVE DURING THE WARRANTY PERIOD. IN THE CASE OF REPLACEMENT OR REPAIR DUE TO FAILURE WITHIN THE WARRANTY PERIOD, THE WARRANTY ON THAT PORTION OF THE WORK SHALL BE EXTENDED FOR A MINIMUM PERIOD OF ONE (1) YEAR FROM THE DATE OF SUCH REPLACEMENT OR REPAIR.

2. BASIC MATERIALS AND METHODS

2.1 GENERAL

- A. THIS SECTION INCLUDES BASIC PLUMBING MATERIALS AND METHODS TO COMPLEMENT OTHER SECTIONS IN THIS SPECIFICATION AND REQUIREMENTS INDICATED ON THE MECHANICAL DRAWINGS.

2.2 SUPPORTS & HANGERS

- A. INSTALL HANGERS, SUPPORTS, CLAMPS AND ATTACHMENTS AS REQUIRED TO PROPERLY SUPPORT PIPING FROM BUILDING STRUCTURE. THE INSTALLATION SHALL COMPLY WITH THE REQUIREMENTS OF MSS SP-69 AND SP-89.

2.3 ESCUTCHEONS

- A. FIT ALL PIPE PASSING THROUGH WALLS, FLOORS OR CEILINGS IN FINISHED ROOMS WITH STEEL OR BRASS ESCUTCHEONS, WHERE SURFACE IS TO RECEIVE A PAINT FINISH, MAKE ESCUTCHEONS NICKEL OR CHROME PLATED. WHERE PIPING IS INSULATED, FIT ESCUTCHEONS OUTSIDE INSULATION.

2.4 IDENTIFYING DEVICES & LABELS

- A. PROVIDE METAL EQUIPMENT NAMEPLATES PERMANENTLY FASTENED TO EQUIPMENT WITH OPERATIONAL DATA ENGRAVED OR STAMPED.
- B. IDENTIFY ALL PIPES AND VALVES AT UNEXPOSED AREAS, AND ACCESSIBLE CEILINGS AND SHAFTS.
- C. COLOR CODE IDENTIFICATION BANDS OR MARKER BACKGROUNDS TO IDENTIFY CONTENTS OF PIPE AND DIRECTION OF FLOW LOCATED NEAR EACH VALVE AND FITTING, ON BOTH SIDES OF PIPE PASSING THROUGH WALLS AND ON LONG RUNS AT NOT OVER 20 FOOT INTERVALS.

2.5 FLUES

- A. FLUES SHALL BE TYPE B DOUBLE WALL TYPE. INNER PIPE SHALL BE FABRICATED OF TYPE 430M STAINLESS STEEL AND THE OUTER PIPE OF ALUMINIZED STEEL. PROVIDE VENTILATED ROOF THIMBLE, EXIT CONE AND STACK CAP.

2.6 CUTTING, PATCHING & DRILLING

- A. PATCH AND FINISH TO MATCH ADJACENT AREAS THAT HAVE BEEN CUT, DAMAGED OR MODIFIED AS A RESULT OF THE INSTALLATION OF THE MECHANICAL SYSTEMS.
- B. EXACT LOCATION OF ROOF TOP MECHANICAL UNITS SHALL BE APPROVED BY THE STRUCTURAL ENGINEER. CONTRACTOR SHALL FURNISH AND INSTALL ALL SUPPLEMENTAL SUPPORT STEEL FOR EQUIPMENT AND ROOF PENETRATIONS AFTER APPROVAL OF STRUCTURAL ENGINEER.

3. INSULATION

- A. PLUMBING INSULATION (AS MANUFACTURED BY OWENS CORNING, KNAUF, SCHULLER OR CERTAINTEED)
1. INSULATE ALL ABOVE GRADE HOT AND COLD WATER PIPING WITH MOLDED FIBER GLASS HAVING AN ALL SERVICE JACKET.
- B. INSULATION THICKNESS SCHEDULE: 1) LESS THAN 2" DIAMETER PIPE: 1" THICK-HW AND 1/2" THICK-CW, 2) 2"-3" DIAMETER PIPE: 1-1/2" THICK.
1. INSULATE ALL ABOVE-GRADE, HORIZONTAL RAIN CONDUCTORS AND ROOF DRAIN SUMPS WITH ONE (1) INCH THICK MOLDED FIBER GLASS HAVING TYPE ASJ JACKET AND MANUFACTURED BY OWENS-CORNING FIBERGLASS COMPANY.
2. INCLUDE INSULATION OF FITTINGS AND VALVES. KEEP VAPOR BARRIERS INTACT. APPLY TO MANUFACTURER'S RECOMMENDATIONS.

4. PIPING AND VALVES

4.1 GENERAL

- A. LABEL ALL PIPING AND SHOW DIRECTION OF FLOW EVERY 20 FEET ON CENTER.

4.2 CONNECTIONS TO EQUIPMENT

- A. PROVIDE VALVES AT ALL WATER AND/OR GAS CONNECTION FOR EQUIPMENT.
- B. INCLUDE ACCESSORIES REQUIRED BY CODE, DRAWING OR MANUFACTURERS INSTRUCTIONS.

4.3 SANITARY AND STORM SEWERS

- A. SANITARY AND STORM SEWERS
 - I. ROOF DRAINS SHALL BE PROVIDED WITH A FLASHING RING AND A 30x30x4 LB. LEAD FLASHING PROPERLY FASTENED TO THE FLASHING RING.
 2. PVC PIPING SHALL NOT BE INSTALLED UNLESS PERMITTED BY CODE.
- B. ABOVE-GRADE SANITARY/STORM SEWER AND VENT MATERIAL SHALL BE AS FOLLOWS:
 1. NO-HUB CAST IRON PIPE CISPI 1-30-178.
 2. PVC-DWV PLASTIC ASTM D1785 WITH ASTM D2665 DWV SOLVENT WELD SOCKET FITTINGS.
- C. SITE STORM AND SANITARY SEWERS
 1. UP TO 15" - PVC PLASTIC ASTM D3034 SDR 35 WITH ASTM D3212 GASKET JOINTS.

4.4 DOMESTIC WATER PIPING

- A. INSTALL DOMESTIC WATER PIPING AS INDICATED ON DRAWINGS. INCLUDE ALL FITTINGS, VALVES, HANGERS AND OTHER ACCESSORIES INCLUDING WATER METER AND BACKFLOW PREVENTER. EXTEND DOMESTIC WATER PIPING TO ALL FIXTURES AND EQUIPMENT REQUIRED FOR COMPLETE INSTALLATION.
- B. INCLUDE UNIONS, OR OTHER DISCONNECT MEANS, STOPS OR VALVES FOR ISOLATION OF FIXTURES AND EQUIPMENT. VALVES TO BE FULLY COMPATIBLE WITH PIPING FOR SERVICE INTENDED AS MANUFACTURED BY NIBCO, CRANE OR MILWAUKEE. INCLUDE HOSE OR DRAIN VALVES AT LOW POINTS WHERE FIXTURES CANNOT BE USED FOR DRAINAGE.
- C. PROVIDE WATER HAMMER ARRESTERS OF TYPE REQUIRED FOR FIXTURES AND WATER PRESSURES. THESE SHALL BE ASSE 1010 OR PDI-WH1201, PISTON TYPE WITH PRESSURIZED METAL-TUBE CUSHIONING CHAMBER AS MANUFACTURED BY SIOUX CHIEF, AMTROL, JOSAM OR ZURN HANGERS ON INSULATED PIPE TO BE OUTSIDE OF INSULATION, SIZED ACCORDINGLY AND WITH A SUFFICIENT SADDLE TO PROTECT INSULATION.
- D. DOMESTIC WATER PIPING SHALL BE AS FOLLOWS:

1. ABOVE GRADE:
 - a. 1-1/2" NPS AND LARGER- TYPE "L" HARD COPPER ASTM B88-832 WITH WROUGHT COPPER FITTINGS ASTM B16.22 1960 AND NON-LEAD OR ANTIMONY SOLDER JOINTS.
 - b. 1-1/4" NPS AND SMALLER - PEX TUBING PER ASTM F877 STANDARD GRADE HYDROSTATIC PRESSURE RATINGS 200# AT 80 PSI.
2. BELOW GRADE - PEX PIPING WITHOUT JOINTS. PROVIDE CPVC CONDUIT.
3. FLUSH, VENT AND SANITIZE ALL WATER PIPING WITH CHLORINE AS REQUIRED PER AWWA, LOCAL BUILDING DEPARTMENT AND HEALTH DEPARTMENT CODES.
4. DOMESTIC HOT AND COLD WATER PIPING UNDER CONCRETE FLOOR TO BE COVERED WITH 6" OF SAND SO THAT PIPING WILL NOT BE EMBEDDED IN THE FLOOR SLAB.
- E. ALL PIPING UNDER CONCRETE FLOOR SHALL BE PEX, CONTINUOUS, NO SPLICES OR FITTINGS WILL BE ALLOWED. PROVIDE CPVC CONDUITS FOR ALL UNDERSLAB PIPING.

4.5 CONDENSATE DRAIN PIPING

- A. INSTALL SCH 40 PVC CONDENSATE PIPING AT A MINIMUM 1% DOWNWARD SLOPE IN THE DIRECTION OF FLOW UNLESS OTHERWISE INDICATED.

4.6 STRAINERS

- A. INSTALL SCH 40 PVC CONDENSATE PIPING AT A MINIMUM 1% DOWNWARD SLOPE IN THE DIRECTION OF FLOW UNLESS OTHERWISE INDICATED.

4.7 PRESSURE REGULATORS

- A. WATER PRESSURE REDUCING VALVE SHALL HAVE AN INITIAL WORKING PRESSURE OF 150 PSI WITH AN ADJ OUT PRESSURE SETTING. VALVES 2" AND SMALLER SHALL BE OF BRONZE BODY WITH THREADED CONNECTIONS.

4.8 BACKFLOW PREVENTER

- A. DOUBLE CHECK BACKFLOW PREVENTION ASSEMBLY SHALL CONSIST OF TWO POSITIVE SEATING CHECK MODULES WITH CAPTURED SPRINGS AND RUBBER SEAT DISCS THAT ARE REPLACEABLE. IT SHALL HAVE A LOW PRESSURE DROP. BACKFLOW PREVENTER SHALL REQUIRE NO SPECIAL TOOLS FOR SERVICING. IT SHALL BE A CAST BRONZE BODY CONSTRUCTION FROM 1/2"-2" AND FUSED EPOXY COATED CAST IRON BODY FOR 2-1/2" - 3".

4.9 PIPE SUPPORTS

- A. PIPE SUPPORTS FOR HOT WATER PIPE SHALL BE ANVIL FIG. 181 OR EQUAL.
- B. PIPE SUPPORTS FOR NATURAL GAS SHALL BE ANVIL FIG. 260 OR EQUAL.

5. PLUMBING SYSTEMS AND EQUIPMENT

5.1 GENERAL

- A. CONTRACTORS SHALL VISIT THE SITE AND FAMILIARIZE THEMSELVES WITH ALL CONDITIONS AFFECTING THEIR WORK.
- B. VERIFY EXACT CONDITIONS IN FIELD AND COORDINATE WITH THESE DRAWINGS AND OTHER TRADES BEFORE BEGINNING NEW WORK.
- C. DETERMINE EXACT LOCATIONS FOR ALL EQUIPMENT, PIPING, CONDUITS AND DUCTWORK IN FIELD.
- D. COORDINATE WORK OF THIS CONTRACT WITH OTHER TRADES. CONFLICTS SHALL IMMEDIATELY BE BROUGHT TO THE ATTENTION OF THE ENGINEER.
- E. ANY DISCREPANCIES BETWEEN WHAT IS SHOWN ON DRAWINGS OR SPECIFIED AND THE ACTUAL CONDITIONS IN THE FIELD SHALL IMMEDIATELY BE BROUGHT TO THE ATTENTION OF THE ENGINEERS BEFORE PROCEEDING.
- F. BUILDING AND SURFACES DAMAGED DURING INSTALLATION SHALL BE REPAIRED, REPLACED, AND/OR RESTORED TO ORIGINAL CONDITION AFTER COMPLETION OF WORK AND BEFORE ACCEPTANCE BY OWNER.

6. PLUMBING INSTRUMENTS AND CONTROLS

6.1 GENERAL

- A. AFTER INSTALLATION, CHECK ALL EQUIPMENT AND PERFORM START UP IN ACCORDANCE WITH THE MANUFACTURERS INSTRUCTIONS.
- B. ALL PIPING SHALL BE TESTED AND FREE OF LEAKS AS REQUIRED BY THE LOCAL AUTHORITY HAVING JURISDICTION.
- C. WORK THAT IS SCHEDULED TO BE CONCEALED OR INSULATED SHALL REMAIN UNCOVERED UNTIL REQUIRED TESTS HAVE BEEN COMPLETED. IF THE CONSTRUCTION SCHEDULE REQUIRES, ARRANGE FOR TESTS ON SECTIONS AT A TIME.
- D. BALANCE ALL SYSTEMS, CALIBRATE CONTROLS, CHECK FOR PROPER OPERATION AND SEQUENCE UNDER ALL CONDITIONS AND MAKE ALL NECESSARY ADJUSTMENTS.
- E. INSTRUCT OWNER IN OPERATION OF SYSTEMS AND SUBMIT OPERATING AND MAINTENANCE MANUAL FOR ALL EQUIPMENT AND SYSTEMS.

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PROJECT
ELMIRA CIVIL WAR PRISON CAMP VISITOR CENTER
637-639 WINSTON AVE
ELMIRA, NY 14901

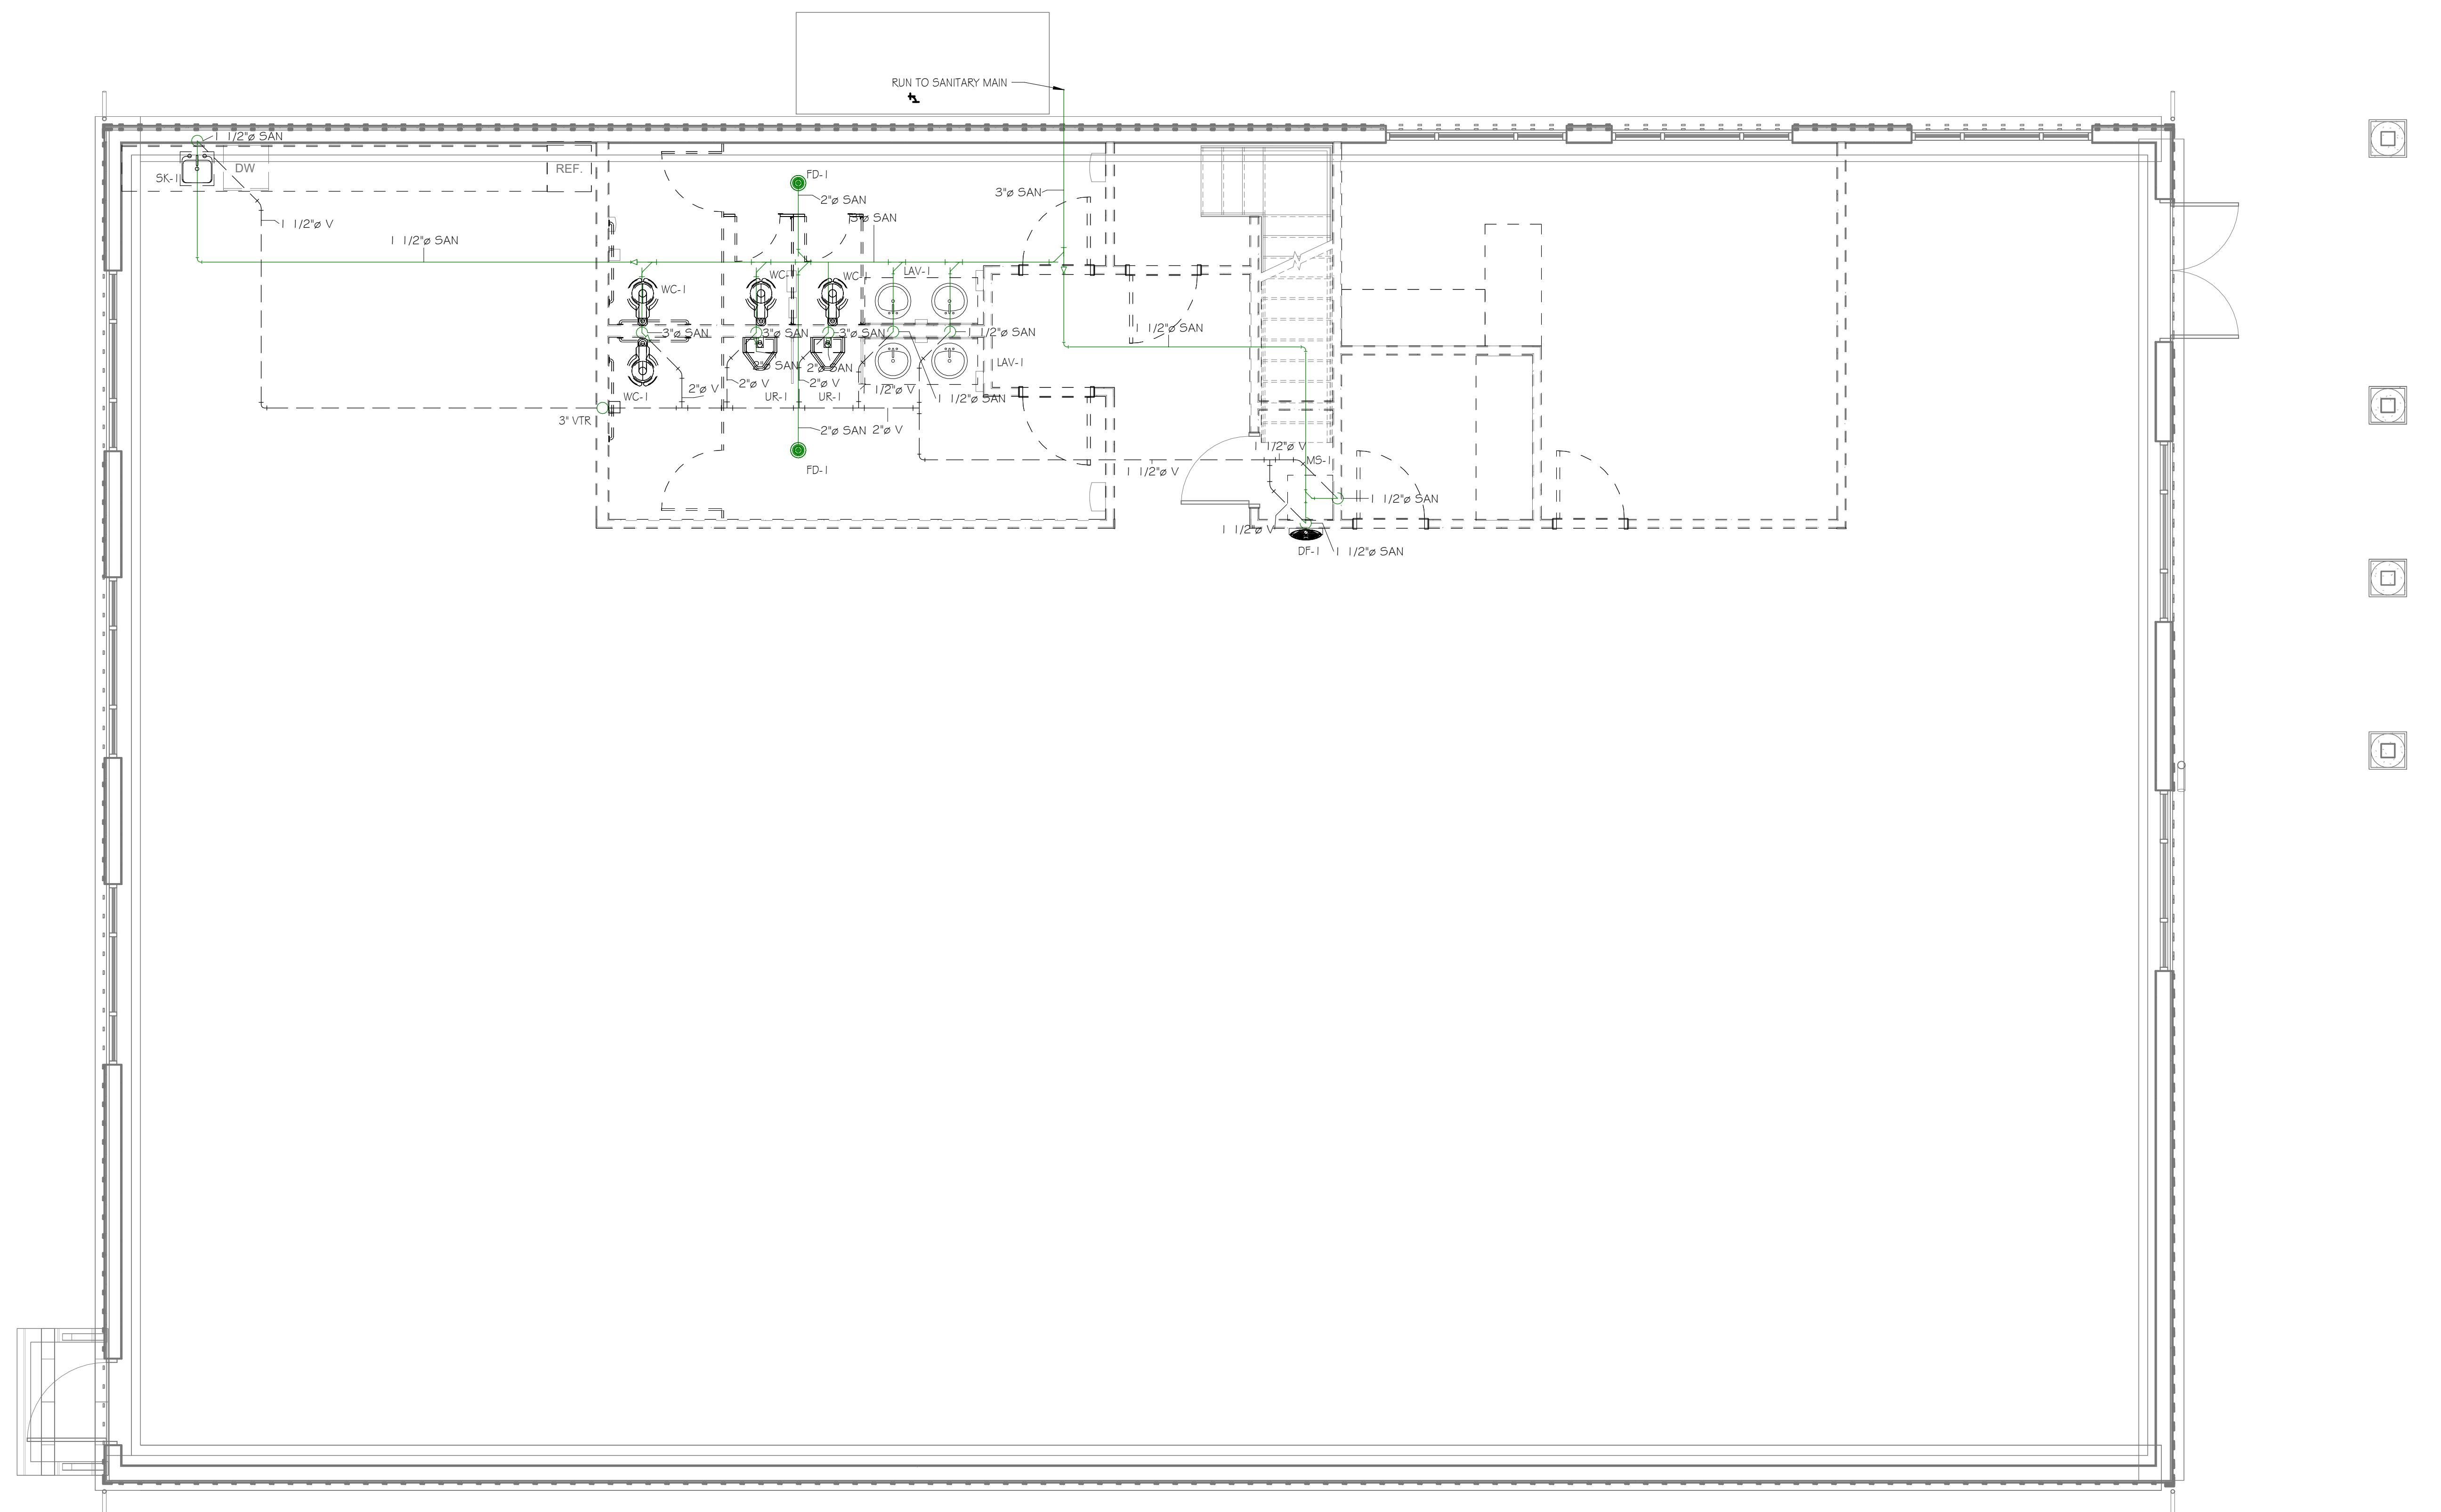
DRAWING SCALE
AS NOTED
ISSUE DATE:
01.05.26
PROJECT NO.
25-086
DRAWING NO.

TITLE OF DRAWING
SPECIFICATIONS, SCHEDULE & NOTES

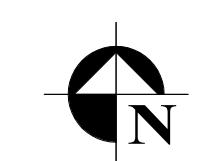
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PLUMBING GENERAL NOTES

1. PLUMBING FIXTURES SHALL BE ALTERNATE #1
 2. DOMESTIC SUPPLY PIPING SHALL BE BASE BID AND BE CAPPED IN PLACE
 FOR PLUMBING FIXTURE FUTURE INSTALLATION



FIRST FLOOR PLUMBING PLAN - SANITARY & VENT
 1/4" = 1'-0"



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P-2.1

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 DRAWING SCALE: AS NOTED
 ISSUE DATE: 01.05.26
 DRAWING NO. 25-086
 TITLE OF DRAWING: FIRST FLOOR PLUMBING PLAN - SANITARY & VENT PIPING

DRAWING SCALE: AS NOTED
 ISSUE DATE: 01.05.26
 PROJECT NO. 25-086
 DRAWING NO. P-2.1

AJH DESIGN
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ELMIRA CIVIL WAR PRISON CAMP

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637-639 WINSOR AVE
ELMIRA, NY 14901
TITLE OF DRAWING
PLUMBING DETAILS

DRAWING SCALE
AS NOTED
ISSUE DATE:
01.05.26

PROJECT NO.
25-086

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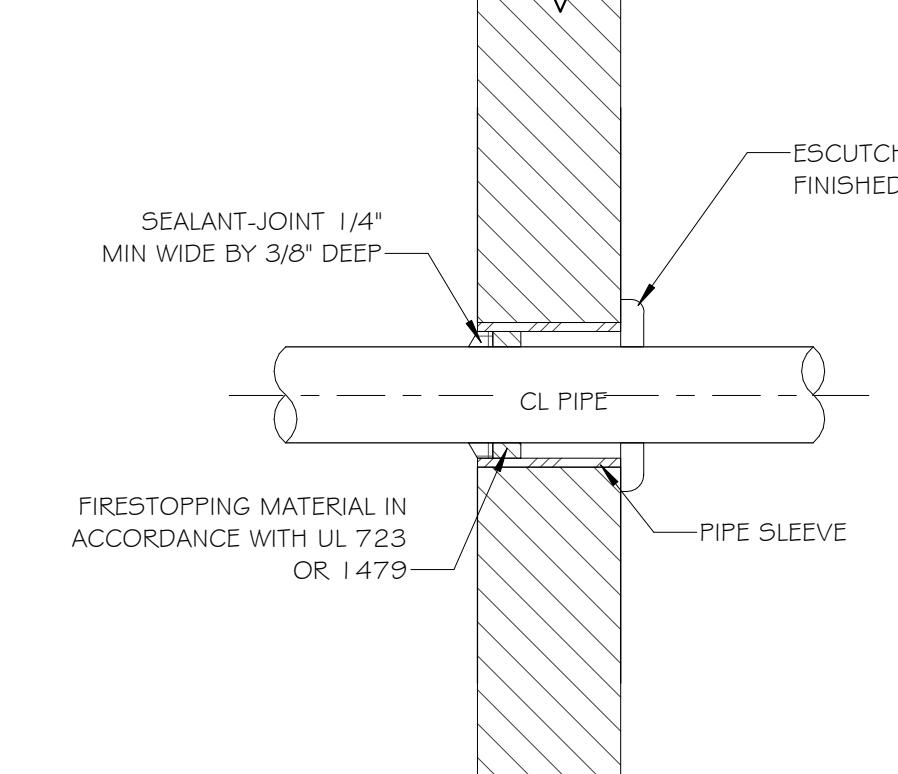
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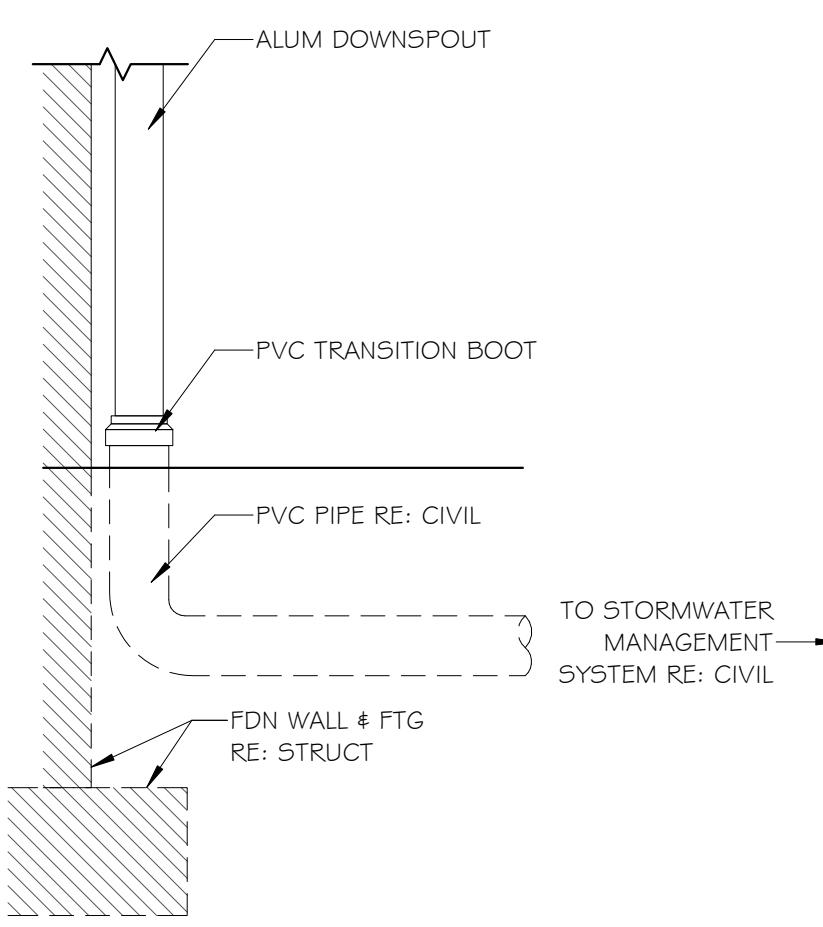
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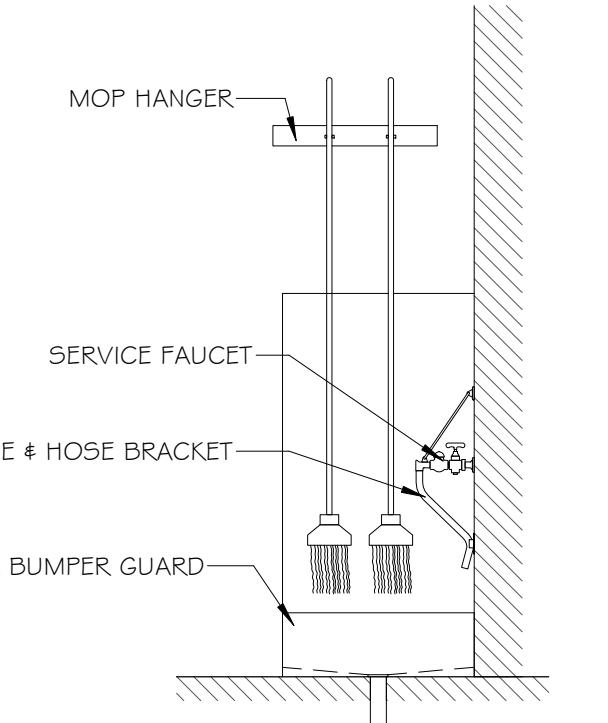
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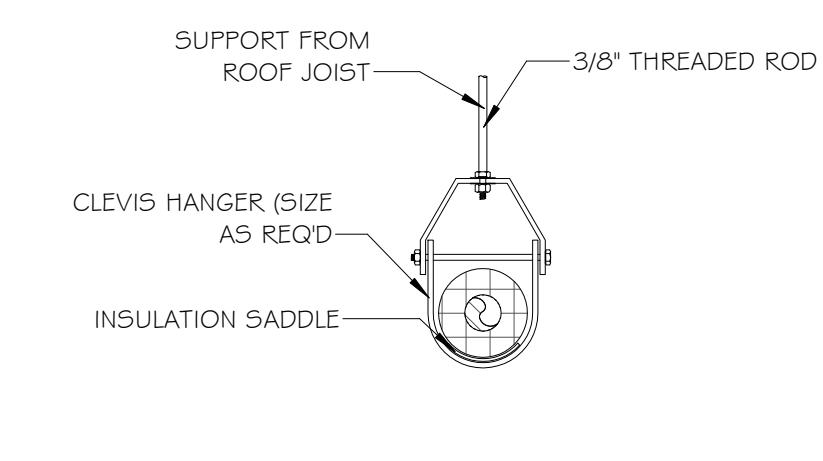
9 N.T.S. TYP. PIP PENETRATION THRU WALL DETAIL



6 N.T.S. TYP. DOWNSPOUT DETAIL

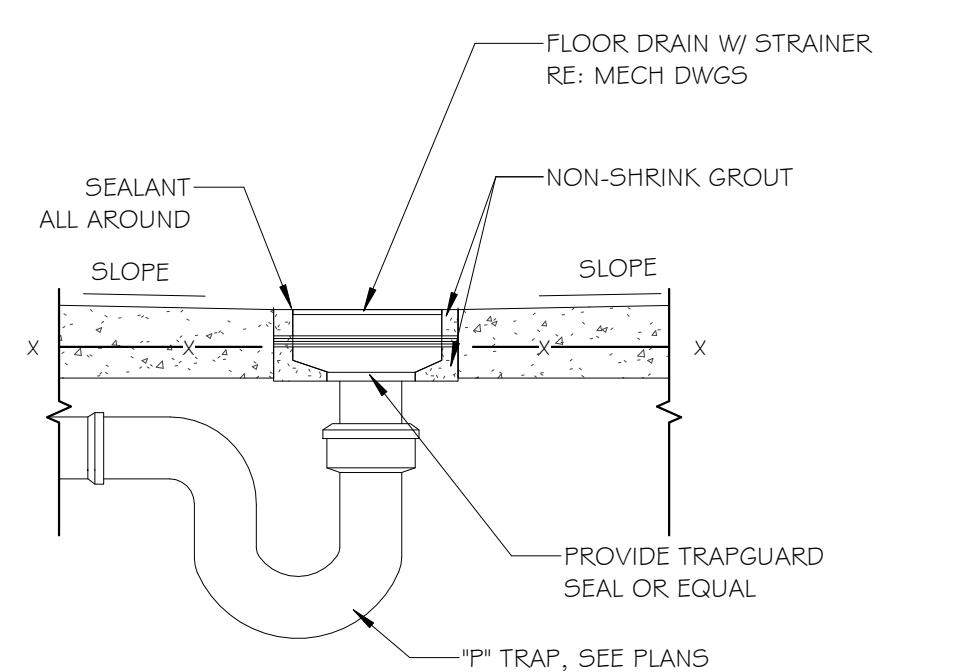


4 N.T.S. MOP SINK ELEVATION DETAIL

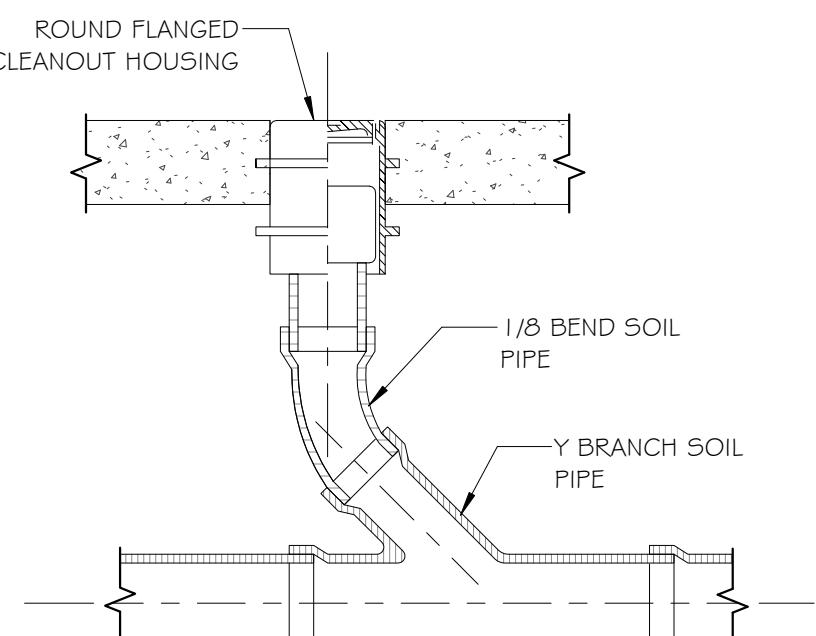


SINGLE PIPE RUN MULTIPLE PIPE RUNS

3 N.T.S. PIPE SUPPORT DETAILS



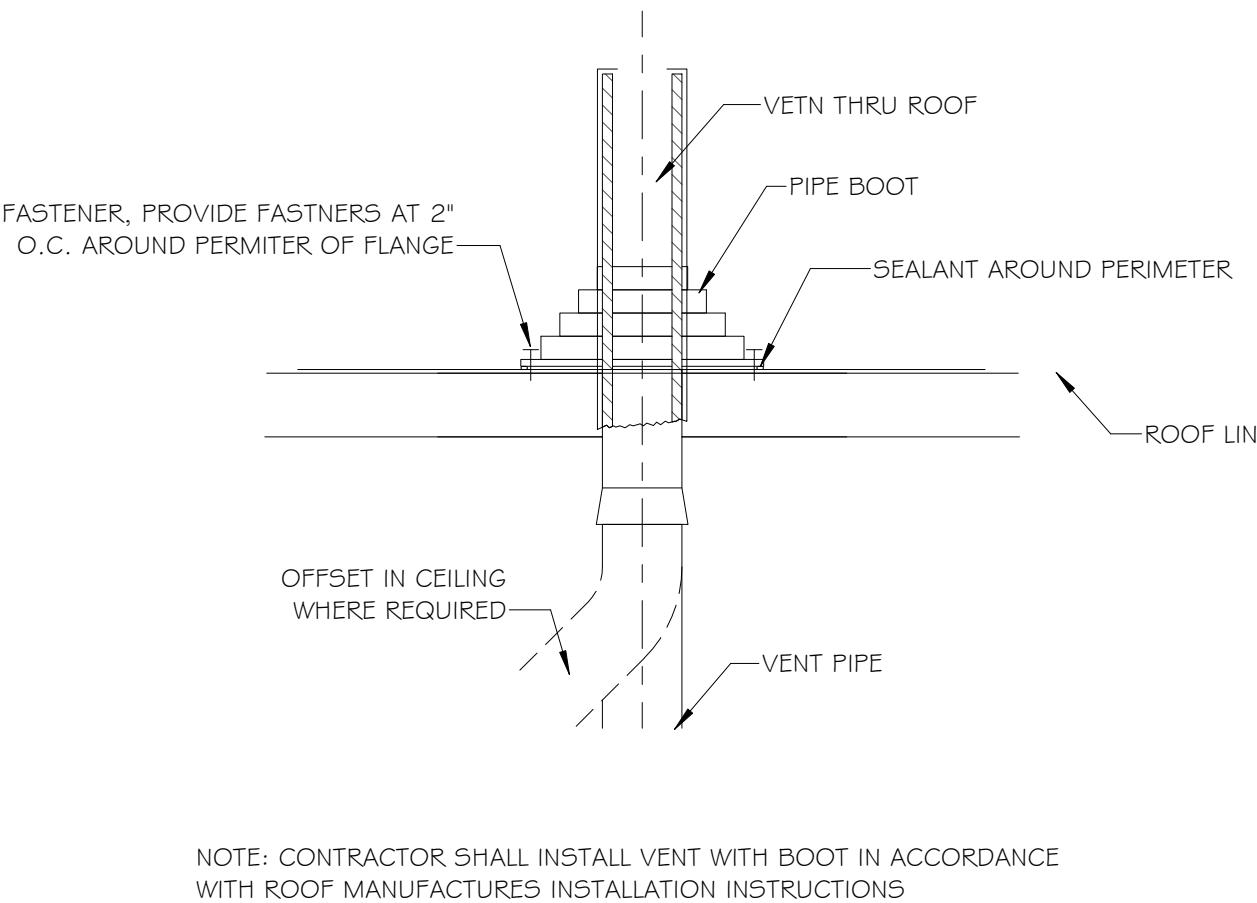
2 N.T.S. TYP. FLOOR DRAIN DETAIL



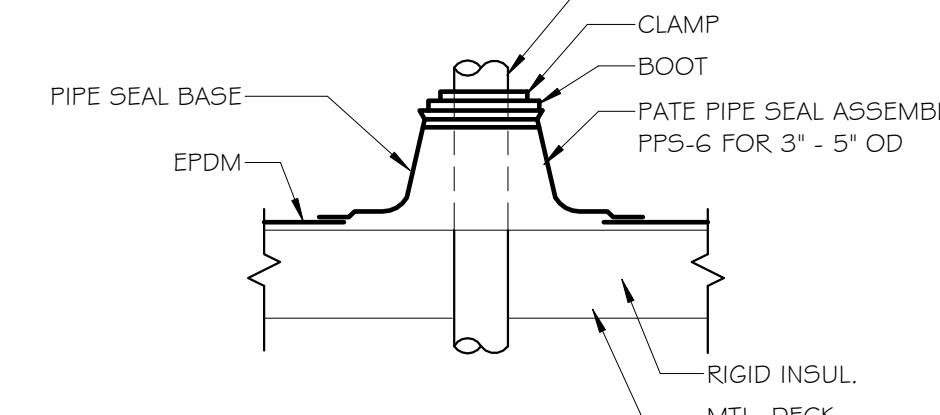
1 N.T.S. TYP. FLOOR CLEANOUT DETAIL

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7 N.T.S. ROOF VENT PENETRATION DETAIL



5 N.T.S. TYP. PIPE PENETRATION THRU ROOF DETAIL

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|---|--|---|--|
|  <p>FIRST FLOOR ELECTRICAL POWER PLAN</p> <p>1/4" = 1'-0"</p> | | <p>PRELIMINARY NOT FOR CONSTRUCTION</p> <p>NOT APPROVED THIS PLAN HAS NOT RECEIVED FINAL APPROVAL BY THE STATE. THE PLAN IS SUBJECT TO REVISIONS UNTIL ALL APPROVALS ARE OBTAINED AND SHOULD NOT BE USED FOR CONSTRUCTION PURPOSES.</p> <p>E-1.1</p> | |
|  <p>PROVIDE ELECTRICAL PANEL COMPLETE</p> | | <p>PROJECT ELMIRA CIVIL WAR VISITOR CENTER 637-639 WINSOR AVE ELMIRA, NY 14901</p> <p>DRAWING SCALE AS NOTED</p> <p>ISSUE DATE: 01-05-26</p> <p>PROJECT NO. 25-086</p> <p>DRAWING NO.</p> | |
| <p>AJH DESIGN</p> <p>111 E. 14TH STREET • ELMIRA HEIGHTS, NEW YORK 14903 PH. (607) 737-4638 WEB: AJH-DESIGN.COM</p> <p>OWNER/CLIENT</p> | | <p>COPYRIGHT © 2025 AJH DESIGN IT IS A VIOLATION OF LAW FOR ANY DRAWING ALTERATION TO BE MADE TO THIS DRAWING BY ANYONE OTHER THAN THE LICENSED ARCHITECT OR ENGINEER WHO IS UNDERTAKING THE ALTERATION. ALTERATION OF THIS DRAWING IS PROHIBITED. ANY LICENSEE WHO ALTERS THIS DRAWING MUST NOTIFY THE OWNER/CLIENT OF THE ALTERATION BY FOLLOWING NOTIFICATION PROCEDURE. NOTIFICATION PROCEDURE IS DESCRIBED ON THE DRAWING.</p> | |
| <p>FRIENDS OF ELMIRA CIVIL WAR PRISON CAMP</p> | | <p>ISSUED / REVISIONS 0</p> <p>ISSUED FOR BID</p> <p>DATE 01-05-26</p> | |