# WASTEWATER TREATMENT FACILITIES CONSENT ORDER IMPROVEMENTS

115 ELLISON ROAD ELKLAND, PENNSYLVANIA 16920



LOCATION MAP N.T.S.


# ELKLAND BOROUGH AUTHORITY

105 PARKHURST STREET ELKLAND, PENNSYLVANIA 16920

LABELLA PROJECT NO. 2242861 NOVEMBER 2025





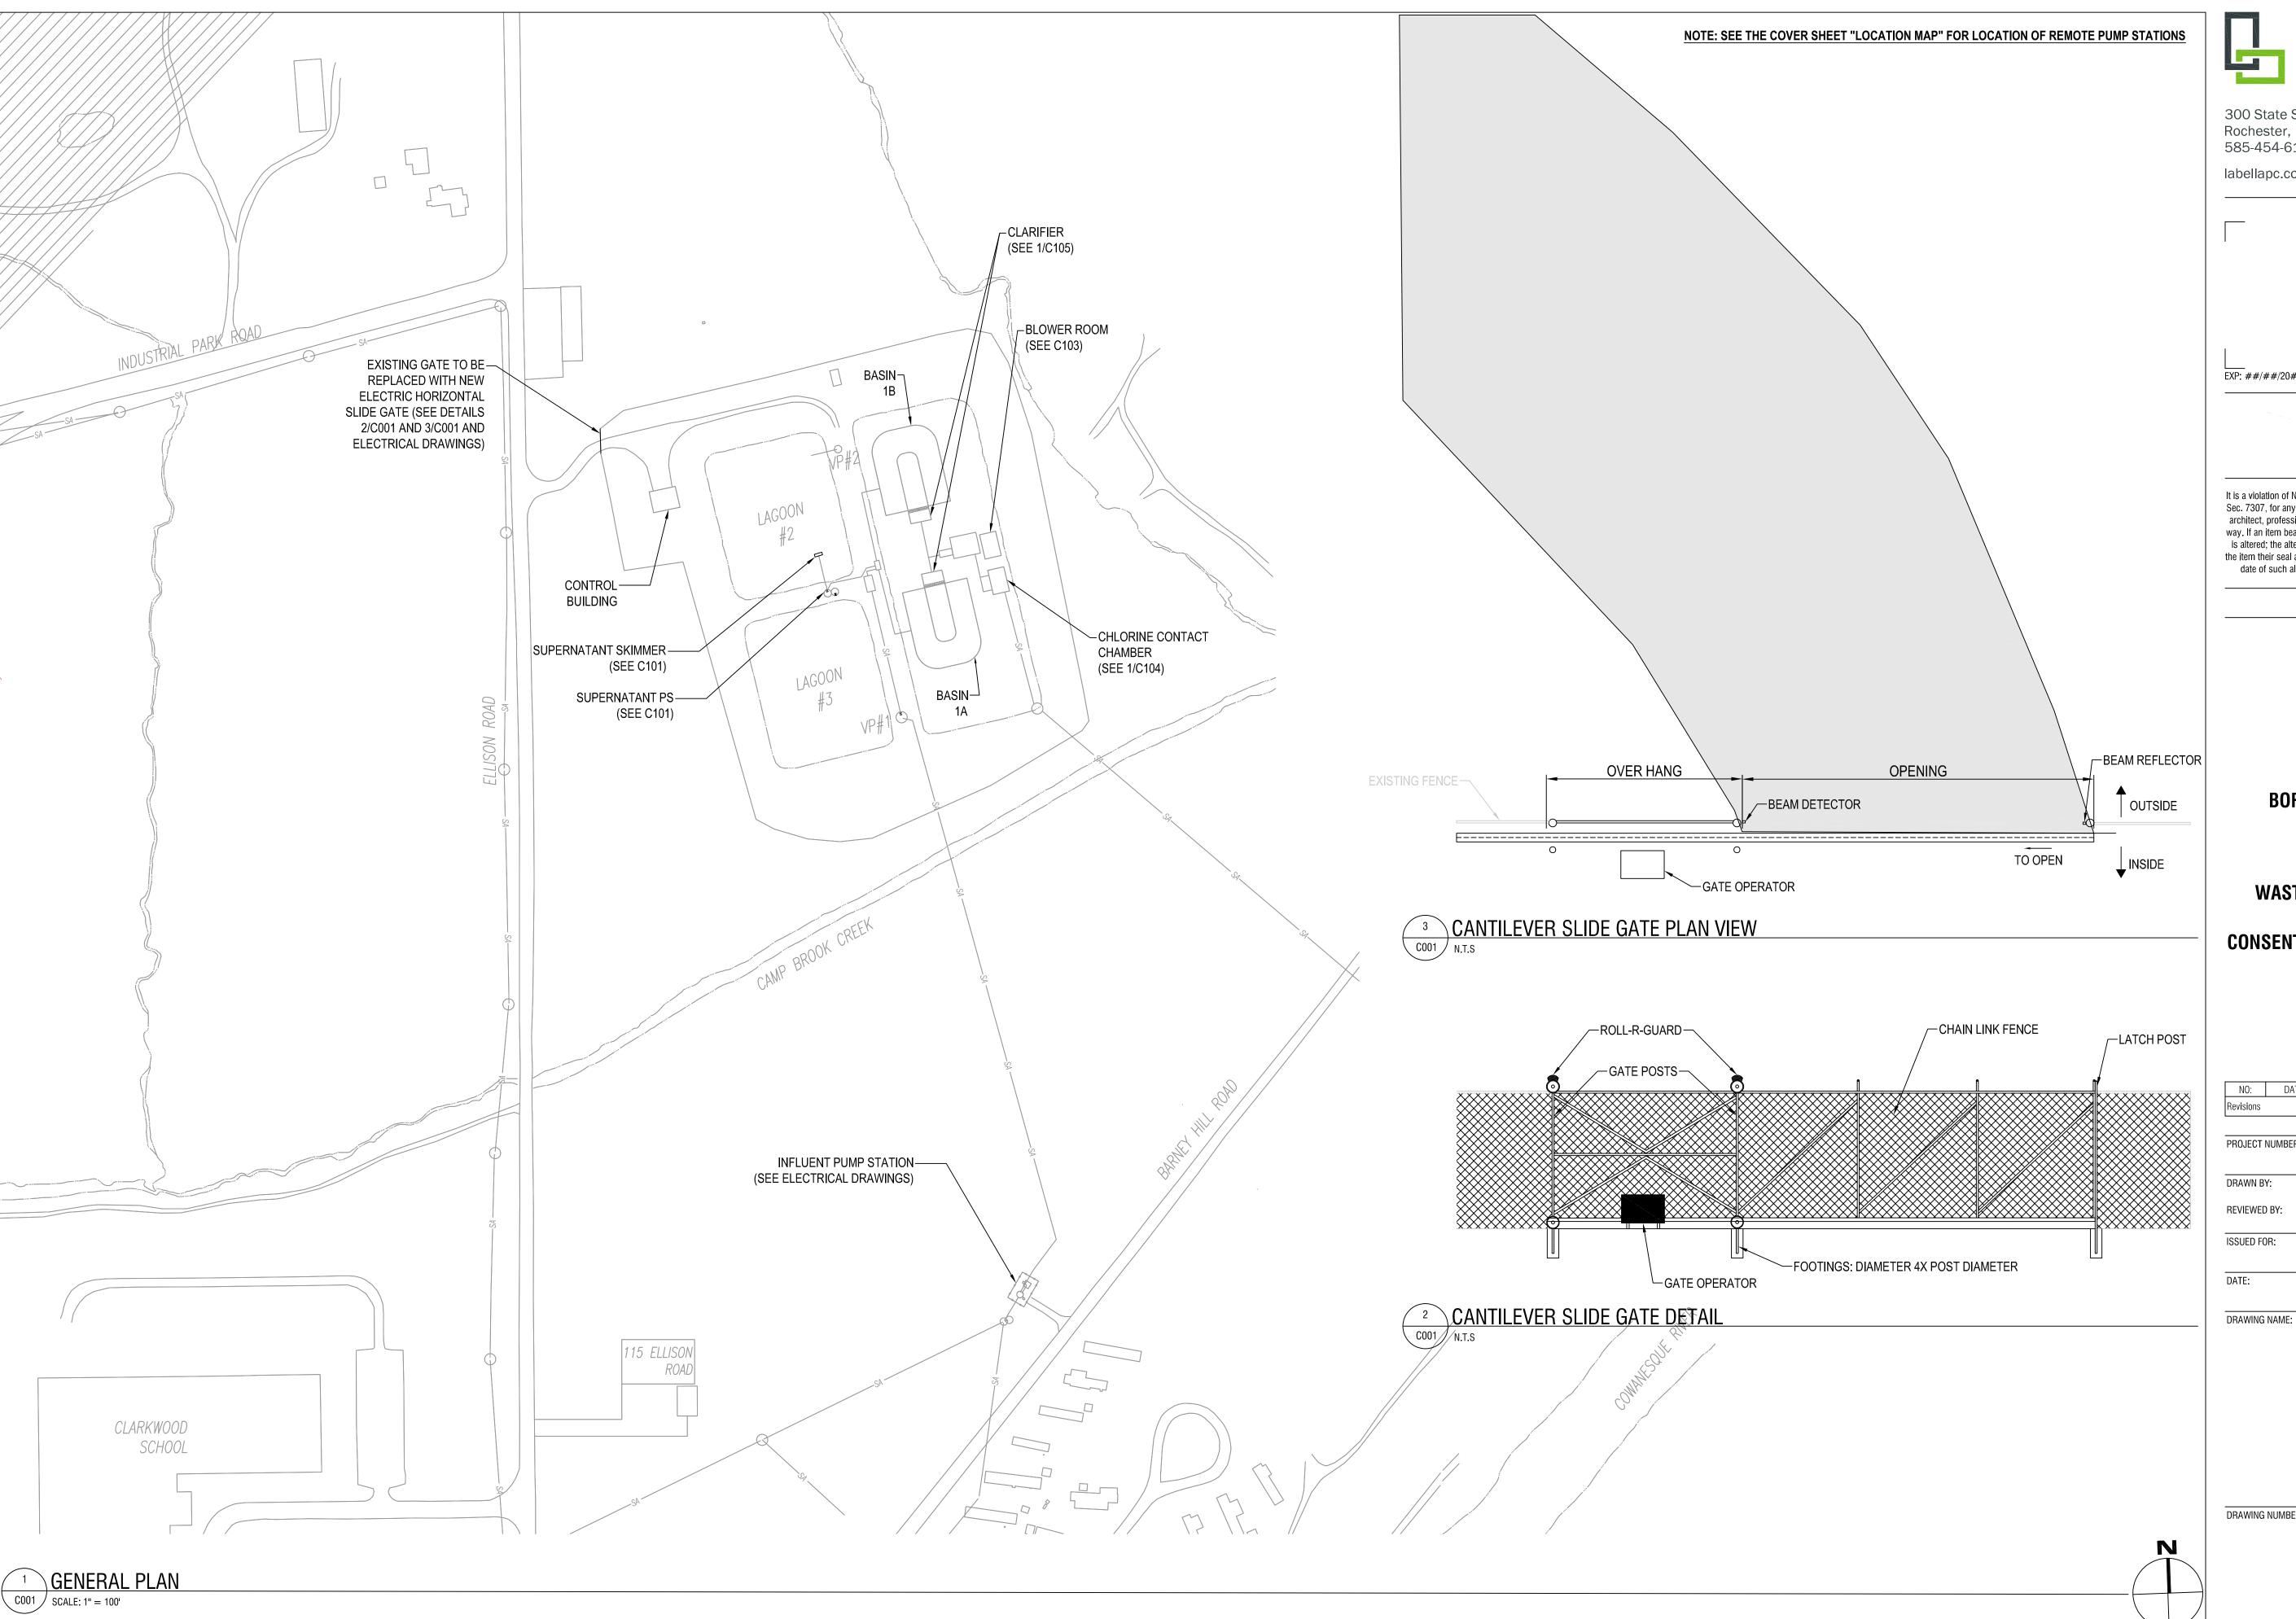



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EXP: ##/##/20##

It is a violation of New York Education Law Art. 145 Sec. 7209 & Art. 147 Sec. 7307, for any person, unless acting under the direction of a licensed architect, professional engineer, or land surveyor, to alter an item in any way. If an item bearing the seal of an architect, engineer, or land surveyor is altered; the altering architect, engineer, or land surveyor shall affix to the item their seal and notation "altered by" followed by their signature and date of such alteration, and a specific description of the alteration.

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#### **BOROUGH OF ELKLAND**

105 PARKHURST ST ELKLAND, PA 16920

### **WASTEWATER TREATMENT FACILITIES CONSENT ORDER IMPROVEMENTS**

115 ELLISON ROAD ELKLAND, PA 16920

NO:	DATE:	DESCRIPTION:	
Revisions			
PR0JECT	NUMBER:	2242861	
DRAWN B	Y:	TK	
REVIEWE	) BY:	BBU	
ISSUED FO	DR:	BID	
DATE:		NOVEMBER 2025	

**GENERAL PLAN** 

DRAWING NUMBER:

#### GENERAL NOTES

- I. WATER TREATMENT PLANT (WTP) SHALL REMAIN IN OPERATION AT ALL TIMES. CONTRACTOR SHALL COMPLETE THE WORK SHOWN WITHOUT DISRUPTING WTP OPERATION. BYPASS PUMPING SHALL BE PROVIDED FOR STAGES OF THIS WORK AS NECESSARY AND ACCORDING TO THE SEQUENCE OF WORK IN SECTION 011000.
- 2. THE CONTRACTOR ALONE SHALL BE RESPONSIBLE TO LOCATE UTILITIES OUTSIDE THE RIGHT-OF-WAY INCLUDING PRIVATE ROADS.
- 3. SITE DRAINAGE, INCLUDING THE PROJECT SITE AND ADJACENT PRIVATE AND PUBLIC ROADWAYS, DRIVES, PARKING AREAS OR PROPERTIES SHALL BE MAINTAINED THROUGHOUT THE CONSTRUCTION PERIOD.
- 4. THE CONTRACTOR SHALL BE RESPONSIBLE FOR SUPPLYING ALL MATERIALS, TOOLS AND EQUIPMENT, INCLUDING SPECIAL CUTTING DEVICES, NECESSARY TO PERFORM THE WORK CONTAINED IN THIS CONTRACT.
- 5. THE SIZES AND MATERIAL OF CONSTRUCTION OF WATER MAINS, SANITARY SEWERS AND STORM SEWERS TO REMAIN ARE REPUTED. THE CONTRACTOR SHALL VERIFY SIZES OF ALL UTILITIES WHERE CONNECTIONS TO SAID EXISTING UTILITIES ARE REQUIRED. EXCAVATION TO VERIFY THESE UTILITIES SHALL BE MADE AT NO ADDITIONAL COST TO THE OWNER.
- 6. THE CONTRACTOR SHALL PROTECT ALL EXISTING SITE AMENITIES NOT DESIGNATED FOR REMOVAL.
- 7. UNLESS OTHERWISE INDICATED ON THE PLANS OR DIRECTED BY THE ENGINEER, THE CONTRACTOR IS RESPONSIBLE FOR PRESERVING AND PROTECTING FROM DAMAGE ALL TREES, SHRUBS AND PLANTS IN THE VICINITY OF THE PROPOSED
- 8. THE CONTRACTOR SHALL PROTECT AND SUPPORT ALL EXISTING UTILITIES DESIGNATED TO REMAIN FOR THE DURATION OF THE CONTRACT.
- 9. ANY SITE AMENITY, UTILITY, STREET APPURTENANCE, OR OTHER ITEM WHICH BECOMES DAMAGED AS A RESULT OF THE CONTRACTOR'S OPERATIONS SHALL BE REPAIRED OR REPLACED IN-KIND BY THE CONTRACTOR AS DETERMINED BY THE ENGINEER AND AT NO ADDITIONAL COST TO THE OWNER.

#### **SURVEY NOTES**

- CONTRACTOR SHALL FIELD VERIFY ALL EXISTING CONDITIONS PRIOR TO BID. NO ALLOWANCE WILL BE MADE FOR ADDITIONAL COSTS DUE TO CONTRACTOR'S FAILURE TO VERIFY EXISTING CONDITIONS.
- 2. THE CONTRACTOR SHALL LOCATE, MARK, SAFEGUARD AND PRESERVE ALL SURVEY MARKERS AND RIGHT-OF-WAY MARKERS IN THE AREA OF CONSTRUCTION.
- 3. ANY IRON PINS, MONUMENTS OR OTHER ITEMS DEFINING PROPERTY LINES WHICH ARE DISTURBED BY CONSTRUCTION OPERATIONS SHALL BE PROPERLY TIED AND ACCURATELY RESET BY A NYS LICENSED SURVEYOR UPON COMPLETION OF THE WORK
- 4. HORIZONTAL DATUM BASED ON NORTH AMERICAN DATUM 1983 (NAD83) NEW YORK STATE PLANE WEST.
- 5. VERTICAL BASED OFF ON NORTH AMERICAN VERTICAL DATUM 1988 (NAVD-88).
- 6. A SURVEY HAS BEEN COMPLETED BY KHEOPS ENGINEERING. THE EXISTING CONDITIONS SHOWN ON THESE PLANS ARE BASED ON TOPOGRAPHIC SURVEY PREPARED BY KHEOPS SURVEY DATED 09/07/2022.
- 7. PROPERTY LINES ARE FROM GIS DATA DATED JULY 2021.
- 8. RIGHT OF WAY LINES ARE FROM RECORD.

#### **DEMOLITION NOTES**

- 1. CONTRACTOR SHALL FIELD VERIFY ALL EXISTING CONDITIONS PRIOR TO BID. NO ALLOWANCE WILL BE MADE FOR ADDITIONAL COSTS DUE TO CONTRACTOR'S FAILURE TO VERIFY EXISTING CONDITIONS AND DIMENSIONS.
- PRIOR TO THE START OF CONSTRUCTION, THE CONTRACTOR SHALL NOTIFY DIG SAFE NEW YORK AT 811 TO REQUEST UTILITY STAKEOUT OF ALL PUBLIC UTILITIES.
- 3. WORK ASSOCIATED WITH THIS CONTRACT WILL OCCUR AT AN ACTIVE AND FUNCTIONAL FACILITY. CONTRACTOR SHALL COORDINATE WITH THE OWNER TO MINIMIZE DISRUPTION TO THE OPERATIONS OF THE FACILITY. CONTRACTOR SHALL BE SOLELY RESPONSIBLE TO PROVIDE A SAFE WORK SITE AND TO PROTECT THE PUBLIC, VISITORS AND EMPLOYEES FROM HARM AS A RESULT OF HIS CONSTRUCTION ACTIVITIES.
- 4. THE HORIZONTAL AND VERTICAL LOCATION OF ALL EXISTING ABOVE GROUND AND BELOW GROUND UTILITIES, STRUCTURES, AND APPURTENANCES SHOWN ON THE PLANS ARE APPROXIMATE AND ARE NOT GUARANTEED. THE CONTRACTOR SHALL BE RESPONSIBLE FOR DETERMINING THE EXACT HORIZONTAL AND VERTICAL LOCATION OF ALL UTILITIES, STRUCTURES, AND APPURTENANCES IN THE PATH OF AND ADJACENT TO THE PROPOSED WORK.
- 5. THE CONTRACTOR SHALL NOTIFY THE LOCAL GOVERNMENT AND NEW YORK STATE DEPARTMENT OF HEALTH (NYSDOH) AS NECESSARY AND SHALL OBTAIN ANY REQUIRED PERMITS PRIOR TO BEGINNING WORK. COPIES OF ANY REQUIRED PERMITS SHALL BE PROVIDED TO THE OWNER PRIOR TO BEGINNING THE WORK.
- 6. CONTRACTOR SHALL REMOVE FROM SITE, MATERIALS NOT INDICATED TO BE SALVAGED INCLUDING ALL DEBRIS. ALL REMOVED MATERIALS SHALL BECOME THE PROPERTY OF CONTRACTOR WHO SHALL LEGALLY DISPOSE OF SAME.
- 7. ALL TREES, SHRUBS AND PLANTS DESIGNATED TO REMAIN AND DISTURBED BY CONSTRUCTION OPERATIONS, SHALL BE REPLACED IN-KIND AS DIRECTED BY THE ARCHITECT/ENGINEER AND/OR OWNER'S DESIGNATED REPRESENTATIVE AT NO ADDITIONAL COST TO THE OWNER.
- 8. THE CONTRACTOR SHALL MAINTAIN SAFE VEHICULAR AND PEDESTRIAN ACCESS TO THE EXISTING BUILDINGS FOR THE DURATION OF THE CONTRACT.
- 9. WHEN EXISTING CONSTRUCTION WHICH IS TO REMAIN IS DAMAGED DURING THE COURSE OF CONSTRUCTION AS A RESULT OF CONTRACTORS WORK, IT SHALL BE REPAIRED AND/OR REPLACED WITH SIMILAR OR LIKE MATERIALS AS MUCH AS POSSIBLE, AT NO COST TO THE OWNER. ALL REPAIRS AND/OR REPLACEMENTS
- COORDINATE LOCATION OF TEMPORARY CONSTRUCTION FENCE AND TEMPORARY STONE STAGING AREAS WITH OWNER.

WILL BE SUBJECT TO OWNERS APPROVAL.

## SITE NOTES

- WELL COMPACTED SUBGRADE SHALL BE UTILIZED UNDERNEATH CONSTRUCTION OF PAVEMENT AND CONCRETE BASES.
- 2. ALL STAKEOUT FOR THE PROPOSED SITE IMPROVEMENTS SHALL BE COMPLETED BY A NEW YORK STATE LICENSED LAND SURVEYOR.
- 3. IF ANY DISCREPANCIES ARE NOTED BETWEEN THESE CONSTRUCTION DOCUMENTS AND INFORMATION PROVIDED OR AN ERROR IS SUSPECT, IT SHALL BE IMMEDIATELY REPORTED TO THE ENGINEER IN WRITING.
- 4. ANY PROOF-ROLLING OF EXPOSED SUBBASE BY A MINIMUM 10 TON SMOOTH DRUM ROLLER SHALL BE DONE UNDER THE GUIDANCE OF, AND OBSERVED BY, QUALIFIED ENGINEERING PERSONNEL PRIOR TO PLACEMENT OF SUBBASE MATERIAL. THE ROLLER SHOULD BE OPERATED IN THE STATIC MODE AND COMPLETE AT LEAST TWO (2) PASSES OVER THE EXPOSED SUBGRADES.

#### UTILITY NOTES

- 1. WATERLINES/WATERMAINS TO BE INSTALLED IN ACCORDANCE WITH THE "RECOMMENDED STANDARDS FOR WATER WORKS" BY THE GREAT LAKES UPPER MISSISSIPPI RIVER BOARD OF STATE AND PROVINCIAL PUBLIC HEALTH AND ENVIRONMENTAL MANAGERS, DATED 2022 (OR ANY SUBSEQUENT REVISION).
- 2. WATER MAINS CROSSING SANITARY OR STORM SEWERS SHALL BE LAID TO PROVIDE A MINIMUM VERTICAL DISTANCE OF 18" INCHES BETWEEN THE OUTSIDE OF THE WATER MAIN AND THE OUTSIDE OF THE SEWER. THIS SHALL BE THE CASE WHERE THE WATER MAIN IS EITHER ABOVE OR BELOW THE SEWER WITH PREFERENCE TO THE WATER MAIN ABOVE THE SEWER.
- 3. AT CROSSINGS, ONE FULL LENGTH OF WATER PIPE SHALL BE LOCATED SO BOTH JOINTS WILL BE AS FAR FROM THE SEWER AS POSSIBLE.
- 4. THERE SHALL BE AT LEAST A 10' HORIZONTAL SEPARATION BETWEEN WATER MAINS AND SANITARY OR STORM SEWERS.
- 5. WHERE WATER MAINS CAN NOT BE INSTALLED IN COMPLIANCE WITH THE ABOVE A CASING PIPE SHALL BE USED.

#### EROSION AND SEDIMENT CONTROL NOTES

- 1. ALL EROSION CONTROL MEASURES SHALL BE IN ACCORDANCE WITH NEW YORK STANDARDS AND SPECIFICATIONS FOR EROSION AND SEDIMENT CONTROL, AND LOCAL GOVERNING SOIL AND WATER CONSERVATION AGENCY RECOMMENDATIONS AND STANDARDS. CONTRACTOR SHALL SUBMIT PROPOSED EROSION CONTROL PLAN INCLUDING SEQUENCING OF WORK TO THE ENGINEER FOR REVIEW PRIOR TO START OF WORK.
- 2. UTILIZE CONSTRUCTION METHODS/TECHNIQUES, WHICH WILL LIMIT THE EXPOSED EARTHEN AREAS AND MINIMIZE THE EFFECT OF EARTH DISTURBANCE ACTIVITIES ON SOIL EROSION. THE AREA OF DISTURBANCE SHALL BE LIMITED TO A MAXIMUM OF 5 ACRES UNLESS OTHERWISE APPROVED BY THE ENGINEER.
- 3. ALL SEDIMENTATION BARRIERS AND OTHER TEMPORARY OR PERMANENT MEASURES SHALL BE IN PLACE PRIOR TO THE START OF CONSTRUCTION. PLANS SHOW THE SUGGESTED MINIMUM MEASURES REQUIRED.
- 4. REMOVAL OF ALL TEMPORARY EROSION AND SEDIMENTATION CONTROL MEASURES SHALL BE COMPLETED AT THE APPROVAL OF THE OWNER AND ENGINEER. THE COST OF REMOVING THESE MEASURES SHALL ALSO BE INCLUDED IN THE BID PRICE.
- 5. FOR THE DURATION OF THE PROJECT, THE CONTRACTOR SHALL PROTECT ALL ON-SITE, ADJACENT AND/OR DOWNSTREAM STORM/SANITARY SEWERS, AND/OR OTHER WATER COURSES FROM CONTAMINATION BY WATER BORNE SILTS, SEDIMENTS, FUELS, SOLVENTS, LUBRICANTS OR OTHER POLLUTANTS ORIGINATING FROM ANY WORK DONE ON, OR IN SUPPORT OF THIS PROJECT.
- 6. DURING CONSTRUCTION NO WET OR FRESH CONCRETE OR LEACHATE SHALL BE ALLOWED TO ESCAPE INTO STORM/SANITARY SEWERS, DITCHES OR OTHER WATERS OF NEW YORK STATE, NOR SHALL WASHINGS FROM CONCRETE TRUCKS, MIXERS OR OTHER DEVICES BE ALLOWED TO ENTER ANY STORM/SANITARY SEWERS, DITCHES, RIVERS, OR WATER COURSES.
- 7. ALL EXCAVATED OR IMPORTED EARTHEN STOCKPILES SHALL BE SUITABLY STABILIZED AND PROTECTED BY SILT FENCE SO THAT IT CANNOT REASONABLY ENTER ANY WATER BODY, OR STORM OR SANITARY SEWER.
- 8. ALL METHODS AND EQUIPMENT PROPOSED BY THE CONTRACTOR TO ACCOMPLISH THE WORK FOR EROSION AND POLLUTION CONTROL SHALL BE SUBJECT TO APPROVAL OF THE ENGINEER.
- 9. THE CONTRACTOR SHALL BE REQUIRED TO TREAT TRAVELED AREAS TO CONTROL DUST. WATER SHALL BE APPLIED TO SUCH TRAVELED AREAS AS THE ENGINEER MAY DESIGNATE. THE NUMBER OF APPLICATIONS AND THE AMOUNT OF WATER SHALL BE BASED UPON FIELD AND WEATHER CONDITIONS.
- 10. ALL AREAS OF SOIL DISTURBANCE RESULTING FROM THIS PROJECT WHICH WILL NOT BE SUBJECT TO FURTHER EARTHWORK OR CONSTRUCTION ACTIVITIES SHALL BE PERMANENTLY SEEDED TO ESTABLISH GRASS, AND MULCHED WITH HAY OR STRAW WITHIN ONE WEEK OF FINAL DISTURBANCE. MULCH SHALL BE MAINTAINED UNTIL A SUITABLE VEGETATIVE COVER IS ESTABLISHED.
- 11. CONTRACTOR STAGING AREAS AND CONSTRUCTION ENTRANCE LOCATIONS SHALL BE COORDINATED WITH THE OWNER PRIOR TO START OF CONSTRUCTION. STABILIZED CONSTRUCTION ENTRANCE(S), AS SHOWN ON THE PLANS SHALL BE PROVIDED. ALL DISTURBED AREAS SHALL BE RESTORED.
- 12. ALL CATCH BASINS/DRAINAGE INLETS SHALL HAVE STONED INLET PROTECTION AROUND THEM AND GEOTEXTILE FABRIC OVER THE GRATE TO PREVENT SEDIMENTATION FROM ENTERING THE STORM SYSTEM.
- 13. TILL ALL COMPACTED SOILS LOCATED IN LAWN AREAS TO RESTORE THE ORIGINAL PROPERTIES OF THE SOIL PRIOR TO SEEDING.

#### DRAWING INDEX

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C001 GENERAL PLAN

C002 GENERAL NOTES

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C104 TRC & TSS MONITORING

C105 SAMPLING CATWALK

E001 ELECTRICAL NOTES, SYMBOL LEGEND, & ABBREVIATIONS

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E101 CONTROL BUILDING-ELECTRICAL

E102 BLOWER BUILDING-ELECTRICAL

E500 ELECTRICAL DETAILS

E501 ELECTRICAL DETAILS

E502 INFLUENT PUMP STATION - AREA CLASSIFICATION


E503 PROCESS CONTROL BLOCK DIAGRAM

E504 INFLUENT PUMP STATION DETAILS

E700 ONE-LINE DIAGRAM - NEW WORK

ED700 ONE-LINE DIAGRAM - DEMOLITION

#### LEGEND

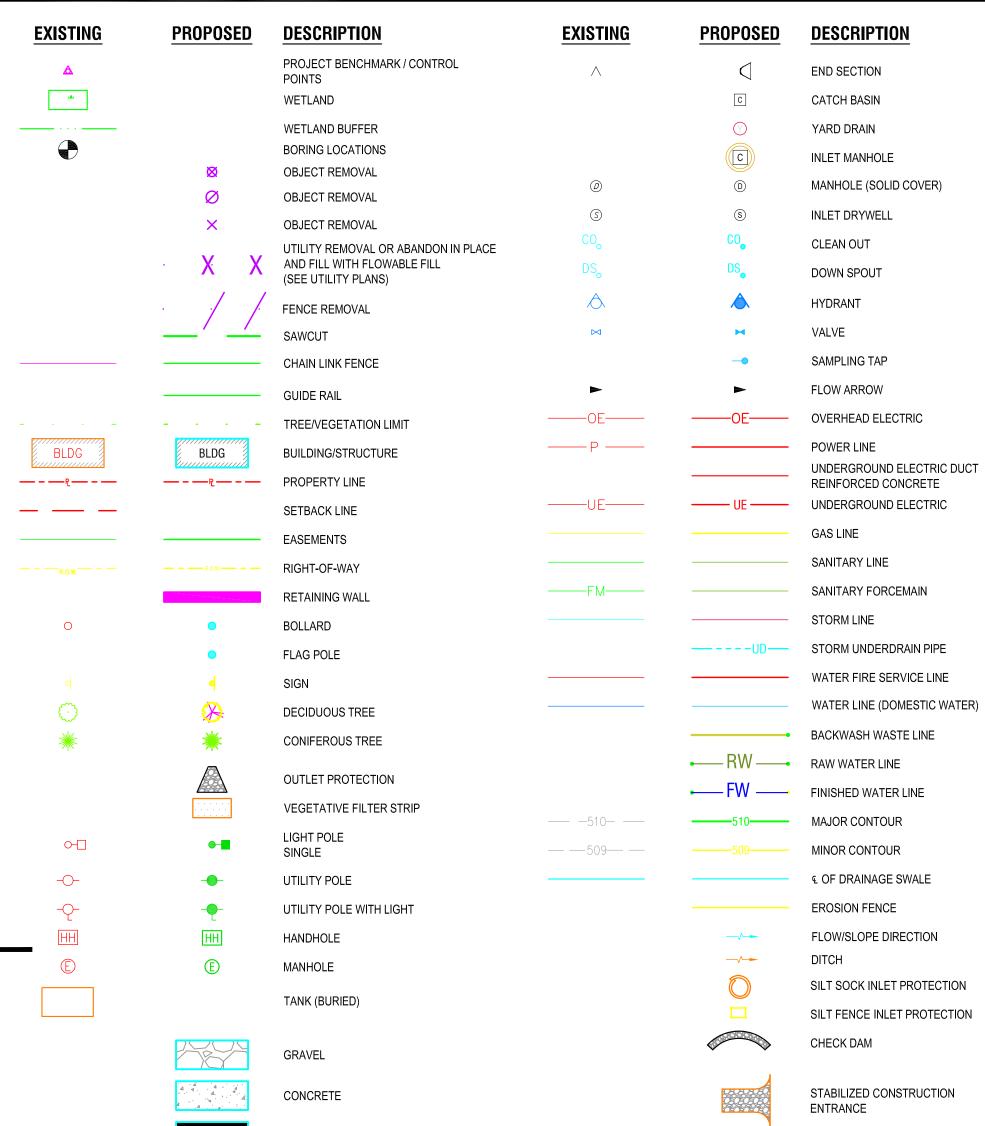

**HEAVY DUTY ASPHALT** 



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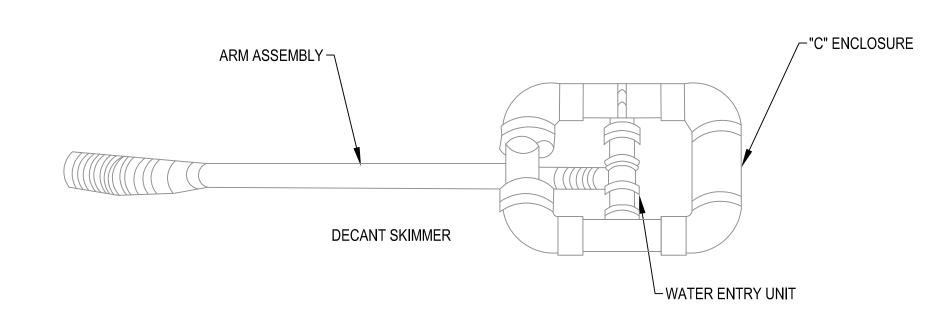
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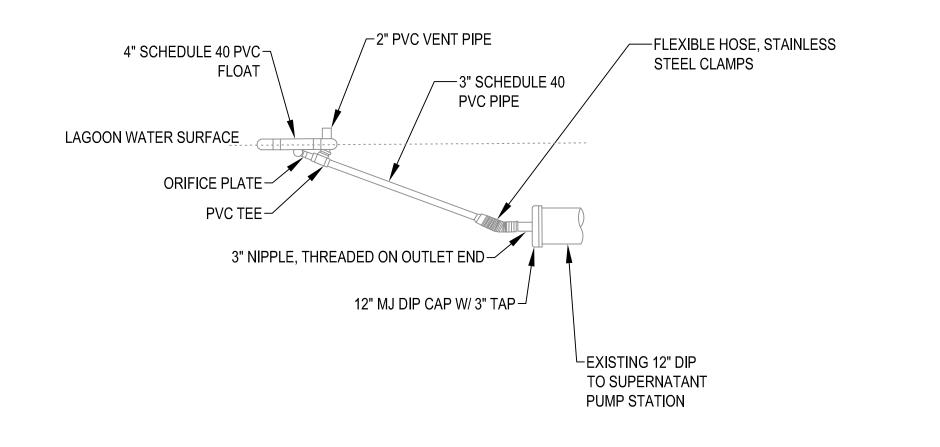
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PROJECT N	IUMBER:	2242861	
DRAWN BY		TK	
REVIEWED BY:		BBU	
ISSUED FO	R:	BID	
DATE:		NOVEMBER 2025	

**GENERAL NOTES** 

DRAWING NUMBER:

DRAWING NAME:









#### NOTES:

- 1. FURNISH NEW DECANT SKIMMER IN LAGOON #2 TO REPLACE EXISTING
- 2. DECANT SKIMMER IS FURNISHED AS AN ASSEMBLY
- 3. OWNER WILL DECANT LAGOON 2. CONTRACTOR TO REMOVE & DISPOSE OF STORED SLUDGE OFFSITE

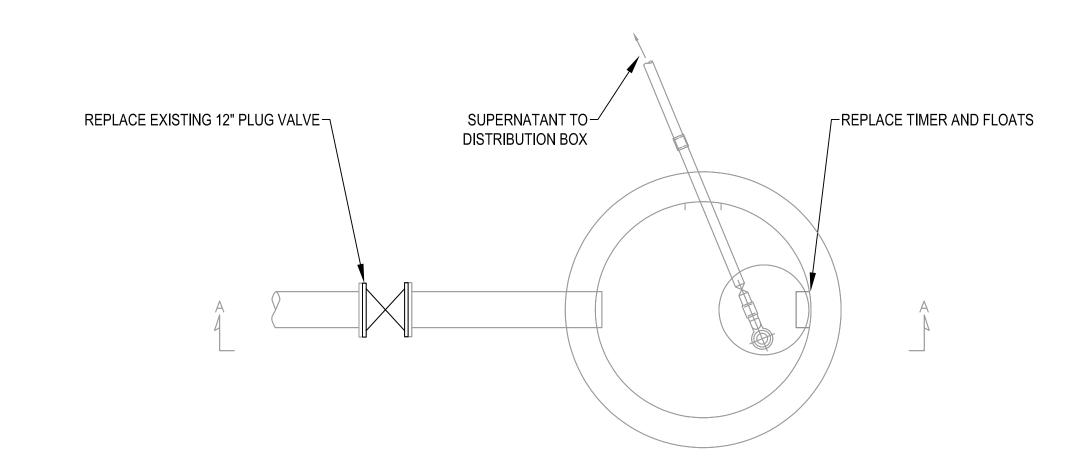

# SUPERNATANT PUMP STATION PLAN VIEW On N.T.S

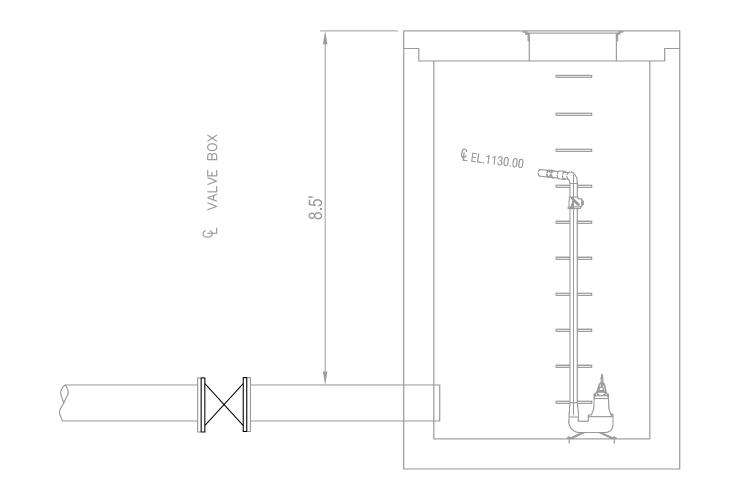

SUPERNATANT PUMP STATION SECTION A-A

C101 N.T.S.



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DATE:		NOVEMBER 2025

SUPERNATANT
PUMP STATION
& SKIMMER

DRAWING NUMBER:

DRAWING NAME:




1. CLEAN UP, RENOVATE, OR REPLACE BIOFUSER ASSEMBLIES IN BASIN 1A

2. CONTRACTOR TO PROVIDE 2 DAYS OF CRANE SERVICE, 1 DAY TO LIFE AERATION CHAINS OUT OF BASIN 1A FOR EVALUATION AND REPAIR BY BOROUGH STAFF AND 1 DAY TO RESET AERATION CHAINS. REPAIRS ARE ANTICIPATED TO TAKE NO MORE THAN 4 DAYS, COORDINATE WITH BOROUGH PERSONNEL.



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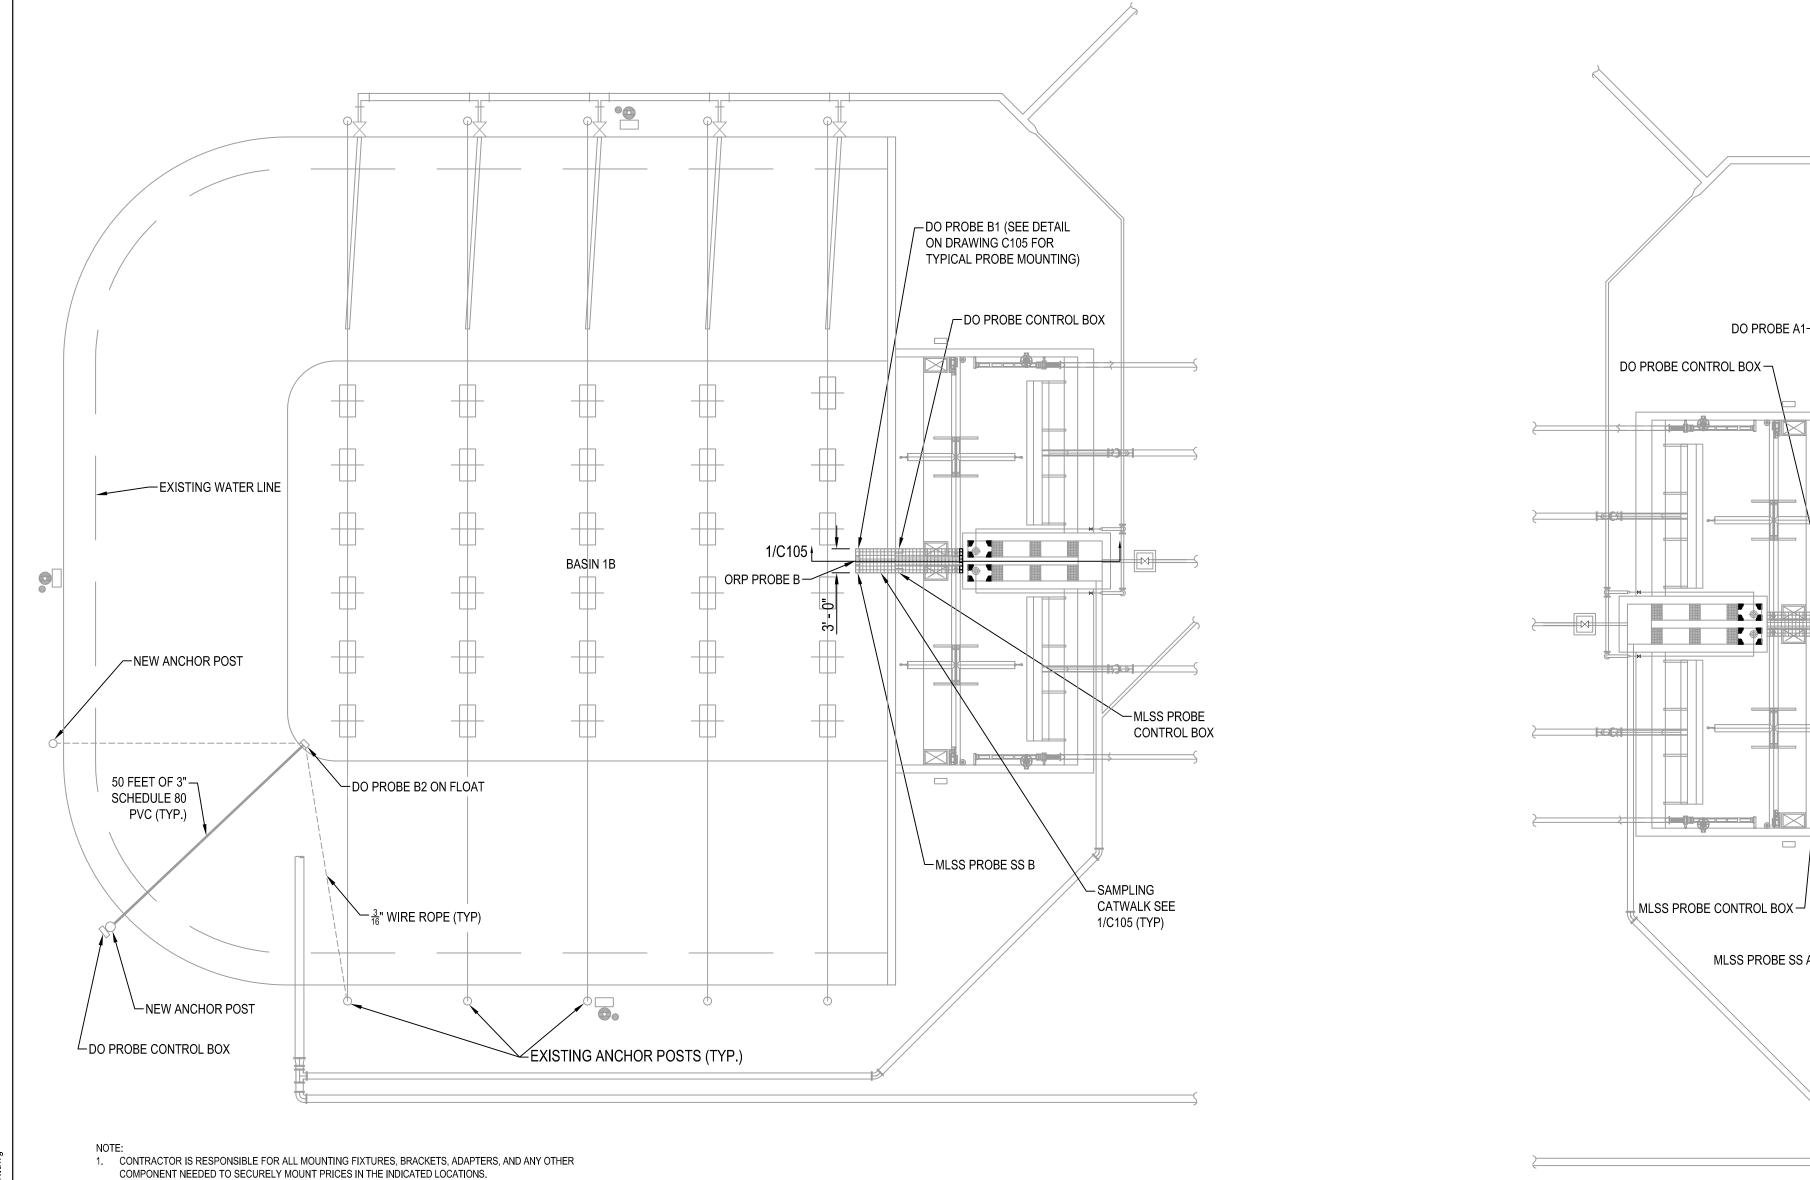
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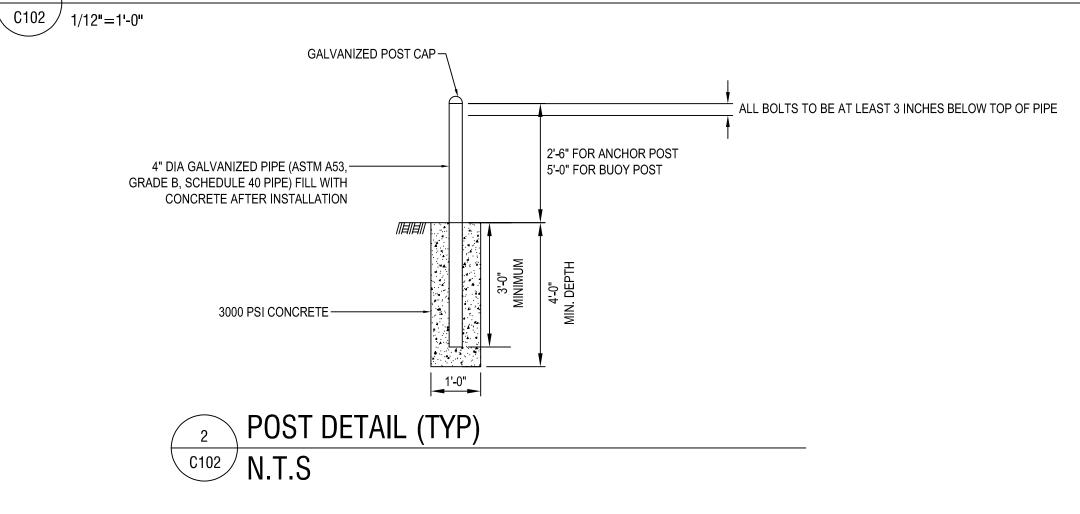
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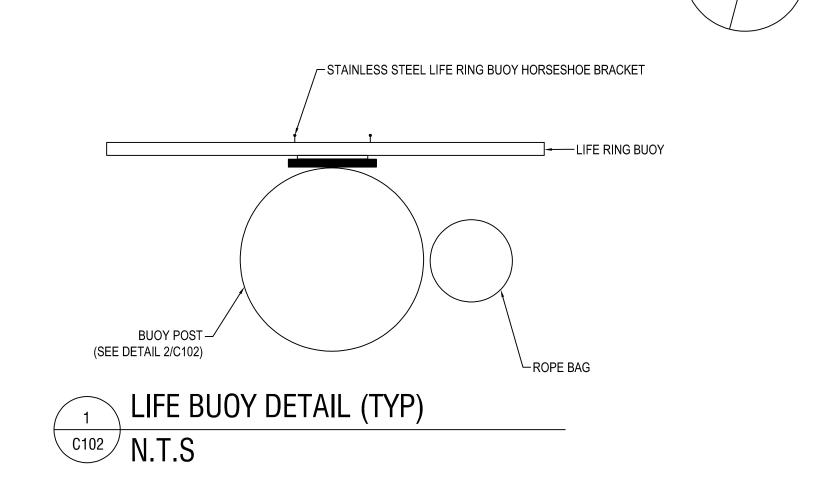
# **AERATION BASINS**


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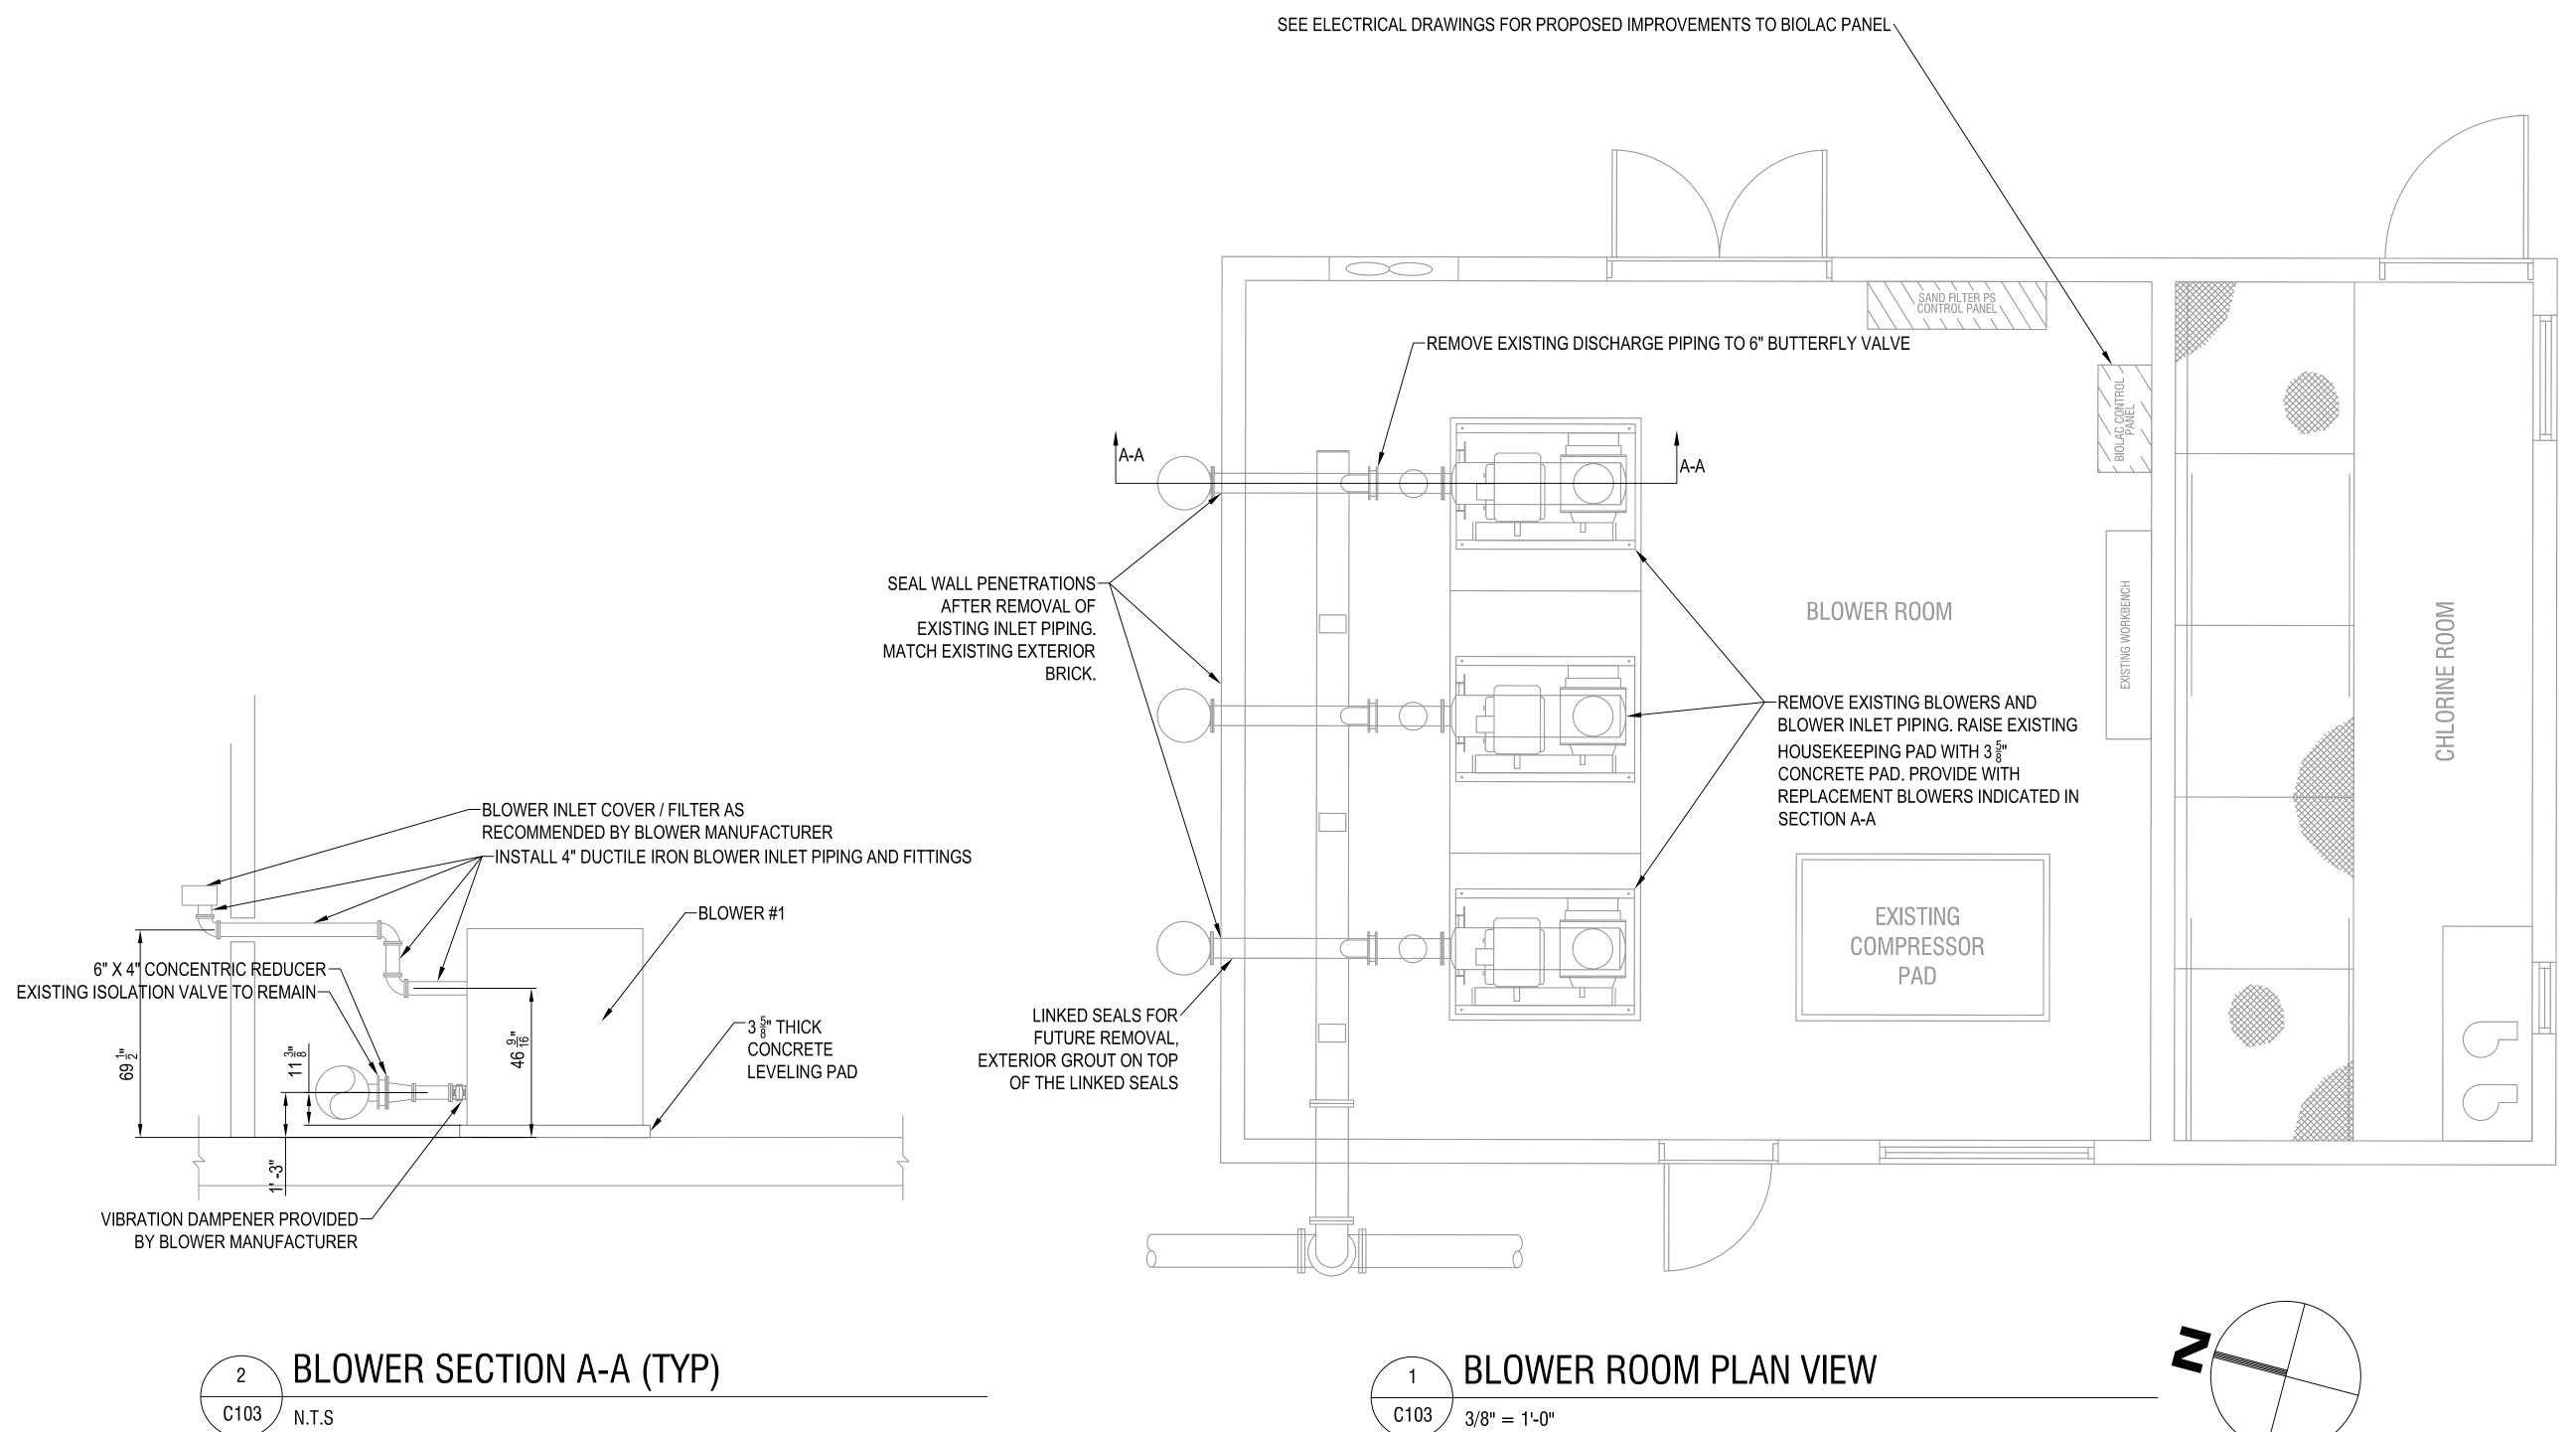


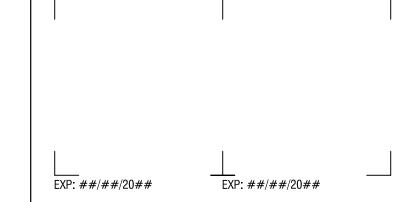





# NOTE: FIELD VERIFY MEASUREMENTS SHOWN ON DRAWINGS

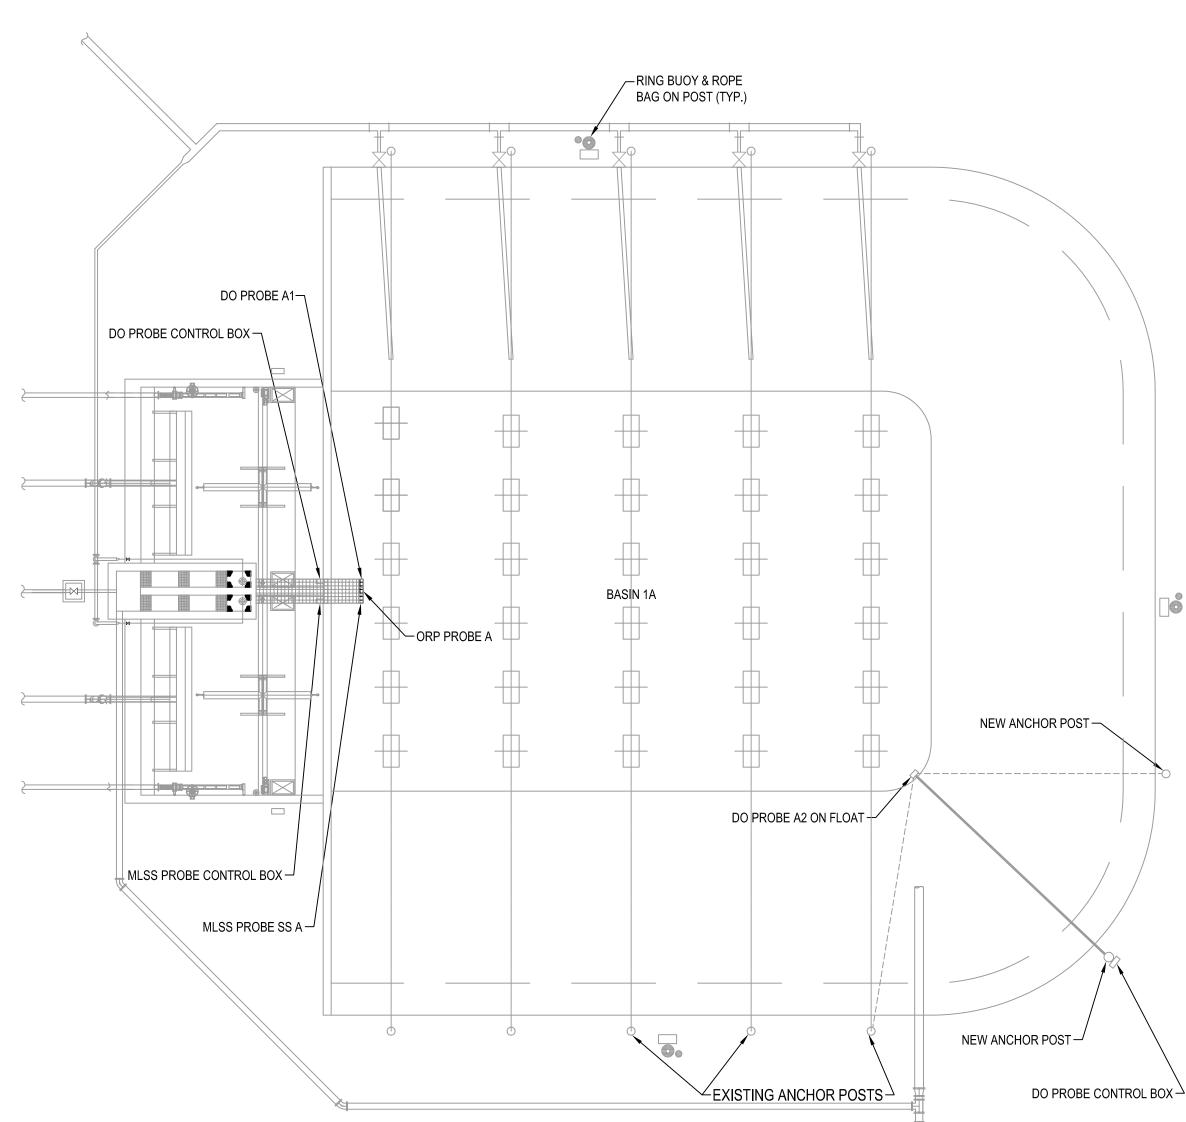



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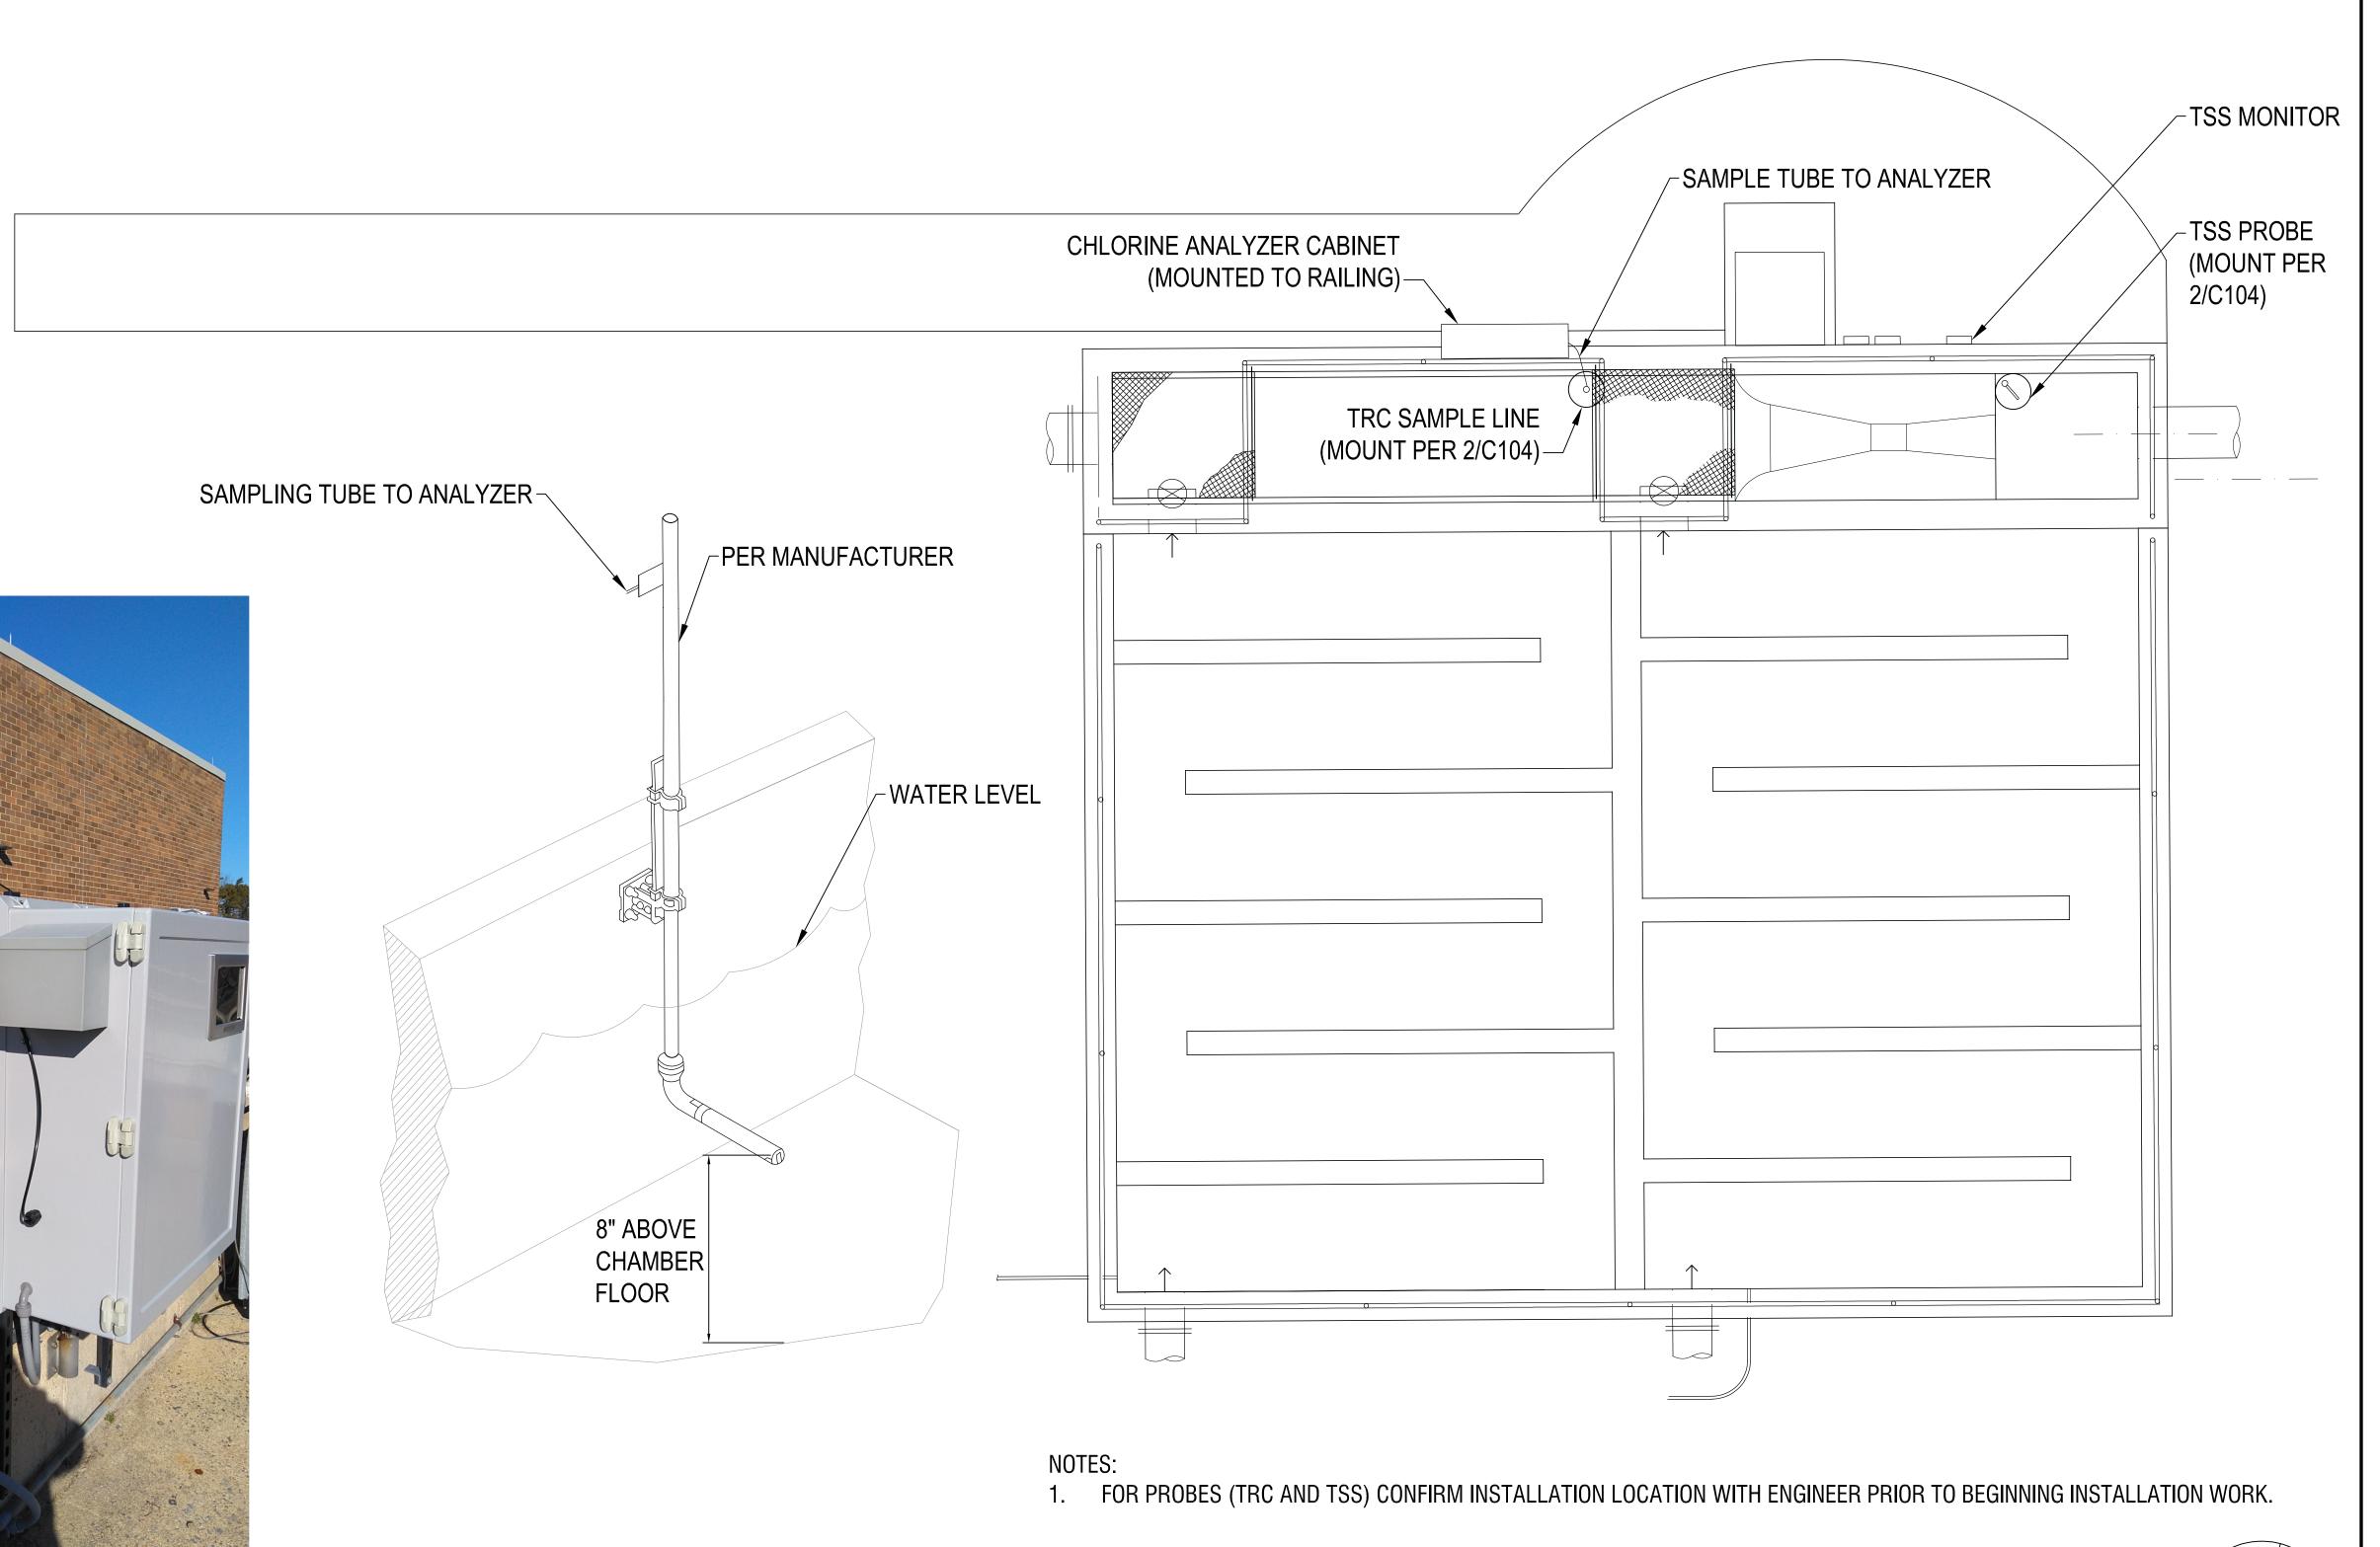
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DATE:		NOVEMBER 2025	

DRAWING NAME:

# **BLOWER ROOM**

DRAWING NUMBER:



PROBE MOUNTING DETAIL

On the second of the

CHLORINE CONTACT BASIN

3/8" = 1'-0"



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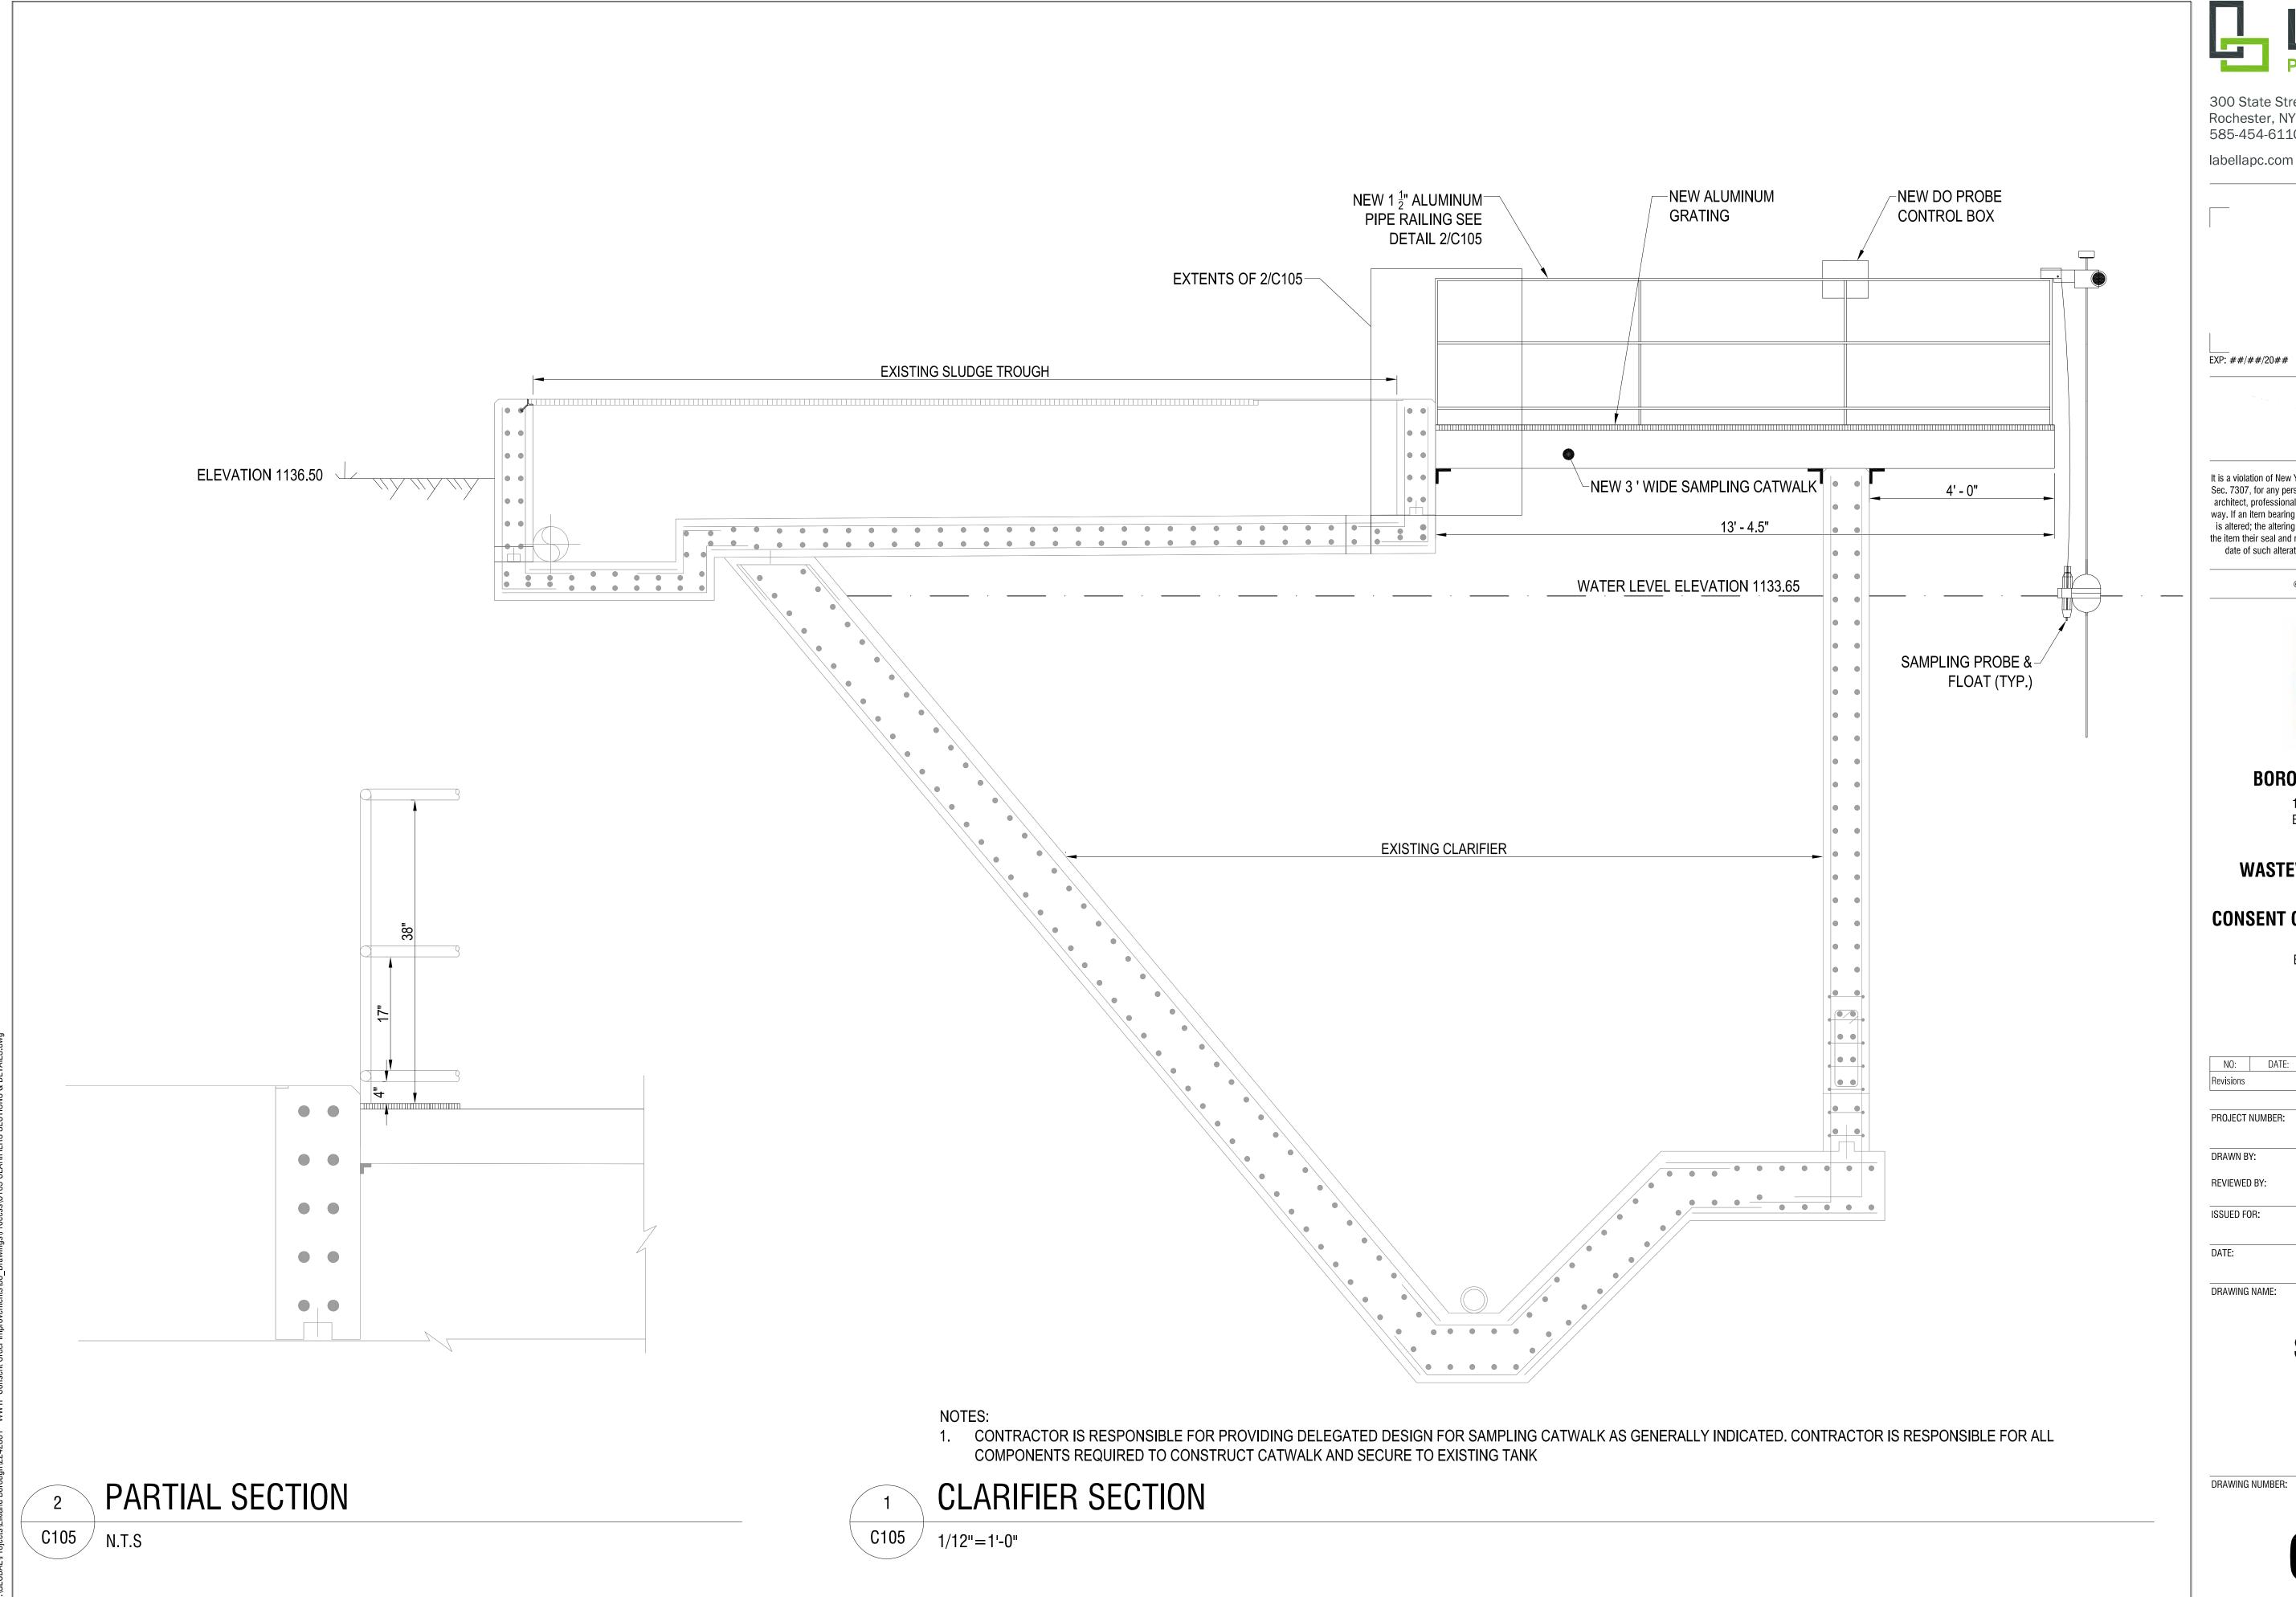
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DRAWING NAME:

TRC & TSS MONITORING

DRAWING NUMBER:





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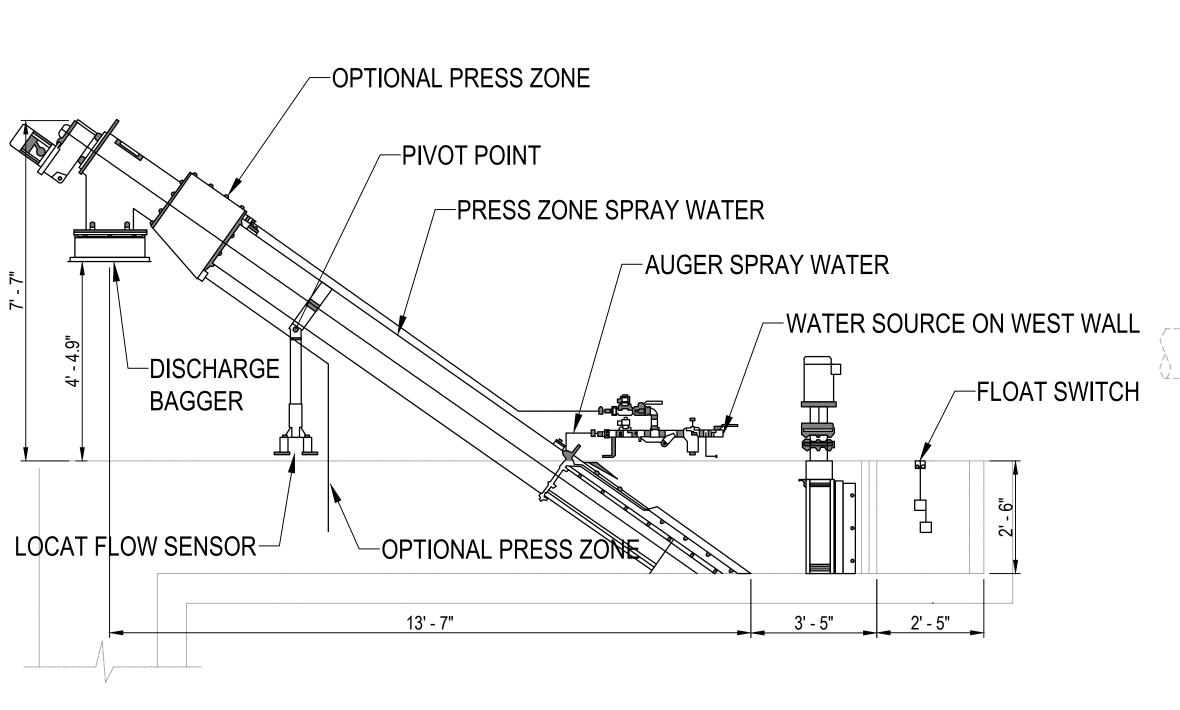
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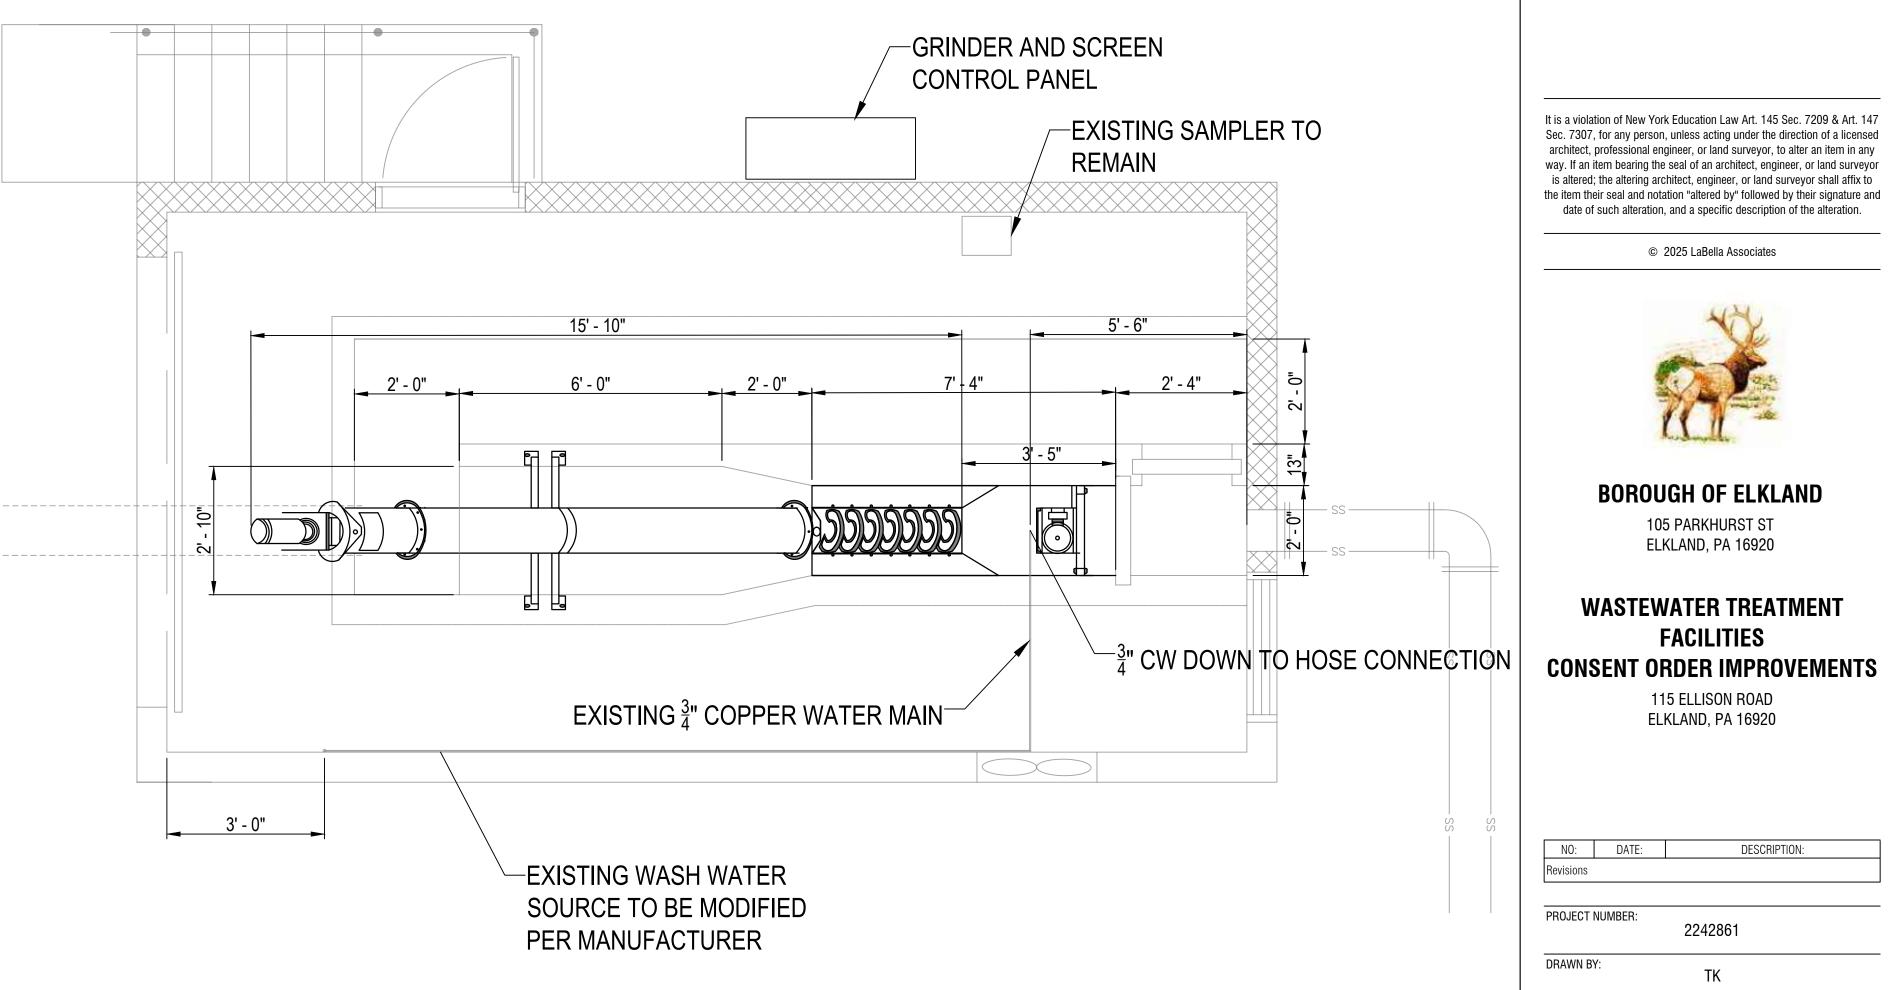
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# **SAMPLING CATWALK**

DRAWING NUMBER:





PLAN VIEW

N.T.S

C106

C106 /

MODEL ALT1835 - 300 AUGER MONSTER

N.T.S

NOTES: 1. REMOVE EXISTING GRINDER AND AUGER SCREEN

- FURNISH NEW GRINDER AND NEW AUGER SCREEN
- ENSURE SCREEN DISCHARGE DOES NOT INTERFERE WITH FLOW METER. METER TO BE RELOCATED IF NECESSARY

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# **HEADWORKS EQUIPMENT**

DRAWING NAME:

#### **DEFINITIONS:**

SUPPLY AND DELIVER TO PROJECT SITE, READY FOR UNLOADING, UNPACKING, ASSEMBLY, INSTALLATION, AND SIMILAR OPERATIONS.

UNLOAD, TEMPORARILY STORE, UNPACK, ASSEMBLE, ERECT, PLACE, ANCHOR, APPLY, WORK TO DIMENSION, FURNISH, CURE, PROTECT, CLEAN, AND SIMILAR OPERATIONS AT

FURNISH AND INSTALL, COMPLETE AND READY FOR THE INTENDED USE.

PROJECT SITE: SPACE AVAILABLE FOR PERFORMING CONSTRUCTION ACTIVITIES. THE EXTENT OF THE PROJECT SITE IS SHOWN ON THE DRAWINGS AND MAY OR MAY NOT BE INDENTICAL WITH THE DESCRIPTION OF THE LAND ON WHICH THE PROJECT IS TO BE BUILT.

#### **ELECTRICAL GENERAL NOTES**

1. VERIFY EXACT LOCATION OF CONNECTION POINTS PRIOR TO ROUGH-IN.

PROJECT SITE

- PROVIDE RACEWAY, WIRE AND CABLE, ASSOCIATED FITTINGS AND CONNECTORS, AND COMPLETE CONNECTIONS REQUIRED FOR DESIGNATED BRANCH CIRCUITS FROM DEVICE(S) TO FINAL OVERCURRENT DEVICE AND TO LOCAL CONTROL DEVICE(S) PER SPECIFICATIONS.
- MINIMUM BRANCH CIRCUIT WIRE SIZE SHALL BE #12 AWG [EXCEPT LIFE SAFETY/EMERGENCY BRANCH CIRCUIT WIRING WHICH SHALL BE MINIMUM #10 AWGI . SIZE BRANCH CIRCUIT CONDUCTORS AS PER NEC AND AS SCHEDULED ON THIS DRAWING BASED ON ACTUAL CIRCUIT DISTANCE. INCLUDE GROUND CONDUCTOR DERATINGS.
- 4. PULL A SEPARATE NEUTRAL CONDUCTOR FOR ALL BRANCH CIRCUITS REQUIRING A NEUTRAL CONNECTION. DERATE CONDUCTORS PER NEC ACCORDINGLY. MULTIWIRE BRANCH CIRCUITS ARE NOT ACCEPTABLE.
- 5. PROVIDE GROUNDING PER NEC & TIA 607B. PROVIDE GREEN GROUND CONDUCTOR IN ALL BRANCH AND FEEDER CIRCUITS.
- 6. DO NOT INSTALL ANY NEW WORK DIRECTLY ABOVE ANY ELECTRICAL PANELS, SWITCHBOARDS, SWITCHGEAR, OR TRANSFORMERS.
- CIRCUIT NUMBERS SHOWN FOR EQUIPMENT TO BE CONNECTED TO EXISTING PANELBOARD(S) IS SHOWN FOR DESIGN INTENT ONLY AND MAY NOT CORRESPOND TO ACTUAL CIRCUIT BREAKER MOUNTING POSITION IN THE PANEL. UPDATE THE RECORD DRAWINGS & PANELBOARD DIRECTORY WITH THE ACTUAL CIRCUIT NUMBERS USED TO CORRESPOND TO THE PANEL DIRECTORY.
- 8. CONFIRM ALL LABELS AND ROOM NUMBERS WITH OWNER PRIOR TO FINALIZING LABELING AND PROGRAMMING
- PROVIDE FIRESTOPPING AT ALL PENETRATIONS THROUGH FIRE RATED WALLS, FLOORS, CEILINGS, & ROOFS AS CALLED OUT ON ARCHITECTURAL PLANS. PROVIDE ACOUSTICAL SEALANT AT PENETRATIONS THROUGH ALL NON-FIRE RATED WALLS, FLOORS, & CEILINGS. PROVIDE CONDUIT EXPANSION JOINTS AT ALL EXPANSION JOINTS AS CALLED OUT ON ARCHITECTURAL PLANS.
- 10. SITE PLAN CONDUIT ROUTING SHOWN FOR INTENT. REFERENCE CIVIL DRAWINGS FOR UNDERGROUND COORDINATION AND DISTANCE OF RUNS, COORDINATE WITH ALL TRADES.

#### **ELECTRICAL DEMOLITION GENERAL NOTES**

- I. REMOVE ALL ELECTRICAL EQUIPMENT ON OR IN EXISTING WALLS, CEILINGS AND PARTITIONS WHICH ARE TO BE DEMOLISHED. WHERE EQUIPMENT IS SCHEDULED TO BE REMOVED, ABANDON CONCEALED RACEWAY AND REMOVE CONDUCTORS BACK TO SOURCE OR LAST SCHEDULED DEVICE TO REMAIN. REMOVE EXPOSED RACEWAY AND CONDUCTORS BACK TO POWER SOURCE OR LAST DEVICE SCHEDULED TO REMAIN IN ALL OTHER AREAS
- WHERE EXISTING WALLS ARE TO REMAIN, REMOVE ALL EXPOSED RACEWAYS, SURFACE AND RECESSED OUTLET BOXES, ETC. WHICH ARE NOT TO BE REUSED. WHERE NEW CONDUITS AND OUTLETS ARE TO BE ADDED TO EXISTING WALLS IN FINISHED ROOMS, THEY SHALL BE CONCEALED BY CUTTING AND PATCHING THE WALLS UNLESS OTHERWISE NOTED.
- 3. UTILIZE EXISTING OUTLET BOXES AND RACEWAY SYSTEMS WHEREVER PRACTICAL IN RENOVATION AREAS. WHERE SUCH EXISTING OUTLET BOXES ARE USED, INSTALL NEW WIRING DEVICES, COVERPLATES, AND WIRING. PROVIDE SPECIAL COVERPLATES TO SUIT FIELD CONDITIONS
- 4. REARRANGE EXISTING CONDUITS AND WIRING TO ACCOMMODATE NEW CIRCUIT ARRANGEMENTS INDICATED AND TO MAINTAIN CONTINUITY OF EXISTING CIRCUITS FFEDING DEVICES THAT ARE TO REMAIN.
- 5. CONTRACTOR SHALL BE RESPONSIBLE TO REMOVE AND REINSTALL EXISTING ELECTRICAL EQUIPMENT TO ACCOMMODATE THE WORK OF OR
- STORE REMOVED ELECTRICAL EQUIPMENT SUCH AS LUMINAIRES, POWER AND COMMUNICATION DEVICES, DISTRIBUTION EQUIPMENT CONTROLLERS. ETC. ON JOB SITE FOR REUSE UNTIL SUBSTANTIAL COMPLETION OR PROJECT CLOSEOUT. PROVIDE OWNER RIGHT OF FIRST REFUSAL OF ELECTRICAL EQUIPMENT OTHERWISE REMOVE THOSE FROM SITE AT CONTRACTORS EXPENSE IN ACCORDANCE WITH APPLICABLE LAWS AND REGULATIONS THAT THE OWNER DOES NOT WISH TO SALVAGE.
- EXISTING DEVICE LOCATIONS WERE IDENTIFIED AS COMPLETELY AS POSSIBLE BY A SITE SURVEY AND BY RECORD DOCUMENTS AS AVAILABLE. BE RESPONSIBLE FOR PROPER DEMOLITION AND REWORK OF DEVICES NOT SHOWN ON DRAWINGS BUT NECESSARY FOR PROJECT RENOVATIONS TO CONFORM WITH INTENT OF DOCUMENTS. VISIT THE SITE TO DETERMINE THE EXACT EXTENT OF ELECTRICAL DEMOLITION WORK REQUIRED TO COMPLETE THE NEW CONSTRUCTION. CONTRACTOR SHALL PROVIDE IN BASE BID A NOMINAL AMOUNT OF UNKNOWN BRANCH CIRCUITS. FIXTURES. DEVICES. AND SYSTEMS WIRING BEING REMOVED OR RELOCATED FOR NEW WORK.
- WHERE DEMOLITION OF DEVICE OR EQUIPMENT AND REMOVAL OF CONDUIT OR OTHER ACCESSORY LEAVES OPENINGS IN THE FLOORS. WALLS, OR CEILINGS, SAME SHALL BE PATCHED AND PAINTED TO MATCH EXISTING ADJACENT FINISH. ALL OPENINGS IN FLOORS SHALL BE
- 9. REFER TO DEMOLITION DRAWINGS & NOTES OF ALL CONTRACTS OR TRADES FOR COORDINATION.

RELOCATE DEVICE AS SHOWN, EXTEND WIRING AS REQUIRED, AND MATCH EXISTING.

WIRING AS NEEDED.

- 10. IN AREAS OF DEMOLITION WHERE THE REMOVAL OF ELECTRICAL EQUIPMENT INTERFERES WITH THE NORMAL BUILDING OPERATIONS AND SYSTEMS, CONSULT WITH THE OWNER PRIOR TO PERFORMING ANY DEMOLITION.
- 11. WHERE UNFORESEEN CONDITIONS CONFLICT WITH CONTRACT DOCUMENTS, SUBMIT AN RFI PRIOR TO PROCEEDING WITH ANY WORK.
- 12. WHERE DEVICES ARE SCHEDULED FOR RELOCATION, DISCONNECT AND REMOVE EXISTING DEVICE AND REMOVE ASSOCIATED WIRING.
- 13. WHERE REMOVALS AFFECT EXISTING CIRCUITS SCHEDULED TO REMAIN, MAINTAIN CONTINUITY OF POWER TO THESE CIRCUITS AND EXTEND
- 14. WHERE ANY EMPTY BACKBOXES OR EMPTY JUNCTION BOXES REMAIN DUE TO ELECTRICAL DEMOLITION, PROVIDE COVERPLATE(S) OVER
- 15. WHERE EQUIPMENT CONNECTIONS ARE SHOWN, REMOVE ELECTRICAL CONNECTION, CONDUIT AND WIRE BACK TO POWER SOURCE. DISCONNECT AND REMOVE ASSOCIATED CONTROLLER SERVING EQUIPMENT AND ASSOCIATED CONTROL WIRING.
- 16. DISCONNECT AND REMOVE EXISTING ELECTRIC WORK NOT NECESSARY FOR EXISTING OR NEW INSTALLATION, BUT INTERFERING WITH NEW
- 17. DISCONNECT, REMOVE, RELOCATE, AND RECONNECT ANY AND ALL EXISTING ELECTRIC WORK REQUIRED TO REMAIN, BUT INTERFERING WITH NEW CONSTRUCTION.
- 18. WHERE DEMOLITION NOTES SCHEDULE EXISTING WIRING DEVICES, LIGHTING FIXTURES, SYSTEMS DEVICES, EQUIPMENT CONNECTIONS, ETC. TO BE "DISCONNECTED AND REMOVED IN THE ENTIRETY", THE CONTRACTOR SHALL DISCONNECT AND REMOVE THE EXISTING LIGHTING FIXTURE, WIRING DEVICES, COVERPLATES, BRANCH CIRCUIT WIRING, CONDUIT OR RACEWAY, OUTLET AND/OR SPLICE BOX(ES) ETC. BACK TO EITHER LAST DEVICE SCHEDULED TO REMAIN, OR BACK TO POWER SOURCE.
- 19. PROPERLY DISPOSE OF ALL PCB CONTAINING FLUORESCENT BALLASTS MANUFACTURED PRIOR TO 1980 ACCORDING TO STATE AND FEDERAL REGULATIONS.
- 20. IF ADDITIONAL SUSPECT ASBESTOS-CONTAINING MATERIALS ARE DISCOVERED DURING THE COURSE OF THE WORK, THE CONTRACTOR SHALL IMMEDIATELY STOP WORK AND NOTIFY THE OWNER AND ARCHITECT IMMEDIATELY. THE CONTRACTOR SHALL COOPERATE WITH THE OWNER AND ARCHITECT TO WITH REGARD TO CONDUCTING ADDITIONAL BULK SAMPLING AND ABATEMENT AT THE OWNER'S EXPENSE.
- 21. DISCONNECT AND REMOVE RECEPTACLES, LIGHTING, & ABANDONED DEVICES & RACEWAY. UNLESS NOTED OTHERWISE, LOW VOLTAGE CONTROL WIRING FOR PROCESS EQUIPMENT IS EXCLUDED FROM DEMOLITION SCOPE. 120V OR HIGHER CONNECTIONS TO PROCESS EQUIPMENT IS INCLUDED IN SCOPE. PREPARE EQUIPMENT FOR RECONNECTION WHERE SHOWN.

#### RACEWAY GENERAL NOTES

- CONCEALED AND EXPOSED WET/DAMP/CORROSIVE LOCATIONS: PROVIDE PVC COATED GALVANIZED RIGID STEEL CONDUIT WITH URETHANE INTERIOR COATING. ELECTRICAL CONTINUITY IS MAINTAINED ACROSS ASSEMBLED JOINTS. ALL FITTINGS. ELBOWS. CONDUIT BODIES USED SHALL BE MANUFACTURED TYPE CONSTRUCTED OF PVC COATED GALVANIZED RIGID STEEL. CONDUIT BODIES SHALL BE SUPPLIED WITH RUBBER GASKET AND STAINLESS STEEL HARDWARE.
- 2. SUPPORT RACEWAY USING 304 STAINLESS STEEL STRUT, PIPE CLAMPS, ADJUSTABLE HANGERS, AND CLEVIS HANGERS.
- 3. GROUP RELATED RACEWAY; SUPPORT USING CONDUIT RACK. CONSTRUCT RACK USING 304 STAINLESS STEEL STRUT.
- 4. MINIMUM RACEWAY SIZE: 3/4 INCH UNLESS OTHERWISE SPECIFIED.
- 5. GROUND AND BOND RACEWAY AND BOXES.
- 6. FASTEN RACEWAY AND BOX SUPPORTS TO STRUCTURE. IDENTIFY RACEWAY AND BOXES.
- RACEWAY ROUTING IS SHOWN IN APPROXIMATE LOCATIONS UNLESS DIMENSIONED. ROUTE TO COMPLETE WIRING SYSTEM
- ARRANGE RACEWAY AND BOXES TO MAINTAIN HEADROOM AND PRESENT NEAT APPEARANCE. ARRANGE RACEWAY SUPPORTS TO PREVENT MISALIGNMENT DURING WIRING INSTALLATION.
- 9. RACEWAYS INSTALLED EXPOSED AND INSTALLED ABOVE ACCESSIBLE CEILINGS SHALL BE ROUTED PARALLEL AND PERPENDICULAR TO
- 10. CUT CONDUIT SQUARE USING SAW OR PIPE CUTTER; DE-BURR CUT ENDS.
- 11. INSTALL NO MORE THAN EQUIVALENT OF THREE 90 DEGREE BENDS BETWEEN BOXES. INSTALL CONDUIT BODIES TO MAKE SHARP CHANGES IN DIRECTION. AS AROUND BEAMS.
- 12. AVOID MOISTURE TRAPS; INSTALL JUNCTION BOX WITH DRAIN FITTING AT LOW POINTS IN CONDUIT SYSTEM.
- 13. INSTALL FITTINGS TO ACCOMMODATE EXPANSION AND DEFLECTION WHERE RACEWAY CROSSES CONTROL AND EXPANSION JOINTS.
- 14. FIRESTOP ALL CONDUIT PENETRATIONS INTO CORRIDOR. SEALANT SHALL BE RATED MINIMUM 2 HOURS FIRE BARRIER, SMOKE SEAL, SOUND BARRIER, UL 90G9 LISTED, AND FM APPROVED. ACCEPTABLE PRODUCT 3M FIRE BARRIER SEALANT CP25WB+ OR APPROVED
- 15. INSTALL SUITABLE PULL STRING OR CORD IN EACH EMPTY RACEWAY EXCEPT SLEEVES AND NIPPLES.
- 16. SUPPORT BOXES INDEPENDENTLY OF CONDUIT.
- 17. MAINTAIN CLEARANCE BETWEEN RACEWAY AND PIPING FOR MAINTENANCE PURPOSES.
- 18. ALL FINAL CONDUIT CONNECTIONS TO EQUIPMENT SUBJECT TO VIBRATION SHALL BE LIQUIDTIGHT FLEXIBLE METAL CONDUIT. LENGTH OF FLEXIBLE METAL CONDUIT SHALL NOT EXCEED 3'-0".
- 19. INSTALL IDENTIFYING NAMEPLATES ON ALL NEW EQUIPMENT. NAMEPLATE SHALL BE LAMINATED THREE-LAYER PLASTIC WITH ENGRAVED BLACK LETTERS ON WHITE CONTRASTING BACKGROUND COLOR. LETTERS SHALL BE 1/4" HIGH. THE NAMEPLATE SHALL HAVE A MINIMUM THICKNESS OF 1/8" AND BE ATTACHED TO THE EQUIPMENT WITH SUITABLE ADHESIVE.

#### **ABBREVIATIONS**

MC MECHANICAL CONTRACTOR

MCA MINIMUM CIRCUIT AMPERES

SPD SURGE PROTECTIVE DEVICE

UC UNDERGROUND COMMUNICATION

UNO UNLESS NOTED OTHERWISE

WAP WIRELESS ACCESS POINT

STP SHIELDED TWISTED PAIR

TR TAMPER RESISTANT

MDP MAIN DISTRIBUTION PANELBOARD

MCB MAIN CIRCUIT BREAKER

MIN MINIMIM

MLO MAIN LUGS ONLY

NA NOT APPLICABLE

NTS NOT TO SCALE

TYP TYPICAL

VOLT

W WATT

VA VOLT-AMPERE

WG WIRE GUARD

WP WEATHERPROOF

OC OVER COUNTER

NIC NOT IN CONTRACT

Δ DELTA PHASE AMPERE AFCI ARC-FAULT CIRCUIT INTERRUPTING AF AMP FRAME AFF ABOVE FINISHED FLOOR AFG ABOVE FINISHED GRADE AHJ AUTHORITY HAVING JURISDICTION AIC AMPERE INTERRUPTING CAPACITY ALUMINUM CONDUIT CURRENT TRANSFORMER

EACH ELECTRICAL CONTRACTOR ECB ENCLOSED CIRCUIT BREAKER FF FXHAUST FAN EMT ELECTRICAL METALLIC TUBING

ETR EXISTING TO REMAIN ER EXISTING RELOCATED FXISTING EXP EXPLOSION PROOF GENERAL CONTRACTOR GFI GROUND FAULT INTERRUPTING

KAIC KILOAMPERE INTERRUPTING CURRENT

kva – Kilovolt ampere kw kilowatt

## **WASTEWATER ABBREVIATIONS:**

**BIOCHEMICAL OXYGEN DEMAND** BOD CHEMICAL OXYGEN DEMAND COD DISSOLVED OXYGEN

FOOD TO MASS RATIO MEAN CELL RESIDENCE TIME MCRT MLSS MIXED LIQUOR SUSPENDED SOLIDS MLVSS MIXED LIQUOR VOLITILE SUSPENDED SOLIDS

RETURN ACTIVATED SI UDGE SOLIDS RESIDENCE TIME

SLUDGE VOLUME INDEX TOTAL RESIDUAL CHLORINE TOTAL SUSPENDED SOLIDS WAS WASTE ACTIVATED SLUDGE

#### CONTROL PANEL WIRING AND

#### **IDENTIFICATION OF CONDUCTORS:**

- CONDUCTORS SHALL BE IDENTIFIED AT EACH TERMINATION BY NUMBER, LETTER, COLOR.
- MINIMUM WIRE SIZE: 14AWG FOR POWER, 16AWG FOR CONTROL
- WIRE INSULATION INSIDE CONTROL PANEL: MTW • UNGROUNDED AC AND DC POWER CONDUCTORS - BLACK
- GROUNDED AC CIRCUIT WHITE OR GRAY
- EQUIPMENT GROUNDING CONDUCTOR GREEN OR GREEN WITH YELLOW STRIPE
- UNGROUNDED AC CONTROL CONDUCTORS RED
- UNGROUNDED DC CONTROL CONDUCTORS BLUE
- GROUNDED (CURRENT-CARRYING) DC CIRCUIT CONDUCTOR WHEN THE MAIN SUPPLY CIRCUIT DISCONNECTING MEANS IS IN THE OFF POSITION - WHITE WITH BLUE STRIPE
- UN-GROUNDED AC CONDUCTORS THAT REMAIN ENERGIZED WHEN THE MAIN SUPPLY CIRCUIT DISCONNECTING MEANS IS IN THE OFF POSITION - ORANGE
- (CURRENT-CARRYING) AC CIRCUIT CONDUCTOR THAT REMAIN ENERGIZED WHEN THE MAIN SUPPLY CIRCUIT DISCONNECTING MEANS IS IN THE OFF POSITIOND - WHITE WITH ORANGE STRIPE

#### GROUNDING & BONDING

GROUND ROD GROUND TERMINAL BAR, 18" AFF

GROUNI

ELECTRICAL LEGEND

TGB TELECOMMUNICATIONS GROUNDING BUSBAR, 18" AFF

#### RACEWAY, BOXES, & BUSWAY

———O CONDUIT TURNED UP CONDUIT TURNED DOWN

CONDUIT STUBBED AND BUSHED INTO ACCESSIBLE CEILING CAVITY

MANHOLE  $\bigoplus$ 

HANDHOLE

PULL BOX

——— CAPPED CONDUIT

JUNCTION BOX, WALL MOUNTED JUNCTION BOX, INSTALLED IN CEILING

DISCONNECT SWITCH, UNFUSED DISCONNECT SWITCH, PER EQUIPMENT SCHEDULE, 48" AFF

FUSED DISCONNECT SWITCH, PER EQUIPMENT SCHEDULE, 48" AFF

FUSE (ONE-LINE NOTATION)

) XXXA-3P CIRCUIT BREAKER (ONE-LINE NOTATION)

LOW VOLTAGE INTERRUPTER SWITCH (ONE-LINE NOTATION) TRANSFER SWITCH (ONE-LINE NOTATION)

FRACTIONAL HORSEPOWER MOTOR CONTROLLER, RECESSED 44" AFF OR ABOVE CEILING (MANUAL THERMAL SWITCH)

ELECTRICAL EQUIPMENT

COMBINATION MOTOR CONTROLLER/DISCONNECT, PER EQUIPMENT CONNECTION SCHEDULE, 48" AFF

MOTOR CONTROLLER, PER EQUIPMENT CONNECTION SCHEDULE, 48" AFF

VSD/VFD VARIABLE SPEED DRIVE/VARIABLE FREQUENCY DRIVE Т TRANSFORMER (PLAN NOTATION) w | TRANSFORMER (ONE-LINE NOTATION)  $\sim$ 

CURRENT TRANSFORMER (ONE-LINE NOTATION) METER CABINET/SOCKET (ONE-LINE & PLAN NOTATION)

# **ELECTRICAL DEVICES**

#### GENERAL ELECTRICAL DEVICE NOTATION:

INSTALLATION HEIGHT TO CENTER OF DEVICE IN INCHES (IF OTHER THAN OBSERVED) SOURCE PANELBOARD (IF OTHER THAN NOTED ON SHEET/CIRCUIT BOUNDARY)

NEMA 5-20R SIMPLEX RECEPTACLE, 18" AFF.

NEMA 5-20R DUPLEX RECEPTACLE, 18" AFF NEMA 5-20R DUPLEX RECEPTACLE, INSTALLED FLUSH IN CEILING

NEMA 5-20R GFCI DUPLEX RECEPTACLE, 18" AFF

NEMA CONFIGURATION TO MATCH INDICATED EQUIPMENT OR AS CALLED OUT, 18" AFF

EMERGENCY POWER OFF STATION, RED MUSHROOM PUSHBUTTON STYLE, KEY-RELEASE TYPE, 54" AFF SURGE PROTECTION DEVICE, TOP OF ENCLOSURE 74" AFF

PANEL/CKT # HOME RUN TO PANEL. PANELBOARD & CIRCUIT NUMBER INDICATED

# BRANCH CIRCUIT CONDUCTOR SIZING

#### CIRCUIT NOTATION:

11,13 — CIRCUIT NUMBER(S)

1LNL1 SOURCE PANELBOARD (IF OTHER THAN NOTED ON SHEET/CIRCUIT BOUNDARY) PROVIDE MINIMUM WIRE SIZE AS FOLLOWED UNLESS NOTED OTHERWISE: 20A CB - #12 AWG

> 30A CB - #10 AWG 40A CB - #8 AWG

INCREASE SIZE OF CONDUCTOR FOR DISTANCE AS SHOWN BELOW IN 20A BRANCH CIRCUIT CONDUCTOR SIZING SCHEDULE

## 20A BRANCH CIRCUIT CONDUCTOR SIZING SCHEDULE:

MAXIMUM BRANCH CIRCUIT LENGTH AT 120V (FEET MAXIMUM BRANCH CIRCUIT LENGTH AT 277V (FEET)

INCREASE ALL BRANCH CIRCUIT CONDUCTORS AS INDICATED BASED ON LENGTH OF CIRCUIT, INCLUDING EQUIPMENT GROUNDING

TRANSITION FROM LARGER CONDUCTOR SIZE TO #12 AWG FOR FINAL TERMINATION TO OUTLET DEVICE. PROVIDE JUNCTION BOX WITHIN 10' OF OUTLET AND EXTEND #12 AWG CONDUCTORS TO OUTLET.

3. LENGTHS ARE FROM OVERCURRENT PROTECTIVE DEVICE, ALONG CIRCUIT ROUTING, TO CENTER OF EQUIPMENT LOAD. 4. SCHEDULE ASSUMES 12A LOAD, FOR LOADS HIGHER THAN 12A, INCREASE CONDUCTOR SIZES ACCORDINGLY TO

#### **EQUIPMENT CONNECTIONS**

MOTOR/PUMP CONNECTION, REFER TO EQUIPMENT CONNECTION SCHEDULE

ACCOUNT FOR VOLTAGE DROP PER THE NEC.

SINGLE POINT EQUIPMENT CONNECTION, REFER TO EQUIPMENT CONNECTION SCHEDULE

#### GENERAL LINEWORK DESCRIPTIONS & DRAWINGS NOTES


EXISTING WORK / FUTURE PROVISIONS / NOT IN CONTRACT WORK WORK TO BE REMOVED (DEMO PLANS) - DEVICE AND ALL ASSOCIATED ELECTRICAL WORK SHALL BE REMOVED BACK TO THE SOURCE, UNLESS NOTED OTHERWISE / UNDERFLOOR CONDUIT (NEW PLANS) WIRE AND / OR CONDUIT RUN CONTINUED ON REFERENCED DETAIL

DRAWING KEYED NOTES

SYMBOL WITH TAIL INDICATES WALL INSTALLATION, HEIGHT AS INDICATED

#### **PANELBOARDS**

## PANELBOARD ONE-LINE NOTATION:

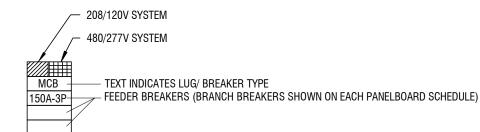

#### PANELBOARD - FLOOR PLAN NOTATION:

BRANCH CIRCUIT PANELBOARD, 480Y/277V, 3 $\varphi$ , 4W BRANCH CIRCUIT PANELBOARD, 208Y/120V, 3o, 4W

#### LIGHTING CONTROL DEVICES

NOTE: LIGHTING CONTROL DEVICES SHOW FUNCTIONAL REQUIREMENTS, NOT ALL DEVICES NEEDED FOR A FULLY FUNCTIONING SYSTEM, DEPENDING ON CONFIGURATION AND MANUFACTURER, DEVICES SUCH AS POWER PACKS, RELAYS. SINGLE/DOUBLE/TRIPLE OUTPUT ROOM CONTROLLERS MAY BE NECESSARY. REFER TO DETAILS & SPECIFICATIONS.

SINGLE POLE TOGGLE SWITCH, 44" AFF. LOWER CASE LETTER INDICATES CONTROL 3-WAY TOGGLE SWITCH, 44" AFF. LOWER CASE LETTER INDICATES CONTROL

4-WAY TOGGLE SWITCH, 44" AFF. LOWER CASE LETTER INDICATES CONTROL

MOMENTARY CONTACT SWITCH, 44" AFF

#### LIGHTING GENERAL LUMINAIRE

#### **NOTATION:**

SOURCE PANELBOARD(IF OTHER THAN NOTED ON SHEET/CIDCUIT POLINIDADY) NOTED ON SHEET/CIRCUIT BOUNDARY) - LUMINAIRE TYPE - REFER TO LUMINAIRE SCHEDULE POLE TYPE - REFER TO SITE LIGHTING POLE → P-A → SCHEDULE/LUMINAIRE SCHEDULE DOTS INDICATE PENDANT HUNG ARROW INDICATES AIMING DIRECTION (WHERE APPLICABLE) TAIL INDICATES WALL MOUNT STYLE LUMINAIRE

GEOMETRIC SHAPE LUMINAIRE, RECESSED OR SURFACE MOUNTED PER LUMINAIRE SCHEDULE ILLUMINATED EXIT SIGN - SINGLE/DOUBLE FACE AS SHOWN - DIRECTION OF ARROWS AS INDICATED -CEILING, SURFACE WALL, OR PERPENDICULAR WALL AS SHOWN

SELF CONTAINED BATTERY LIGHTING UNIT REMOTE LIGHTING LAMP HEAD(S) - CONNECT TO REMOTE BATTERY PACK IN INTERIOR ACCESSIBLE CEILING SPACE

# LUMINAIRE(S) AND POLE ASSEMBLY

SECTIONAL AREA 0.0387 SQ. IN.

4-20mA SIGNALS: #8760 - 2 CONDUCTOR 18AWG (16X30) TINNED COPPER, PE INSULATION, OVERALL BELDFOIL® SHIELD, PVC OUTER JACKET, CM, FOR USE WITH LOW VOLTAGE ANALOG SIGNALS (4-20MA, 0-10V, ...), OVERALL DIAMETER 0.222 INCHES, CROSS

BELDEN CABLE LEGEND:

#8770 - 3 CONDUCTOR 18AWG (16X30) TINNED COPPER, PE INSULATION, OVERALL BELDFOIL® SHIELD, PVC OUTER JACKET, CM, FOR USE WITH LOW VOLTAGE ANALOG SIGNALS (4-20MA, 0-10V, RTD, ...), OVERALL DIAMETER 0.246 INCHES, CROSS SECTIONAL AREA 0.0475 SQ. IN.

#3092A - COAX RG-6 18 AWG (SOLID) BARE COPPER COVERED STEEL, FOAM PE INSULATION, OVERALL DUOBOND® II+ALUMINUM,BRAID(60%)+DUOFOIL®+ALUMINUM BRAID(40%) SHIELD, PVC OUTER JACKET, CMR, OVERALL DIAMETER 0.298 INCHES, CROSS SECTIONAL AREA 0.0697 SQ. IN.

#3105A - 120Ω, 1 PAIR 22AWG (7X30) TINNED COPPER, DATALENE INSULATION, OVERALL FOIL + 65% COPPER BRAID, PVC JACKET, CM, PLTC. SUN RESISTANT AND OIL RESISTANT, OVERALL DIAMETER 0.294 INCHES, CROSS SECTIONAL AREA 0.0679

#7958A - CAT. 5E, 4 BONDED-PAIR 24AWG SOLID BARE COPPER, PO INSULATION, OVERALL BELDFOIL SHIELD, PVC OUTER

JACKET, CMR 600V, AWM 21047, OVERALL DIAMETER 0.275 INCHES, CROSS SECTIONAL AREA 0.0594 SQ. IN.

FOR CONTROL SIGNAL CABLES, GROUND THE SHIELD AT ONE END OF THE CABLE ONLY. TAPE BACK SHIELD AT OPPOSITE END.

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labellapc.com



EXP: 2027/09/30

CERTIFICATE OF AUTHORIZATION NUMBER: PROFESSIONAL ENGINEERING: 0021272 LAND SURVEYING: 0021271 GEOLOGICAL: 0021659

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**Borough of Elkland Wastewater Treatment Facilities** 115 Ellison Road Elkland, PA 16920

DESCRIPTION:

115 Ellison Road

Elkland, PA 16920

PROJECT NUMBER: 2242861 DRAWN BY: BTM REVIEWED BY: TBZ ISSUED FOR: BID

NO: DATE:

**ELECTRICAL NOTES, SYMBOL** 


LEGEND, & ABBREVIATIONS

**NOVEMBER 2025** 

DRAWING NUMBER:

DATE:

DRAWING NAME:

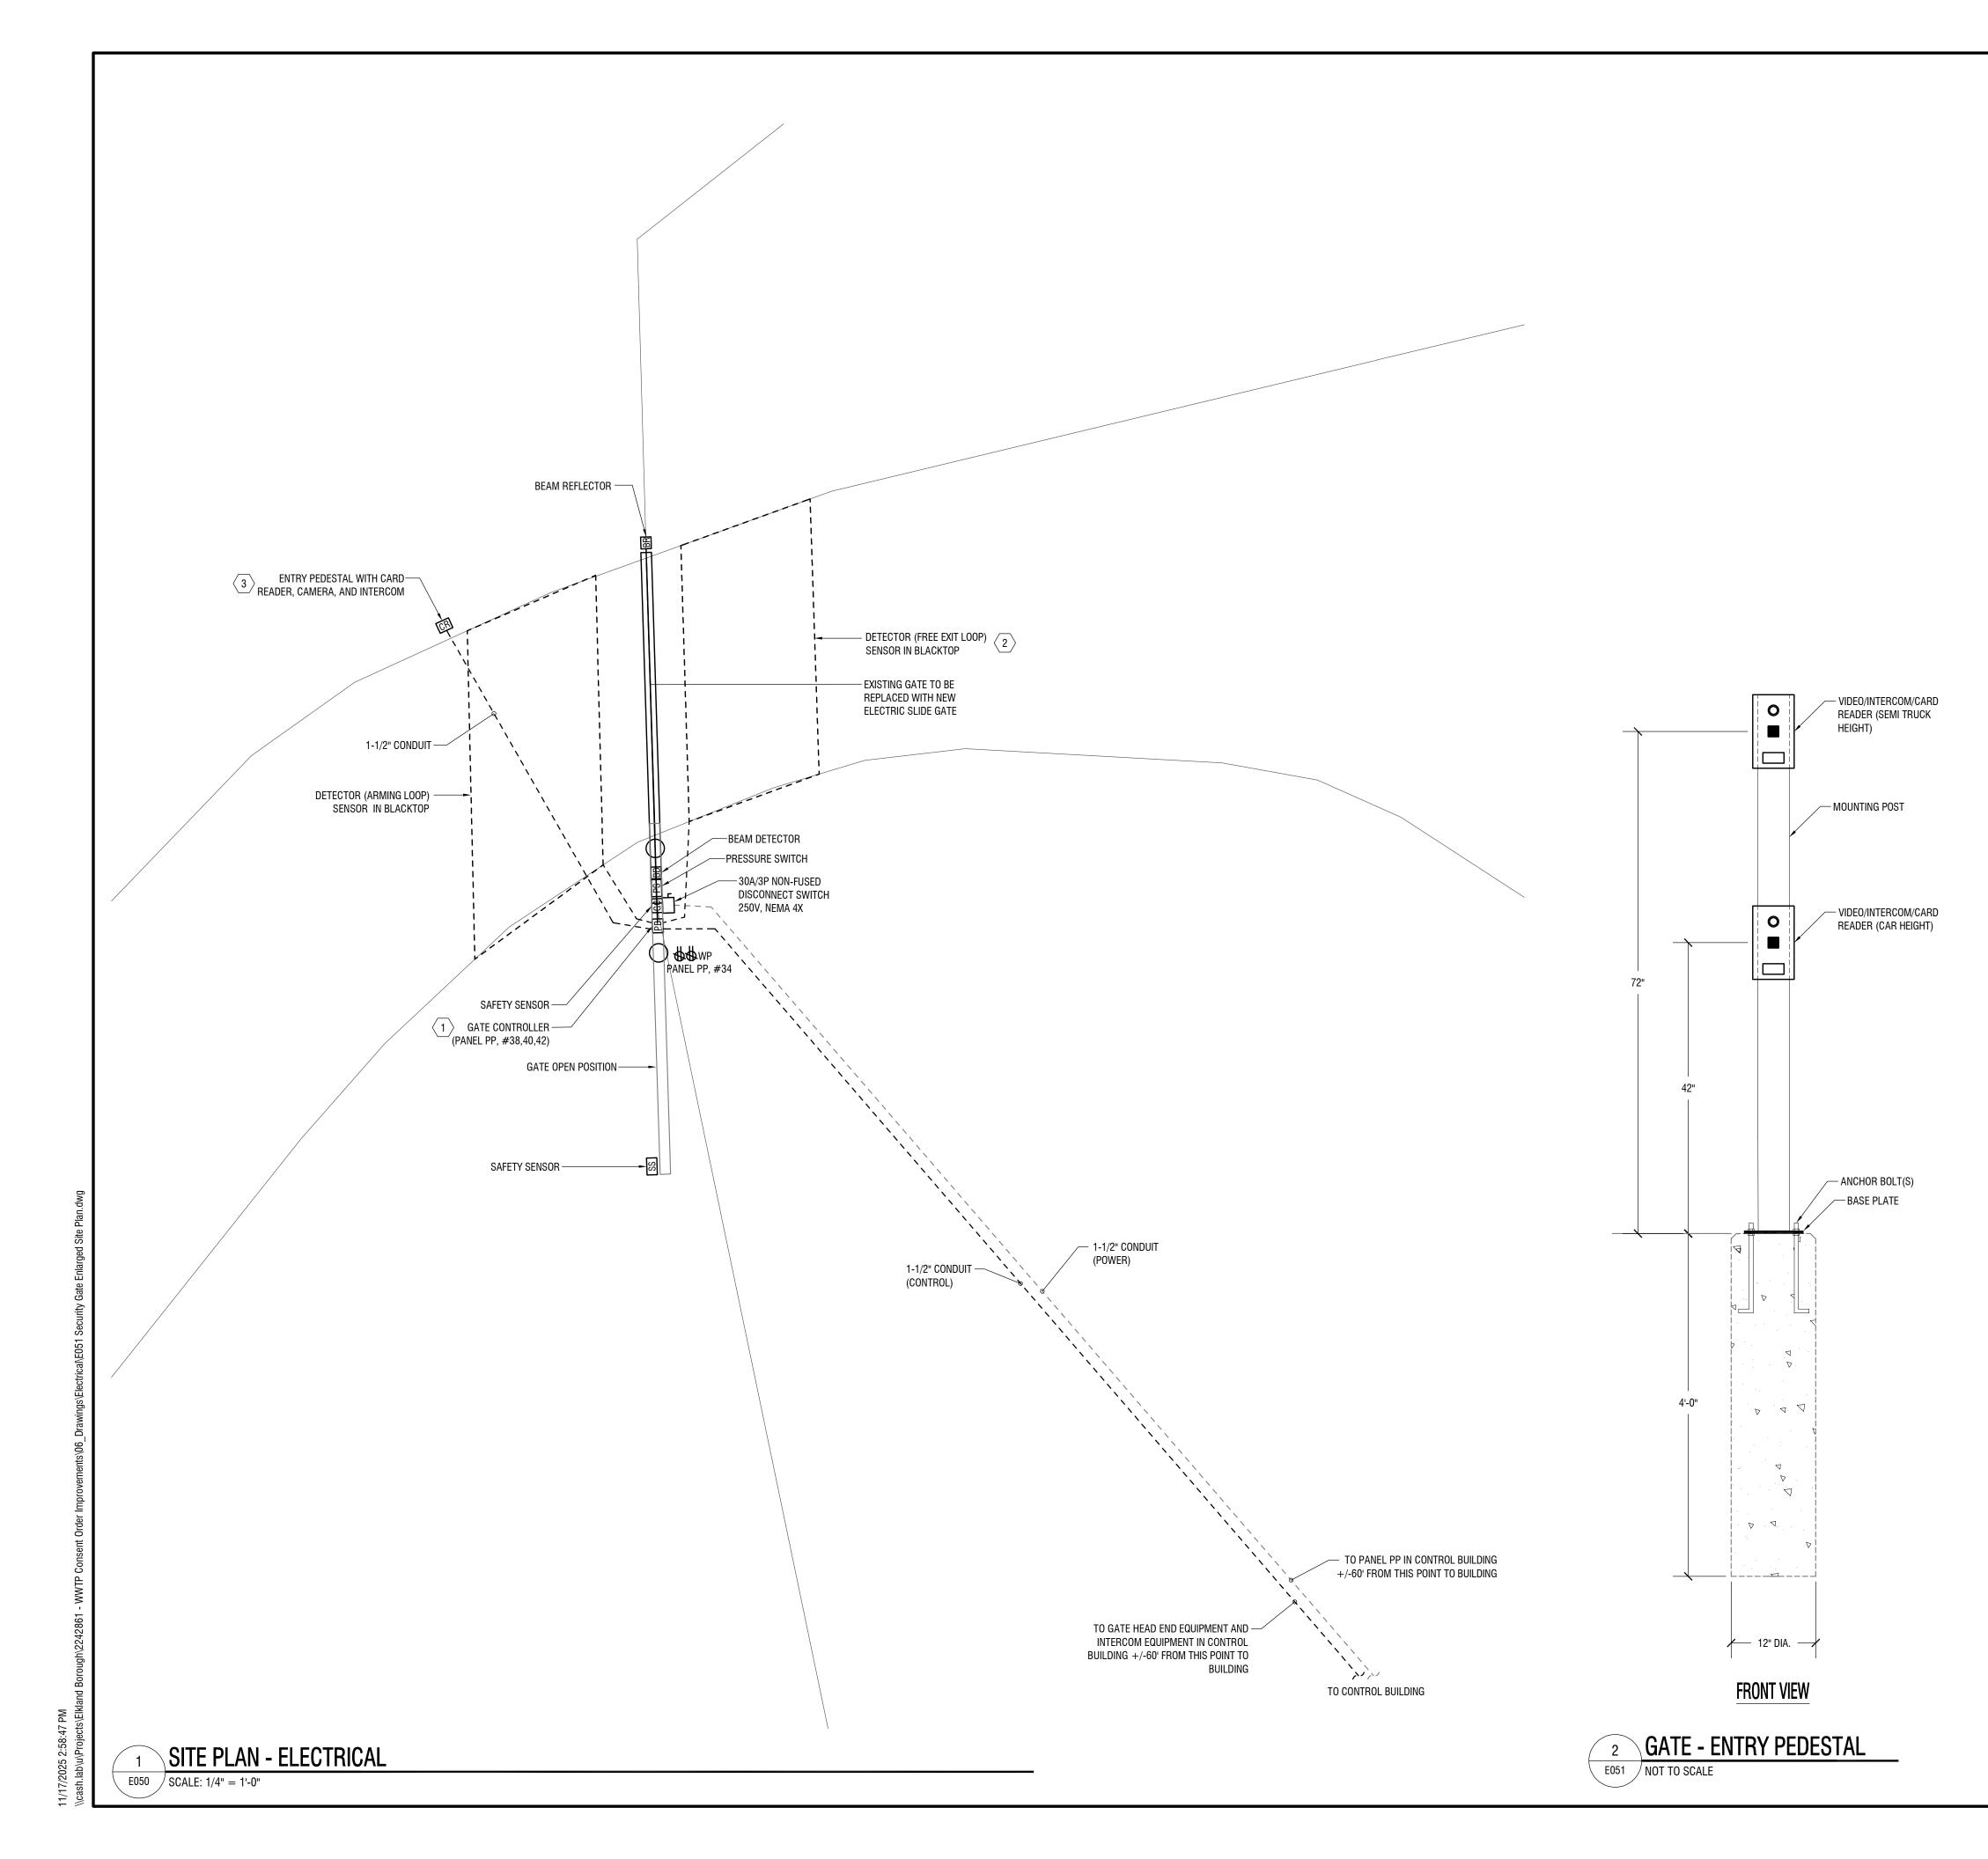

#### GATE NOTES:

- A. REFER TO GATE CONTROLLER'S MANUFACTURING INSTALLATION DRAWINGS AND INSTRUCTIONS FOR INSTALLATION DETAILS.
- B. PROVIDE INSTRUCTIONAL AND PRECAUTIONARY SIGNAGE AT AUTOMATIC SLIDE GATE.
- C. THE AUTOMATIC SLIDE GATE OPERATOR SHALL BE INSTALLED AND SERVICED BY A TRAINED GATE SYSTEMS TECHNICIAN ONLY.
- D. THE AUTOMATIC SLIDE GATE IS FOR USE ON VEHICULAR TRAFFIC ONLY AND IS NOT INTENDED FOR PEDESTRIAN TRAFFIC.
- E. UPON COMPLETION OF THE AUTOMATIC SLIDING GATE INSTALLATION, TEST THE FUNCTIONALITY OF THE GATE CONTROLLER AND SAFETY DEVICES FOR CORRECT FUNCTIONALITY. MAKE CORRECTIONS TO ANY ITEMS DEEMED NOT FUNCTIONING PROPERLY AND RETEST.
- F. INTERIOR SENSOR LOOP (FREE EXIT LOOP) SHALL OPEN GATE FOR VEHICLES LEAVING THE
- G. EXTERIOR SENSOR LOOP (ARMING LOOP). THE VEHICLE MUST DRIVE ONTO THE ARMING LOOP BEFORE USING AN ACCESS DEVICE SUCH AS A CARD READER.

#### UL325 ENTRAPMENT PROTECTION REQUIREMENTS:

- A MINIMUM OF TWO INDEPENDENT\* MONITORED ENTRAPMENT PROTECTION DEVICES ARE REQUIRED TO BE INSTALLED AT EACH ENTRAPMENT ZONE.
- IT IS THE RESPONSIBILITY OF THE INSTALLER TO INSTALL EXTERNAL MONITORED ENTRAPMENT PROTECTION DEVICES IN EACH ENTRAPMENT ZONE.
- THE VEHICULAR SLIDE GATE OPERATOR WILL OPERATE ONLY AFTER INSTALLATION OF A
  MINIMUM OF TWO INDEPENDENT\* MONITORED ENTRAPMENT PROTECTION DEVICES IN EACH
  DIRECTION, TWO IN THE OPEN DIRECTION AND TWO IN THE CLOSE DIRECTION.
- ENTRAPMENT PROTECTION DEVICE TYPES INCLUDE INHERENT (BUILT INTO THE OPERATOR),
   MONITORED EXTERNAL PHOTOELECTRIC SENSORS AND MONITORED EXTERNAL EDGE
   SENSORS
- THE OPERATOR IS PROVIDED WITH AN INHERENT ENTRAPMENT PROTECTION DEVICE BUILT INTO THE OPERATOR THAT SERVES AS ONE OF THE TWO INDEPENDENT DEVICES.

\* INDEPENDENT - THE SAME TYPE OF DEVICE SHALL NOT BE USED FOR BOTH ENTRAPMENT PROTECTION DEVICES.

#### REFERENCE DRAWINGS:

C001 GENERAL PLAN

E101 CONTROL BUILDING - ELECTRICAL

#### **GENERAL NOTES:**

- A. ALL EXTERIOR ABOVE GRADE CONDUIT SHALL BE PVC COATED RIGID GALVANIZED
- B. ALL EXTERIOR BELOW GRADE CONDUIT SHALL BE SCHEDULE 40 PVC ENCASED IN CONCRETE

#### KEYED NOTES # :

- 1. INSTALL ALL INTERRELATED GATE WIRING PER MANUFACTURERS INSTALLATION INSTRUCTIONS.
- 2. AUTOMATIC GATE TO OPEN TO EXIT UPON SENSING VEHICLE ON INTERIOR SENSOR
- CONFIRM EXACT LOCATION OF ENTRY PEDESTAL WITH OPERATIONS.



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Wastewater Treatment
Facilities
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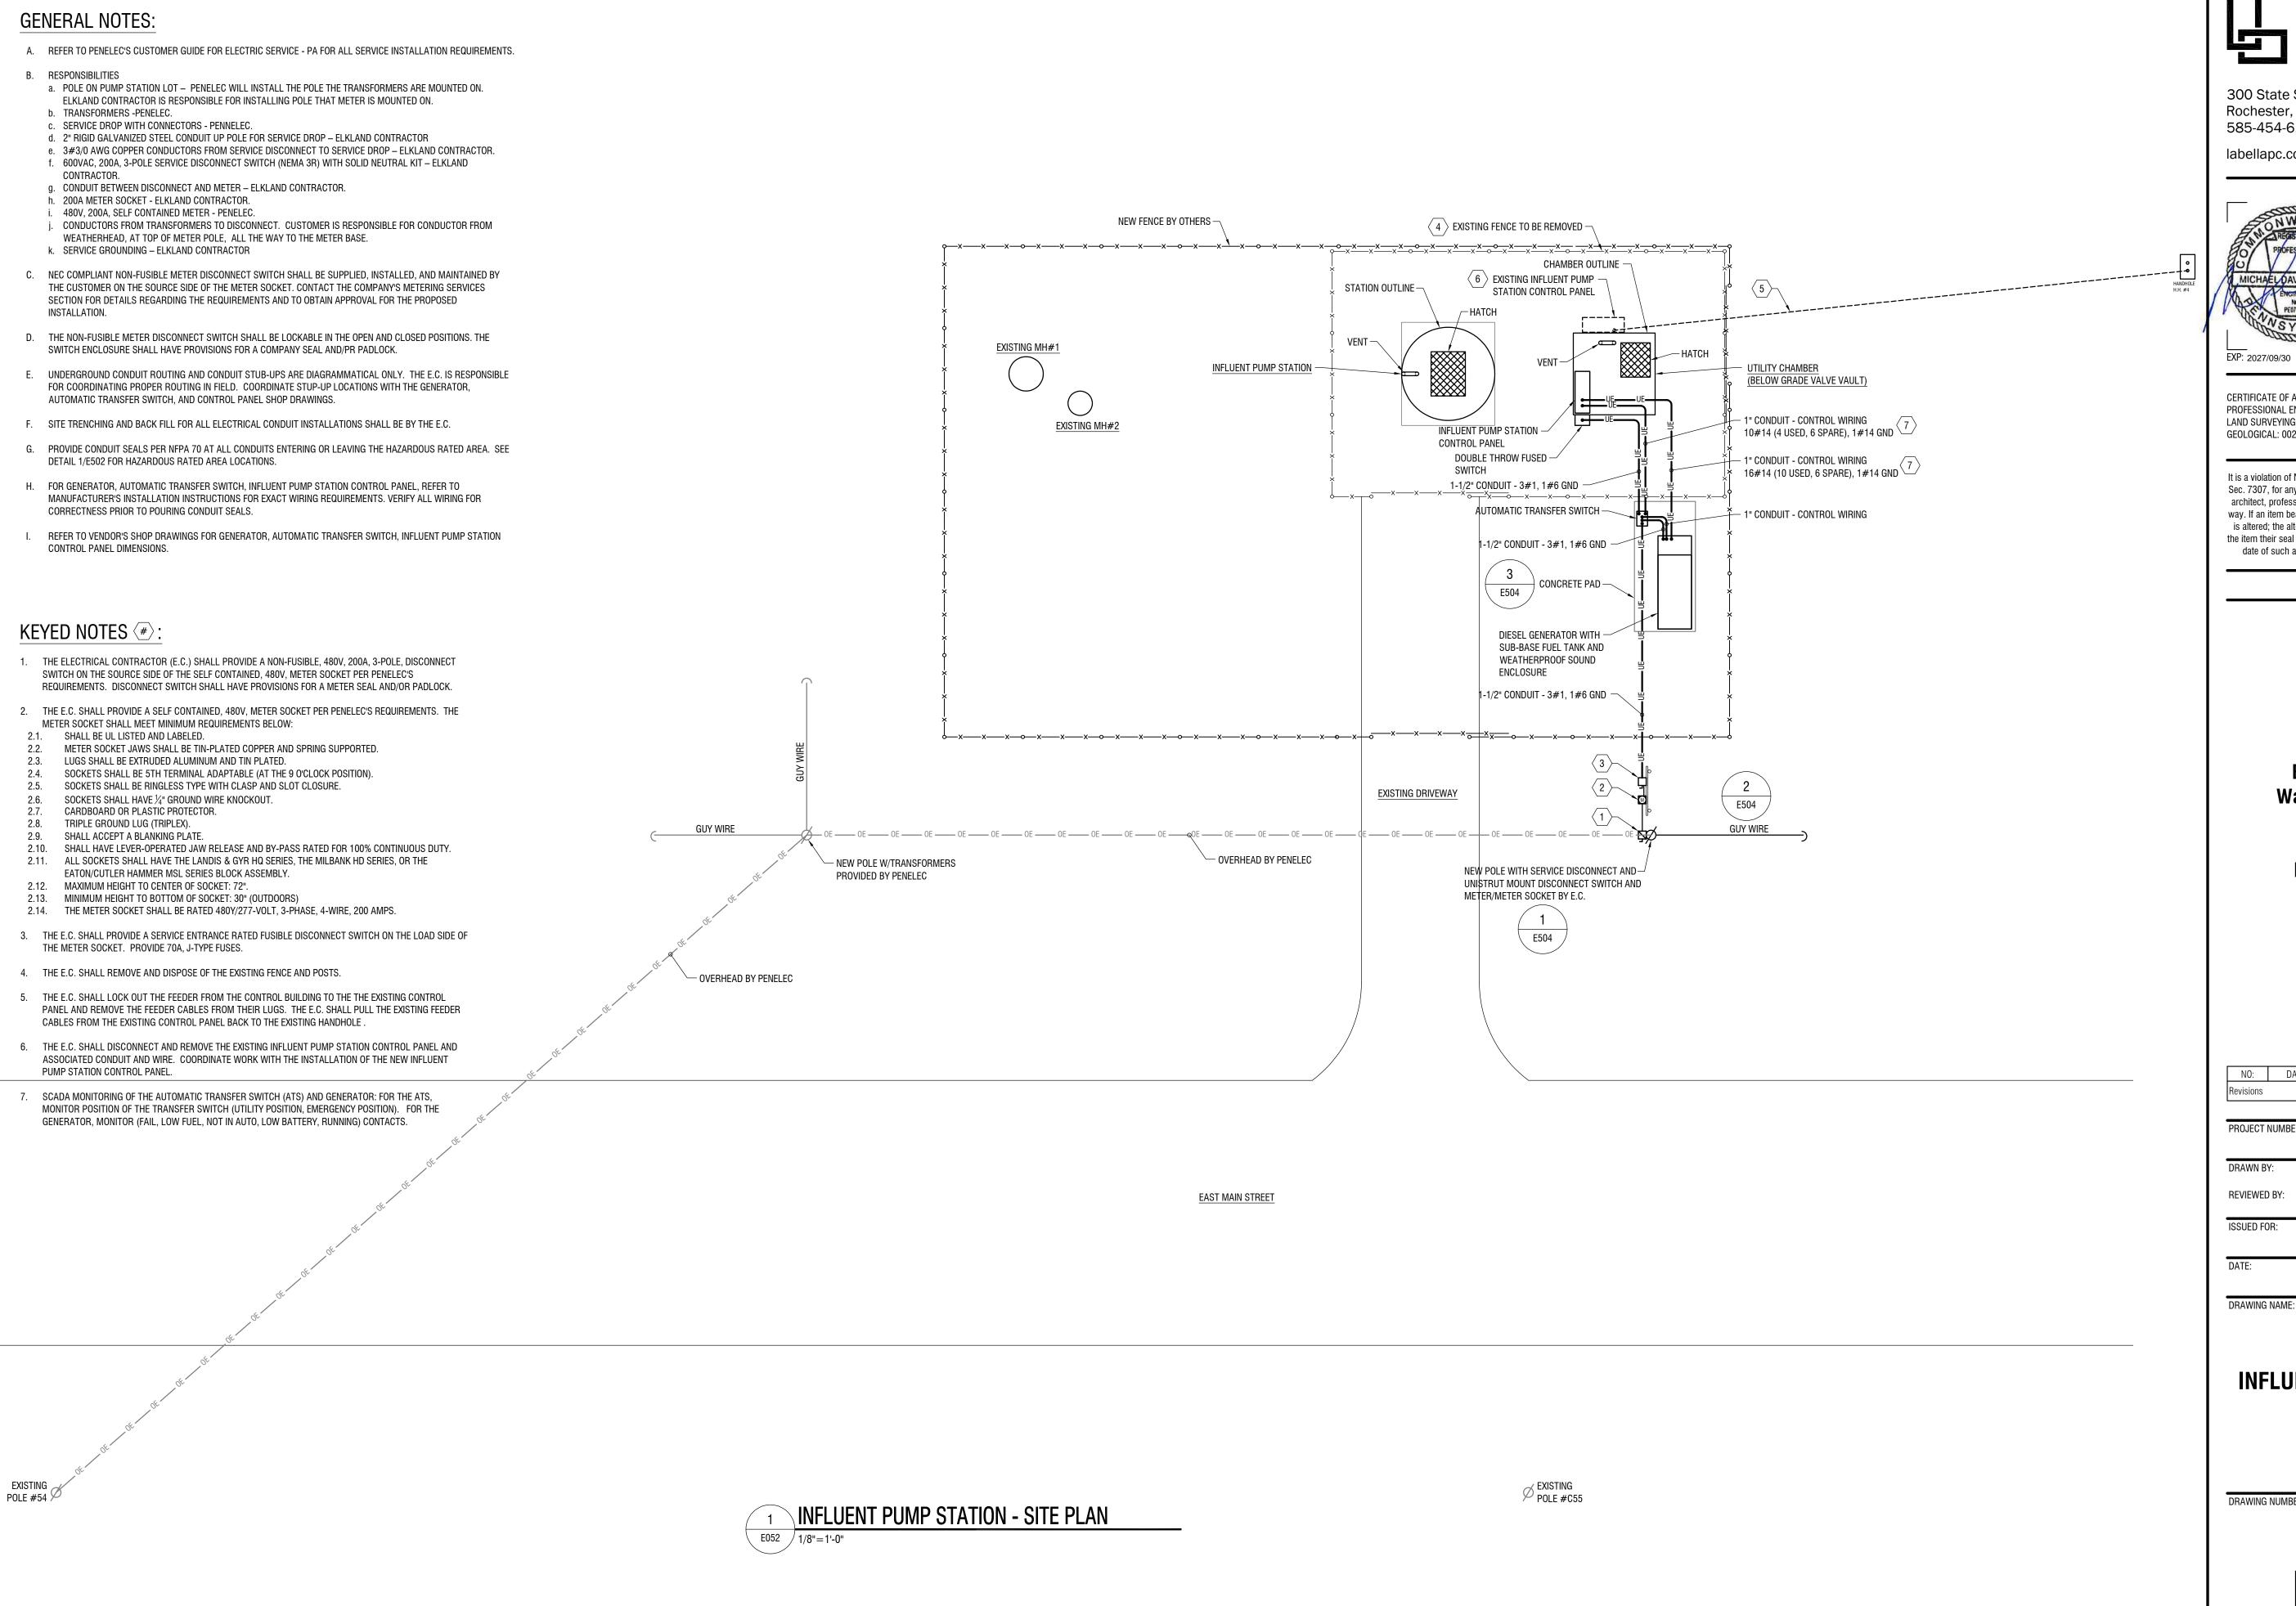
115 Ellison Road Elkland, PA 16920

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DATE:		NOVEMBER 2025	

DRAWING NAME:

SECURITY GATE ENLARGED SITE PLAN -ELECTRICAL

DRAWING NUMBER:



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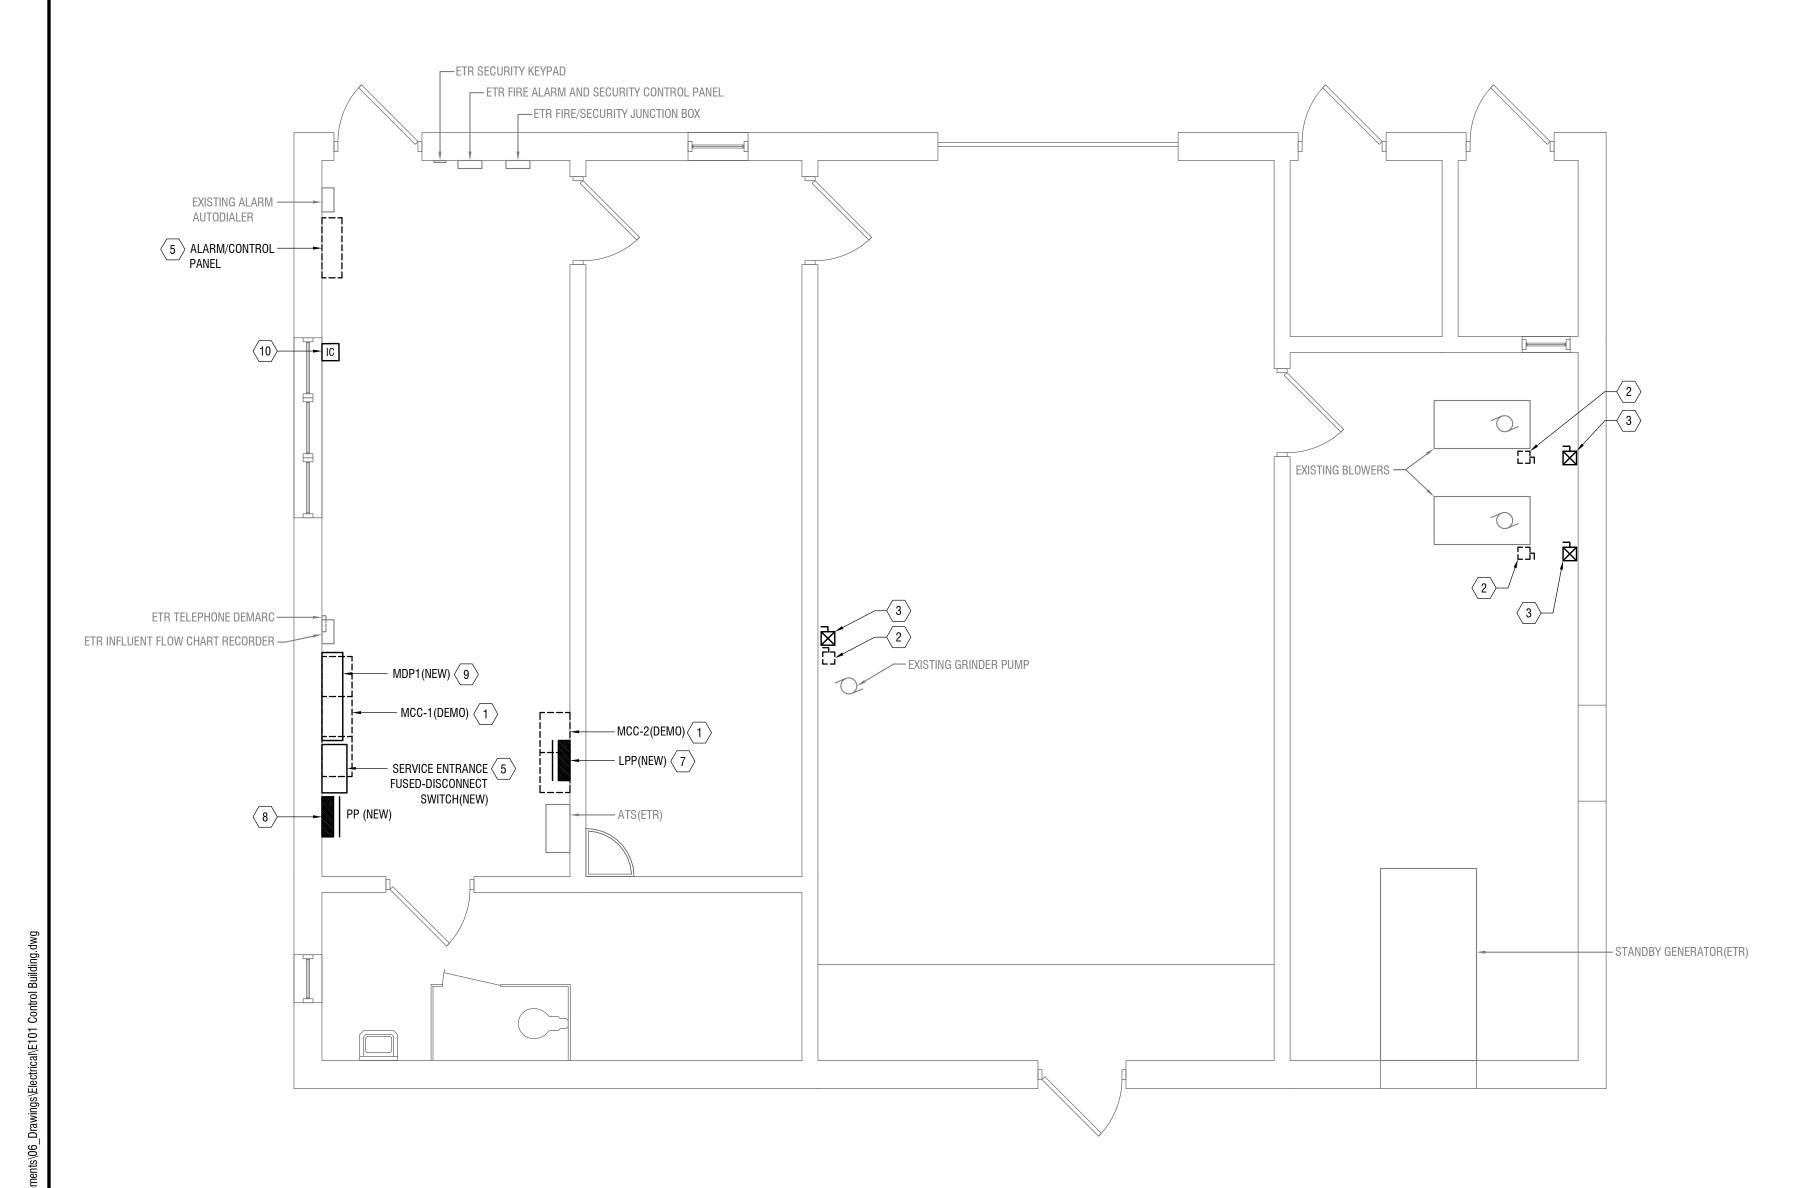
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REVIEWED	BY:	TBZ
ISSUED FO	R:	BID
DATE:		NOVEMBER 2025

**INFLUENT PUMP STATION -SITE PLAN** 

DRAWING NUMBER:



1 CONTROL BUILDING - ELECTRICAL

E101 SCALE: 1/4" = 1

#### **GENERAL NOTES:**

- A. COORDINATE AND SCHEDULE ELECTRICAL AND OTHER UTILITY OUTAGES WITH OWNER.
- B. PROVIDE AND MAINTAIN LIGHTING FOR CONSTRUCTION OPERATIONS TO ACHIEVE MINIMUM LIGHTING LEVEL OF 5 FOOT CANDLES.
- C. CONTRACTOR SHALL DISPOSE OF ALL MATERIAL NOTED FOR REMOVAL. USE SOURCE SEPARATION METHOD OR COMINGLING METHOD SUITABLE TO SORTING AND PROCESSING METHOD OF SELECTED RECYCLING CENTER. DISPOSE NONRECYCLABLE TRASH SEPARATELY INTO LANDFILL.
- D. COORDINATE SCHEDULING OF WORK OF VARIOUS TRADES OF SPECIFICATIONS TO ENSURE EFFICIENT AND ORDERLY SEQUENCE OF INSTALLATION OF INTERDEPENDENT CONSTRUCTION ELEMENTS.
- E. COORDINATE SPACE REQUIREMENTS AND INSTALLATION OF MECHANICAL AND ELECTRICAL WORK INDICATED DIAGRAMMATICALLY ON DRAWINGS. FOLLOW ROUTING SHOWN FOR PIPES, DUCTS, AND CONDUIT, AS CLOSELY AS PRACTICABLE. IN FINISHED AREAS, CONCEAL PIPES, DUCTS, AND WIRING WITHIN CONSTRUCTION.
- F. EXECUTE CUTTING, FITTING, AND PATCHING TO COMPLETE WORK, AND TO PROVIDE OPENINGS IN ELEMENTS OF WORK FOR PENETRATIONS OF MECHANICAL AND ELECTRICAL WORK. ARRANGE OPENINGS TO FIT SEVERAL PARTS TOGETHER, AND TO INTEGRATE WITH OTHER WORK. FIT WORK TIGHT TO ADJACENT ELEMENTS. MAINTAIN INTEGRITY OF WALL, CEILING, OR FLOOR CONSTRUCTION; COMPLETELY SEAL VOIDS. FIT WORK TIGHT TO PIPES, SLEEVES, DUCTS, CONDUIT, AND OTHER PENETRATIONS THROUGH SURFACES. REFINISH SURFACES TO MATCH ADJACENT FINISHES.
- G. AT PENETRATIONS OF FIRE-RATED WALLS, PARTITIONS, CEILING, OR FLOOR CONSTRUCTION, COMPLETELY SEAL VOIDS WITH FIRE-RATED MATERIAL TO FULL THICKNESS OF PENETRATED ELEMENT. CONDUIT PENETRATIONS SHALL BE SEALED WITH SEALANT RATED MINIMUM 2 HOURS FIRE BARRIER, SMOKE SEAL, SOUND BARRIER, UL 90G9 LISTED, AND FM APPROVED. ACCEPTABLE PRODUCT 3M FIRE BARRIER SEALANT CP25WB+ OR APPROVED EQUAL.
- H. INSTALL IDENTIFYING NAMEPLATES ON ALL NEW EQUIPMENT. NAMEPLATE SHALL BE LAMINATED THREE-LAYER PLASTIC WITH ENGRAVED BLACK LETTERS ON WHITE CONTRASTING BACKGROUND COLOR. LETTERS SHALL BE 1/4" HIGH. THE NAMEPLATE SHALL HAVE A MINIMUM THICKNESS OF 1/8" AND BE ATTACHED TO THE EQUIPMENT WITH SUITABLE ADHESIVE.
- I. START UP SYSTEMS: ENSURE EACH PIECE OF EQUIPMENT OR SYSTEM IS READY FOR OPERATION. EXECUTE START-UP UNDER SUPERVISION OF RESPONSIBLE PERSONS IN ACCORDANCE WITH MANUFACTURER'S INSTRUCTIONS. SUBMIT WRITTEN REPORT STATING EQUIPMENT OR SYSTEM HAS BEEN PROPERLY INSTALLED AND IS FUNCTIONING CORRECTLY.
- J. FINAL CLEANING: CLEAN INTERIOR AND EXTERIOR GLASS AND SURFACES EXPOSED TO VIEW; REMOVE TEMPORARY LABELS, STAINS, AND FOREIGN SUBSTANCES; POLISH TRANSPARENT AND GLOSSY SURFACES, AND VACUUM CARPETED AND SOFT SURFACES. CLEAN EQUIPMENT AND FIXTURES TO SANITARY CONDITION WITH APPROPRIATE CLEANING MATERIALS. REPLACE FILTERS OF OPERATING EQUIPMENT. REMOVE WASTE AND SURPLUS MATERIALS, RUBBISH, AND CONSTRUCTION FACILITIES FROM SITE.

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DATE:		NOVEMBER 2025

# CONTROL BUILDING -ELECTRICAL

DRAWING NUMBER:

DRAWING NAME:

E101


#### KEYED NOTES (#):

- 1. DISCONNECT AND REMOVE EXISTING MOTOR CONTROL CENTER IN ITS ENTIRETY. RELOCATE ALL CIRCUITS TO NEW PANEL MDP1 UNLESS NOTED OTHERWISE.
- 2. DISCONNECT AND REMOVE THE EXISTING DISCONNECT SWITCH AND FEEDER FROM MCC. SEE DRAWING ED700 FOR DETAILS.
- 3. PROVIDE A NEW COMBINATION STARTER FOR THE EXISTING MOTOR. SEE DRAWING E700 FOR DETAILS.
- 4. DISCONNECT AND REMOVE EXISTING MOTOR CONTROL CENTER IN ITS ENTIRETY.
- 5. PROVIDE A NEW SERVICE ENTRANCE RATED FUSED DISCONNECT. SEE DRAWING E700 FOR DETAILS.
- 6. DISCONNECT AND REMOVE THE ALARM/CONTROL PANEL. THE SCADA INTEGRATOR SHALL PROVIDE A NEW COMPUTER GRAPHIC TO REPLACE THE PANEL'S ALARM AND CONTROL FUNCTIONS.
- 7. PROVIDE A NEW 42 CIRCUIT PANELBOARD. SEE DRAWING E501 FOR PANELBOARD SCHEDULE.
- 8. REPLACE PANEL PP WITH A NEW 42 CIRCUIT PANELBOARD. SEE DRAWING E501 FOR PANELBOARD SCHEDULE.
- 9. PROVIDE A NEW MAIN DISTRIBUTION PANEL. SEE DRAWING E700 FOR DETAILS.
- 10. PROVIDE INTERCOM PHONE WITH ALL ASSOCIATED CONDUIT WIRE REQUIRE IN THE MANUFACTURER'S INSTALLATION INSTRUCTIONS. PROVIDE ALL ASSOCIATED EQUIPMENT FOR A COMPLETE SYSTEM INCLUDING POE SWITCH, COMPUTER, ETC. PROVIDE 120V RECEPTACLES AS REQUIRED FOR SYSTEM. COORDINATE EXACT LOCATION OF EQUIPMENT WITH OWNER.

#### EXISTING BLOWER BUILDING - ELECTRICAL E102 SCALE: 1/4" = 1'-0"

## KEYED NOTES (#):

- 1. VERIFY THE WIRING OF THE EXISTING EXHAUST FAN AND MAKE CORRECTIONS IF NECESSARY SUCH THAT THE HAZARDOUS GAS DETECTION AND LIGHT SWITCH OPERATE THE EXHAUST FAN.
- 2. THE BLOWER(S) SHALL BE REPLACED WITH NEW. THE EXISTING DISCONNECT SWITCHES SHALL BE REUSED.
- 3. THE EXISTING BREAKER(S), STARTER(S), AND OVERLOAD(S) IN THE BLOWER CONTROL PANEL FEEDING THE BLOWER MOTORS SHALL BE REMOVED BY THE SCADA INTEGRATOR. THE POWER WIRING TO THE STARTER(S) SHALL BE REMOVED BY THE ELECTRICAL CONTRACTOR. THE SCADA INTEGRATOR SHALL REFURBISH THE PLC AND CONTROLS AS REQUIRED. THE ENCLOSURE SHALL BE REUSED. SEE ED700 AND E700 FOR MORE DETAIL.

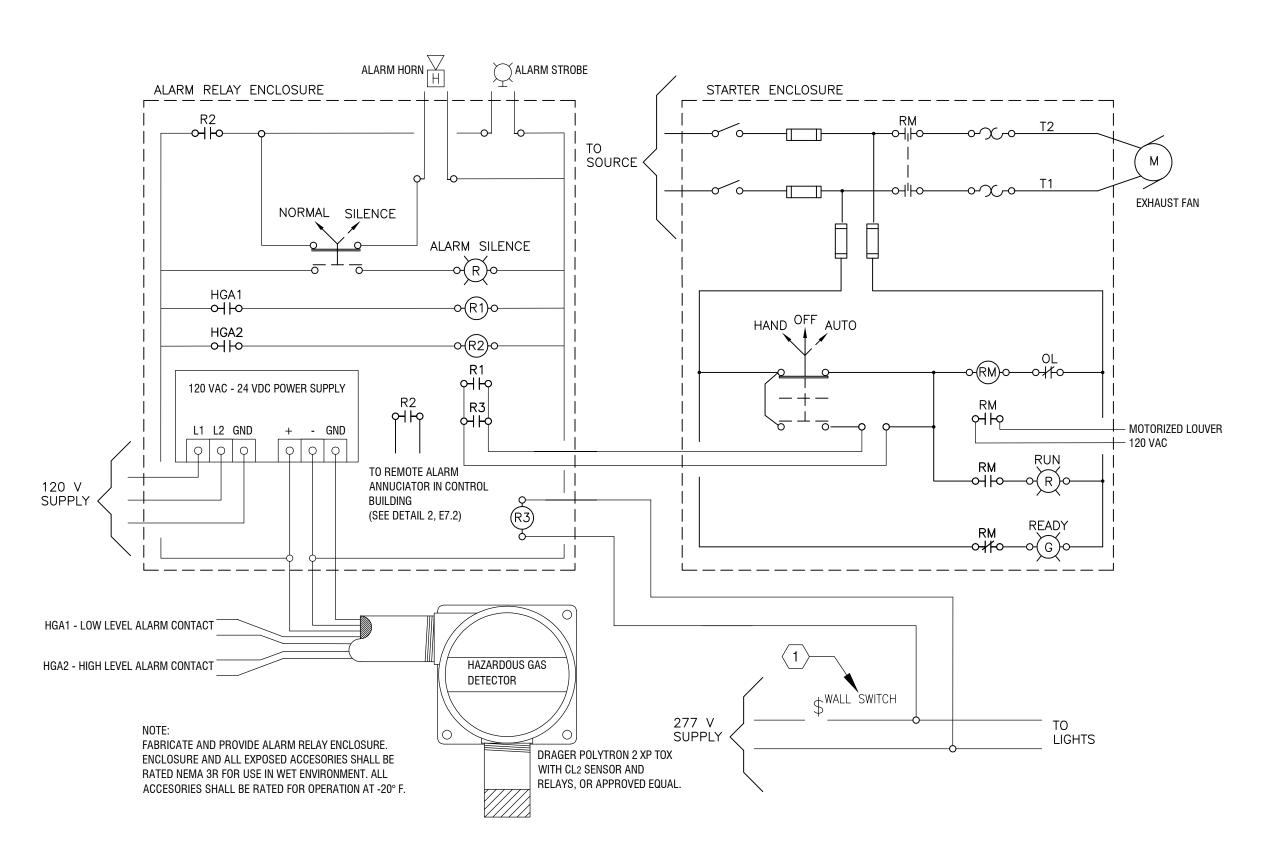

2 EXISTING CHEMICAL STORAGE VENTILATION CONTROL SCHEMATIC
E102 N.T.S.

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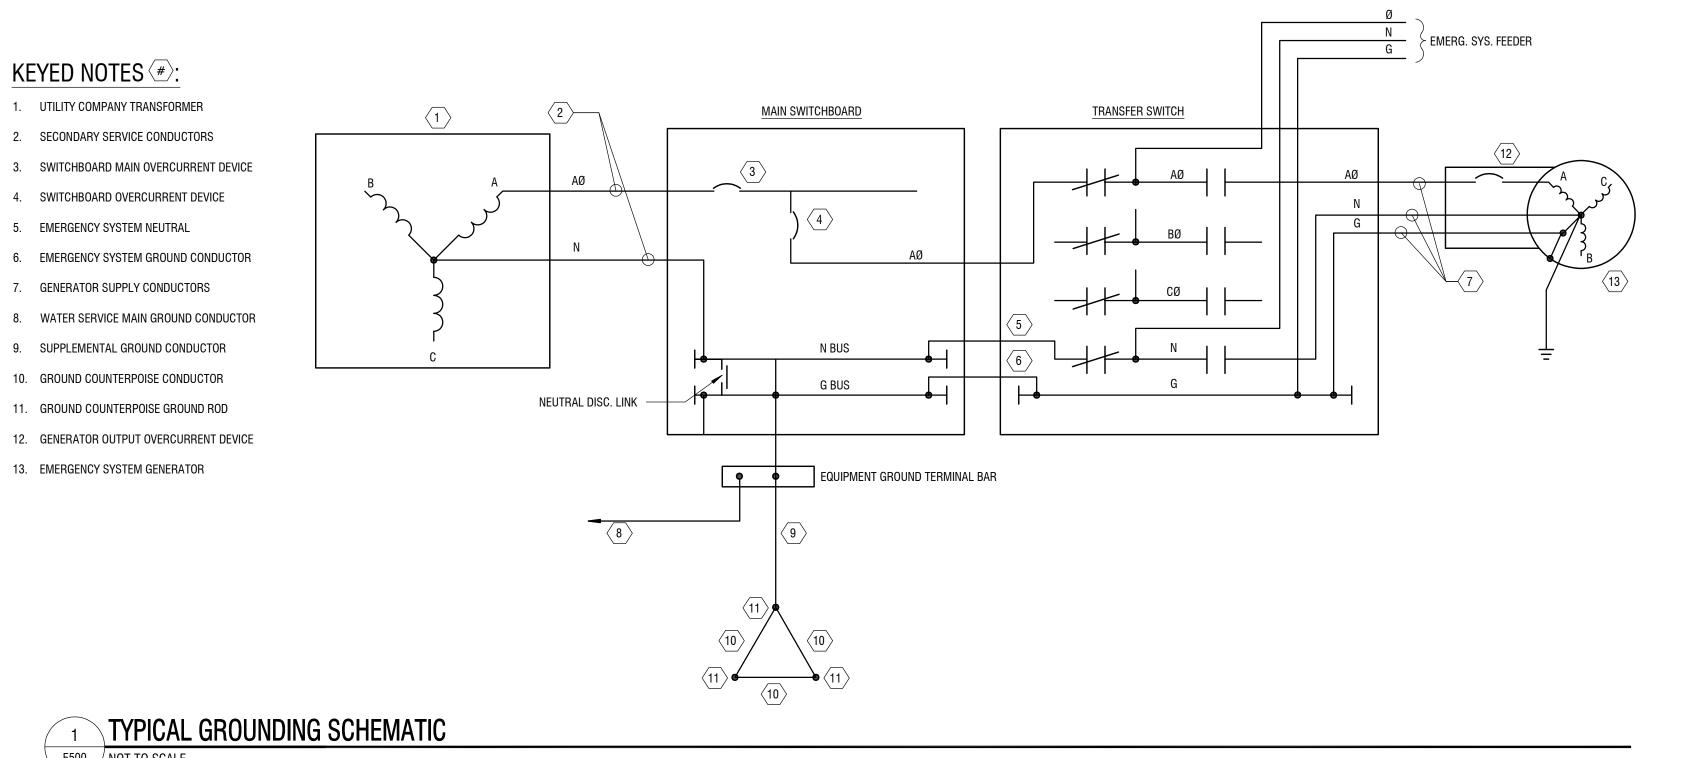
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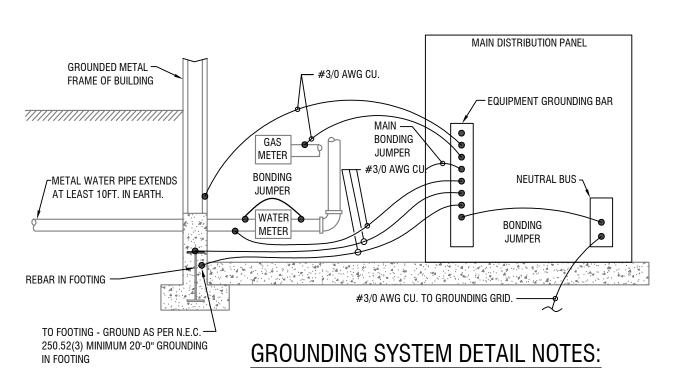
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DATE:			

**BLOWER BUILDING -ELECTRICAL** 

DRAWING NUMBER:

DRAWING NAME:





A. GROUNDING ELECTRODE SYSTEM TO BE INSTALLED PER ALL REQUIREMENTS OF N.E.C. ARTICLE 250.52

B. SIZE ALL BONDING JUMPERS PER N.E.C. ARTICLE 250.

**TYPICAL GROUNDING SYSTEM DETAIL** 

E500 NOT TO SCALE

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DATE:		NOVEMBER 2025		

**ELECTRICAL DETAILS** 

KEYED NOTES (#):

5. EMERGENCY SYSTEM NEUTRAL

E500 NOT TO SCALE

NOTE: CIRCUITS MARKED (EX) ARE EXISTING CIRCUITS TO BE RECONNECTED TO NEW PANELBOARD.

LOCATION: I BUS RATING	•			PANE	EL SCHED	ULE			FULLY RATED AIC: 14 KAIC SERVICE: 480/277V, 3Ø, 4W MOUNTING: SURFACE	
MAIN: 200 A SERVICE EN	Amp MCB ITRANCE LABEL: YES		PAN	EL	'LPP	(NE	EW	)	FED FROM: MDP-1 ENCLOSURE TYPE: NEMA 12/3R	
CKT.	LOAD DESIGNATION	BREAKER	L1 (VA	A)	L2 (VA)	L3 (	(VA)	BREAKER	LOAD DESIGNATION	CKT.
1	LIGHTING (EX)	20A/1P	2050 1	260				20A/1P	EXTERIOR LIGHTING (EX)	2
3	LIGHTING (EX)	20A/1P		2	2400 -			20A/1P	SPARE	4
5	SPARE	20A/1P		/ ,		-	-	20A/1P	SPARE	6
7	SPARE	20A/1P	-	-				20A/1P	SPARE	8
9	SPARE	20A/1P						20A/1P	SPARE	10
11	SPARE	20A/1P		/ 7		-	-	20A/1P	SPARE	12
13	-	20A/1P	-	-				20A/1P	-	14
15	-	20A/1P						20A/1P	-	16
17	-	20A/1P				-	-	20A/1P	-	18
19	-	20A/1P	-	-				20A/1P	-	20
21	-	20A/1P						20A/1P	-	22
23	-	20A/1P				-	-	20A/1P	-	24
25	-	20A/1P	-	-				20A/1P	-	26
27	-	20A/1P						20A/1P	-	28
29	-	20A/1P		/ -		-	-	20A/1P	-	30
31	-	20A/1P	-	- [				20A/1P	-	32
33	-	20A/1P						20A/1P	-	34
35	-	20A/1P				-	-	20A/1P	-	36
37	-	20A/1P	-	-				20A/1P	-	38
39	-	20A/1P						20A/1P	-	40
41	-	20A/1P				-	-	20A/1P	-	42
	TOTAL CONNECTED VA/LEG	•	###	+	###	##	##			•
	TOTAL CONNECTED KVA				####					
	TOTAL CONNECTED AMPS									

NOTE: CIRCUITS MARKED (EX) ARE EXISTING CIRCUITS TO BE RECONNECTED TO NEW PANELBOARD.



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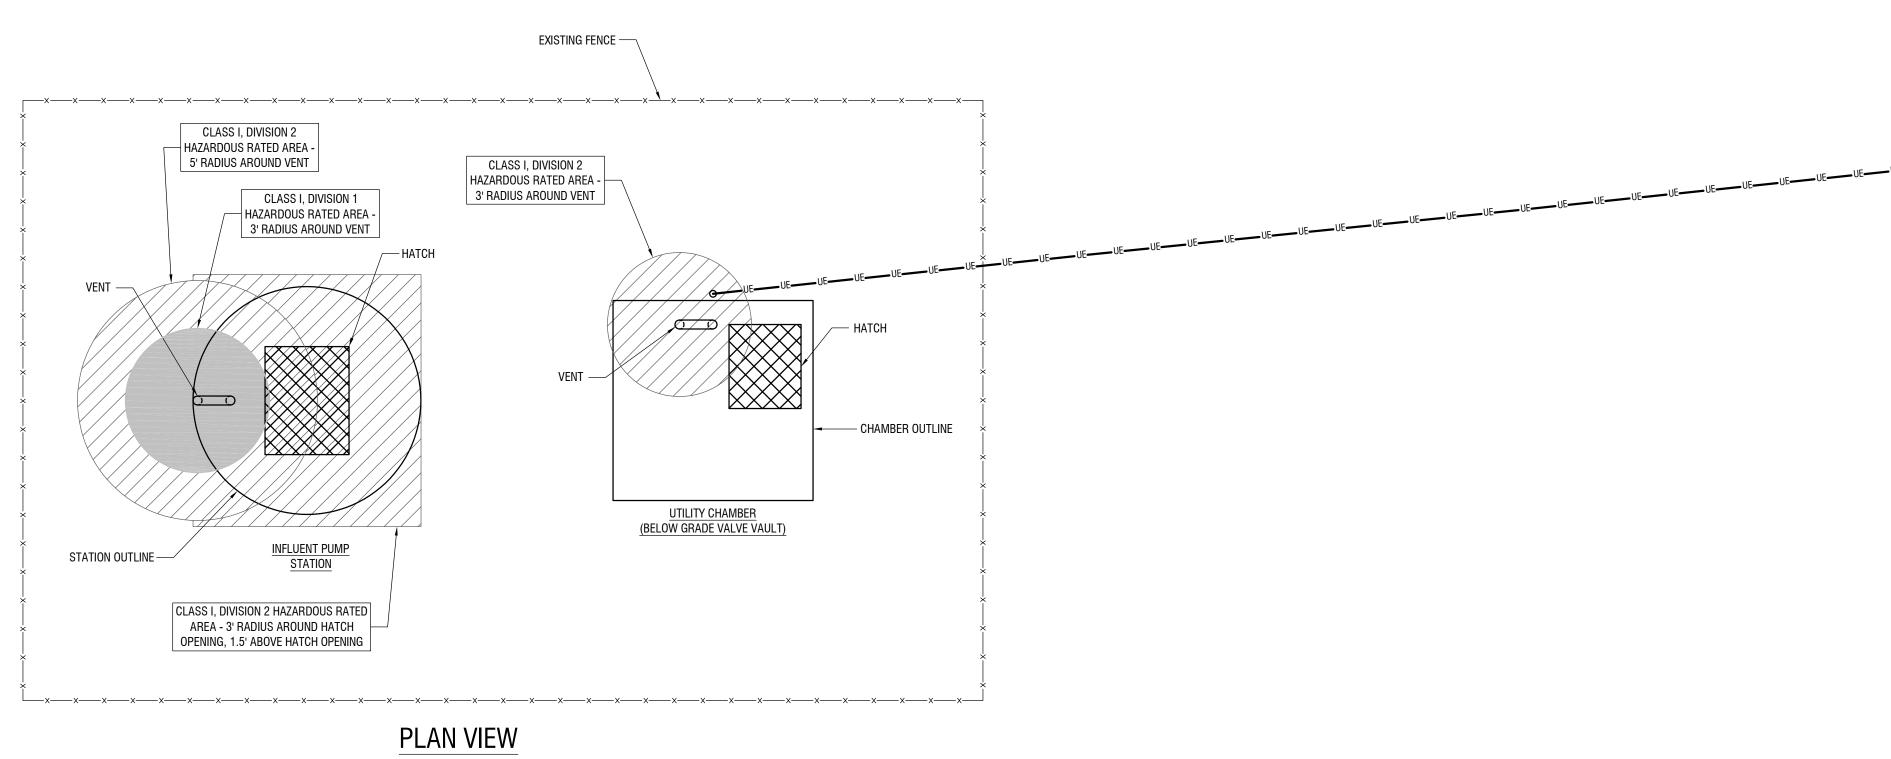
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**ELECTRICAL DETAILS** 

DRAWING NUMBER:

DRAWING NAME:



# CLASS I, DIVISION 1 HAZARDOUS RATED AREA -3' RADIUS AROUND VENT CLASS I, DIVISION 2 HAZARDOUS RATED AREA -CLASS I, DIVISION 2 HAZARDOUS RATED AREA 3' RADIUS AROUND VENT 5' RADIUS AROUND VENT CLASS I, DIVISION 2 HAZARDOUS RATED AREA - 3' RADIUS AROUND HATCH OPENING, 1.5' ABOVE HATCH OPENING GRADE CLASS I, DIVISION 2 CLASS I, DIVISION 1 HAZARDOUS RATED HAZARDOUS RATED AREA - INSIDE VAULT AREA - INSIDE VAULT CHAMBER OUTLINE — STATION OUTLINE — <u>UTILITY CHAMBER</u> (BELOW GRADE VALVE VAULT)

## **ELEVATION VIEW**

1 INFLUENT PUMP STATION - AREA CLASSIFICATION

E502 NOT TO SCALE




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HANDHOLE

H.H. #4



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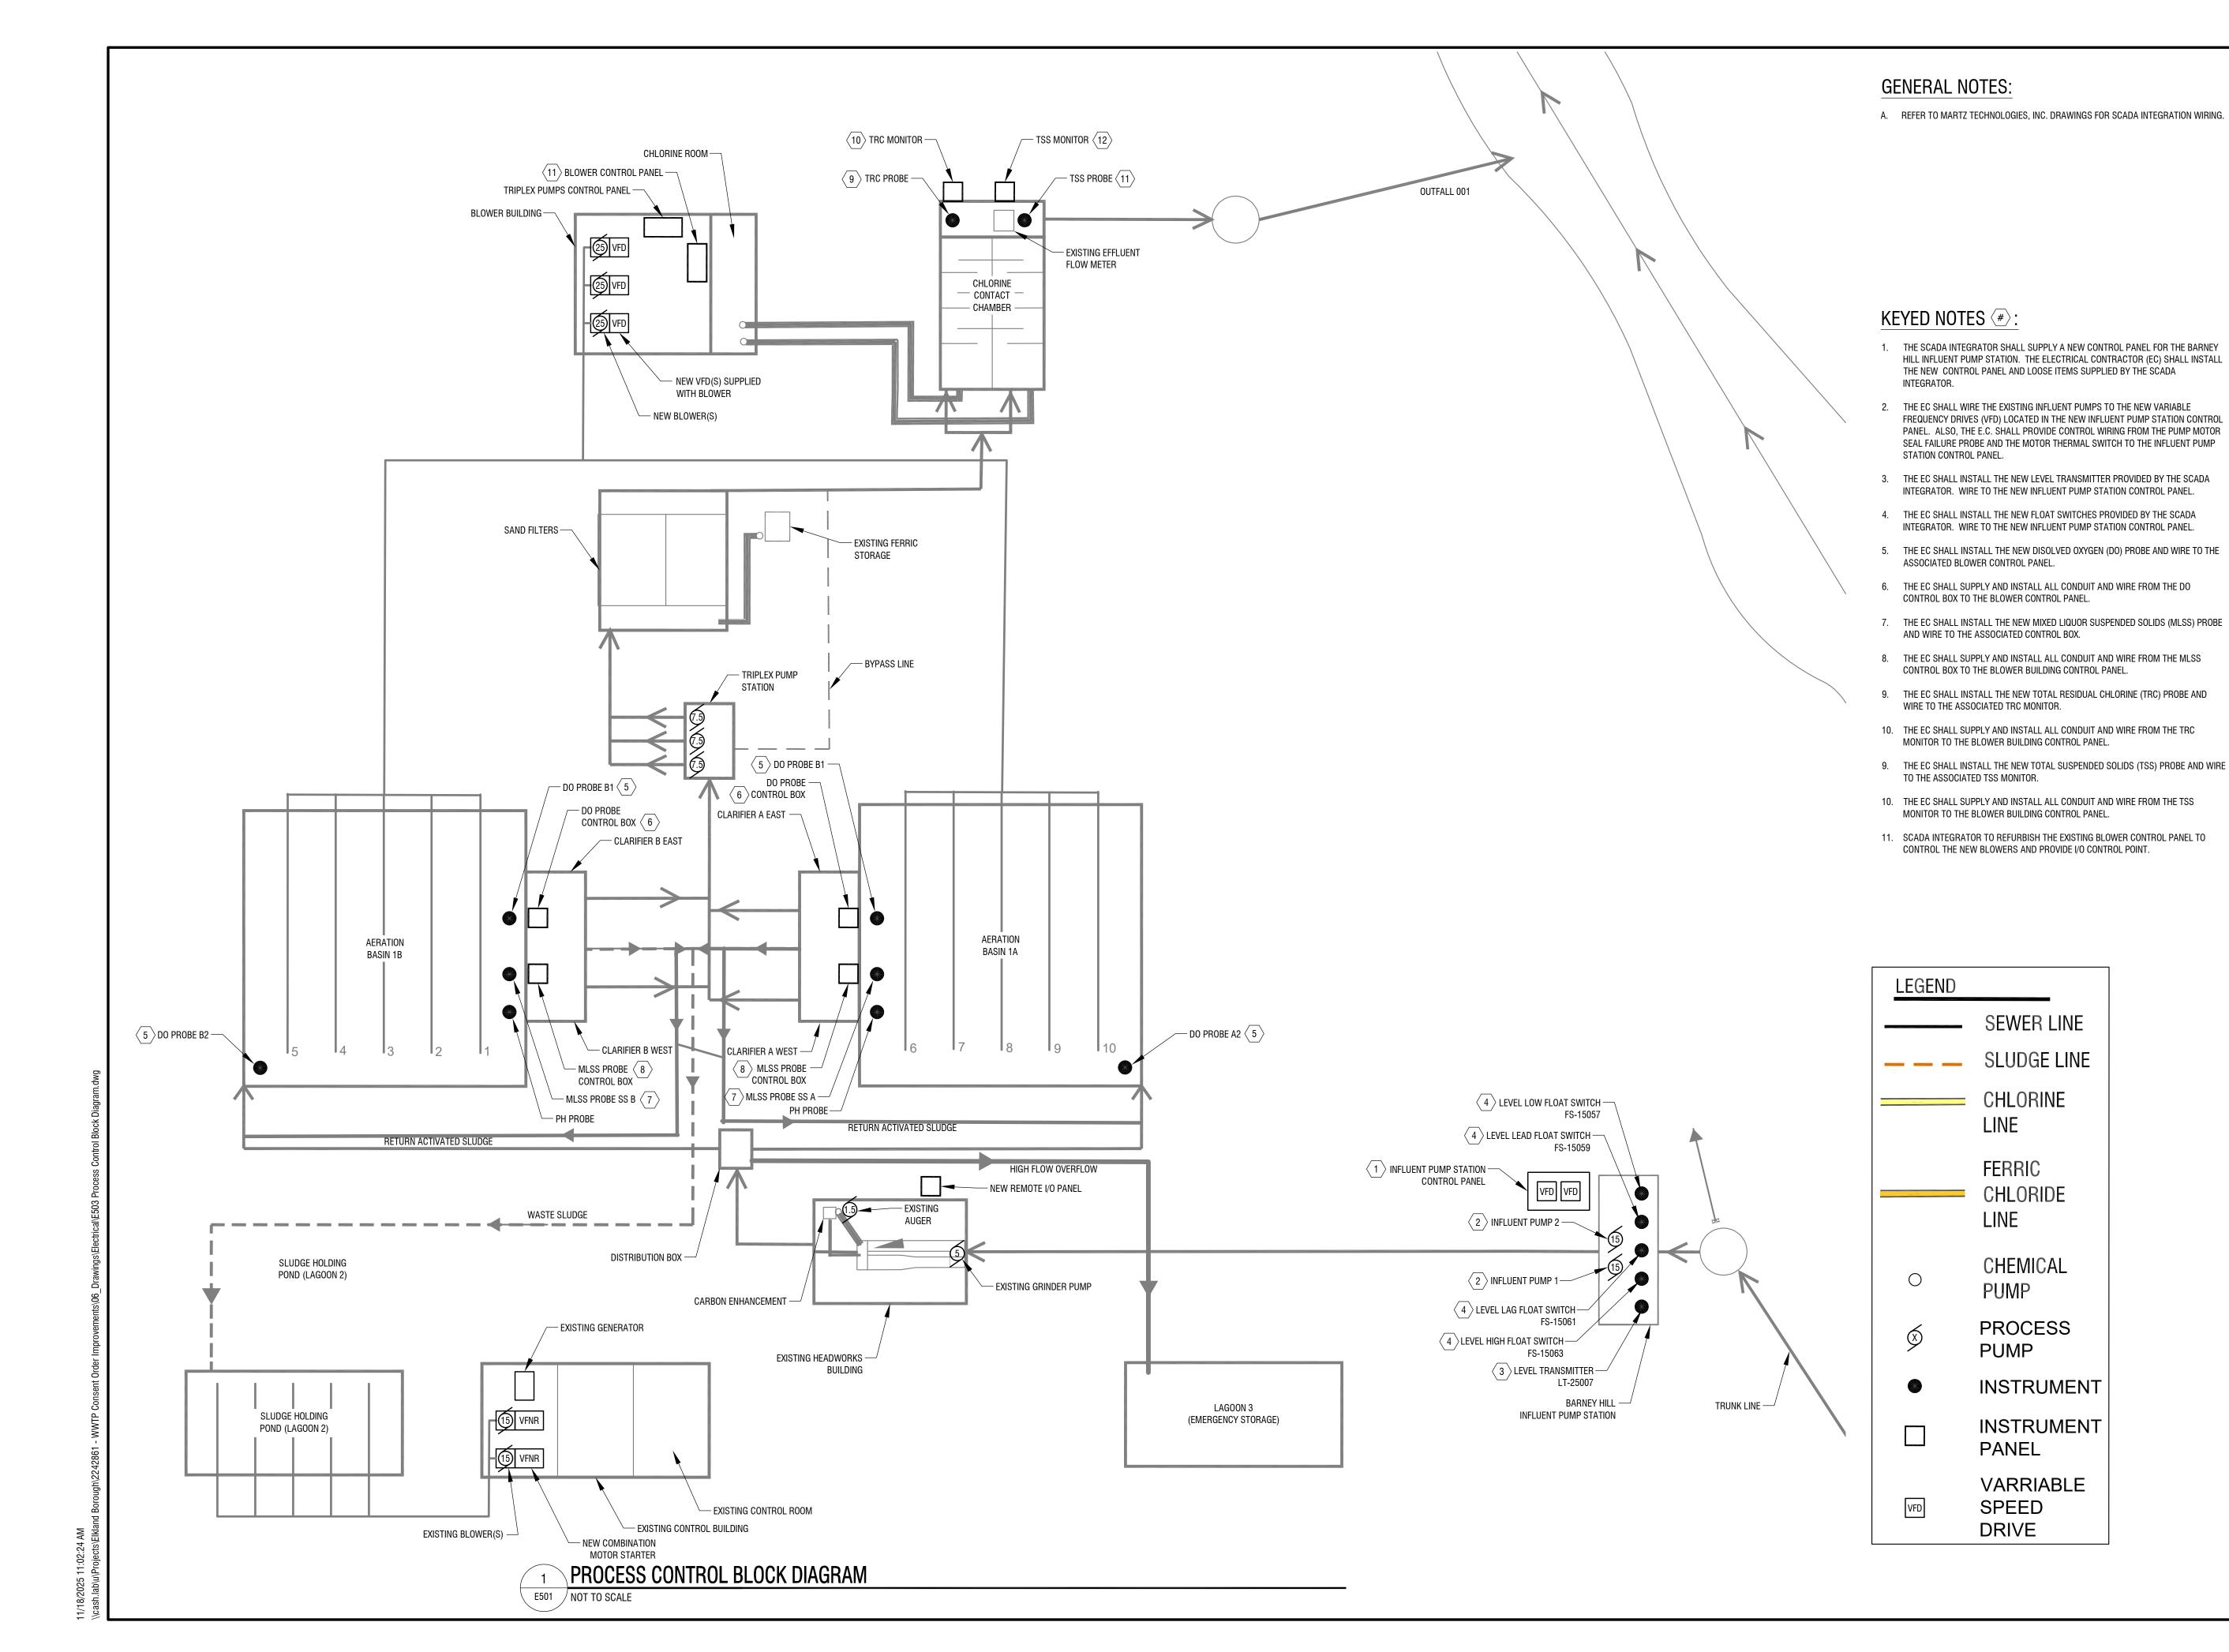
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INFLUENT PUMP STATION - AREA CLASSIFICATION

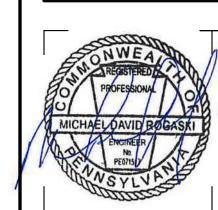DRAWING NUMBER:

DRAWING NAME:





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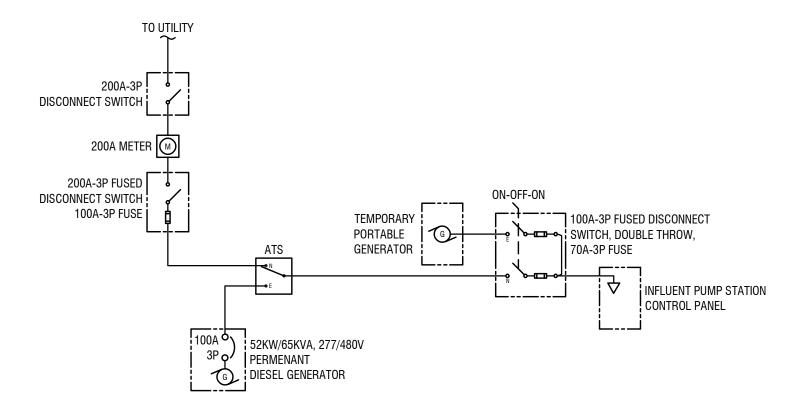
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PROCESS CONTROL BLOCK DIAGRAM

DRAWING NUMBER:

DRAWING NAME:



## 4 ONE-LINE DIAGRAM - INFLUENT PUMP STATION

E504 NOT TO SCALE

# CUT AND PATCH EX. LAWN TO ACCOMMODATE NEW CONCRETE PAD (TYP) CHAMFER EDGES 2" CLR WWF 4x4-W8xW8


LONGITUDINAL SECTION

## GENERATOR PAD DETAIL NOTES:

- A. EXACT SIZE OF GENERATOR PAD TO BE DETERMINED AFTER APPROVED GENERATOR SUBMITTAL.
- B. CONCRETE STRENGTH: USE 5000psi CONCRETE. GENERATOR SHALL NOT BE INSTALLED UNTIL CONCRETE HAS CURED FOR A MINIMUM OF 3 DAYS.
- C. WELDED WIRE FABRIC SHALL CONFORM TO ASTM A185, Fy=65,000 psi, AND SHALL BE HOT-DIPPED GALVANIZED OR EPOXY COATED AFTER FABRICATION TO PRODUCE A CLASS 2 COATING EQUAL TO THAT SPECIFIED IN ASTM A641,TABLE 1.
- D. DRILL AND SET ANCHOR BOLTS IN FIELD AFTER INSTALLATION OF GENERATOR ON FOOTING AND AS PER MANUFACTURER'S SPECIFICATIONS.
- E. LOCATION OF PAD SHALL BE APPROVED BY THE OWNER BEFORE CONSTRUCTION.
- F. COMPACTED STONE SHALL BE AASHTO 57 COARSE AGGREGATE.
- G. CONDUIT REQUIREMENTS SHALL BE PER MANUFACTURER'S SPECIFICATIONS AND SHALL BE PLACED INTO POSITION BEFORE CASTING CONCRETE PAD.
- H. ANCHOR BOLTS SHALL BE 1/2"DIA. HILTI HY-200 ADHESIVE ANCHOR RODS WITH 4-1/2" EMBEDMENT DEPTH OR APPROVED EQUAL.
- I. REINFORCEMENT BARS SHALL CONFORM TO ASTM A615, GRADE 60.
- J. VERIFY DIMENSIONS WITH THOSE ON GENERATOR SHOP DRAWINGS AND ADJUST ACCORDINGLY.

### GENERATOR PAD DETAIL - INFLUENT PUMP STATION

E504 NOT TO SCALE

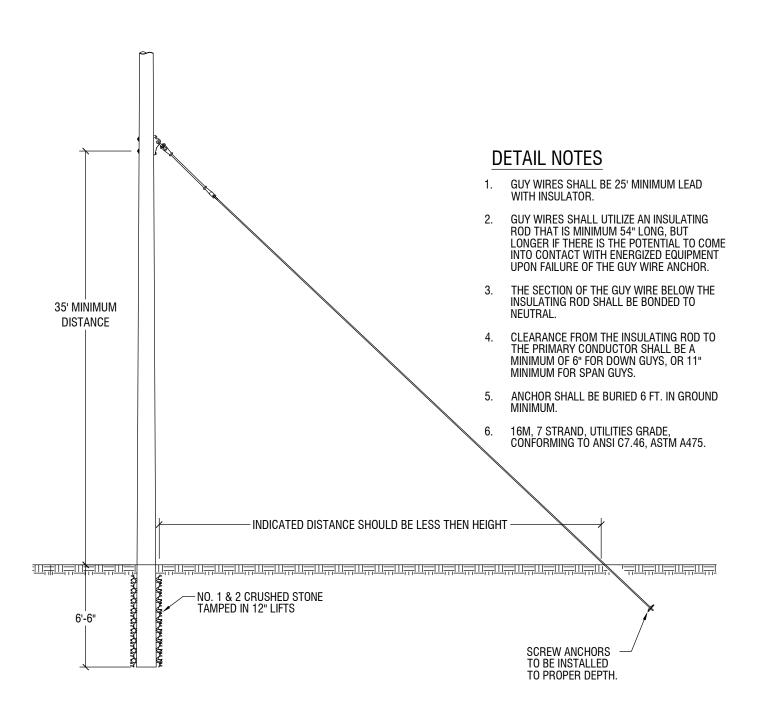


2 GUY WIRE DETAIL

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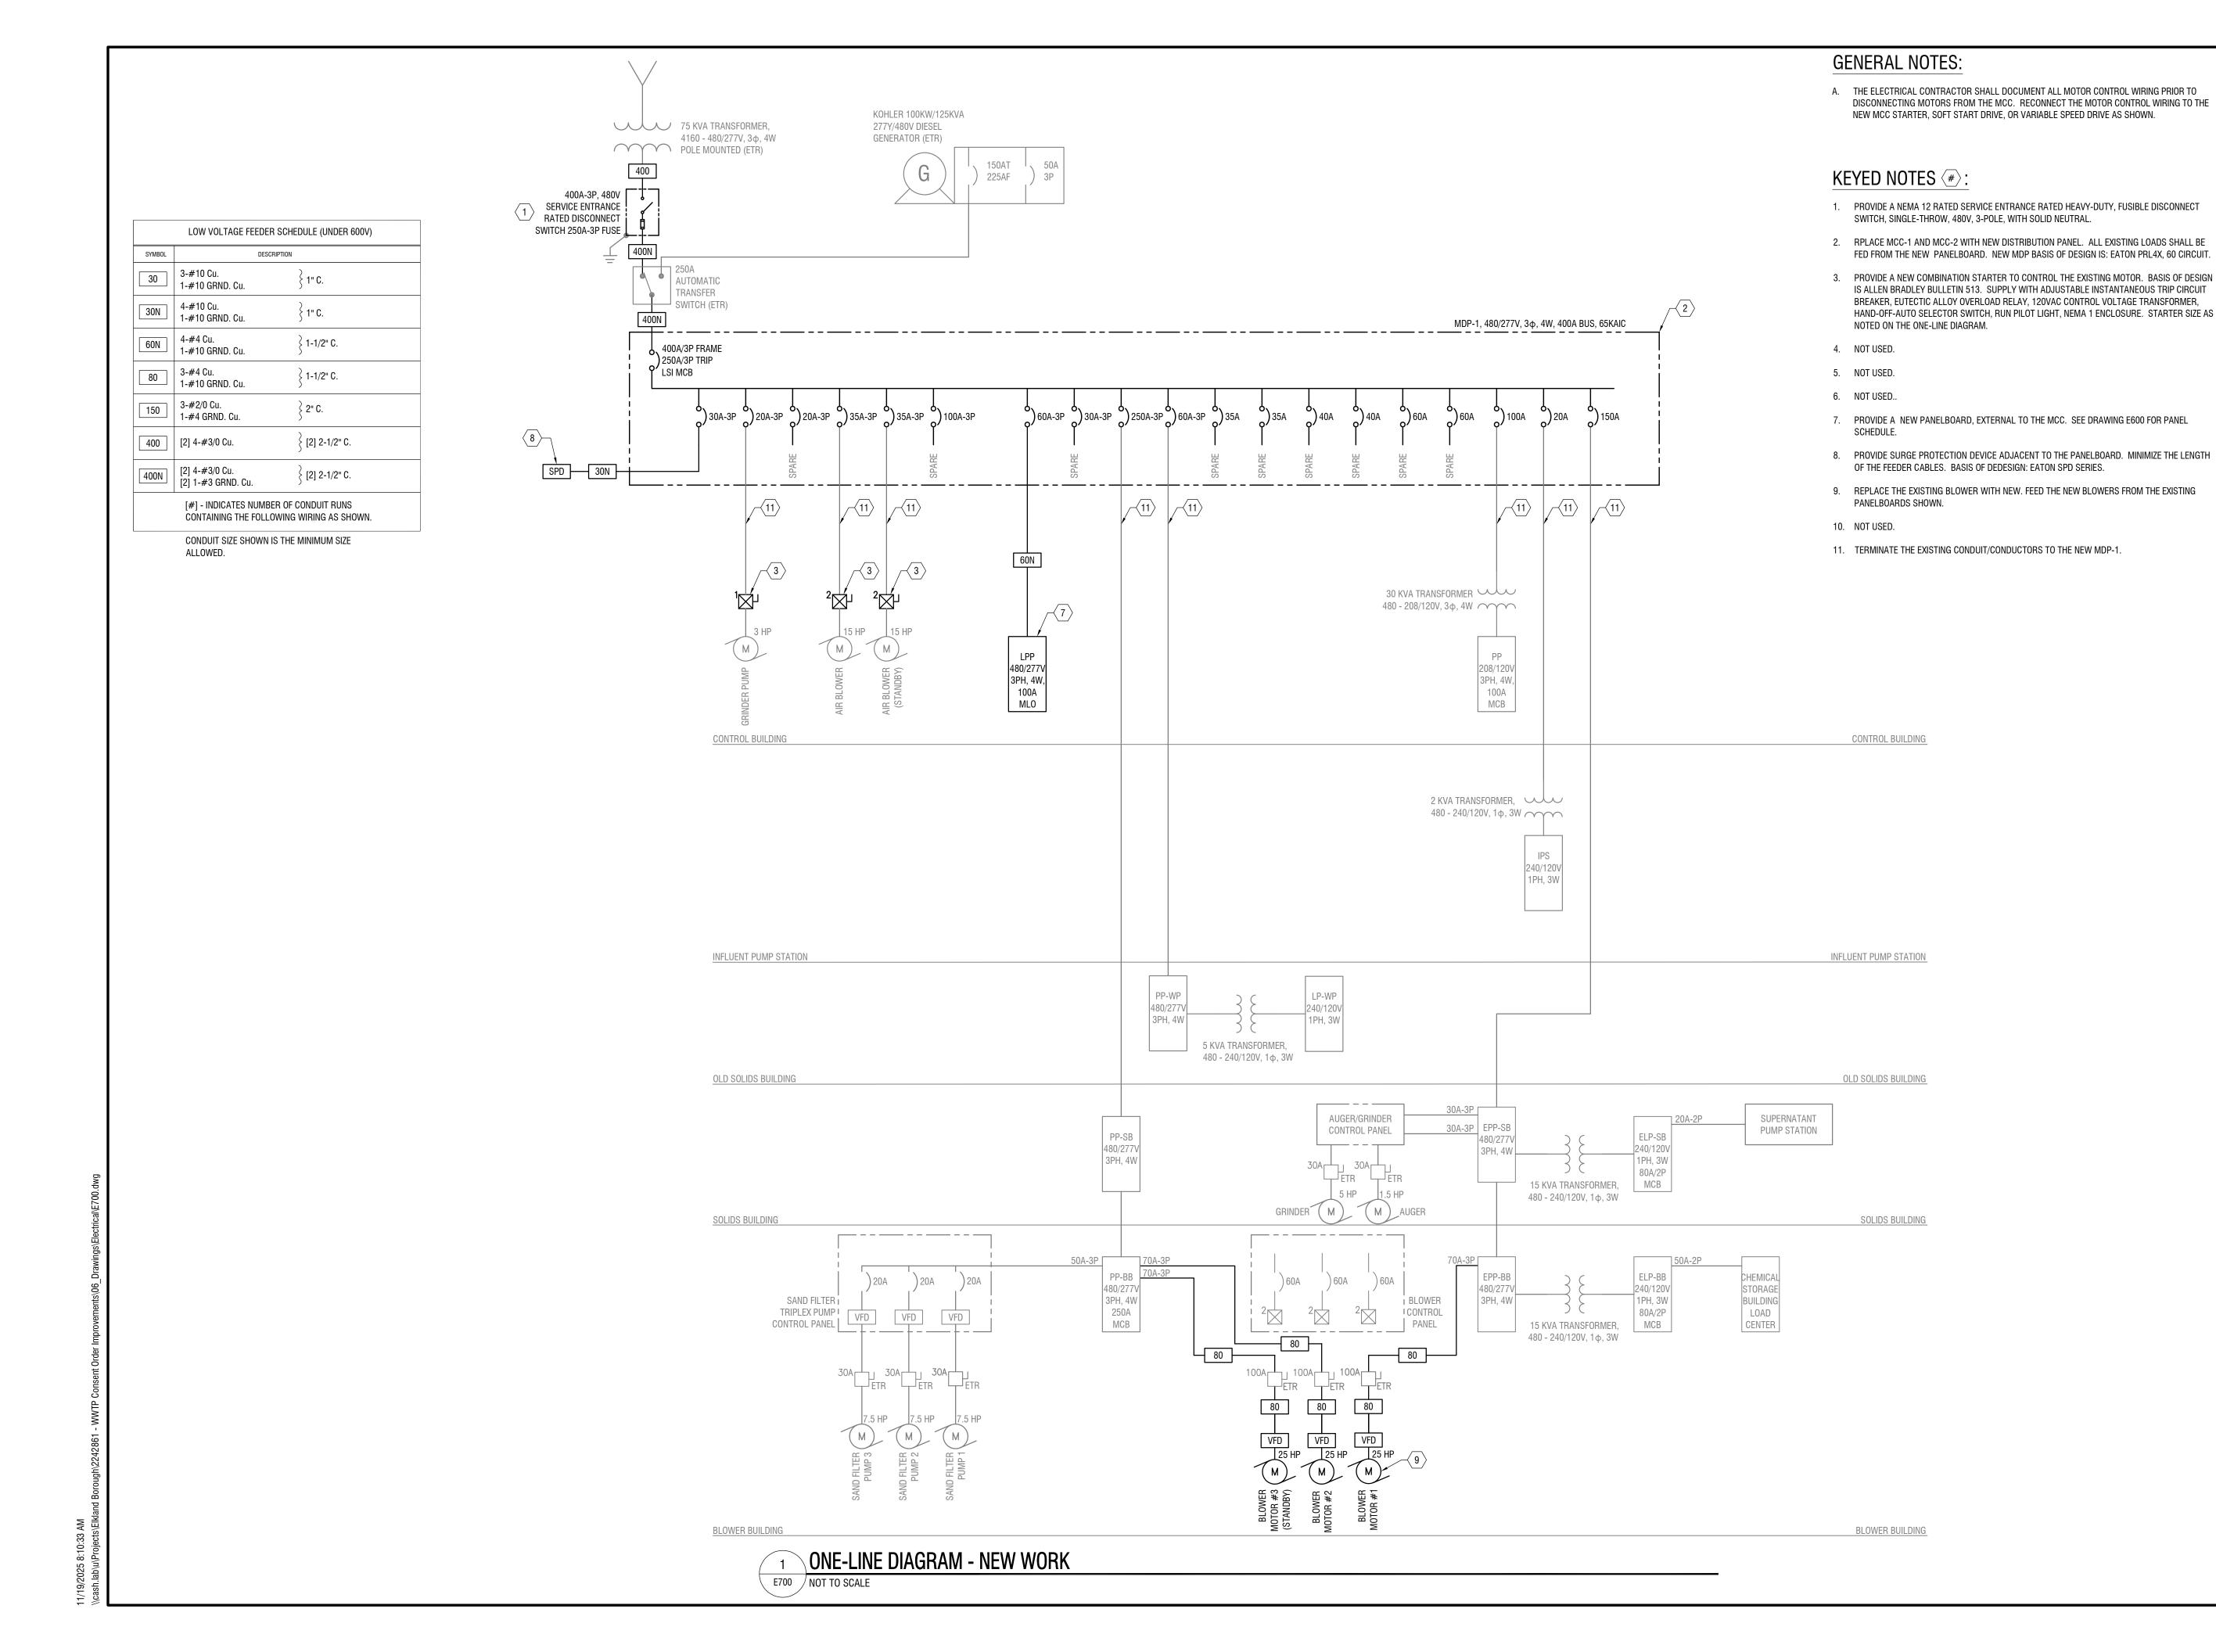
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# INFLUENT PUMP STATION DETAILS

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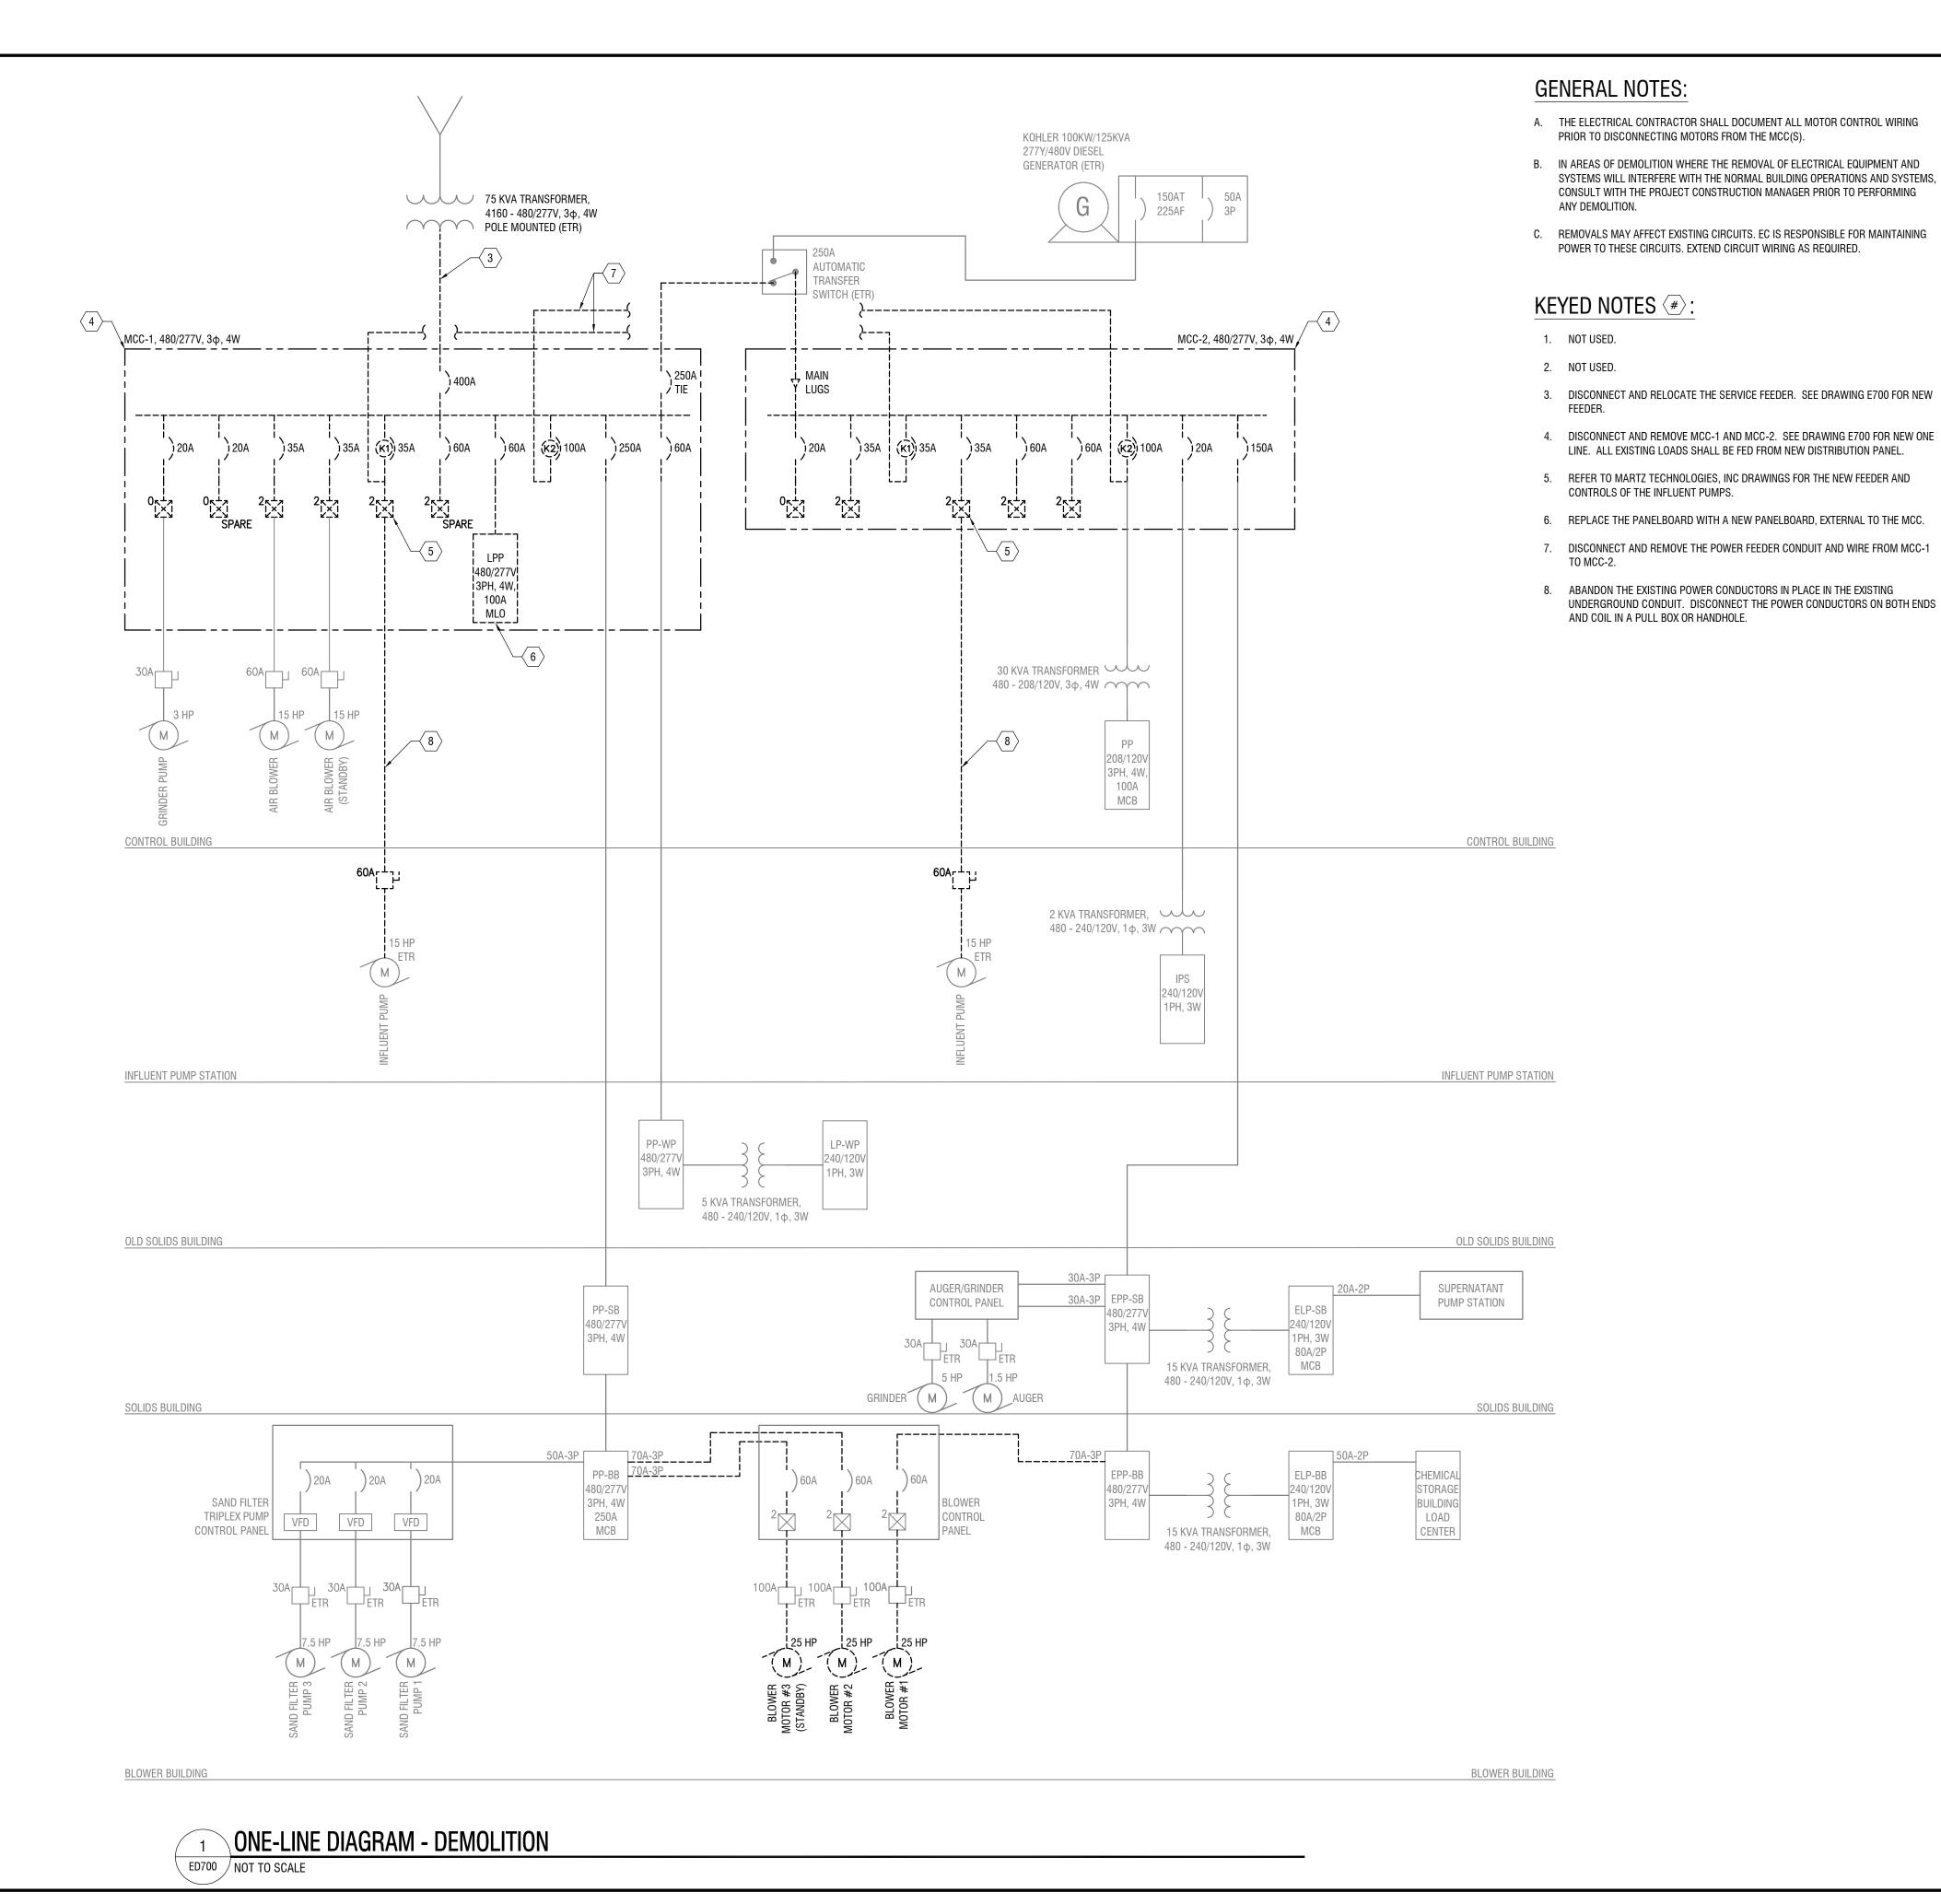
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ONE-LINE DIAGRAM -

**NEW WORK** 

DRAWING NUMBER:
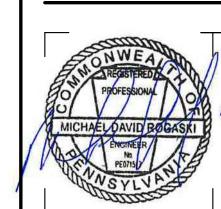
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CERTIFICATE OF AUTHORIZATION NUMBER: PROFESSIONAL ENGINEERING: 0021272 LAND SURVEYING: 0021271 GEOLOGICAL: 0021659

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ONE-LINE DIAGRAM - DEMOLITION

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**ED700**