ELMIRA CITY SCHOOL DISTRICT ELEMENTARY SCHOOLS 2023 RENOVATIONS (PHASE II)

ELMIRA, CHEMUNG COUNTY, NEW YORK CONTRACT DOCUMENTS

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FASSETT ELEMENTARY

BEECHER ELEMENTARY

DIVEN ELEMENTARY

COBURN ELEMENTARY

HENDY ELEMENTARY

BROADWAY ACADEMY

PINE CITY ELEMENTARY

LOCATION MAP

ISSUE DATE: 05/26/2023 CONTRACT DOCUMENT ISSUE DATE: 10/21/2022 HUNT PROJECT NUMBER: 2012.233

BEECHER ELEMENTARY 2023 – RECONSTRUCTION SED #: 07-06-00-01-0-005-016 BROADWAY ACADEMY 2023 – RECONSTRUCTION SED # : 07-06-00-01-0-034-022 COBURN ELEMENTARY 2023 – RECONSTRUCTION SED # : 07-06-00-01-0-002-019 DIVEN ELEMENTARY 2023 RECONSTRUCTION SED #: 07-06-00-01-0-006-019 FASSETT ELEMENTARY 2023 RECONSTRUCTION SED #: 07-06-00-01-0-008-014 HENDY ELEMENTARY 2023 RECONSTRUCTION SED #: 07-06-00-01-0-014-021 PINE CITY ELEMENTARY 2023 RECONSTRUCTION SED #: 07-06-00-01-0-033-023

HUNT ENGINEERS | ARCHITECTS | SURVEYORS

100 Hunt Center, Horseheads, New York 14845 P: 607-358-1000 F: 607-358-1800 Offices: Rochester | Horseheads | Towanda

PRT PRESERVATIVE TREATED

PSC PRE-STRESSED CONCRETE

SPL SPECIAL

SQ SQUARE

WB WOODBASE

WC WATER CLOSET

MH MANHOLE

MIN MINIMUM

HH HANDHOLE

HI HEIGHT OF INSTRUMENT

CIR CIRCLE

CJ CONTROL JOINT

EST ESTIMATE(D)

ETR EXISTING TO REMAIN

DRAWN BY: ACA SCC CHECKED BY 10/21/2022 SCALE: 12" = 1'-0"

> S H ___ S Ξ Z G Z

TRIE ABBREVIATIONS $\dot{\boldsymbol{S}}$ CHOOL ARY CITY

∞ಶ YMBOLS SYMBOLS ELEMENTA ELMIRA CI

GENERAL CEILING NOTES:

ACCESS REQUIRED ABOVE HARD CEILING.

FOR COLORS.

- ALL EXPOSED GYPSUM WALL BOARD SHALL BE PAINTED, UNLESS NOTED OTHERWISE
- B REFER TO FINISH KEY AND SCHEDULE FOR INDIVIDUAL CEILING TYPES AND SPECIFIED LOCATIONS. ALL NEW CEILING SYSTEMS TO BE INSTALLED DIRECTLY TO STRUCTURE. SUPPORT WIRES FOR SUSPENDED CEILING ASSEMBLY SHALL NOT BE TIED TO ANY MECHANICAL, ELECTRICAL, PLUMBING OR FIRE PROTECTION PIPING OR
- CENTER ALL MECHANICAL PENETRATIONS AND ELECTRICAL DEVICES WITHIN CEILING TILE. COORDINATE WITH THE
- WORK OF ALL PRIME CONTRACTORS. ARCHITECTURAL DRAWINGS TAKE PRECEDENCE OVER ENGINEERING DRAWINGS FOR LOCATION OF LIGHT FIXTURES AND MECHANICAL EQUIPMENT. COORDINATE WITH ALL OTHER PRIME CONTRACTORS.
- CEILING GRID TO BE CENTERED WITHIN ROOMS, UNLESS NOTED OTHERWISE. INSTALL TRIMLESS ACCESS PANELS FURNISHED BY OTHER PRIME CONTRACTORS FOR GYPSUM WALL BOARD CEILING AREAS. COORDINATE SIZE, LOCATION, AND QUANTITY OF ACCESS PANELS WITH OTHER PRIME CONTRACTORS FOR
- PAINT ALL EXPOSED CONDUITS, JUNCTION BOXES, ELECTRICAL ITEMS (NOT FACTORY FINISHED), SPRINKLER LINES, MECHANICAL DUCTWORK AND PIPING UNLESS NOTED OTHERWISE. REFER TO FINISH KEY FOR COLORS.

GENERAL NOTES - INTERIOR WALL FINISH:

- DRAWINGS REPRESENT LOCATIONS OF NEW WALL FINISHES AND INDICATE PATTERNS FOR INSTALLATION. FOR COMPLETE LIST OF FINISHES, REFER TO FINISH KEY AND ROOM FINISH SCHEDULES ON DRAWINGS.
- REFER TO A2 DRAWINGS FOR CEILING HEIGHTS. VERIFY CEILING HEIGHTS IN FIELD PRIOR TO START OF WORK. PAINT ALL UNFINISHED EXPOSED HVAC EQUIPMENT INCLUDING DUCTWORK, AIR DIFFUSERS AND RETURNS AT CEILING
- PLANE TO MATCH ADJACENT CEILING FINISH/COLOR. ARCHITECT TO SELECT COLOR. REFER TO WALL FINISH LEGENDS AND ELEVATIONS FOR FINISHES THAT REQUIRE ADDITIONAL INFORMATION
- REGARDING EXTENTS OR INSTALLATION PATTERNING. PAINT ALL NEW INTERIOR WINDOW TRIM AND DOOR FRAMES. REFER TO FINISH KEY AND ROOM FINISH SCHEDULES

GENERAL NOTES - INTERIOR FLOOR FINISH:

- FLOOR FINISH PATTERNS ARE INDICATED WHERE FLOOR FINISHES WILL BE EXPOSED. ALL FLOOR FINISHES, WITH THE EXCEPTION OF CARPET, SHALL BE INSTALLED EXTENDING COMPLETELY UNDER NEW BUILT-IN CASEWORK, **EVEN WHEN NOT SHOWN ON PLANS.**
- SCARIFY CONCRETE SLAB AS REQUIRED IN ORDER TO PROVIDE SMOOTH TRANSITION BETWEEN ADJACENT
- DISSIMILAR MATERIALS. INSTALL NEW WOOD STRIP FLOORING ADJACENT TO EXISTING WOOD STRIP FLOORING DIRECTION.
- D ALL FLOOR FINISHES TO TRANSITION @ CENTERLINE OF DOOR UNLESS NOTED OTHERWISE. CARPETING TO EXTEND UNDER COUNTERTOPS WHERE THERE ARE NO BASE CABINETS.
- WHERE NO PATTERN IS INDICATED REFER TO FINISH SCHEDULE FOR FLOOR FINISHES. REFER TO FINISH KEY FOR ACTUAL COLORS AND FINISHES.
- PROVIDE ADA COMPLIANT TRANSITION STRIP WHEN ABUTTING FLOOR FINISHES DIFFER IN THICKNESS OR MATERIAL. REFER TO FINISH KEY AND ROOM FINISH SCHEDULES FOR DETAILS.

GENERAL ASBESTOS ABATEMENT NOTES:

- A REFER TO SPECIFICATION 02 21 10 ASBESTOS ABATEMENT FOR ADDITIONAL INFORMATION. B ALL WORK IS TO COMPLY WITH NYS CODE RULE 56 REQUIREMENTS OR HIGHER. SITE SPECIFIC VARIENCES MAY BE
- IMPLEMENTED IF APPROVED BY THE ARCHITECT.
- ASBESTOS SURVEY WAS CONDUCTED AND THE REPORT IS ON FILE WITH THE OWNER.
- THE REGULATED ABATEMENT WORK AREA SHALL BE VACATED BY THE OCCUPANTS AND NON-CERTIFIED PERSONNEL, PRIOR TO WORK AREA PREPARATION, AND SHALL REMAIN VACATED UNTIL THE ASBESTOS PROJECT IS COMPLETE. THE PERSONAL AND WASTE DECONTAMINATION SYSTEM ENCLOSURE(S) SHALL BE PROVIDED OUTSIDE THE REGULATED ABATEMENT WORK AREA AND ATTACHED TO THE BUILDING AT ENTRY/EXIT LOCATION AS PER SECTION 56-7.5. THESE LOCATIONS SHALL BE REVIEWED AND APPROVED BY THE OWNER/OWNERS REPRESENTATIVE PRIOR TO COMMENCEMENT
- OF WORK. THE DECONTAMINATION UNIT(S) SHALL BE CORDONED OFF AT A DISTANCE OF TWENTY-FIVE (25) FEET IN ALL DIRECTIONS TO SEPARATE IT FROM PUBLIC AREAS. THE CONTRACTOR SHALL ESTABLISH, MARK AND MAINTAIN PROPER EXITS WITHIN EACH WORK AREA FOR NORMAL AND EMERGENCY USE AND MAINTAIN A CLEAR EGRESS PATH. ALL TOOLS AND EQUIPMENT SHALL BE REMOVED FROM SITE AFTER DECONTAMINATION. G AFTER ALL REGULATED ABATEMENT WORK AREAS HAVE BEEN DISMANTLED ANY REMAINING REMOTE DECONTAMINATION
- ENCLOSURES MUST BE DISMANTLED AND REMOVED FROM SITE. ALL PLASTIC SHEETHING SHALL BE REMOVED AND **DISPOSED OF ASBESTOS WASTE.** H ALL WASTE GENERATED AS PART OF ASBESTOS PROJECT SHALL BE REMOVED FROM THE SITE WITHIN TEN (10) CALENDAR
- DAYS AFTER SUCCESSFUL COMPLETION OF PHASE 11 C FOR ALL REGUALTED WORK AREAS. ALL WASTE GENERATED AS PART OF THE ASBESTOS PROJECT SHALL BE LEGALLY DISPOSED OF AT ANY APPROVED LANDFILL FACILITY. ALL GENERATED WASTE REMOVED SHALL BE DOCUMENTED, ACCOUNTED FOR AND DISPOSED OF IN COMPLIANCE WITH REQUIREMENTS OF EPA NESHAP.

	INTERIOR LOOSE LINTE	<u>L SCHEDULE</u>		EXTERIOR LOOSE LINTE	L SCHEDULE			
	MASON	RY OPENING		MASONRY OPENING				
WALL IICKNESS	UP TO 4'-0" 4" BEARING EACH END	4'-0" TO 8'-0" 6" BEARING EACH END	WALL THICKNESS	UP TO 4'-0" 4" BEARING EACH END	UP TO 8'-0" 8" BEARING EAC			
4"	WT 4 x 6.5*	WT 6 x 8*	4"	^L 3 1/2 x 3 1/2 x 5/16	^L 5 x 3 1/2 x			
8"	2 [⊥] [⊥] 4 x 3 1/2 x 1/4 (LLV)	2 5 x 3 1/2 x 5/16 (LLV)	8"	2 [⊥] [⊥] 4 x 3 1/2 x 5/16 (LLV)	2 [⊥] ^L 5 x 3 1/2 x			
10"	2 4 x 3 1/2 x 1/4 (LLV) 9" x 5/16" PLATE	2 5 x 3 1/2 x 5/16 (LLV) 9" x 5/16" PLATE	10"	2 4 x 3 1/2 x 5/16 (LLV) 9" x 5/16" PLATE	2 [⊥] 5 x 3 1/2 x 5/16 (LL			
12"	2 [⊥] 5 x 3 1/2 x 5/16 (LLH)	2 [⊥] [∟] 5 x 5 x 3/8	12"	2 [⊥] ^L 5 x 3 1/2 x 5/16 (LLH)	2 [⊥] ^L 5 x 5 x 5/1			
	OR 3	OR 3 ^{1 1} ⁶ x 3 1/2 x 3/8 (LLV)	1'-4" TOTAL 8" CMU_	J L L 4 x 3 1/2 x 5/16 (LLV) — 15" x 5/16" PLATE				
1'-4"	☐ ☐ ☐ ☐ ☐ ☐ ☐ ☐ ☐ ☐ ☐ ☐ ☐ ☐ ☐ ☐ ☐ ☐ ☐	☐ ☐ ☐ ☐ ☐ ☐ ☐ ☐ ☐ ☐ ☐ ☐ ☐ ☐ ☐ ☐ ☐ ☐ ☐	1'-5"	L L L4 x 3 1/2 x 5/16 (LLV) 16" x 5/16" PLATE	<u> </u>			
6" GLAZED IASONRY	L5 x 3 1/2 x 5/16 (LLV)** 5 1/2" x 5/16" PLATE **L6 x 3 1/2 x 5/16 (LLV)W/ PLATE MAY BE USED UP TO 6'-0" SPAN		1'-6"	L L L4 x 3 1/2 x 5/16 (LLV) 17" x 5/16" PLATE	J L			

GENERAL DEMO NOTES:

OWNER'S REPRESENTATIVE AND THE ARCHITECT.

DURING FACILITY OPERATIONS.

THAT BECOME ONE ROOM.

PERFORMED BY THE OWNER.

EXISTING CONDITIONS IN THE FIELD.

GENERAL NOTES:

PERFORMED BY THE OWNER.

NEW CORRIDOR FINISHES.

AND MILLWORK.

AND ADAAG.

PREPARE SURFACE TO RECEIVE NEW FINISHES.

SPECIFICALLY INDICATED OR NOT, UNLESS NOTED OTHERWISE.

ARCHITECT IMMEDIATELY IF ANY DISCREPANCIES ARE FOUND.

ACTUAL QUANTITY & EXISTING FIELD CONDITIONS.

CLEAR FLOOR SPACE ON THE PUSH SIDE OF ALL NEW DOORS.

M EXTEND ALL NEW PARTITIONS TO DECK ABOVE, UNLESS NOTED OTHERWISE.

A ASBESTOS ABATEMENT IS BEING PERFORMED AT PARLEY COBURN AND DIVEN ELEMENTARY SCHOOL. ASEBSTOS CONTAINING

MATERIAL NOT SCHEDULED IS ENCOUNTERED, STOP WORK IMMEDIATELY, DO NOT DISTURB THE MATERIAL AND NOTIFY THE

MATERIALS ARE PRESENT IN THE EXISTING BUILDINGS. REFER TO SPECIFICATIONS FOR LOCATIONS AND SCHEDULE. THE OWNER

HAS REPORTS IDENTIFYING ACM MATERIALS AND WILL HAVE THESE AVAILABLE FOR CONTRACTORS REFERENCE. IF SUSPECT

S CONTRACTOR TO PROVIDE PROTECTIVE BARRIER AT ALL AREAS OF DEMOLITION. KEEP ALL EXITS FREE AND CLEAR AT ALL TIMES

THE OWNER RESERVES THE RIGHT TO RETAIN ANY REMOVED ITEMS AFTER CONTRACTOR REMOVAL. THE CONTRACTOR SHALL

GRINDING OF CONCRETE FLOORS AND SUBSTRATES OF DIFFERENT HEIGHTS IN THE SAME AREA IS REQUIRED AT WALL REMOVALS

AND NEW DOORS IN EXISTING WALLS TO ALLOW THE NEW FINISHES TO ALIGN BETWEEN ADJACENT ROOMS AND ADJACENT ROOMS

CONTRACTOR SHALL PROTECT EXISTING CONSTRUCTION TO REMAIN AS REQUIRED DURING DEMOLITION. PATCH, REPAIR, PAINT OR

RE-FINISH EXISTING CONSTRUCTION MATERIALS AND FINISHES DAMAGED DURING DEMOLITION TO THIER ORIGINAL CONDITION.

CONTRACTOR TO COORDINATE THE WORK OF THIS CONTRACT WITH THE WORK OF ALL OTHER CONTRACTED WORK AND WORK

G DIMENSIONS SHOWN FOR ALL NEW OPENINGS IN EXISTING CONSTRUCTION SHOULD BE COORDINATED WITH THE NEW PLANS AND

H ROOM NUMBERS INDICATED ARE EXISTING BUILDING NUMBERS. REFER TO NEW FLOOR PLANS FOR NEW ROOM NUMBERING.

I REMOVE EXISTING WOOD BLOCKING FOR EXISTING WALL MOUNTED EQUIPMENT AND/OR DEVICES THAT INTERFERE WITH NEW

MAINTAIN EXISTING STRUCTURAL SYSTEMS AT ALL TIMES. PROVIDE TEMPORARY SHORING AND BRACING AT LOCATIONS WHERE

THE EXISTING STRUCTURE IS BEING MODIFIED. PROTECT THE EXISTING STRUCTURE SCHEDULED TO REMAIN FROM DAMAGE

COORDINATE ANY WALL REPAIR/INFILL THAT IS CAUSED BY THE REMOVAL OF EQUIPMENT BY OTHER PRIME CONTRACTORS AND

DURING DEMOLITION. MAINTAIN SHORING AND BRACING UNTIL THE NEW STRUCTURE IS INSTALLED AND READY TO ACCEPT LOADS.

A THE CONTRACTOR IS RESPONSIBLE FOR ALL WORK REQUIRED TO IMPLEMENT THE WORK OF THE CONTRACT, REGARDLESS OF WHETHER

C THE CONTRACTOR SHALL COORDINATE THE WORK OF THIS CONTRACT WITH THE WORK OF ALL OTHER CONTRACTED WORK AND WORK

D ALL NEW DOOR FRAMES INSTALLED IN METAL STUD OR MASONRY PARTITIONS SHALL BE MOUNTED 4" FROM ADJACENT WALLS (6" TO DOOR). TOOTH IN CMU BLOCK AND ANCHORS AT DOORS IN EXISTING CMU WALLS, UNLESS NOTED OR DETAILED OTHERWISE.

B THE CONTRACTOR SHALL VERIFY ALL DIMENSIONS AND EXISTING CONDITIONS IN THE FIELD PRIOR TO COMMENCING ANY WORK AND NOTIFY

E WHERE NEW DOORS ARE LOCATED IN EXISTING CORRIDOR WALLS, FLOORING, BASE AND WALL SHALL BE PATCHED TO MATCH EXISTING OR

F INSTALL SOLID WOOD BLOCKING IN METAL STUD WALLS AT ALL WALL MOUNTED EQUIPMENT AND ACCESSORIES. COORDINATE WITH THE

G ITEMS SHOWN ARE INTENDED TO GIVE APPROXIMATE QUANTITY, LOCATION & TYPE. THE CONTRACTOR IS RESPONSIBLE FOR VERIFYING

H VERIFY WITH OWNER EXACT SIZE OF ALL EQUIPMENT FURNISHED BY OWNER FOR PROPER FIT WITH CONTRACTOR SUPPLIED CASEWORK

J THERE SHALL BE A MINIMUM OF 1'-6" CLEAR FLOOR SPACE ON THE PULL SIDE OF ALL NEW DOORS; THERE SHALL BE A MINIMUM OF 1'-0"

K THE WHEELCHAIR SYMBOL INDICATES HANDICAP ACCESSIBLE MOUNTED FIXTURE ELEVATION AND SHALL CONFORM WITH CABO/ANSI A117.1

INFILL EXISTING MASONRY OPENINGS TO MATCH EXISTING WALL CONSTRUCTION & THICKNESS, UNLESS NOTED OTHERWISE. TOOTH IN NEW

OR SALVAGED MASONRY WITH EXISTING. MATCH EXISTING FINISHES OR PREPARE SUBSTRATE AS REQUIRED TO ACCEPT NEW FINISHES.

NEW FIRE RATED WALL ASSEMBLIES TO BE SEALED WITH APPROVED U.L. FIRE RATED SYSTEMS AT ALL DECK TERMINATIONS.

) ALL PENETRATIONS THROUGH FIRE RATED WALL ASSEMBLIES TO BE SEALED WITH APPROVED U.L. FIRE RATED SYSTEM.

J ITEMS SHOWN ARE INTENDED TO GIVE APPROXIMATE QUANTITY, LOCATION AND TYPE. CONTRACTOR IS RESPONSIBLE FOR

VERIFYING ACTUAL QUANTITIES AND EXISTING FIELD CONDITIONS IN ORDER TO COMPLETE THE WORK.

REMOVE FROM THE SITE AND DISPOSE OF ALL REMOVED ITEMS THE OWNER DOES NOT WISH TO RETAIN.


WORK OR NEW ROOM FINISHES AND WALL TREATMENTS. TYPICAL FOR ALL AREAS.


WORK OF ALL OTHER CONTRACTED WORK AND WORK PERFORMED BY THE OWNER.

I ALL DIMENSIONS ARE TAKEN FROM FACE OF WALL TO FACE OF WALL. UNLESS NOTED OTHERWISE.

	EXTERIOR LOOSE LINTEL SCHEDULE									
	MASONRY OPENING									
WALL THICKNESS 4" 8" 10" 12" 1'-4" TOTAL 8" CMU 1'-5"	UP TO 4'-0" 4" BEARING EACH END	UP TO 8'-0" 8" BEARING EACH END								
4"	^L 3 1/2 x 3 1/2 x 5/16	^L 5 x 3 1/2 x 5/16 (LLV)								
8"	2 [⊥] [⊥] 4 x 3 1/2 x 5/16 (LLV)	2 [⊥] ^L 5 x 3 1/2 x 5/16 (LLV)								
10"	2 [⊥] [⊥] 4 x 3 1/2 x 5/16 (LLV) 9" x 5/16" PLATE	2 ^{_ L} 5 x 3 1/2 x 5/16 (LLV) 9" x 5/16" PLATE								
12"	2 [⊥] 5 x 3 1/2 x 5/16 (LLH)	2 [⊥] [∟] 5 x 5 x 5/16								
1'-4" TOTAL _8" CMU	J L L4 x 3 1/2 x 5/16 (LLV) — 15" x 5/16" PLATE	J L L5 x 3 1/2 x 5/16 (LLV) — 15" x 5/16" PLATE								
1'-5"	L L L4 x 3 1/2 x 5/16 (LLV) 16" x 5/16" PLATE	L L 5 x 5 x 3/8 16" x 5/16" PLATE								
1'-6"	L L L4 x 3 1/2 x 5/16 (LLV) 17" x 5/16" PLATE	J L L6 x 6 x 3/8 — 17" x 5/16" PLATE								


CONTRACTED THE CONTRACT	WORK, UNLESS NOTED	LL FLOOR, WALL AND ROOF OPENINGS REQUIR! OTHERWISE. COORDINATE WITH ALL OTHER CO	NG SUPPLEMENTAL SUPPORT FRAMING FOR ALL
	TOD SHALL DDOVIDE A		NIKACIED WORK FOR EXACT LOCATIONS AND S
THE CONTRACT	I OR SHALL PROVIDE A	LL STEEL LINTELS REQUIRED AT NEW MASONRY	OPENINGS. REFER TO LOOSE LINTEL SCHEDULE
	E, QUANTITY AND LOC		THE HVAC CONTRACTOR, REFER TO HVAC DRAW
		EXTERIOR LOOSE LINTE	L SCHEDULE
	WALL	MASONI	RY OPENING
	THICKNESS	UP TO 4'-0" 4" BEARING EACH END	UP TO 8'-0" 8" BEARING EACH END
	4"	^L 3 1/2 x 3 1/2 x 5/16	^L 5 x 3 1/2 x 5/16 (LLV)
	8"	2 [⊥] [⊥] 4 x 3 1/2 x 5/16 (LLV)	2 ^{」 ∟} 5 x 3 1/2 x 5/16 (LLV)
	10"	$2^{ \square L}$ 4 x 3 1/2 x 5/16 (LLV) 9" x 5/16" PLATE	2 5 x 3 1/2 x 5/16 (LLV) 9" x 5/16" PLATE
	12"	2^{-1} L 5 x 3 1/2 x 5/16 (LLH)	2 [⊥] 5 x 5 x 5/16
	1'-4" TOTAL 8" CMU	J L L 4 x 3 1/2 x 5/16 (LLV) 15" x 5/16" PLATE	J L L√5 x 3 1/2 x 5/16 (LLV) — 15" x 5/16" PLATE
			J L ^L 5 x 5 x 3/8
	1'-5"	16" x 5/16" PLATE	16" x 5/16" PLATE

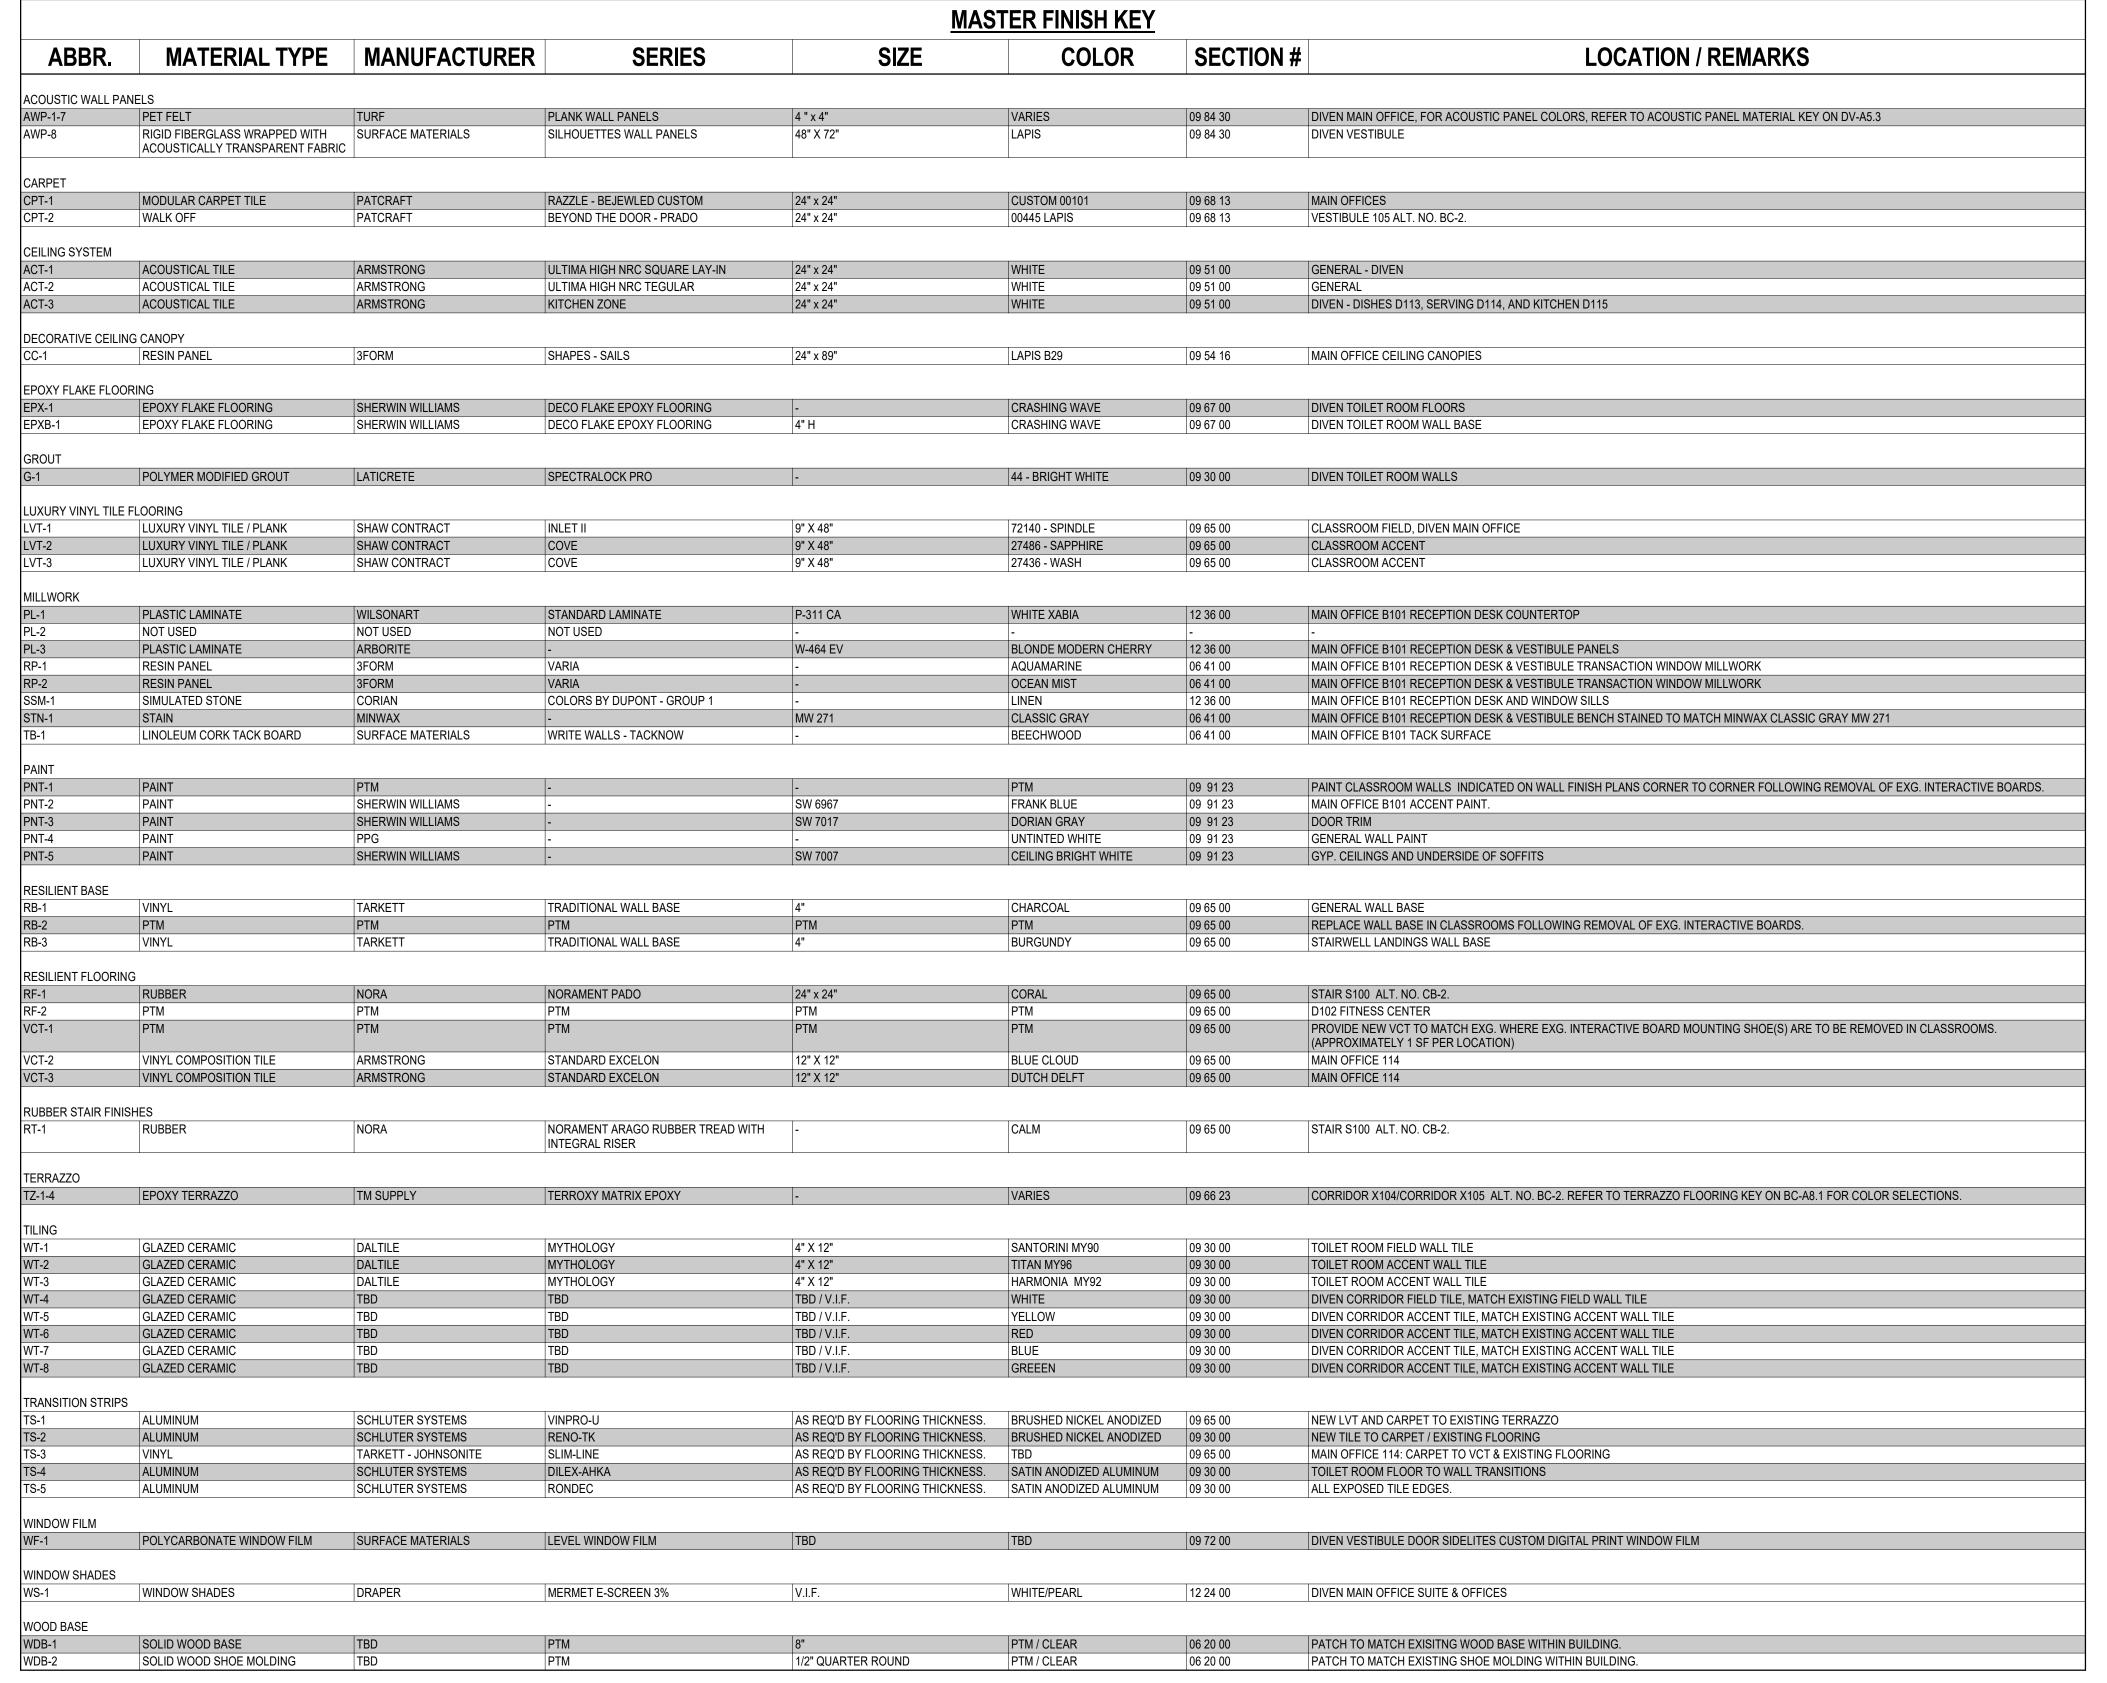

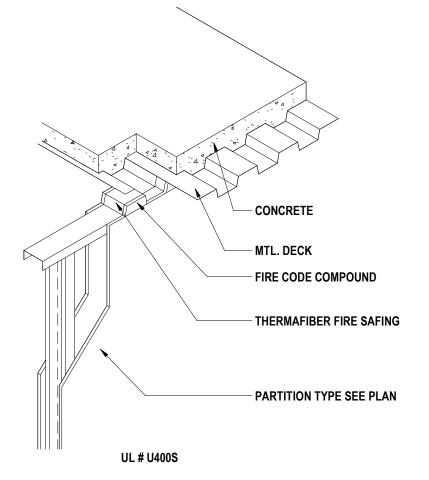

* CUT FLANGES TO 3 1/2" WIDTH AT BEARING ENDS

NOTE: PROVIDE FIRESTOP AT ALL PENETRATIONS THROUGH FIRE RATED PARTITIONS.

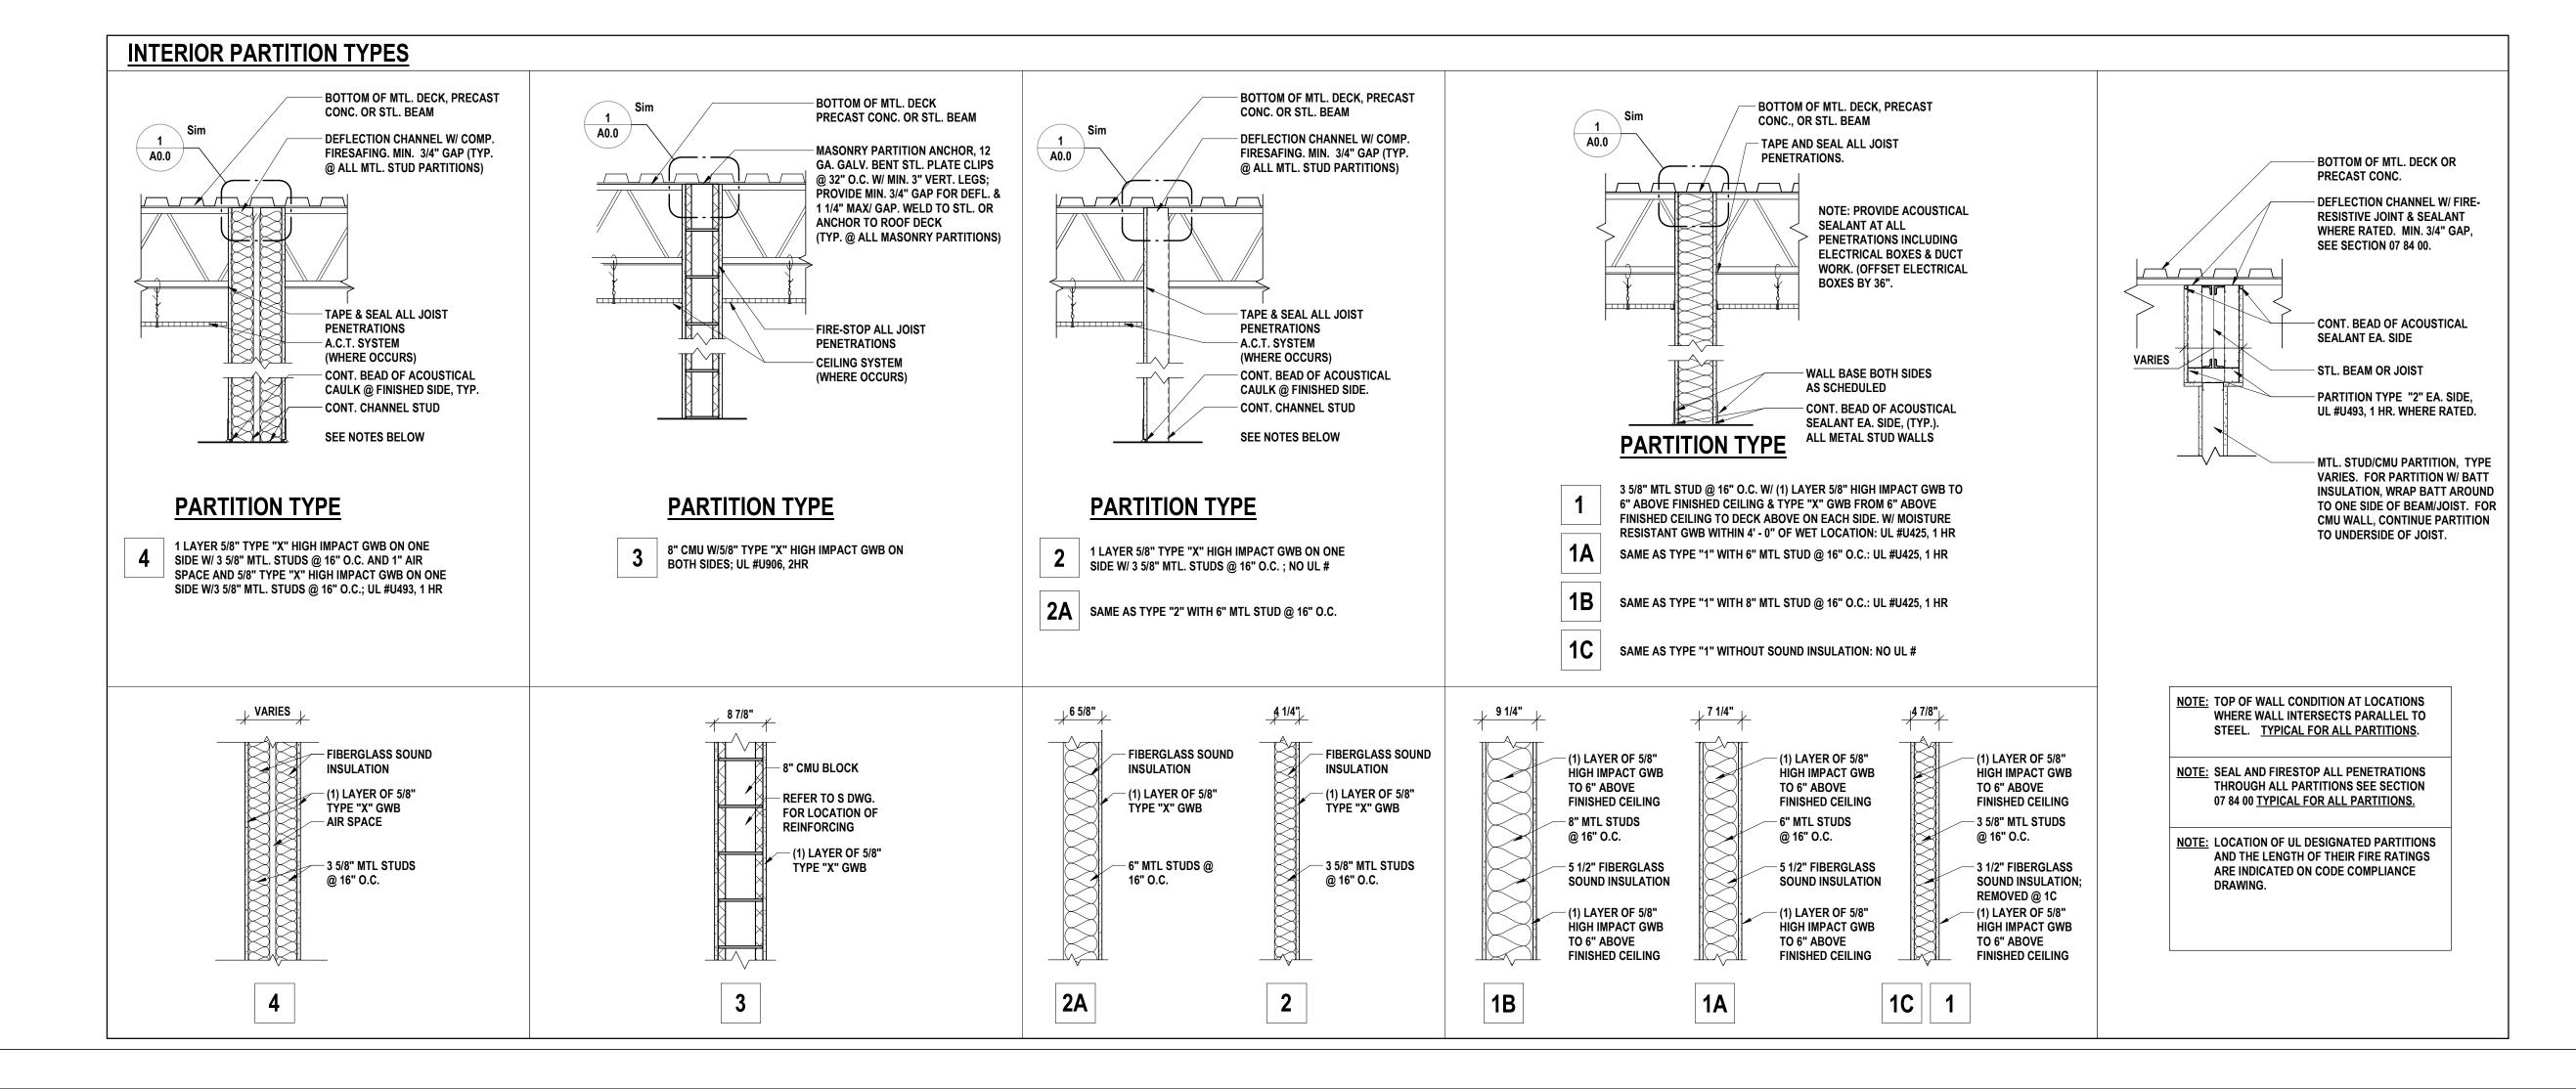


DRAWN BY: KAB SCC CHECKED BY: 10/21/2022 DATE: SCALE: As indicated

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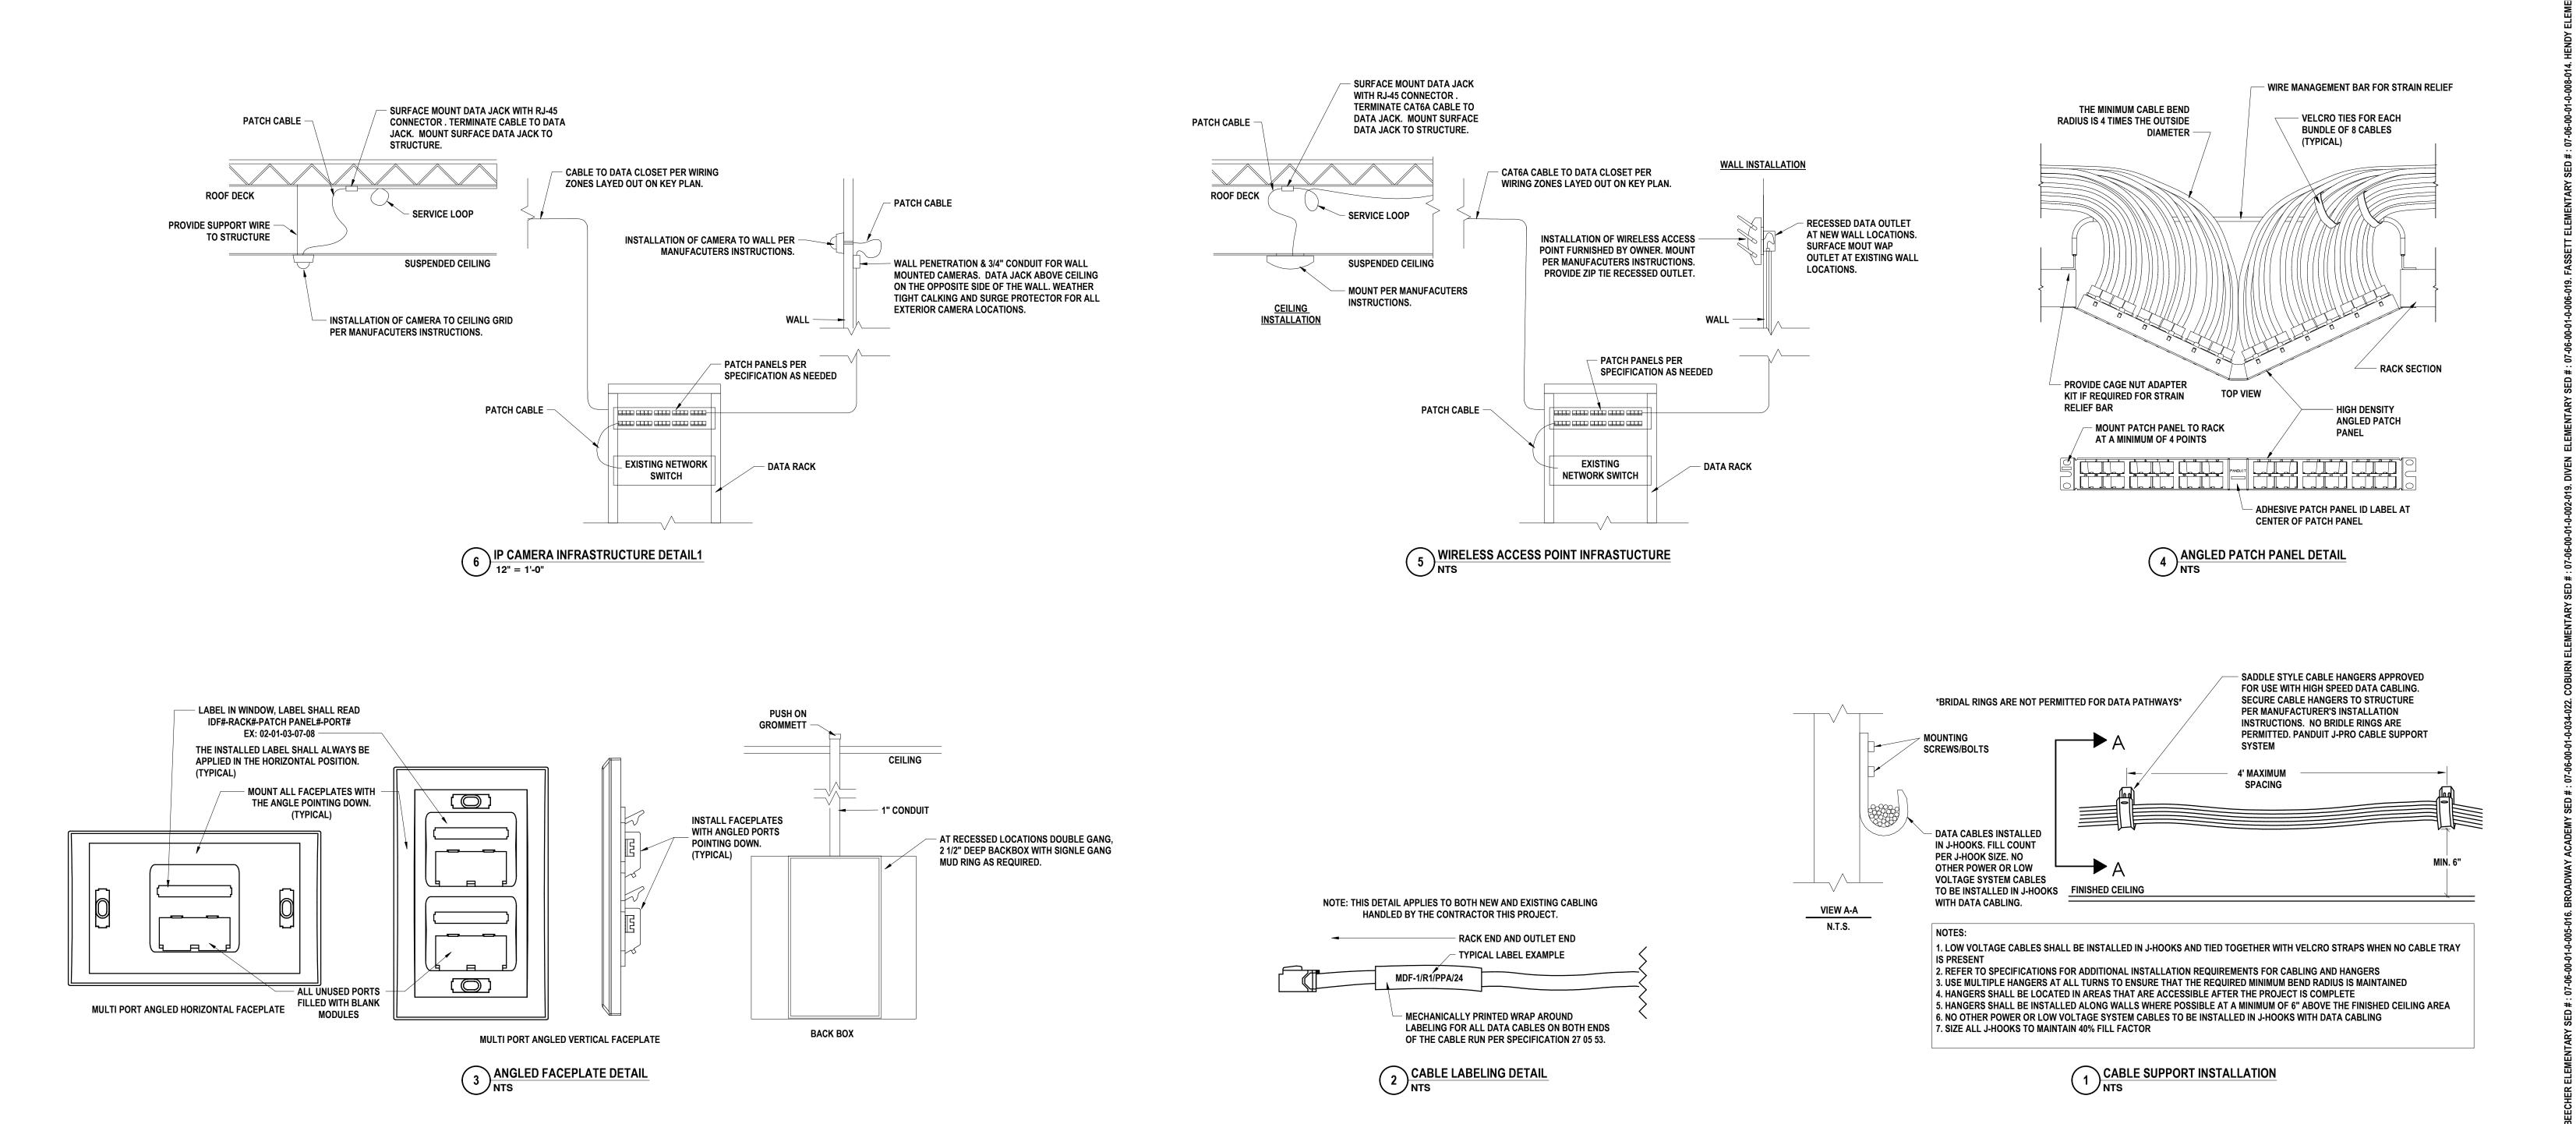
SCHE **ං**ජ ARY TYPE CH


WALL

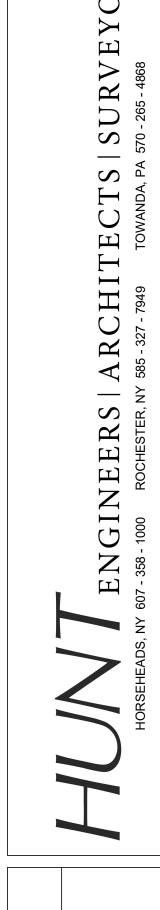

CH

PROJECT NO: 2012-233



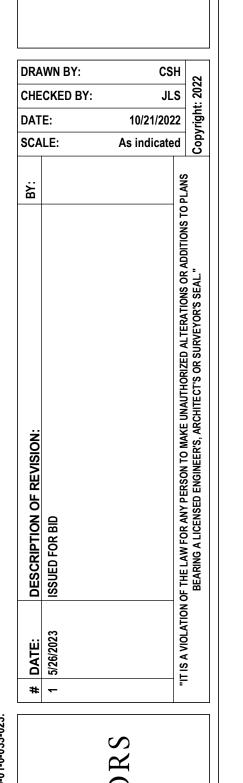

SUPPORT WIRE TO STRUCTURE ABOVE

(2) CONDUCTOR PLENUM RATED SPEAKER CABLE

SHIELDED FOR TALKBACK

WALL HORN

SPEAKER

APPLICATIONS (TYP) SIZE FOR VOLT DROP AND SPEAKER XFMR TAP

TYPICAL

CEILING

SPEAKER

■ TO PA SYSTEM

PUNCH DOWN

- ACT CEILING

MINIMUM TAP VALUES IN WATTS

MULTI POSITION TERMINAL BLOCK

PLANS -

SPEAKER CABLE -

FOR PUNCHING DOWN PA SPEAKER WIRING FOR SPEAKERS PER FLOOR

PLENUM RATED

AS REQUIRED -

BRIDGE -

TILE SUPPORT

BACKBOX

PA SYSTEM

SPEAKER

0 0

CEILING MOUNT

CLASSROOM: 0.625

CORRIDOR: 1.25

GYMNASIUM: 1.8

AUDITORIUM: 1.25


CAFETERIA: 1.25


PAGING SYSTEM AMP

EXISTING CABINET

TOILET ROOM: 0.312


EXTERIOR: 1.8

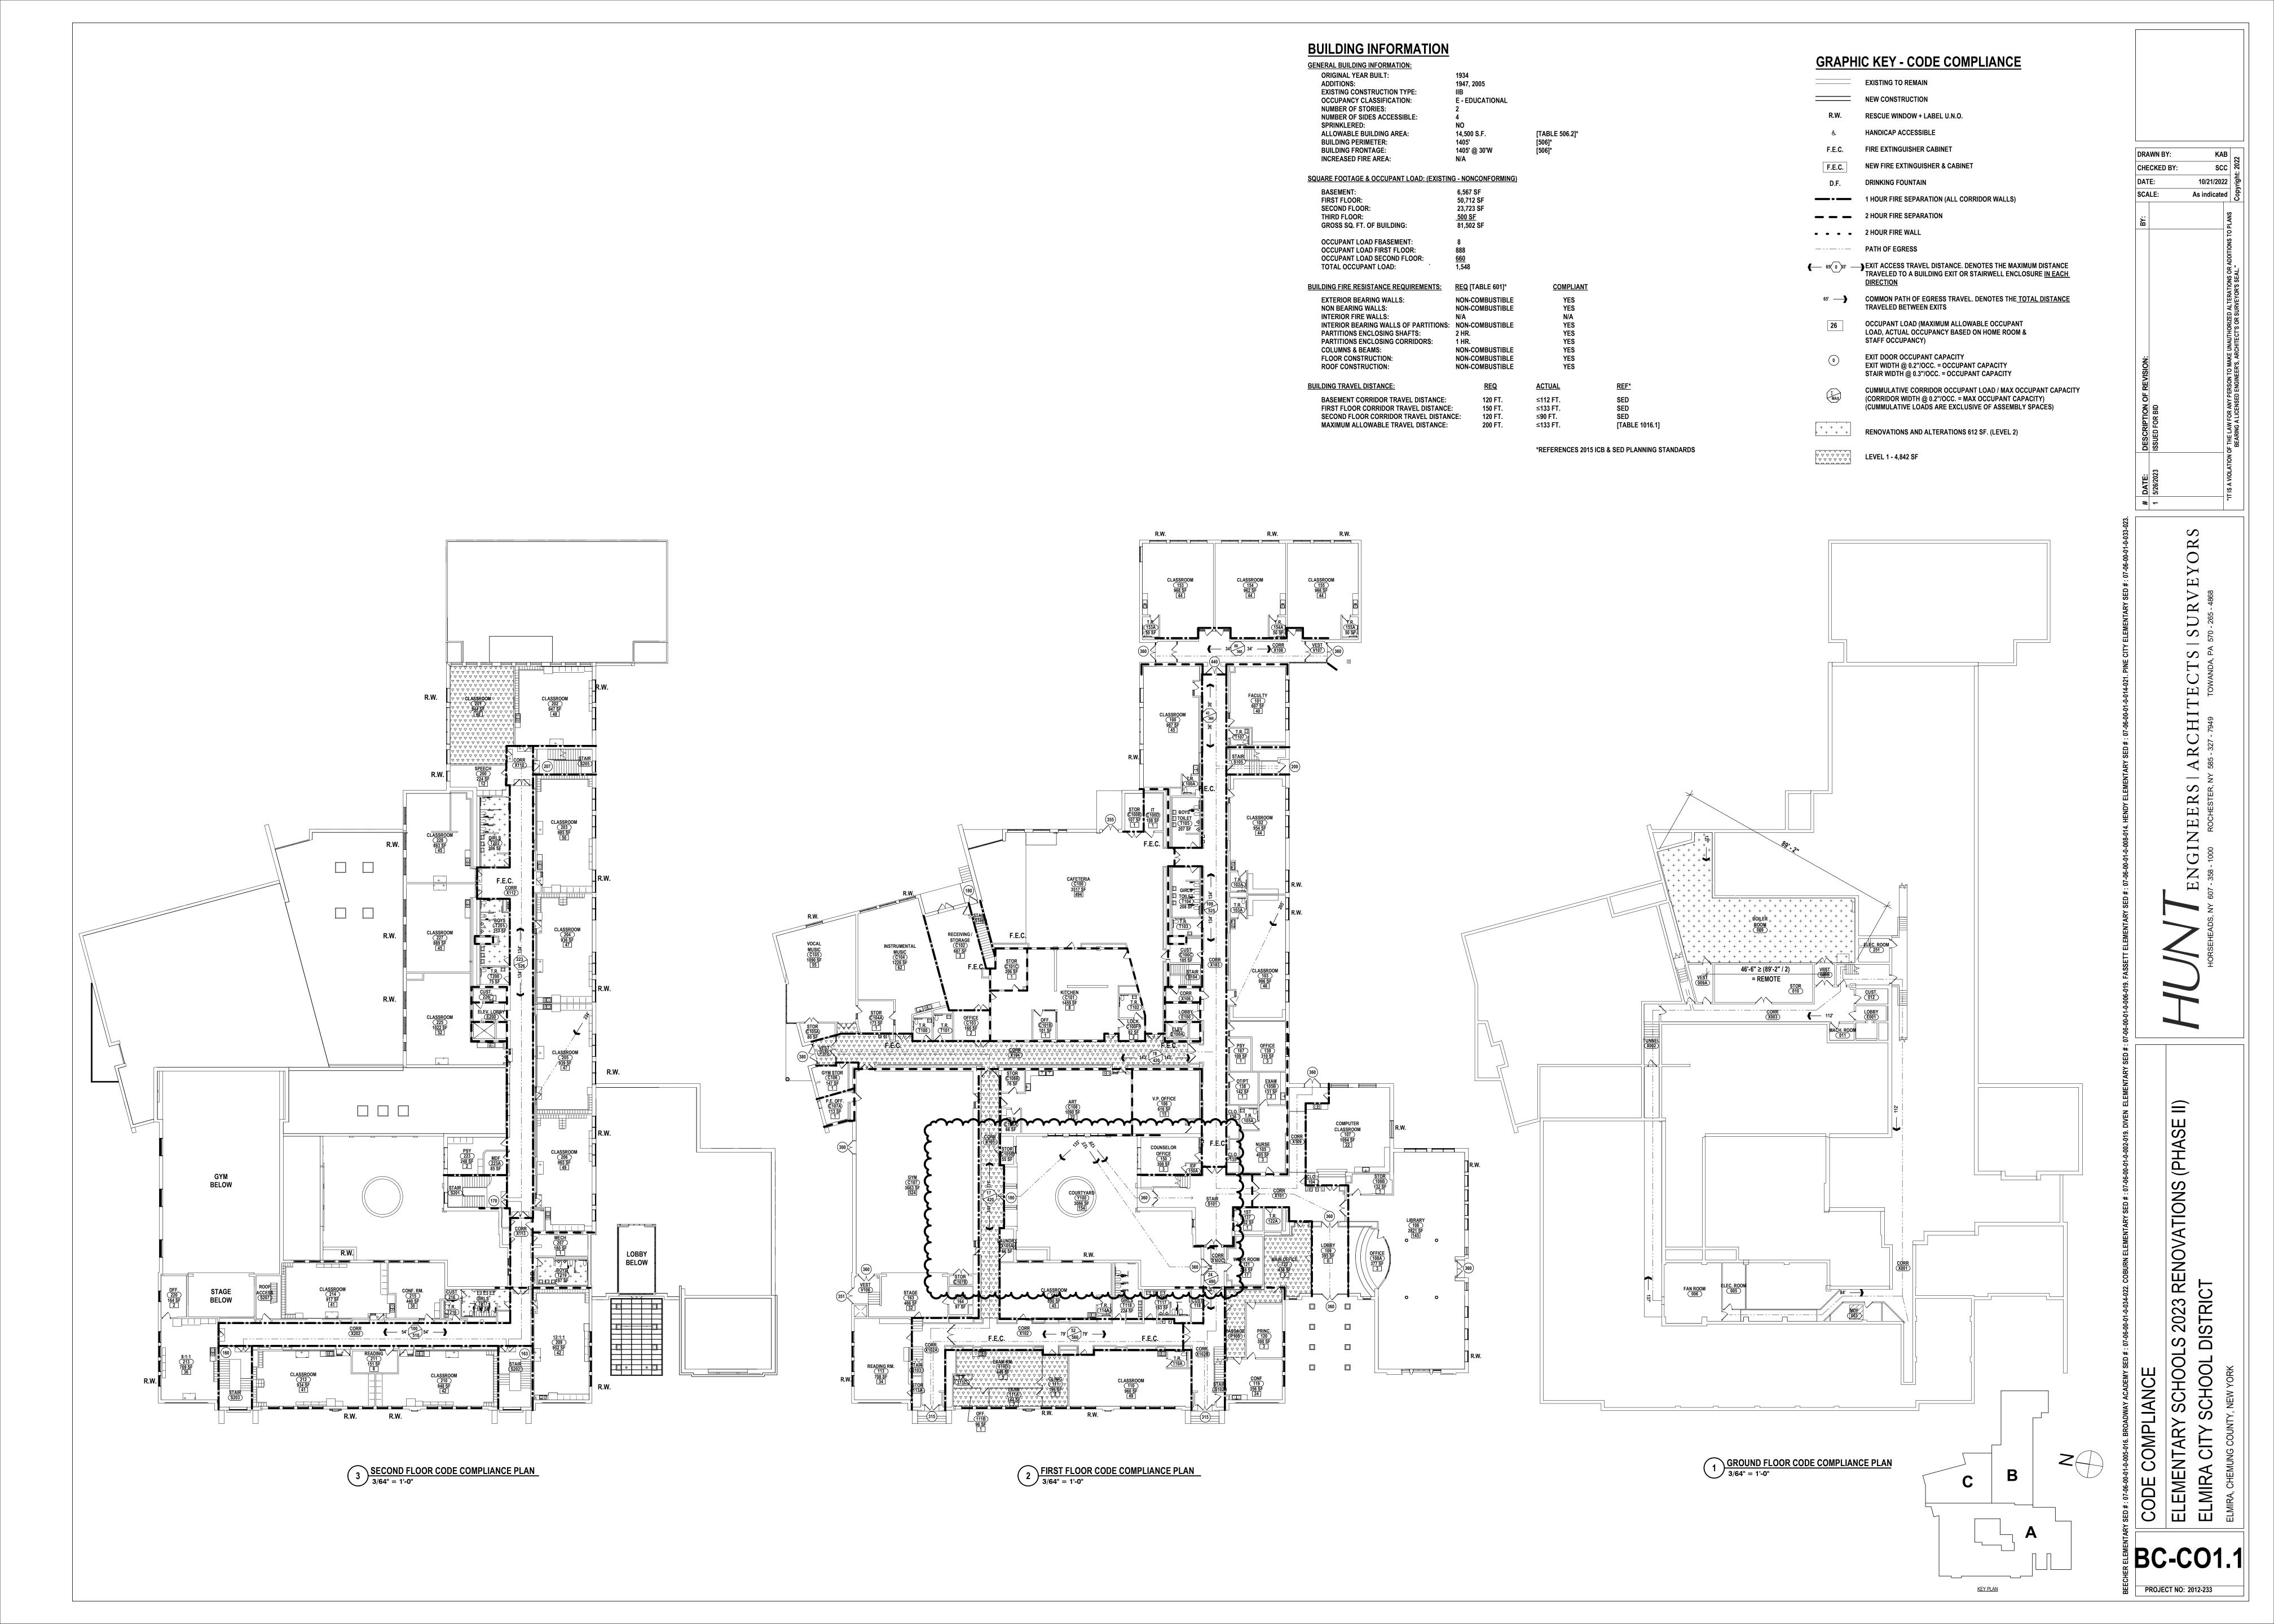

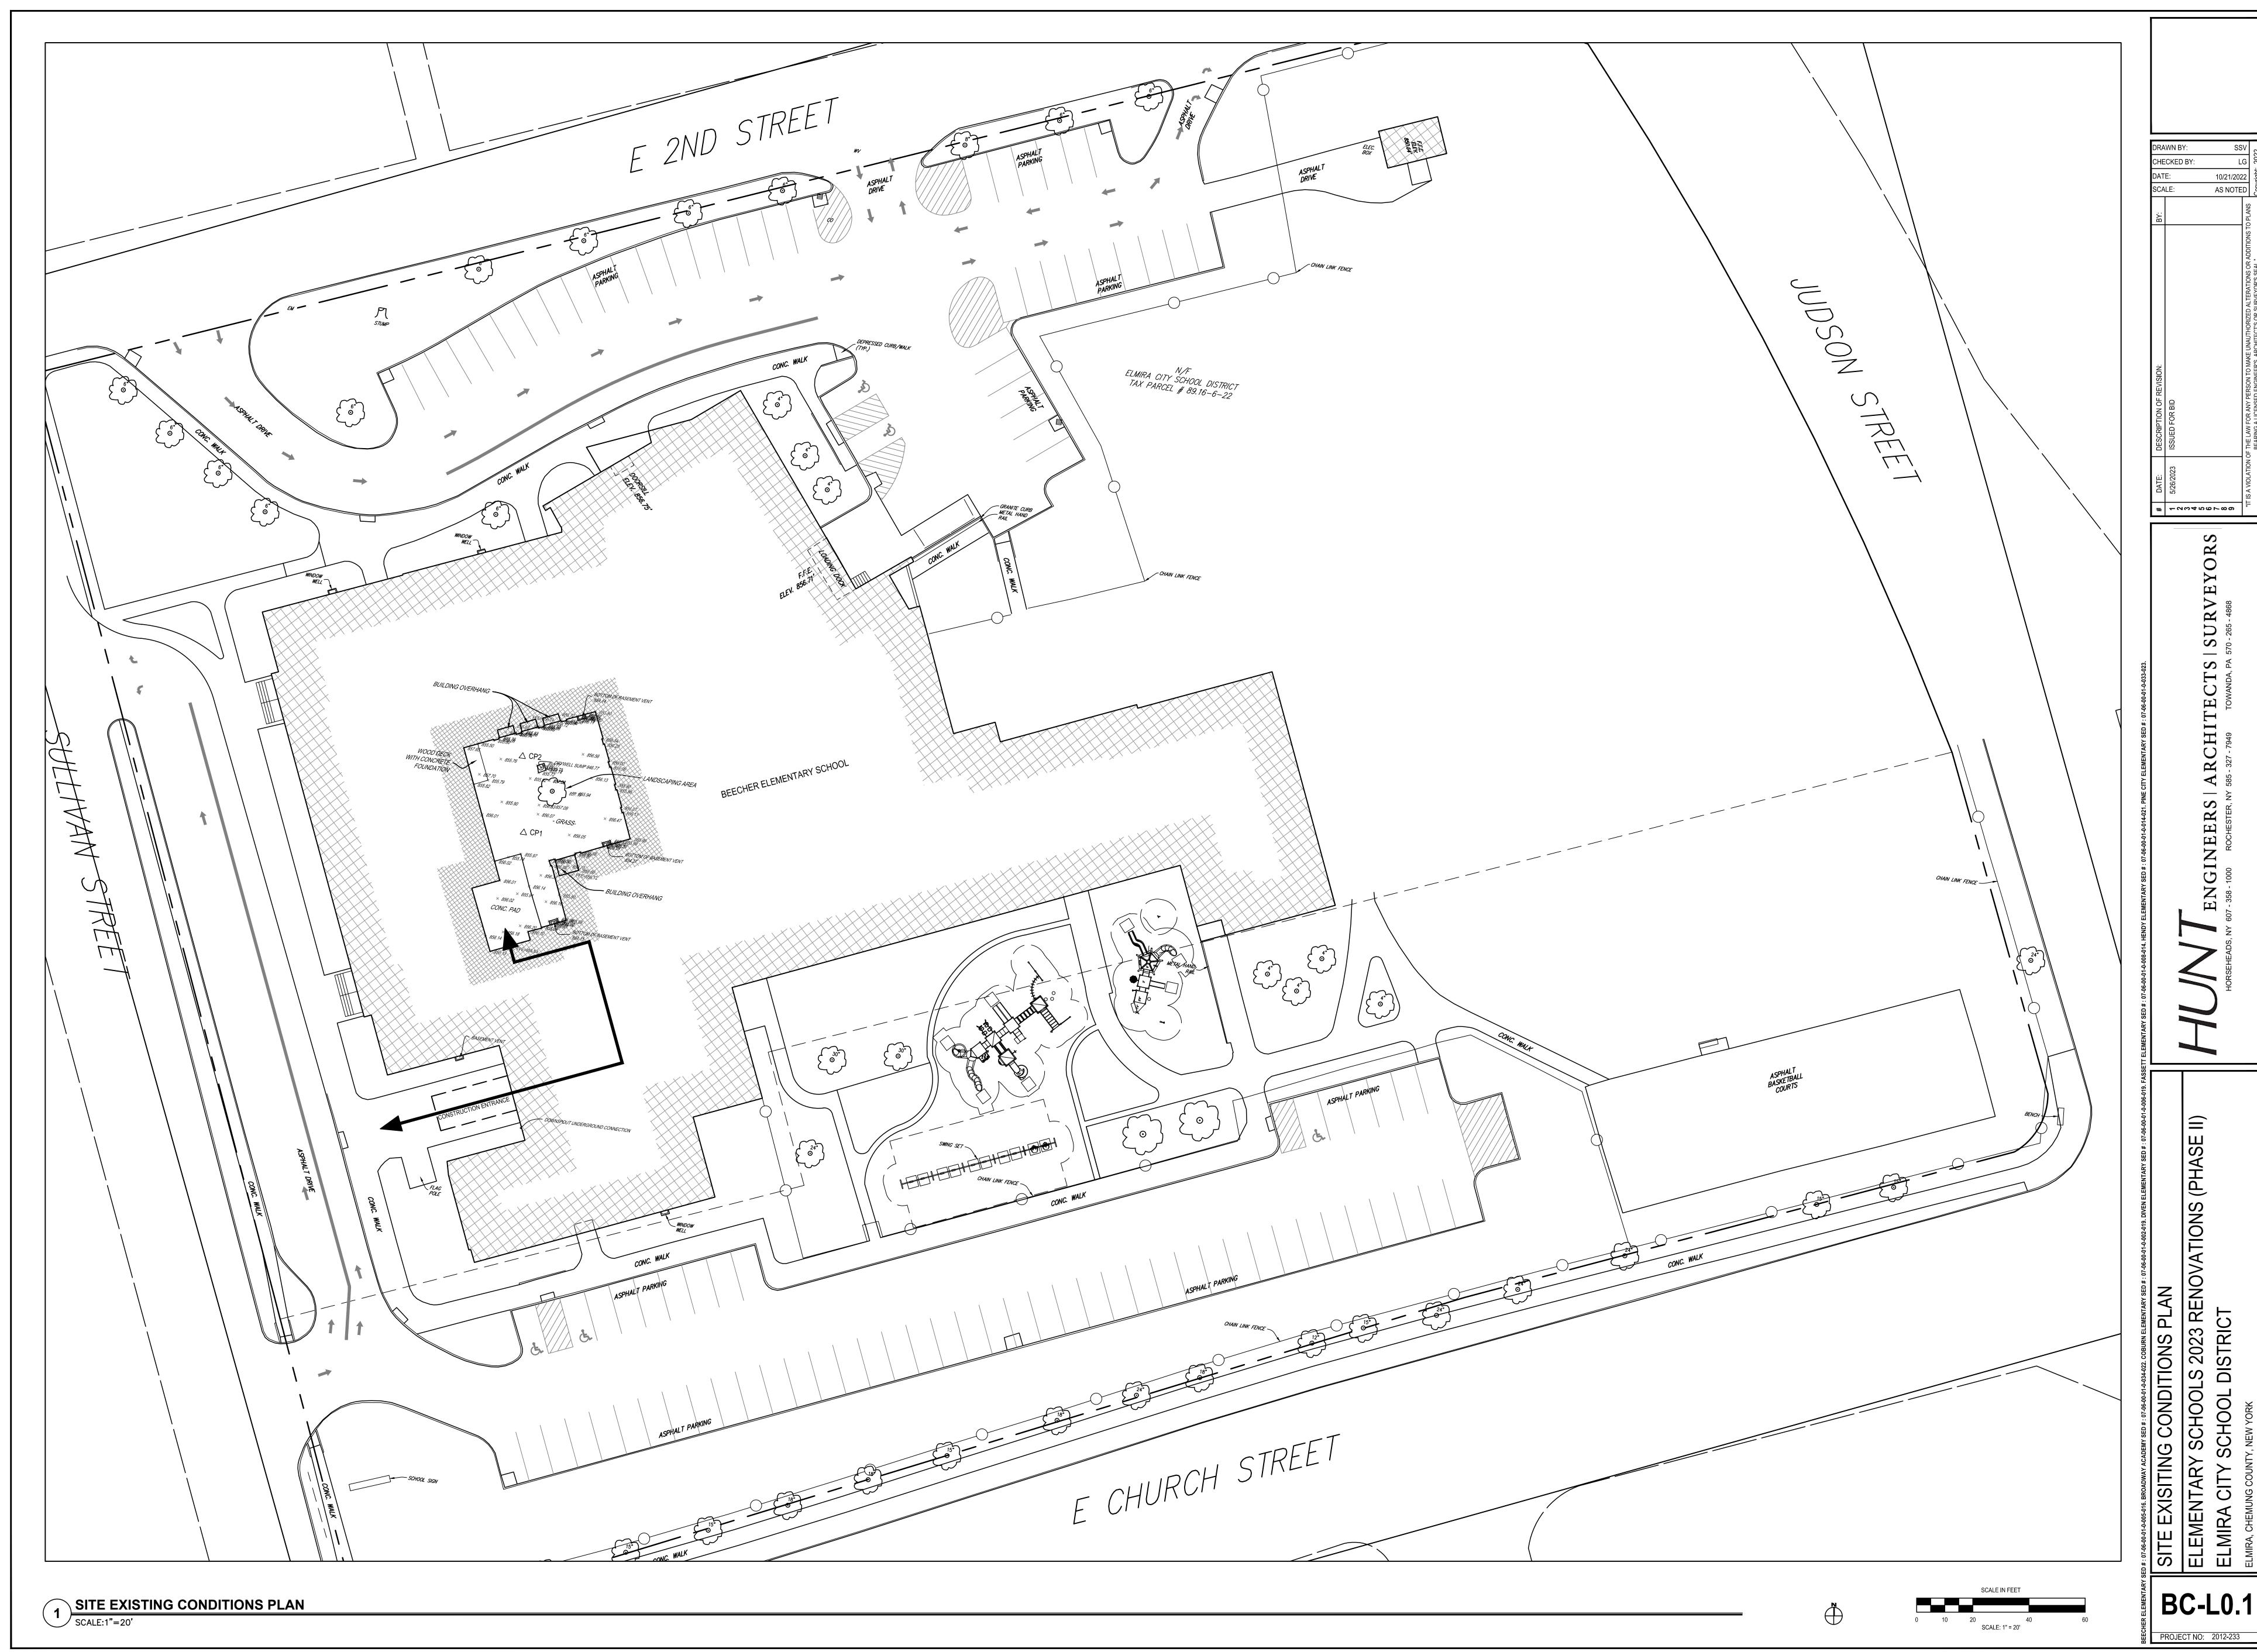

ENGINEERS | ARCHITEC

BC-L0.1

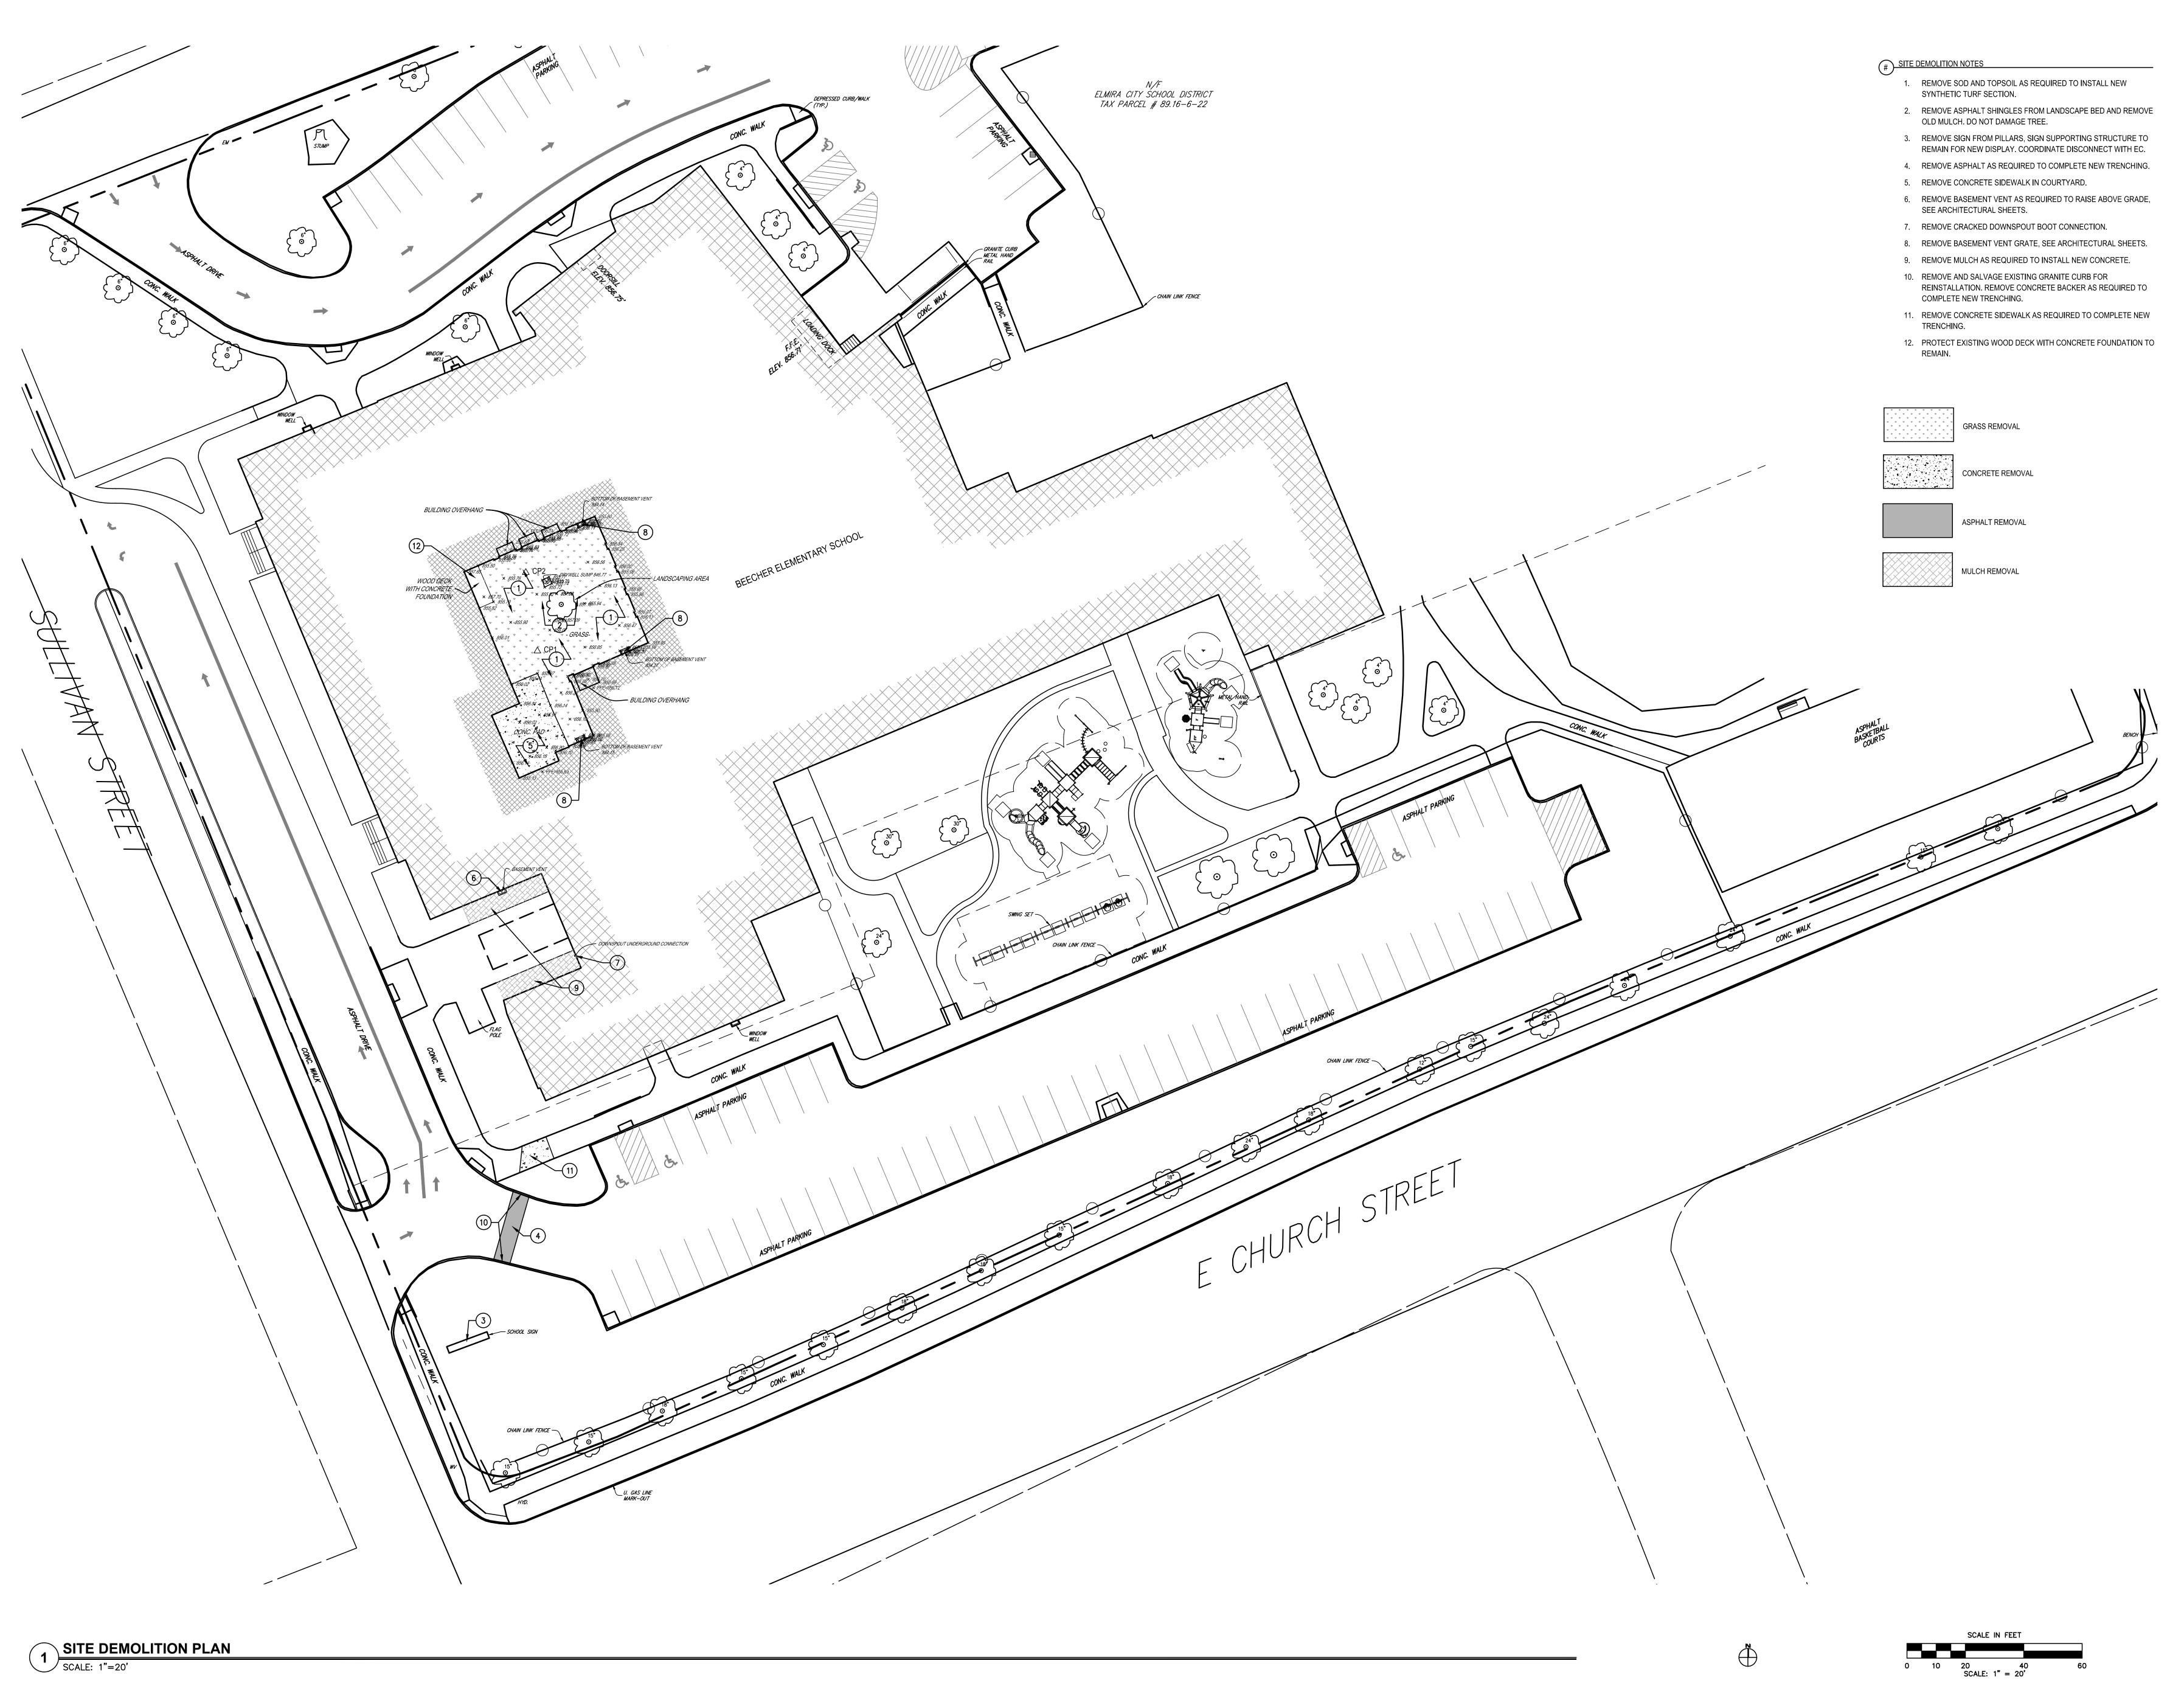


ENGINEERS | ARCHITECTS | SURVEYOI

AY SCHOOL DISTRICT

Y SCHOOL DISTRICT

BC-L1.1

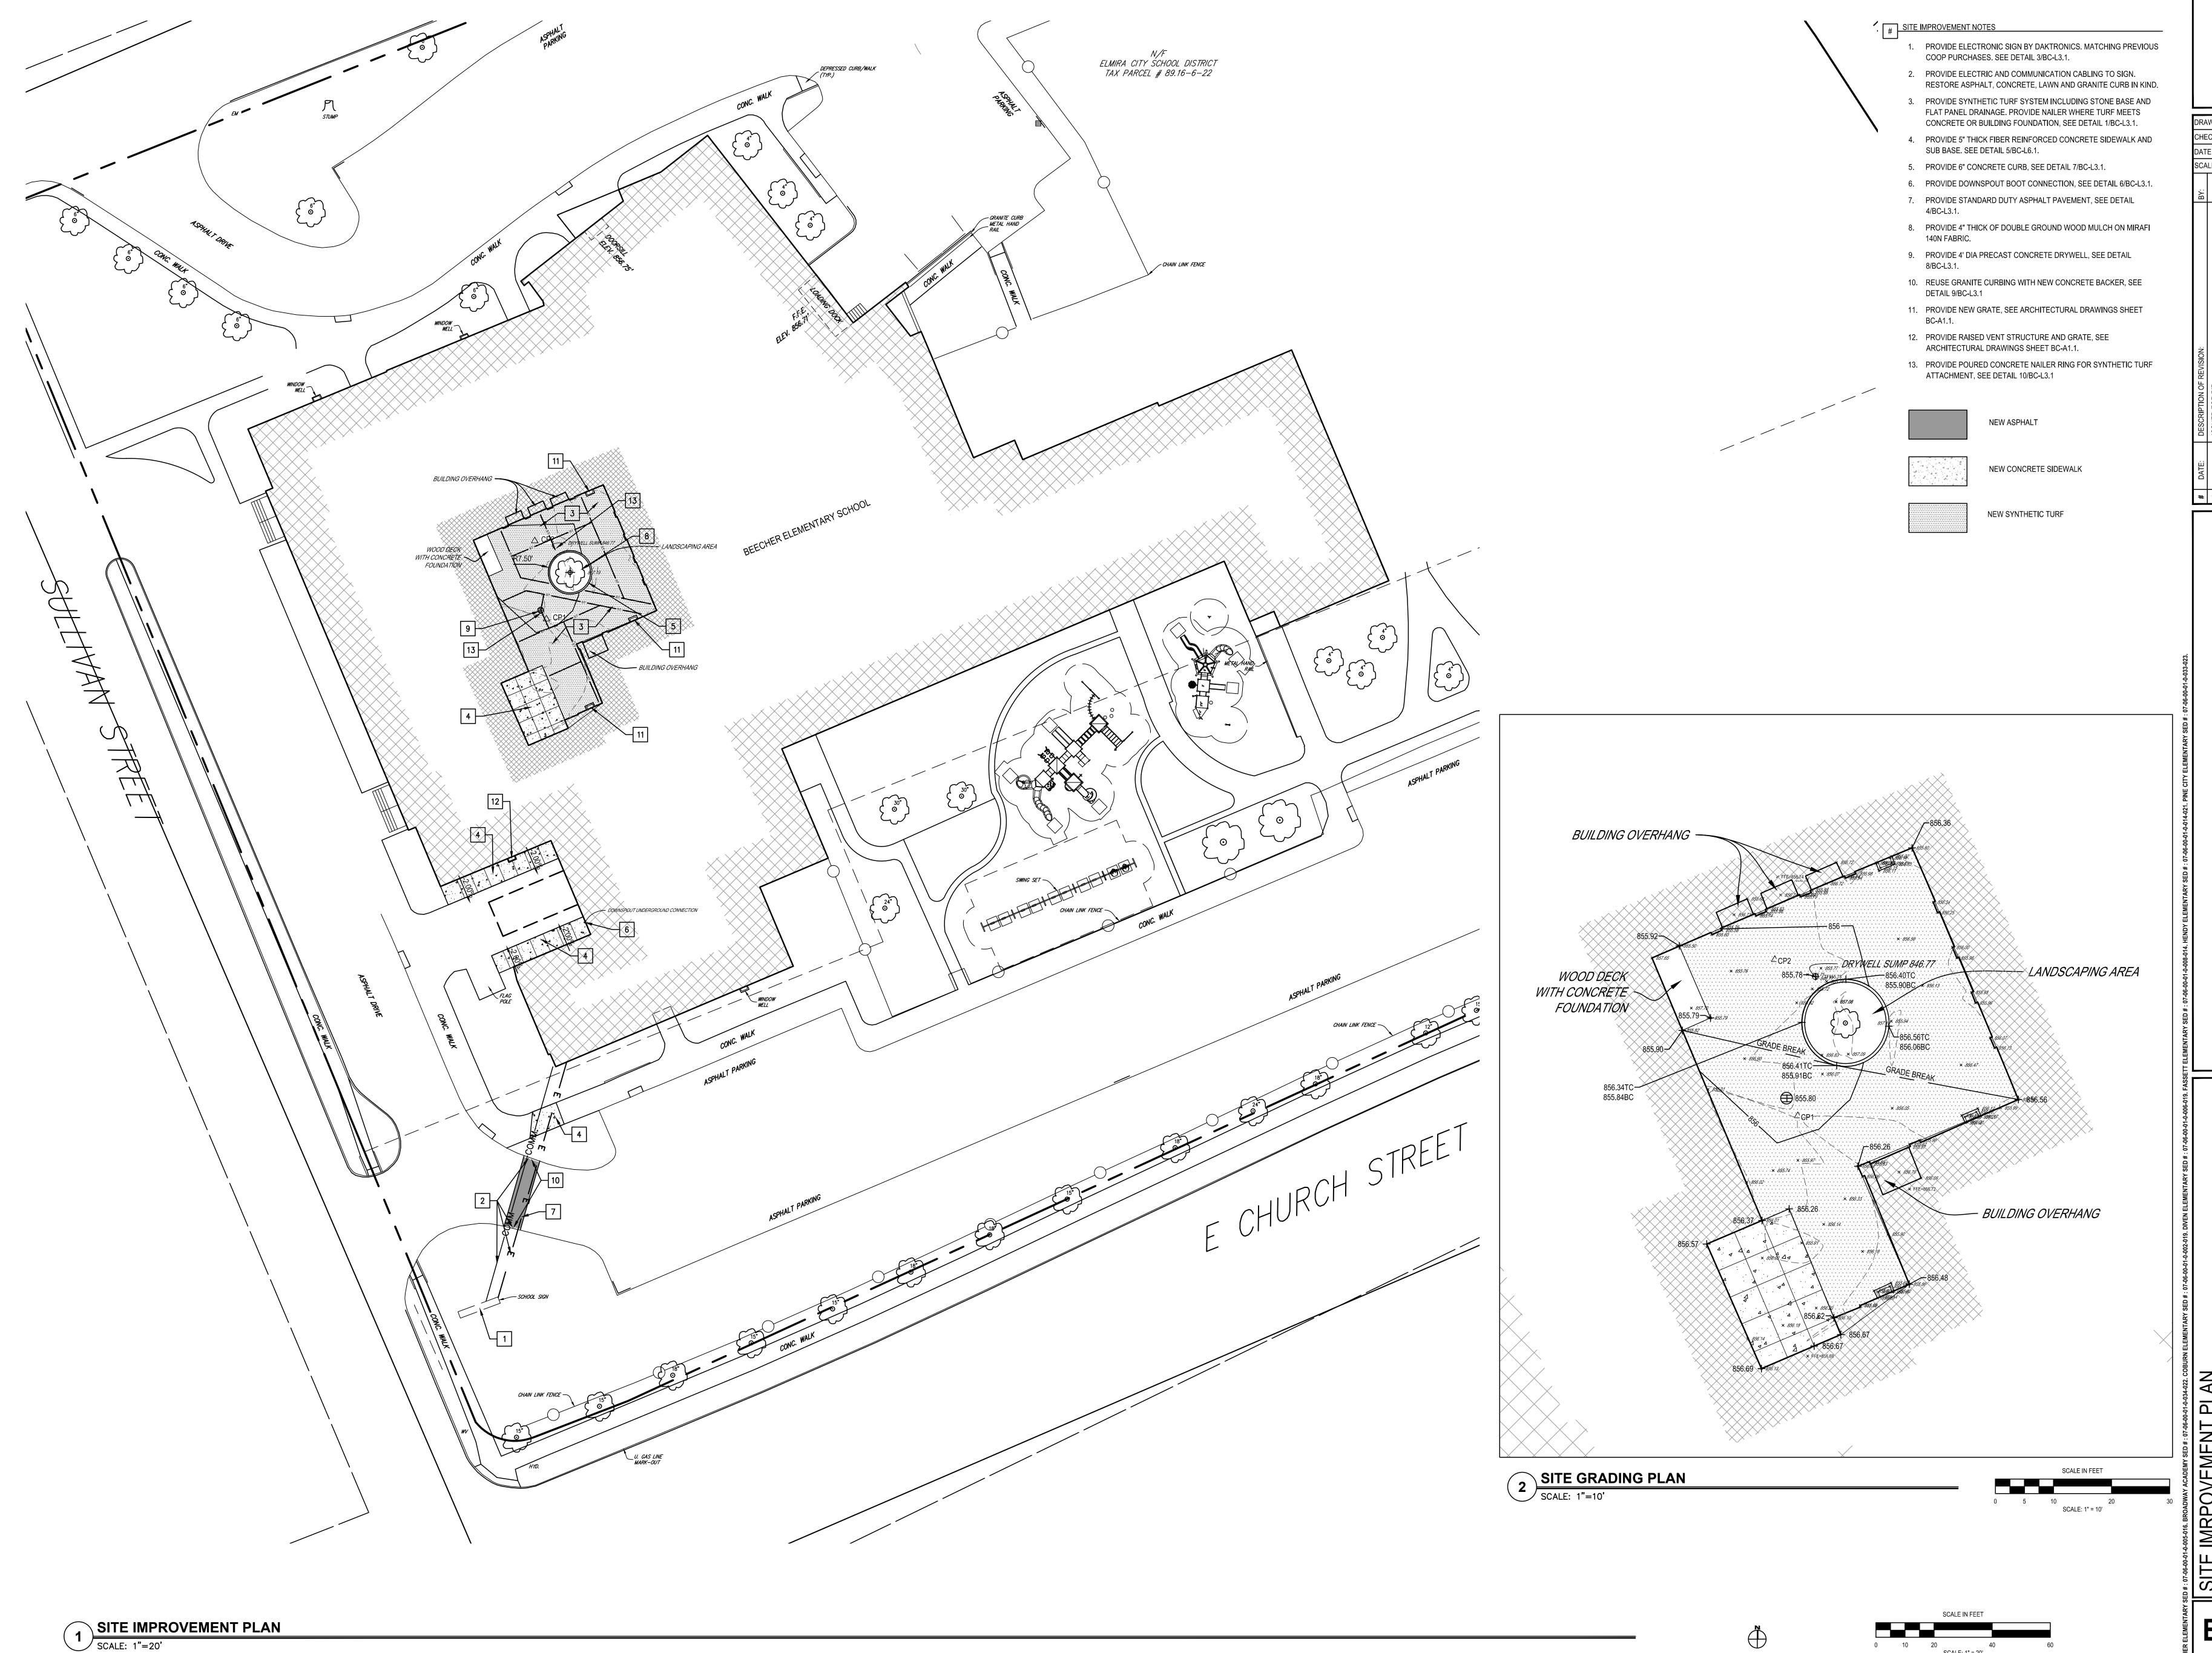

1 5/26/2023 ISSUED FOR BID
3 ISSUED FOR BID
3 ISSUED FOR BID
3 ISSUED FOR BID
3 ISSUED FOR BID
4 IS A VIOLATION OF THE LAW FOR ANY PERSON TO MAKE UNAUTHORIZED ALTERATIONS OR ADDITIONS TO PLANS
BEARING A LICENSED ENGINEERS, ARCHITECT'S OR SURVEYOR'S SEAL."

Copyright: 2022

HORSEHEADS, NY 607 - 358 - 1000 ROCHESTER, NY 585 - 327 - 7949 TOWANDA, PA 570 - 2

SCHOOLS 2023 RENOVATIONS (PHASE II)

SITE IMRPOVEMENT PLAN
ELEMENTARY SCHOOLS 202
ELMIRA CITY SCHOOL DISTF

BC-L2.1




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RV

S ____

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10/21/2022 AS NOTED 3





WATERTIGHT -CONNECTION (TYP.) CLEANOUT — — 1" RADIUS, TYP. MOUNTING LUG WITH WALL — FRAME & GRATE SYRACUSE SPACER CASTING 2379 NEENAH FOUNDRY CONCRETE CURB R-4820 OR APPROVED EQUAL, SEE SIDEWALK DETAIL — DRAIN HOLE DETAIL PROVIDE PLAYGROUND RUBBER DOUBLE GROUND — DRAINAGE MANHOLE COVER WOOD MULCH FINISH GRADE CONCRETE — GEOTEXTILE FABRIC MIRIFI 140 OR APPROVED EQUAL TO WRAP CHAMBER AND THE 6" — SYNTHETIC GRASS TO 9" DIA IRREGULAR STONE SURFACING SLOPES OF EXCAVATION TO MIRAFI 140N FABRIC — CONFORM TO O.S.H.A. OR APPROVED EQUAL REGULATIONS 6" TO 9" DIA. IRREGULARS 30" FOR 4' DIA DRYWELL 48" FOR 7.5' DIA DRYWELL – 12" BASE LAYER NYSDOT #1 & #2 CRUSHED STONE COMPACTED TO 95% UNCOMPACTED — DENSITY (MIN.) ASTM *CONTROL JOINTS CAN BE SAWCUT OR SOIL D-1557 TOOLED. SAWCUT: 1/8" TO 1/4" WIDE AND 1 1/2" NOTE:

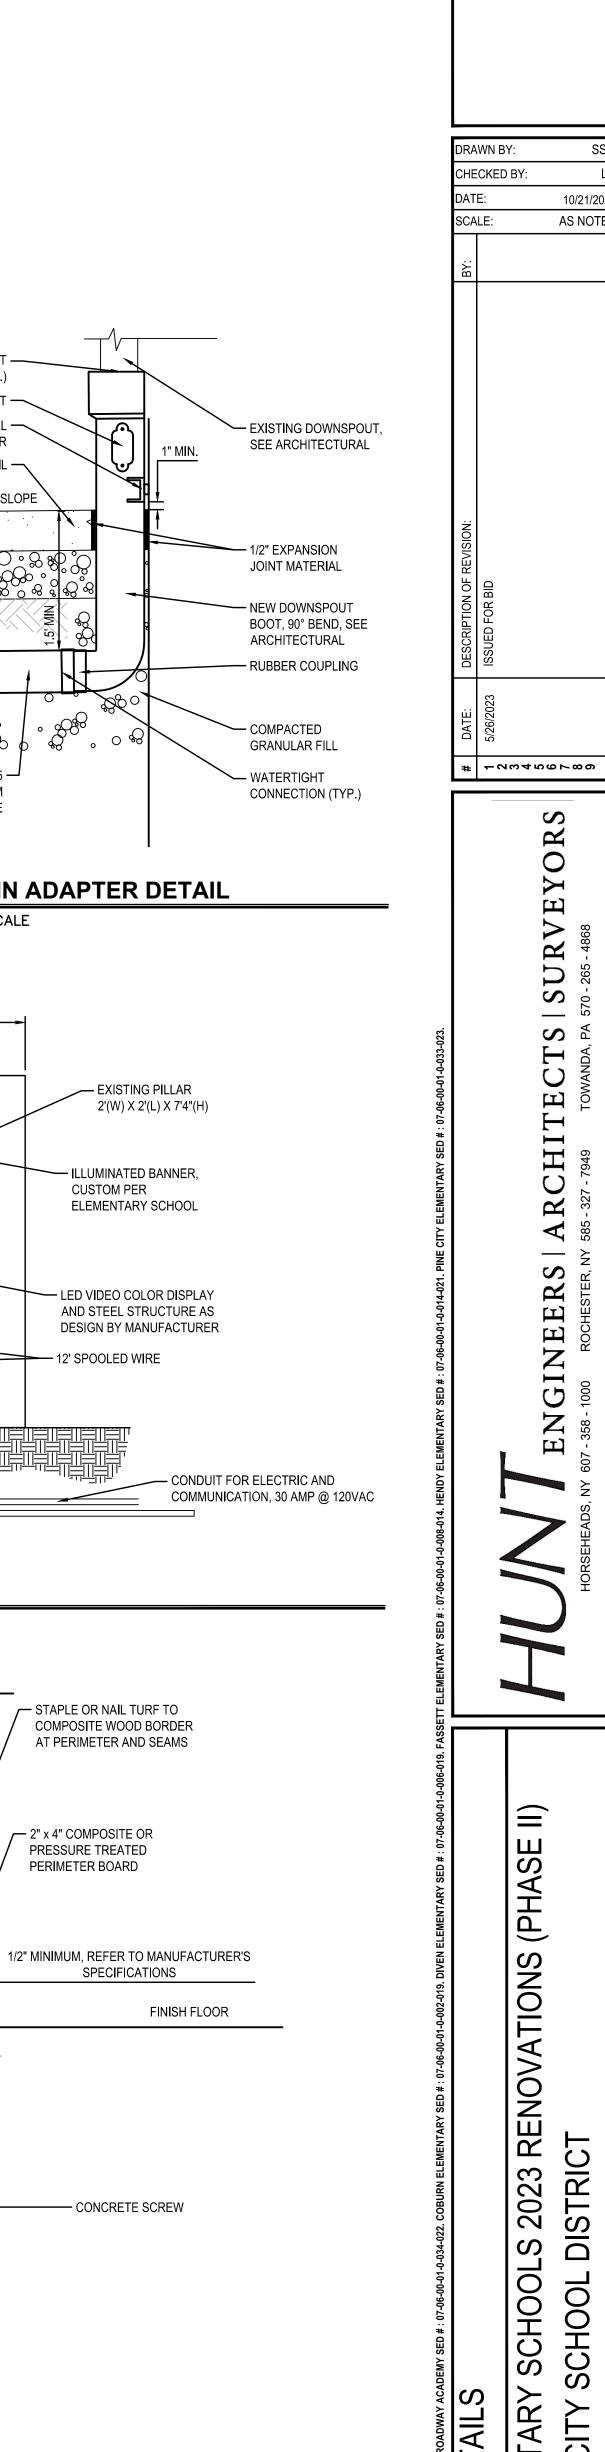
DRYWELL TO BE CERTIFIED TO CARRY H-20 HIGHWAY LOADING, AS MFG. BY ZEISER-WILBERT DEEP EVERY 10'. TOOLED: 1 1/2" DEEP AND GRANULAR FILL EVERY 10'. USE 3/4" PRE-MOLDED EXPANSION VAULT, INC. OR APPROVED EQUAL WHEN IN PAVED AREAS. JOINT WHERE SINGLE POUR ENDS. CONCRETE CURB DETAIL ✓ SCALE:NOT TO SCALE SCALE:NOT TO SCALE SCALE:NOT TO SCALE 7'-5 3/8"


SCALE:NOT TO SCALE

— STAPLE OR NAIL TURF TO COMPOSITE WOOD BORDER

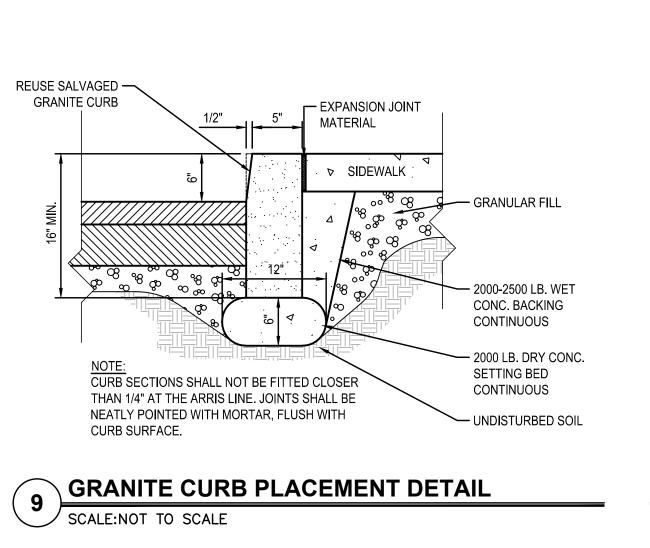

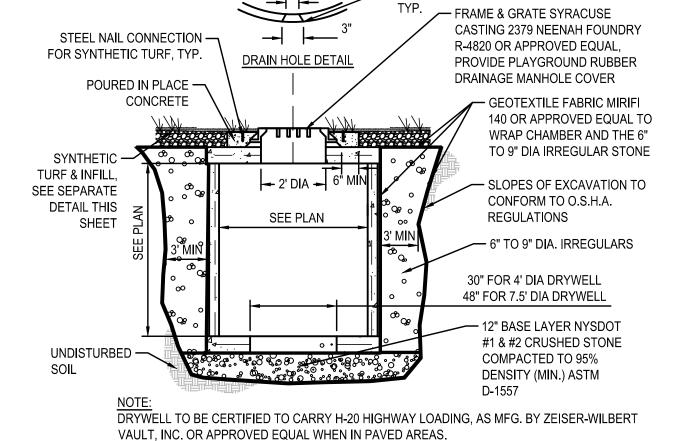

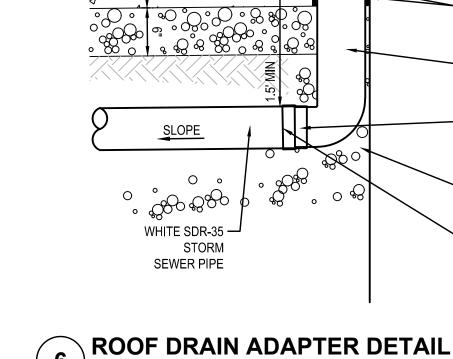

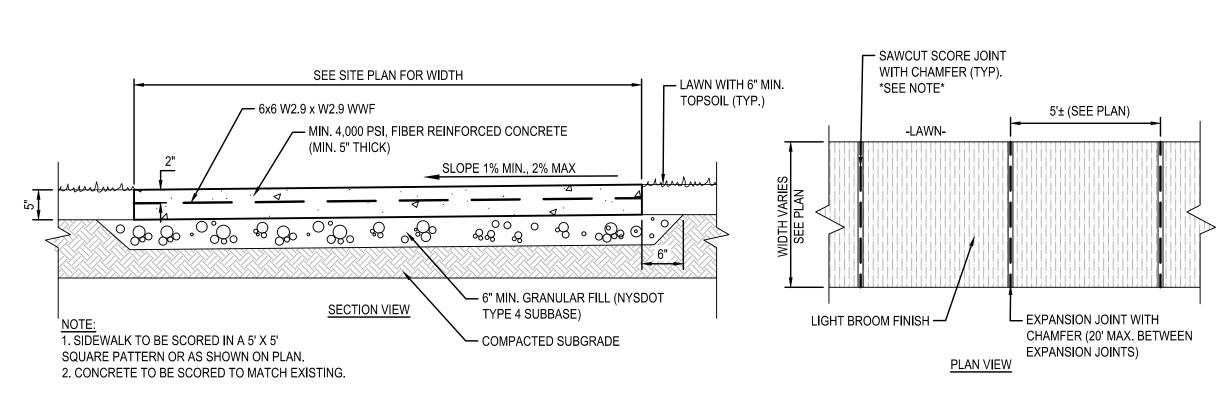

CONCRETE SIDEWALK DETAIL SCALE:NOT TO SCALE

- FRAME & GRATE SYRACUSE

CASTING 2379 NEENAH FOUNDRY

PROVIDE PLAYGROUND RUBBER

STEEL NAIL CONNECTION

— POURED IN PLACE

— EXISTING STRUCTURE

FOR SYNTHETIC TURF, TYP.

R-4820 OR APPROVED EQUAL,


DRAINAGE MANHOLE COVER

SYNTHETIC TURF & INFILL, —


SEE SEPARATE DETAIL

SCALE:NOT TO SCALE

SYNTHETIC TURF NAILER AT EXISTING DRYWELL

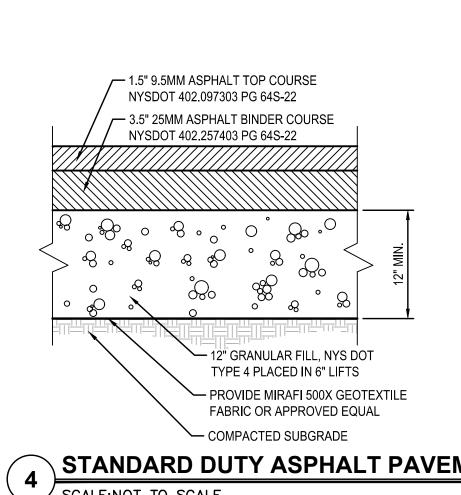

STANDARD DUTY ASPHALT PAVEMENT

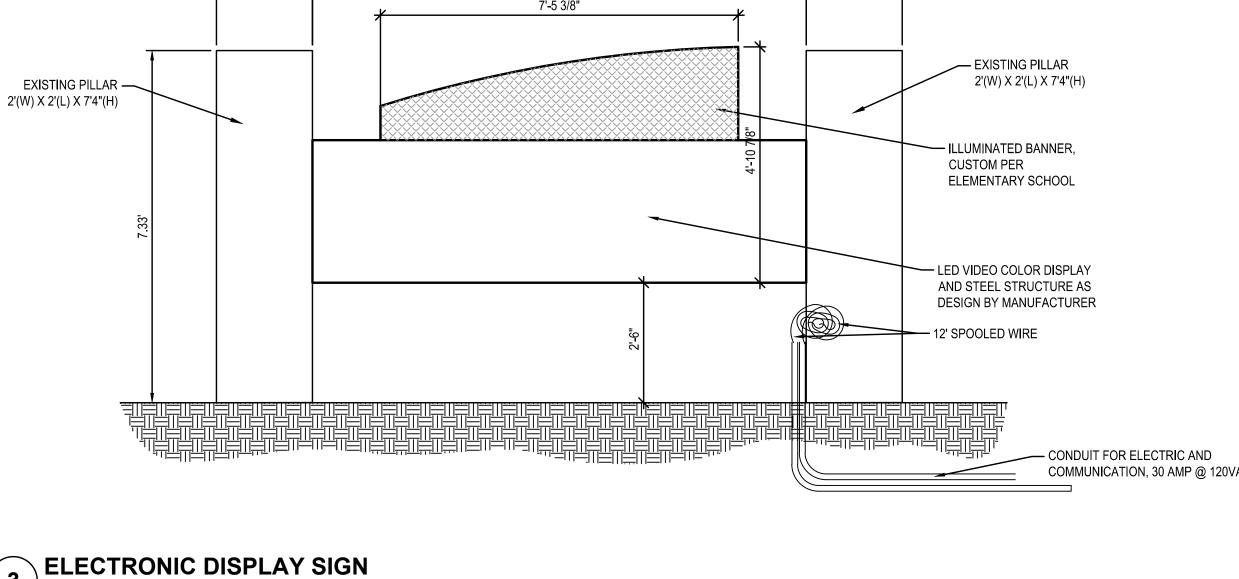

— SYNTHETIC GRASS SURFACING AND ENVIRO FILL. SEE SPECIFICATIONS

INFILL (SEE SPECS) —

COMPACTED -

AGGREGATE BASE (SEE SPECS)

HYDROWAY FLAT PANEL -

DRAIN (1" TALL)

GEOTEXTILE · MIRAFI 500X

NATIVE SUBGRADE · COMPACTED 95%

AT PERIMETER AND SEAMS ___ 2" x 4" COMPOSITE OR PRESSURE TREATED — SYNTHETIC GRASS SURFACING AND ENVIRO FILL. SEE SPECIFICATIONS PERIMETER BOARD 1/2" MINIMUM, REFER TO MANUFACTURER'S SPECIFICATIONS CONCRETE SIDEWALK INFILL (SEE SPECS) -COMPACTED -AGGREGATE BASE (SEE SPECS) HYDROWAY FLAT PANEL — DRAIN (1" TALL) GEOTEXTILE -MIRAFI 500X

NATIVE SUBGRADE — COMPACTED 95%

LANDSCAPE SYNTHETIC TURF WITH NAILER SCALE:NOT TO SCALE

TO CROWN DRIP LINE TREE PROTECTION FENCE: HIGH DENSITY POLYETHYLENE FENCING WITH 3.5" X 1.5" OPENINGS; COLOR-ORANGE. STEEL POSTS INSTALLED AT 8' O.C. 2" X 6' STEEL POSTS 8.5" x 11" SIGN LAMINATED IN OR APPROVED EQUAL PLASTIC SPACED EVERY 50' ALONG THE FENCE LAYER OF MULCH MAINTAIN EXISTING GRADE WITH THE TREE PROTECTION FENCE **UNLESS OTHERWISE** INDICATED ON THE PLANS 1. SEE SPECIFICATIONS FOR ADDITIONAL TREE PROTECTION REQUIREMENTS. IF THERE IS NO EXISTING IRRIGATION, SEE SPECIFICATIONS FOR WATERING REQUIREMENTS. 2. NO PRUNING SHALL BE PERFORMED EXCEPT BY APPROVED ARBORIST.

NO EQUIPMENT SHALL OPERATE INSIDE THE PROTECTIVE FENCING INCLUDING DURING FENCE INSTALLATION AND REMOVAL.
 SEE SITE IMPROVEMENT PLAN FOR ANY MODIFICATIONS WITH THE TREE PROTECTION AREA.

TREE PROTECTION DETAIL

SCALE:NOT TO SCALE

BC-L3.1 PROJECT NO: 2012-233

10/21/2022 SCALE: 1/8" = 1'-0"

> S ENGINEERS | ARCHITEC

S 2023 RENOVATIONS (PHASE DISTRICT FLOOR DEMO PLAN - AREA A

BC-A0.1




CHECKED BY: 10/21/2022 1/8" = 1'-0"

> S ENGINEERS | ARCHITEC

FIRST FLOOR DEMO PLAN - AREAS B
ELEMENTARY SCHOOLS 2023 RENOV/
ELMIRA CITY SCHOOL DISTRICT
ELMIRA, CHEMUNG COUNTY, NEW YORK

BC-A0.2

PROJECT NO: 2012-233

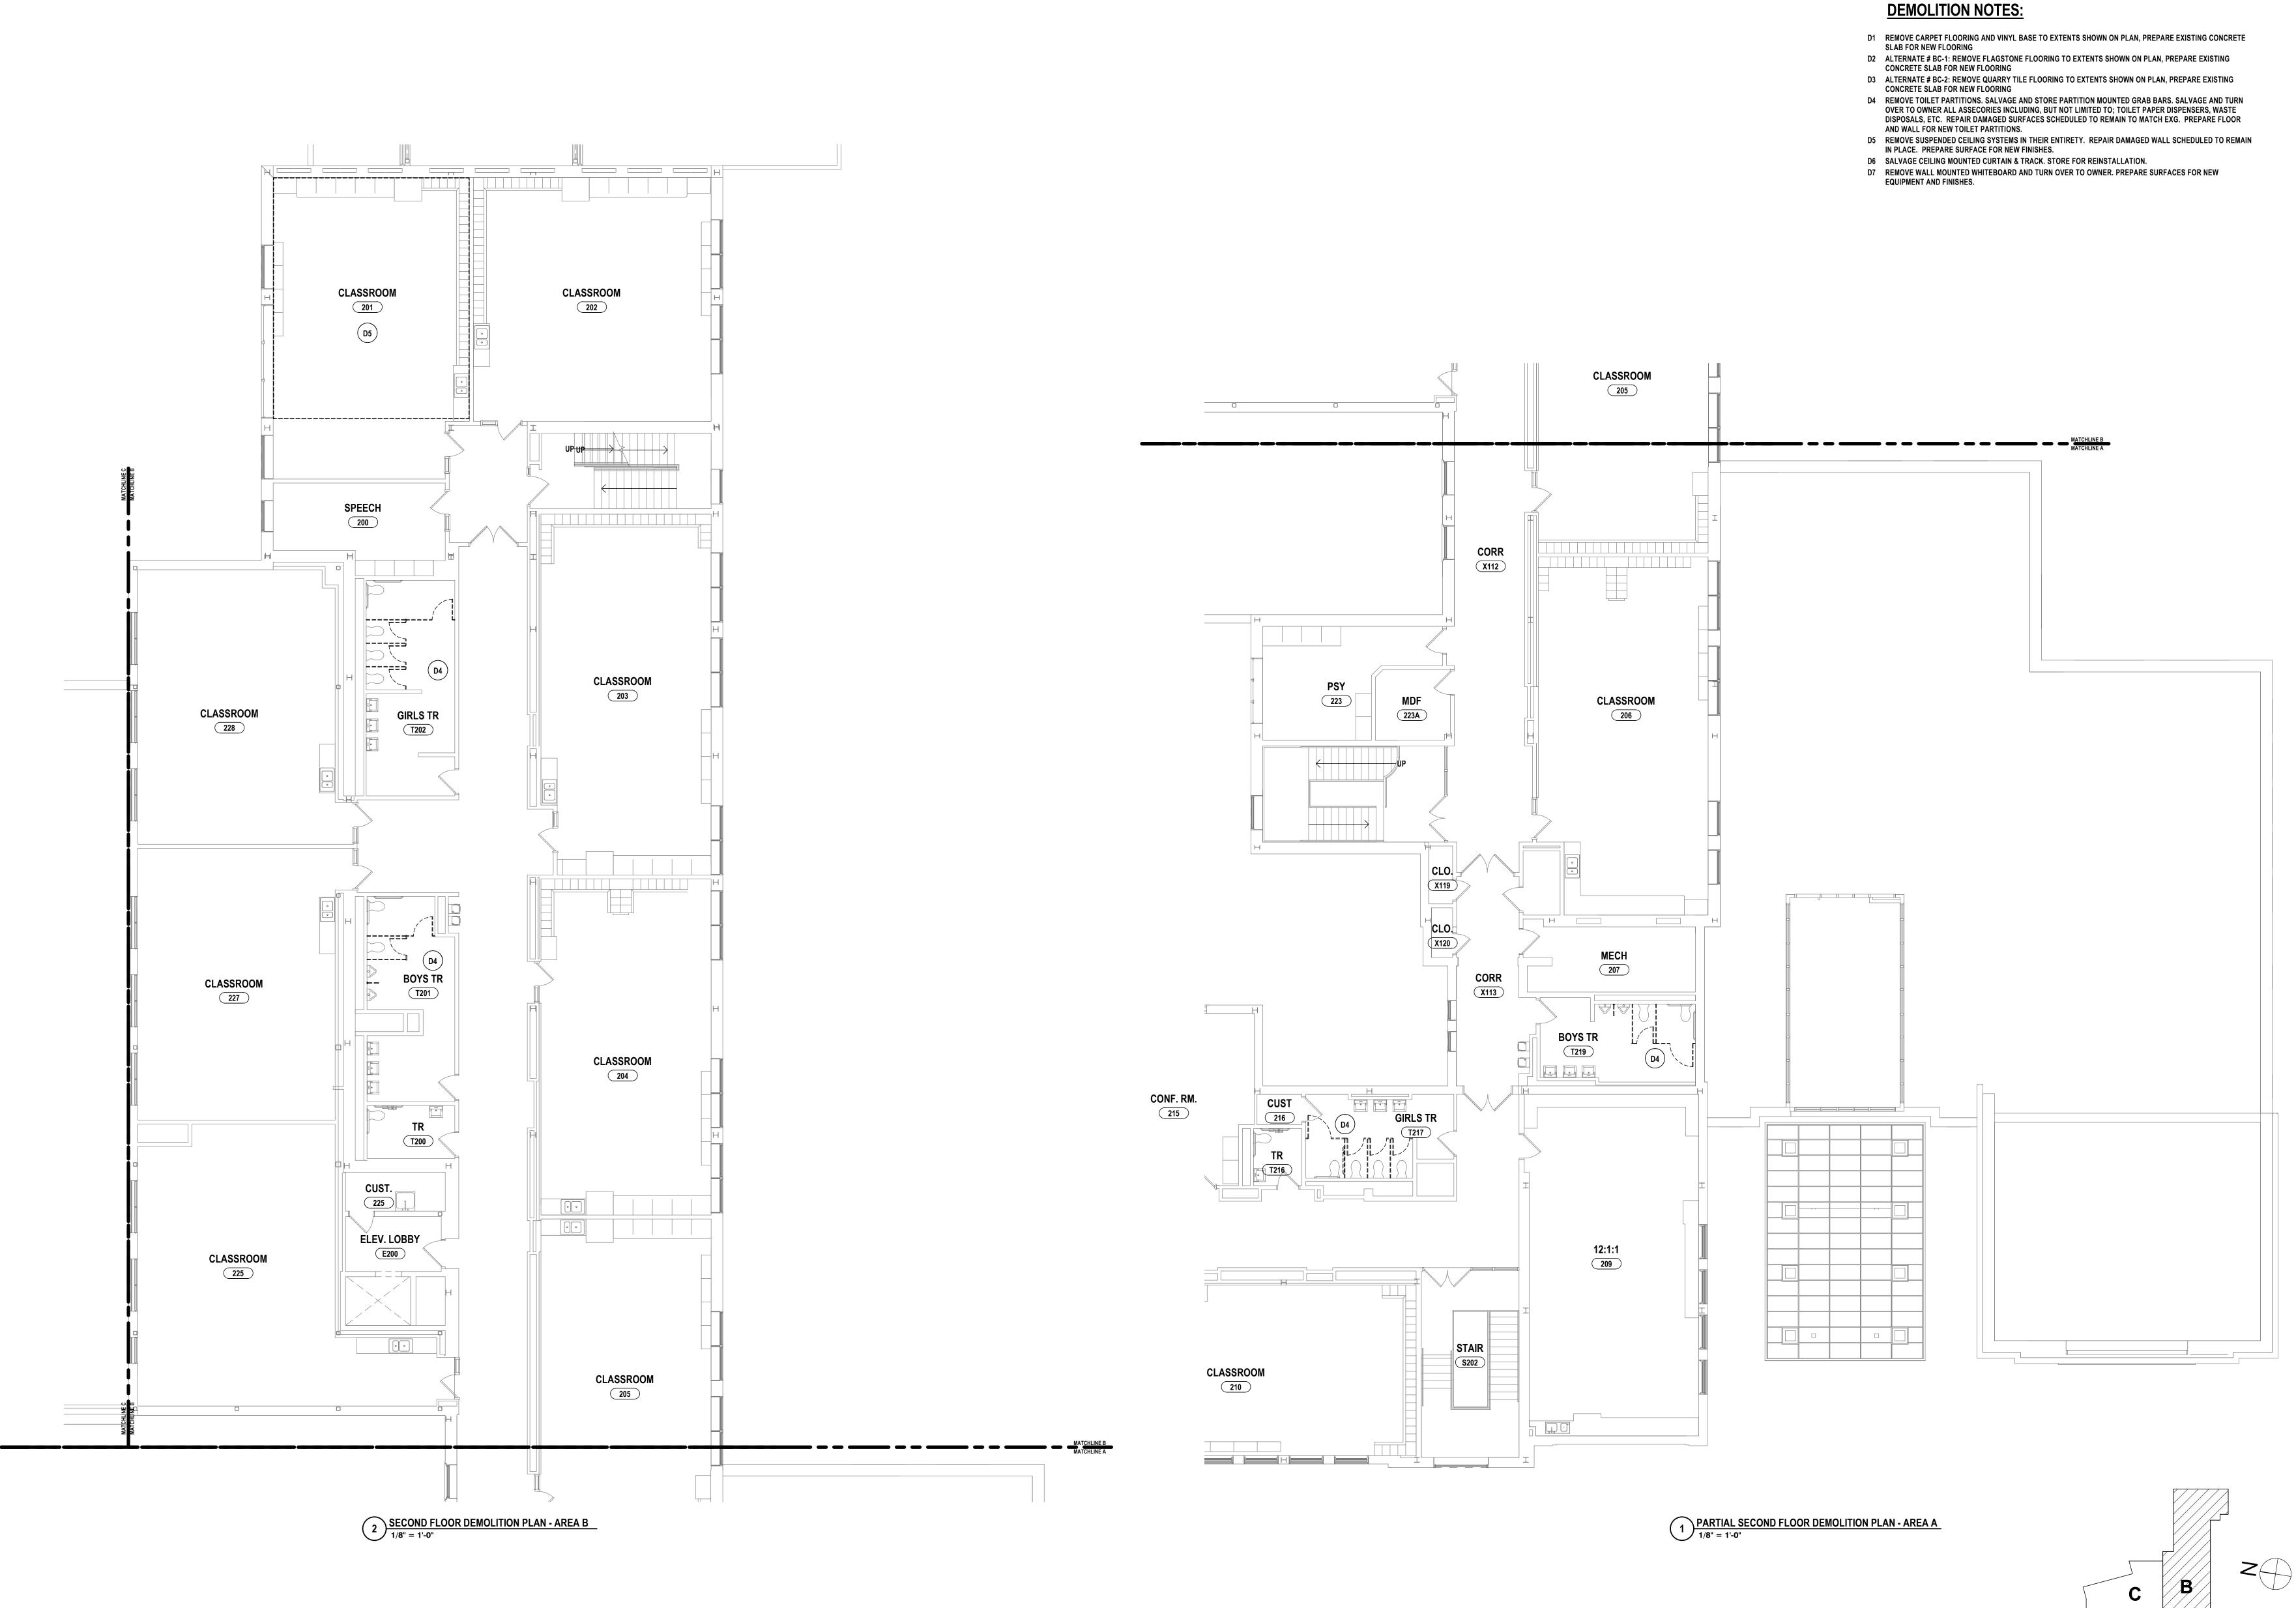


GENERAL DEMO NOTES: REFER TO DRAWING A0.0 FOR GENERAL DEMOLITION NOTES.

DRAWN BY: ACA SCC CHECKED BY: DATE: 10/21/2022 SCALE: 1/8" = 1'-0"

> S ENGINEERS | ARCHITEC

DEMO PLAN - AREA A & B LS 2023 RE DISTRICT

BC-A0.3 PROJECT NO: 2012-233

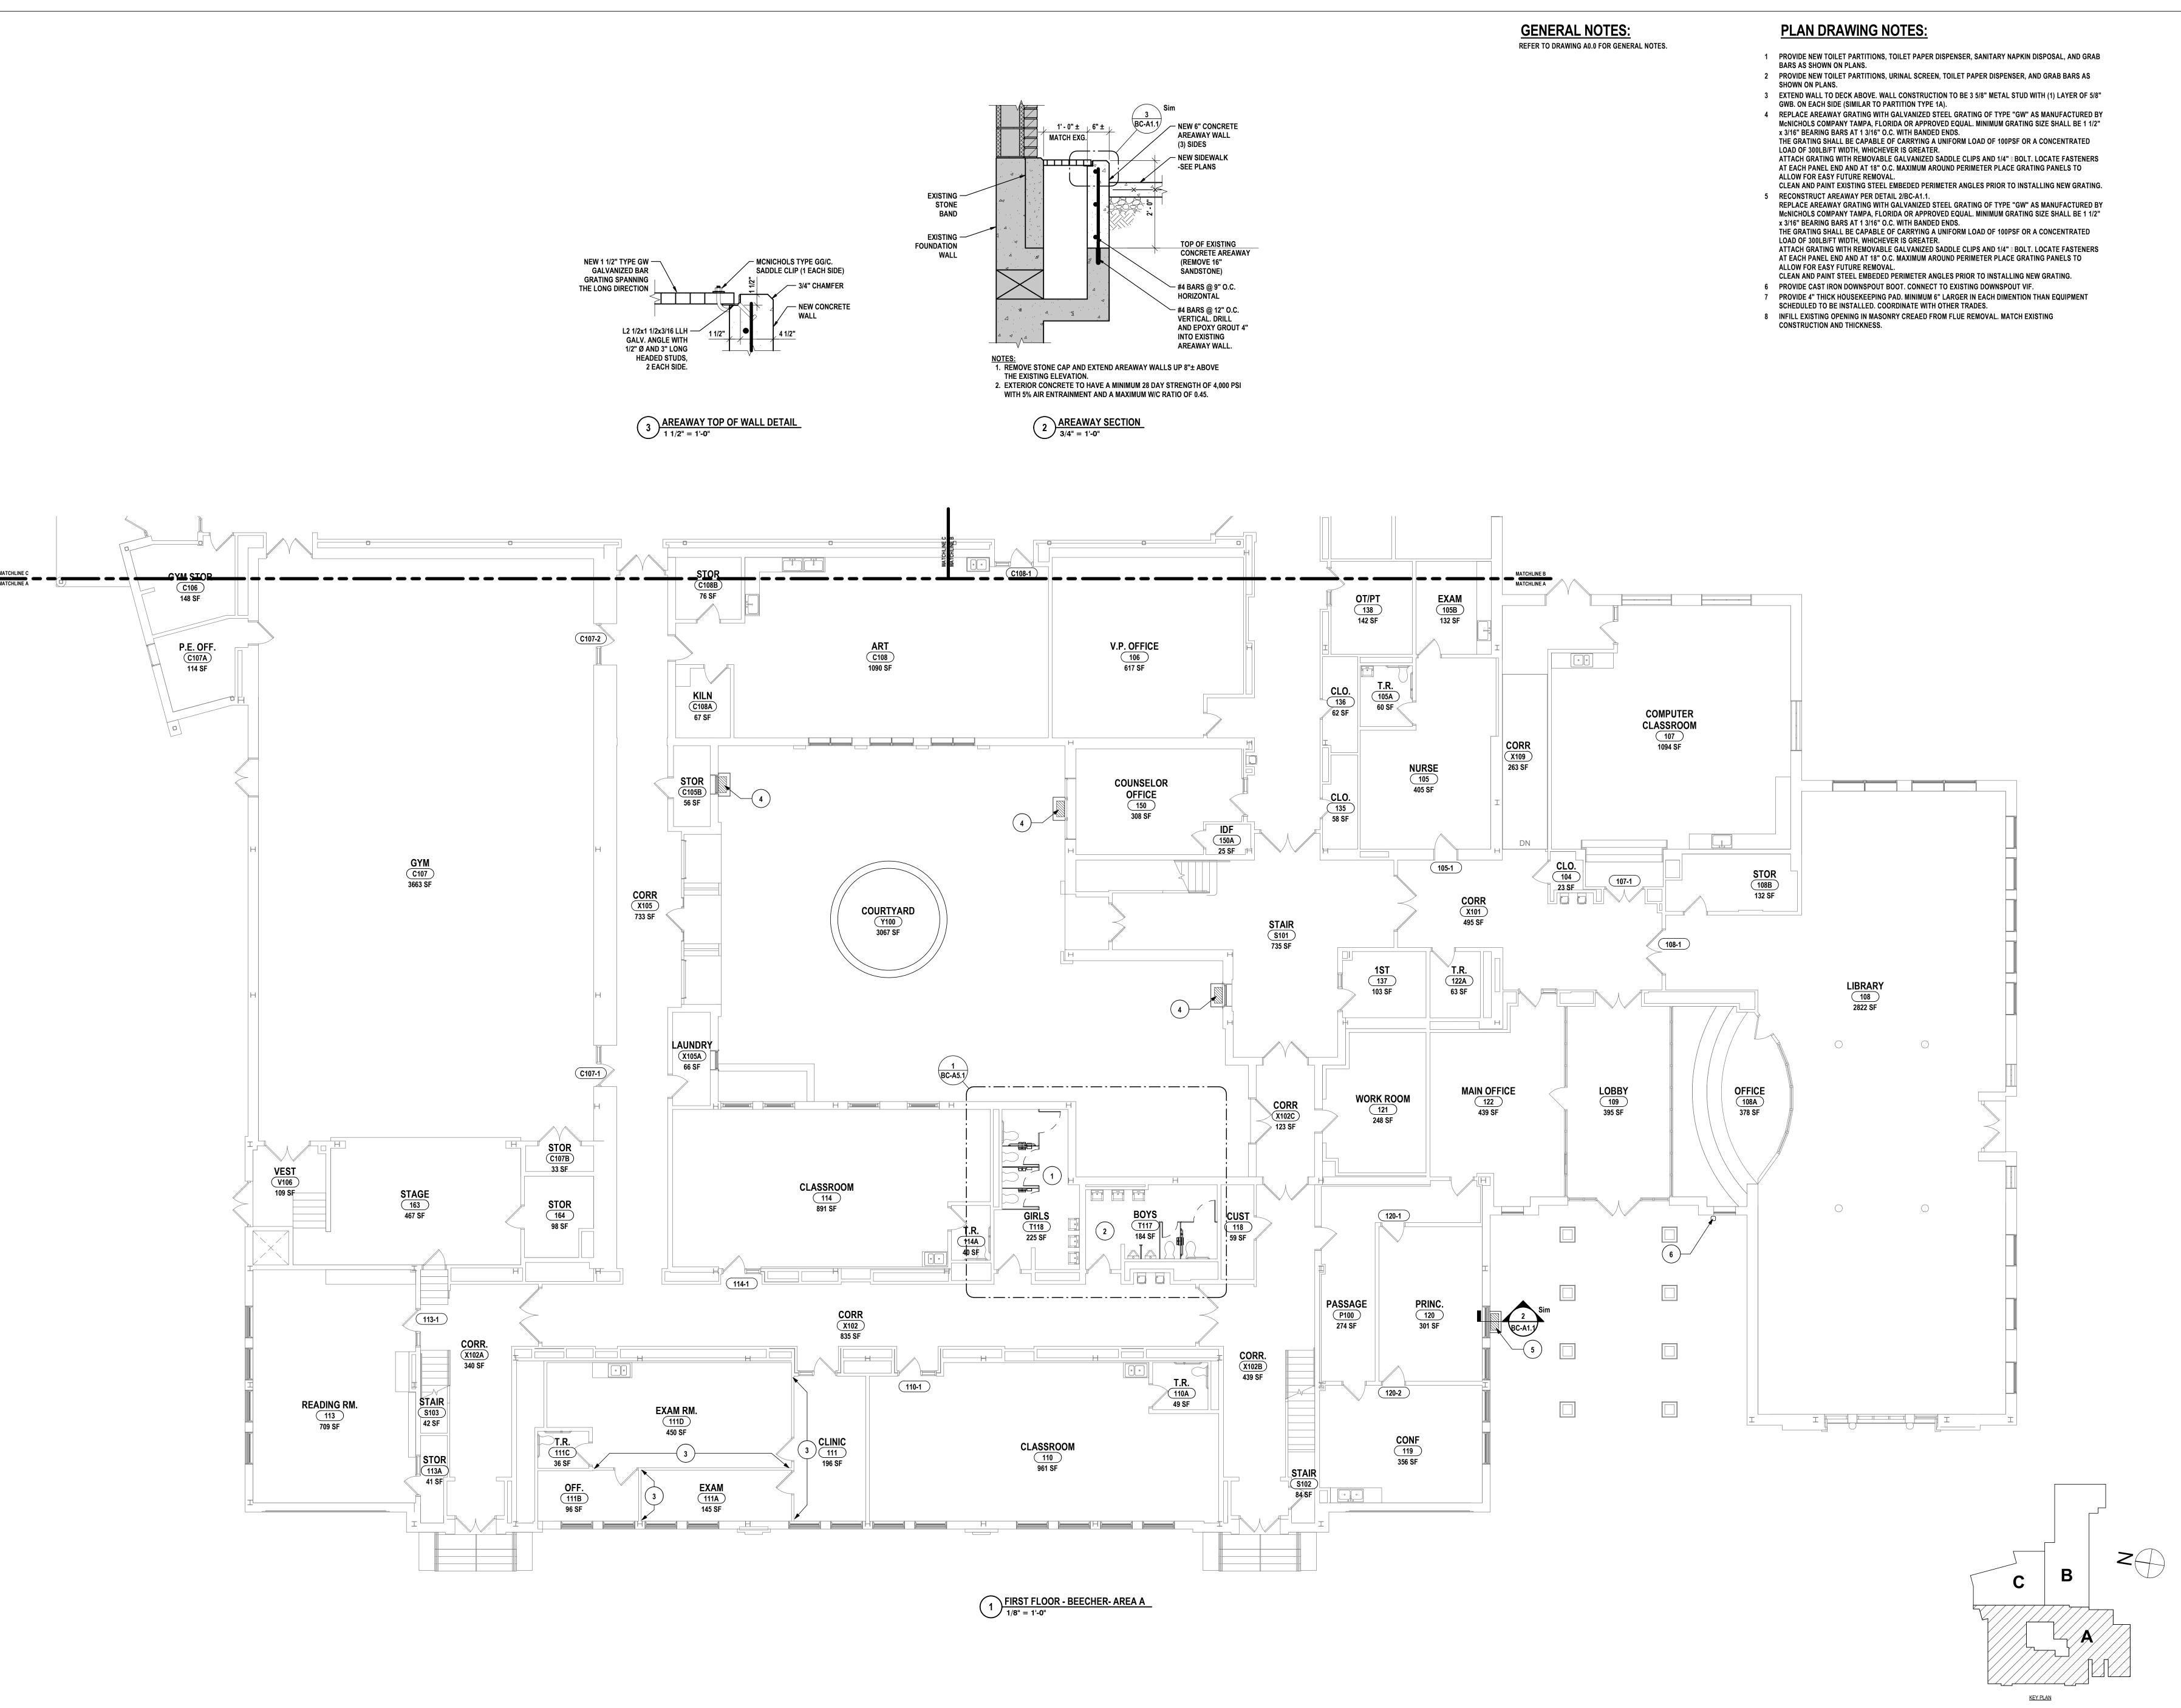

SCC CHECKED BY: DATE: 10/21/2022 SCALE: As indicated

DRAWN BY:


ACA

S ENGINEERS | ARCHITEC

S 2023 RENOVATIONS DISTRICT

AREA A

BC-A1.1

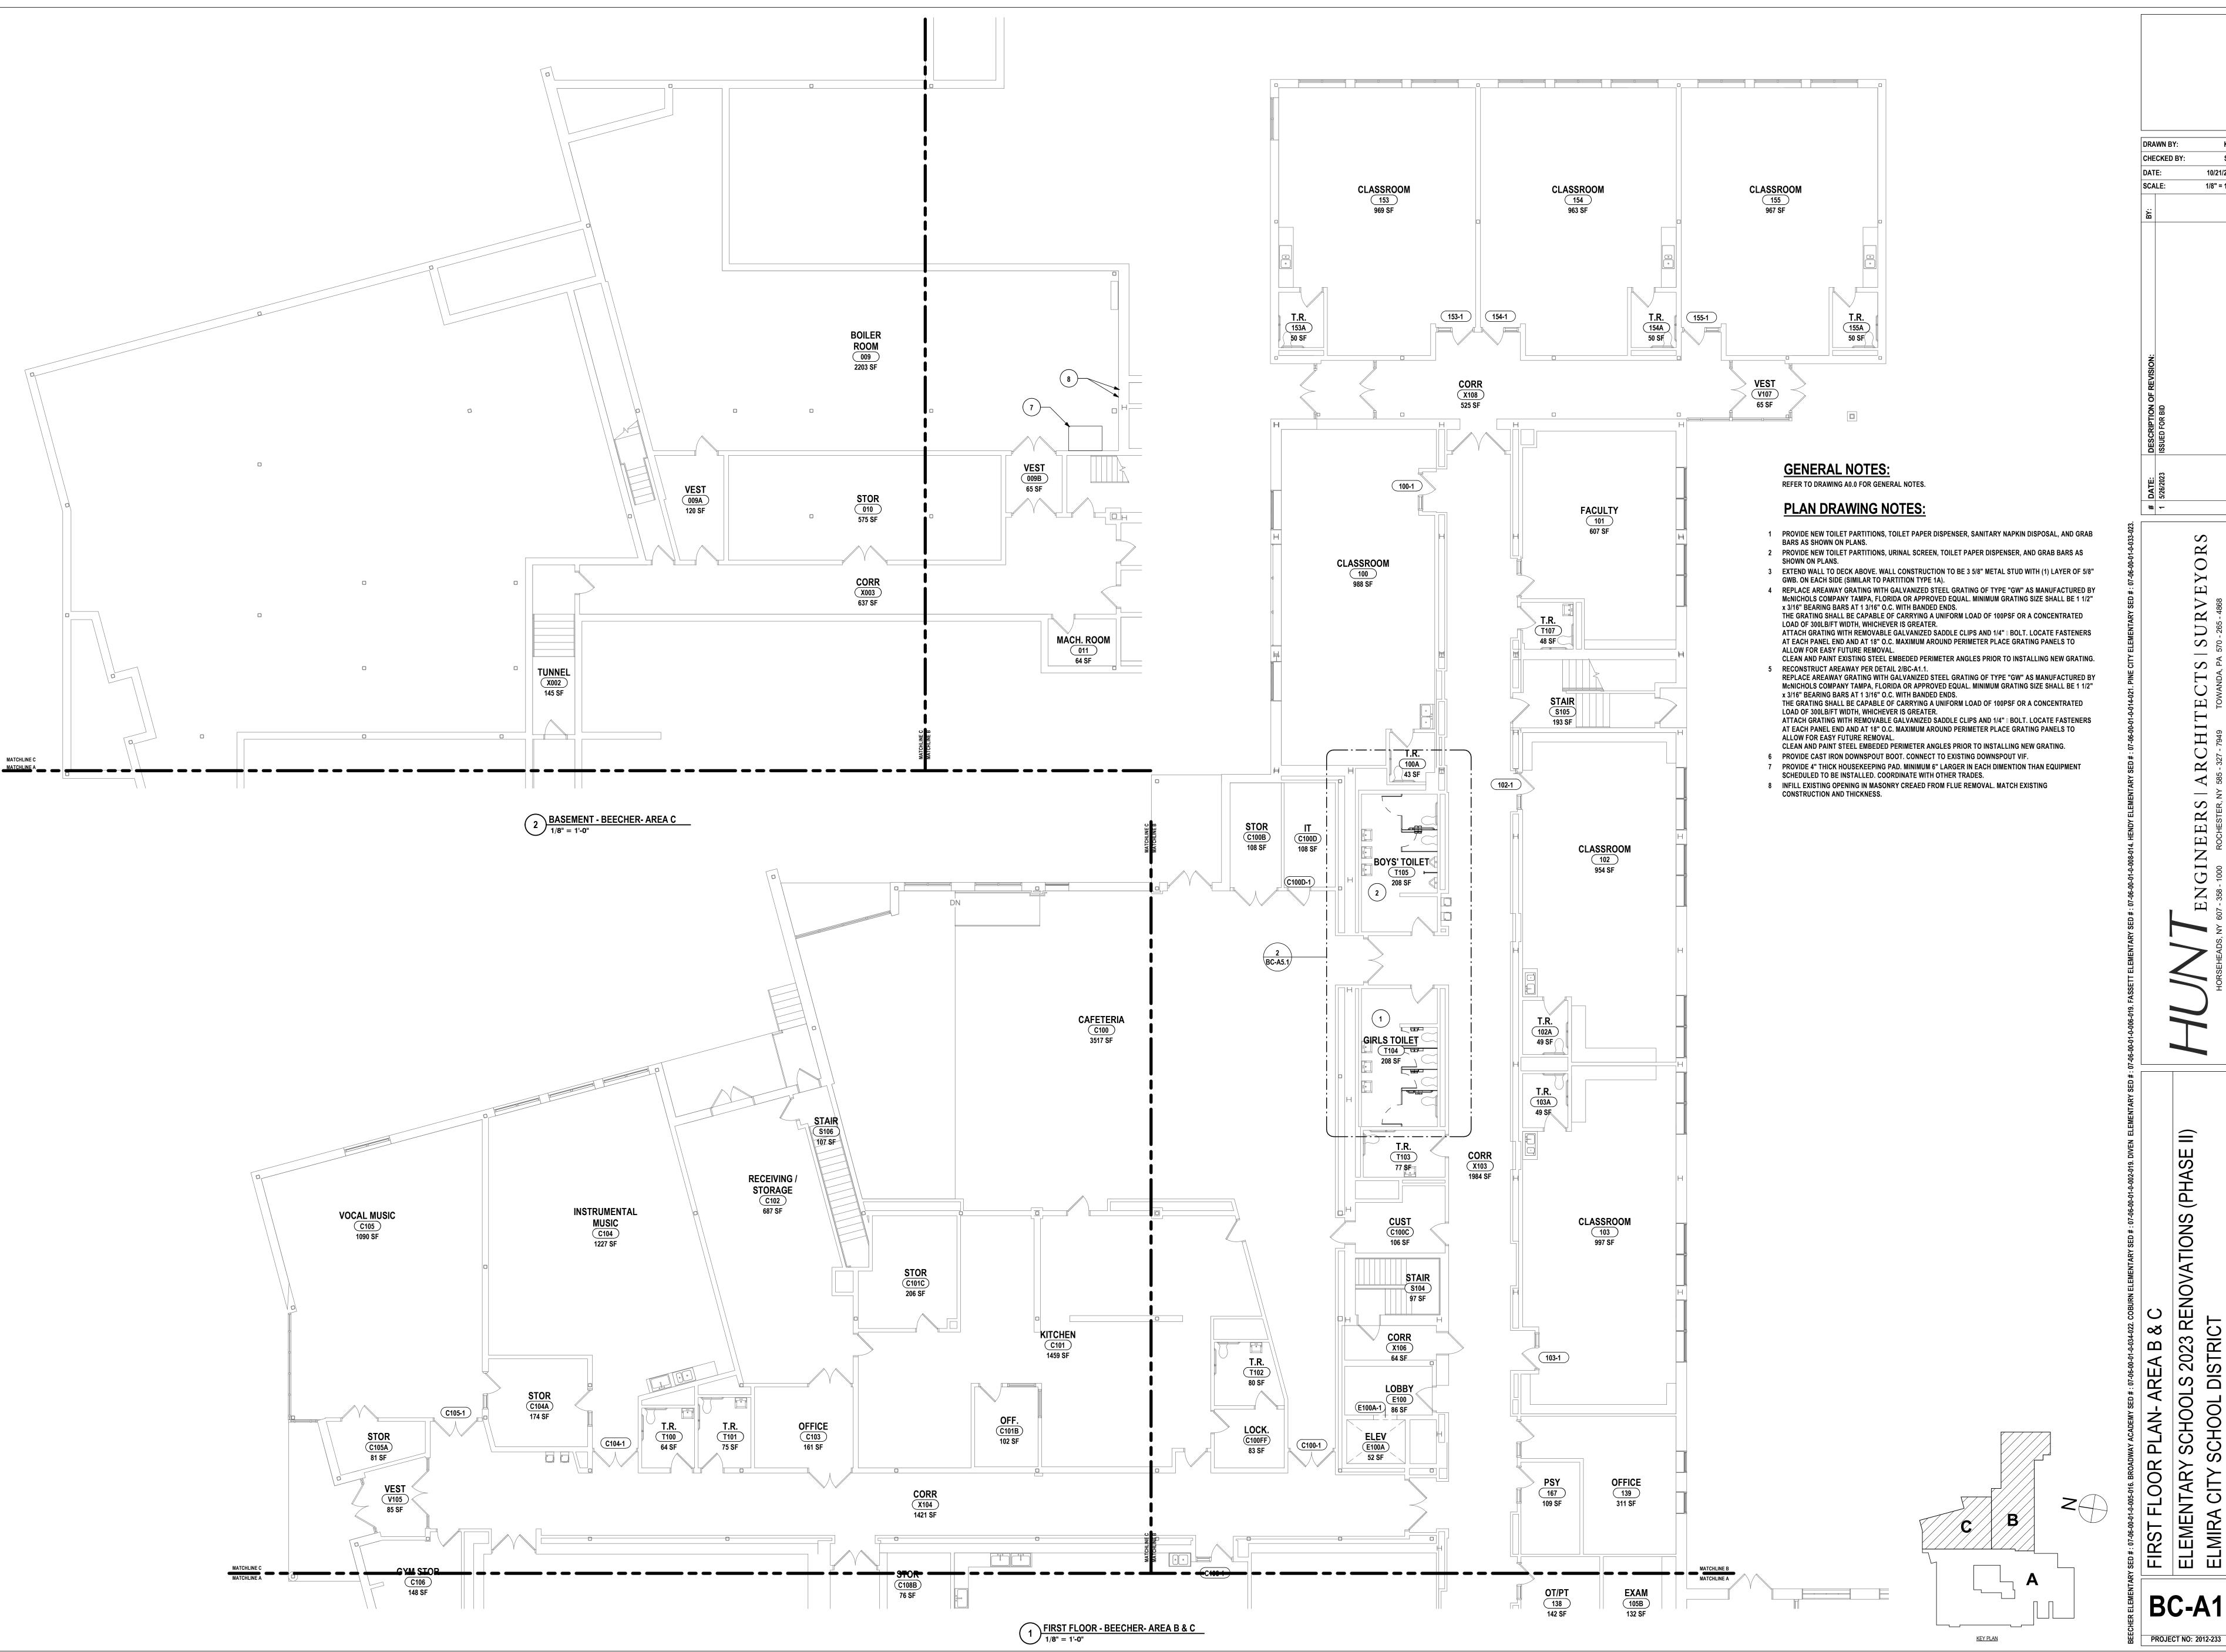

CHECKED BY: 10/21/2022 1/8" = 1'-0"

> \mathbf{O} S HI RC RS STER. N Z

BC-A1.2

GENERAL NOTES: REFER TO DRAWING A0.0 FOR GENERAL NOTES. **PLAN DRAWING NOTES:** BARS AS SHOWN ON PLANS. 2 PROVIDE NEW TOILET PARTITIONS, URINAL SCREEN, TOILET PAPER DISPENSER, AND GRAB BARS AS SHOWN ON PLANS. GWB. ON EACH SIDE (SIMILAR TO PARTITION TYPE 1A). 4 REPLACE AREAWAY GRATING WITH GALVANIZED STEEL GRATING OF TYPE "GW" AS MANUFACTURED BY x 3/16" BEARING BARS AT 1 3/16" O.C. WITH BANDED ENDS. LOAD OF 300LB/FT WIDTH, WHICHEVER IS GREATER. ALLOW FOR EASY FUTURE REMOVAL. 5 RECONSTRUCT AREAWAY PER DETAIL 2/BC-A1.1. x 3/16" BEARING BARS AT 1 3/16" O.C. WITH BANDED ENDS. LOAD OF 300LB/FT WIDTH, WHICHEVER IS GREATER. AT EACH PANEL END AND AT 18" O.C. MAXIMUM AROUND PERIMETER PLACE GRATING PANELS TO ALLOW FOR EASY FUTURE REMOVAL. 6 PROVIDE CAST IRON DOWNSPOUT BOOT. CONNECT TO EXISTING DOWNSPOUT VIF. 7 PROVIDE 4" THICK HOUSEKEEPING PAD. MINIMUM 6" LARGER IN EACH DIMENTION THAN EQUIPMENT SCHEDULED TO BE INSTALLED. COORDINATE WITH OTHER TRADES. 8 INFILL EXISTING OPENING IN MASONRY CREAED FROM FLUE REMOVAL. MATCH EXISTING CONSTRUCTION AND THICKNESS. MATCHLINE B MATCHLINE A 1742 SF CLASSROOM 206 965 SF GYM BELOW

SECOND FLOOR - BEECHER - AREA A

1/8" = 1'-0"

12:1:1 209 952 SF

OFF. 220 164 SF

8:1:1 213 709 SF

STAIR S203 297 SF

CLASSROOM
212
934 SF

- 1 PROVIDE NEW TOILET PARTITIONS, TOILET PAPER DISPENSER, SANITARY NAPKIN DISPOSAL, AND GRAB
- 3 EXTEND WALL TO DECK ABOVE. WALL CONSTRUCTION TO BE 3 5/8" METAL STUD WITH (1) LAYER OF 5/8"
- McNICHOLS COMPANY TAMPA, FLORIDA OR APPROVED EQUAL. MINIMUM GRATING SIZE SHALL BE 1 1/2" THE GRATING SHALL BE CAPABLE OF CARRYING A UNIFORM LOAD OF 100PSF OR A CONCENTRATED
- ATTACH GRATING WITH REMOVABLE GALVANIZED SADDLE CLIPS AND 1/4" BOOLT. LOCATE FASTENERS AT EACH PANEL END AND AT 18" O.C. MAXIMUM AROUND PERIMETER PLACE GRATING PANELS TO CLEAN AND PAINT EXISTING STEEL EMBEDED PERIMETER ANGLES PRIOR TO INSTALLING NEW GRATING.
- REPLACE AREAWAY GRATING WITH GALVANIZED STEEL GRATING OF TYPE "GW" AS MANUFACTURED BY McNICHOLS COMPANY TAMPA, FLORIDA OR APPROVED EQUAL. MINIMUM GRATING SIZE SHALL BE 1 1/2" THE GRATING SHALL BE CAPABLE OF CARRYING A UNIFORM LOAD OF 100PSF OR A CONCENTRATED ATTACH GRATING WITH REMOVABLE GALVANIZED SADDLE CLIPS AND 1/4" BOOLT. LOCATE FASTENERS
- CLEAN AND PAINT STEEL EMBEDED PERIMETER ANGLES PRIOR TO INSTALLING NEW GRATING.

KAB SCC CHECKED BY: 10/21/2022 SCALE: 1/8" = 1'-0"

DRAWN BY:

S ENGINEERS | ARCHITEC

2

В

KEY PLAN

BC-A1.3

GENERAL NOTES:

REFER TO DRAWING A0.0 FOR GENERAL NOTES.

PLAN DRAWING NOTES:

- 1 PROVIDE NEW TOILET PARTITIONS, TOILET PAPER DISPENSER, SANITARY NAPKIN DISPOSAL, AND GRAB BARS AS SHOWN ON PLANS.
- 2 PROVIDE NEW TOILET PARTITIONS, URINAL SCREEN, TOILET PAPER DISPENSER, AND GRAB BARS AS SHOWN ON PLANS.
- EXTEND WALL TO DECK ABOVE. WALL CONSTRUCTION TO BE 3 5/8" METAL STUD WITH (1) LAYER OF 5/8" GWB. ON EACH SIDE (SIMILAR TO PARTITION TYPE 1A).
 REPLACE AREAWAY GRATING WITH GALVANIZED STEEL GRATING OF TYPE "GW" AS MANUFACTURED BY
- McNICHOLS COMPANY TAMPA, FLORIDA OR APPROVED EQUAL. MINIMUM GRATING SIZE SHALL BE 1 1/2" x 3/16" BEARING BARS AT 1 3/16" O.C. WITH BANDED ENDS.

 THE GRATING SHALL BE CAPABLE OF CARRYING A UNIFORM LOAD OF 100PSF OR A CONCENTRATED LOAD OF 300LB/FT WIDTH, WHICHEVER IS GREATER.

 ATTACH GRATING WITH REMOVABLE GALVANIZED SADDLE CLIPS AND 1/4" BOOLT. LOCATE FASTENERS AT EACH PANEL END AND AT 18" O.C. MAXIMUM AROUND PERIMETER PLACE GRATING PANELS TO ALLOW FOR EASY FUTURE REMOVAL.

CLEAN AND PAINT EXISTING STEEL EMBEDED PERIMETER ANGLES PRIOR TO INSTALLING NEW GRATING.

- 5 RECONSTRUCT AREAWAY PER DETAIL 2/BC-A1.1.
 REPLACE AREAWAY GRATING WITH GALVANIZED STEEL GRATING OF TYPE "GW" AS MANUFACTURED BY McNICHOLS COMPANY TAMPA, FLORIDA OR APPROVED EQUAL. MINIMUM GRATING SIZE SHALL BE 1 1/2" x 3/16" BEARING BARS AT 1 3/16" O.C. WITH BANDED ENDS.
 THE GRATING SHALL BE CAPABLE OF CARRYING A UNIFORM LOAD OF 100PSF OR A CONCENTRATED LOAD OF 300LB/FT WIDTH, WHICHEVER IS GREATER.
 ATTACH GRATING WITH REMOVABLE GALVANIZED SADDLE CLIPS AND 1/4" BOLT. LOCATE FASTENERS AT EACH PANEL END AND AT 18" O.C. MAXIMUM AROUND PERIMETER PLACE GRATING PANELS TO ALLOW FOR EASY FUTURE REMOVAL.
- CLEAN AND PAINT STEEL EMBEDED PERIMETER ANGLES PRIOR TO INSTALLING NEW GRATING.

 PROVIDE CAST IRON DOWNSPOUT BOOT. CONNECT TO EXISTING DOWNSPOUT VIF.
- 7 PROVIDE 4" THICK HOUSEKEEPING PAD. MINIMUM 6" LARGER IN EACH DIMENTION THAN EQUIPMENT SCHEDULED TO BE INSTALLED. COORDINATE WITH OTHER TRADES.
- 8 INFILL EXISTING OPENING IN MASONRY CREAED FROM FLUE REMOVAL. MATCH EXISTING CONSTRUCTION AND THICKNESS.

STEEL GRATING OF TYPE "GW" AS MANUFACTURED BY OVED EQUAL. MINIMUM GRATING SIZE SHALL BE 1 1/2" ED ENDS.
A UNIFORM LOAD OF 100PSF OR A CONCENTRATED R.
SADDLE CLIPS AND 1/4" || BOLT. LOCATE FASTENERS ROUND PERIMETER PLACE GRATING PANELS TO

NGLES PRIOR TO INSTALLING NEW GRATING.
T TO EXISTING DOWNSPOUT VIF.
6" LARGER IN EACH DIMENTION THAN EQUIPMENT HOTHER TRADES.

ROM FLUE REMOVAL. MATCH EXISTING

HORSEHEADS, NY 607 - 358 - 1000 ROCHESTER, NY 585 - 327 - 7949 TOWANDA,

DRAWN BY:

CHECKED BY:

KAB

SCC

10/21/2022

1/8" = 1'-0"

Y SCHOOLS 2023 RENOVATIONS (PHAS) SCHOOL DISTRICT


ELEMENTARY S
ELMIRA CITY S

BC-A1.4

PROJECT NO: 2012-233

KEY PLAN

1 SECOND FLOOR - BEECHER - AREA B
1/8" = 1'-0"

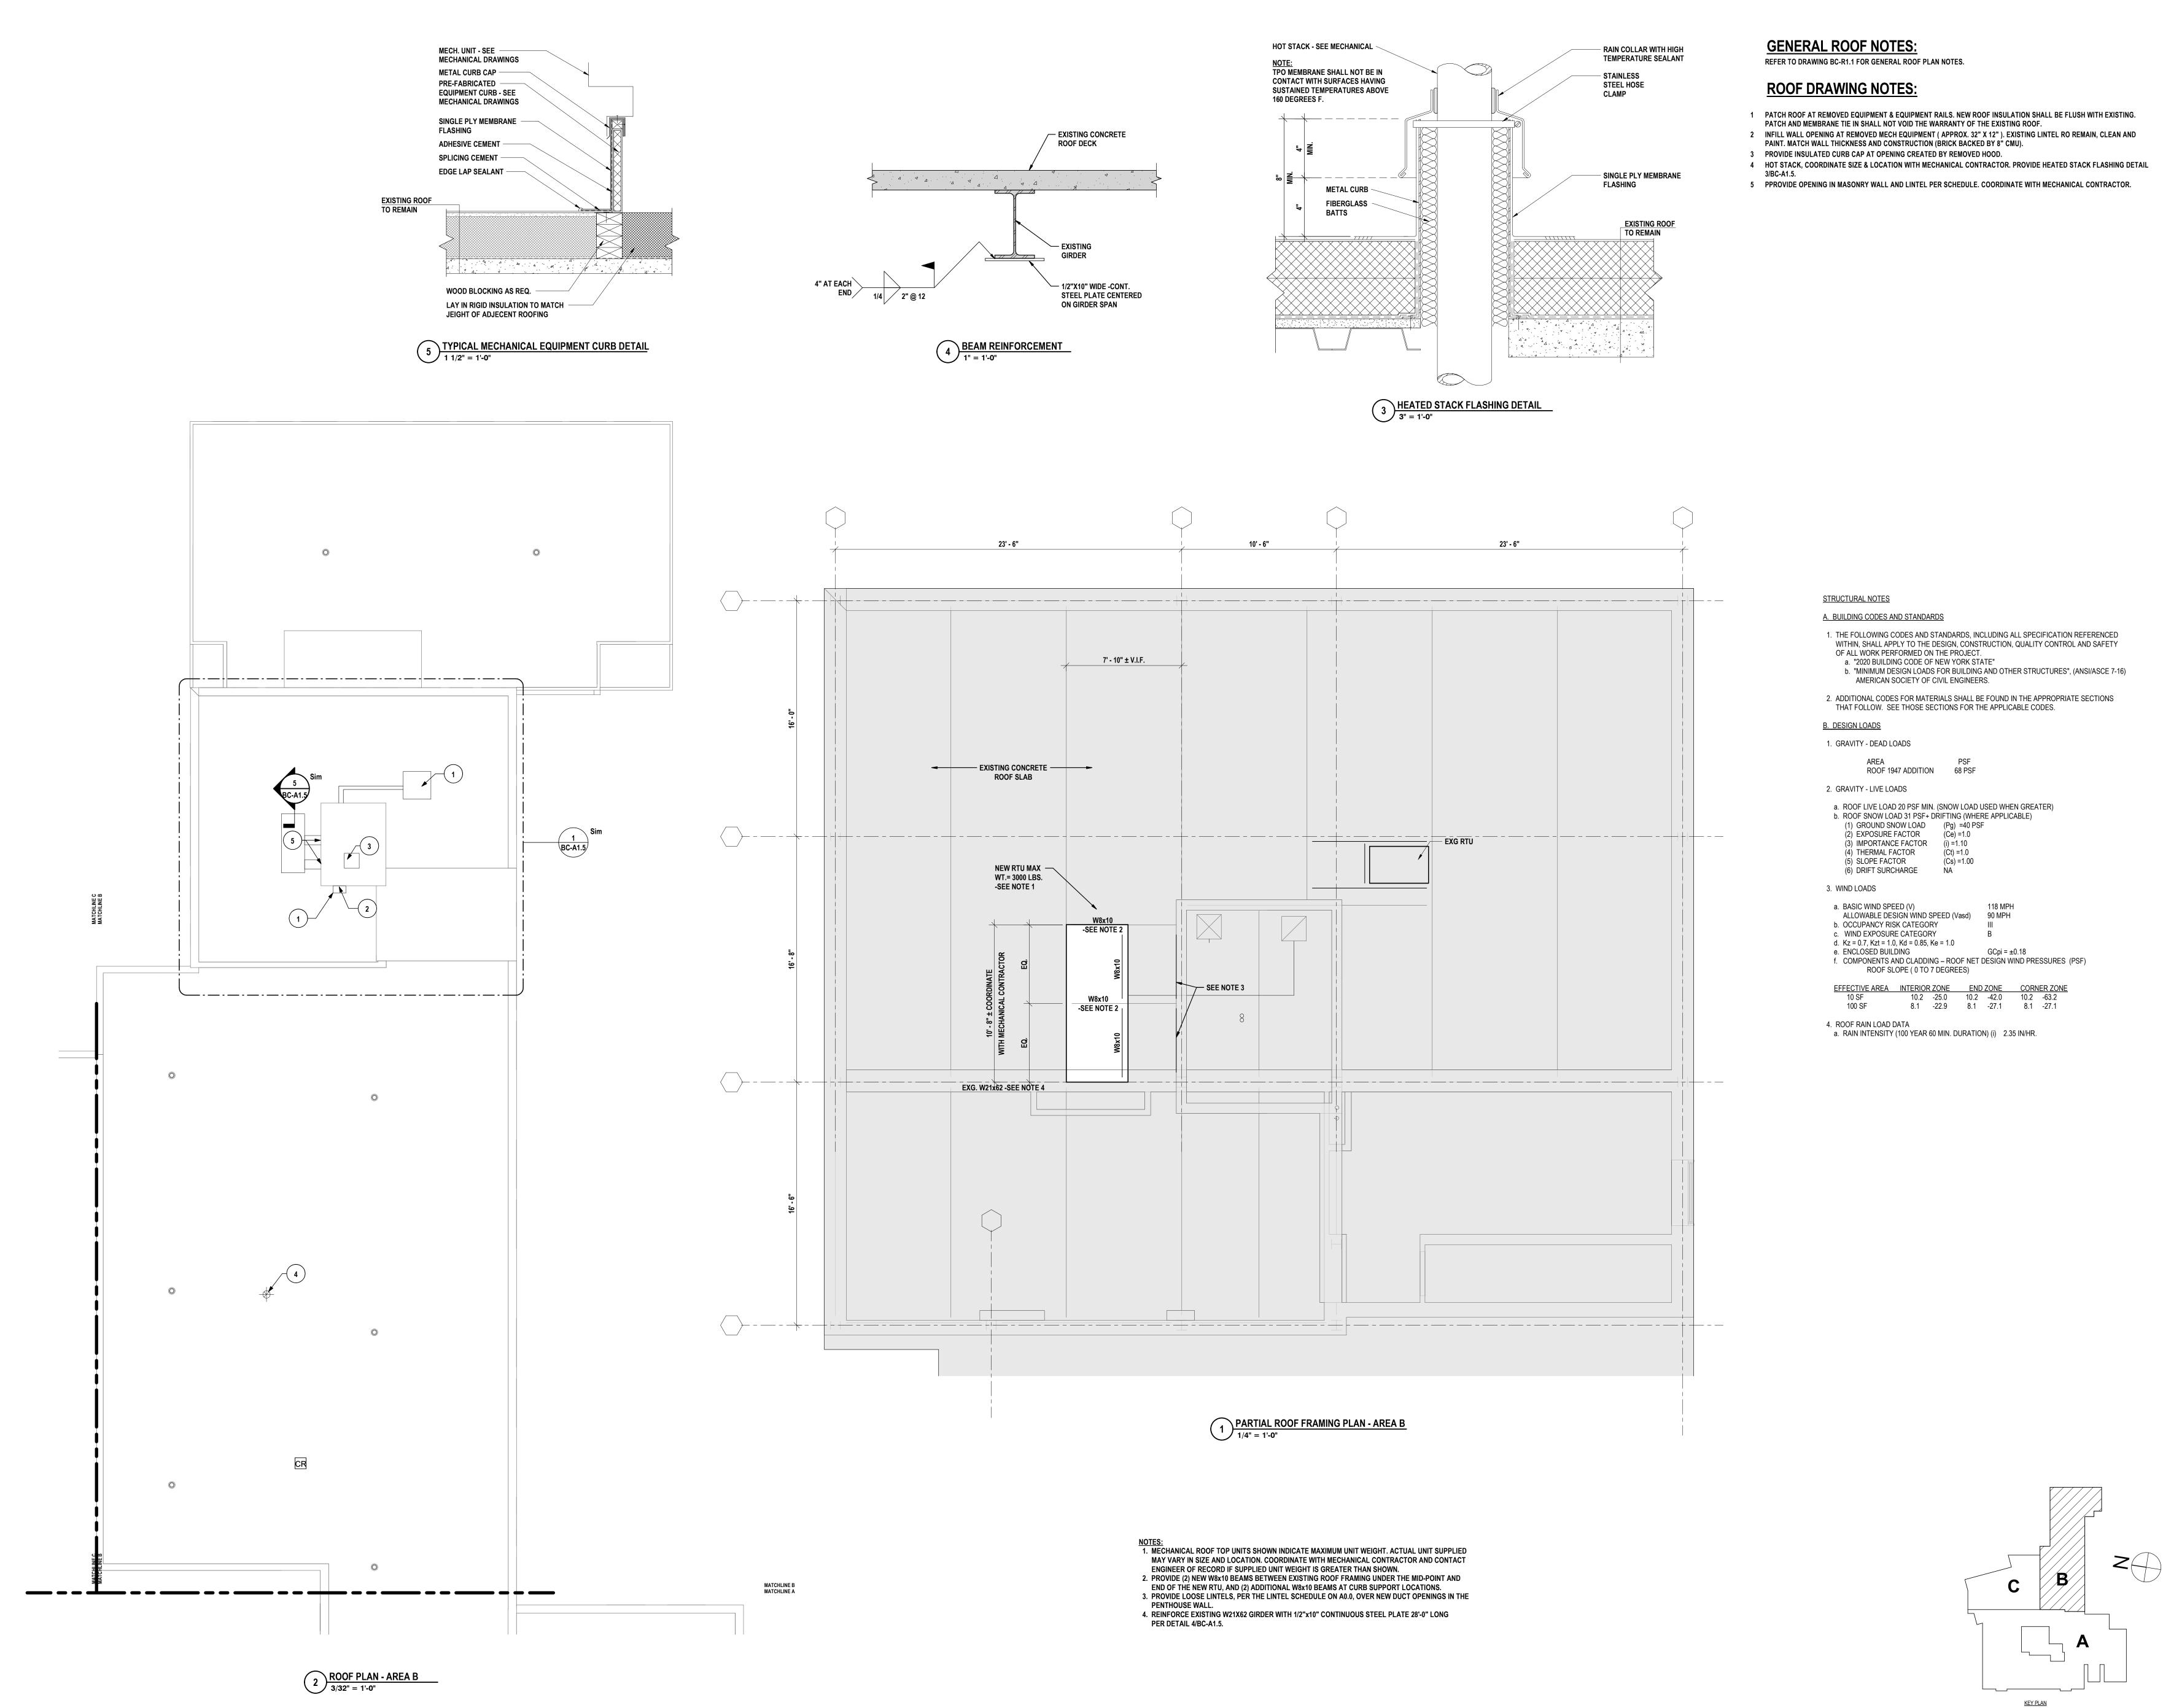


HORSEHEADS, NY 607 - 358 - 1000 ROCHESTER, NY 585 - 327 - 7949 TOWANDA, PA 570 - 265 - 4868

SCHOOLS 2023 RENOVATIONS (PHASE II)

SOOF PLAN- AREA B ELEMENTARY SCHOOLS 2023 R ELMIRA CITY SCHOOL DISTRIC

BC-A1.5

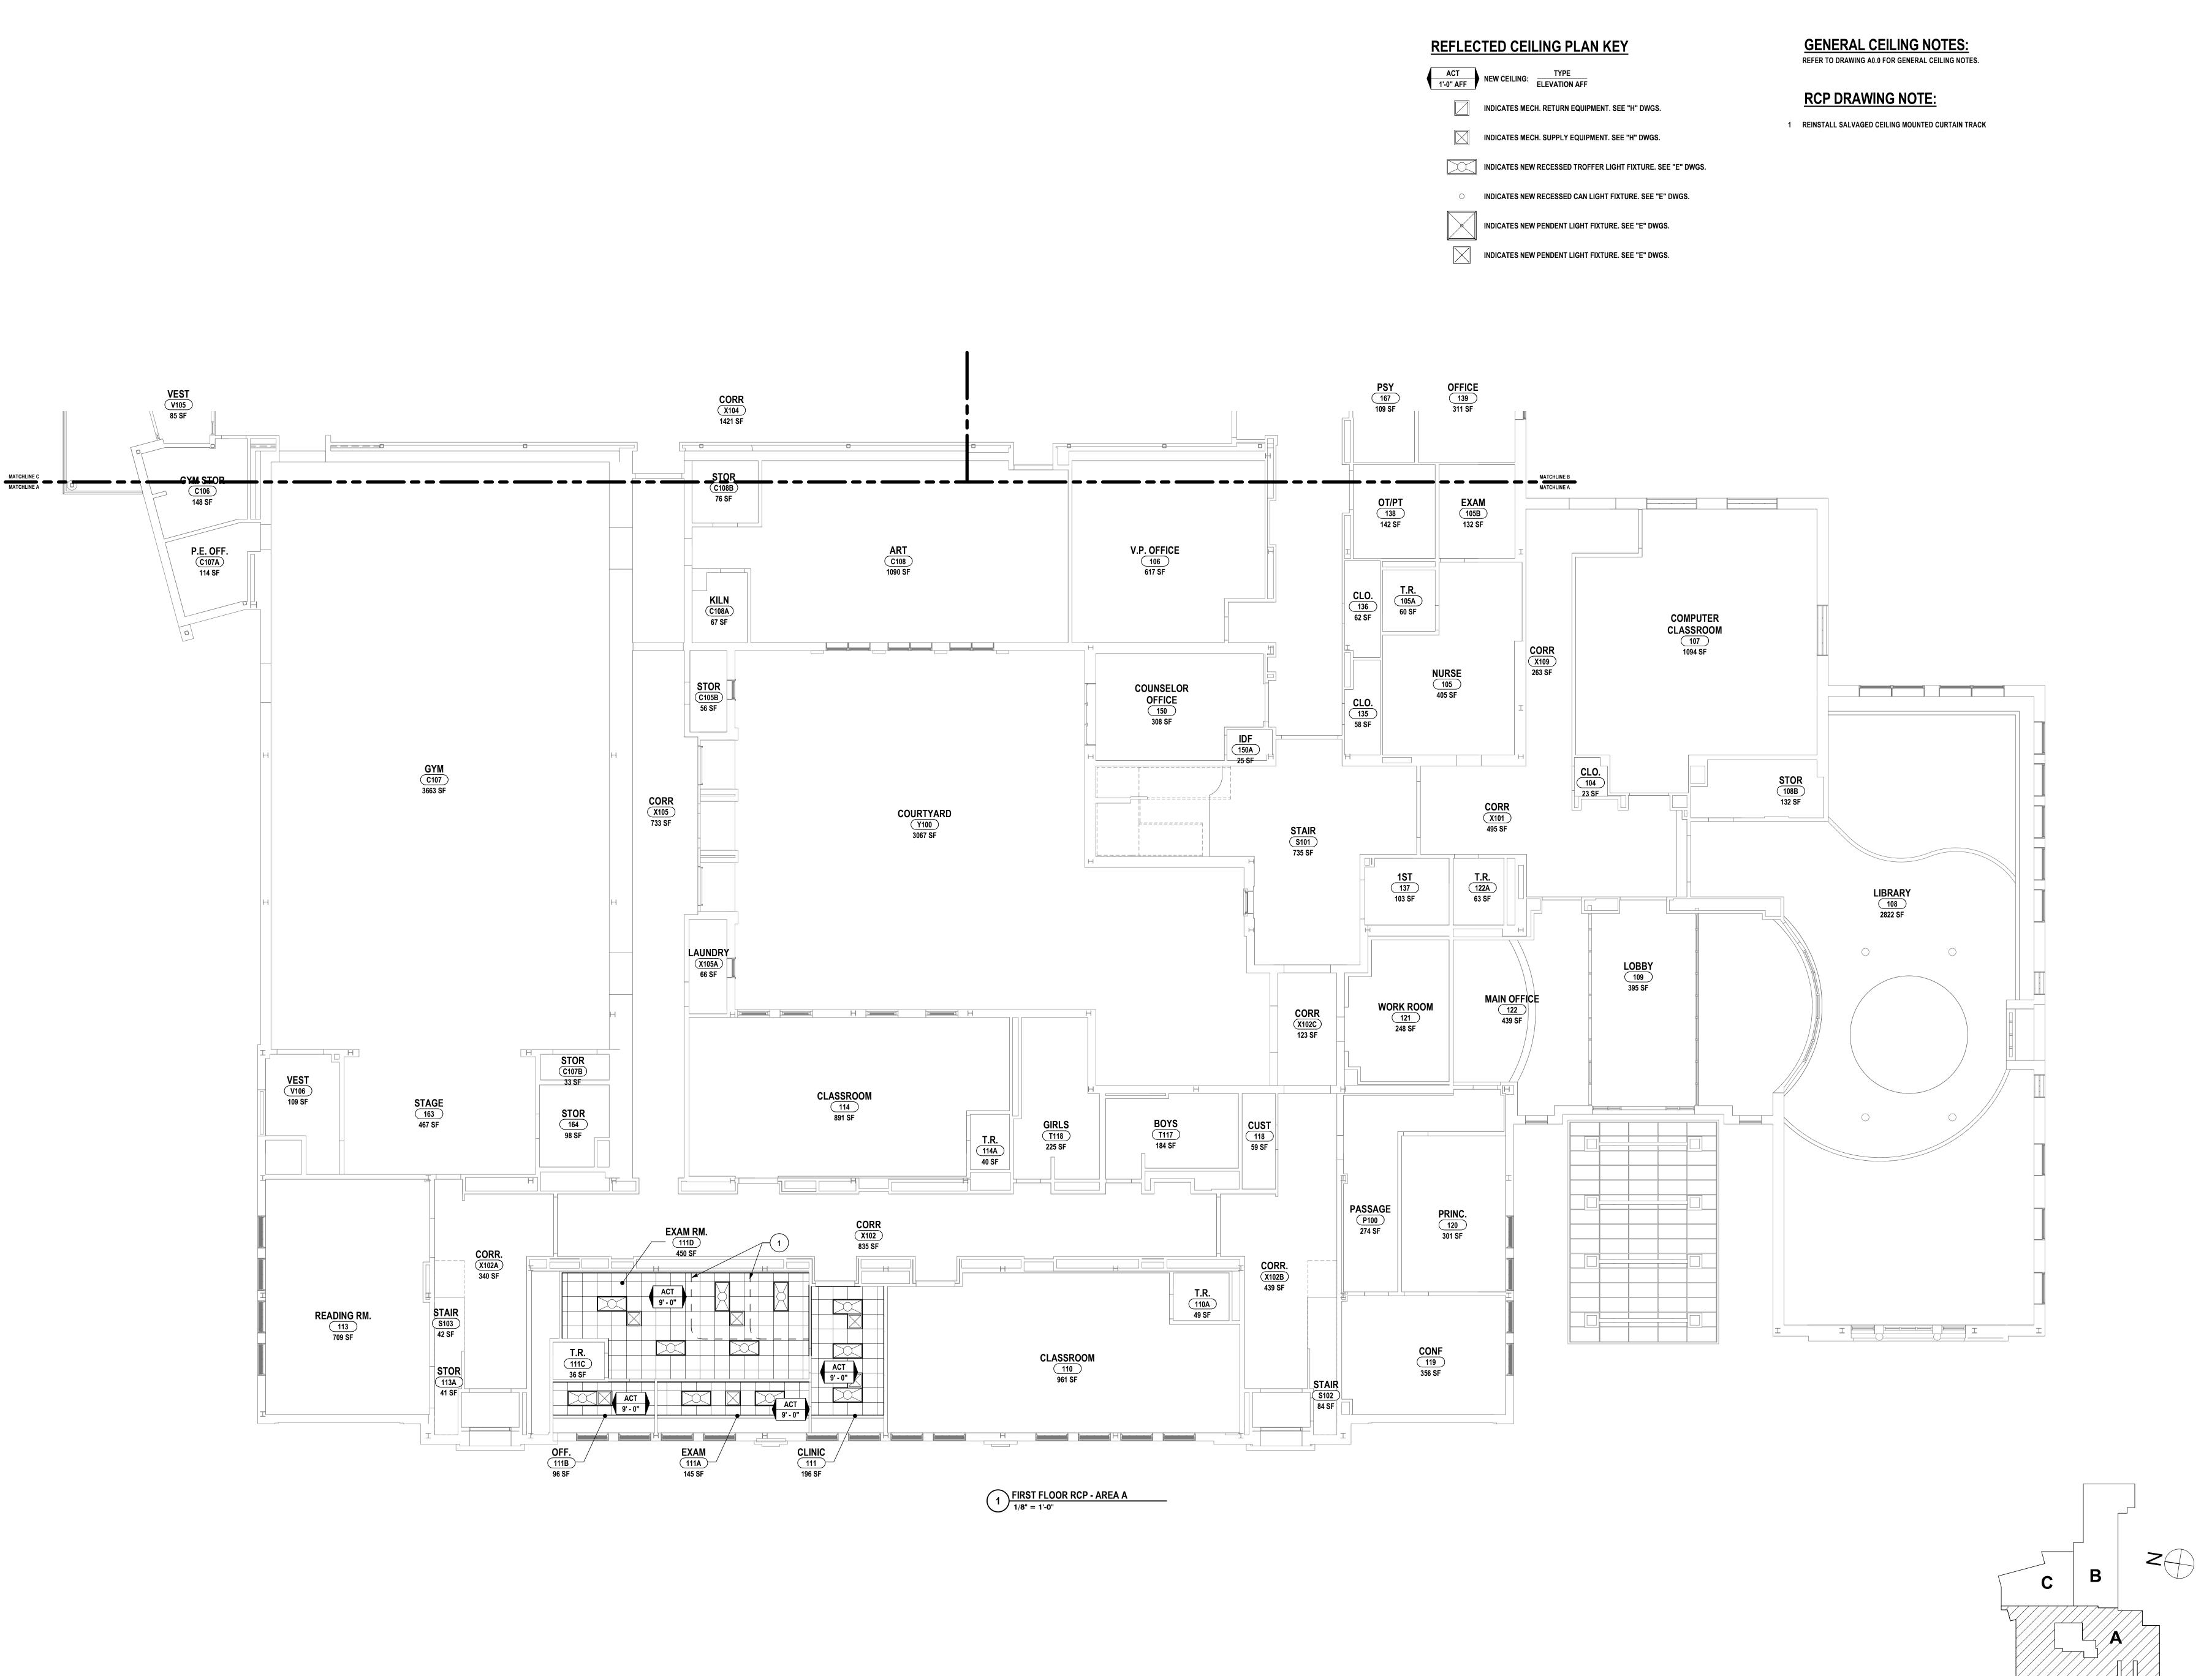

ATE: DESCRIPTION OF REVISION:

S6/2023 ISSUED FOR BID

S6/2024 ISSUED FOR BID

PORSEHEADS, NY 607 - 358 - 1000 ROCHESTER, NY 585 - 327 - 7949 TOWANDA, PA 570 - 265 - 4868

FIRST FLOOR REFLECTED CEILING PLAN - AREA A

FIRST FLOOR REFLECTED CEILING PLAN - AREA A

ELEMENTARY SCHOOLS 2023 RENOVATIONS (PHASE I

ELMIRA CITY SCHOOL DISTRICT

ELMIRA, CHEMUNG COUNTY, NEW YORK

BC-A2.1

PROJECT NO: 2012-233



REFLECTED CEILING PLAN KEY

1'-0" AFF NEW CEILING: TYPE ELEVATION AFF

INDICATES MECH. RETURN EQUIPMENT. SEE "H" DWGS.

INDICATES MECH. SUPPLY EQUIPMENT. SEE "H" DWGS.

INDICATES NEW RECESSED TROFFER LIGHT FIXTURE. SEE "E" DWGS.

O INDICATES NEW RECESSED CAN LIGHT FIXTURE. SEE "E" DWGS.

INDICATES NEW PENDENT LIGHT FIXTURE. SEE "E" DWGS. INDICATES NEW PENDENT LIGHT FIXTURE. SEE "E" DWGS. **GENERAL CEILING NOTES:** REFER TO DRAWING A0.0 FOR GENERAL CEILING NOTES.

RCP DRAWING NOTE:


1 REINSTALL SALVAGED CEILING MOUNTED CURTAIN TRACK

10/21/2022 ្តែ 1/8" = 1'-0"


> SU. ENGINEERS | ARCHITEC


REFLECTED CEILING PLAN - AREA B S 2023 RENOVATIONS DISTRICT


BC-A2.2 PROJECT NO: 2012-233

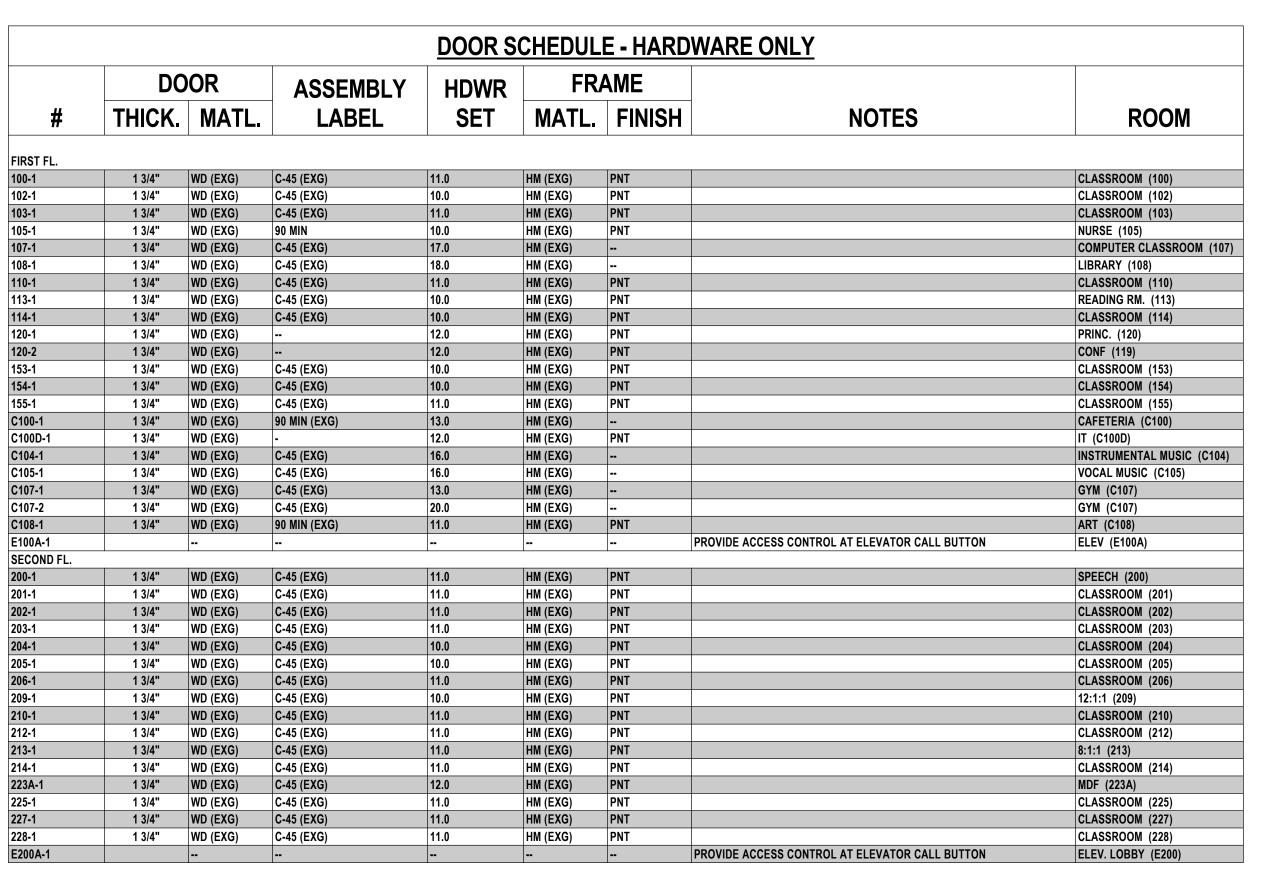


	TOILET ROOM ACCESSORY SCHEDULE											
SYMBOL	DESCRIPTION	MANUFACT.	MODEL	SIZE	REMARKS							
1B	GRAB BAR	AMERICAN SPECIALTIES INC.	3800	42"	SALVAGED FOR REINSTALLATION							
1C	GRAB BAR	AMERICAN SPECIALTIES INC.	3800	18"	SALVAGED FOR REINSTALLATION							
1D	GRAB BAR	AMERICAN SPECIALTIES INC.	3800	18"	PROVIDE NEW							
2	TOILET TISSUE DISPENSER	FURNISHED BY OWNER			INSTALLED BY GC							
3	SANITARY NAPKIN DISPOSAL	FURNISHED BY OWNER			INSTALLED BY GC							

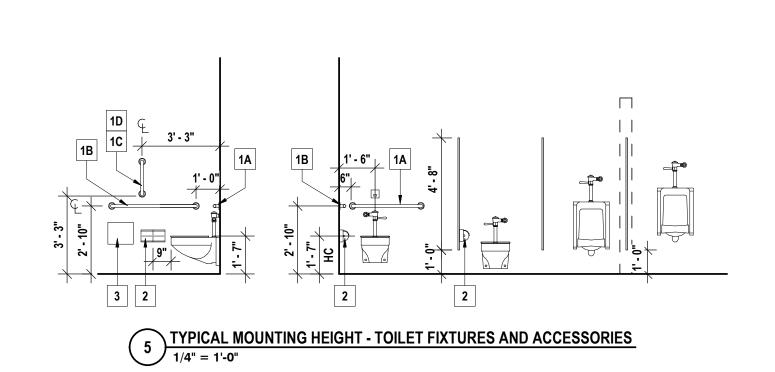

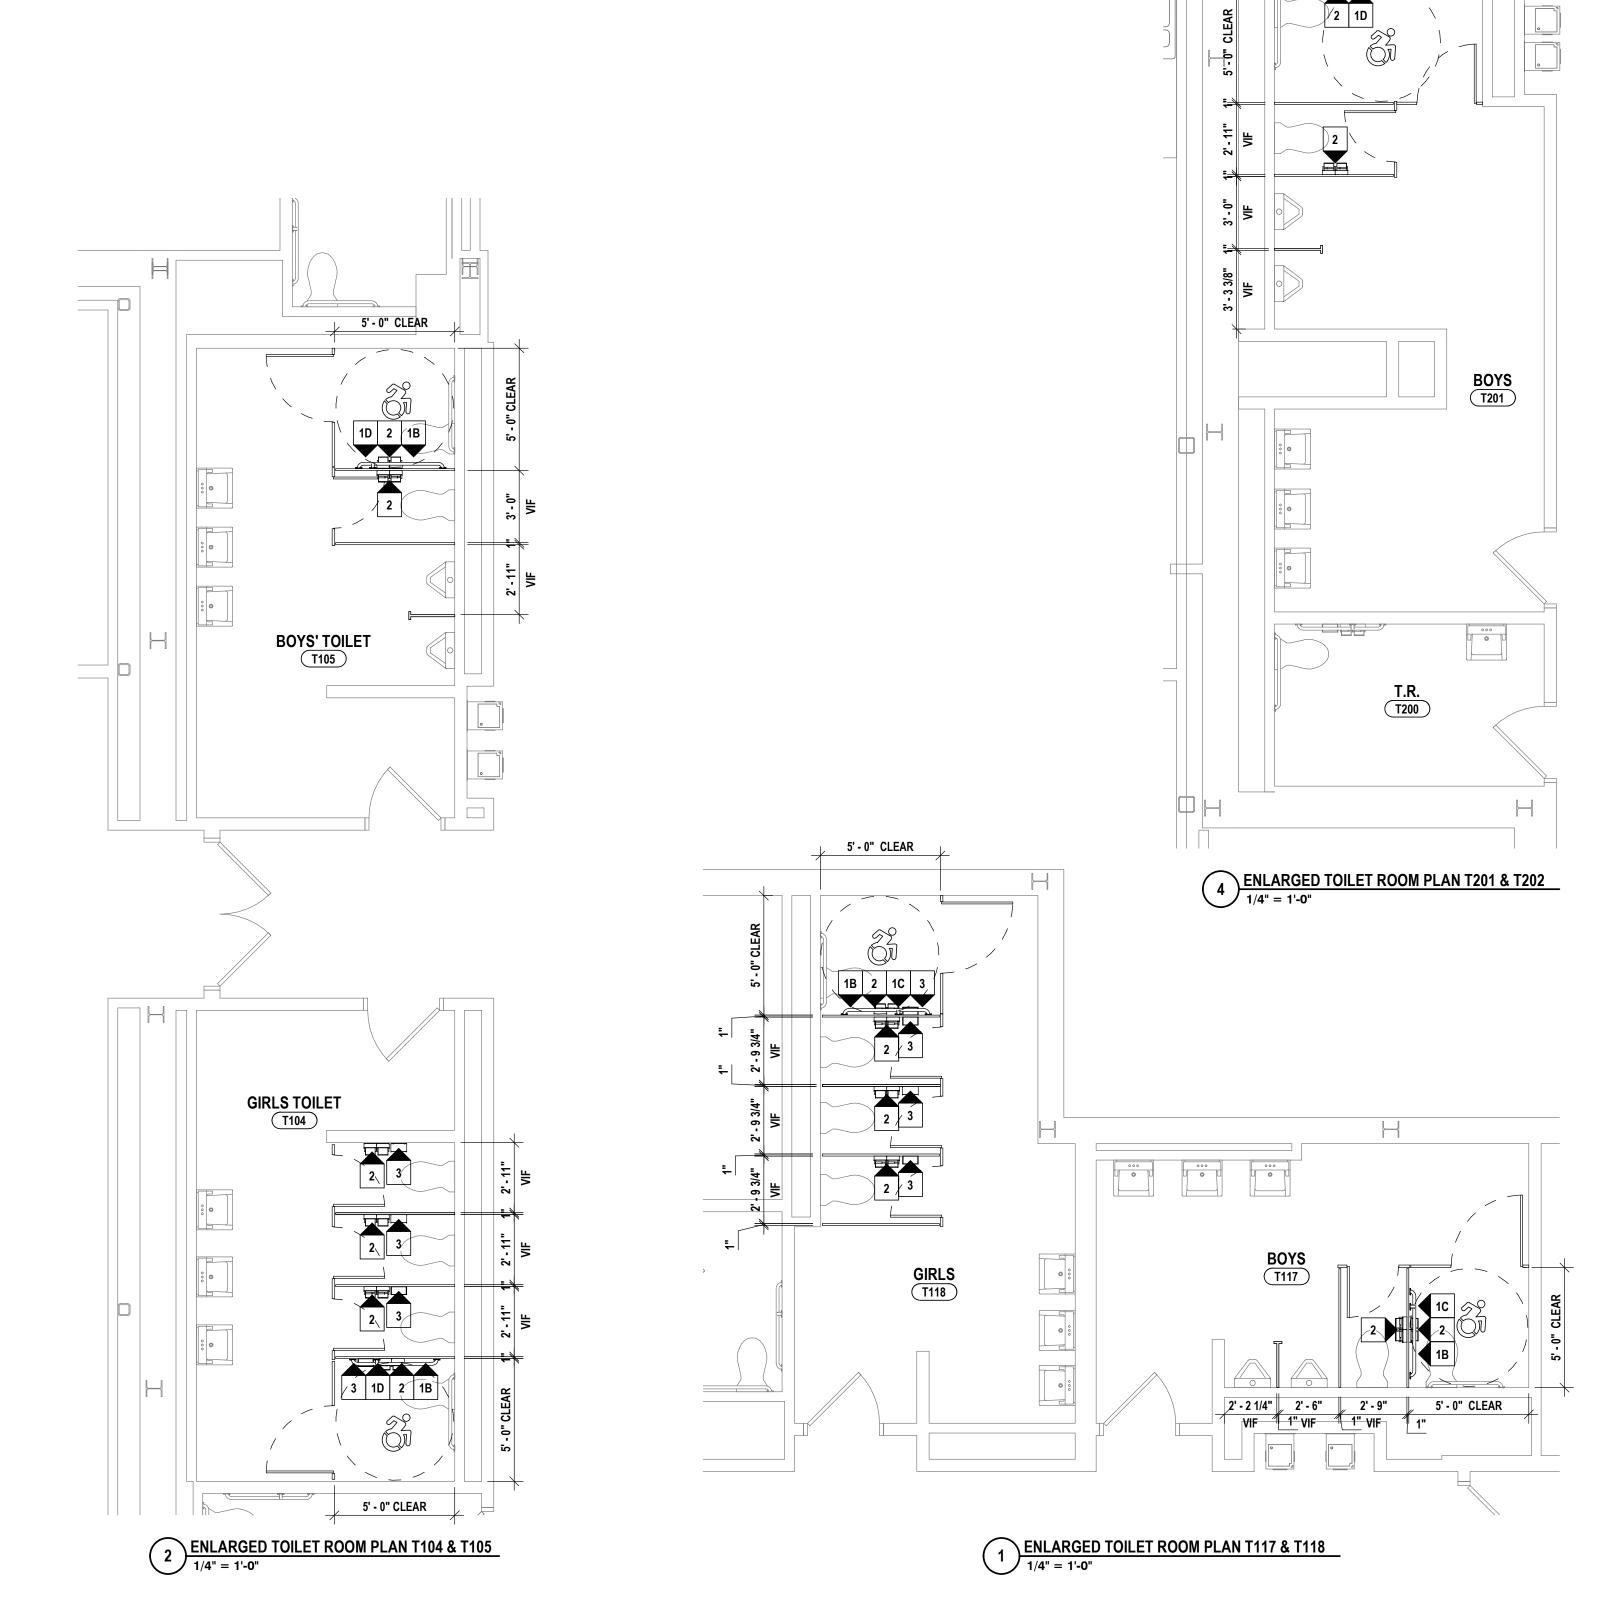

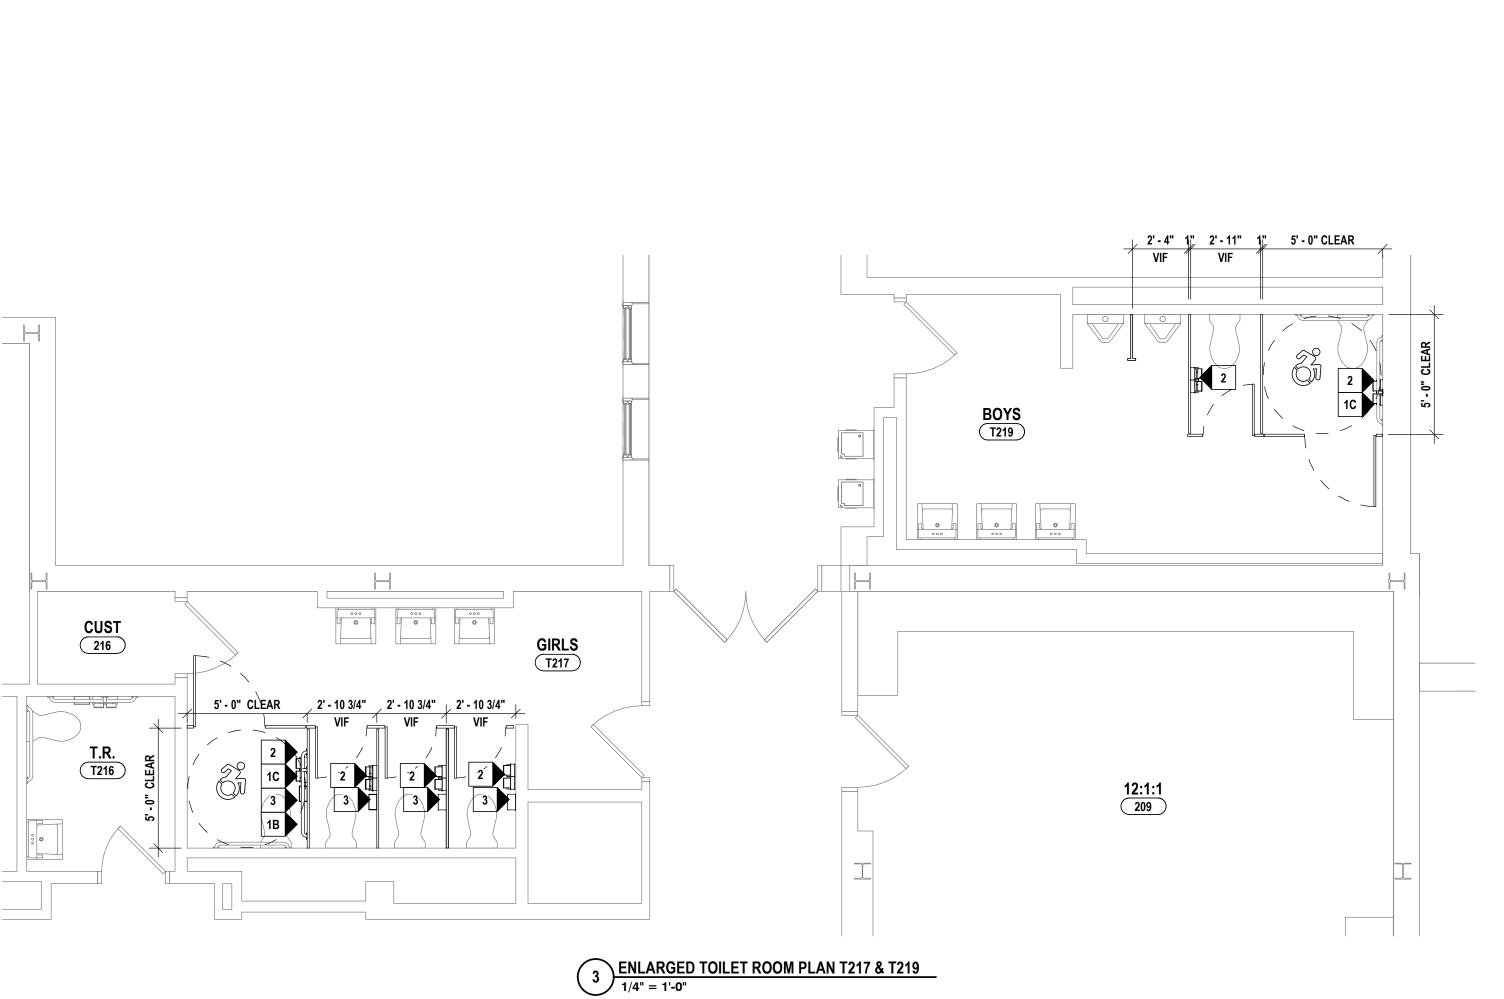

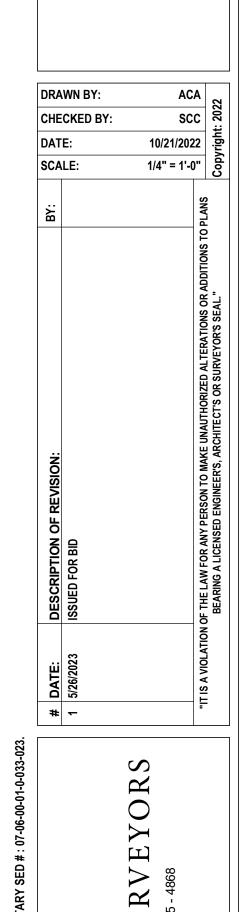

SU 570 - 265

 $\frac{S}{PA}$

ARCHI

ENGINEERS |

± 11' - 4"

GIRLS T202

± 8' - 8"


2' - 11" VIF

ENLARGED TOILET PLANS & SCHEDULES

ELEMENTARY SCHOOLS 2023 RENOVATIONS (PHASI
ELMIRA CITY SCHOOL DISTRICT

ELMIRA, CHEMUNG COUNTY, NEW YORK

BC-A5.1

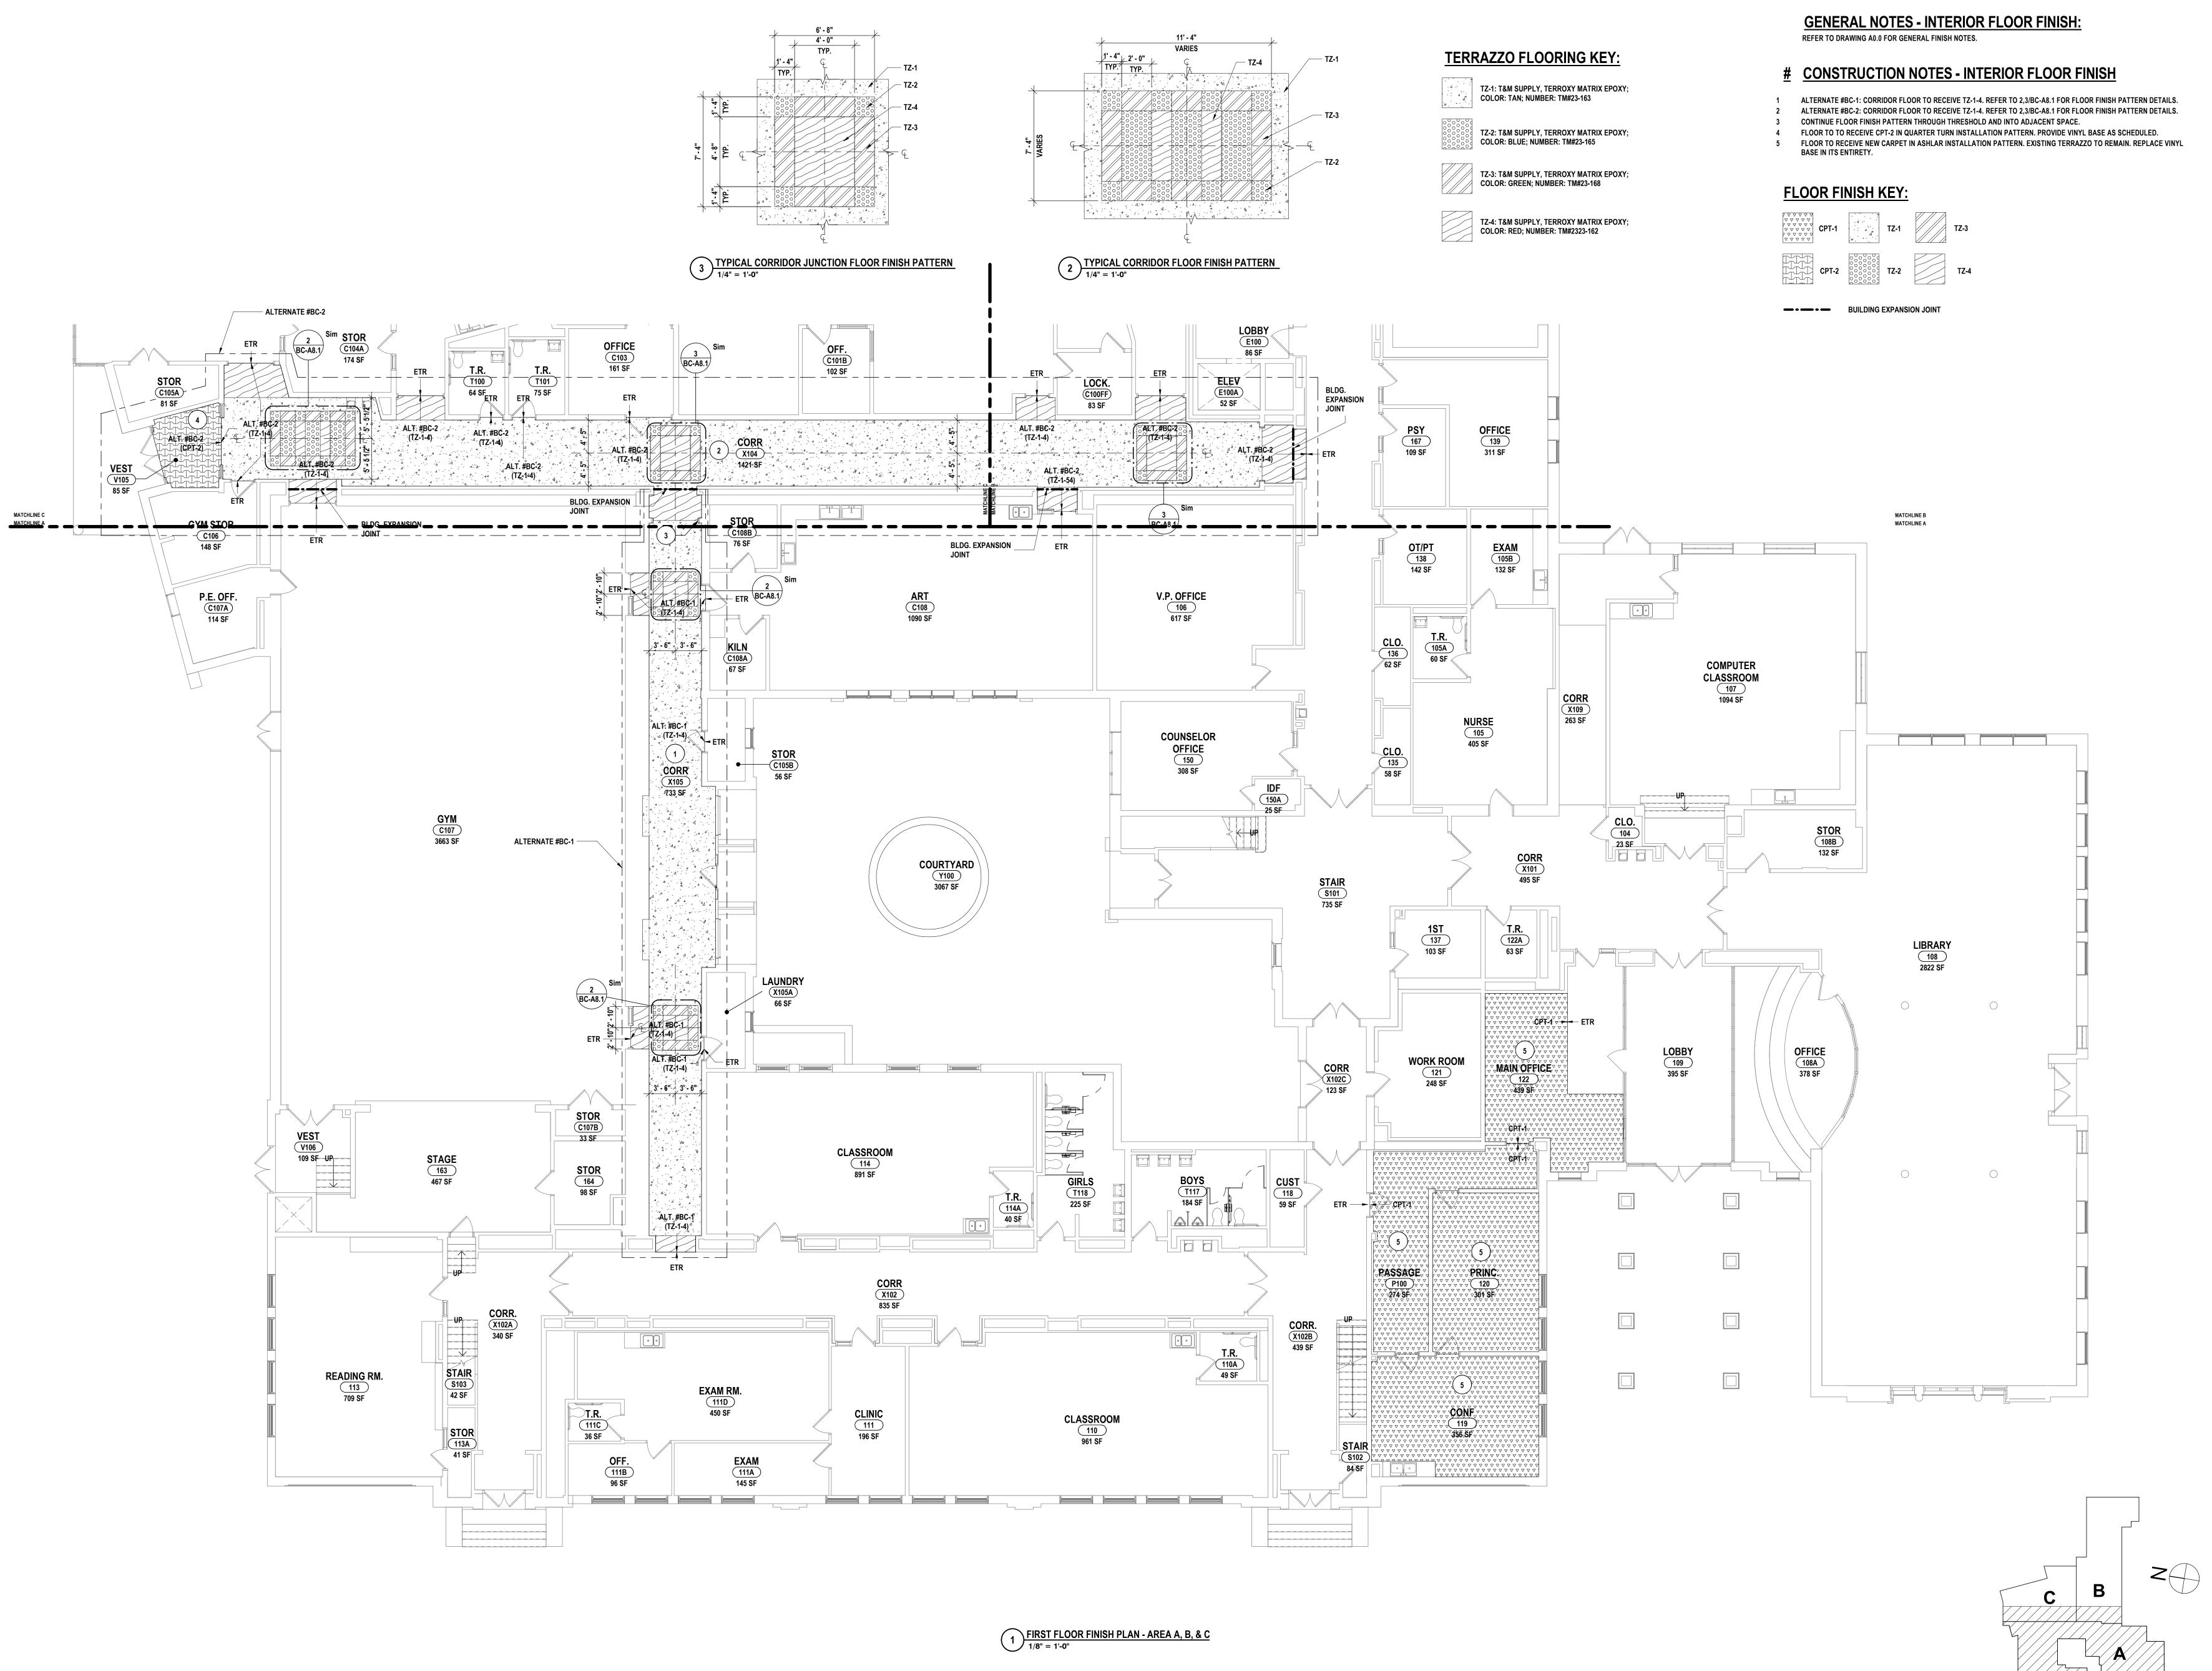

10/21/2022 As indicated


CHECKED BY:

S ENGINEERS | ARCHITEC

PLAN - AREA A, B,

BC-A8.1

PROJECT NO: 2012-233

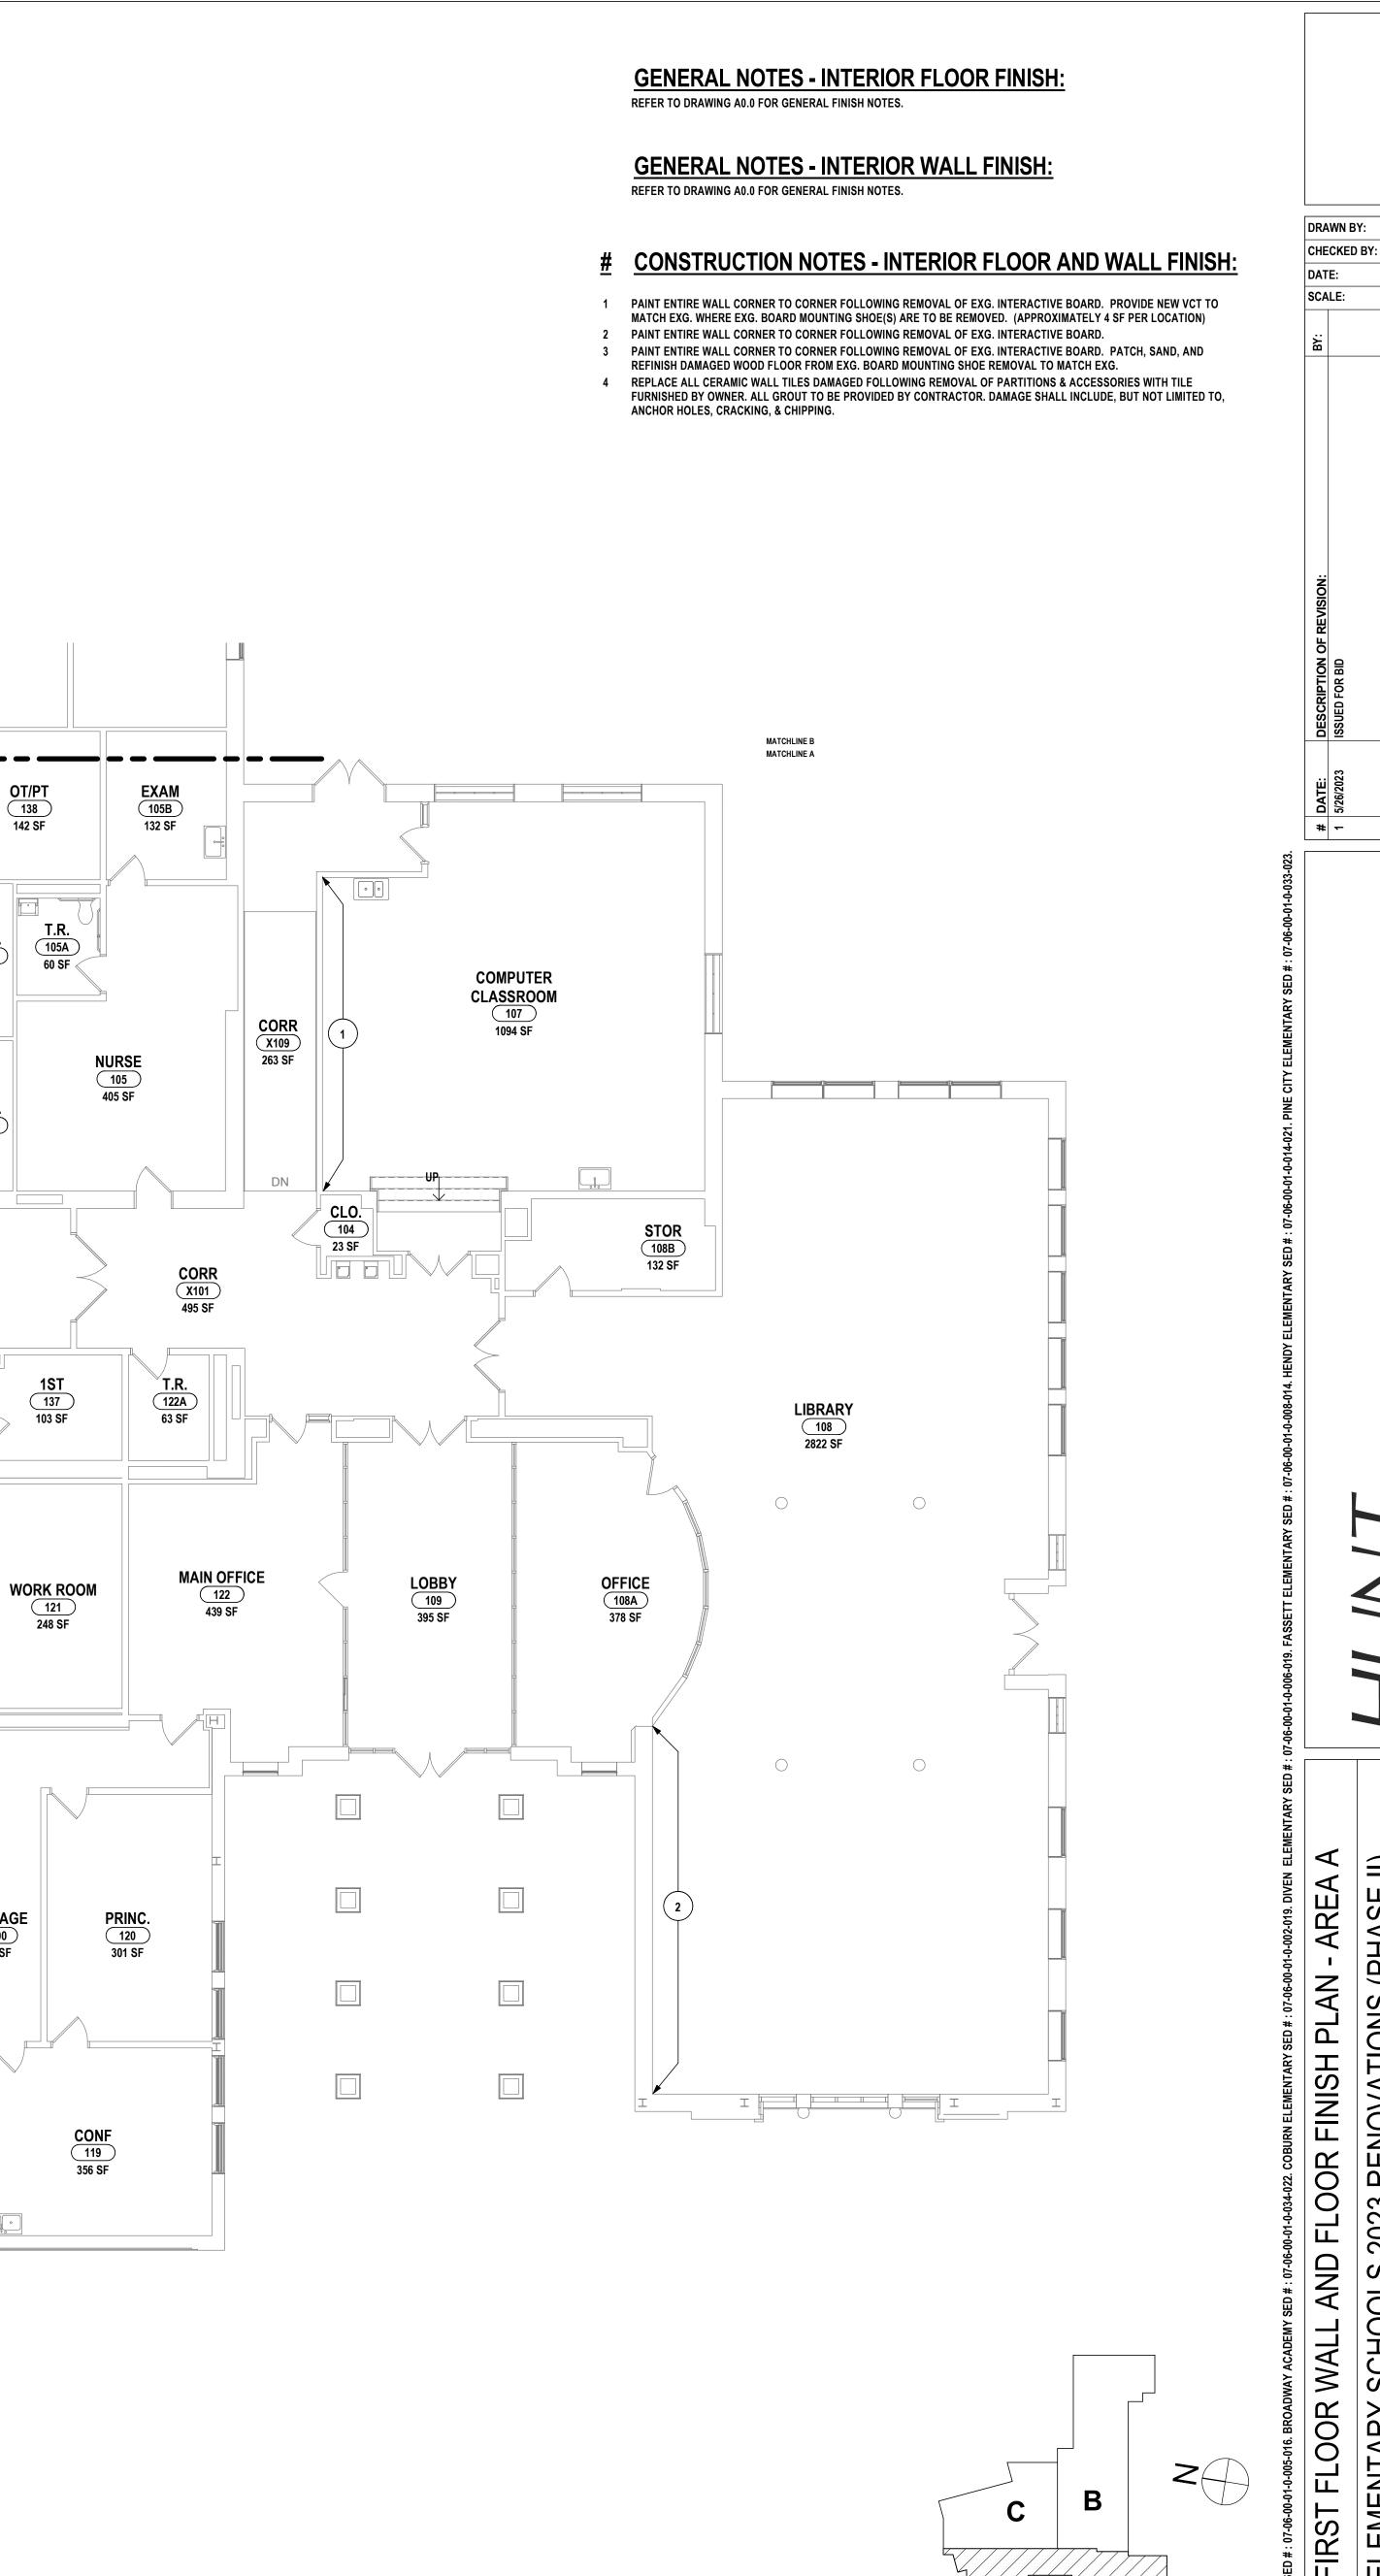

V.P. OFFICE 106 617 SF

COUNSELOR OFFICE

308 SF

 $\underbrace{ 1 }_{1/8"} \underbrace{ \text{FIRST FLOOR WALL AND FLOOR FINISH PLAN - AREA A} }_{1/8"}$

1DF 150A 25 SF

STAIR \$101 735 SF

CORR. (X102B) 439 SF

1ST 137 103 SF

ART C108

COURTYARD Y100 3067 SF

CORR X105 733 SF

STOR 164 98 SF

T.R. 111C 36 SF

111A 145 SF

CORR. (X102A) 340 SF

P.E. OFF. C107A

VEST V106 109 SF UP

1/8" = 1'-0"

10/21/2022

S ENGINEERS | ARCHITEC

- AREA A FLOOR WALL AND FLOOR FINISH PLAN

BC-A8.2



GENERAL NOTES - INTERIOR FLOOR FINISH:

REFER TO DRAWING A0.0 FOR GENERAL FINISH NOTES.

MATCHLINE B MATCHLINE A

GENERAL NOTES - INTERIOR WALL FINISH:

CONSTRUCTION NOTES - INTERIOR FLOOR AND WALL FINISH:

- 1 PAINT ENTIRE WALL CORNER TO CORNER FOLLOWING REMOVAL OF EXG. INTERACTIVE BOARD. PROVIDE NEW VCT TO MATCH EXG. WHERE EXG. BOARD MOUNTING SHOE(S) ARE TO BE REMOVED. (APPROXIMATELY 4 SF PER LOCATION)
- PAINT ENTIRE WALL CORNER TO CORNER FOLLOWING REMOVAL OF EXG. INTERACTIVE BOARD.
- PAINT ENTIRE WALL CORNER TO CORNER FOLLOWING REMOVAL OF EXG. INTERACTIVE BOARD. PATCH, SAND, AND REFINISH DAMAGED WOOD FLOOR FROM EXG. BOARD MOUNTING SHOE REMOVAL TO MATCH EXG.
- 4 REPLACE ALL CERAMIC WALL TILES DAMAGED FOLLOWING REMOVAL OF PARTITIONS & ACCESSORIES WITH TILE FURNISHED BY OWNER. ALL GROUT TO BE PROVIDED BY CONTRACTOR. DAMAGE SHALL INCLUDE, BUT NOT LIMITED TO, ANCHOR HOLES, CRACKING, & CHIPPING.

DRAWN BY:

SCALE:

CHECKED BY:

10/21/2022


1/8" = 1'-0"

S ENGINEERS | ARCHITEC

- AREA B & FIRST FLOOR WALL AND FLOOR FINISH PLAN
ELEMENTARY SCHOOLS 2023 RENOVATIONS //

BC-A8.3

PROJECT NO: 2012-233

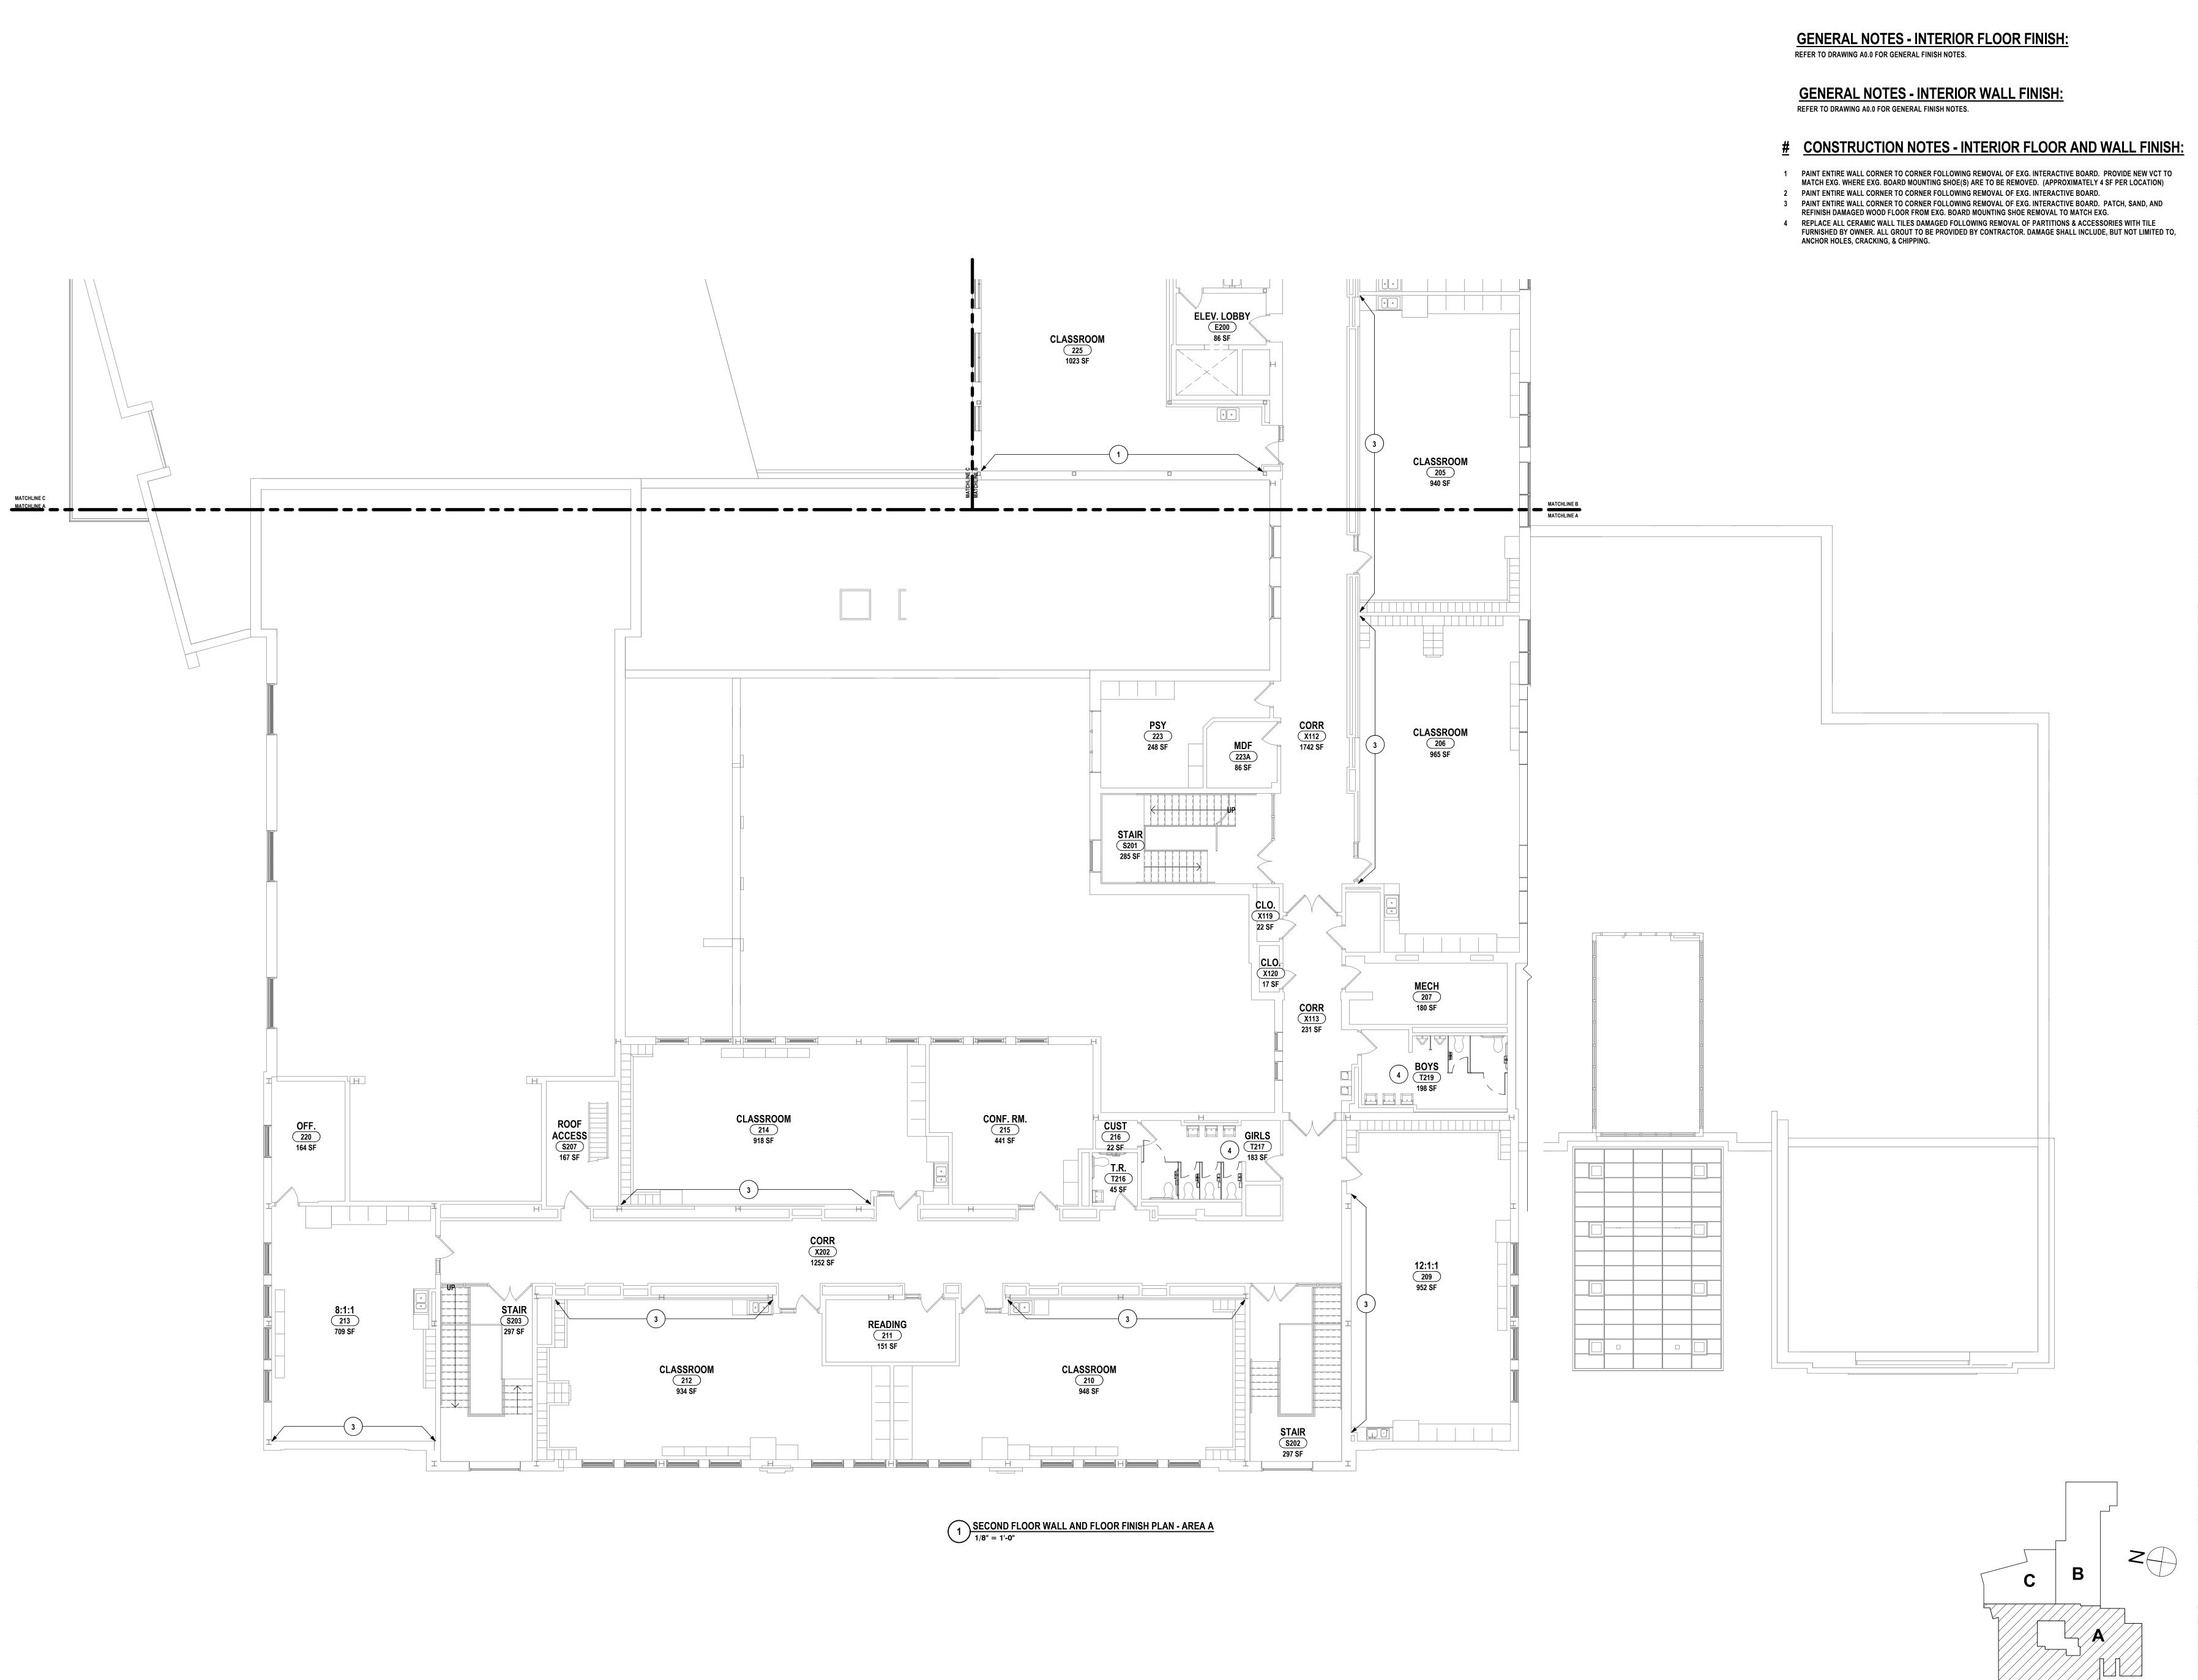


10/21/2022 1/8" = 1'-0"

ENGINEERS | ARCHITEC

COND FLOOR WALL AND FLOOR FINISH PLAN - AREA A S 2023 RENOVATIONS (PHASE DISTRICT

BC-A8.4

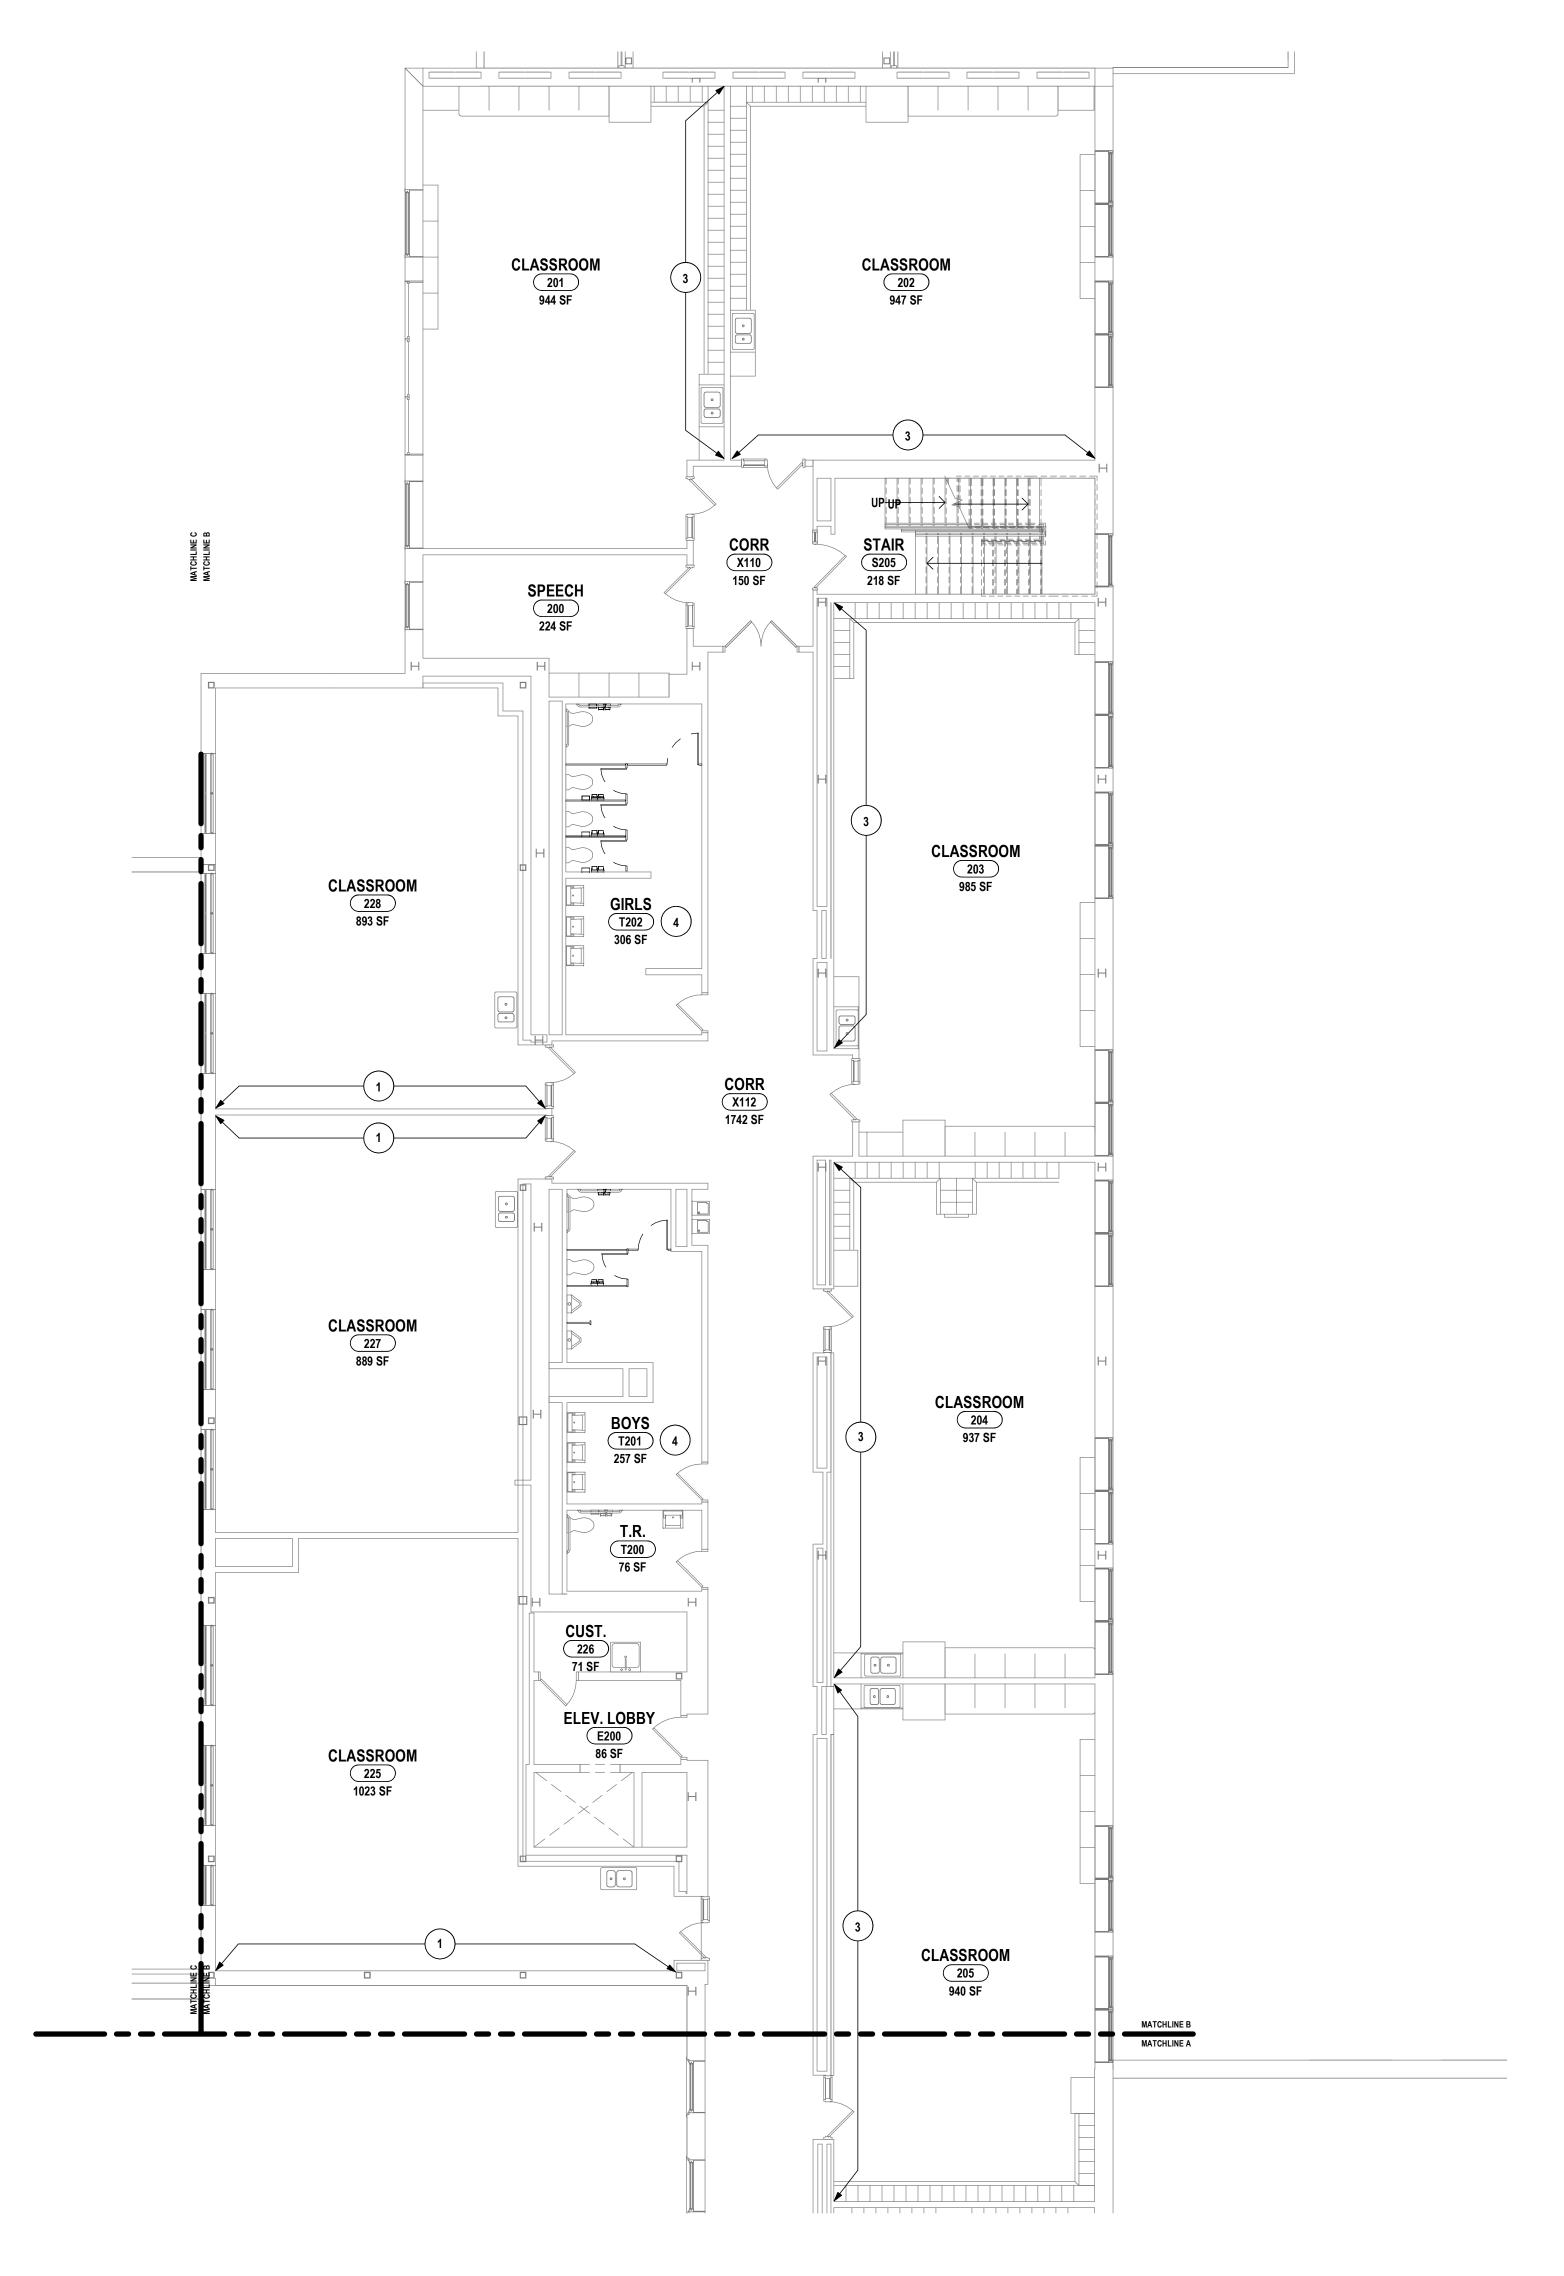

SECOND FLOOR WALL AND FLOOR FINISH PLAN - AREA B

1/8" = 1'-0"

GENERAL NOTES - INTERIOR FLOOR FINISH:

REFER TO DRAWING A0.0 FOR GENERAL FINISH NOTES.

GENERAL NOTES - INTERIOR WALL FINISH: REFER TO DRAWING A0.0 FOR GENERAL FINISH NOTES.

CONSTRUCTION NOTES - INTERIOR FLOOR AND WALL FINISH:

1 PAINT ENTIRE WALL CORNER TO CORNER FOLLOWING REMOVAL OF EXG. INTERACTIVE BOARD. PROVIDE NEW VCT TO MATCH EXG. WHERE EXG. BOARD MOUNTING SHOE(S) ARE TO BE REMOVED. (APPROXIMATELY 4 SF PER LOCATION) 2 PAINT ENTIRE WALL CORNER TO CORNER FOLLOWING REMOVAL OF EXG. INTERACTIVE BOARD. 3 PAINT ENTIRE WALL CORNER TO CORNER FOLLOWING REMOVAL OF EXG. INTERACTIVE BOARD. PATCH, SAND, AND

REFINISH DAMAGED WOOD FLOOR FROM EXG. BOARD MOUNTING SHOE REMOVAL TO MATCH EXG. 4 REPLACE ALL CERAMIC WALL TILES DAMAGED FOLLOWING REMOVAL OF PARTITIONS & ACCESSORIES WITH TILE FURNISHED BY OWNER. ALL GROUT TO BE PROVIDED BY CONTRACTOR. DAMAGE SHALL INCLUDE, BUT NOT LIMITED TO, ANCHOR HOLES, CRACKING, & CHIPPING.

CHECKED BY: 10/21/2022 SCALE: 1/8" = 1'-0"

> S ENGINEERS | ARCHITEC

COND FLOOR WALL AND FLOOR FINISH PLAN - AREA B S 2023 RENOVATIONS (PHASE DISTRICT

BC-A8.5

PROJECT NO: 2012-233

ALTERNATE #BC-1 & #BC-2 ROOM FINISH SCHEDULE										
ROOM NUMBER	ROOM NAME	FLOOR FINISH	WALL BASE	REMARKS						
1ST FLOOR - AREA A										
X105	CORR	TZ-1,2,3,4	ETR	ALTERNATE #BC-1						
1ST FLOOR - AREA B										
V105	VEST	CPT-2	RB-2	ALTERNATE #BC-2						
X104	CORR	TZ-1,2,3,4	ETR	ALTERNATE #BC-2						


ROOM FINISH SCHEDULE GENERAL NOTES:
1. REFER TO MASTER FINISH KEY FOR MATERIAL DEFINITIONS.
2."ETR": EXISTING TO REMAIN
3. "PTM": PATCH TO MATCH EXISTING, ADJACENT FINISHES

 $^{\prime}EC$ ARCHI. ENGINEERS | 07-358-1000 ROCHESTER, NY

RENOVATIONS (PHASE

INTERIOR ROOM FINISH SCHEDULE LS 2023 RE DISTRICT ELEMENTARY SELMIRA CITY SELMIRA, CHEMUNG COUNTY,

BC-A9.1

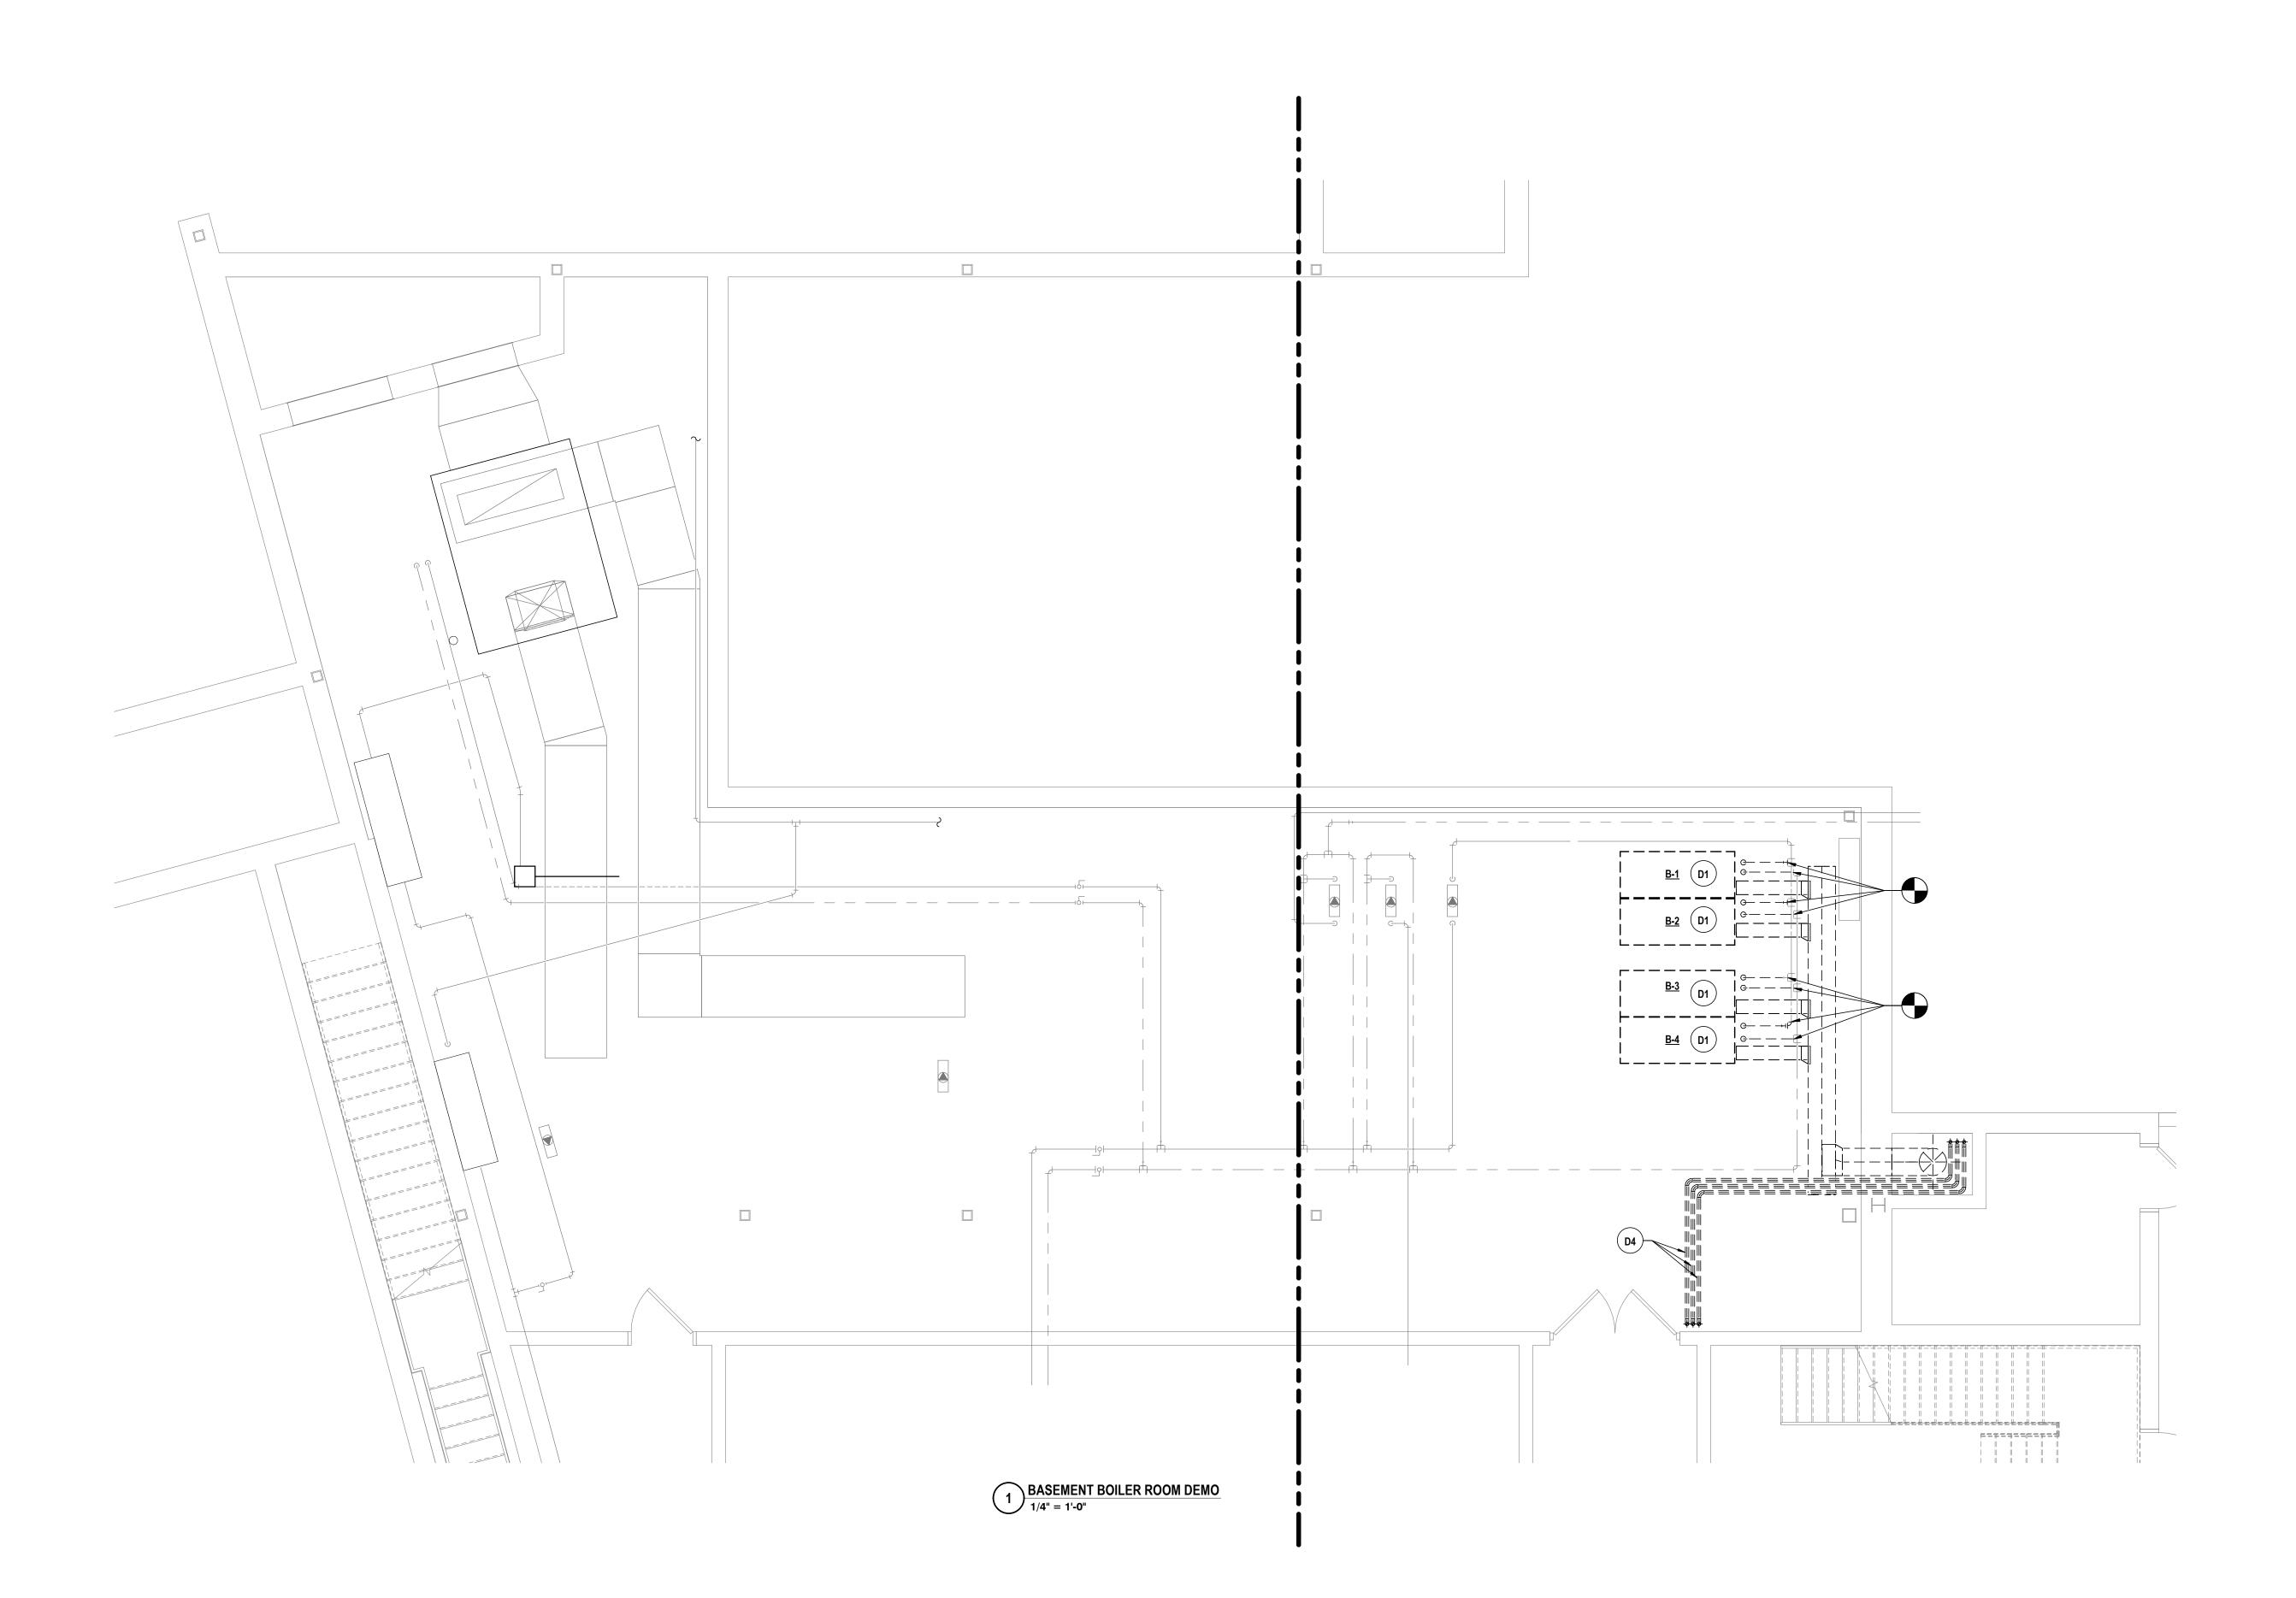

GENERAL NOTES - MECHANICAL

- A ALL EQUIPMENT INTENDED TO BE TURNED OVER TO THE OWNER, SHALL BE BALANCED, FULLY CONTROLLED & FUNCTIONALLY TESTED REGARDLESS OF SUBSTANTIAL COMPLETION DATE.
- B THIS DRAWING IS INTENDED TO SHOW THE GENERAL SCOPE OF ITEMS TO BE REMOVED. IT IS NOT INTENDED TO BE ALL INCLUSIVE. THE CONTRACTOR SHALL FIELD VERIFY ALL ITEMS TO BE REMOVED. ANY ITEM IN QUESTION SHOULD BE VERIFIED WITH THE ENGINEER PRIOR TO REMOVAL.
- REMOVAL.

 C ALL ITEMS SCHEDULED FOR DEMOLITION ARE THE PROPERTY OF THE OWNER. THE CONTRACTOR SHALL PLACE WANTED EQUIPMENT IN AREA DESIGNATED, ON SITE BY THE OWNER. ANY ITEM THE OWNER WISHES NOT TO KEEP SHALL BE DISPOSED OF BY THE CONTRACTOR.
 - PATCHING UNLESS CLEARLY INDICATED TO BE PART OF ANOTHER PRIME CONTRACT. CONTRACTOR TO PATCH TO MATCH ALL EXISTING FINISHES RESULTING FROM DEMOLITION WORK UNLESS INDICATED TO BE PART OF ANOTHER PRIME CONTRACT.

 THE CONTRACTOR SHALL REMOVE, PROTECT, REPLACE AND/OR

THE CONTRACTOR WILL BE RESPONSIBLE FOR ALL CUTTING AND

- REINSTALL ANY CEILING OR GRID DAMAGED OR REMOVED AS A RESULT OF EXECUTION OF CONTRACT SCOPE. UNLESS INDICATED TO BE PART OF ANOTHER PRIME CONTRACT.

 COORDINATE ALL NEW ROOF, WALL, AND FLOOR PENETRATIONS WITH OTHER TRADES.
- G PRIOR TO CONSTRUCTION AND INSTALLATION OF NEW WORK, THE CONTRACTOR SHALL FIELD VERIFY ALL EXISTING CONDITIONS (FRAMING, ELECTRICAL, PLUMBING, HVAC, ETC.). NOTIFY ARCHITECT/ENGINEER OF ANY CONFLICTS THAT REQUIRE MODIFICATION TO NEW HVAC SYSTEM INSTALLATION.

DEMOLITION NOTES - MECHANICAL

- D1 REMOVE BOILER IN ITS ENTIRETY. REMOVE FLUE TO ROOF, HWS/R BACK TO POINTS INDICATED. REMOVE FLUE & STACK TO ROOF. ALTERNATE BC-3.
- D2 REMOVE VAV BOX & DUCTWORK BACK TO POINT INDICATED. REMOVE HWS/R TO ALLOW FOR INSTALLATION OF NEW VAV.
- ALLOW FOR INSTALLATION OF NEW VAV.

 D3 REMOVE AHU, EXHAUST FAN, ROOF MOOUNTED DUCTWORK, CONDENING UNIT & REFRGIERANT PIPING IN THEIR ENTIRETY. REMOVE ROOF HOOD, DUCTWORK &
- HWS/R BACK TO POINT INDICATED.

 D4 REMOVE WATER HEATER FLUE TO ROOF IN ITS ENTIRETY.

	WN BY:	КТК	22
CHE	CKED BY:	JDG	Copyright: 2022
DAT		10/21/2022	vriah
SCA	LE:	1/4" = 1'-0"	ပ္ပိ
BY:			
# DATE: DESCRIPTION OF REVISION:	1 5/26/2023 ISSUED FOR BID	"IT IS A VIOLATION OF THE LAW EOD ANY DEDSON TO MAKE INAUTHODIZED ALTEDATIONS OD ADDITIONS TO DIANS	BEARING A LICENSED ENGINEER'S, ARCHITECT'S OR SURVEYOR'S SEAL."

HORSEHEADS, NY 607 - 358 - 1000 ROCHESTER, NY 585 - 327 - 7949 TOWANDA, PA 570 - 265 - 4868

PLAN PLS 2023 RENOVATIONS (PHASE II)

R ROOM DEMO PLAN

INTARY SCHOOL DISTRICT

BC-H0.1


PROJECT NO: 2012-233

REFER TO BC-H0.1.


DEMOLITION NOTES - MECHANICAL

- REMOVE BOILER IN ITS ENTIRETY. REMOVE FLUE TO ROOF, HWS/R BACK TO POINTS INDICATED. REMOVE FLUE & STACK TO ROOF. ALTERNATE BC-3.
- REMOVE VAV BOX & DUCTWORK BACK TO POINT INDICATED. REMOVE HWS/R TO ALLOW FOR INSTALLATION OF NEW VAV.
- REMOVE AHU, EXHAUST FAN, ROOF MOOUNTED DUCTWORK, CONDENING UNIT & REFRGIERANT PIPING IN THEIR ENTIRETY. REMOVE ROOF HOOD, DUCTWORK & HWS/R BACK TO POINT INDICATED.

D4 REMOVE WATER HEATER FLUE TO ROOF IN ITS ENTIRETY.

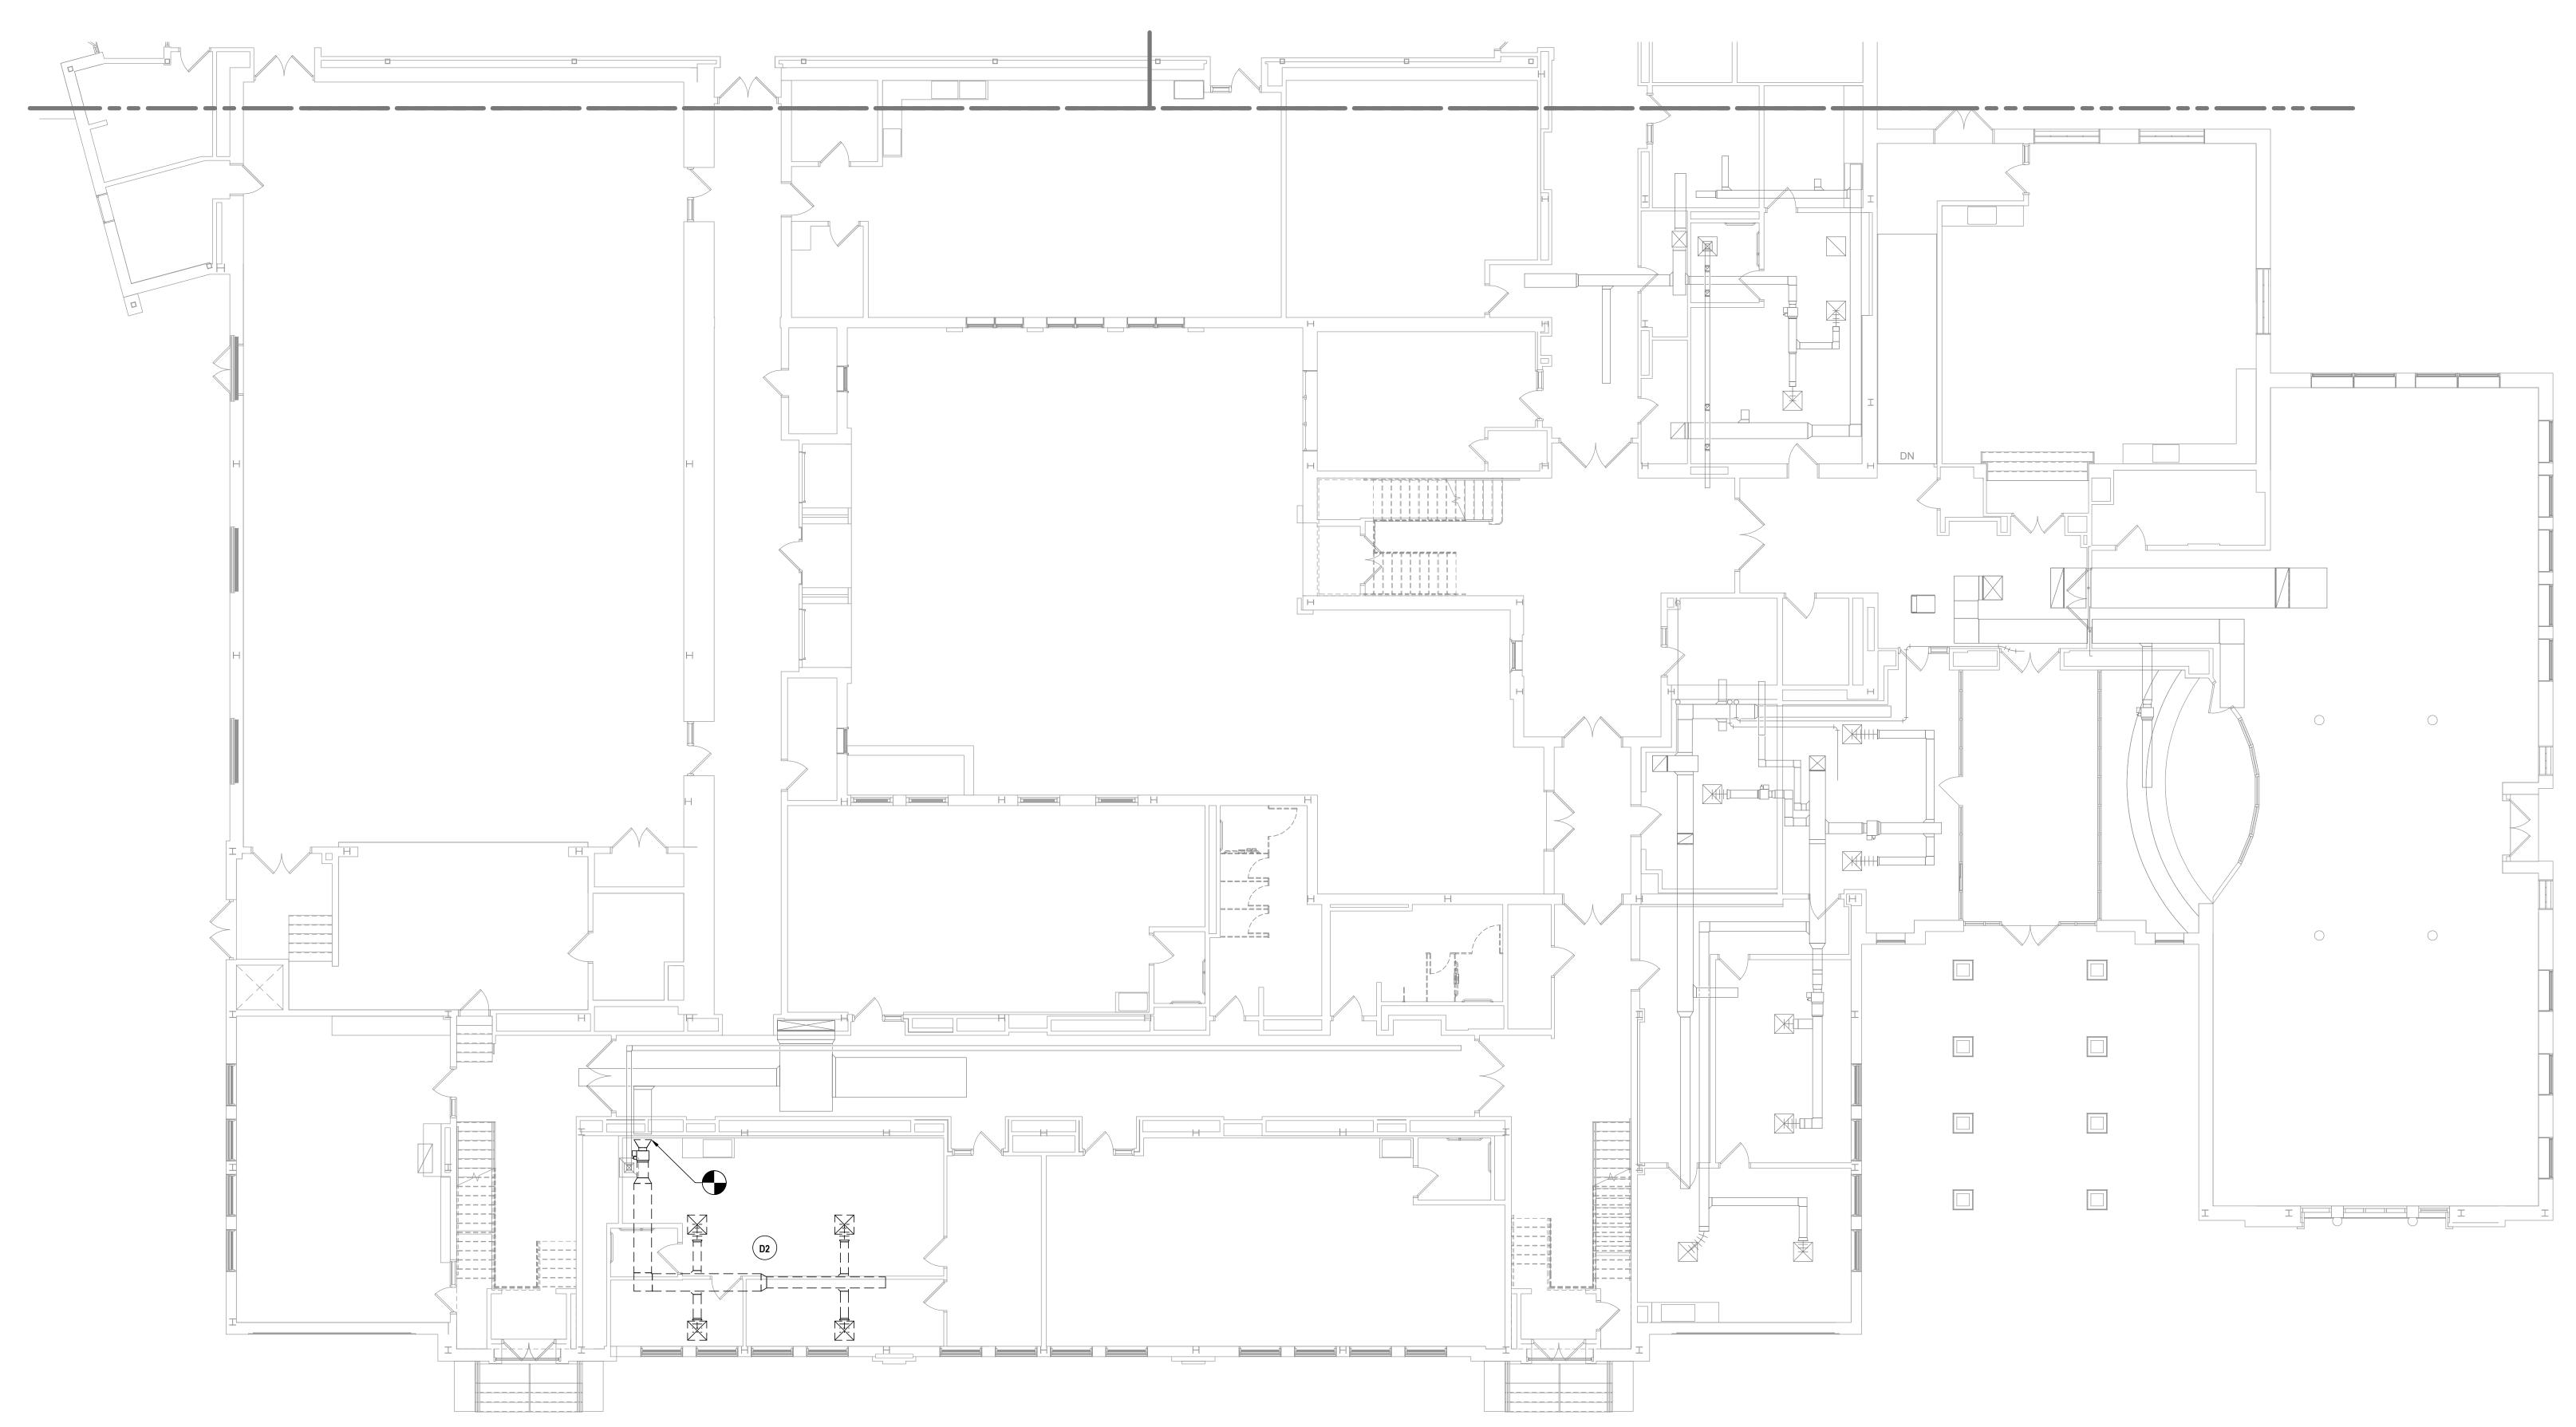


1 FIRST FLOOR HVAC DEMOLITION PLAN - AREA A 1/8" = 1'-0"

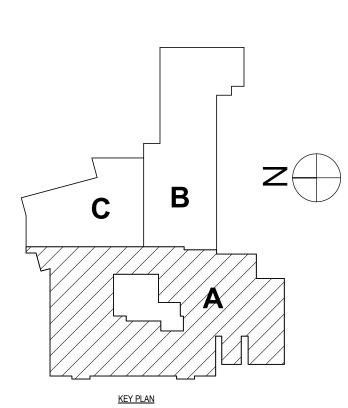

DRAWN BY: CHECKED BY: 10/21/2022 1/8" = 1'-0"

 \sim 6 ENGINEERS | ARCHITEC

BC-H0.2

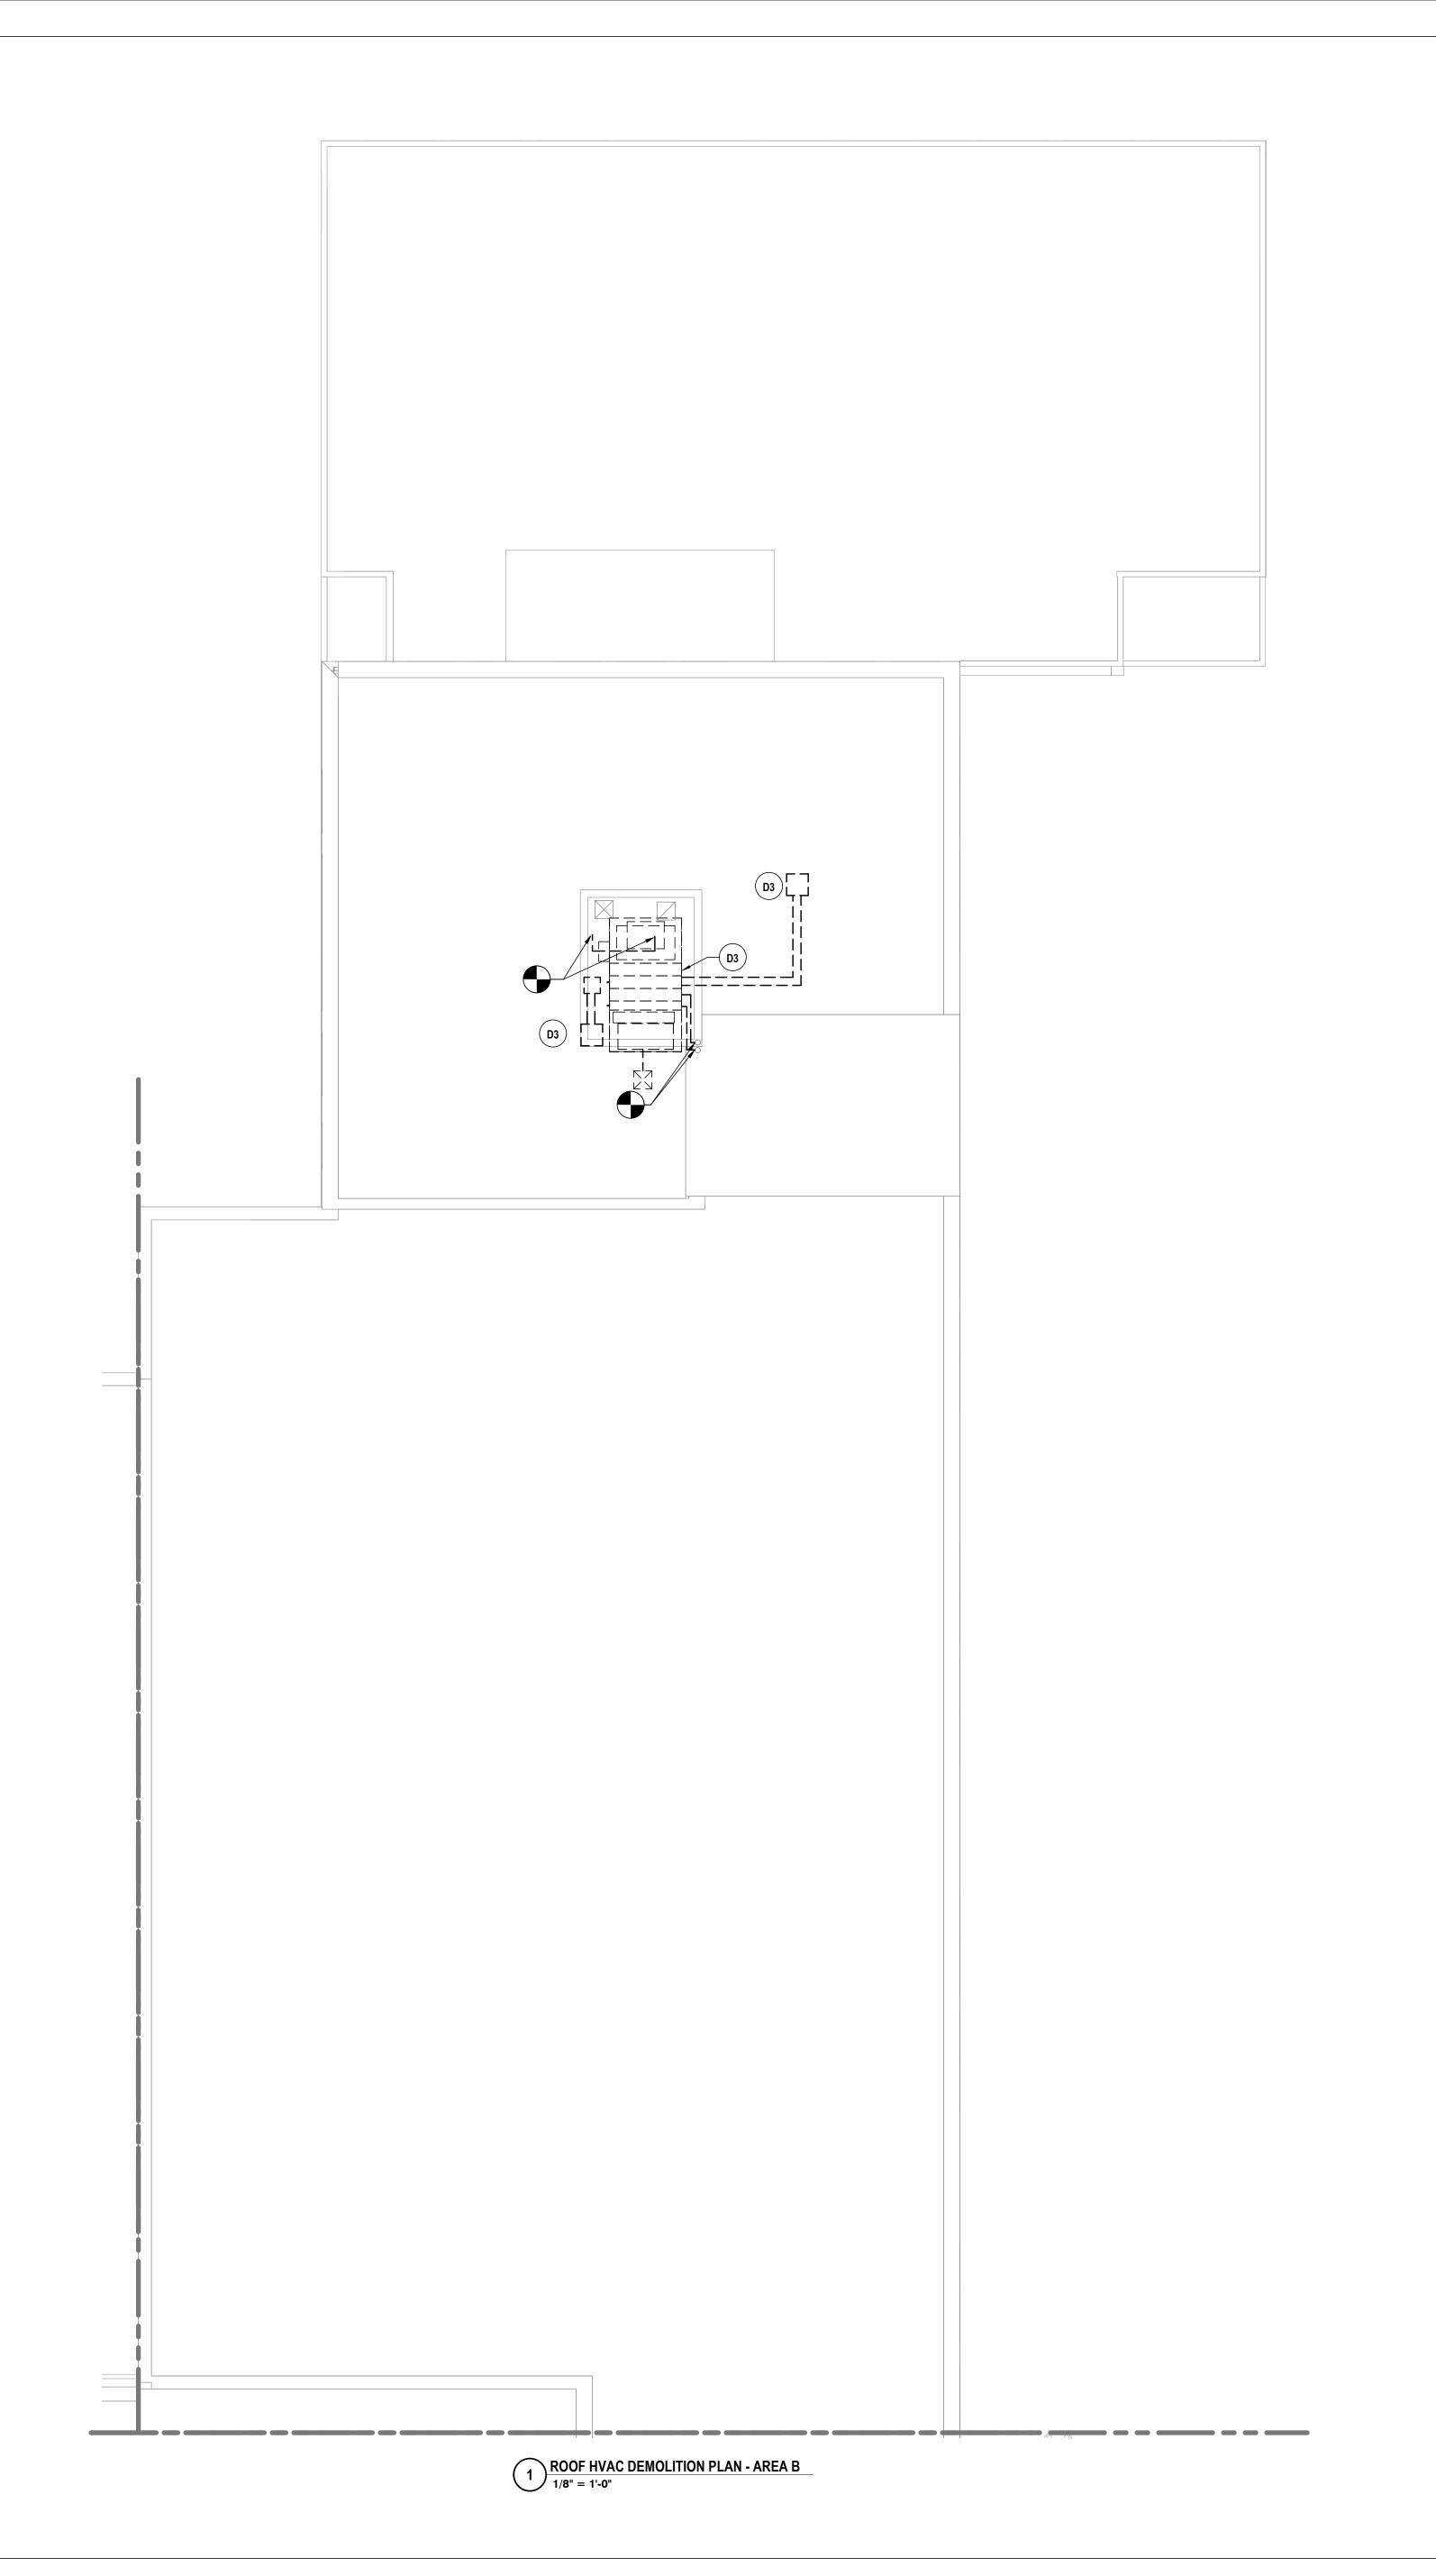

GENERAL NOTES - MECHANICAL

REFER TO BC-H0.1.

DEMOLITION NOTES - MECHANICAL

- REMOVE BOILER IN ITS ENTIRETY. REMOVE FLUE TO ROOF, HWS/R BACK TO POINTS INDICATED. REMOVE FLUE & STACK TO ROOF. ALTERNATE BC-3.
- REMOVE VAV BOX & DUCTWORK BACK TO POINT INDICATED. REMOVE HWS/R TO ALLOW FOR INSTALLATION OF NEW VAV.
- REMOVE AHU, EXHAUST FAN, ROOF MOOUNTED DUCTWORK, CONDENING UNIT & REFRGIERANT PIPING IN THEIR ENTIRETY. REMOVE ROOF HOOD, DUCTWORK & HWS/R BACK TO POINT INDICATED.
- D4 REMOVE WATER HEATER FLUE TO ROOF IN ITS ENTIRETY.

DRAWN BY: CHECKED BY: 10/21/2022 ្តិ SCALE: 1/8" = 1'-0"


ENGINEERS | ARCHITEC

LS 2023 RENOVATIONS (PHASE II) DISTRICT

SED #: 07-06-00-01-0-005-016. BROADWAY ACADEMY SED #: 07-06-00-01-0-034-022. COBURN ELEMENTARY SED #: THIRD FLOOR HVAC DEMO PLAN - AREA B

BC-H0.3

PROJECT NO: 2012-233

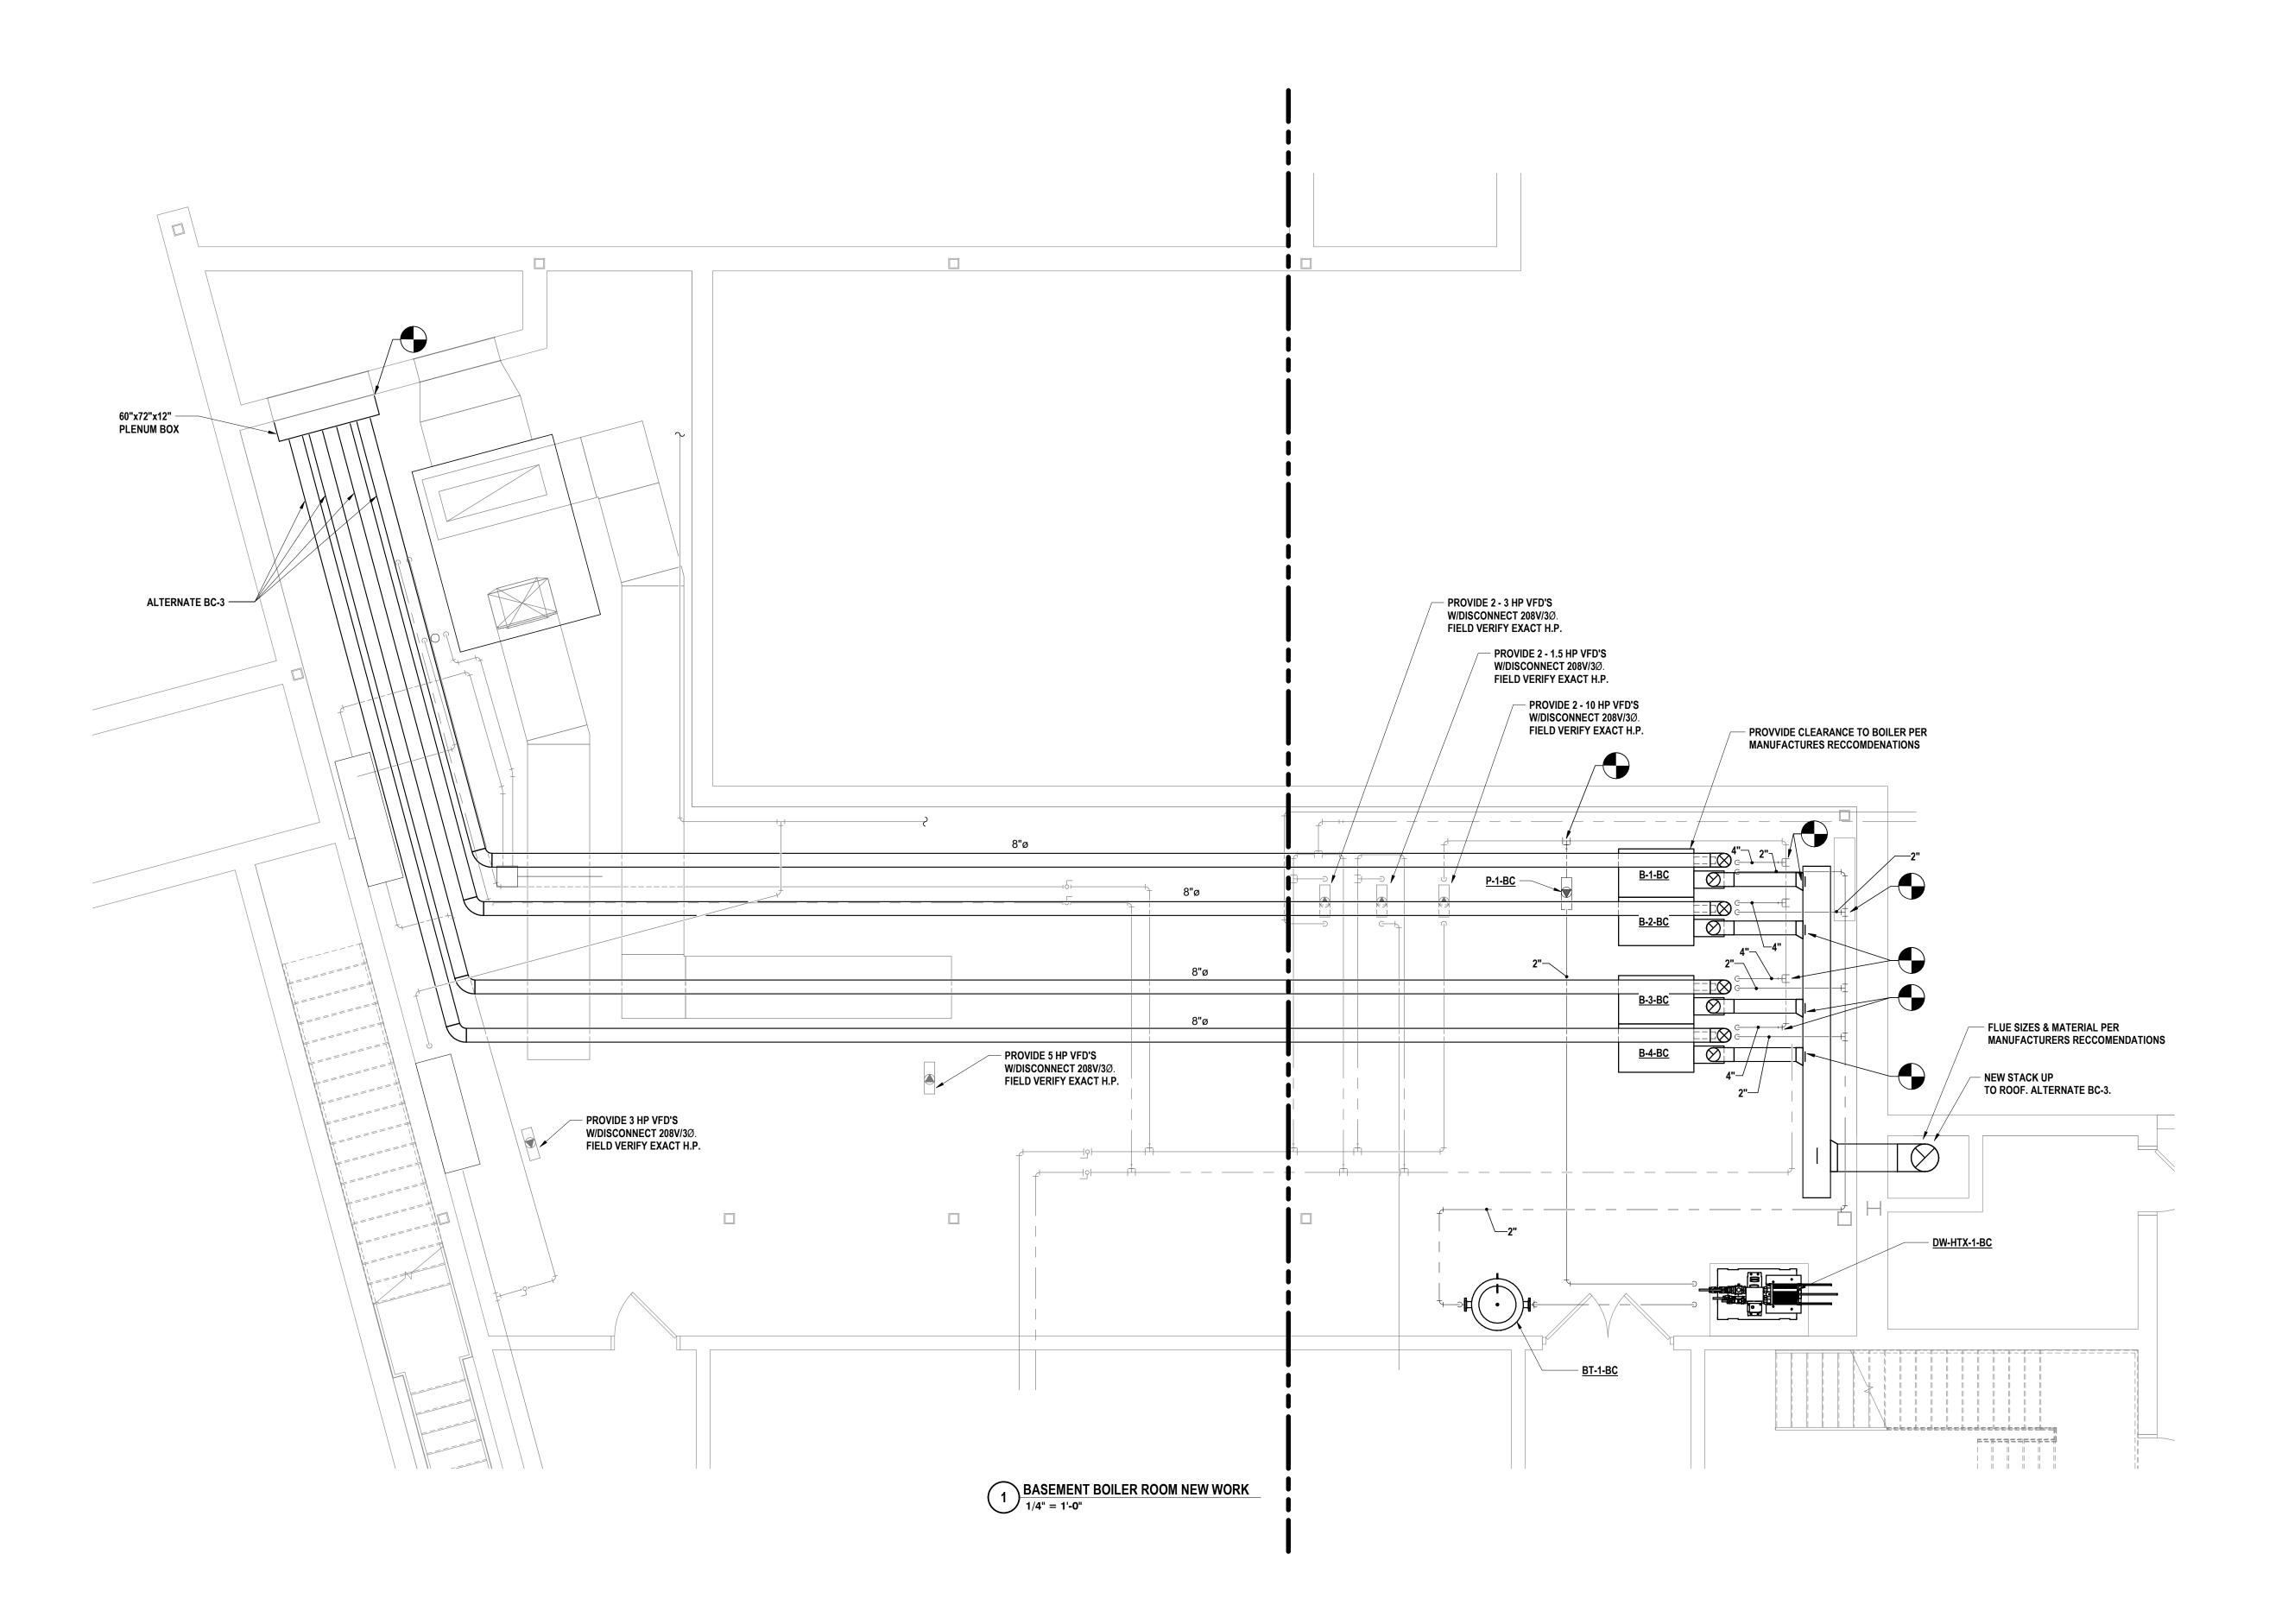

1/4" = 1'-0"

HI INEERS | ENGI


BOILER ROOM NEW WORK PLAN
ELEMENTARY SCHOOLS 2023 RENC
ELMIRA CITY SCHOOL DISTRICT
ELMIRA, CHEMUNG COUNTY, NEW YORK


2

В

KEY PLAN

BC-H1.1 PROJECT NO: 2012-233

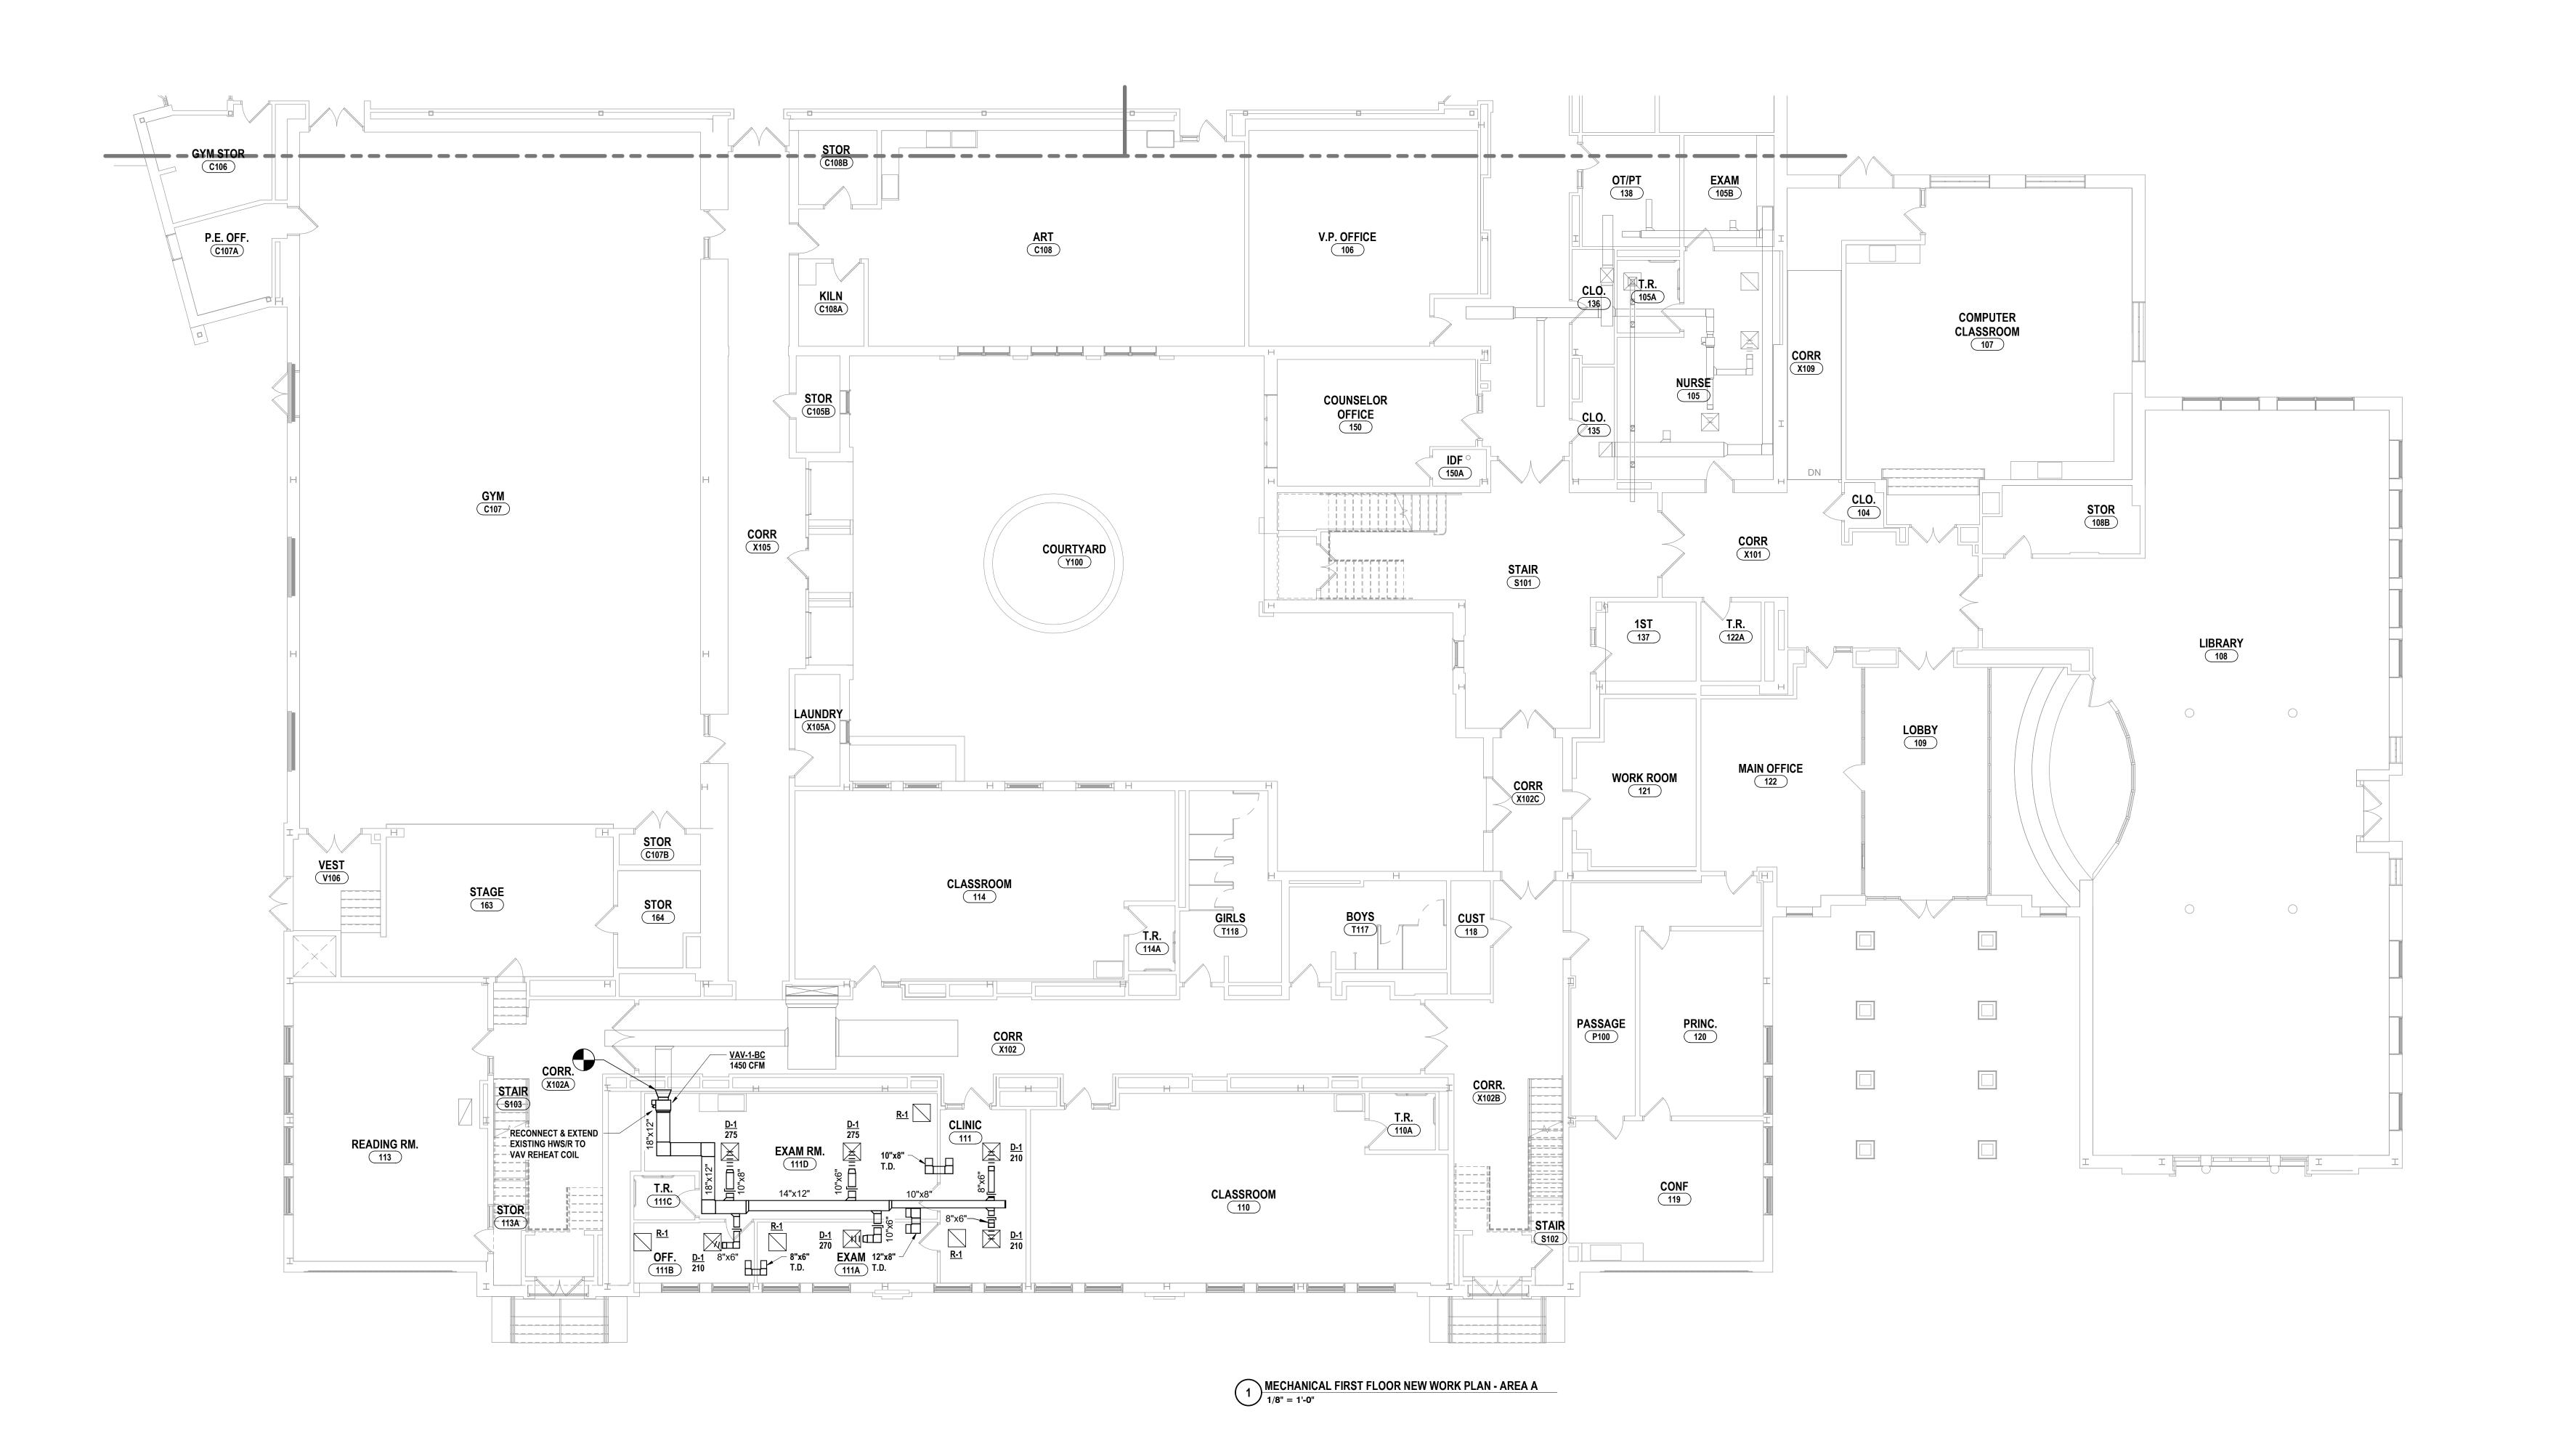

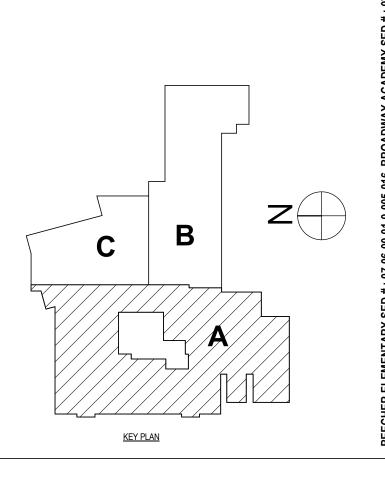


SURVEYORS ARCHITEC. ENGINEERS |

DRAWN BY:

10/21/2022 1/8" = 1'-0"

S 2023 RENOVATIONS DISTRICT FIRST FLOOR HVAC PLAN - AREA A ELEMENTARY SCHOOLS
ELMIRA CITY SCHOOL [
ELMIRA, CHEMUNG COUNTY, NEW YORK

BC-H1.2 PROJECT NO: 2012-233

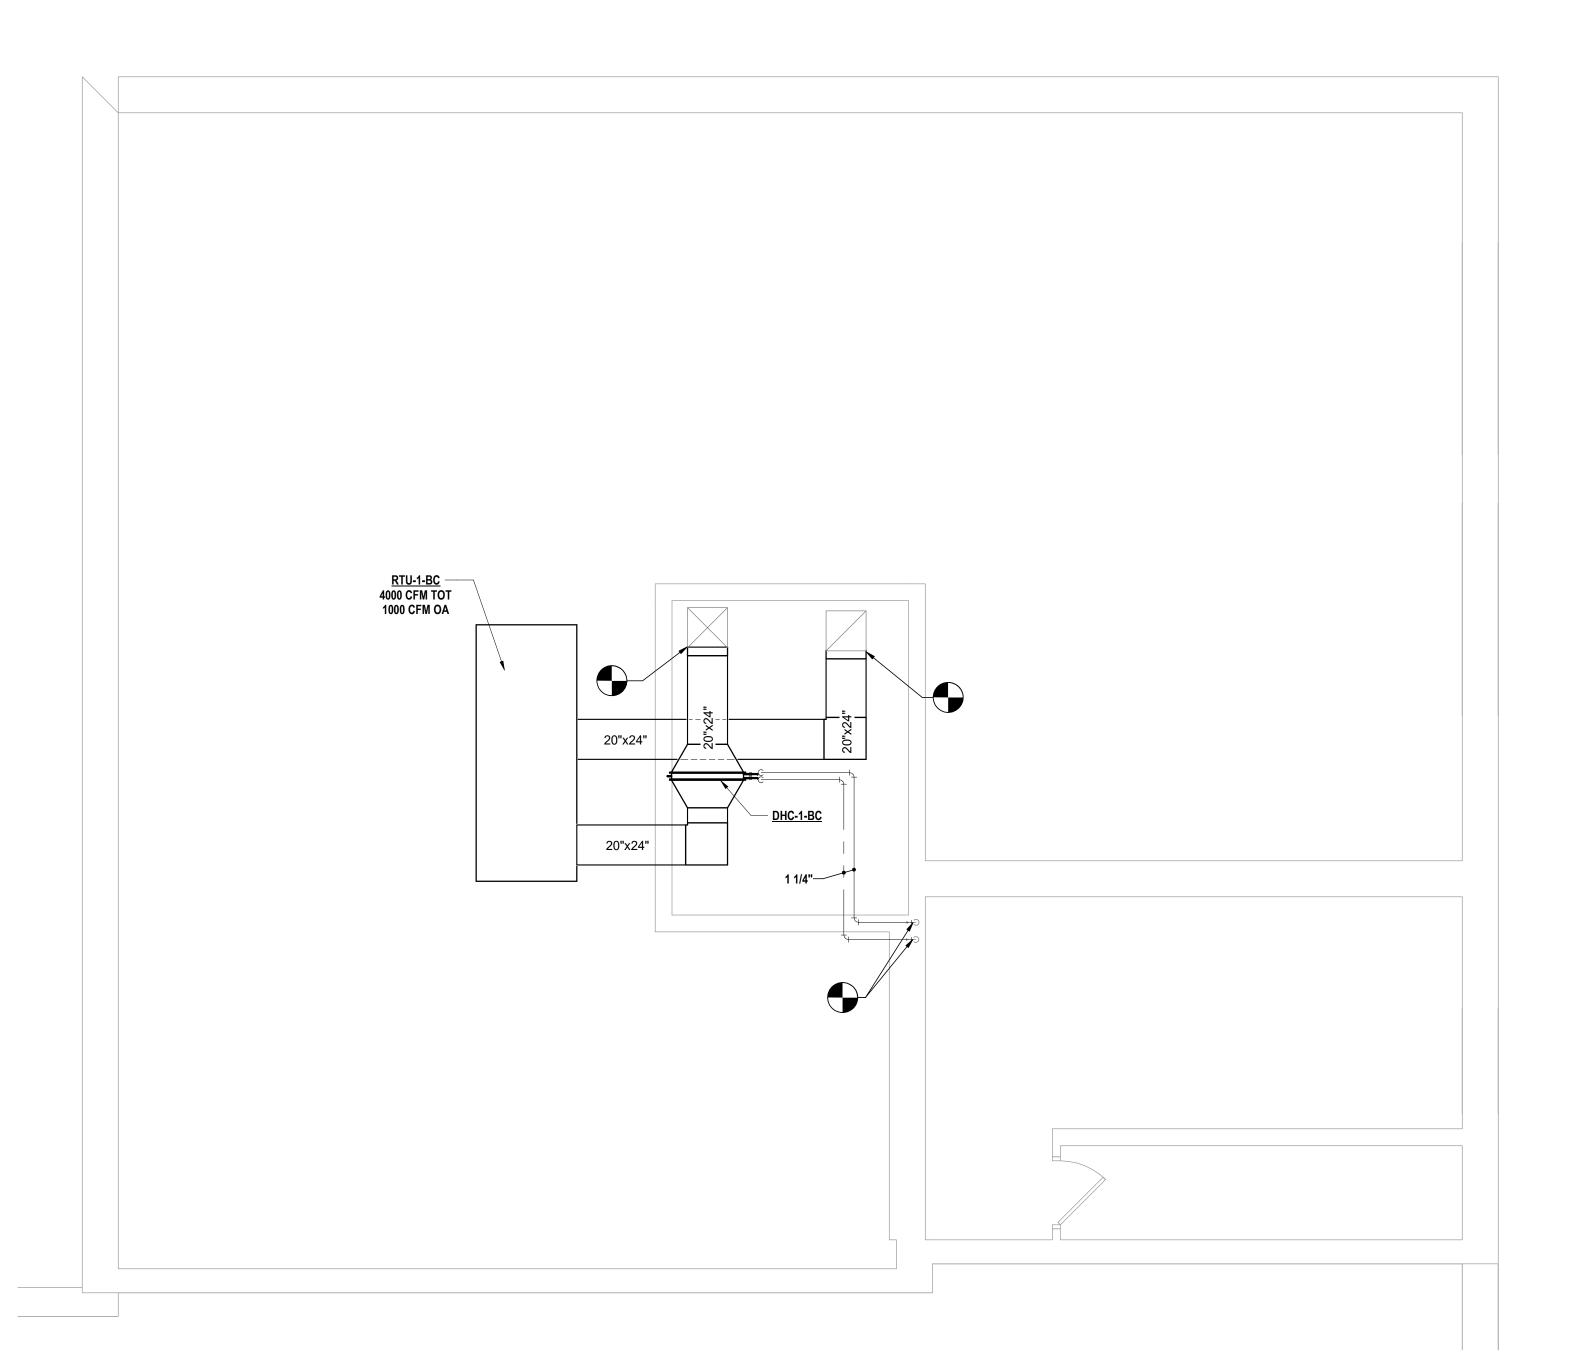

1 ROOF HVAC PLAN - AREA B
1/4" = 1'-0"

 \sim 6 ENGINEERS | ARCHITEC


S 2023 RENOVATIONS (PHASE DISTRICT

THIRD FLOOR HVAC NEW WORK PLAN - AREA B ELEMENTARY SCHOOLS 2023 RENOVATIONS (PH. ELMIRA, CHEMUNG COUNTY, NEW YORK

BC-H1.3

PROJECT NO: 2012-233

10/21/2022 1/4" = 1'-0"

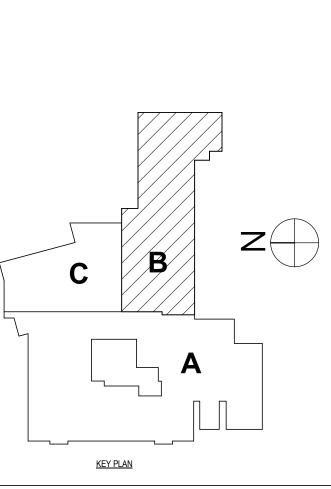

GRILL SCHEDULE									
UNIT #	FUNCTION	MFG/ MODEL	FACE / NECK SIZE	MAX SP	MAX N.C.	BORDER	REMARKS		
R-1	RETURN	PRICE/80D	24x24	•	20	FLANGED			

	VAV SCHEDULE										
UNIT NUMBER	UNIT NO.	INLET DIAMETER (IN)	MAX. CFM	MIN. CFM	ENT AIR (F)	LVG AIR (F)	GPM	WPD MAX	CAP MBH	ENT WTR (F)	NOTES
VAV-1-BC	EX AHU	14	1450	1075	55	95	4	5	44	160	TRANE VCWF 14

	SUPPI	LY DIFFUSE	ER SCHED	ULE	
UNIT #	MFG/ MODEL	FACE / NECK SIZE	MAX. SP	MAX. N.C.	NOTES
D-1	PRICE/SCDA	24x24/8"Ø	•	20	•

	BUFFER TANK SCHEDULE											
UNIT NUMBER	SERVES	MODEL#	TANK VOLUME	TANK DIA. (IN)	TANK HEIGHT (IN)	MAX WORKING PRESSURE	PIPE CONNECTION SIZE	NOTES				
BT-1-BC	DW-HTX-1-BC	AERCO 2 PORT	210	2' - 6"	73.5	125 PSIG	3" NPT	1,2,3				

NOTES: 1. DESIGN MAKE BASED ON AERCO.
2. PROVIDE TANK WITH ASME CERTIFICATION.
3. PROVIDE CONNECTIONS FOR AIR VENT AND DRAIN.

	BOILER SCHEDULE											
				MANUFACTURER &								
UNIT NUMBER	LOCATION	MODEL#	INPUT MBH	OUTPUT MBH	FLUE SIZE	VOLTS	PHASE	AMPS	NOTES			
B-1-BC	BC-H-1.1	BMK-2000-PLATINUM	2000	1920	8"	120 V	1	16 A	AERCO 1,2,3			
B-2-BC	BC-H-1.1	BMK-2000-PLATINUM	2000	1920	8"	120 V	1	16 A	AERCO 1,2,3			
B-3-BC	BC-H-1.1	BMK-2000-PLATINUM	2000	1920	8"	120 V	1	16 A	AERCO 1,2,3			
B-4-BC	BC-H-1.1	BMK-2000-PLATINUM	2000	1920	8"	120 V	1	16 A	AERCO 1.2.3			

NOTES: 1. E.C. TO PROVIDE SEPERATE 20 A CIRCUIT FOR EACH BOILER.
2. RECONNECT TO EXISTING EMEGENCY BOILER SHUTDOWN SWITCHES.
3. ALTERNATE BC-3.

	DOMESTIC HOT WATER HEAT EXCHANGER											
			DOMESTIC WATER SIDE		BOILER WATER SIDE							
UNIT NUMBER	LOCATION	MODEL#	GPM	TOTAL PRESSURE DROP (PSI)	INLET/OUTLET WATER TEMP °F	FLOW GPM	EWT (°F)	LWT (°F)	TOTAL PRESSURE DROP (PSI)	NOTES		
DW-HTX-1-BC	BC-H1.1	SPDW 23	9	1	40/100	26	125	96	5	1,2,3,4,5		

NOTES: 1. DESIGN BASED ON AERCO.
2. PROVIDE PACKAGED 3-WAY ELECTRONIC CONTROL VALVE.
3. PROVIDE STAINLESS STEEL POTABLE WATER SIDE SURFACES.
4. UNIT TO BE ASEM B&PV CODE SECTION VIII DIVISION 1 STAMPED.

ELECTRICAL REQUIREMENTS 120V/1PH, 2AMP.


PUMP SCHEDULE														
	LOCATION					ELEC	CTRIC							
UNIT NUMBER	(SHEET #)	GPM	HEAD FEET	RPM	MOTOR HP	VOLTS	PHASE	MAKE & MODEL#	NOTES					
P-1-BC	BC-H1.1	30	35	2713	1	208 V	3	ARMSTRONG PUMPS 4300DC 1206-000.7	1,2,3					


NOTES: 1. E.C. TO FURNISH AND WIRE DISCONNECT.
2. E.C. TO FURNISH STARTER WITH CONTACT CLOSURE FOR USE BY DDC SYSTEM.
3. B PUMPS REPRESENT STAND-BYE.


START STOP SHALL BE BY DDC SYSTEM.
 PUMP MUST BE SUITABLE FOR CHLORINE SERVICE.
 PROVIDE FACTORY MOUNTED VFD.


	ROOFTOP UNIT SCHEDULE																						
		SUPPLY FAN DATA			EXHAUST FAN DATA ELECTRICAL					HTG COIL DATA DX					X CLG. COIL DATA			ENERGY WHEEL					
																				SUMMER	WINTER	WINTER	
UNIT NUMBER	LOCATION	CFM (TOTAL)	CFM (OA)	TOT. SP(")	EXT.SP(")	CFM (TOTAL)	EXT.SP(")	VOLTS	MCA	PHASE	MOP	EAT	EWT	GPM	CAP MBH	EAT	SENS	CAP MBH	SUMMER EAT	LAT	EAT	LAT	REMARKS & NOTES
RTU-1-BC	BC-H1.3	4000	1000	3.6	2.5	4000	.5	208	68	3	80	-	-	-	-	75.9/62.7	89	112	90/71	75.9/62.7	0	63	AAON RN-011-8-0-HA09-0
																							1,2,3,4


NOTES: 1. PROVIDDE 36" H CURB.
2. PROVIDE POWERED EXHAUST.
3. PROVIDE ENERGY WHEEL BYPASS.
4. IT SHALL BE SINGLE POINT POWER.

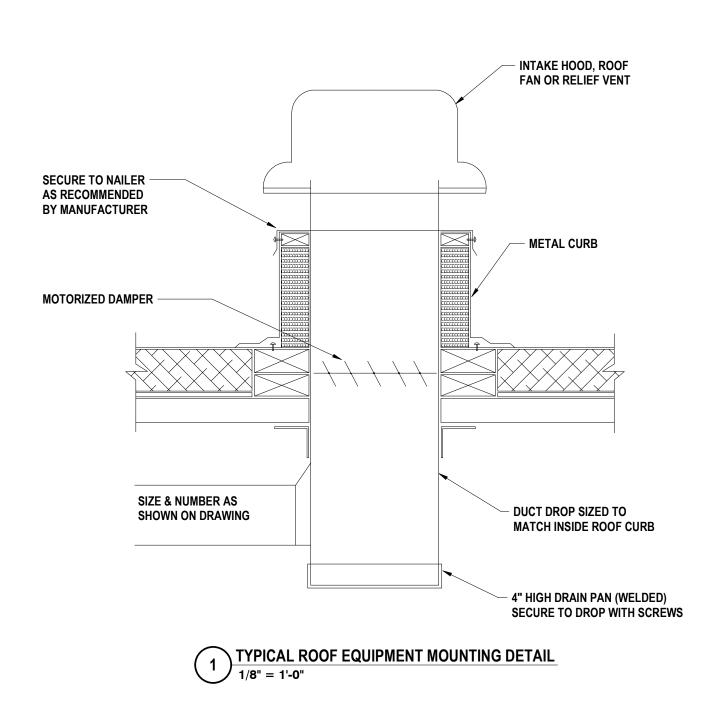

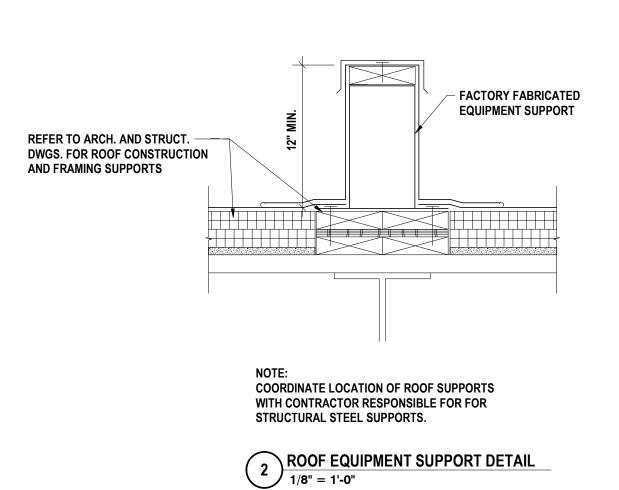

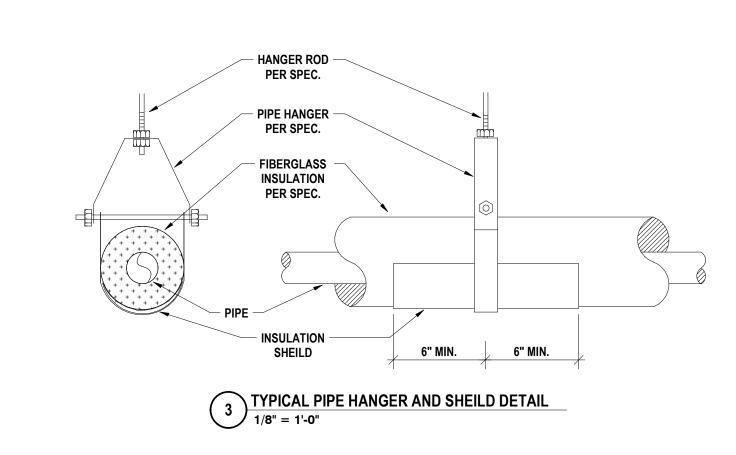

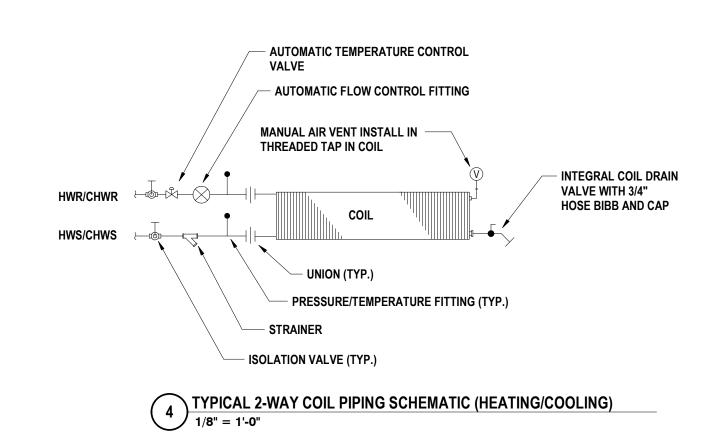

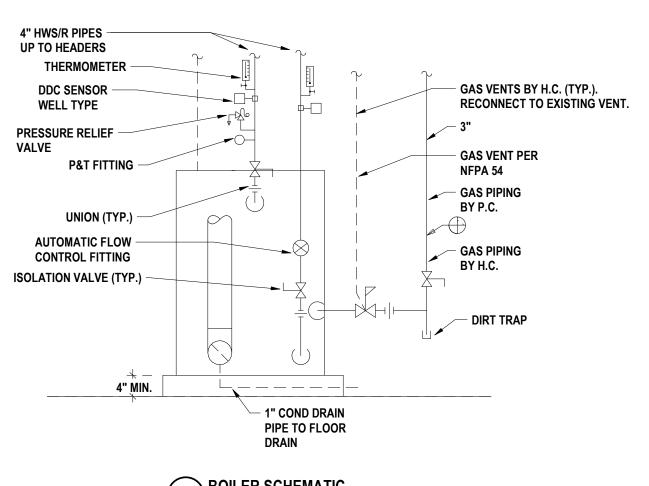

5 BOILER SCHEMATIC
1/8" = 1'-0"

DRAWN BY:

SCALE:

CHECKED BY:

KTK

10/21/2022

1/8" = 1'-0"

HORSEHEADS, NY 607 - 358 - 1000 ROCHESTER, NY 585 - 327 - 7949 TOWANDA, PA

SCHEDULES

ELEMENTARY SCHOOLS 2023 RENOVATIONS (PHAS ELMIRA CITY SCHOOL DISTRICT

ELMIRA, CHEMUNG COUNTY, NEW YORK

BC-H2.1



DRAWN BY: CJH

CHECKED BY: JDG

DATE: 10/21/2022

SCALE: 1/4" = 1'-0"

Cobyright: 202

DATE: DESCRIPTION OF REVISION:

| PATE: | DESCRIPTION OF REVISION: | BY: | SO | BY: | BEARING A LICENSED ENGINEER'S, ARCHITECT'S OR SURVEYOR'S SEAL." | Copyright: 20


ENGINEERS | ARCHITECTS | SURVEYORS | DS, NY 607 - 358 - 1000 ROCHESTER, NY 585 - 327 - 7949 TOWANDA, PA 570 - 265 - 4868

ROOM AND KITCHEN PLANS

NTARY SCHOOLS 2023 RENOVATIONS (PHASE II)

CITY SCHOOL DISTRICT

BC-P1.1

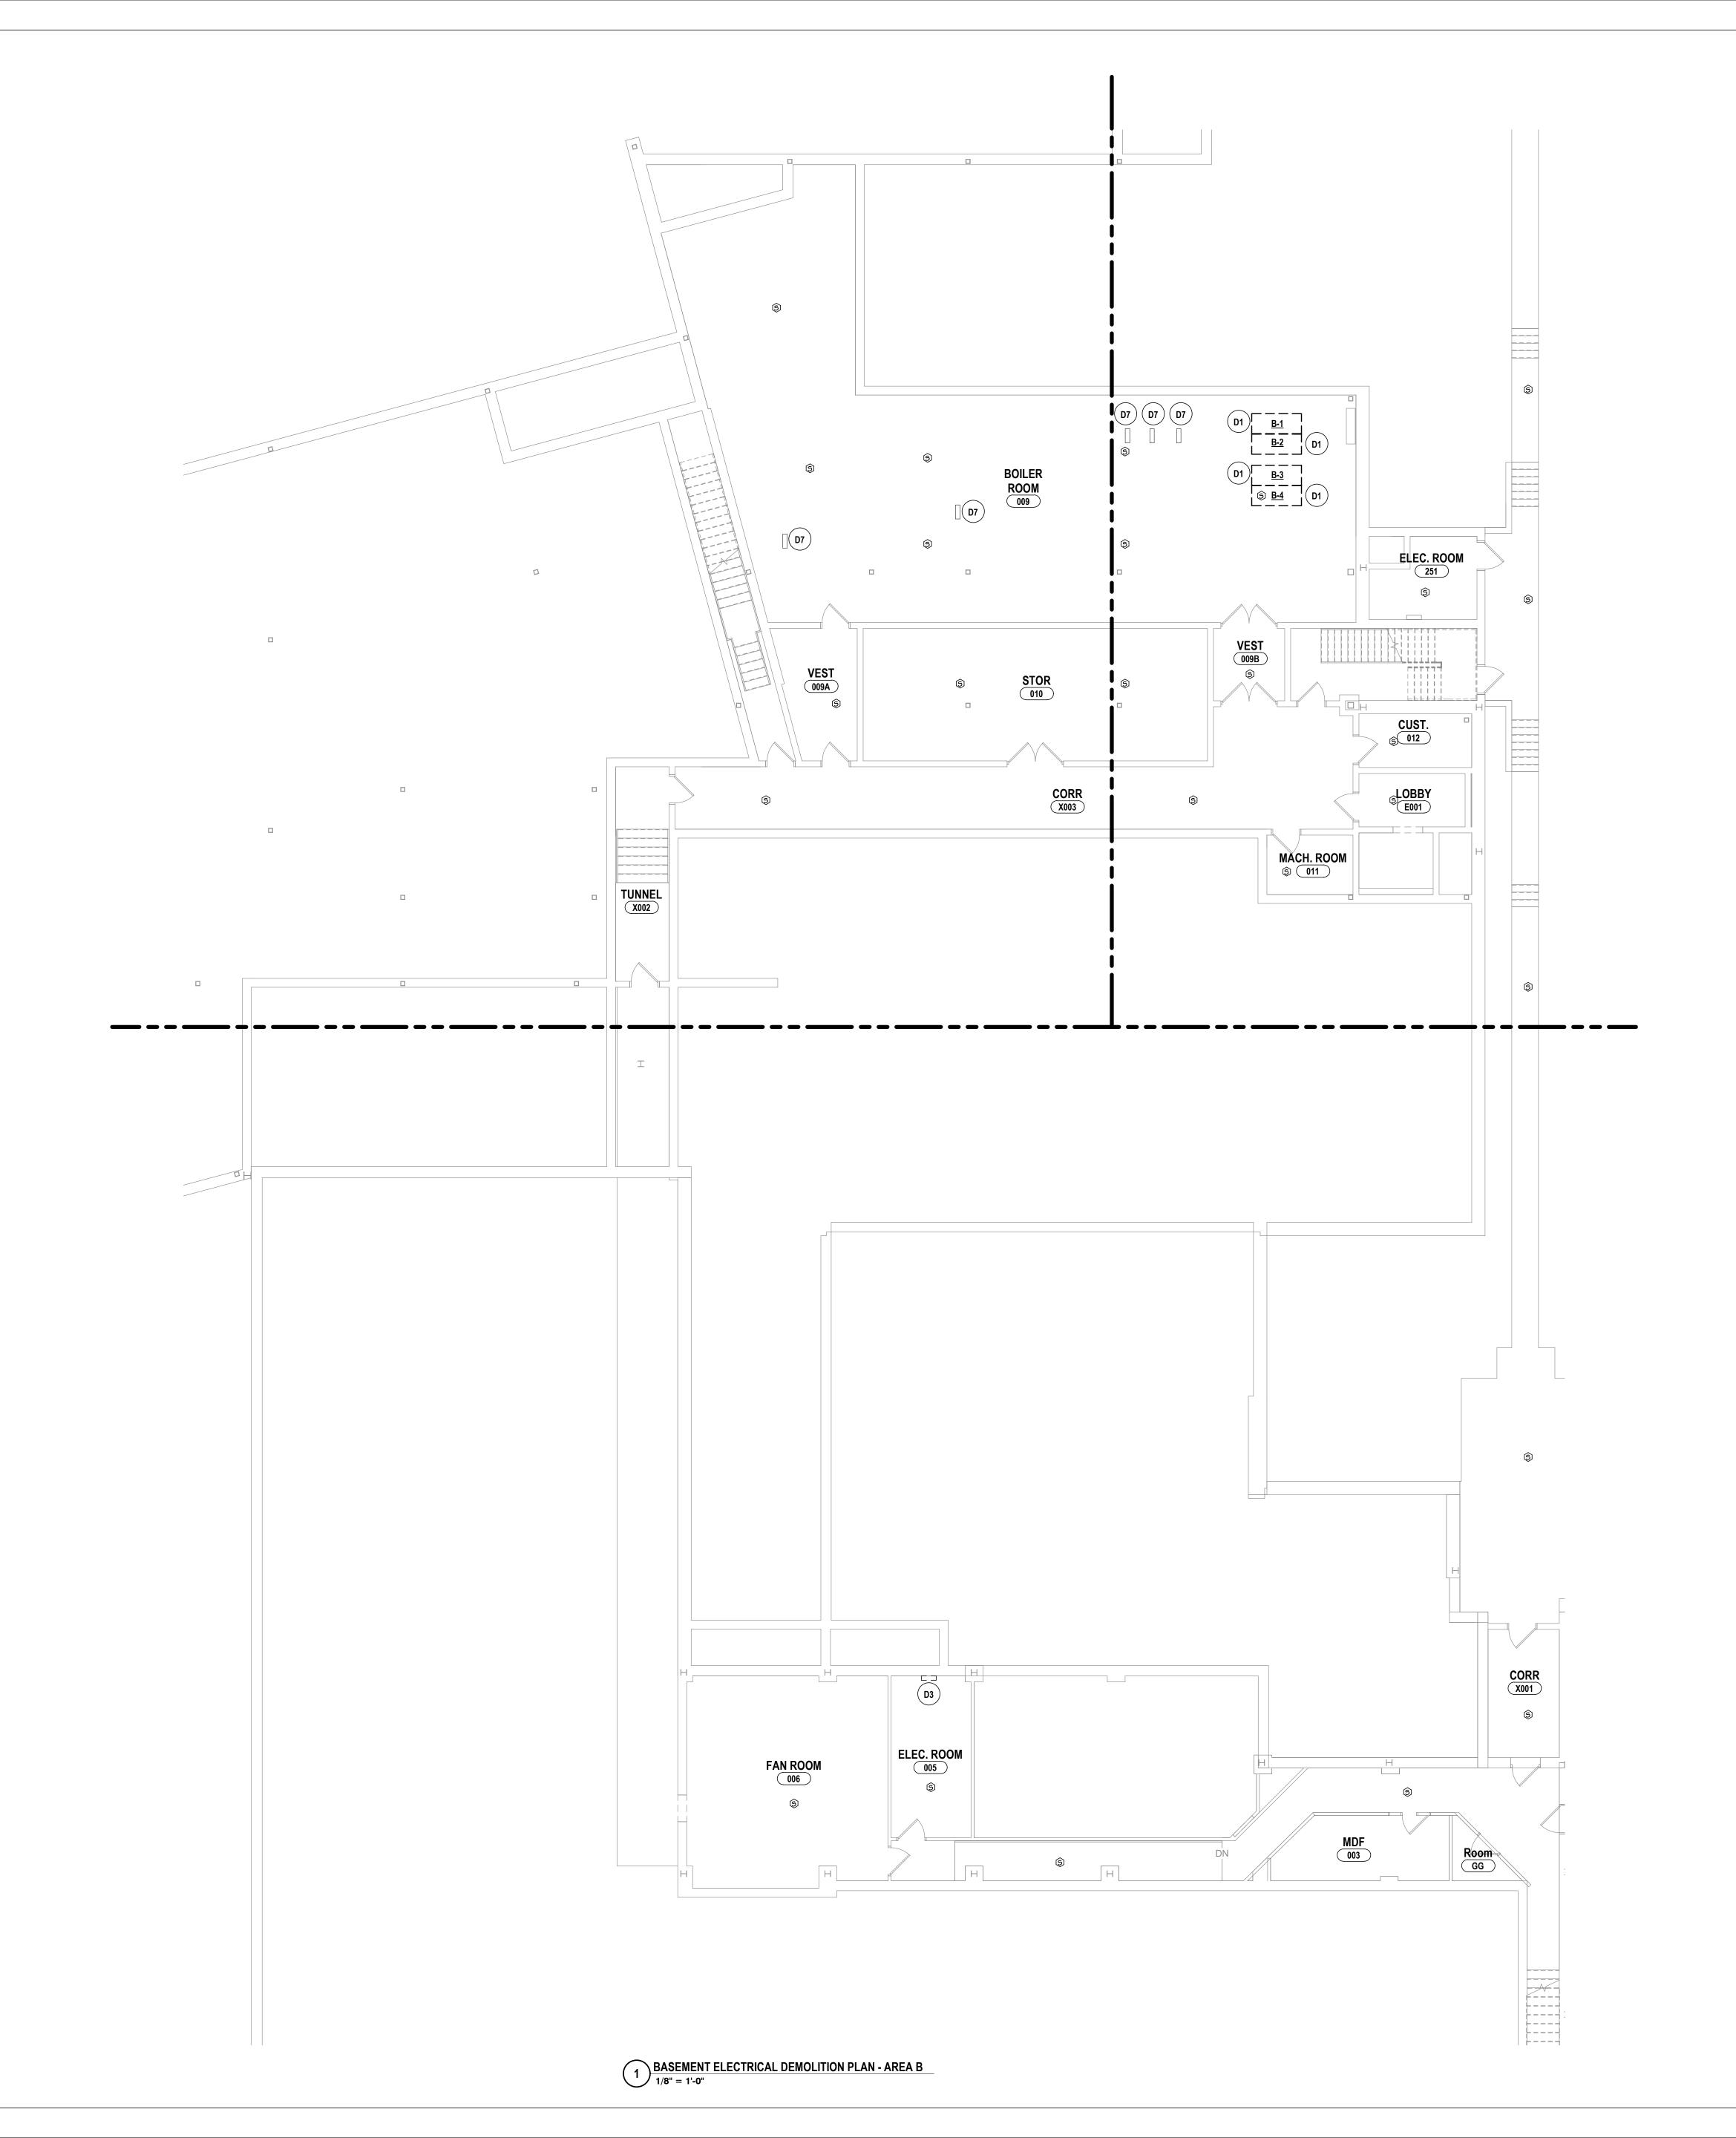

GENERAL NOTES - ELECTRICAL


- ALL WORK ON THIS DRAWING IS THE RESPONSIBILITY OF THE ELECTRICAL CONTRACTOR UNLESS CLEARLY INDICATED TO BE PART OF ANOTHER PRIME CONTRACTOR. PRIOR TO CONSTRUCTION AND INSTALLATION, E.C. SHALL VERIFY EXISTING CONDITIONS AND NOTIFY ENGINEER/ARCHITECT OF CONFLICTS OR CONDITIONS WHICH INTERFERE
- WITH INSTALLATION AS SET FORTH IN CONTRACT DOCUMENTS. E.C. IS RESPONSIBLE FOR ALL NEW FLOOR OPENINGS, EXCAVATIONS AND PENETRATIONS, UNLESS SPECIFICALLY NOTED. UPON COMPLETION, ALL PENETRATIONS TO BE
- SEALED TO MAINTAIN FIRE RATING AS SPECIFIED ON ARCHITECTURAL DRAWINGS.
- ALL CABLING INSTALLATIONS AND TERMINATIONS TO ADHERE TO CURRENT NEC CODES AND RELATED ANSI/TIA/EIA STANDARDS.
- ALL CUTTING AND PATCHING SHALL BE THE RESPONSIBILITY OF THE E.C. UNLESS CLEARLY INDICATED AS PART OF ANOTHER PRIME CONTRACT.
- MINIMUM CONDUIT SIZE USED ON THIS PROJECT SHALL BE 3/4" UNLESS OTHERWISE NOTED.

MINIMUM WIRE SIZE USED ON THIS PROJECT SHALL BE #12 THHN/THWN, UNLESS OTHERWISE NOTED.

- DURING DEMOLITION OF EXISTING CABLING, ANY DAMAGE TO FUNCTIONING CABLING SYSTEM IS THE RESPONSIBILITY OF AND WILL BE REPAIRED BY THE CONTRACTOR. THE CONTRACTOR SHALL BE AWARE OF THE PRESENCE OF EXISTING ASBESTOS CONTAINING MATERIAL SCHEDULED TO REMAIN IN PLACE WITHIN THE PROJECT SCOPE. ANY
- WORK REQUIRED THAT HAS THE POTENTIAL TO DISTURB HAZARDOUS MATERIALS SHALL BE COORDINATED DIRECTLY WITH THE OWNER ELECTRICAL DEVICES, MATERIALS AND PACKAGED EQUIPMENT SHALL BE LISTED AND LABELED BY UNDERWRITERS LABORATORIES INC. (UL).
- NEW CIRCUIT BREAKER(S) TO BE ADDED TO EXISTING PANELBOARD(S) SHALL BE LISTED/LABELED FOR USE WITH THE EXISTING PANELBOARD(S). THE SHORT-CIRCUIT RATINGS OF ALL PROTECTIVE DEVICES SHALL BE EQUAL TO OR EXCEED THE AVAILABLE SHORT-CIRCUIT CURRENT.
- ALL WORK TO CONFORM TO CURRENT NEC AND ALL APPLICABLE CODES. E.C. TO NOTIFY ELECTRICAL ENGINEER FOR INSPECTION OF ALL INSTALLATIONS BEFORE BEING BURIED OR COVERED.
- ALL ELECTRICAL DEVICES SCHEDULED FOR REMOVAL ARE CONSIDERED PROPERTY OF THE OWNER. DEVICES SHALL BE PLACED IN AN AREA DESIGNATED BY THE OWNER.
- ANY DEVICE THE OWNER WISHES NOT TO KEEP SHALL BE LEGALLY DISPOSED OF BY THE CONTRACTOR. CONTRACTOR SHALL BE RESPONSIBLE FOR DISCONNECTING POWER TO ANY MECHANICAL EQUIPMENT TO BE REMOVED, RELOCATED OR REINSTALLED. COORDINATE THIS
- EFFORT WITH THE MECHANICAL WORK CONTRACTOR. ALL FIRE ALARM WORK ON THESE DRAWINGS TO BE PART OF A SEPERATE CONTRACT (INCLUDING DEMOLITION AND NEW WORK). DEVICES ARE SHOWN FOR REFERENCE

DEMOLITION NOTES - ELECTRICAL

- PART OF ALTERNATE #BC-3 DISCONNECT POWER SERVING EXISTING BOILERS. SECURE CIRCUITRY FOR REUSE.
- REMOVE EXISTING CIRCUITRY SERVING HVAC UNIT. REMOVE ALL WIRING, CONDUIT, AND ASSOCIATED DEVICES BACK TO SOURCE.
- EXISTING FIRE ALARM SYSTEM TO BE REPLACED IN ITS ENTIRITY. EXISTING SYSTEM TO BE MAINTAINED WHILE A NEW ONE IS INSTALLED. REFER TO SPECS. EXISTING CEILING IS BEING REMOVED FOR HVAC WORK. TIE UP EXISTING ELECTRICAL CEILING DEVICES DURING CONSTRUCTION.
- DISCONNECT POWER SERVING EXISTING BOILER. SECURE CIRCUITRY FOR REUSE.
- DISCONNECT POWER SERVING EXISTING VAV BOX. SECURE CIRCUITRY FOR REUSE. PART OF ALTERNATE #BC-4 EXISTING (2) STARTER/VFD IS BEING REPLACED BY OTHERS. DISCONNECT POWER SERVING EXISTING PUMP AND SECURE CIRCUITRY FOR REUSE.

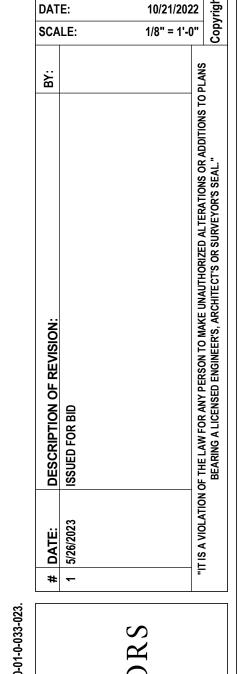

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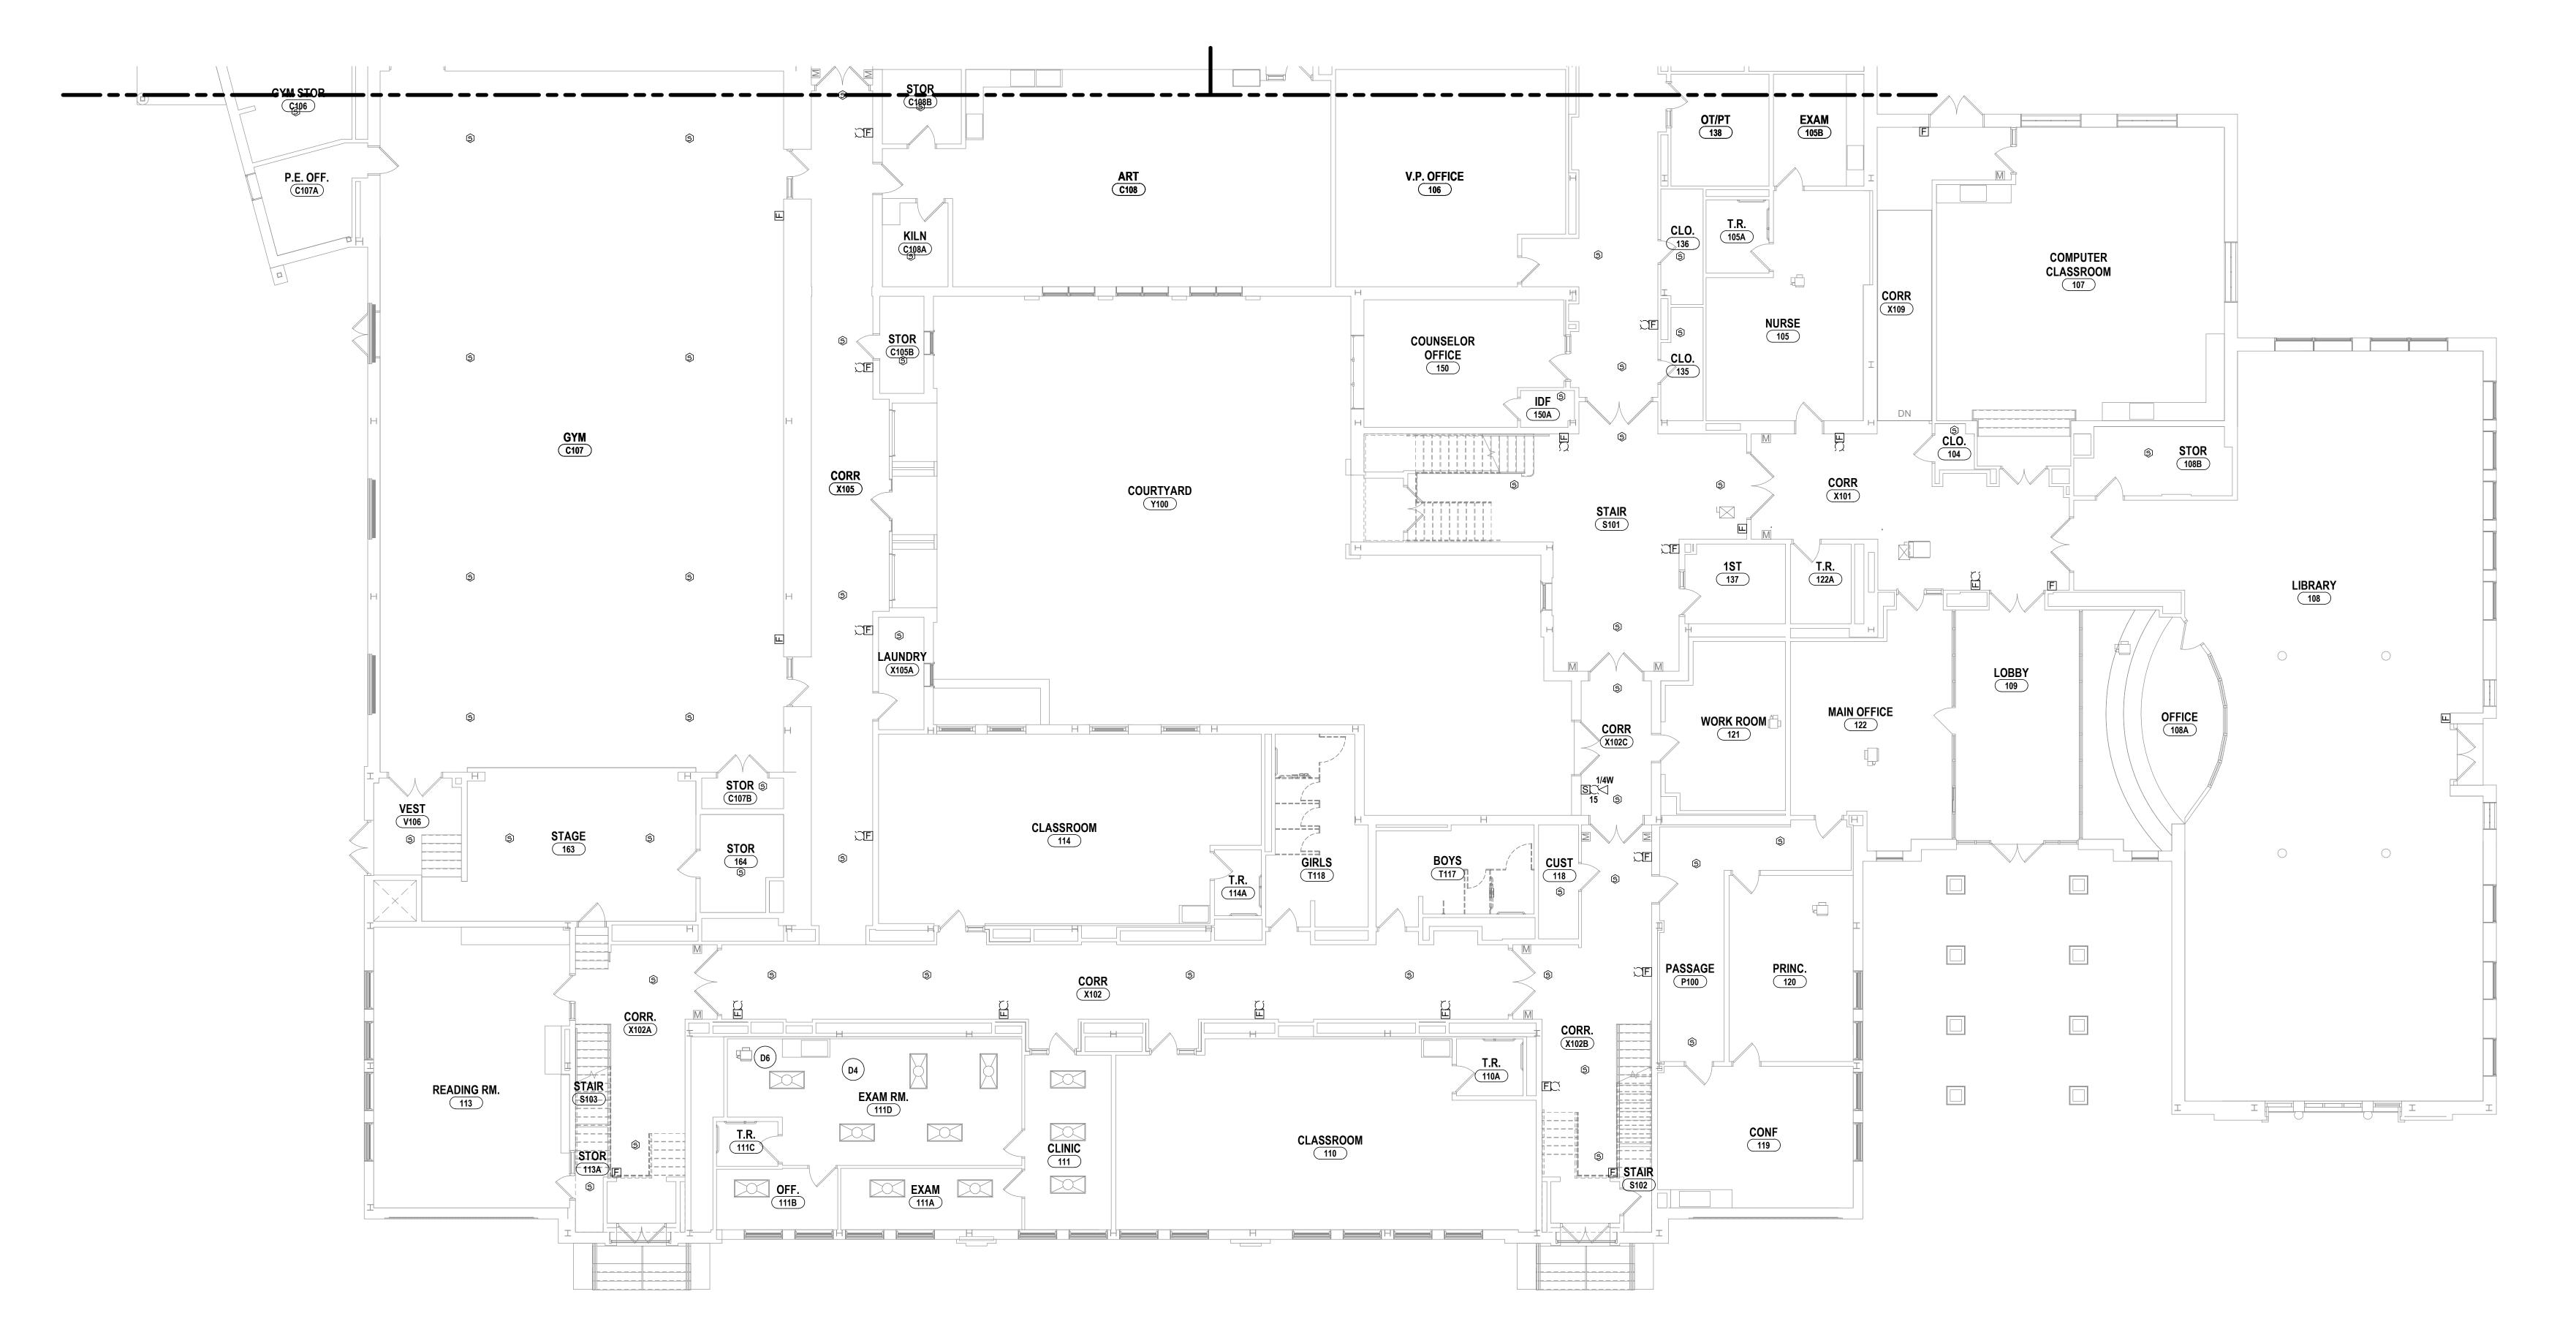
BC-E0.1

PROJECT NO: 2012-233


GENERAL NOTES - ELECTRICAL REFER TO BC-E0.1.

DEMOLITION NOTES - ELECTRICAL

- PART OF ALTERNATE #BC-3 DISCONNECT POWER SERVING EXISTING BOILERS. SECURE CIRCUITRY FOR REUSE.
- REMOVE EXISTING CIRCUITRY SERVING HVAC UNIT. REMOVE ALL WIRING, CONDUIT, AND ASSOCIATED DEVICES BACK TO SOURCE. EXISTING FIRE ALARM SYSTEM TO BE REPLACED IN ITS ENTIRITY. EXISTING SYSTEM TO BE MAINTAINED WHILE A NEW ONE IS INSTALLED. REFER TO SPECS. EXISTING CEILING IS BEING REMOVED FOR HVAC WORK. TIE UP EXISTING ELECTRICAL CEILING DEVICES DURING CONSTRUCTION.
- DISCONNECT POWER SERVING EXISTING BOILER. SECURE CIRCUITRY FOR REUSE.
- DISCONNECT POWER SERVING EXISTING VAV BOX. SECURE CIRCUITRY FOR REUSE. PART OF ALTERNATE #BC-4 EXISTING (2) STARTER/VFD IS BEING REPLACED BY OTHERS. DISCONNECT POWER SERVING EXISTING PUMP AND SECURE




1 FIRST FLOOR ELECTRICAL DEMOLITION PLAN - AREA A 1/8" = 1'-0"

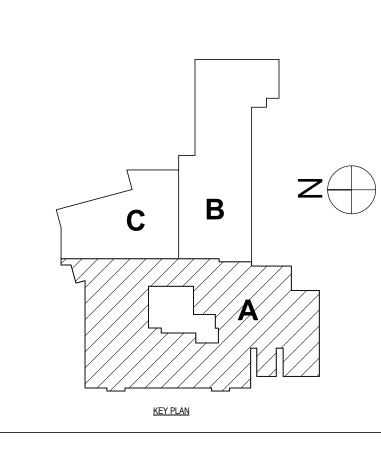

10/21/2022 1/8" = 1'-0"

> \sim 6 ENGINEERS | ARCHITEC

BC-E0.2

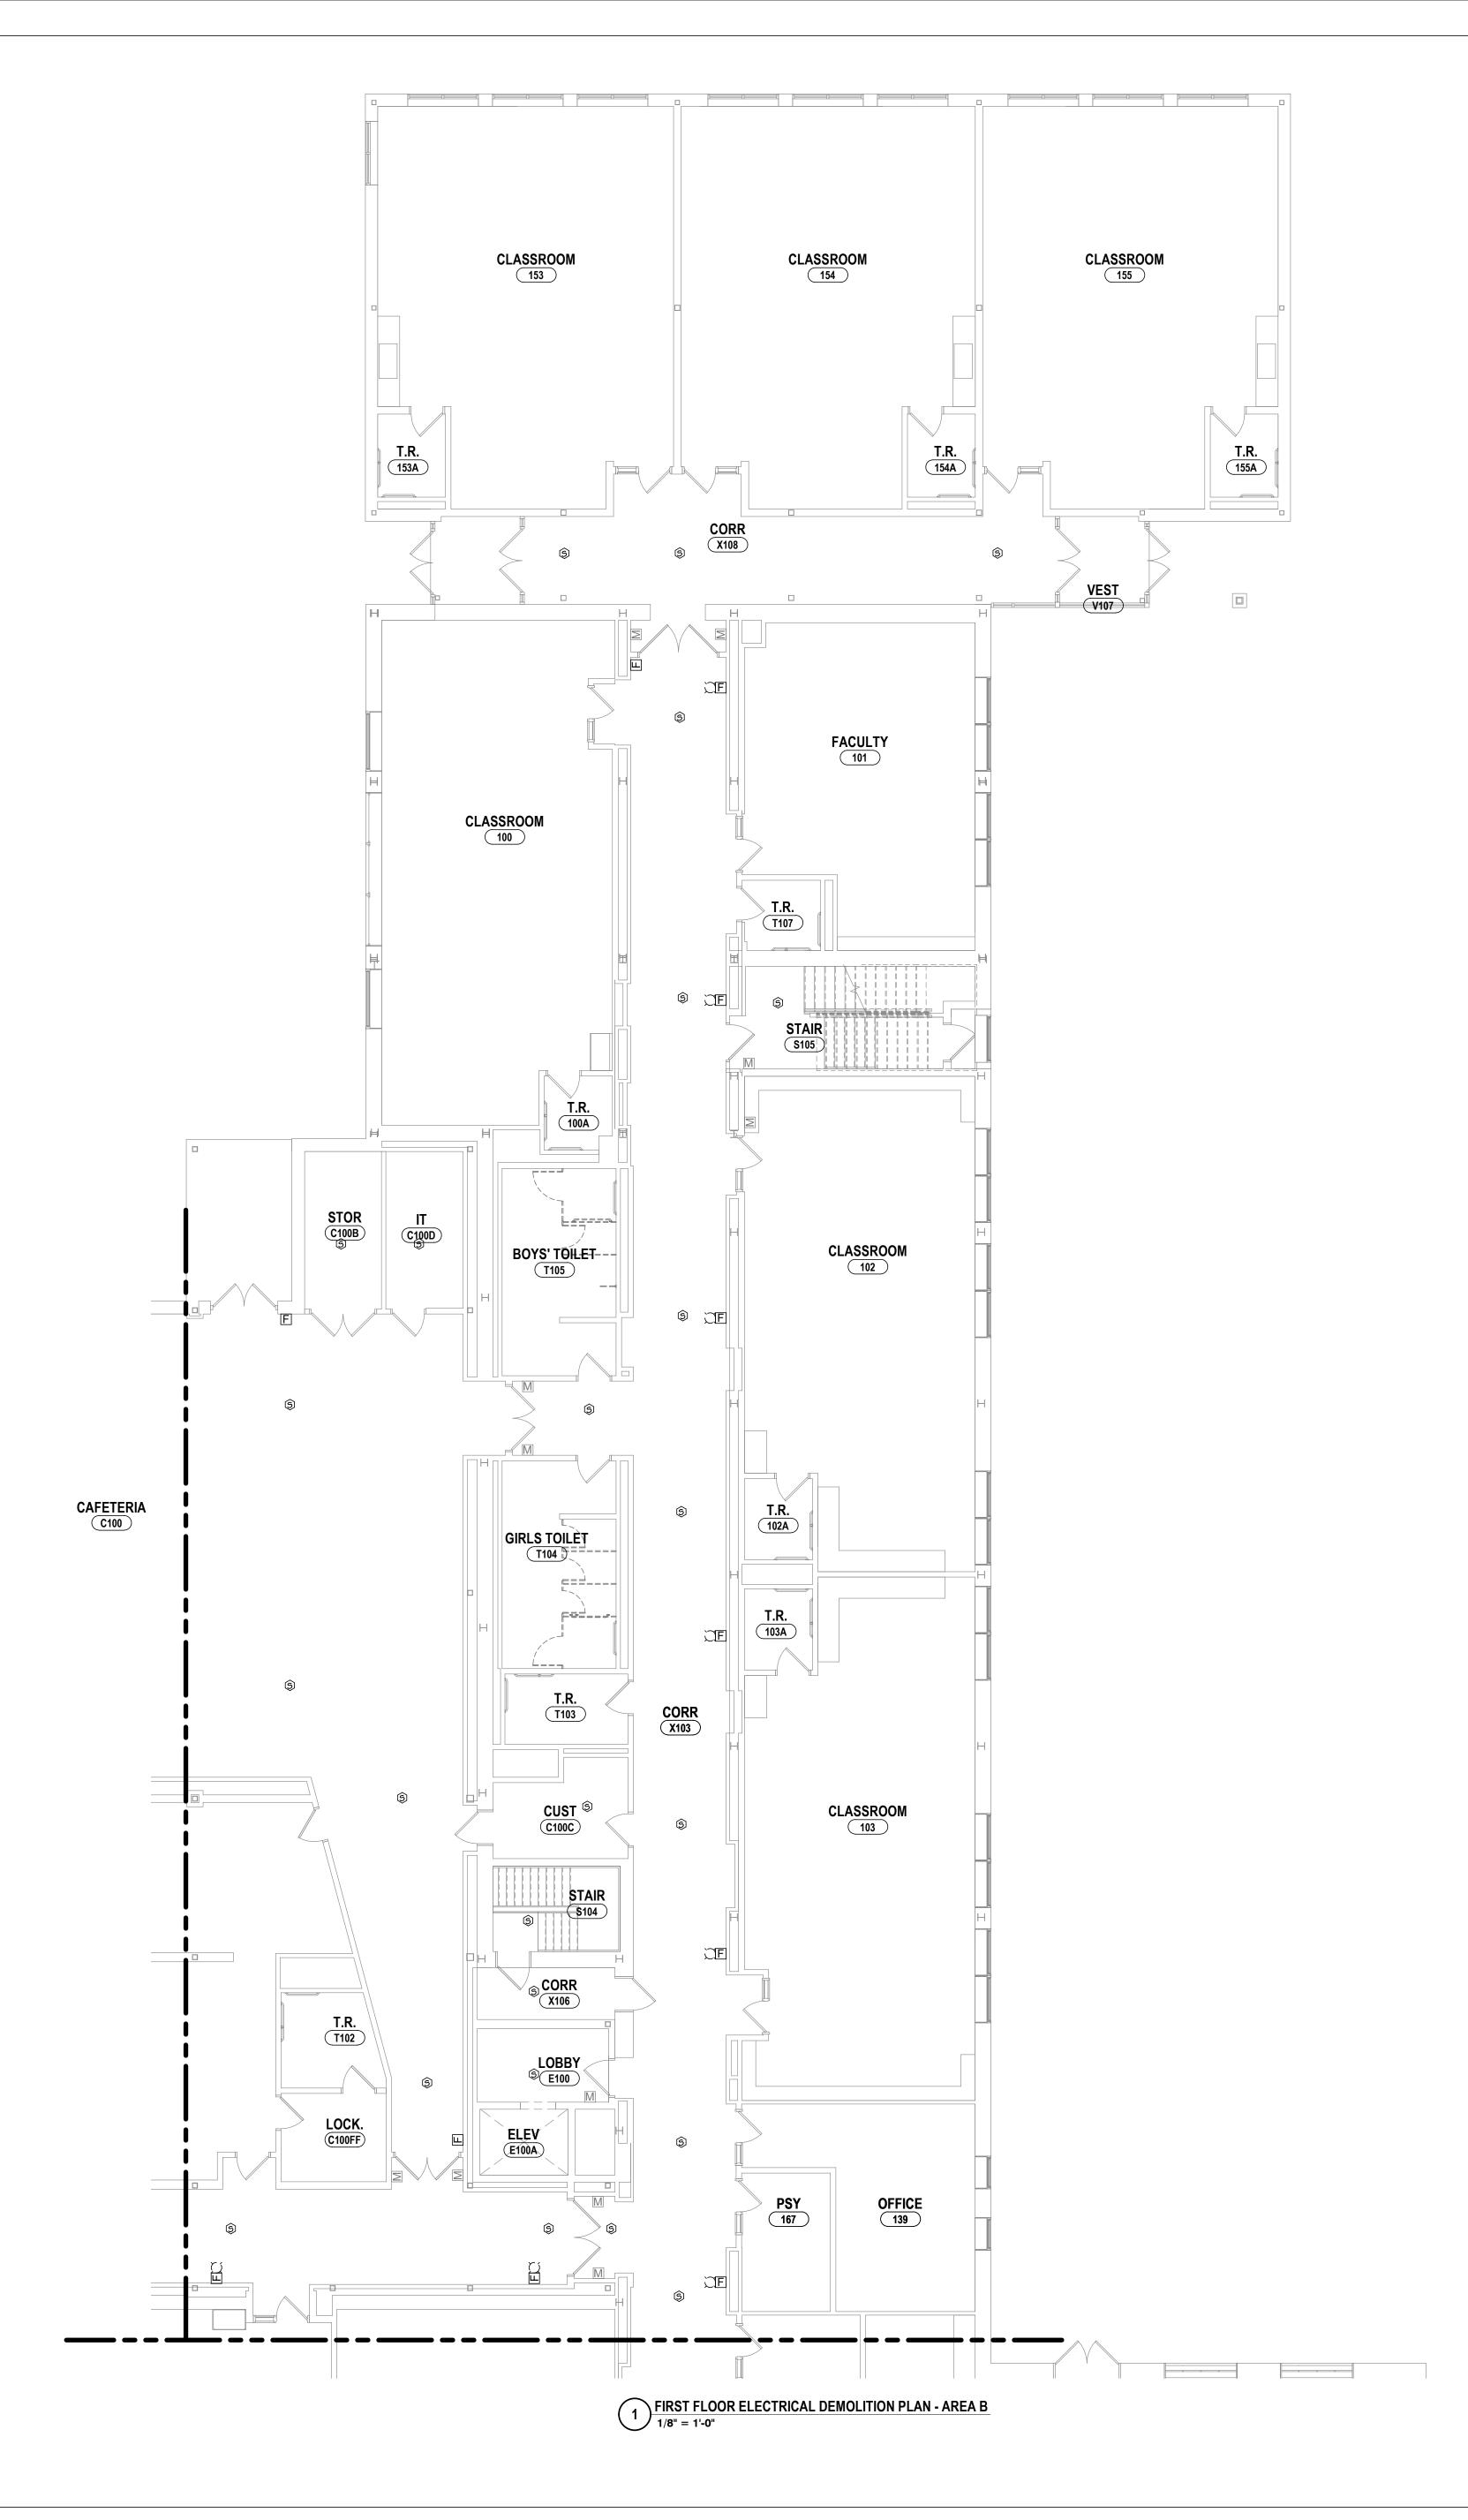

GENERAL NOTES - ELECTRICAL REFER TO BC-E0.1.

CIRCUITRY FOR REUSE.

DEMOLITION NOTES - ELECTRICAL

PART OF ALTERNATE #BC-3 DISCONNECT POWER SERVING EXISTING BOILERS. SECURE CIRCUITRY FOR REUSE. REMOVE EXISTING CIRCUITRY SERVING HVAC UNIT. REMOVE ALL WIRING, CONDUIT, AND ASSOCIATED DEVICES BACK TO SOURCE.

EXISTING FIRE ALARM SYSTEM TO BE REPLACED IN ITS ENTIRITY. EXISTING SYSTEM TO BE MAINTAINED WHILE A NEW ONE IS INSTALLED. REFER TO SPECS.

EXISTING CEILING IS BEING REMOVED FOR HVAC WORK. TIE UP EXISTING ELECTRICAL CEILING DEVICES DURING CONSTRUCTION. DISCONNECT POWER SERVING EXISTING BOILER. SECURE CIRCUITRY FOR REUSE.

DISCONNECT POWER SERVING EXISTING VAV BOX. SECURE CIRCUITRY FOR REUSE. PART OF ALTERNATE #BC-4 EXISTING (2) STARTER/VFD IS BEING REPLACED BY OTHERS. DISCONNECT POWER SERVING EXISTING PUMP AND SECURE

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ENGINEERS | ARCHITEC

S 2023 RENOVATIONS (PHASE DISTRICT TION PLAN - AREA B

BC-E0.3

PROJECT NO: 2012-233



GENERAL NOTES - ELECTRICAL REFER TO BC-E0.1.

CIRCUITRY FOR REUSE.

DEMOLITION NOTES - ELECTRICAL

- PART OF ALTERNATE #BC-3 DISCONNECT POWER SERVING EXISTING BOILERS. SECURE CIRCUITRY FOR REUSE.
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DATE: DESCRIPTION OF REVISION: BY:			"IT IS A VIOLATION OF THE LAW FOR ANY PERSON TO MAKE UNAUTHORIZED ALTERATIONS OR ADDITIONS TO PLANS BEARING A LICENSED ENGINEER'S, ARCHITECT'S OR SURVEYOR'S SEAL."

SU. ENGINEERS | ARCHITEC

S 2023 RENOVATIONS (PHASE DISTRICT TION PLAN - AREA C

BC-E0.4

PROJECT NO: 2012-233

DEMOLITION NOTES - ELECTRICAL

- PART OF ALTERNATE #BC-3 DISCONNECT POWER SERVING EXISTING BOILERS. SECURE CIRCUITRY FOR REUSE.
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- CIRCUITRY FOR REUSE.

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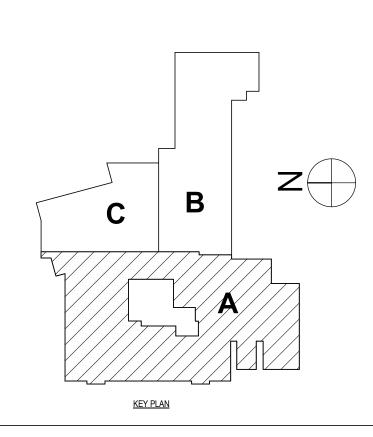
CLASSROOM

1 SECOND FLOOR ELECTRICAL DEMOLITION PLAN - AREA A 1/8" = 1'-0"

READING 211

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8:1:1 213



10/21/2022 1/8" = 1'-0"

ENGINEERS | ARCHITEC

SECOND FLOOR DEMOLITION PLAN - AREA A
ELEMENTARY SCHOOLS 2023 RENOVATIONS (
ELMIRA CITY SCHOOL DISTRICT
ELMIRA, CHEMUNG COUNTY, NEW YORK

BC-E0.5



GENERAL NOTES - ELECTRICAL

REFER TO BC-E0.1.

DEMOLITION NOTES - ELECTRICAL

- PART OF ALTERNATE #BC-3 DISCONNECT POWER SERVING EXISTING BOILERS. SECURE CIRCUITRY FOR REUSE.
- REMOVE EXISTING CIRCUITRY SERVING HVAC UNIT. REMOVE ALL WIRING, CONDUIT, AND ASSOCIATED DEVICES BACK TO SOURCE.
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- DISCONNECT POWER SERVING EXISTING VAV BOX. SECURE CIRCUITRY FOR REUSE.


 D7 PART OF ALTERNATE #BC-4 EXISTING (2) STARTER/VFD IS BEING REPLACED BY OTHERS. DISCONNECT POWER SERVING EXISTING PUMP AND SECURE CIRCUITRY FOR REUSE.


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DATE: DESCRIPTION OF REVISION: 5/26/2023 ISSUED FOR BID	"IT IS A VIOLATION OF THE LAW FOR ANY PERSON TO MAKE LINALITHORIZED ALTERATIONS OR ADDITIONS TO PLANS	BEARING A LICENSED ENGINEER'S, ARCHITECT'S OR SURVEYOR'S SEAL."

HORSEHEADS, NY 607 - 358 - 1000 ROCHESTER, NY 585 - 327 - 7949 TOWANDA, PA 570 - 265 - 4868

SECOND FLOOR DEMOLITION PLAN - AREA B LEMENTARY SCHOOLS 2023 RENOVATIONS (ELMIRA CITY SCHOOL DISTRICT

BC-E0.6

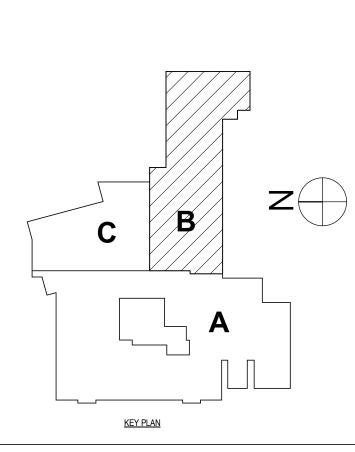

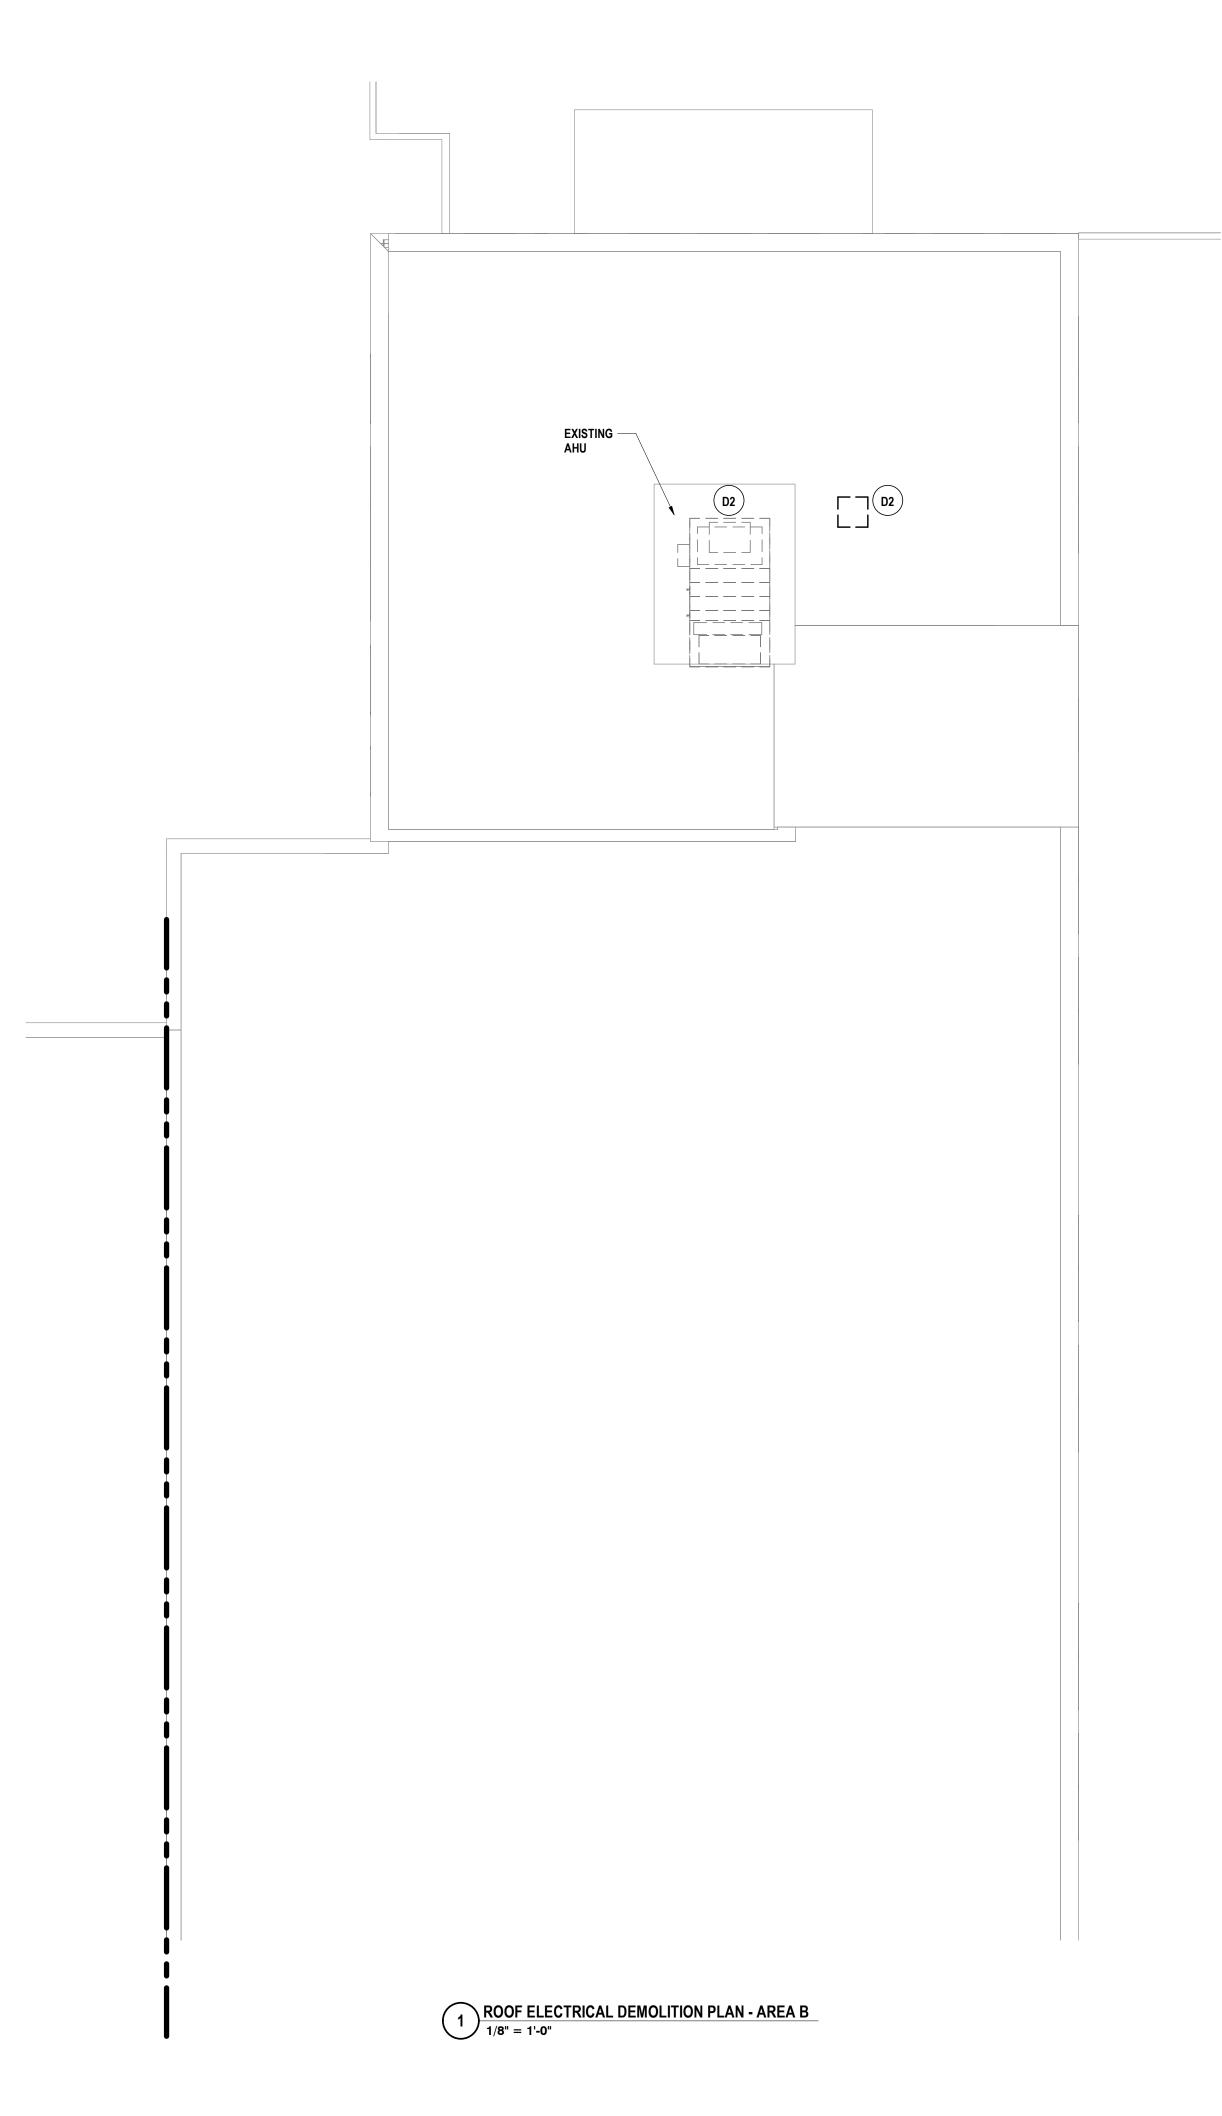

GENERAL NOTES - ELECTRICAL REFER TO BC-E0.1.

DEMOLITION NOTES - ELECTRICAL

- PART OF ALTERNATE #BC-3 DISCONNECT POWER SERVING EXISTING BOILERS. SECURE CIRCUITRY FOR REUSE. REMOVE EXISTING CIRCUITRY SERVING HVAC UNIT. REMOVE ALL WIRING, CONDUIT, AND ASSOCIATED DEVICES BACK TO SOURCE.
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- DISCONNECT POWER SERVING EXISTING BOILER. SECURE CIRCUITRY FOR REUSE.


D6	DISCONNECT POWER SERVING EXISTING VAV BOX. SECURE CIRCUITRY FOR REUSE.
D7	PART OF ALTERNATE #BC-4 EXISTING (2) STARTER/VFD IS BEING REPLACED BY OTHERS. DISCONNECT POWER SERVING EXISTING PUMP AND SECURE CIRCUITRY FOR REUSE.

DRAWN BY: 10/21/2022 ្តិ 1/8" = 1'-0"

> SU. ENGINEERS |

BC-E0.7

PROJECT NO: 2012-233

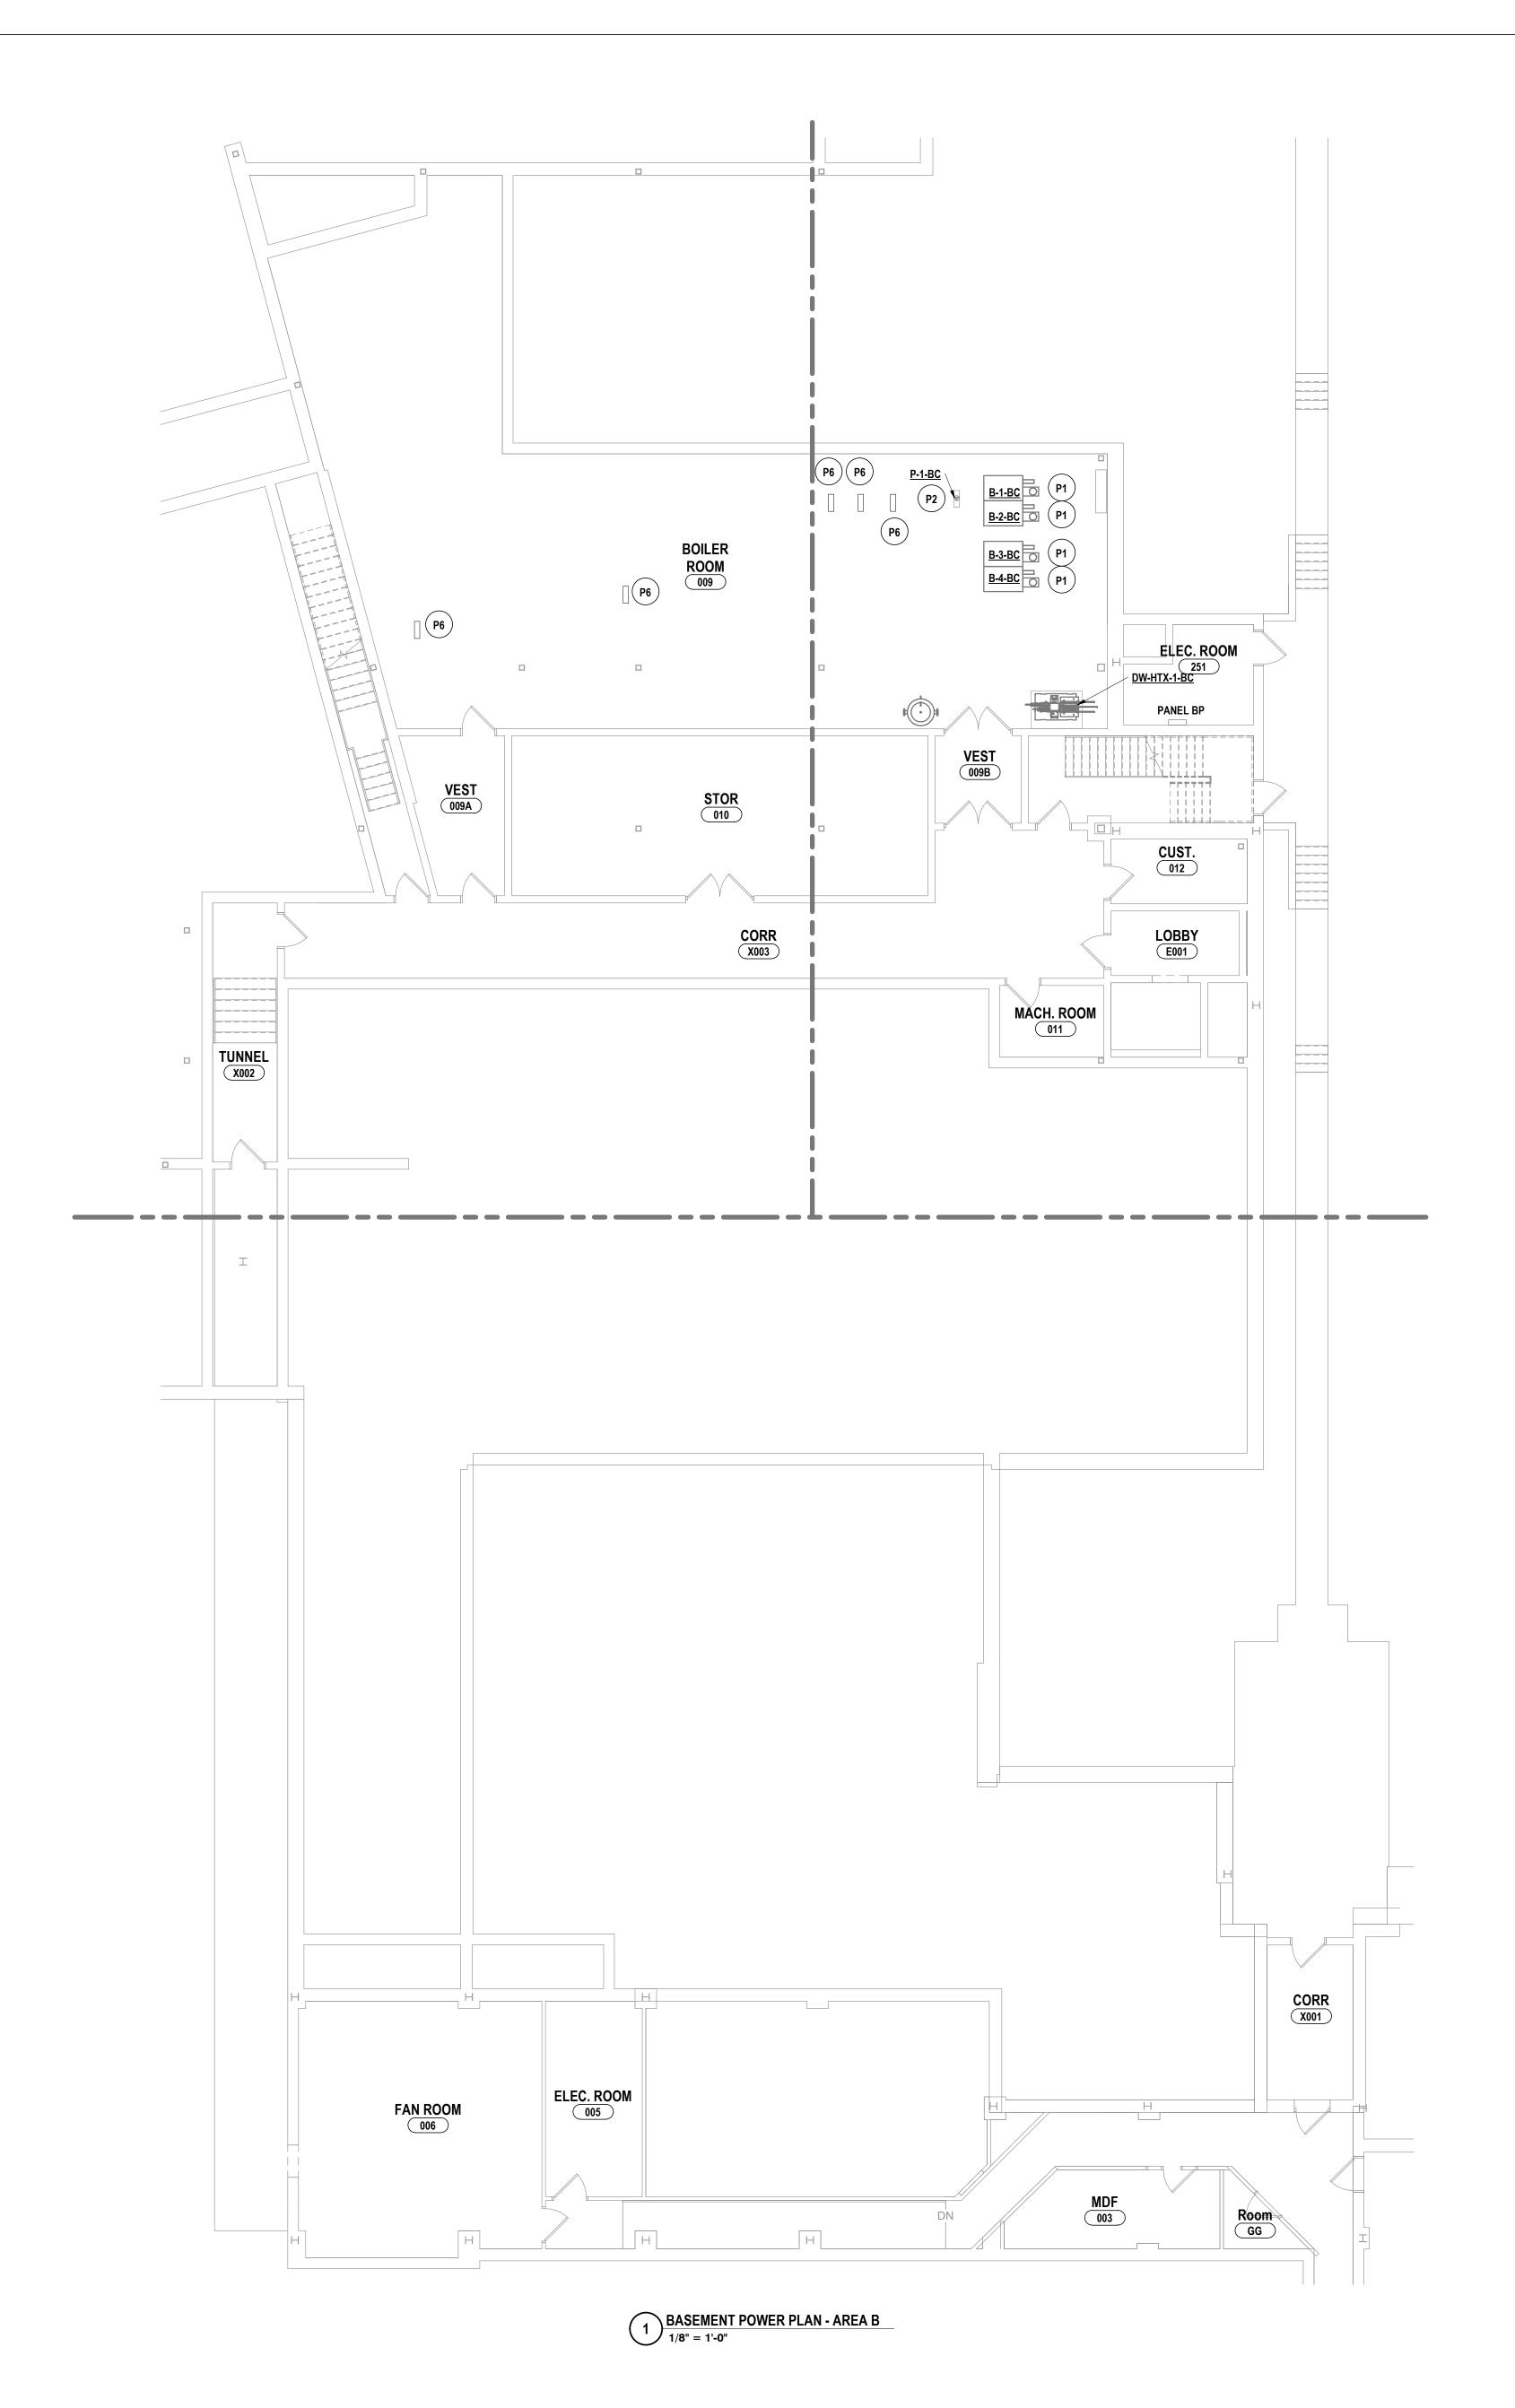

GENERAL NOTES - ELECTRICAL REFER TO BC-E0.1.

CONSTRUCTION NOTES - POWER

P1 RECONNECT EXISTING CIRCUITRY TO NEW BOILERS. EXTEND AS NEEDED.
P2 PROVIDE NEW POWER FEED TO NEW PUMP.

P3 PROVIDE NEW POWER FEED TO NEW MECHANICAL UNIT.


P4 RECONNECT POWER TO NEW VAV BOX. EXTEND CIRCUITRY AS NEEDED WITH WIRE IN SCHEDULE. P5 RECONNECT POWER TO NEW BOILER. EXTENDED CICUITRY AS NEEDED WITH 2 #12, 1 #12G, 3/4"C.

P6 RECONNECT EXISTING POWER TO NEW (2) VFDS. EXTEND CIRCUITRY AS NEEDED. REFER TO H SERIES PLANS FOR MORE DETAILS. EXTEND 1-5HP MOTORS WITH 3#10, 1#10G, 1"C. EXTEND 10HP MOTORS WITH 3#8, 1#10G, 1"C.

10/21/2022 1/8" = 1'-0"


> \sim 6 ENGINEERS |

BC-E1.1

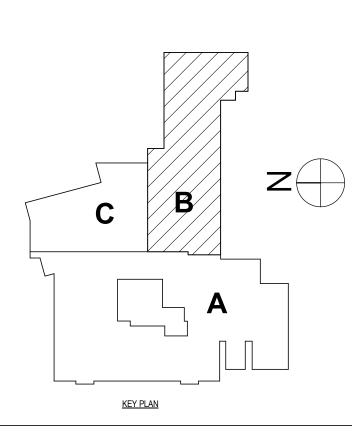


CONSTRUCTION NOTES - POWER

- P1 RECONNECT EXISTING CIRCUITRY TO NEW BOILERS. EXTEND AS NEEDED.
- P2 PROVIDE NEW POWER FEED TO NEW PUMP. P3 PROVIDE NEW POWER FEED TO NEW MECHANICAL UNIT.
- P4 RECONNECT POWER TO NEW VAV BOX. EXTEND CIRCUITRY AS NEEDED WITH WIRE IN SCHEDULE.
- P5 RECONNECT POWER TO NEW BOILER. EXTENDED CICUITRY AS NEEDED WITH 2 #12, 1 #12G, 3/4"C.

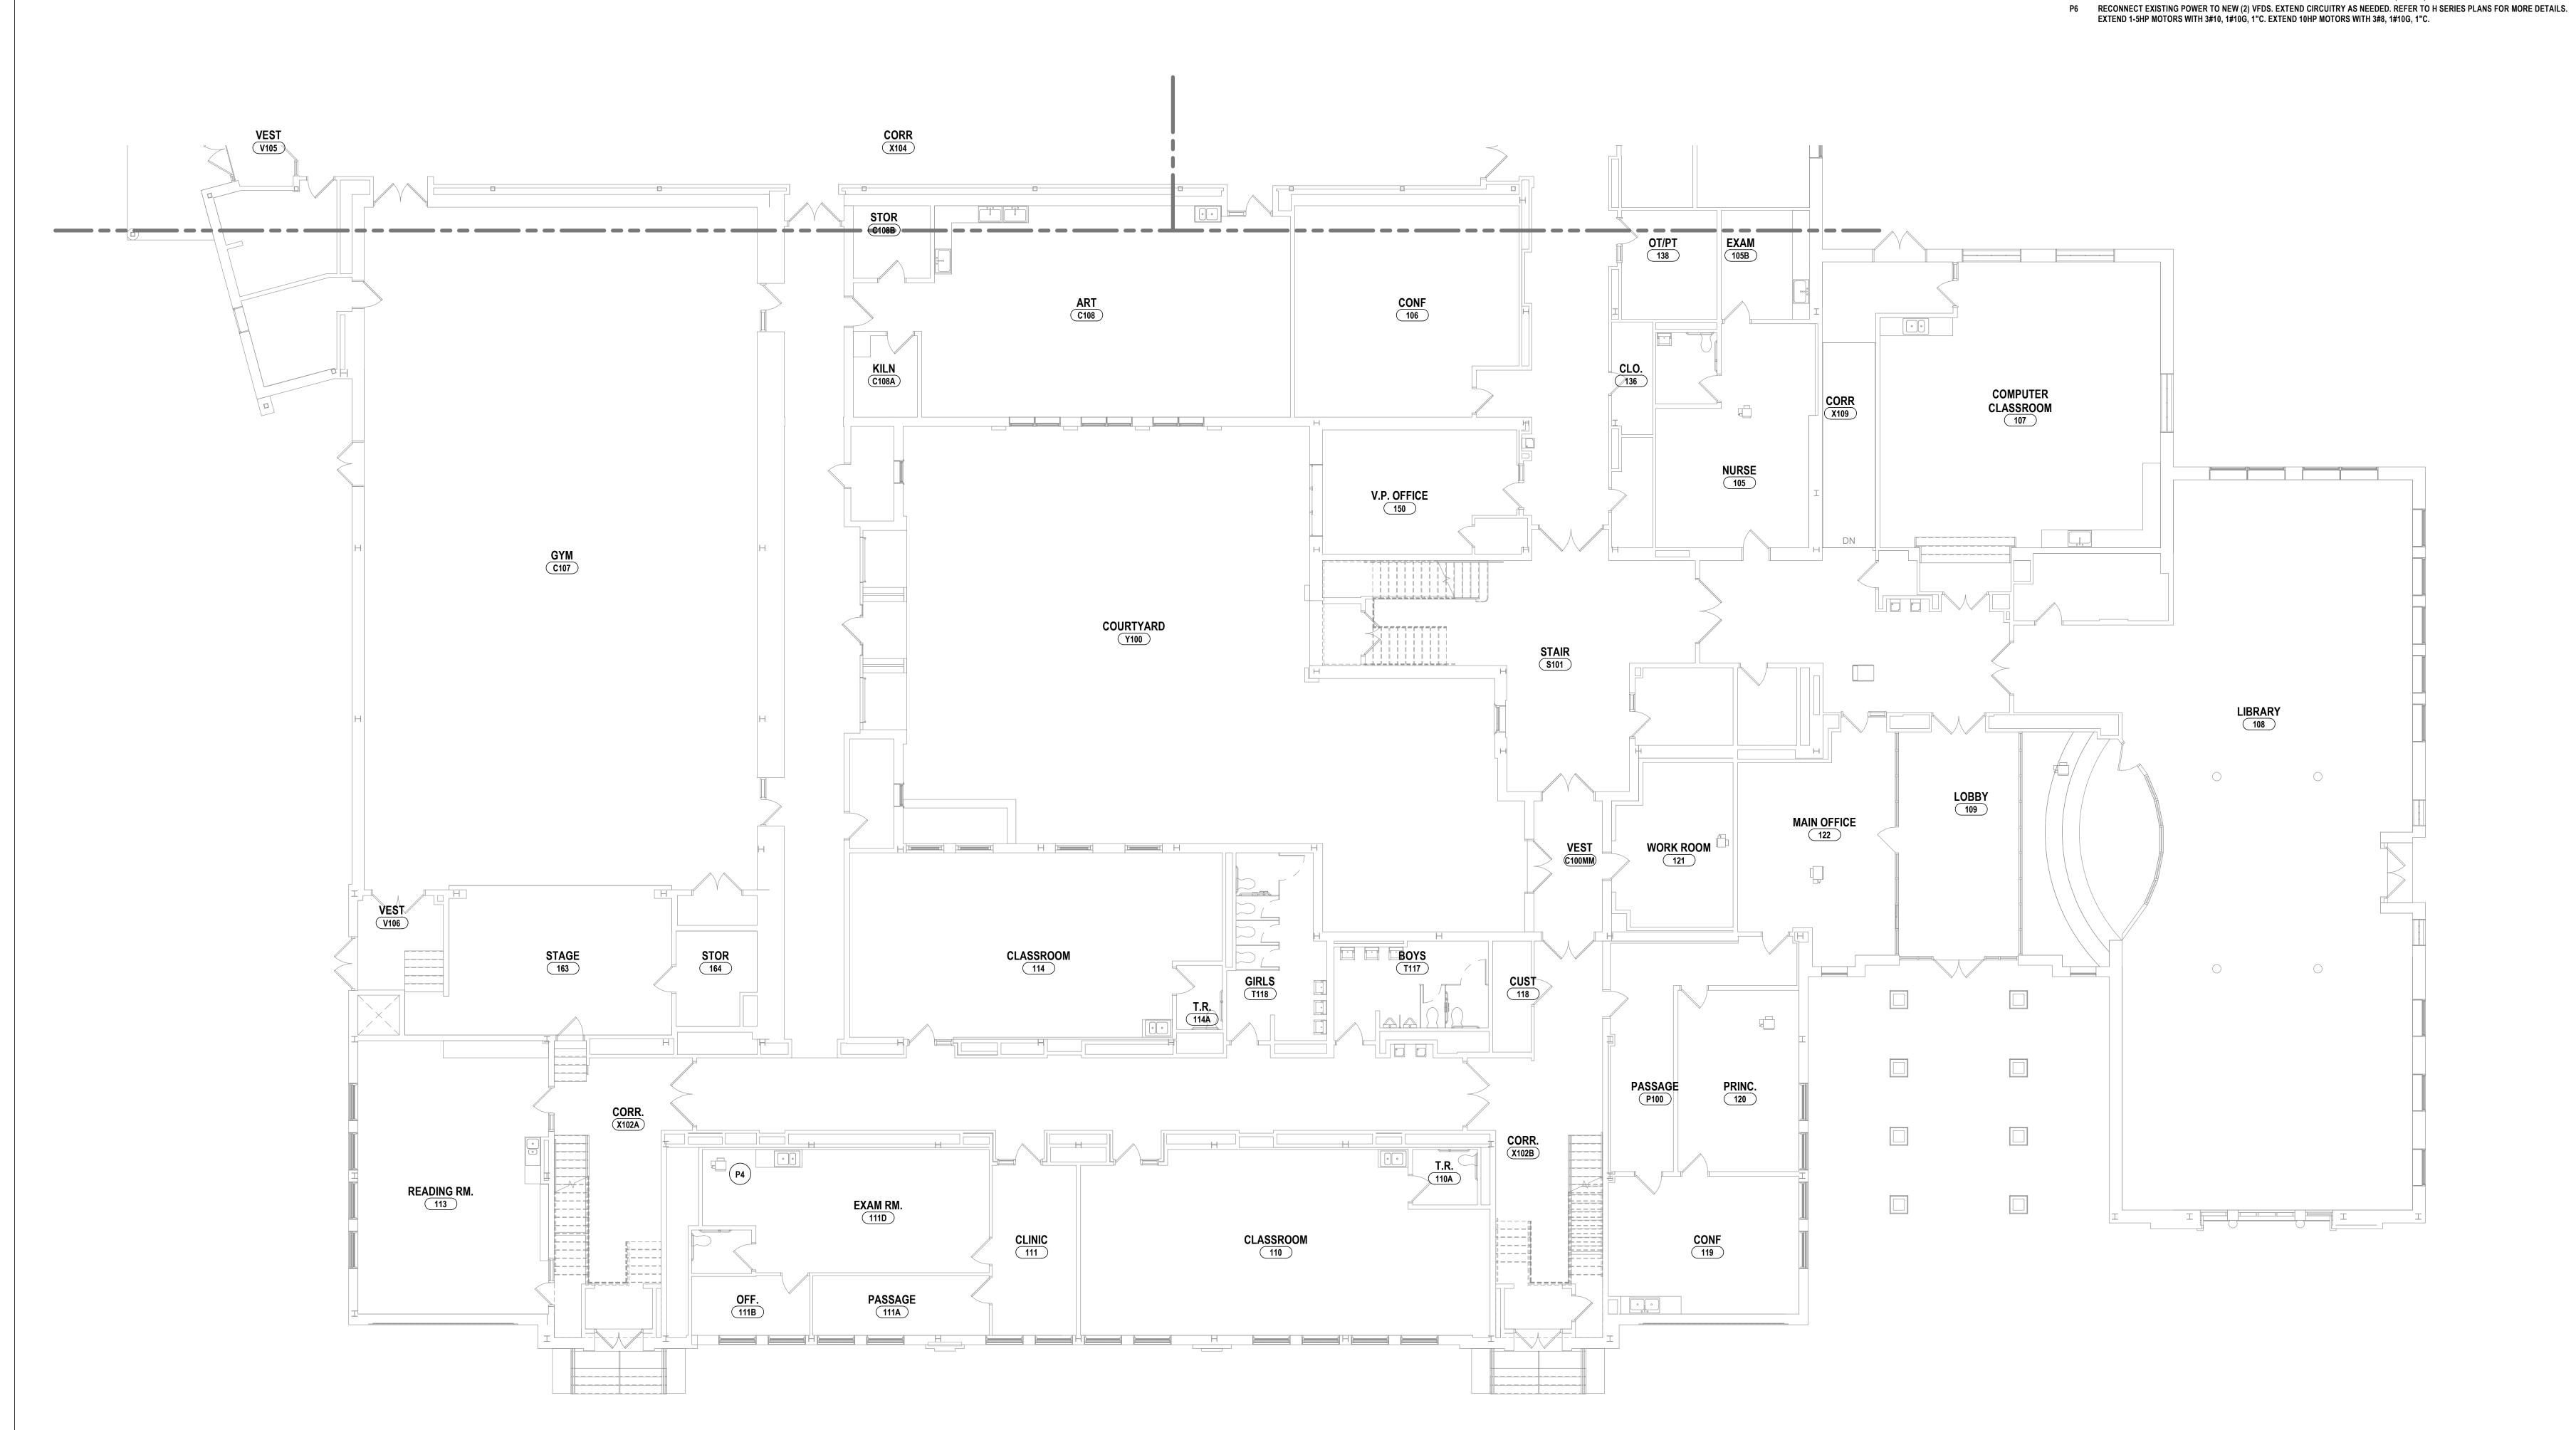

1 FIRST FLOOR POWER PLAN - AREA A

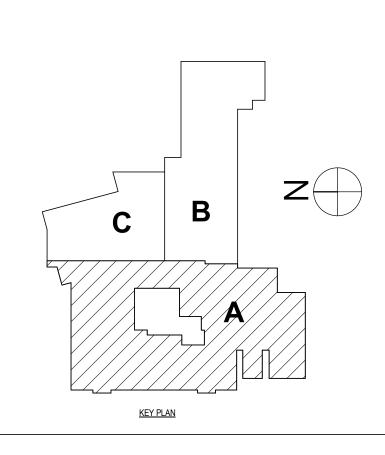

10/21/2022 1/8" = 1'-0"

> \sim 6 ENGINEERS | ARCHITEC

PLAN - AREA A

BC-E1.2 PROJECT NO: 2012-233



GENERAL NOTES - ELECTRICAL

REFER TO BC-E0.1.

CONSTRUCTION NOTES - POWER

P1 RECONNECT EXISTING CIRCUITRY TO NEW BOILERS. EXTEND AS NEEDED.

P2 PROVIDE NEW POWER FEED TO NEW PUMP.

P3 PROVIDE NEW POWER FEED TO NEW MECHANICAL UNIT.
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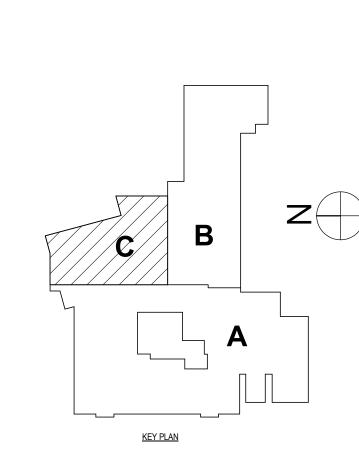
HORSEHEADS, NY 607 - 358 - 1000 ROCHESTER, NY 585 - 327 - 7949 TOWANDA, PA 570 - 265 - 4


IRST FLOOR POWER PLAN - AREA C

LEMENTARY SCHOOL DISTRICT

LMIRA CITY SCHOOL DISTRICT

BC-E1.3



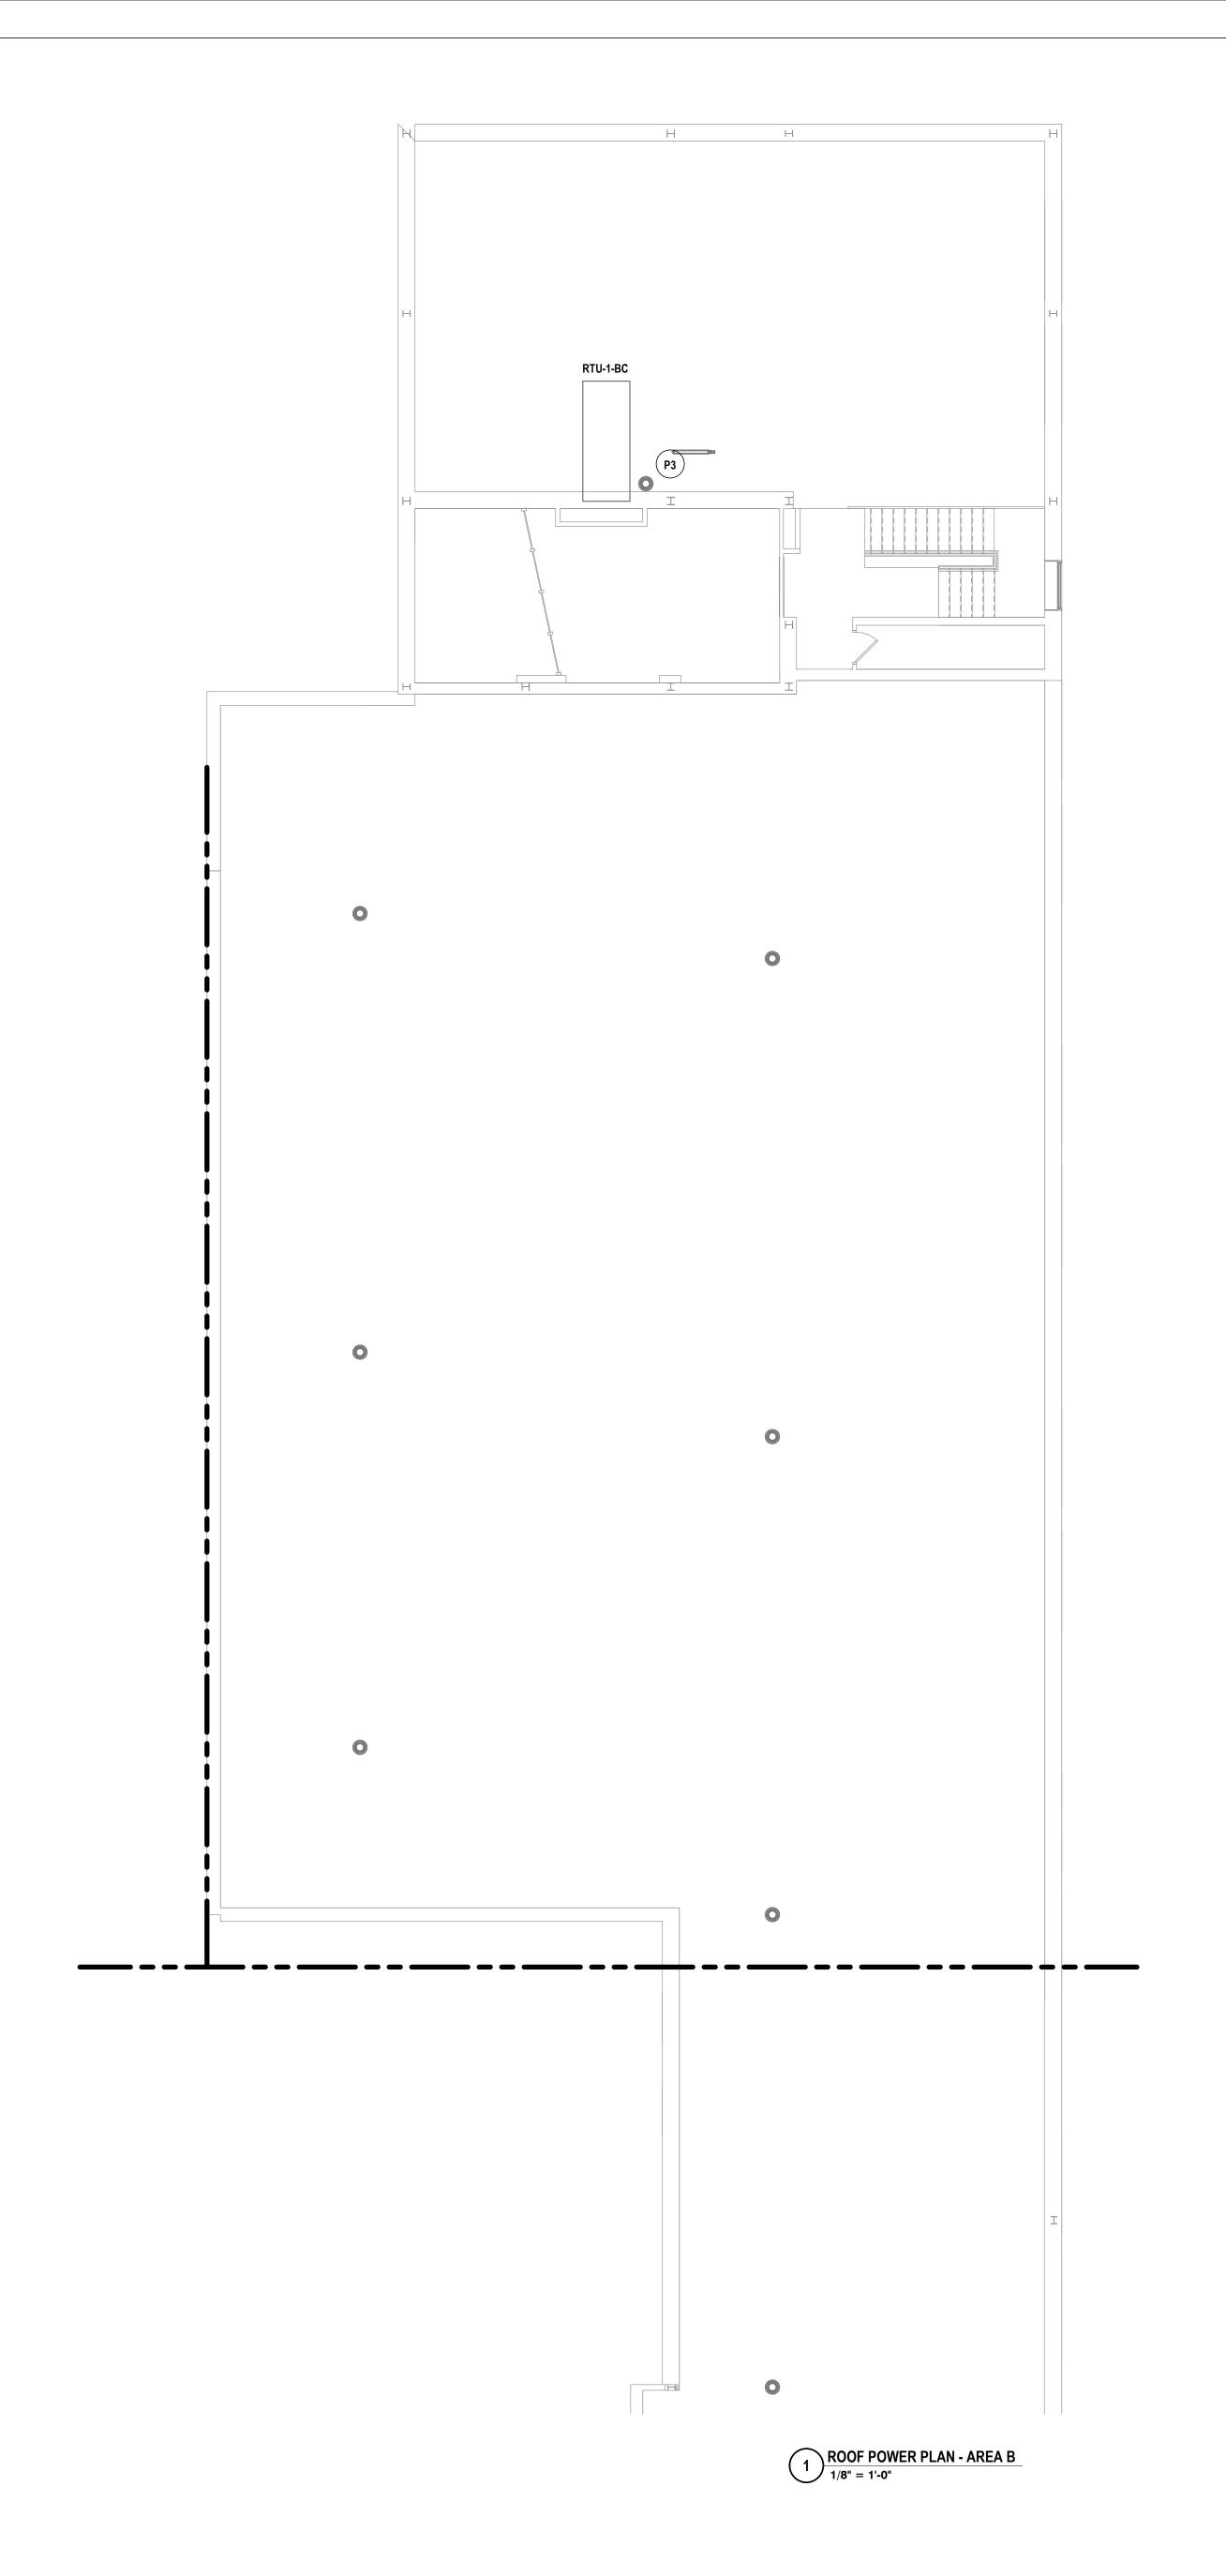

GENERAL NOTES - ELECTRICAL REFER TO BC-E0.1.

CONSTRUCTION NOTES - POWER


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10/21/2022 ្តិ 1/8" = 1'-0"

2

KEY PLAN

BC-E1.4 PROJECT NO: 2012-233

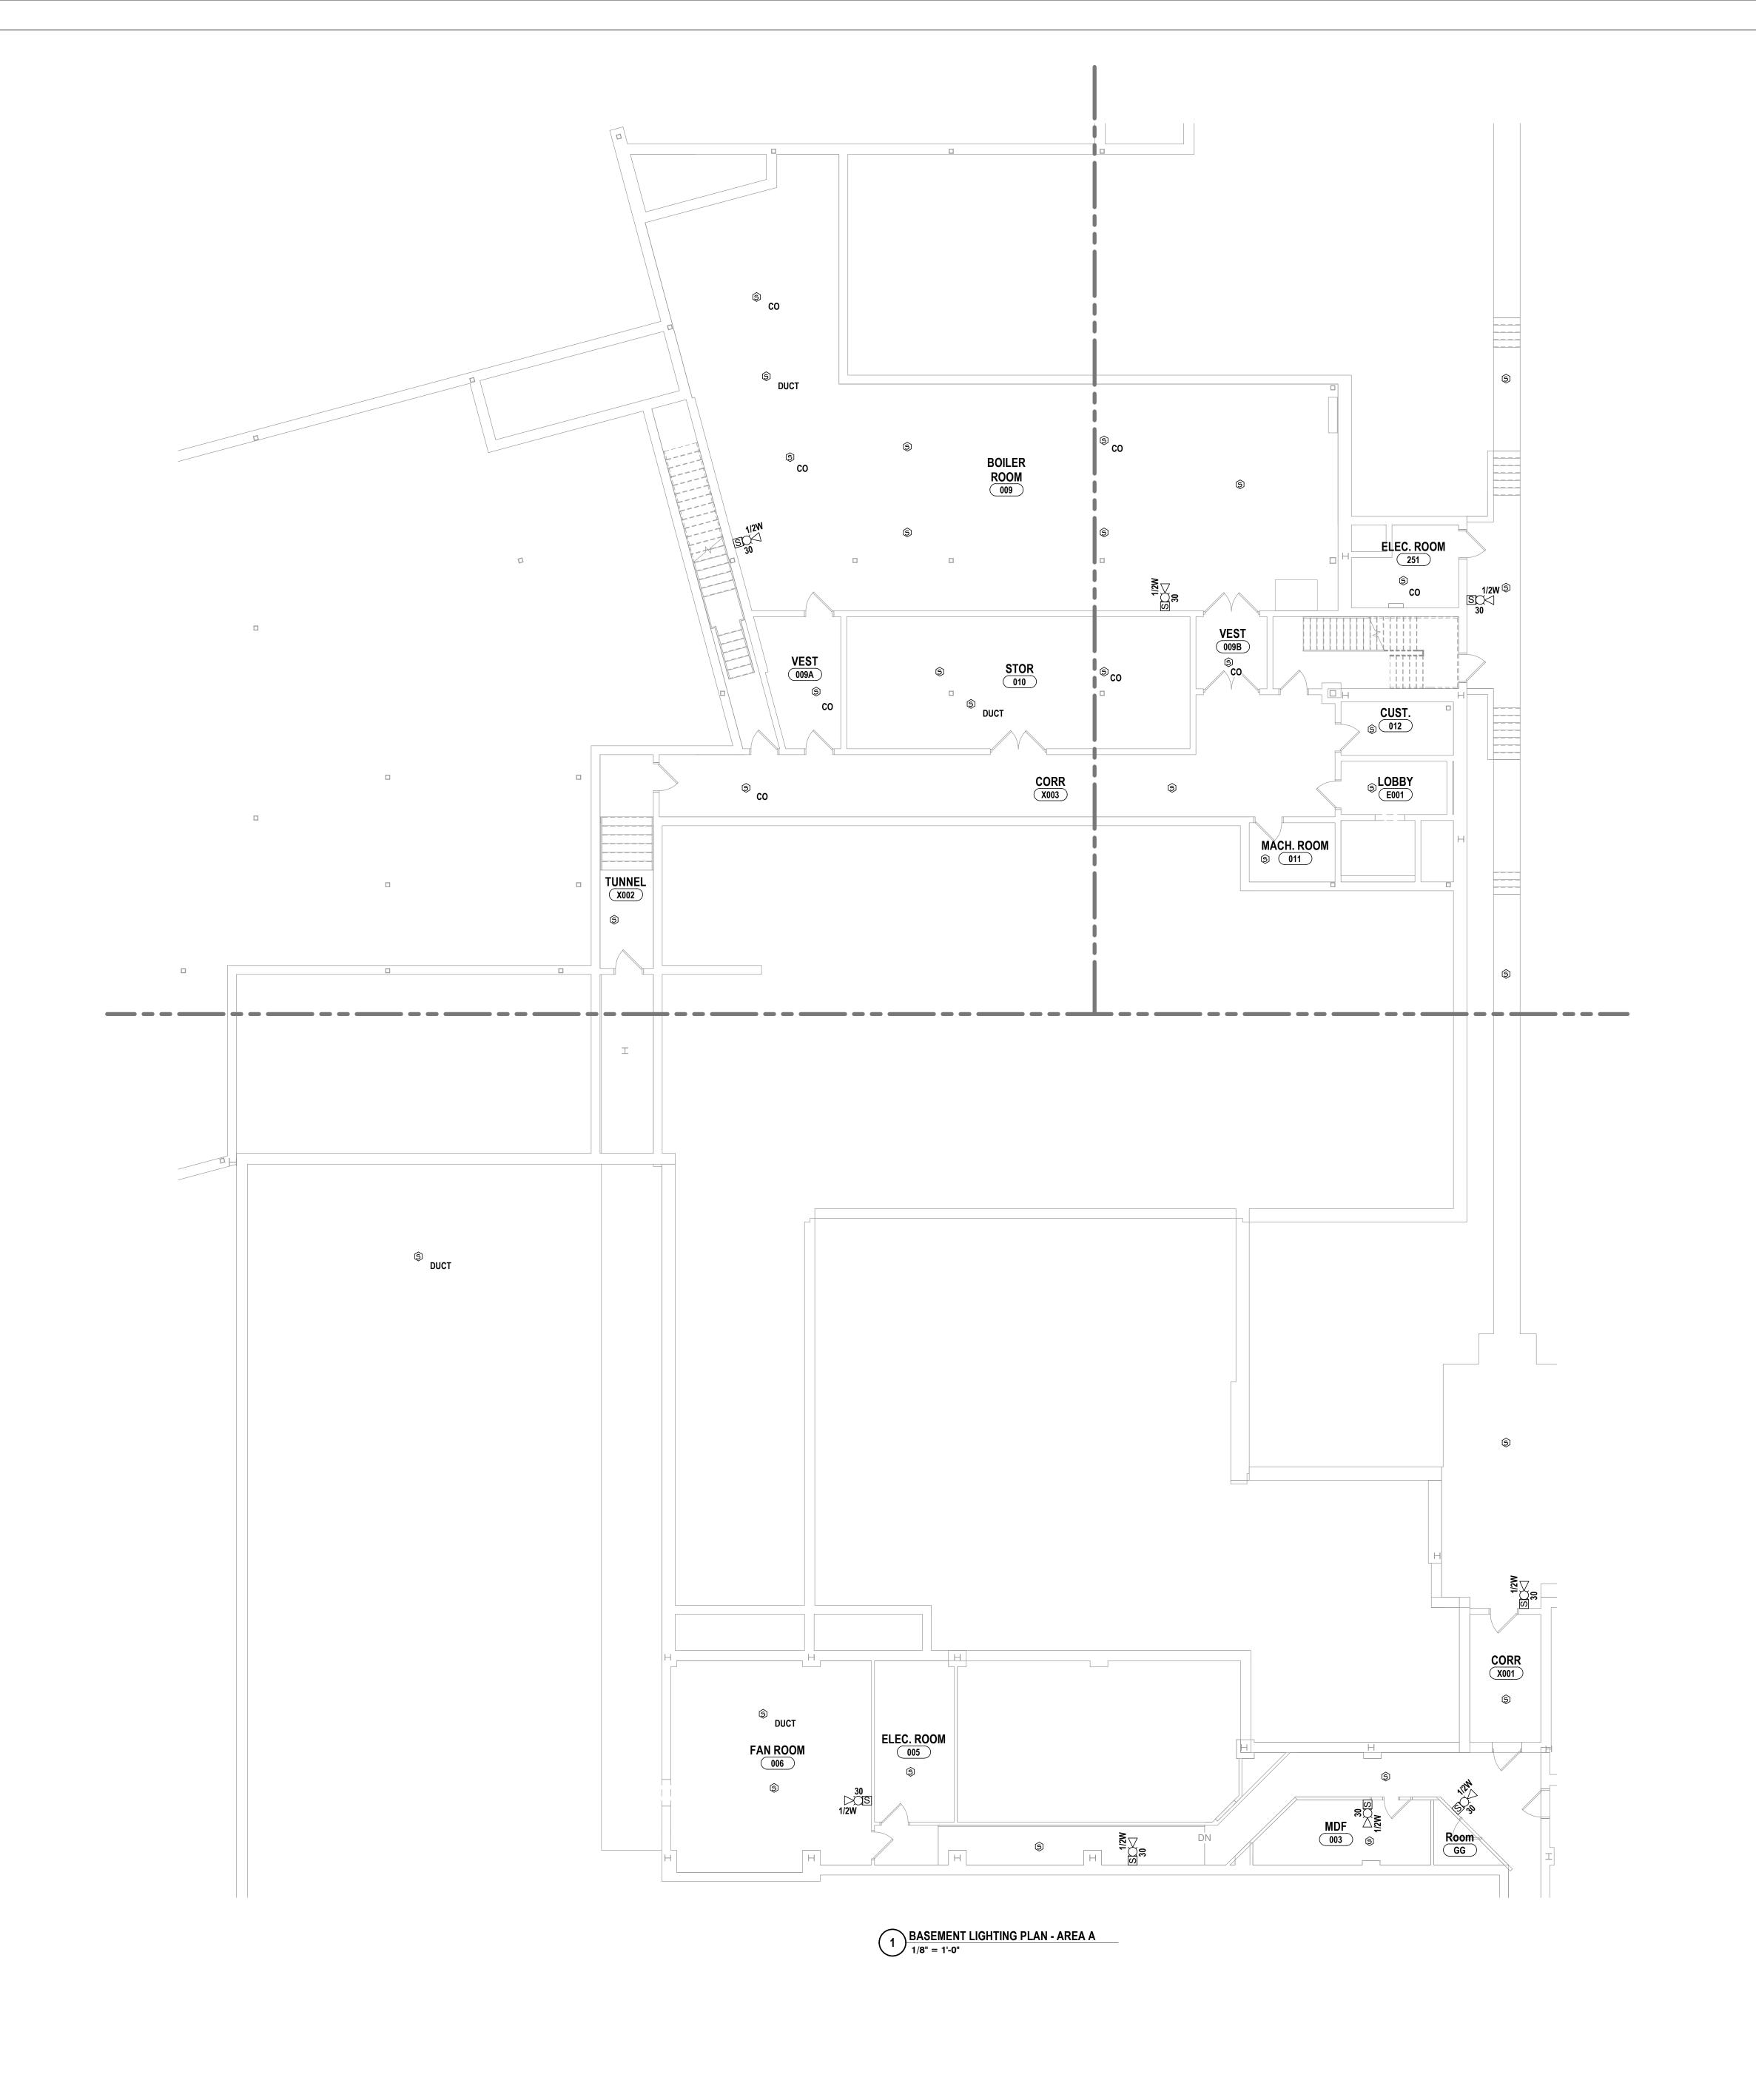

GENERAL NOTES - ELECTRICAL

CONSTRUCTION NOTES - LIGHTING & FA

- L1 BY SEPARATE STATE CONTRACT (REFER TO GENERAL NOTES AND SPEC SECTION). PROVIDE COMPLETE NEW FIRE ALARM SYSTEM WITH VOICE CAPABILITIES. ALL NOTIFICATION DEVICES TO BE SPEAKER/STROBE. DOOR OPENS IN BOLD ON DOORS SHOWN FOR INTEGRATION WITH LOCKDOWN/SECURITY REQUIRE FIRE ALARM CONNECTION BUT ARE INSTALLED AND FURNISHED BY OTHERS WITH M BEING STANDARD MAG AND C BEING
- L2 PROVIDE NEW SWITCHING FOR EXISTING LIGHTING. REUSE EXISTING HOMERUN AND EXTEND AS NEEDED WITH
- 2#12, 1#12G, 3/4"C. L3 REINSTALL EXISTING ELECTRICAL LIGHTING DEVICES INTO NEW GRID. COORDINATE WITH OTHERS.

1/8" = 1'-0"

BASEMENT FLOOR LIGHTING & FA PLAN Z


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PROJECT NO: 2012-233


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CONSTRUCTION NOTES - LIGHTING & FA

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- L3 REINSTALL EXISTING ELECTRICAL LIGHTING DEVICES INTO NEW GRID. COORDINATE WITH OTHERS.



1 FIRST FLOOR LIGHTING PLAN - AREA A 1/8" = 1'-0"

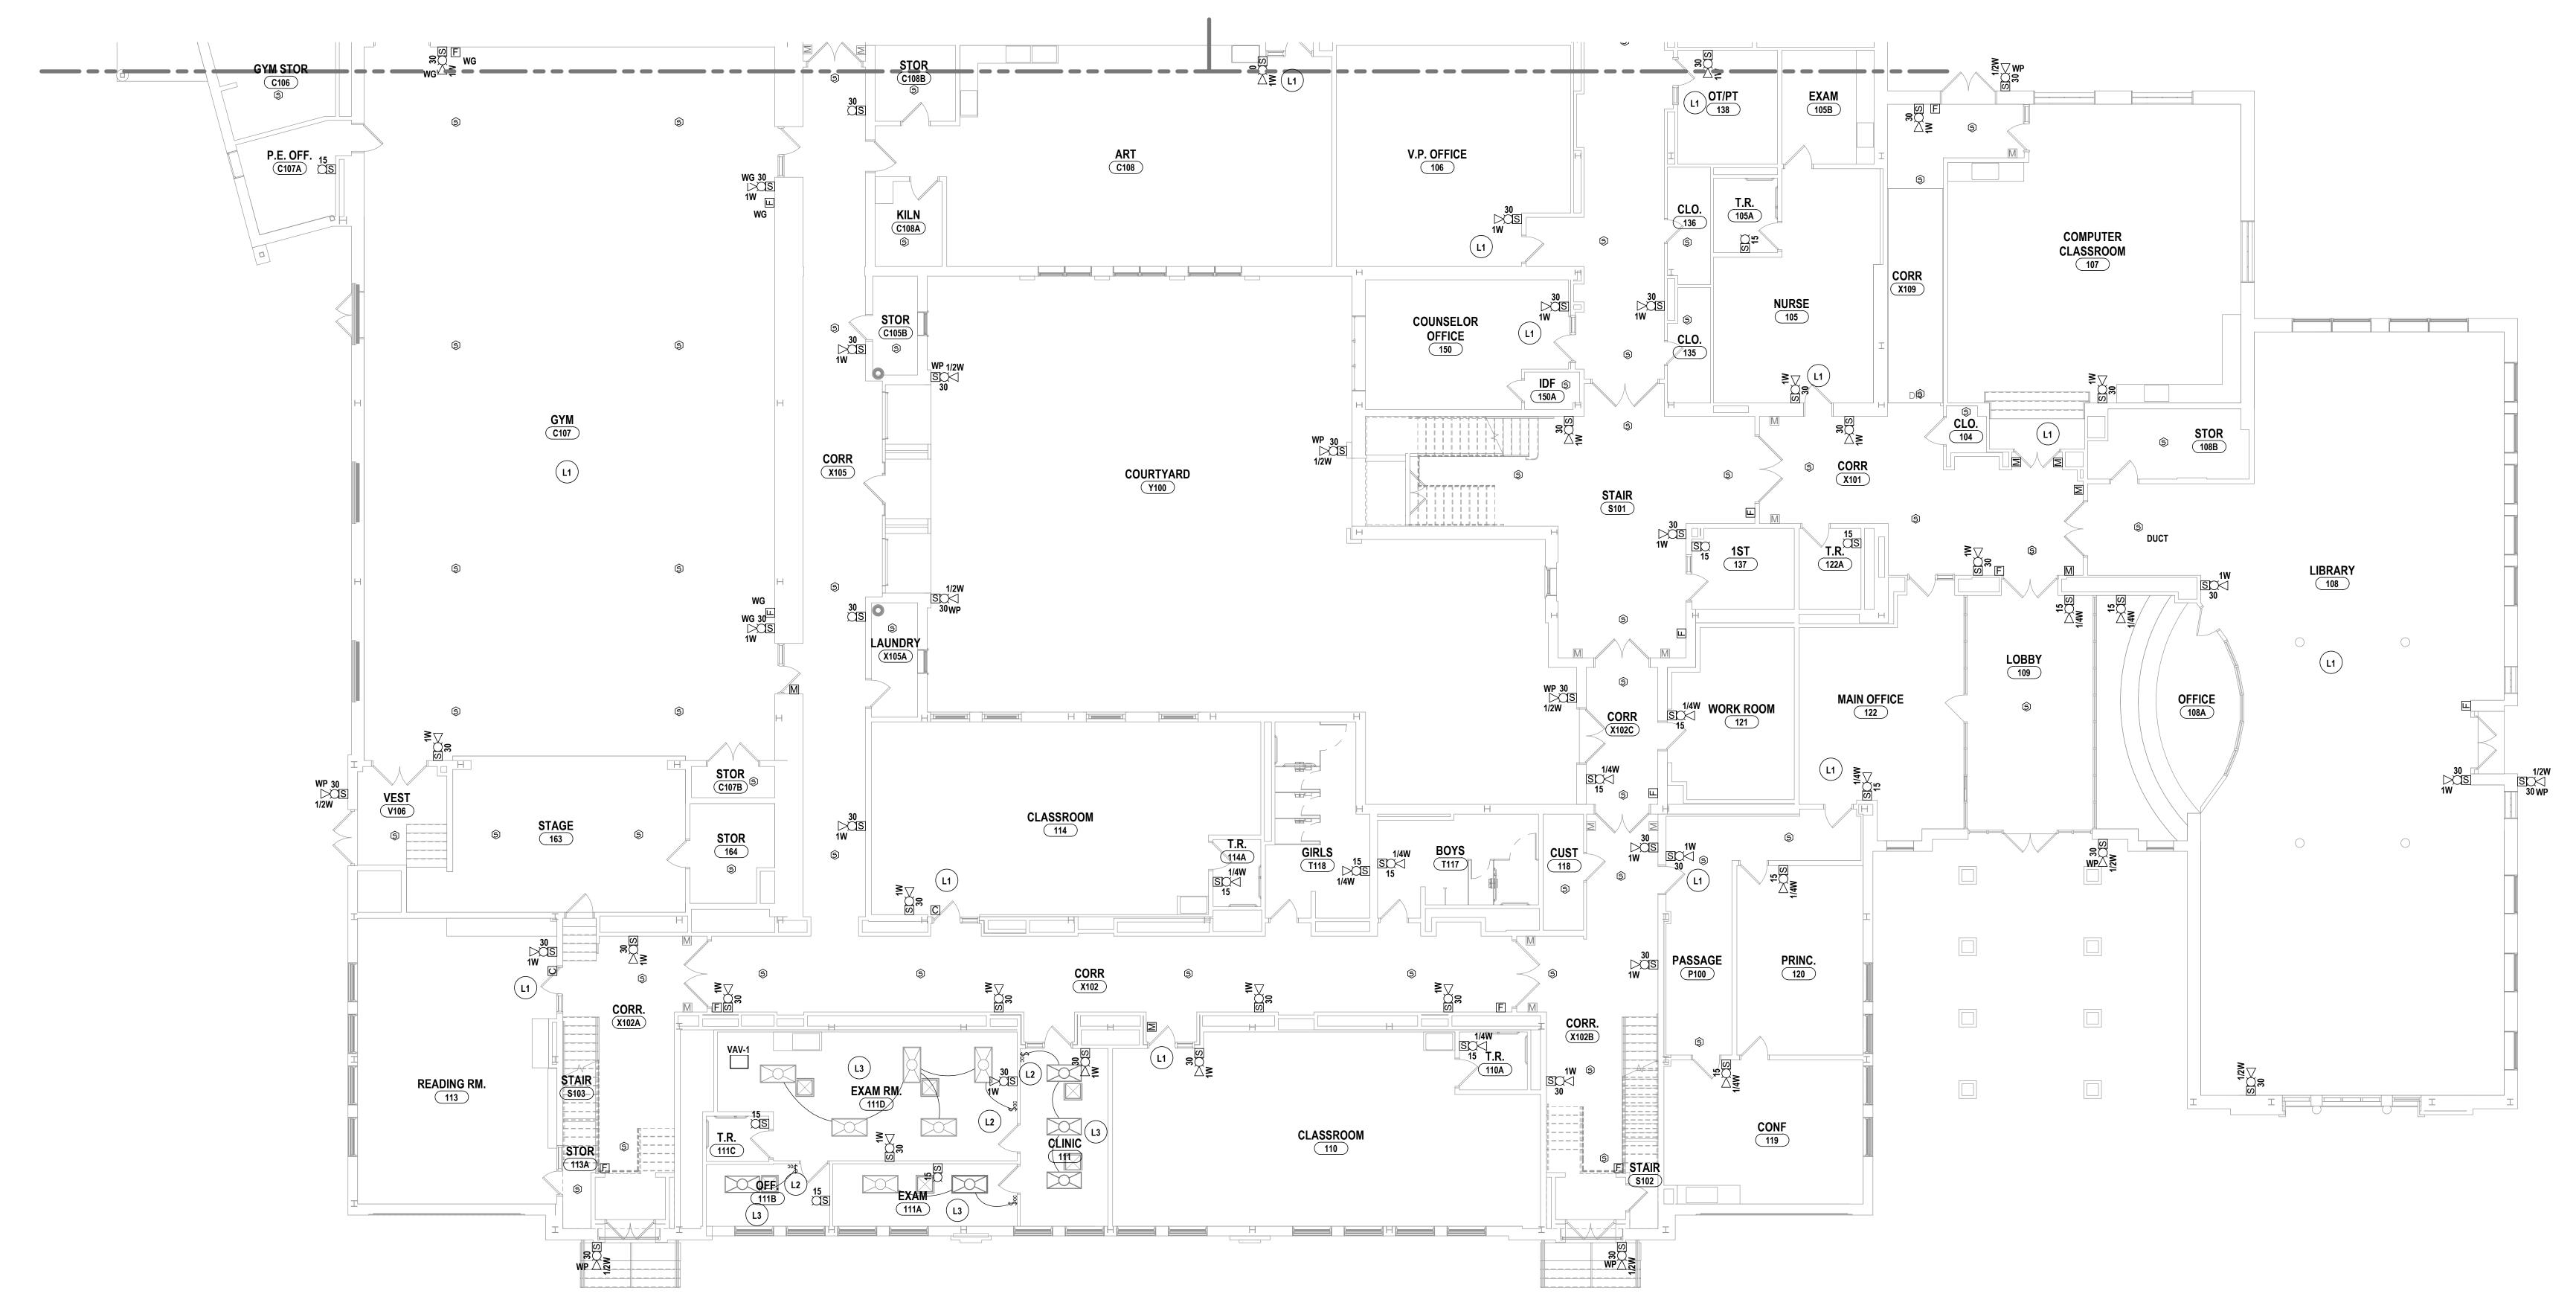

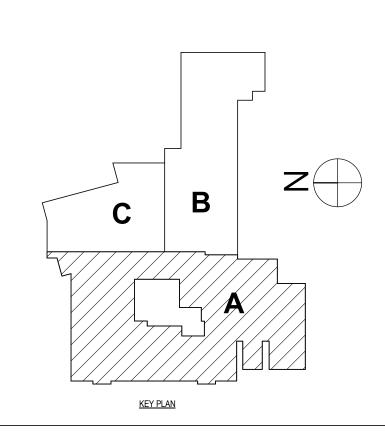10/21/2022 1/8" = 1'-0"

ENGINEERS | ARCHITEC

IG & FA PLAN

BC-E2.2

GENERAL NOTES - ELECTRICAL

CONSTRUCTION NOTES - LIGHTING & FA

- BY SEPARATE STATE CONTRACT (REFER TO GENERAL NOTES AND SPEC SECTION). PROVIDE COMPLETE NEW FIRE ALARM SYSTEM WITH VOICE CAPABILITIES. ALL NOTIFICATION DEVICES TO BE SPEAKER/STROBE. DOOR OPENS IN BOLD ON DOORS SHOWN FOR INTEGRATION WITH LOCKDOWN/SECURITY REQUIRE FIRE ALARM CONNECTION BUT ARE INSTALLED AND FURNISHED BY OTHERS WITH M BEING STANDARD MAG AND C BEING DOOR CLOSER. EXISTING IN GREYSCALE ARE TO BE REUSED WHERE POSSIBLE WITH EXISTING CIRCUITRY AND
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 REINSTALL EXISTING ELECTRICAL LIGHTING DEVICES INTO NEW GRID. COORDINATE WITH OTHERS.

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FLOOR LIGHTING & FA PLAN - AREA B ENTARY SCHOOLS 2023 RENOVATIONS (PHASE RA CITY SCHOOL DISTRICT

EMENTARY SED #: 07-06-00-01-0-005-0

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KEY PLAN

BC-E2.3

PROJECT NO: 2012-233

GENERAL NOTES - ELECTRICAL REFER TO BC-E0.1.

CONSTRUCTION NOTES - LIGHTING & FA

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SU. ENGINEERS | ARCHITEC

S 2023 RENOVATIONS (PHASE DISTRICT FIRST FLOOR LIGHTING & FA PLAN - AREA C

ELEMENTARY SCHOOLS 2023 RENOVATIONS (PI

ELMIRA CITY SCHOOL DISTRICT

ELMIRA, CHEMUNG COUNTY, NEW YORK

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BC-E2.4


PROJECT NO: 2012-233

GENERAL NOTES - ELECTRICAL


REFER TO BC-E0.1.

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1 SECOND FLOOR LIGHTING PLAN - AREA A 1/8" = 1'-0"

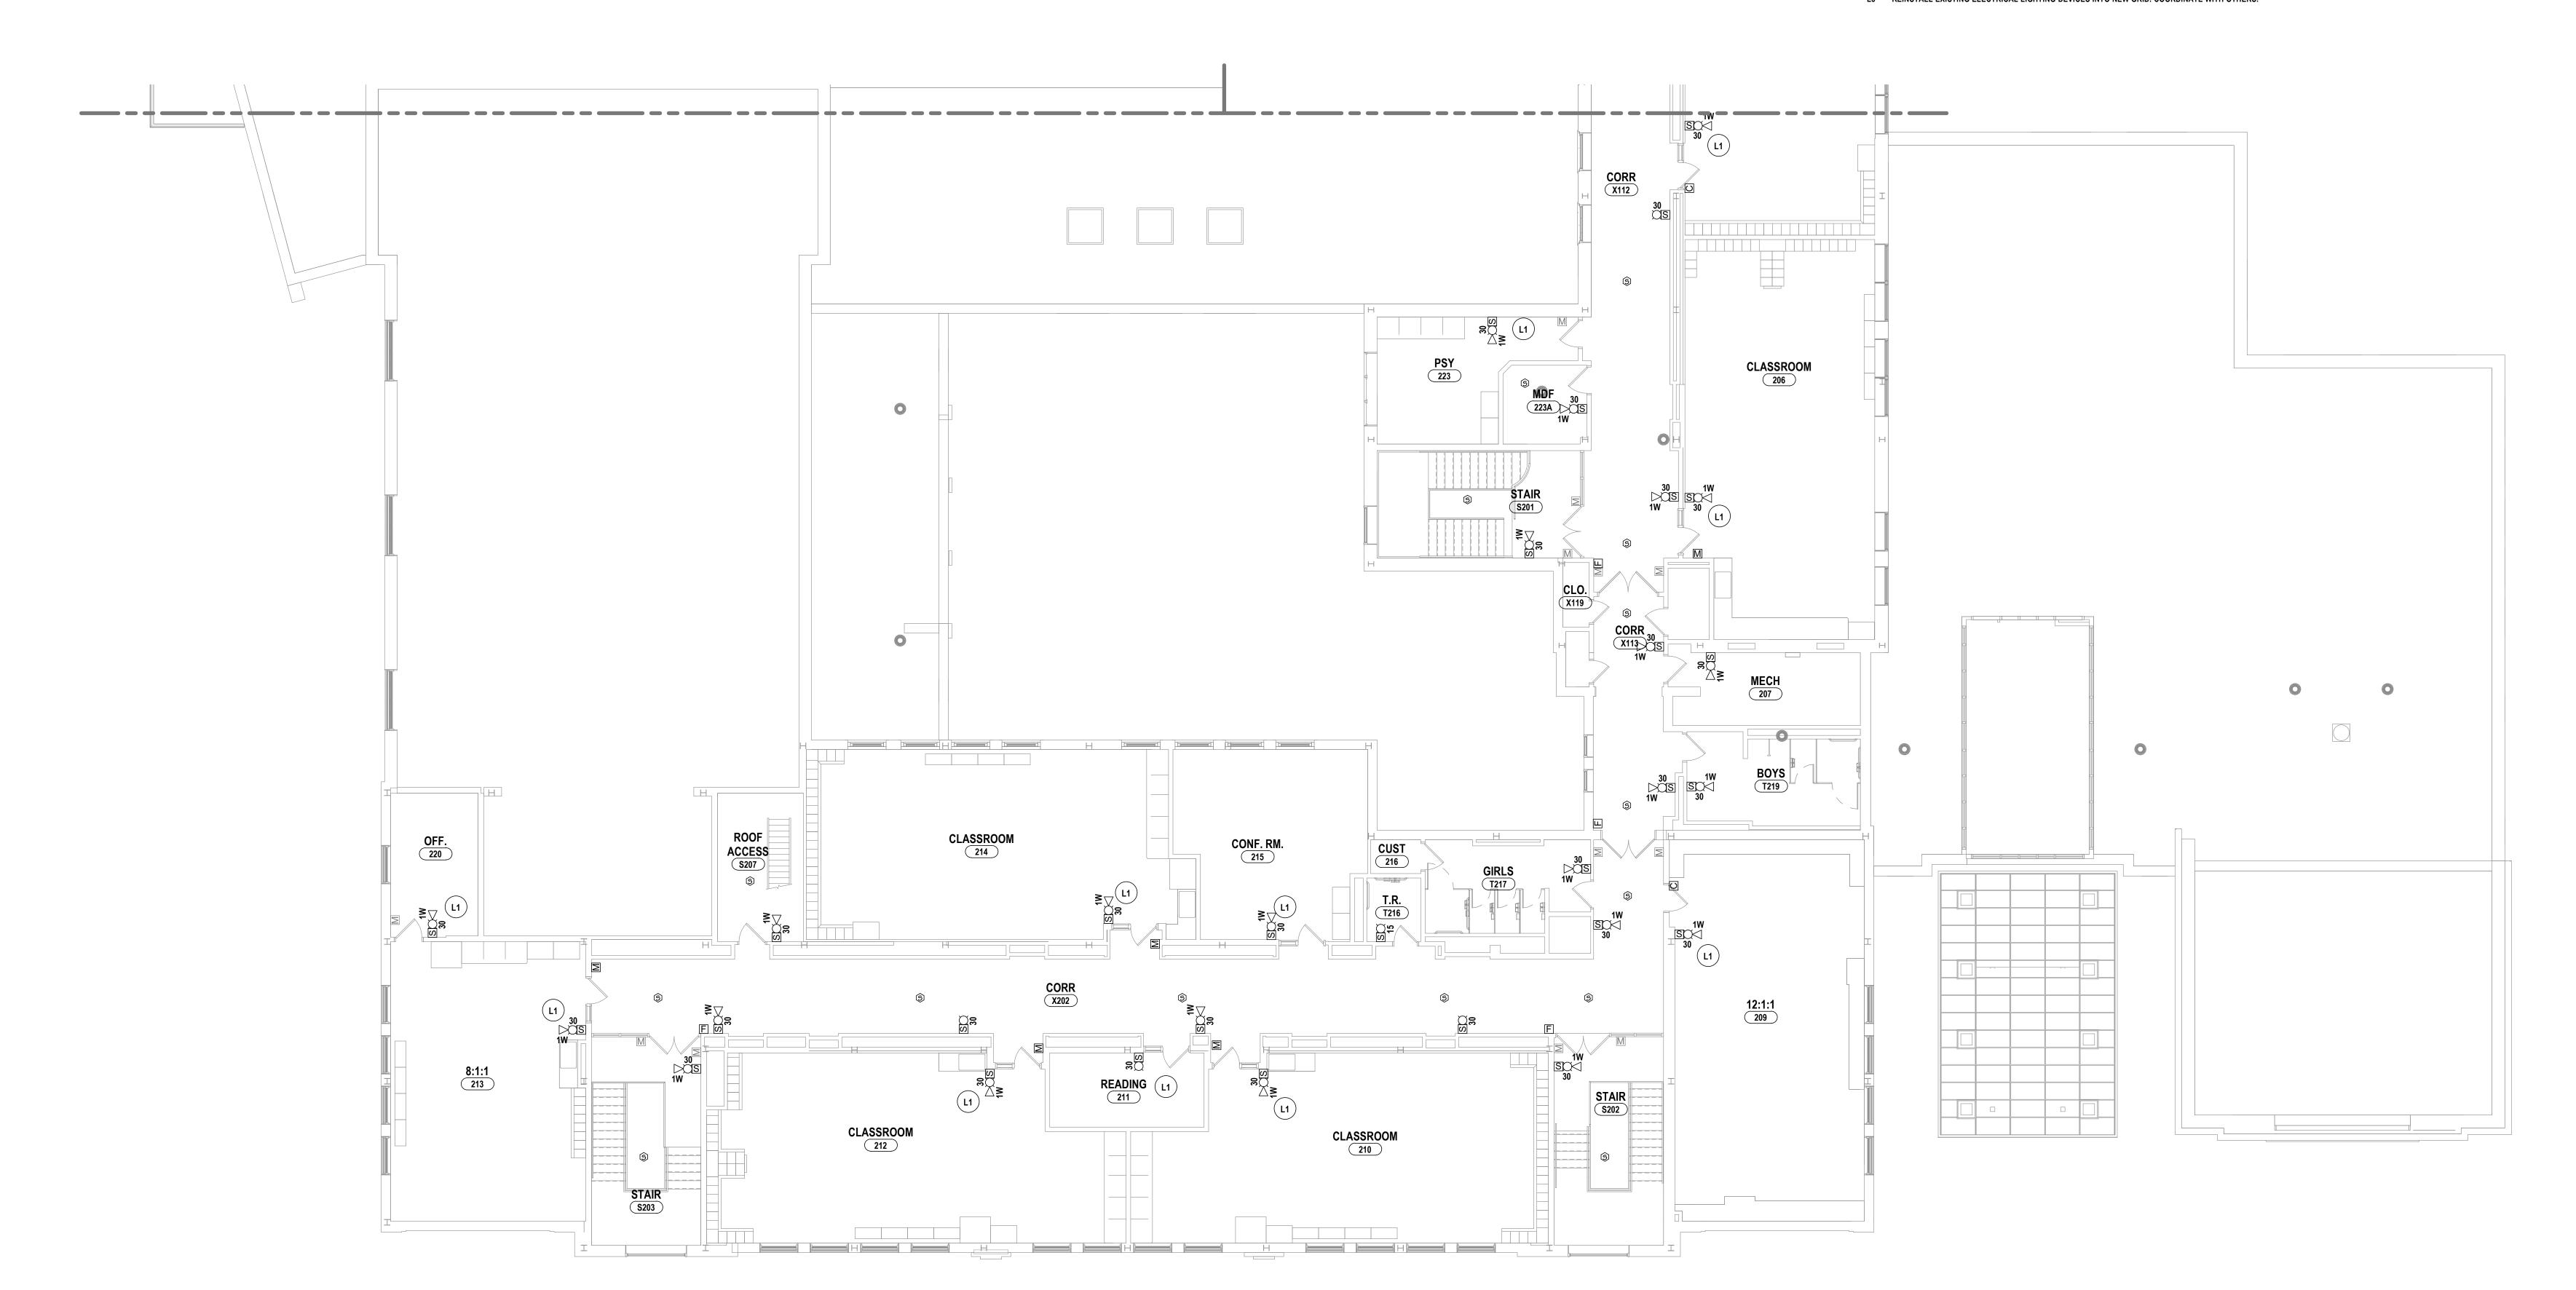

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HORSEHEADS, NY 607-358-1000 ROCHESTER, NY 585-327-7949 TOWANDA, PA 570-265-4868

SECOND FLOOR LIGHTING & FA PLAN - AREA A

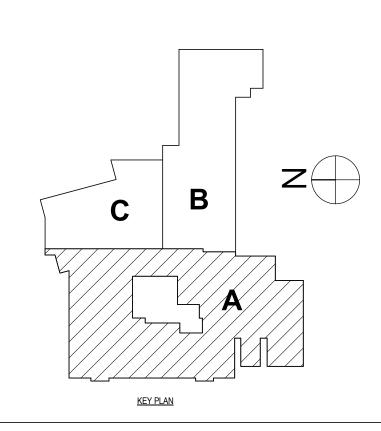ELEMENTARY SCHOOLS 2023 RENOVATIONS (PHASE II)

ELMIRA CITY SCHOOL DISTRICT

ELMIRA, CHEMUNG COUNTY, NEW YORK

BC-E2.5

GENERAL NOTES - ELECTRICAL REFER TO BC-E0.1.

CONSTRUCTION NOTES - LIGHTING & FA

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HORSEHEADS, NY 607 - 358 - 1000 ROCHESTER, NY 585 - 327 - 7949 TOWANDA, PA 570 - 265 - 4868

COND FLOOR LIGHTING & FA PLAN - AREA B EMENTARY SCHOOLS 2023 RENOVATIONS (PHAMIRA CITY SCHOOL DISTRICT

BC-E2.6


BC-E2.6

PROJECT NO: 2012-233

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UNIT#		HORSEPOWER	WATTS FULL LOAD AMPS	MINIMUM CURCUIT AMPACITY	NOMINAL VOLTAGE	PHASE Φ	PANEL / CONTROL CENTER	CIRCUIT BREAKER	WIRE SIZE	REFERENCE NOTES	DISCONNECT SWITCH (PROVIDED BY EC)	DISCONNECT SWITCH (FURNISHED BY HC & INSTALLED BY EC)	PRE-WIRED/FACTORY MOUNTED DISCONNECT SWITCH (BY MFR)	MANUAL MOTOR STARTER (PROVIDED BY EC)	COMBINATION STARTER WITH CONTACTS FOR DDC (PROVIDED BY EC)	(;	VFD PACKAGE (PROVIDED BY HC, CONNECTED BY EC)	VFD WITH CHOKE (FURNISHED BY H.C.& INSTALLED BY EC)	SINGLE POINT CONNECTION	FAN SHUTDOWN UPON FACP ACTIVATION	DUCT SMOKE DETECTOR IN RETURN DUCT	LINE VOLTAGE THERMOSTAT (FURNISHED BY HC & INSTALLED BY EC)	FACTORY MOUNTED STARTER & DISCONNECT (BY MFR)	CONNECT AQUASTAT PROVIDE 20A. 120V GFCI RECEPT. IN WEATHERPROOF ENCLOSURE AT UNIT
B-1-BC	BOILER		16 A		120 V		ВР	20A 1P	2#12, 1#12G, 3/4"C	A														
B-2-BC	BOILER		16 A		120 V		ВР	20A 1P	2#12, 1#12G, 3/4"C	A														
B-3-BC	BOILER		16 A		120 V		BP	20A 1P	2#12, 1#12G, 3/4"C	Α Α														
B-4-BC DW-HTX-1-BC	BOILER HOT WATER EXHANGER		16 A		120 V 120 V		BP BP	20A 1P 20A 1P	2#12, 1#12G, 3/4"C 2#12, 1#12G, 3/4"C	A	Х													
P-1-BC	PUMP -	1	ZA		120 V 208 V	3P	BP	20A 1P 20A 3P	3#12, 1#12G, 3/4 C		X				X									
RTU-1-BC	ROOF TOP UNIT	1	64 A		208 V	3P	HVAC-1	80A 3P	3#4, 1#8G, 1-1/2"C		_		Х		^					X	Х			X
VAV-1-BC	VAV BOX		1 A		120 V			EXG	2#12, 1#12G, 3/4"C				^								Α			^

SCHEDULE NOTES:

A.. BY ALTERNATE BC-3.

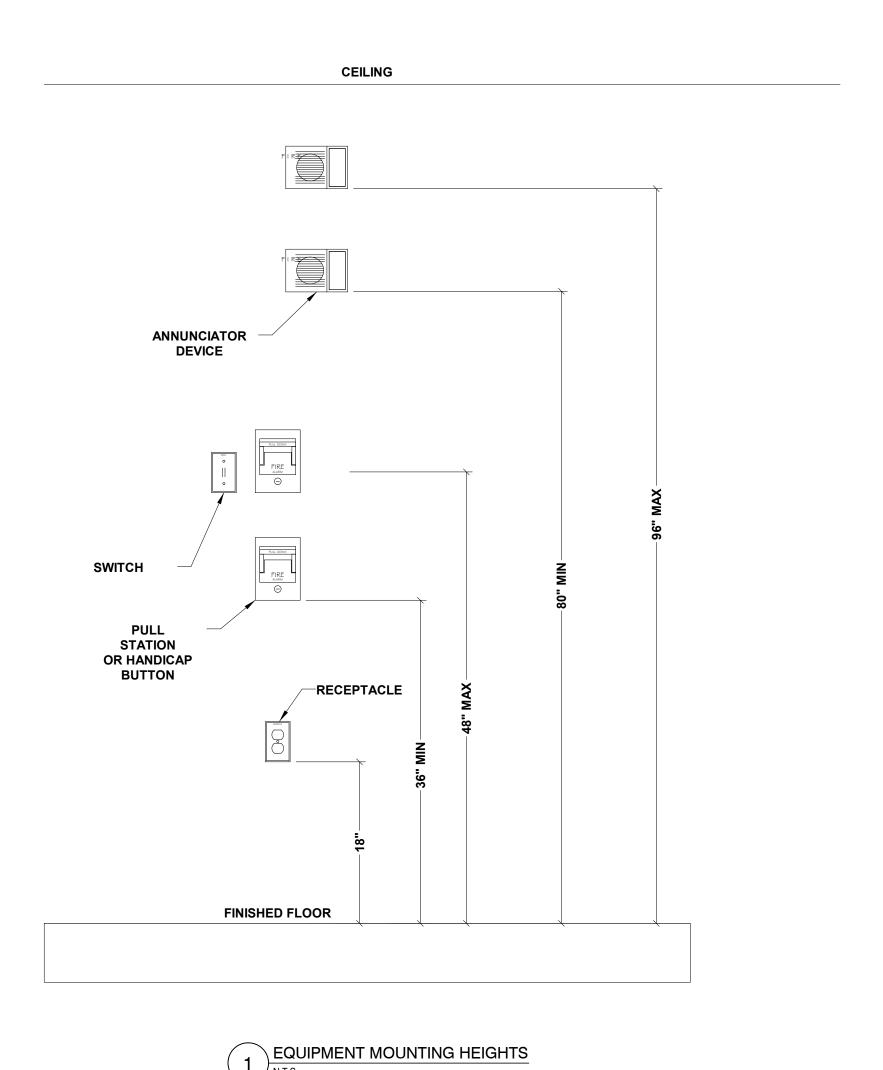

DATE: DESCRIPTION OF REVISION:

DATE: DESCRIPTION OF REVISION:

1 5/26/2023 ISSUED FOR BID

3 A BY: SSUED FOR BID

3 A BY: SSUED FOR BID

3 A BANAMA SOLICENSED ALTERATIONS OR ADDITIONS TO PLANS

4 BEARING A LICENSED ENGINEERS, ARCHITECT'S OR SURVEYOR'S SEAL."


COpyright: 2022


HORSEHEADS, NY 607 - 358 - 1000 ROCHESTER, NY 585 - 327 - 7949 TOWANDA, PA


SCHOOLS 2023 RENOVATIONS (PHACHOOL DISTRICT

SCHEDULES & DETAILS
ELEMENTARY SCHOOLS 202
ELMIRA CITY SCHOOL DISTE

BC-E3.1

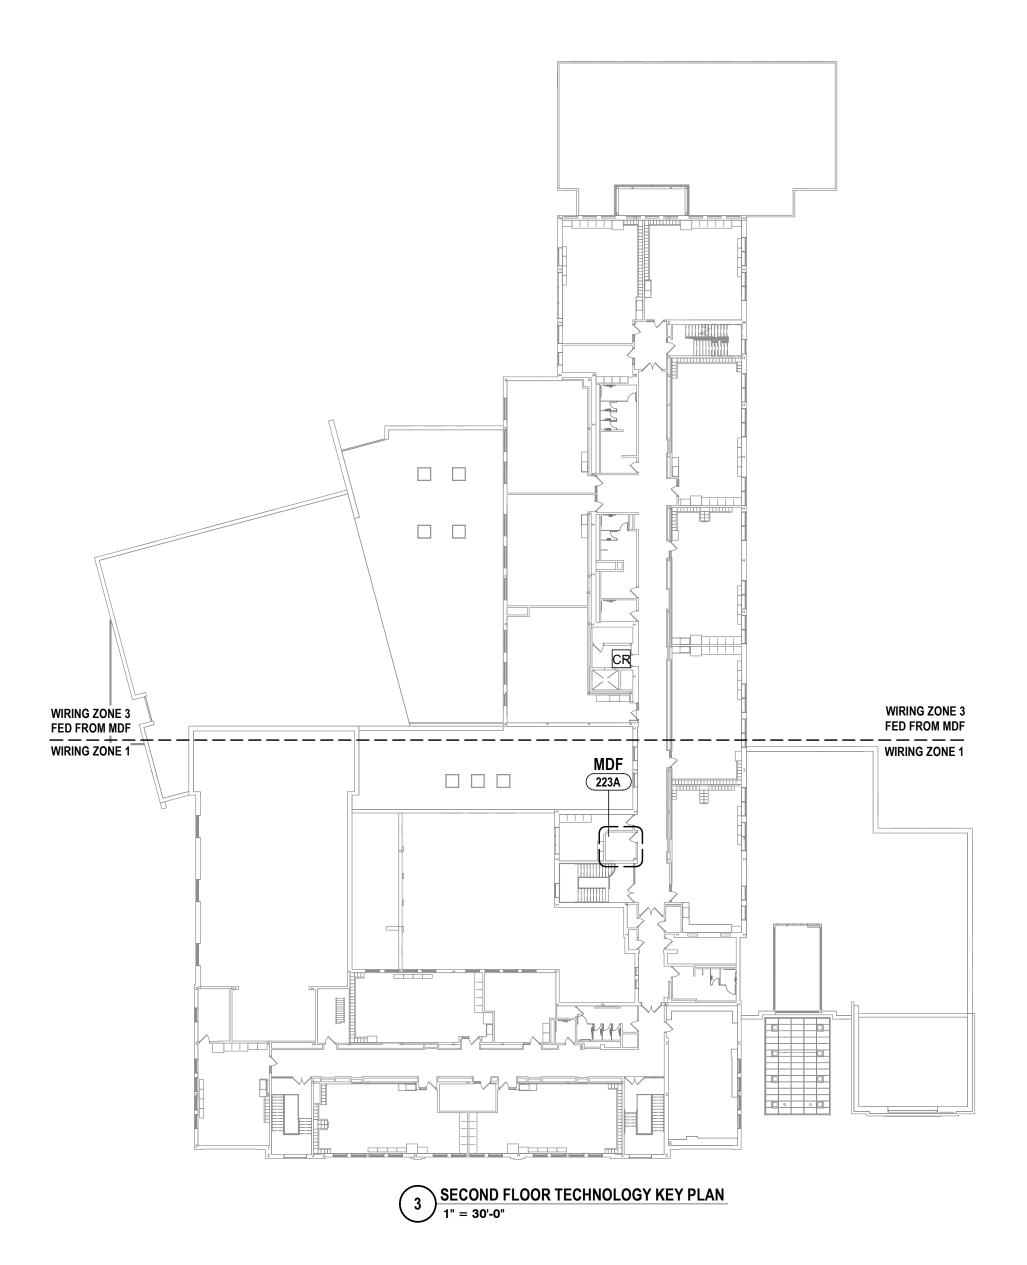

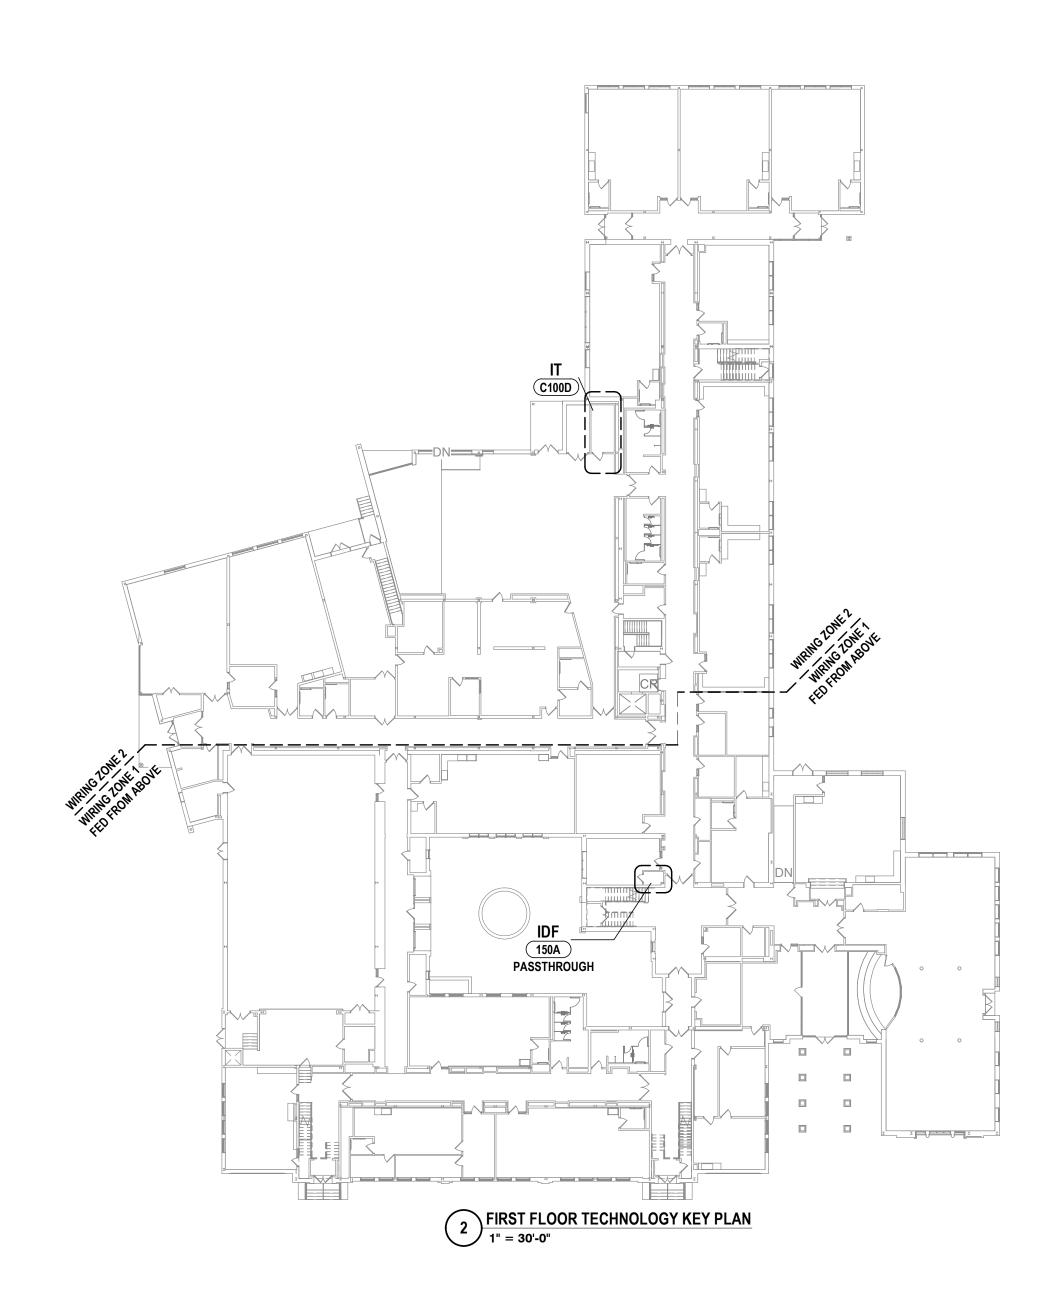

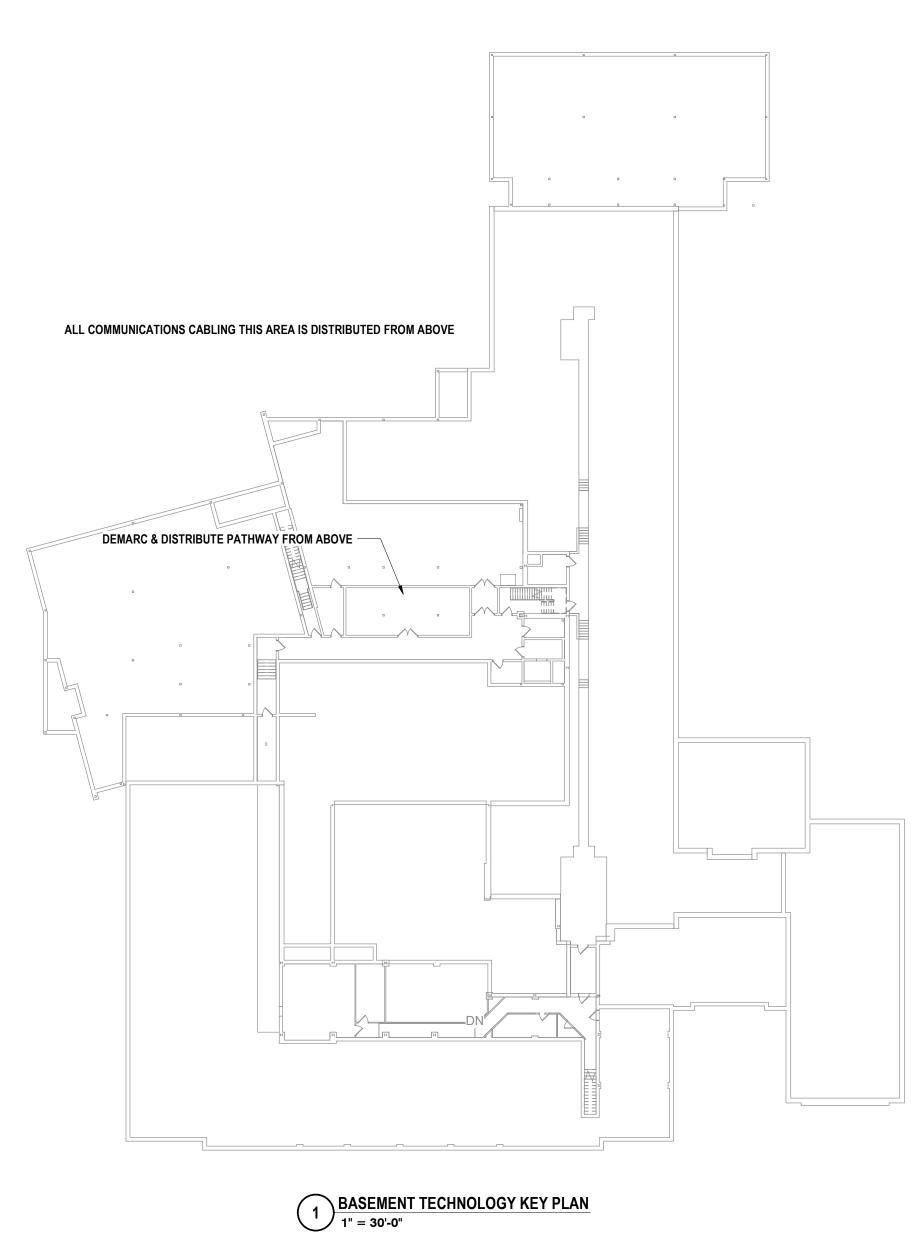

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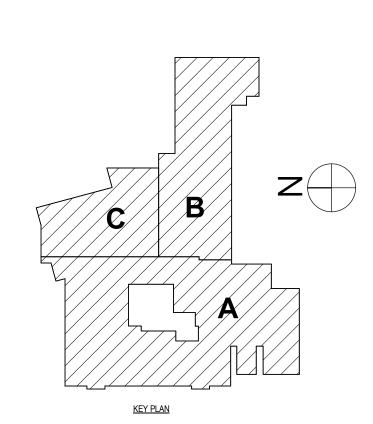
ANSI/TIA/EIA STANDARDS.

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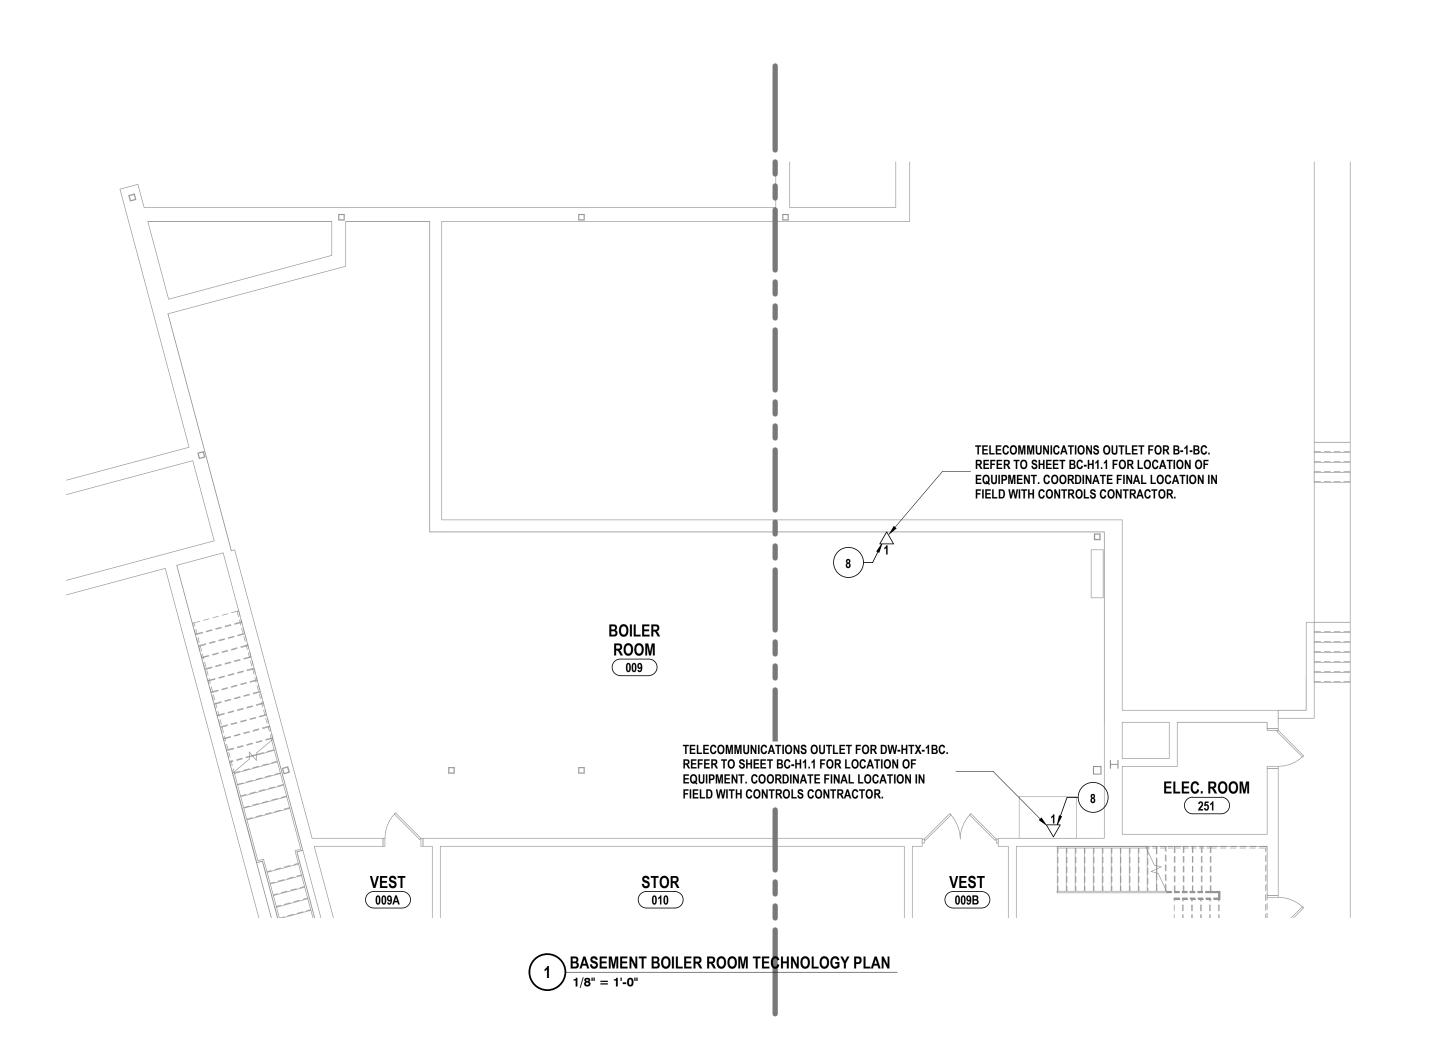
CAT 6A INDOOR/OUTDOOR CABLE, PER
SPECIFICATIONS. REFER TO L-SERIES
DRAWINGS FOR PATHWAY AND DEVICE MDF 223A ROOM NETWORK SWITCH 4 ELECTRONIC MESSAGE SIGN RISER DIAGRAM NTS



DRAWN BY: CSH CHECKED BY: 10/21/2022 SCALE: As indicated

, FIRST & SECOND FL T RY SCHOOLS 2023 REN

BC-T1.1 PROJECT NO: 2012-233



- A ALL CABLING INSTALLATION AND TERMINATION TO ADHERE TO CURRENT NEC CODES AND RELATED ANSI/TIA/EIA STANDARDS.
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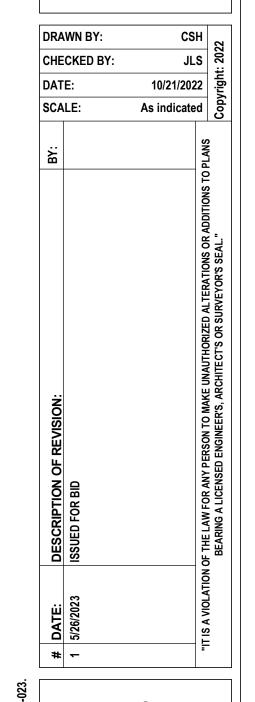
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CONSTRUCTION NOTES - TECHNOLOGY

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HORSEHEADS, NY 607 - 358 - 1000 ROCHESTER, NY 585 - 327 - 7949 TOWANDA, PA 570 - 265 - 4868

B C B KEY PLAN

BASEMENT TECHNOLOGY PLAN

BC-T1.2

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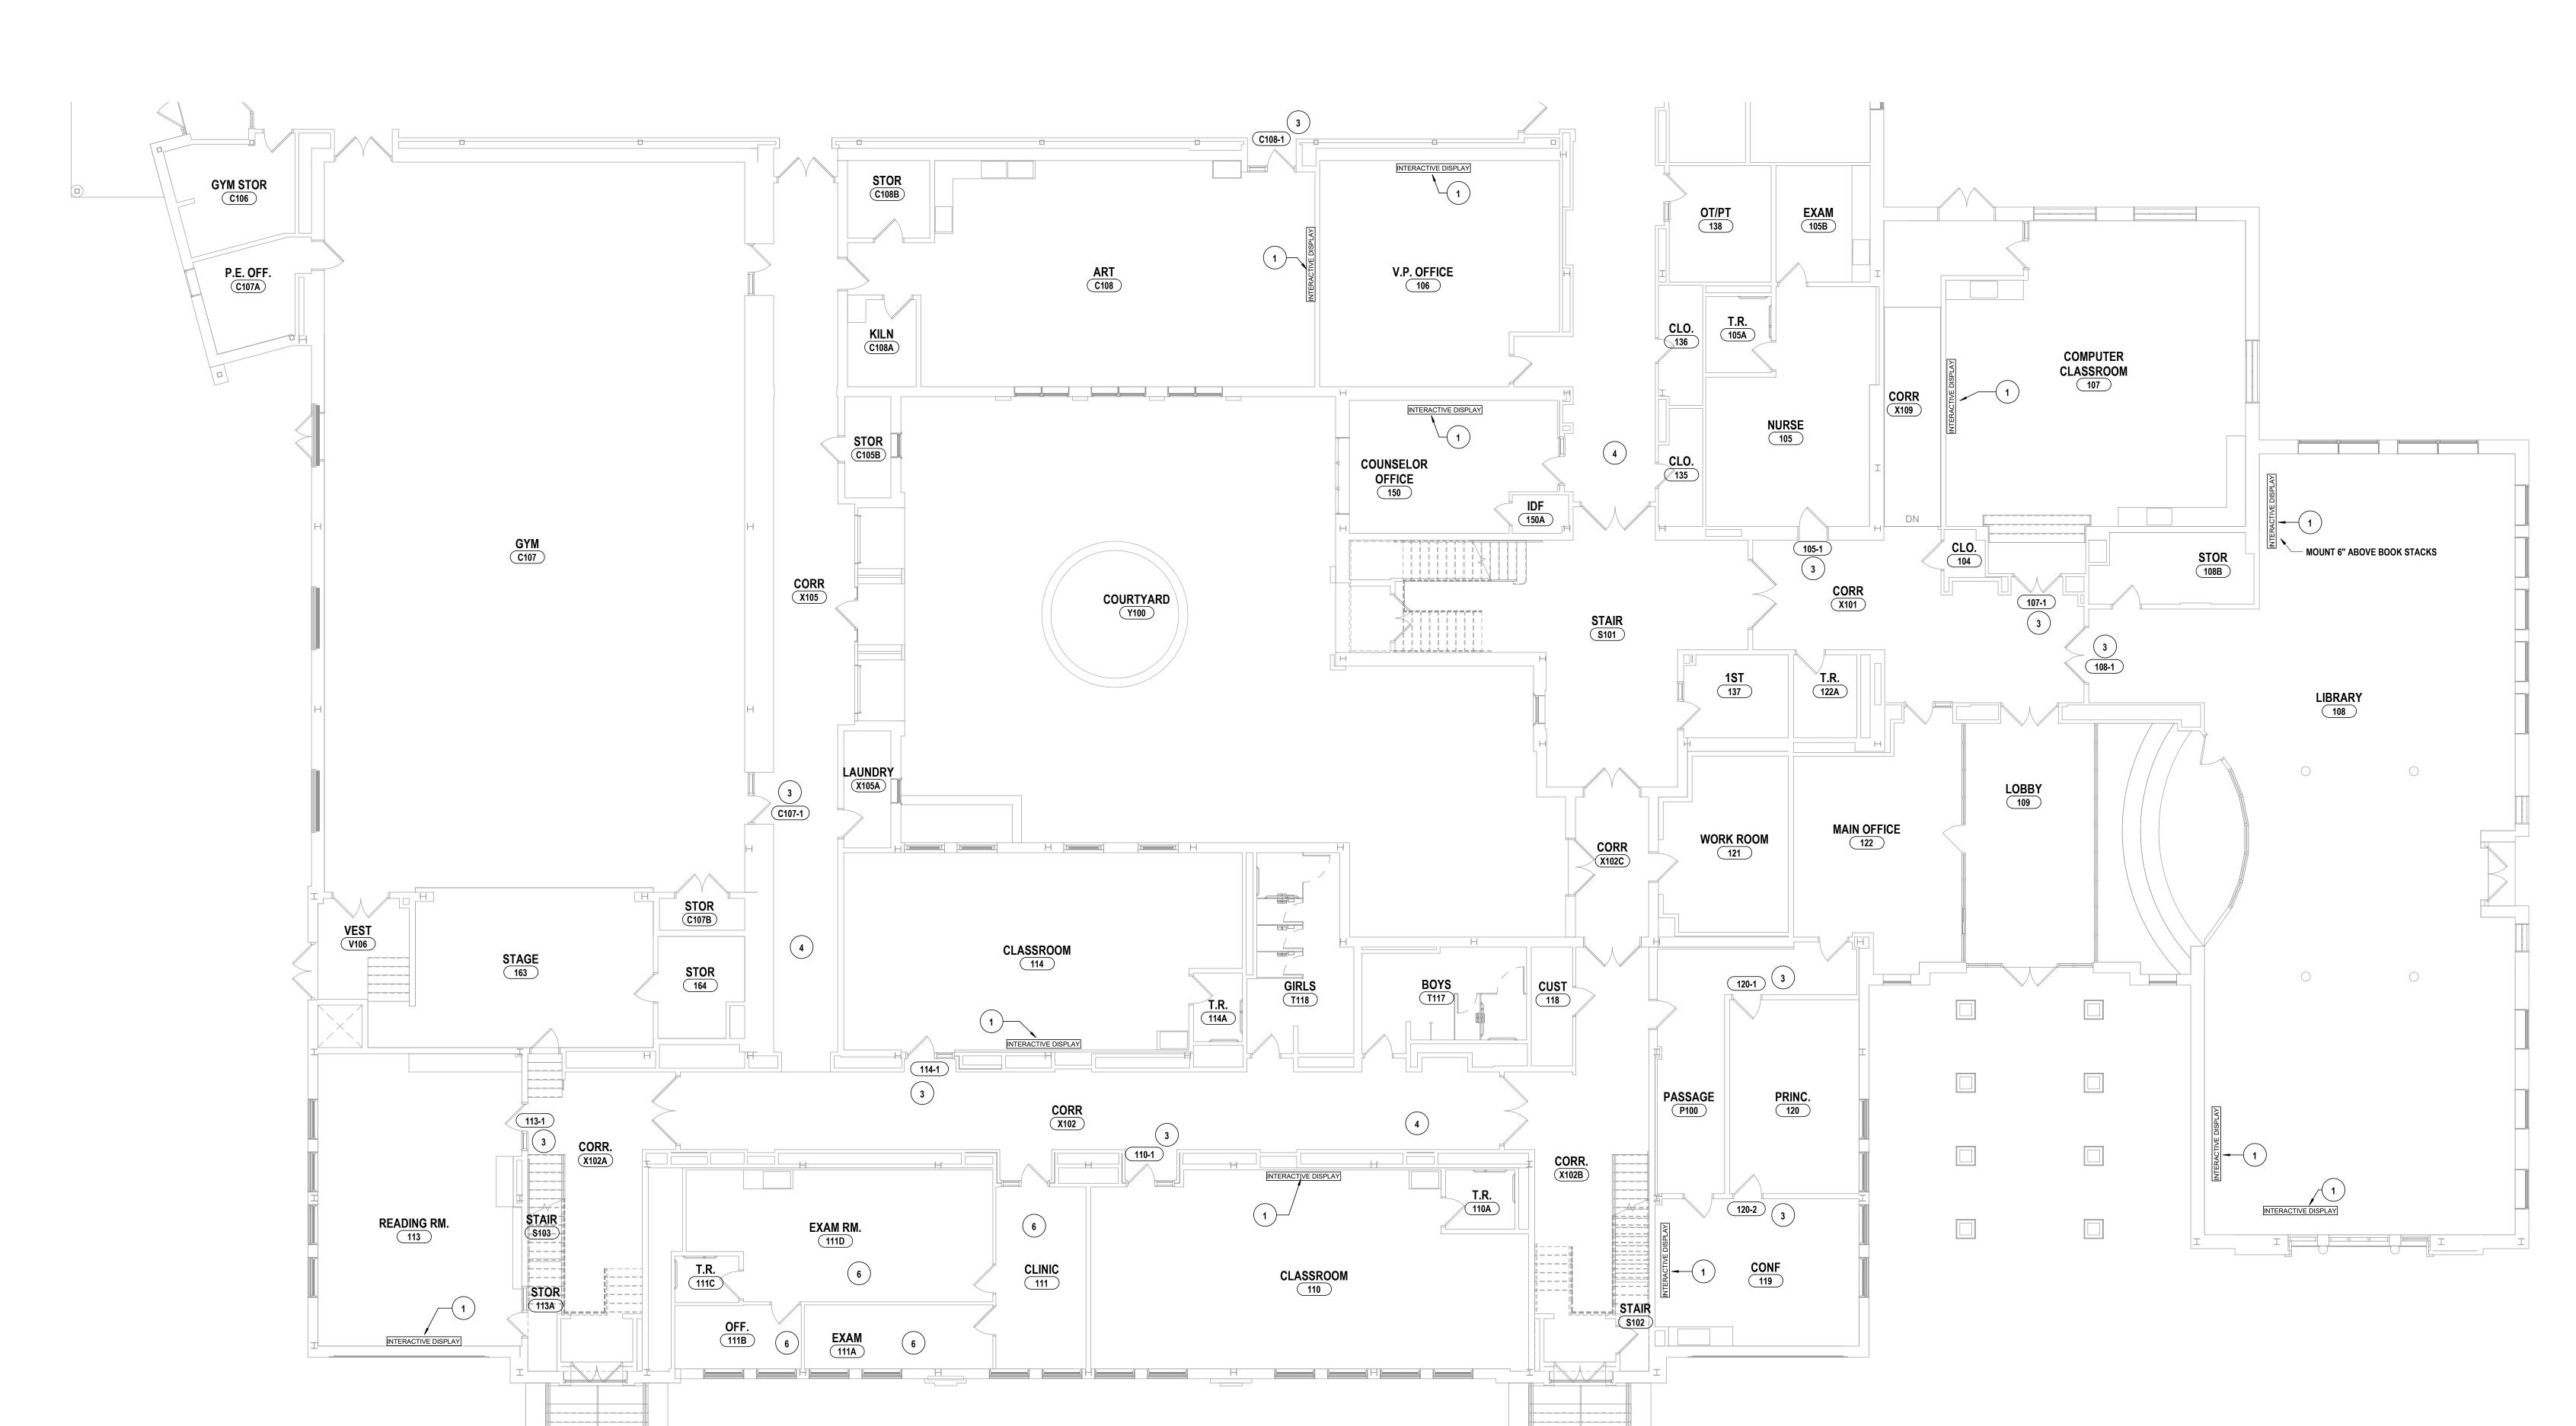
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CONSTRUCTION NOTES - TECHNOLOGY


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1 FIRST FLOOR TECHNOLOGY PLAN - AREA A
1/8" = 1'-0"



DATE: DESCRIPTION OF REVISION:
| 5/26/2023 | ISSUED FOR BID | ISSUED FOR

HORSEHEADS, NY 607 - 358 - 1000 ROCHESTER, NY 585 - 327 - 7949 TOWANDA, PA 570 - 2

PLOOR TECHNOLOGY PLAN - AREA A

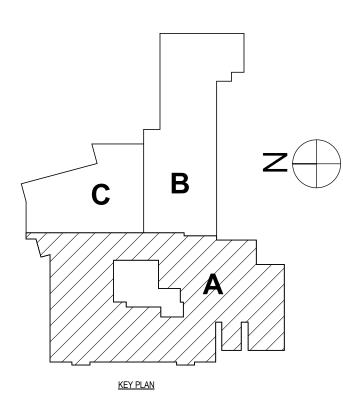FLOOR TECHNOLOGY PLAN - AREA A

ENTARY SCHOOLS 2023 RENOVATIONS (PHAS

RA CITY SCHOOL DISTRICT

BC-T1.3



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CONSTRUCTION NOTES - TECHNOLOGY

SHEETS FOR REFELECTED CEILING DEMO PLANS BY AREA.

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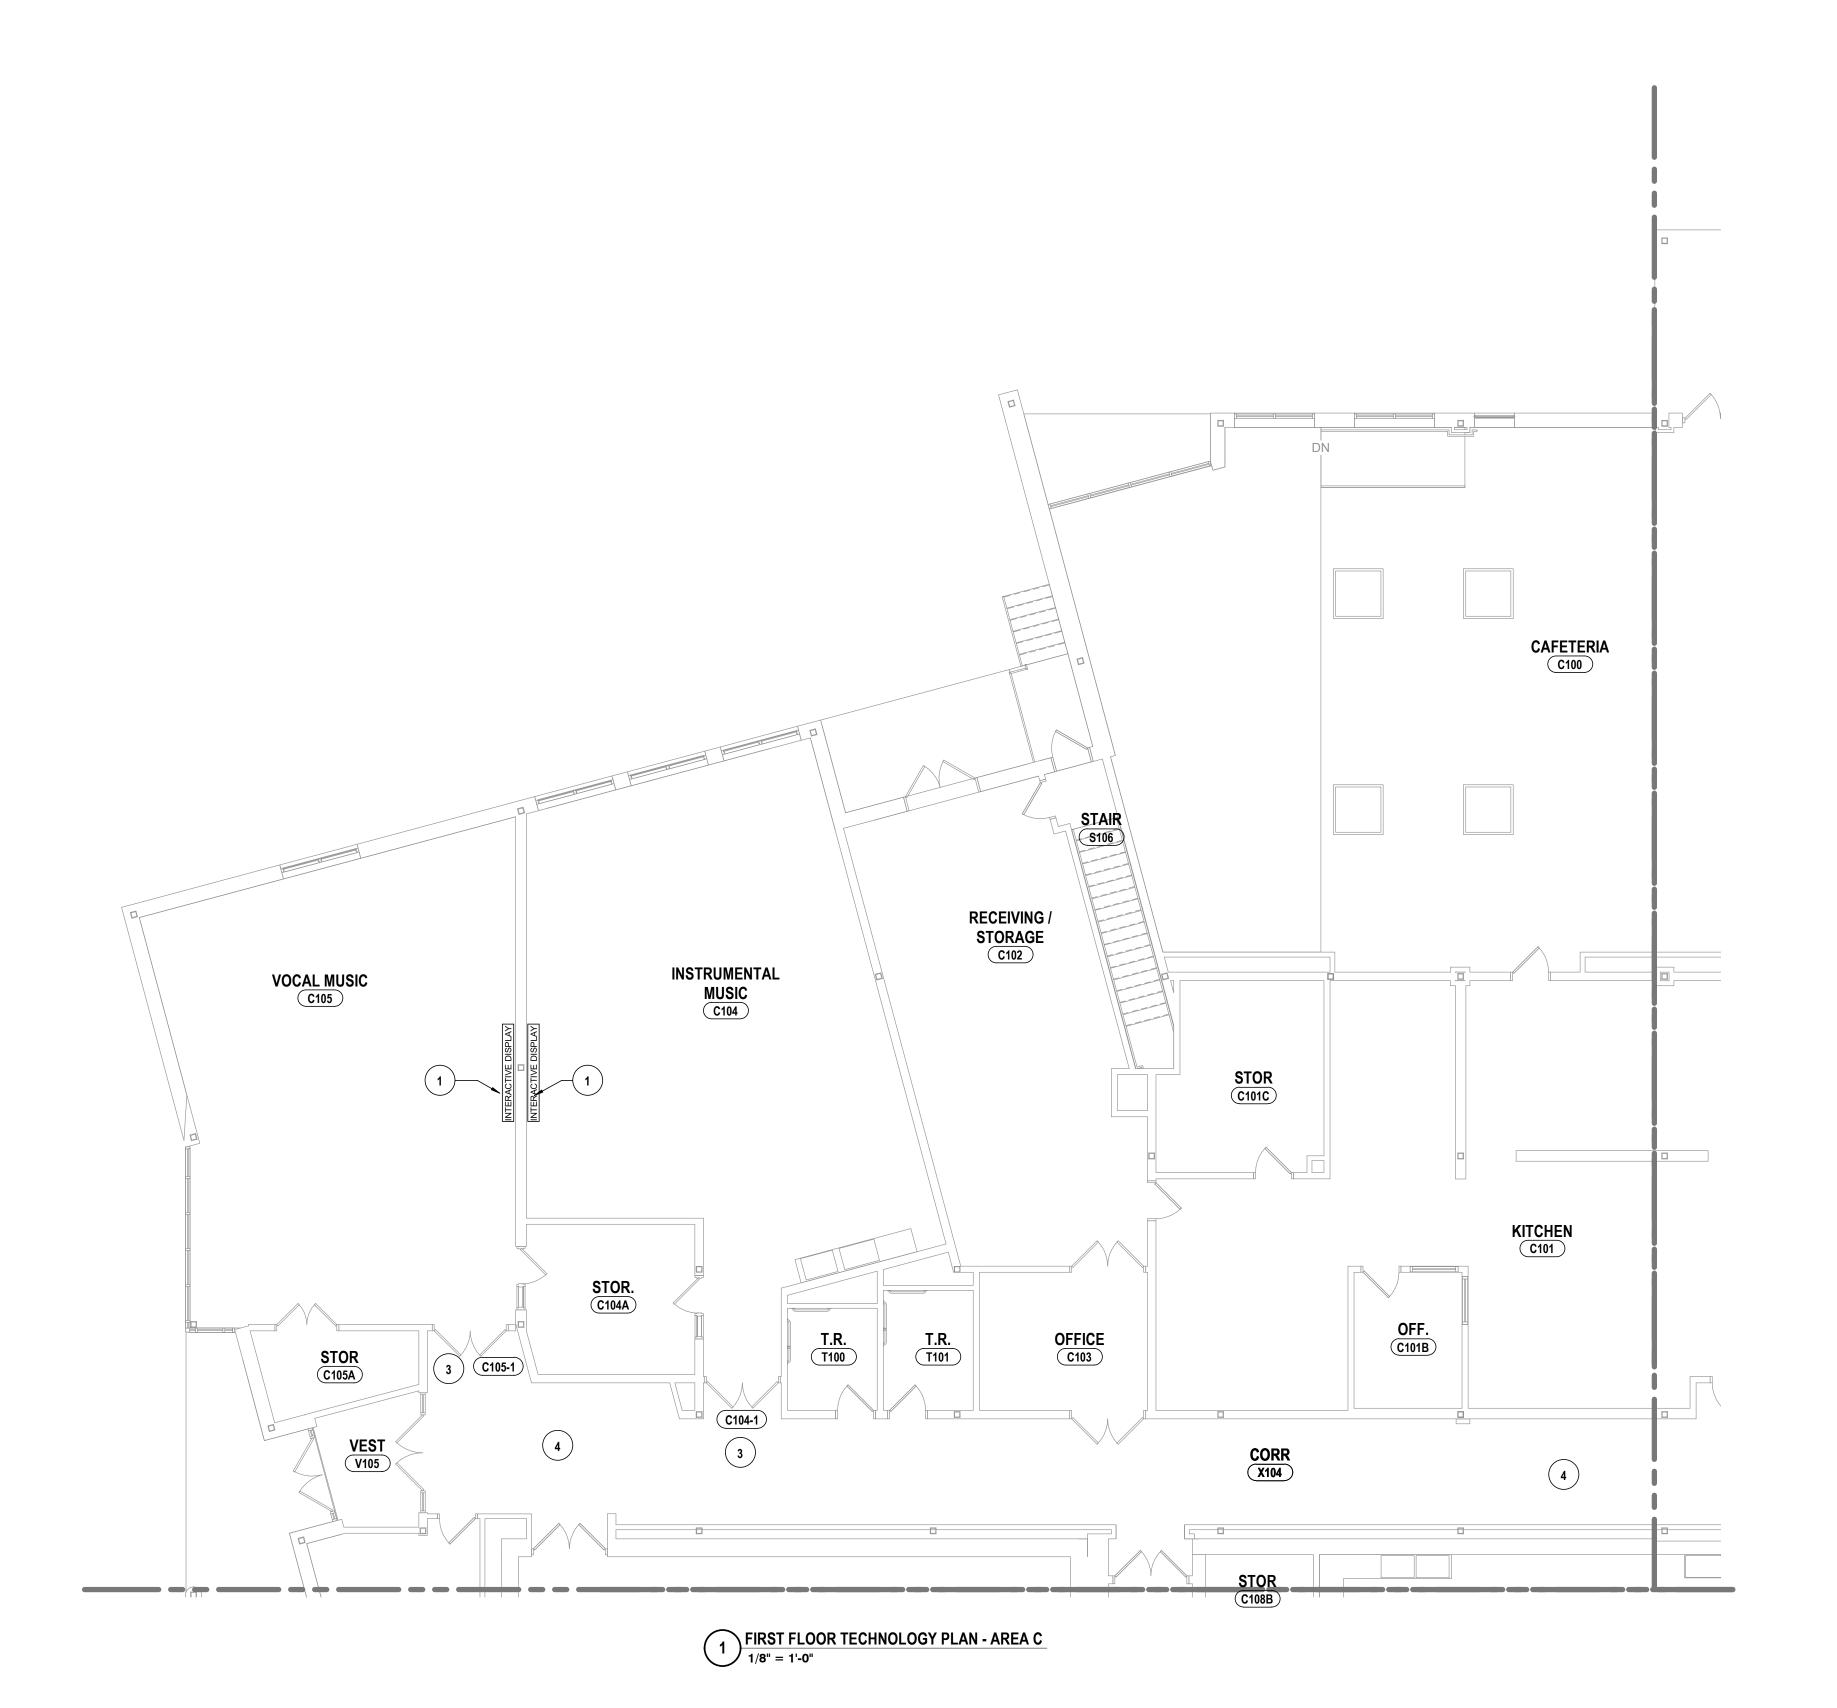
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ENGINEERS | ARCHITEC

- AREA B COND FLOOR TECHNOLOGY PLAN

BC-T1.4

PROJECT NO: 2012-233



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> S ARCHITEC ENGINEERS |


- AREA C

FIRST FLOOR TECHNOLOGY PLAN

LS 2023 RE DISTRICT

BC-T1.5


PROJECT NO: 2012-233

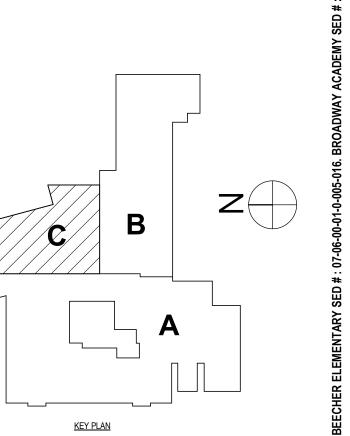

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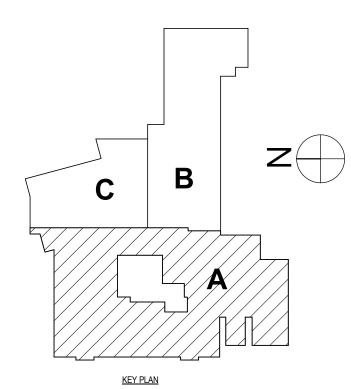
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SECOND FLOOR TECHNOLOGY PLAN - AREA A

1/8" = 1'-0"

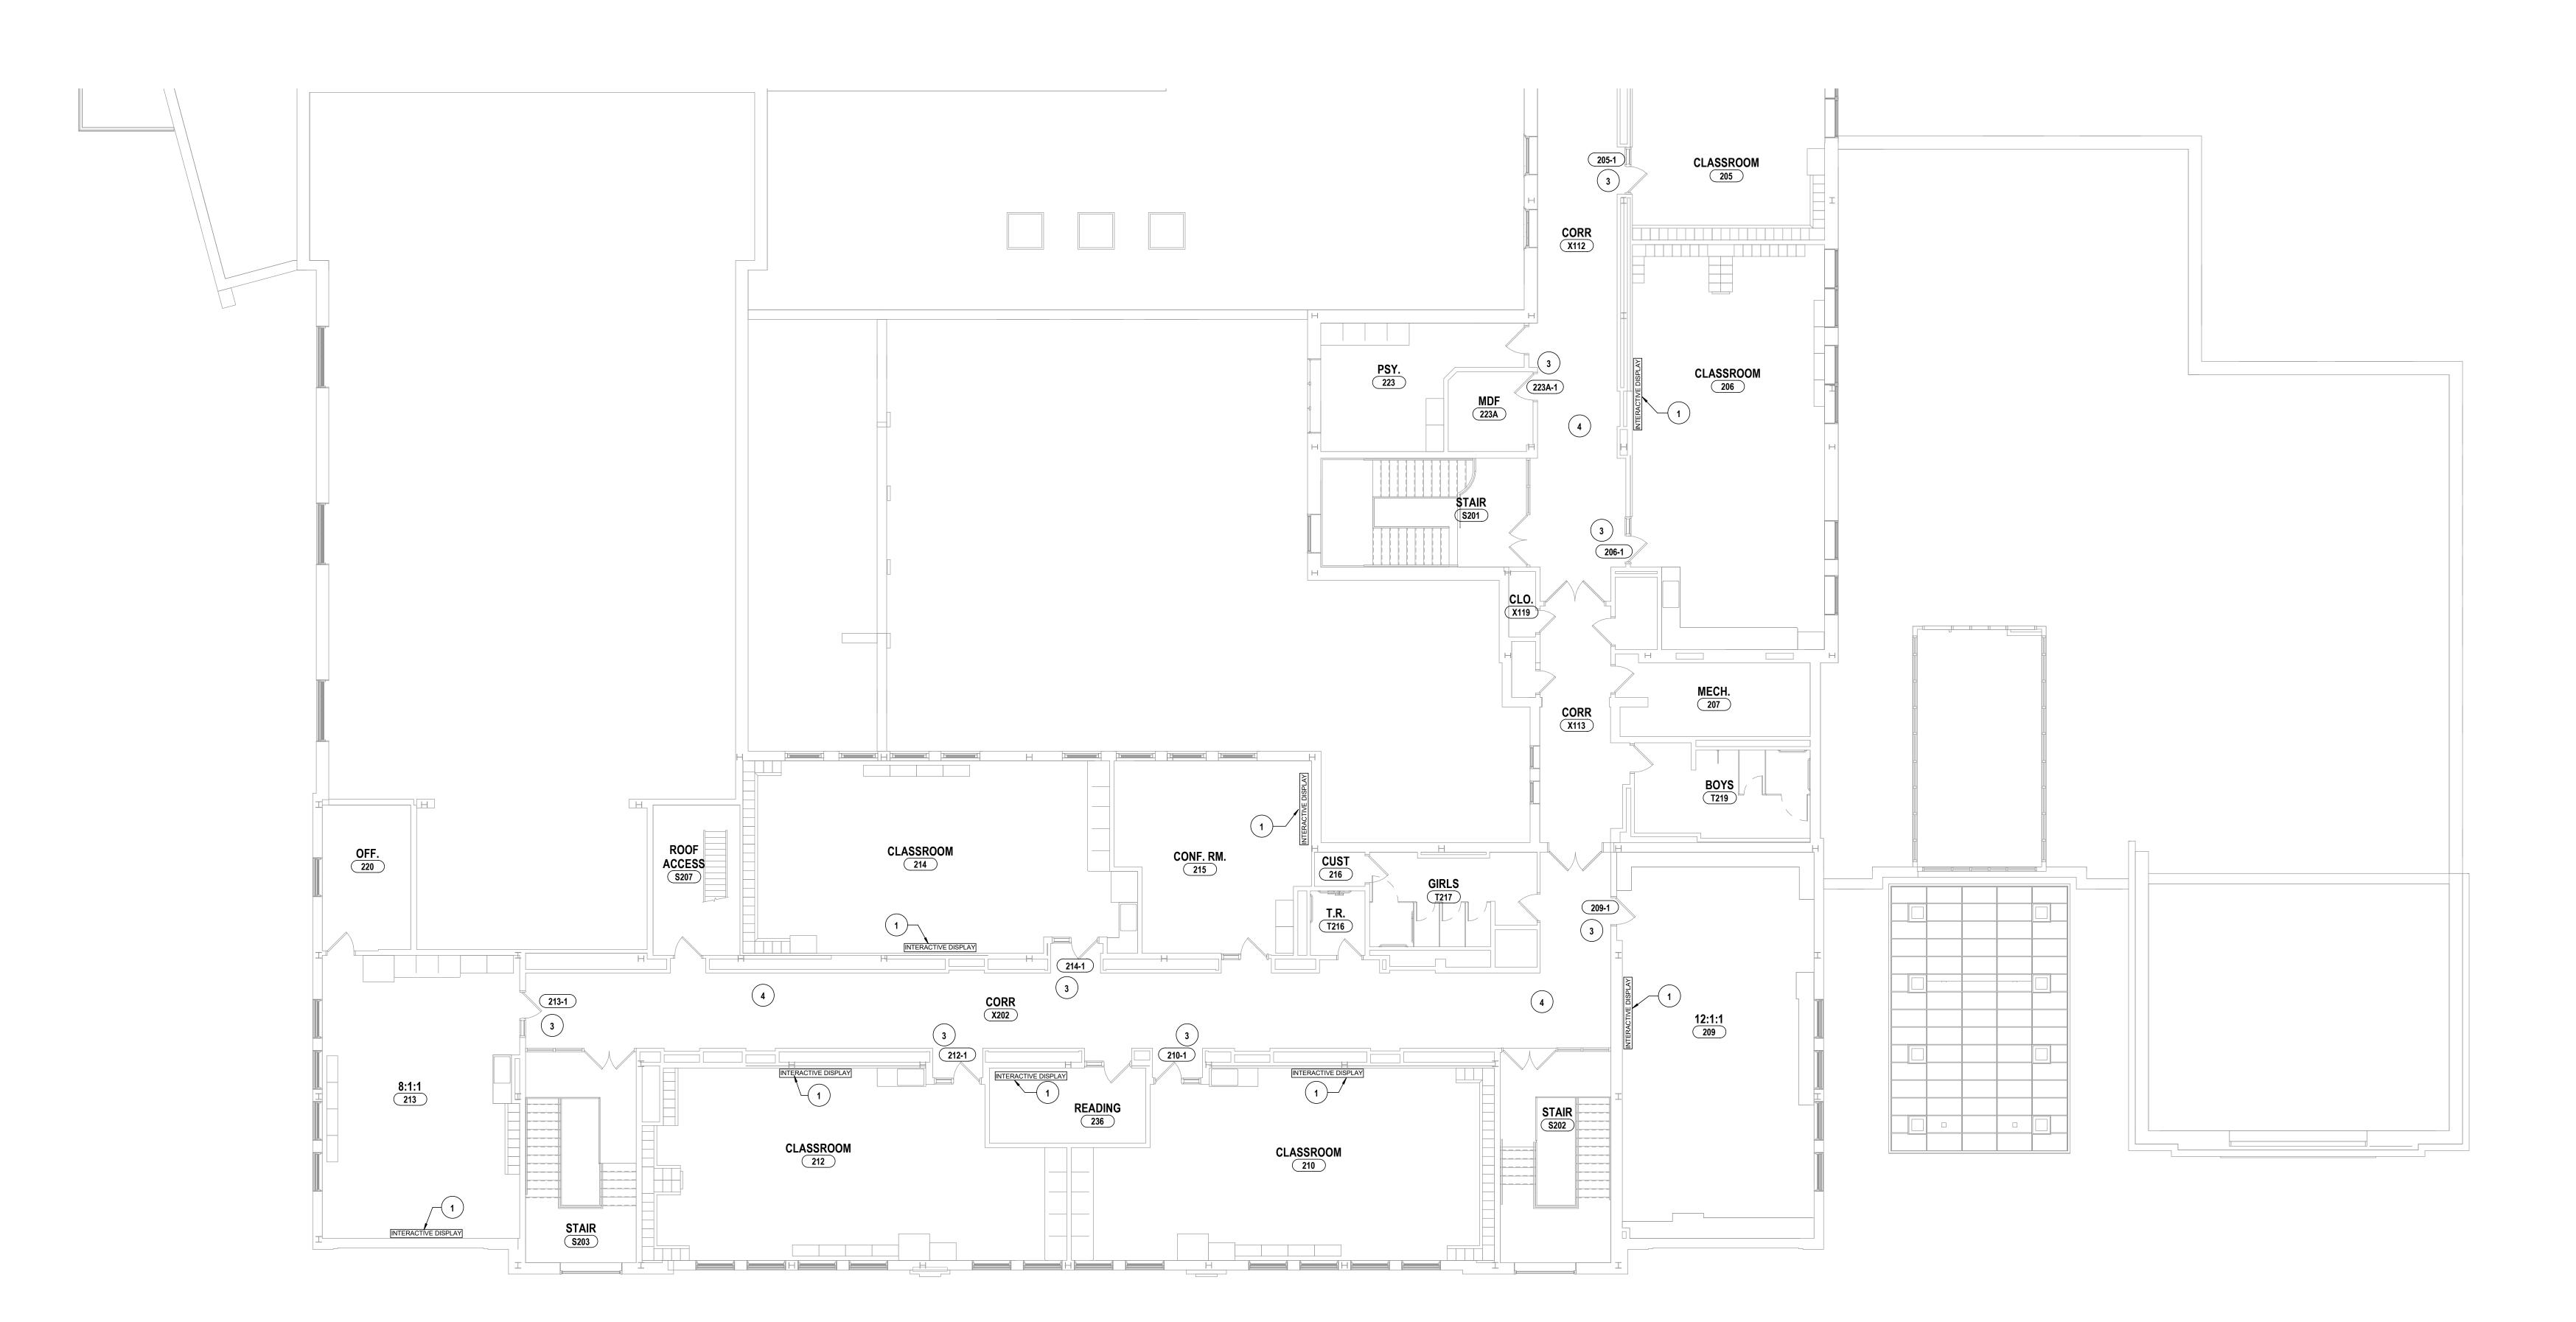



DRAWN BY: CSH CHECKED BY: 10/21/2022 1/8" = 1'-0"


> S ENGINEERS | ARCHITEC


- AREA A


BC-T1.6 PROJECT NO: 2012-233

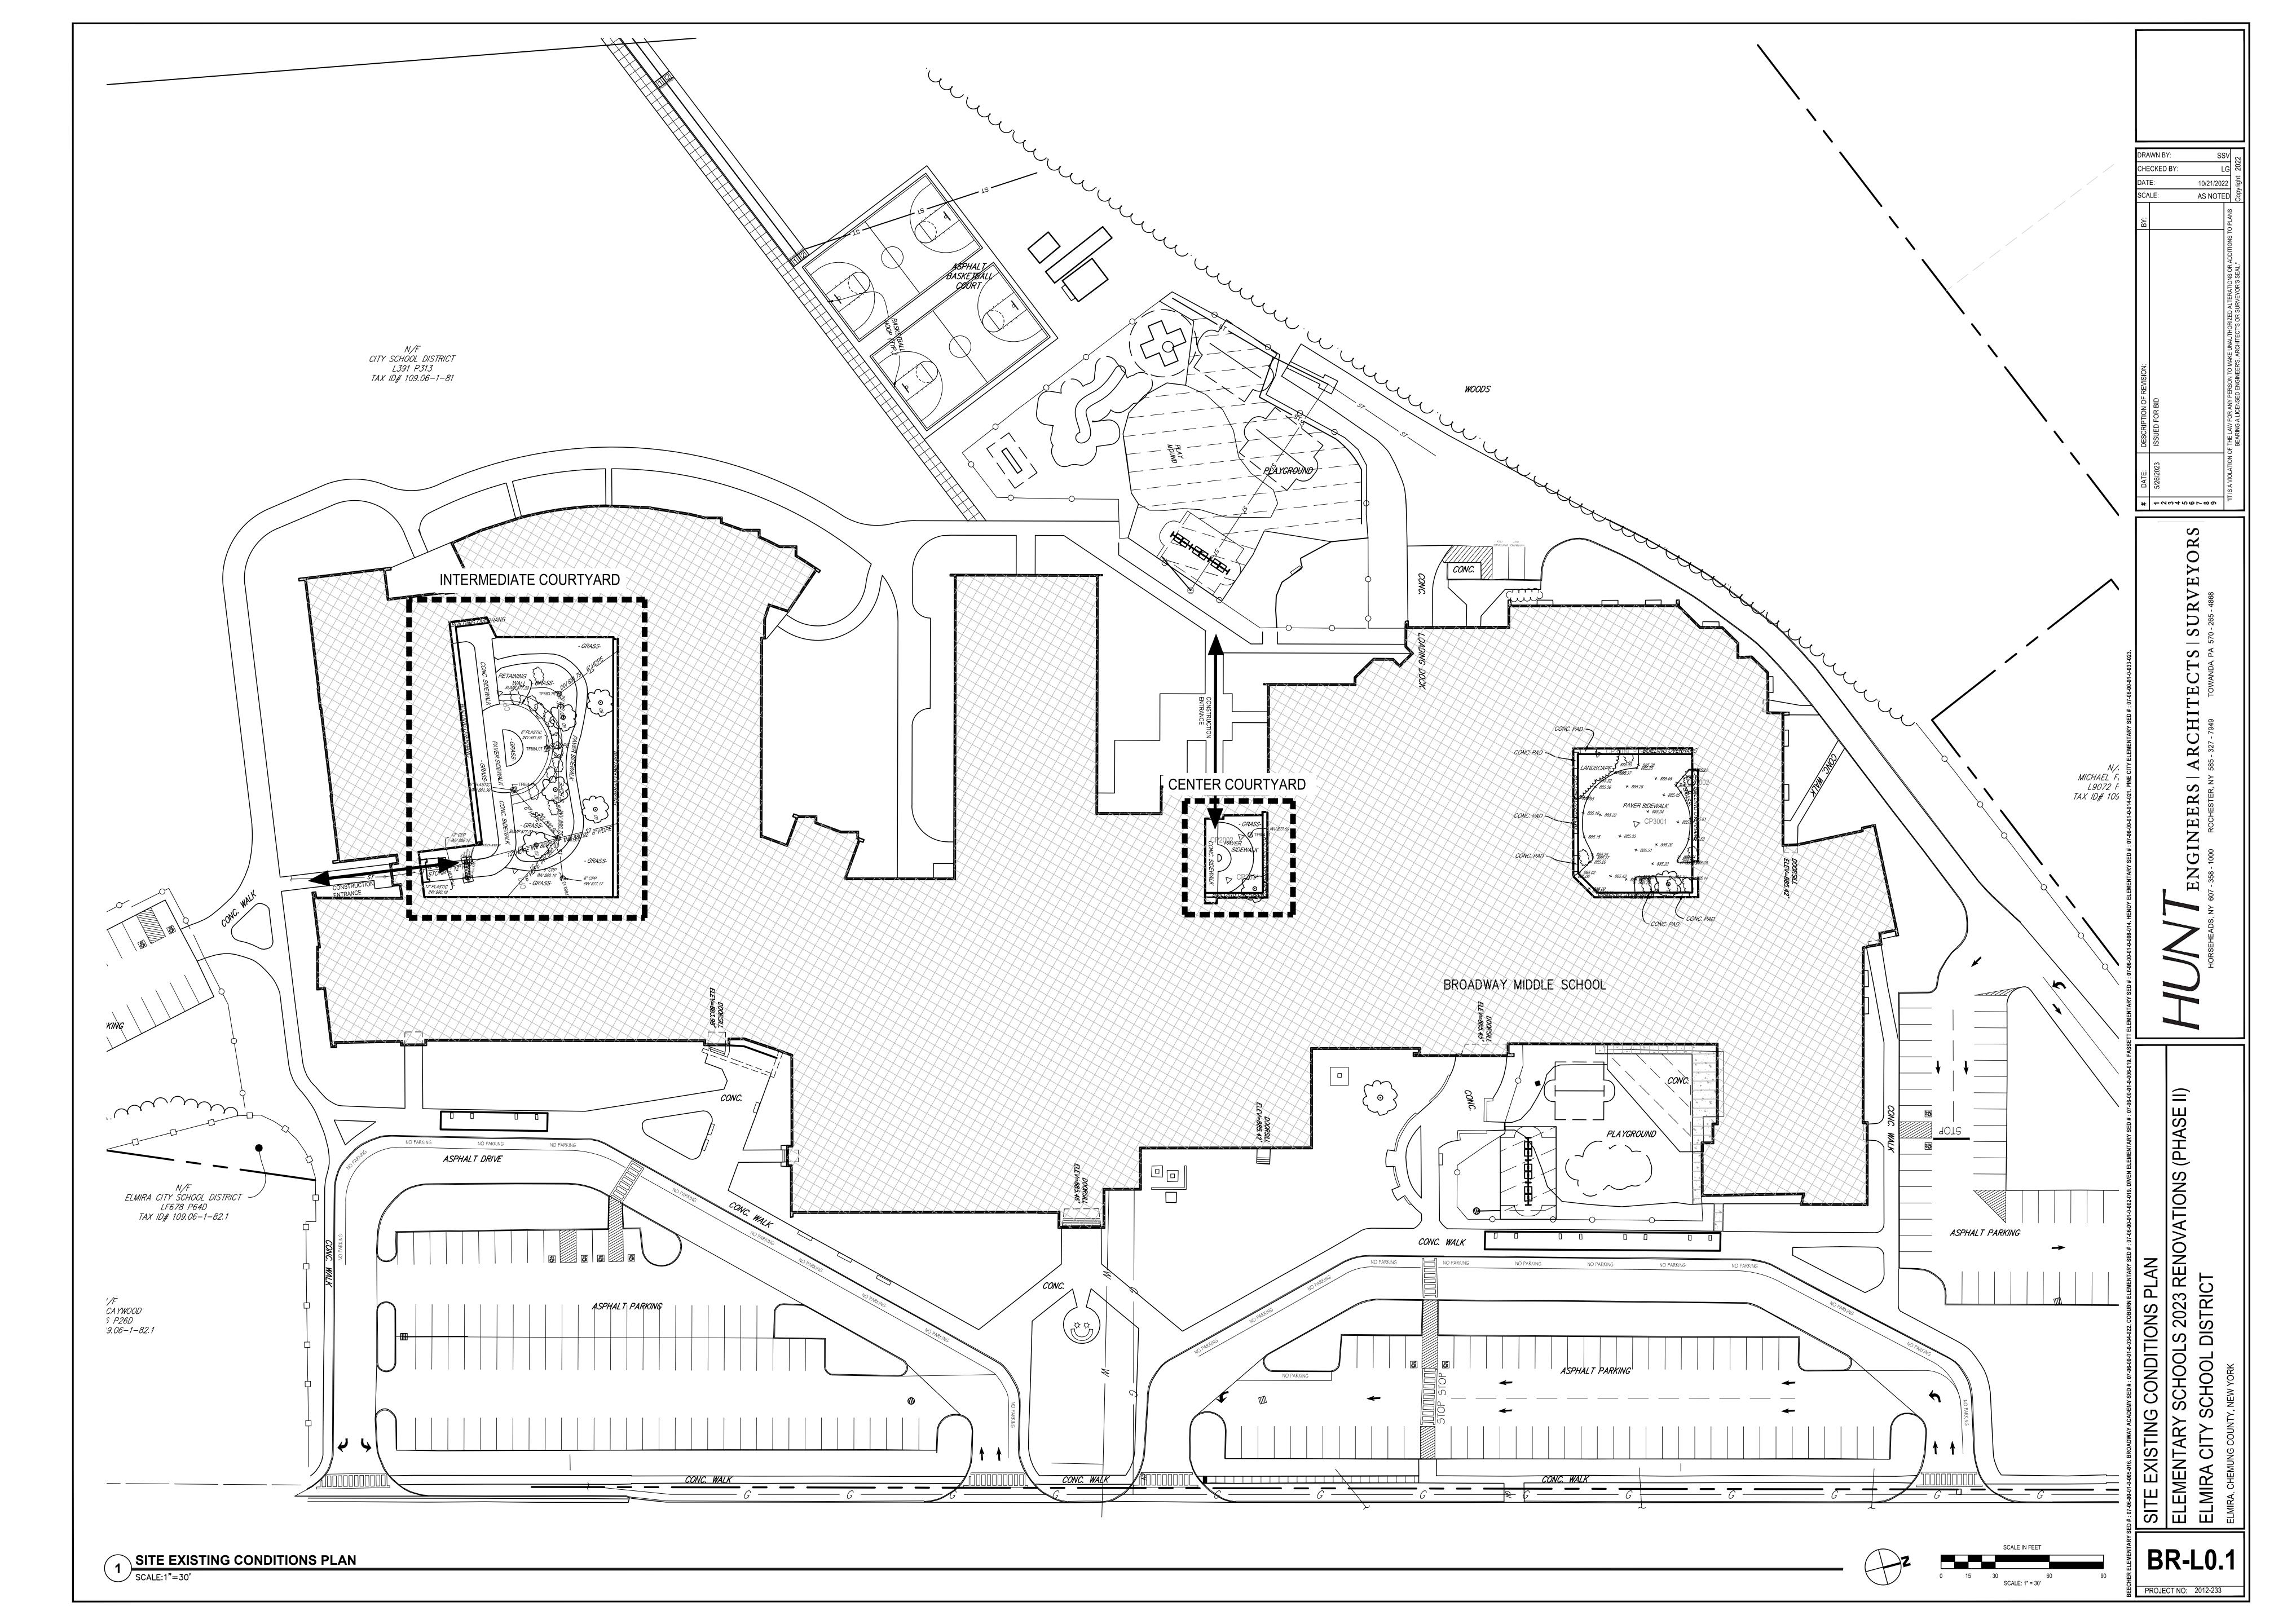

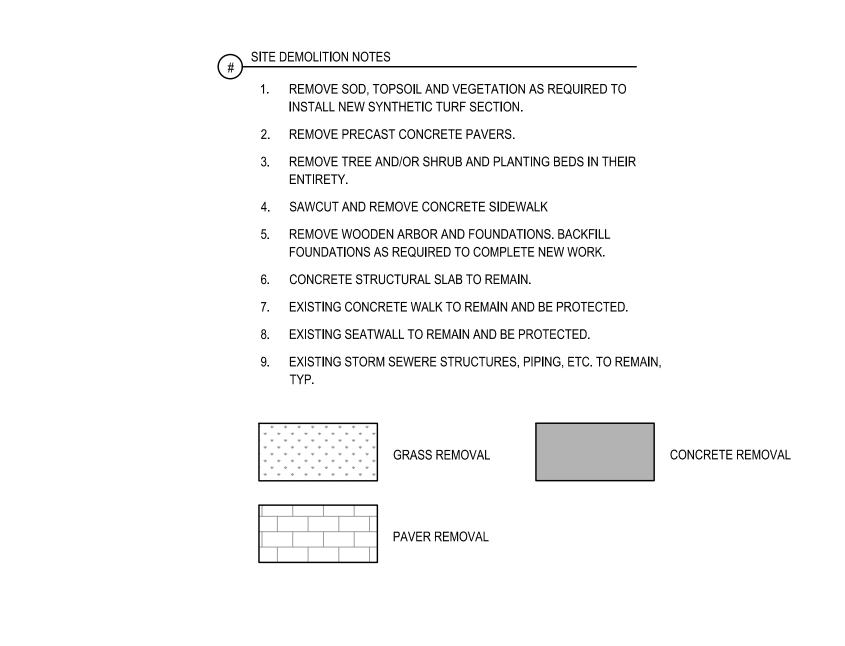


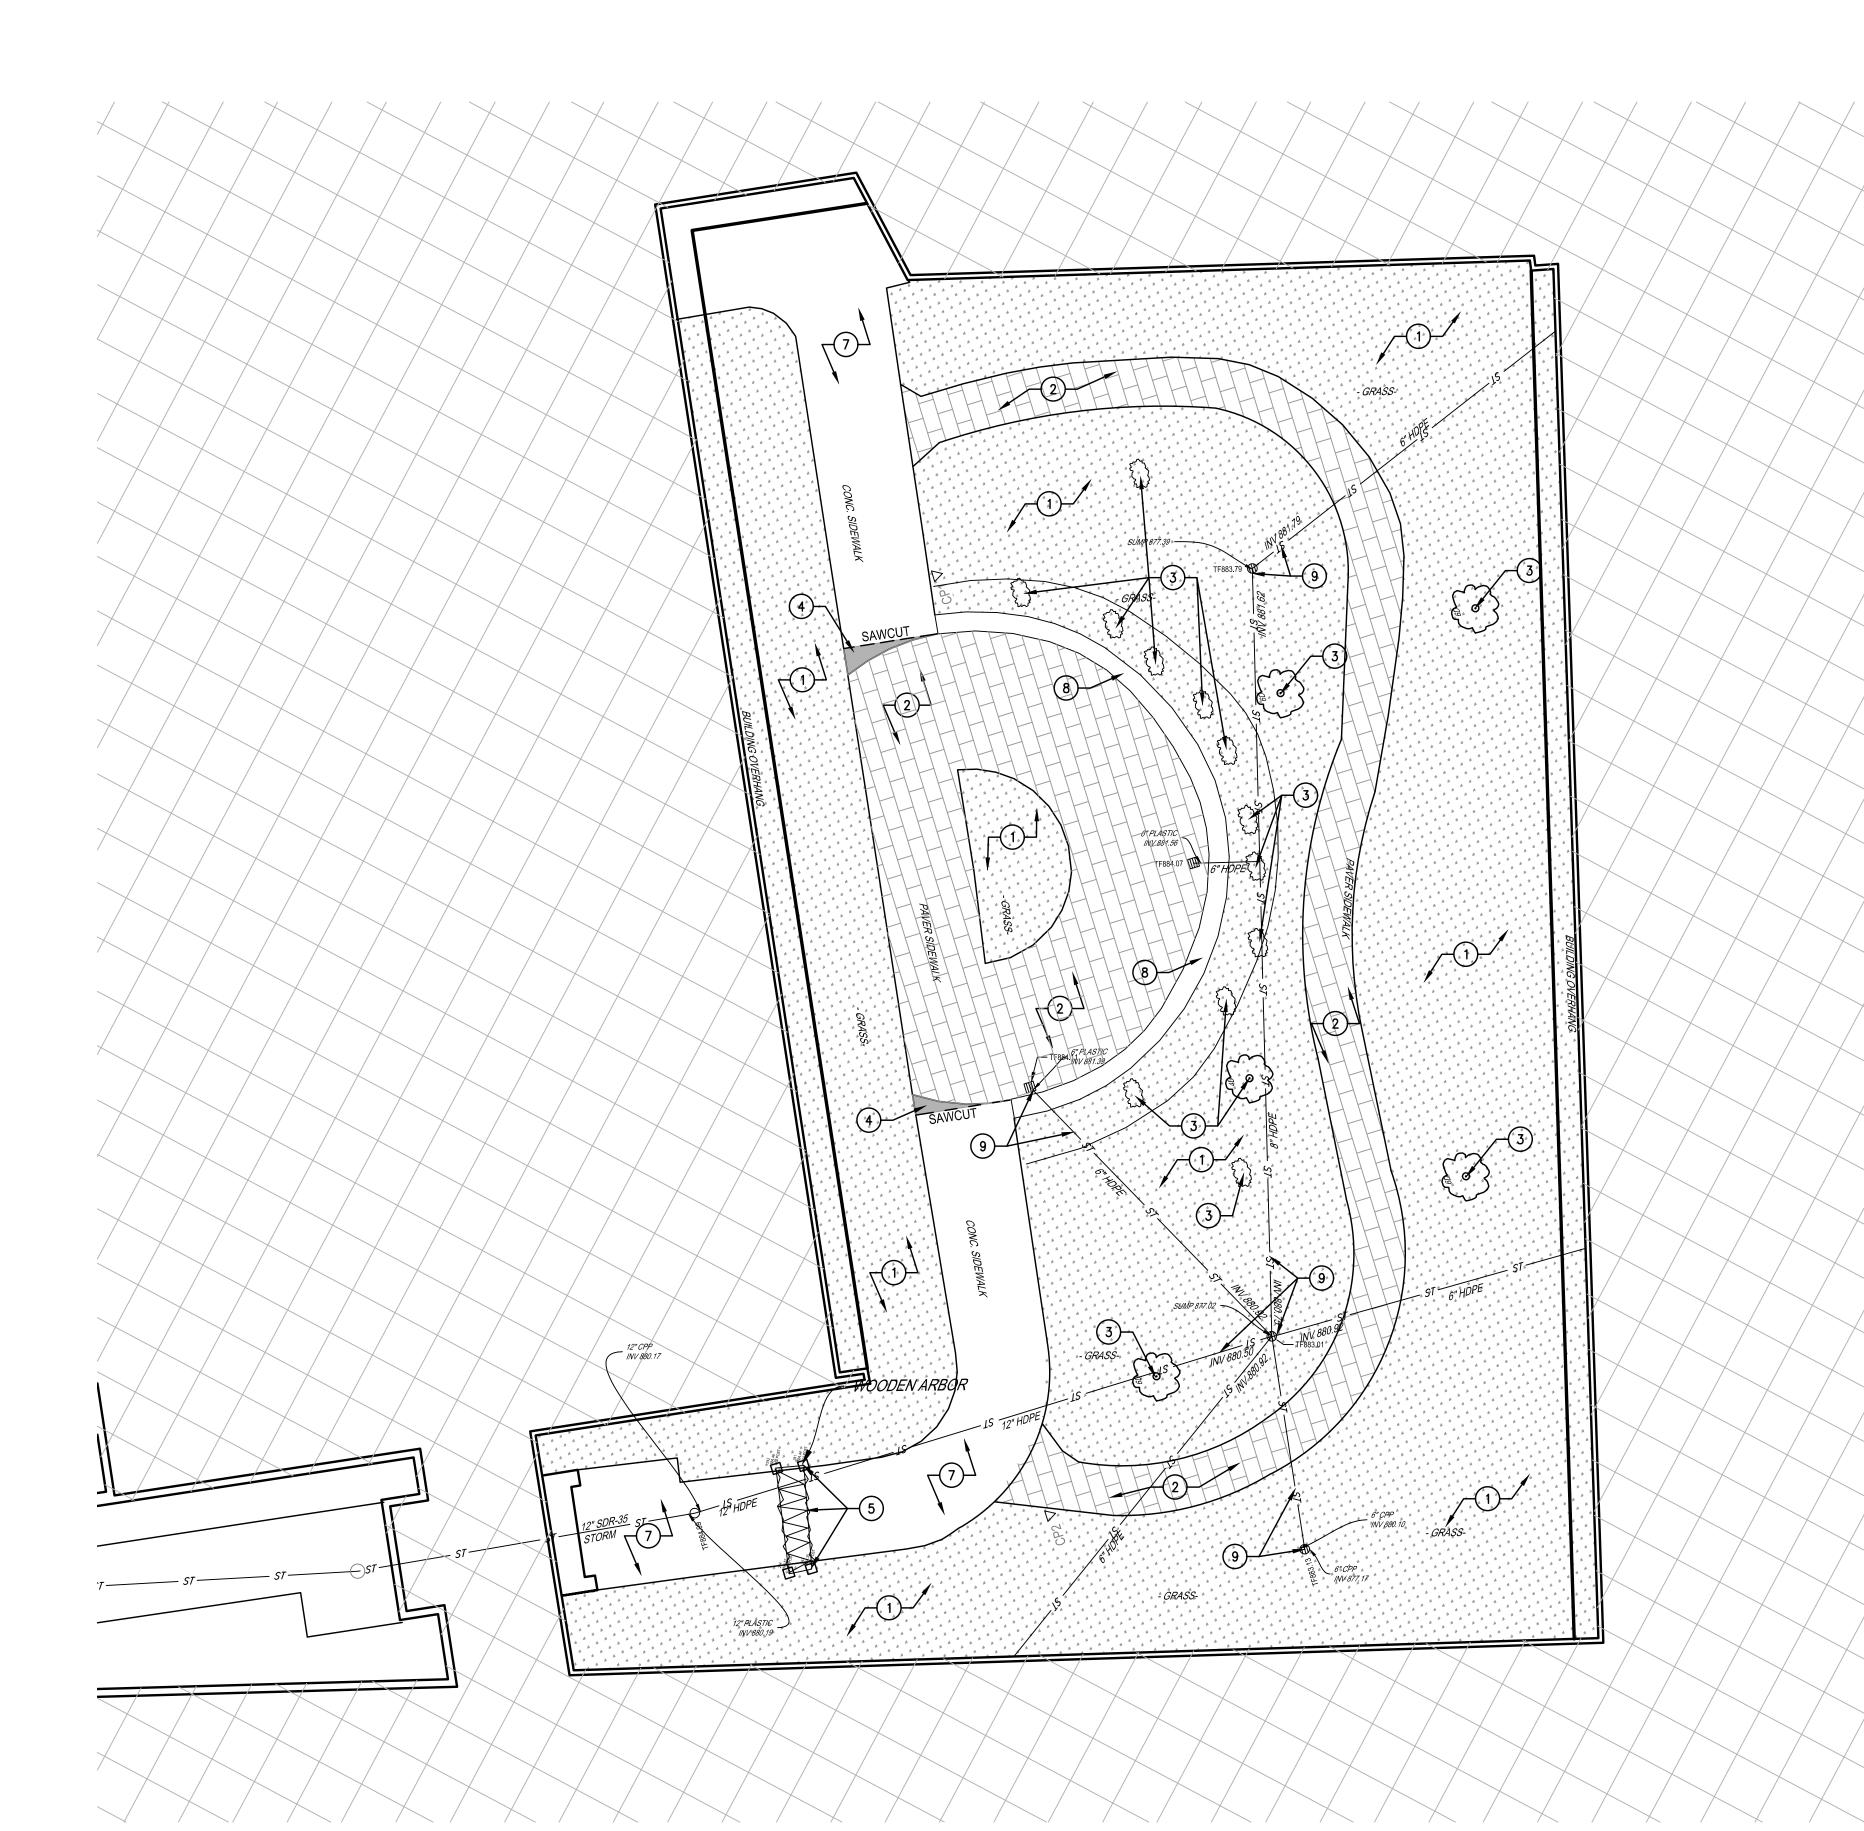

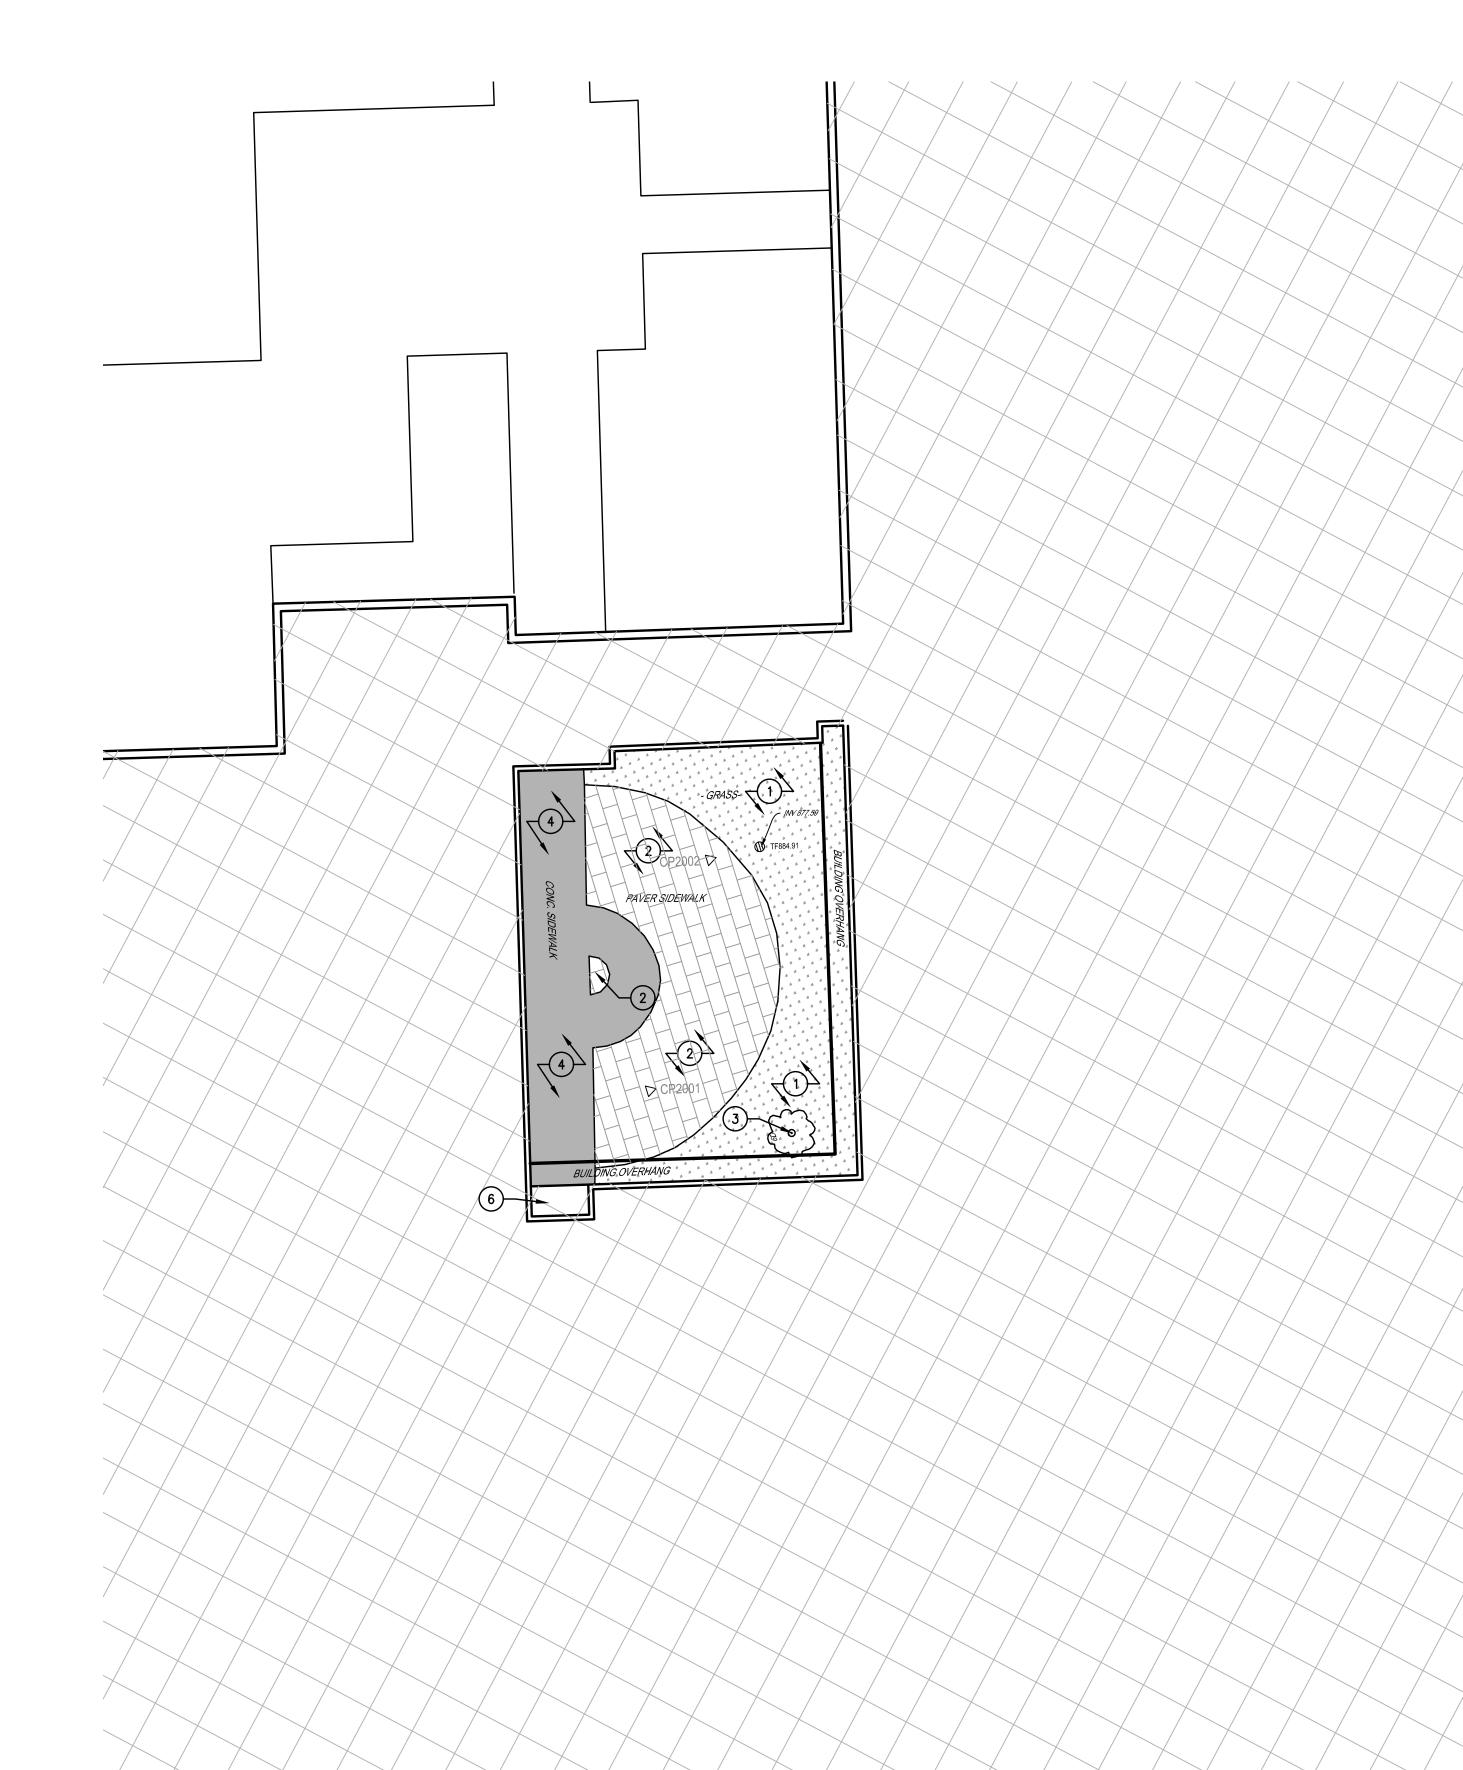

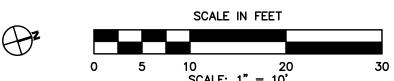



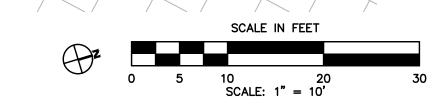

SITE DEMOLITION PLAN

SITE DEMOLITION PLAN

ELEMENTARY SCHOOLS 2023 RENOVAT

ELMIRA CITY SCHOOL DISTRICT

ELMIRA, CHEMUNG COUNTY, NEW YORK

CHECKED BY:

-264469786

S


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LG 8

10/21/2022 5 AS NOTED 6

BR-L1.1

PROJECT NO: 2012-233

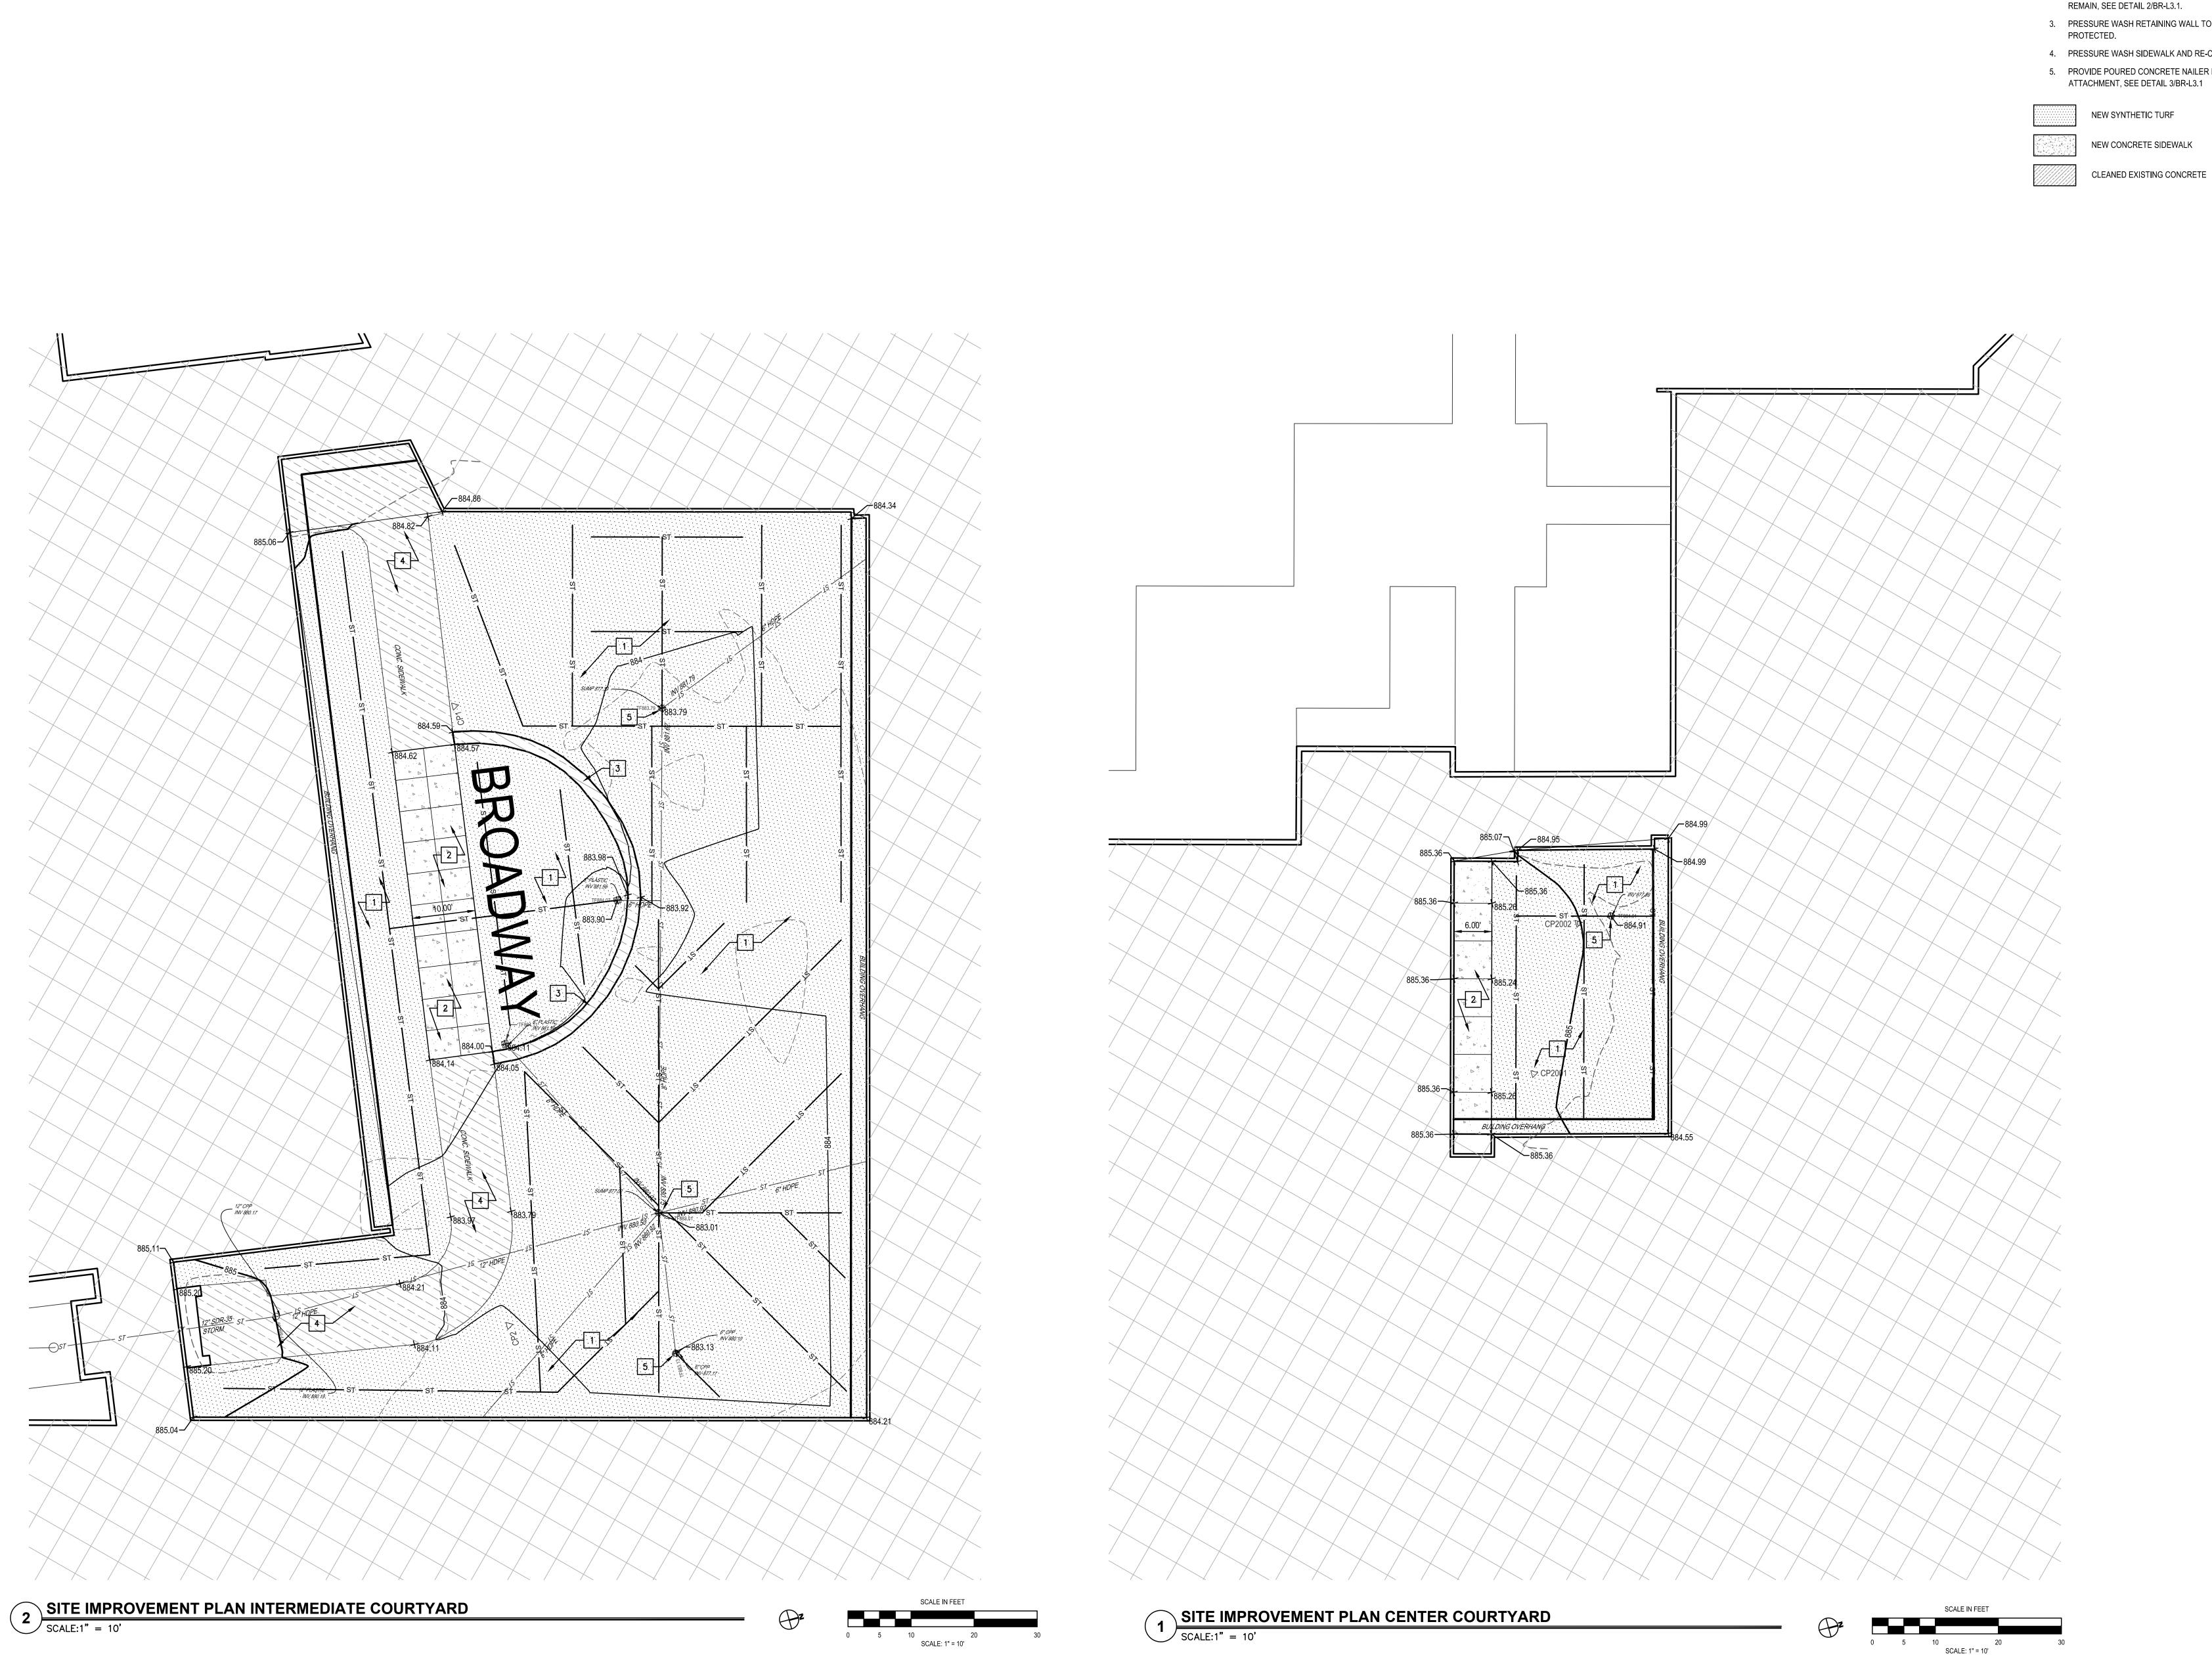

SITE IMPROVEMENT NOTES


- 1. PROVIDE SYNTHETIC TURF SYSTEM INCLUDING STONE BASE AND FLAT PANEL DRAINAGE. PROVIDE NAILER WHERE TURF MEETS CONCRETE OR BUILDING FOUNDATION, SEE DETAIL 1/BR-L3.1. PROVIDE "BROADWAY" TURF LOGO, 6' HEIGHT LETTERING, AERIAL FONT, WHITE.
- 2. PROVIDE 5" THICK FIBER REINFORCED CONCRETE SIDEWALK, MATCH EXISTING SCORE JOINT LAYOUT FROM CONCRETE WALK TO
- 3. PRESSURE WASH RETAINING WALL TO REMAIN AND BE
- 4. PRESSURE WASH SIDEWALK AND RE-CAULK JOINTS.
- 5. PROVIDE POURED CONCRETE NAILER RING FOR SYNTHETIC TURF

CLEANED EXISTING CONCRETE

CHECKED BY: LG 8 10/21/2022 AS NOTED # -264496

SITE IMPROVEMENT PLAN
ELEMENTARY SCHOOLS 202
ELMIRA, CHEMUNG COLINTY NITHERS
ELMIRA, CHEMUNG COLINTY NITHERS

BR-L2.1

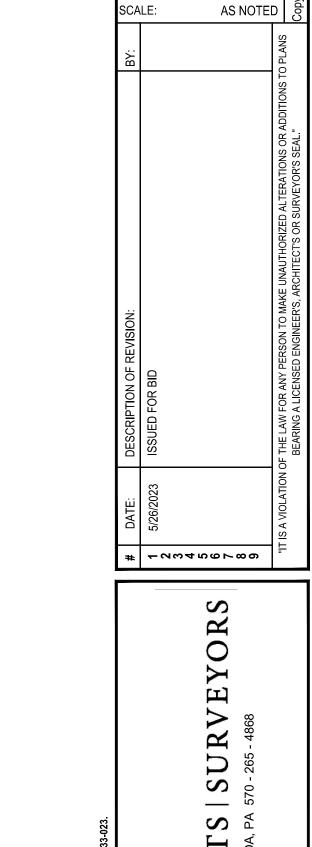

— ≥

--- EXISTING STRUCTURE

SYNTHETIC TURF NAILER AT EXISTING DRYWELL


SYNTHETIC TURF & INFILL, — SEE SEPARATE DETAIL


FRAME & GRATE SYRACUSE
CASTING 2379 NEENAH FOUNDRY R-4820 OR APPROVED EQUAL, PROVIDE PLAYGROUND RUBBER

DRAINAGE MANHOLE COVER

STEEL NAIL CONNECTION FOR SYNTHETIC TURF, TYP.

POURED IN PLACE

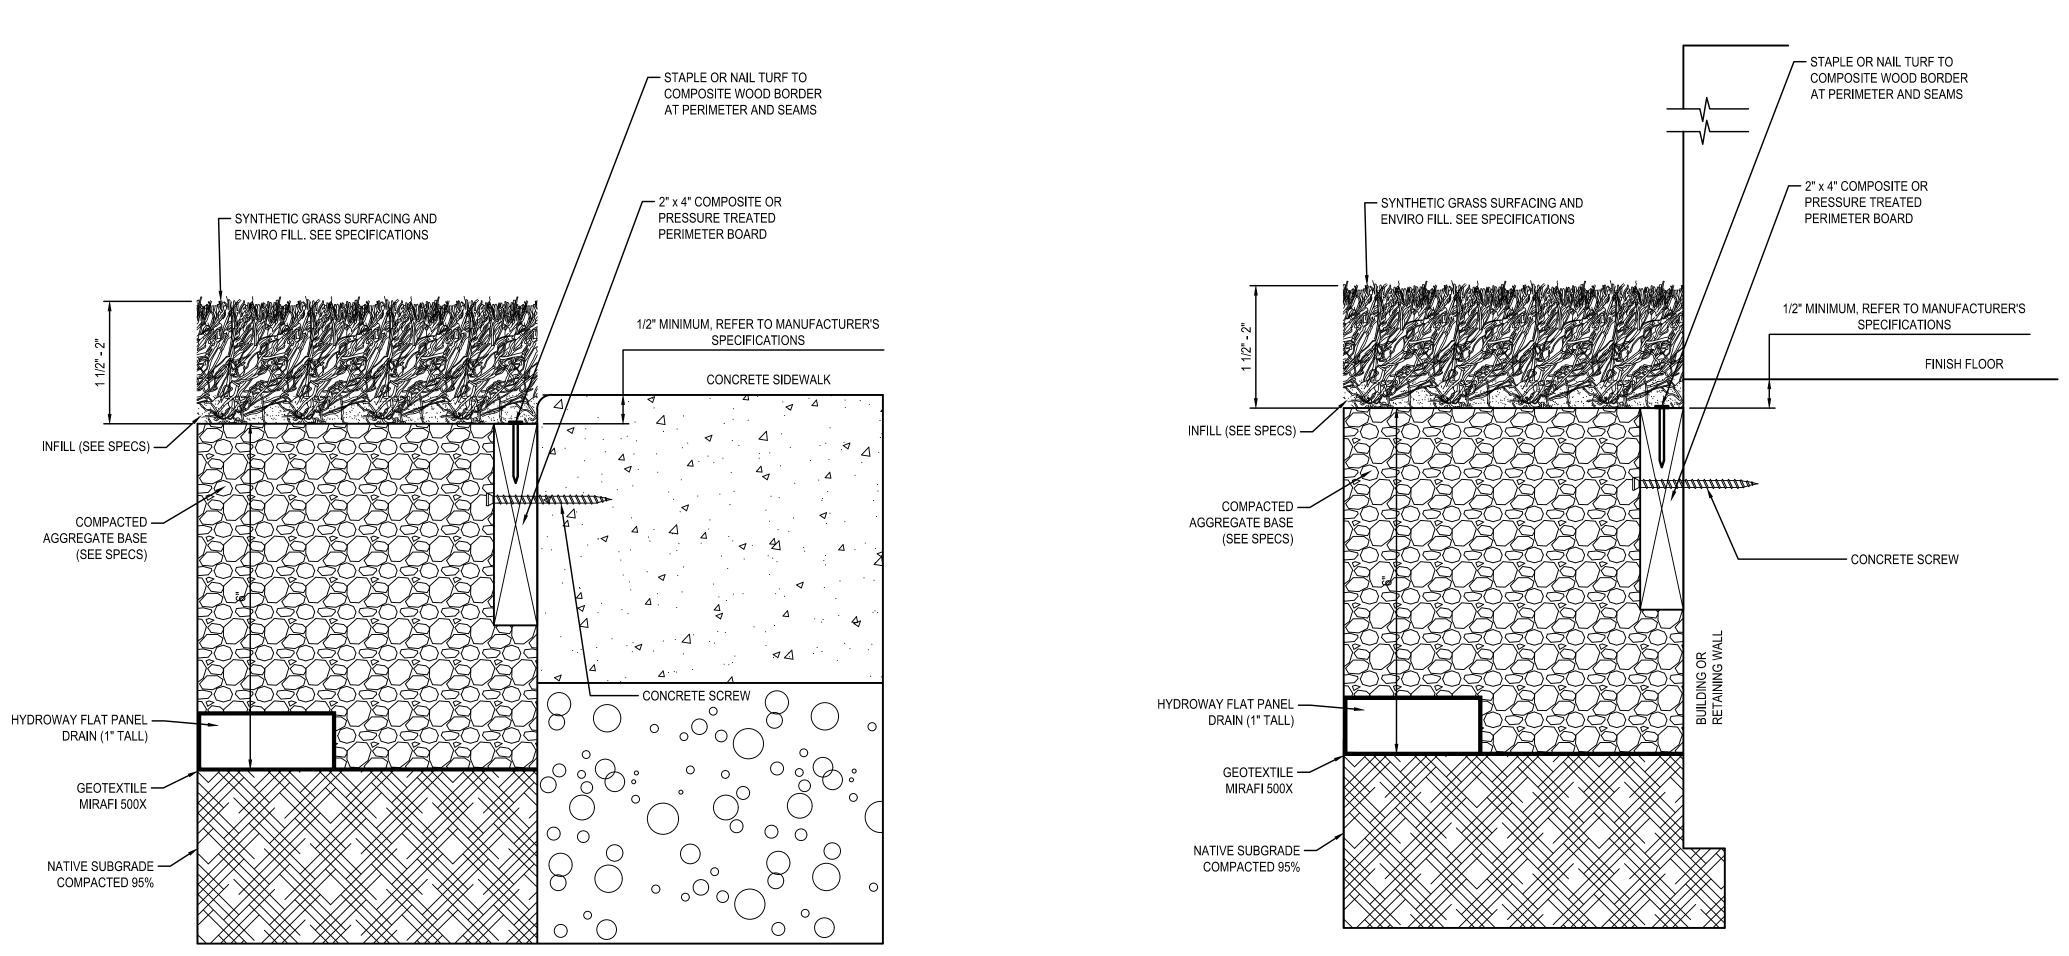


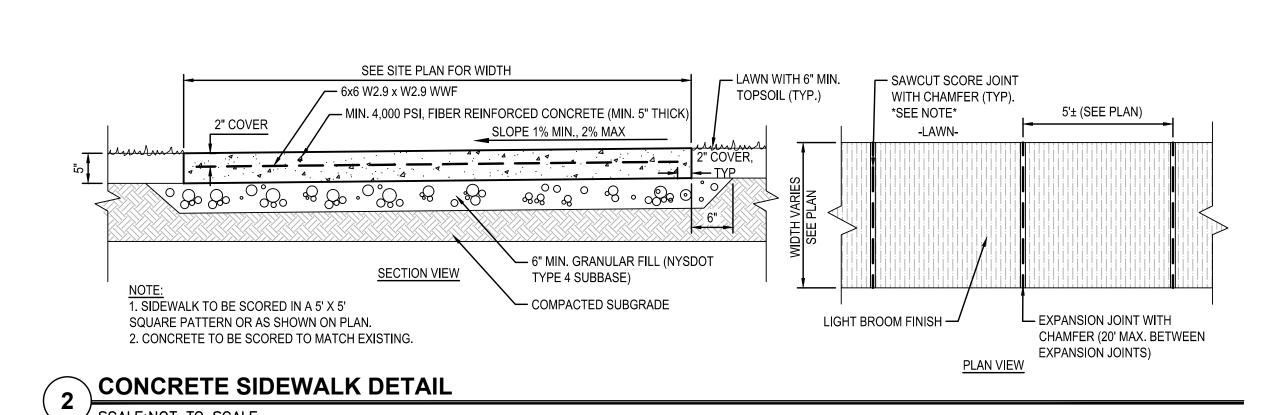

LANDSCAPE SYNTHETIC TURF WITH NAILER

BR-L3.1

SITE DETAILS
ELEMENTARY
ELMIRA CITY S

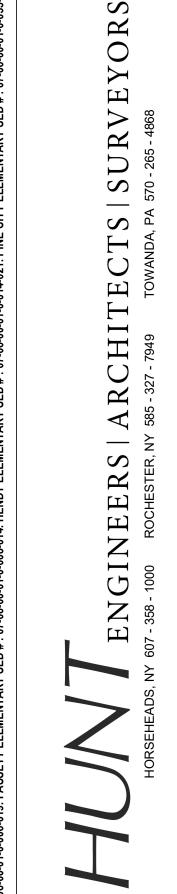

CHECKED BY: 10/21/2022 SCALE: 1" = 30'-0"

DRAWN BY:

S 2023 RENOVATIONS (PHASE DISTRICT **KEY PLANS**

BR-A1.0 PROJECT NO: 2012-233

KEY PLAN

D1

E1/

E2

1 FIRST FLOOR KEY PLAN
1" = 30'-0"

TECHNOLOGY C105 1090 SF 12:1 SPECIAL EDUCATION (A118) 863 SF MODULAR CLASSROOM C110 762 SF SEC. CLASSROOM B102 905 SF ELEM. EDUCATION (A112) 869 SF CORR 109 TR (C104) VEST CORRIDOR (V103) (116) SCIENCE CLASSROOM (B101) 1156 SF ELEM. CLASSROOM A119 876 SF HEALTH CLASSROOM C103 755 SF CAFETERIA (C111) 4121 SF FACULTY WORK ROOM (B100) 691 SF PARTITION TR POCKET E113e CLO 134 E136 SCIENCE CLASSROOM (A110) 1225 SF GREEN HOUSE (A107a) 396 SF CORR 101 341 SF

TR

TR

D1000

EXAM
D1000

99 SF

78 SF

OFF.
O1000

97 SF

OFF.
O1000

97 SF

ASST. PRINC.
D1000

135 SF SPECIAL ED 12:1:1 CLASSROOM (A101) 789 SF SPECIAL ED 8:1:1 CLASSROOM (A100) 787 SF SEC. CLASSROOM (A102) 789 SF SCIENCE CLASSROOM (A107) 1125 SF OFFICE AP SRO COUNS.

[E110e] (E110f) (E110g) (E110h)

189 SF 143 SF 219 SF 216 SF VEST. (V104) 366 SF OPEN OFFICE (E110) 1169 SF MIDDLE SCHOOL GYM (D106) 7761 SF AUDITORIUM (D107) 7554 SF STAGE (D107a) 2414 SF ADMIN OPEN
OFFICE
(D100)
1257 SF

COMPUTER CLASSROOM C106 1161 SF

TECHNOLOGY ©106A 1349 SF

HOME AND CAREERS C107 1134 SF

MODULAR CLASSROOM C108 769 SF

INST. MUSIC CLASSROOM B112 1910 SF

P. INST STOR P. (B112r) 154 SF 189 SF 181 SF

SEC. CLASSROOM B103 913 SF

ELEM.
CLASSROOM
(A116)
1075 SF

CORRIDOR 103

ELEM. CLASSROOM (A114) 863 SF

ELEM. CLASSROOM (A113) 863 SF

MUSIC CLASSROOM B114 849 SF

SPECIAL ED CLASSROOM (B116) 556 SF

MUSIC CLASSROOM B115 778 SF

GREEN HOUSE (A206a) 396 SF

CAFETERIA (E100) 3295 SF


COMPUTER CLASSROOM F114 903 SF


B2

/A2/

2 SECOND FLOOR KEY PLAN - AREA A2
1" = 30'-0"

	DOOR SCHEDULE															
#			DOOR	OOOR ASSEMBLY GLAZING HDWR FRAME DETAIL						NOTES						
#	TYPE	SIZE	THICK.	MATL.	FINISH	LABEL	MATL.	MARKING	SET	TYPE	MATL.	FINISH	HEAD	JAMB	SILL	NOIES
102-1	A	PR @ 3' - 6" x 8' - 0"	1 3/4"	AL	ANOD.	-	IG	-	1.0	EXG.	EXG.	EXG.				VIF DIMENSIONS

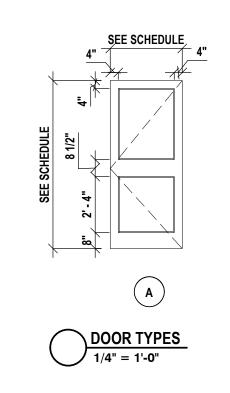

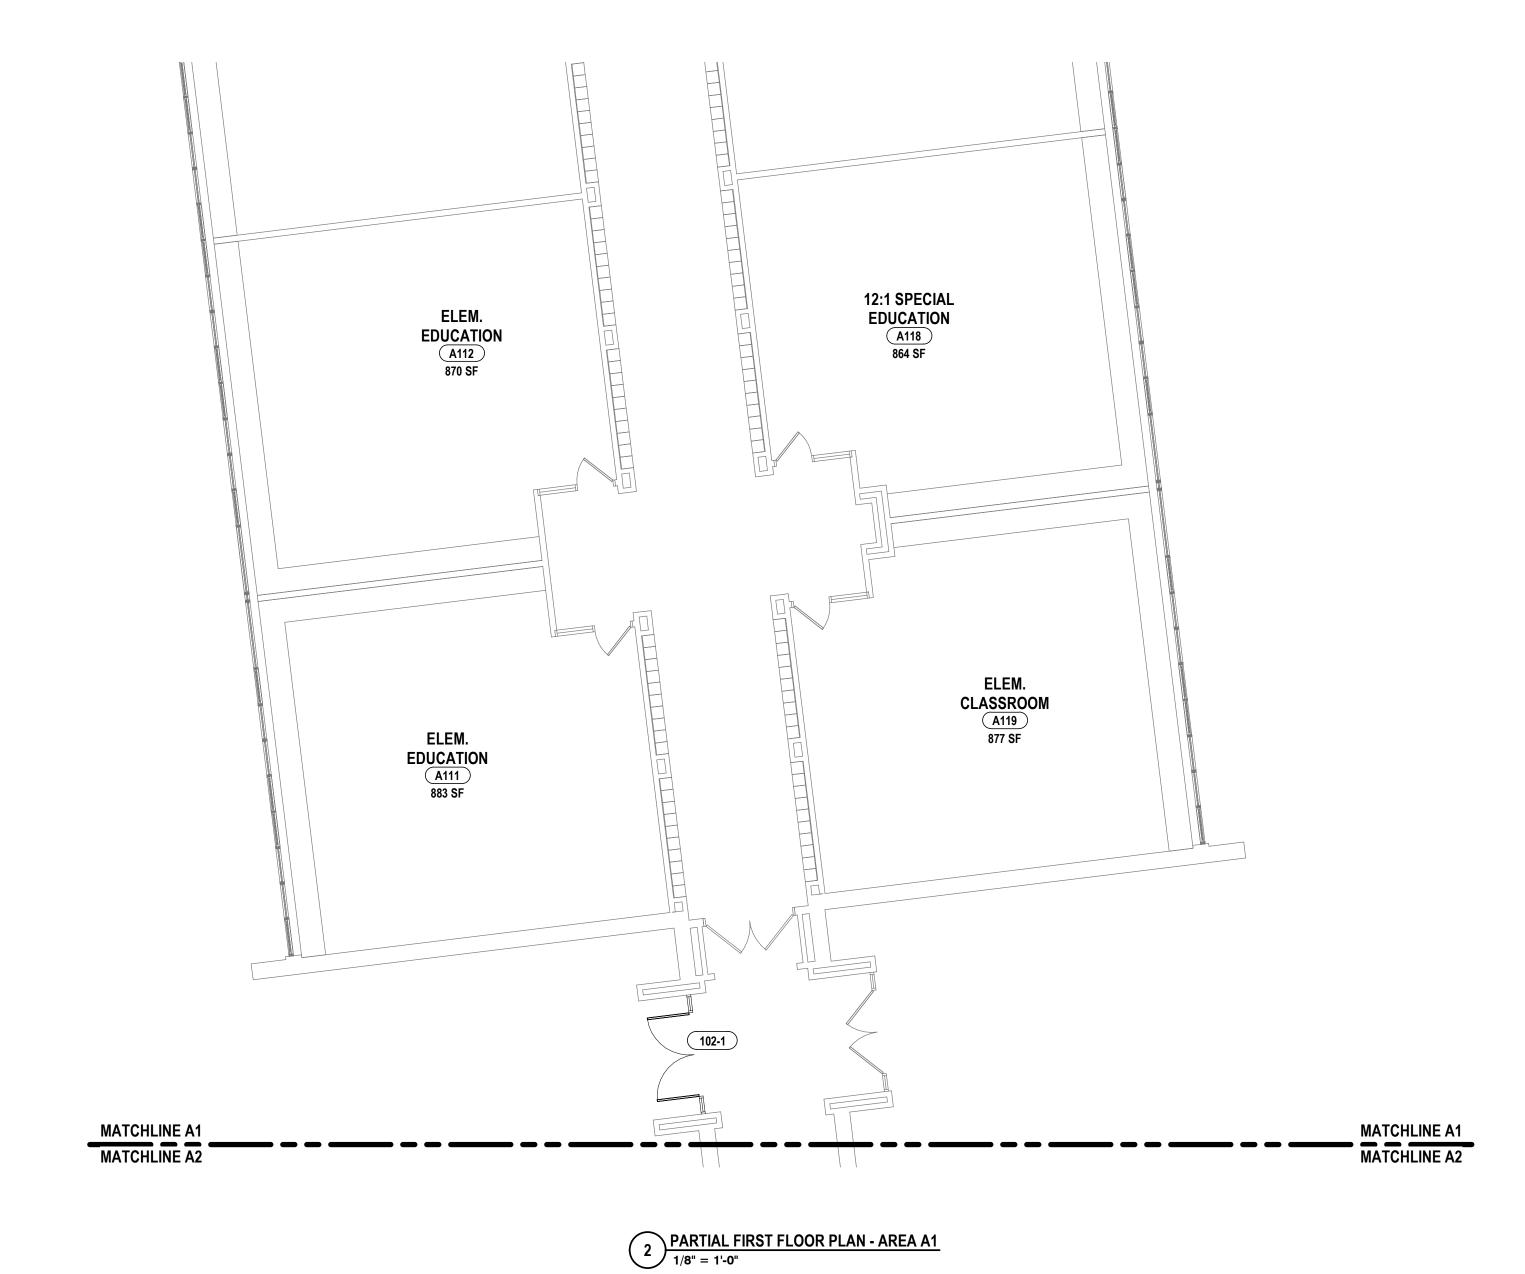

GENERAL NOTES:
REFER TO DRAWING A0.0 FOR GENERAL NOTES.

GENERAL DEMO NOTES:
REFER TO DRAWING A0.0 FOR GENERAL DEMOLITION NOTES.

DEMOLITION NOTES:

D1 REMOVE DOOR AND HARDWARE IN THEIR ENTIRETY TO EXTENTS SHOWN ON PLAN. DOOR FRAME TO REMAIN. REPAIR DAMAGED SURFACES SCHEDULED TO REMAIN IN PLACE TO MATCH EXISTING CONSTRUCTION AND PREPARE SURFACES TO RECEIVE NEW FINISHES.

| ATE: | DESCRIPTION OF REVISION: | BY: |

ENGINEERS | ARCHITECTS | SURVEYORS

PLAN - AREA A1 & DOOR SCHEDULE

S 2023 RENOVATIONS (PHASE II)


ST FL DEMO & NEW PLAN - AREA A1
EMENTARY SCHOOLS 2023 RENOVA
MIRA CITY SCHOOL DISTRICT


E1

D1

KEY PLAN

BR-A1.1

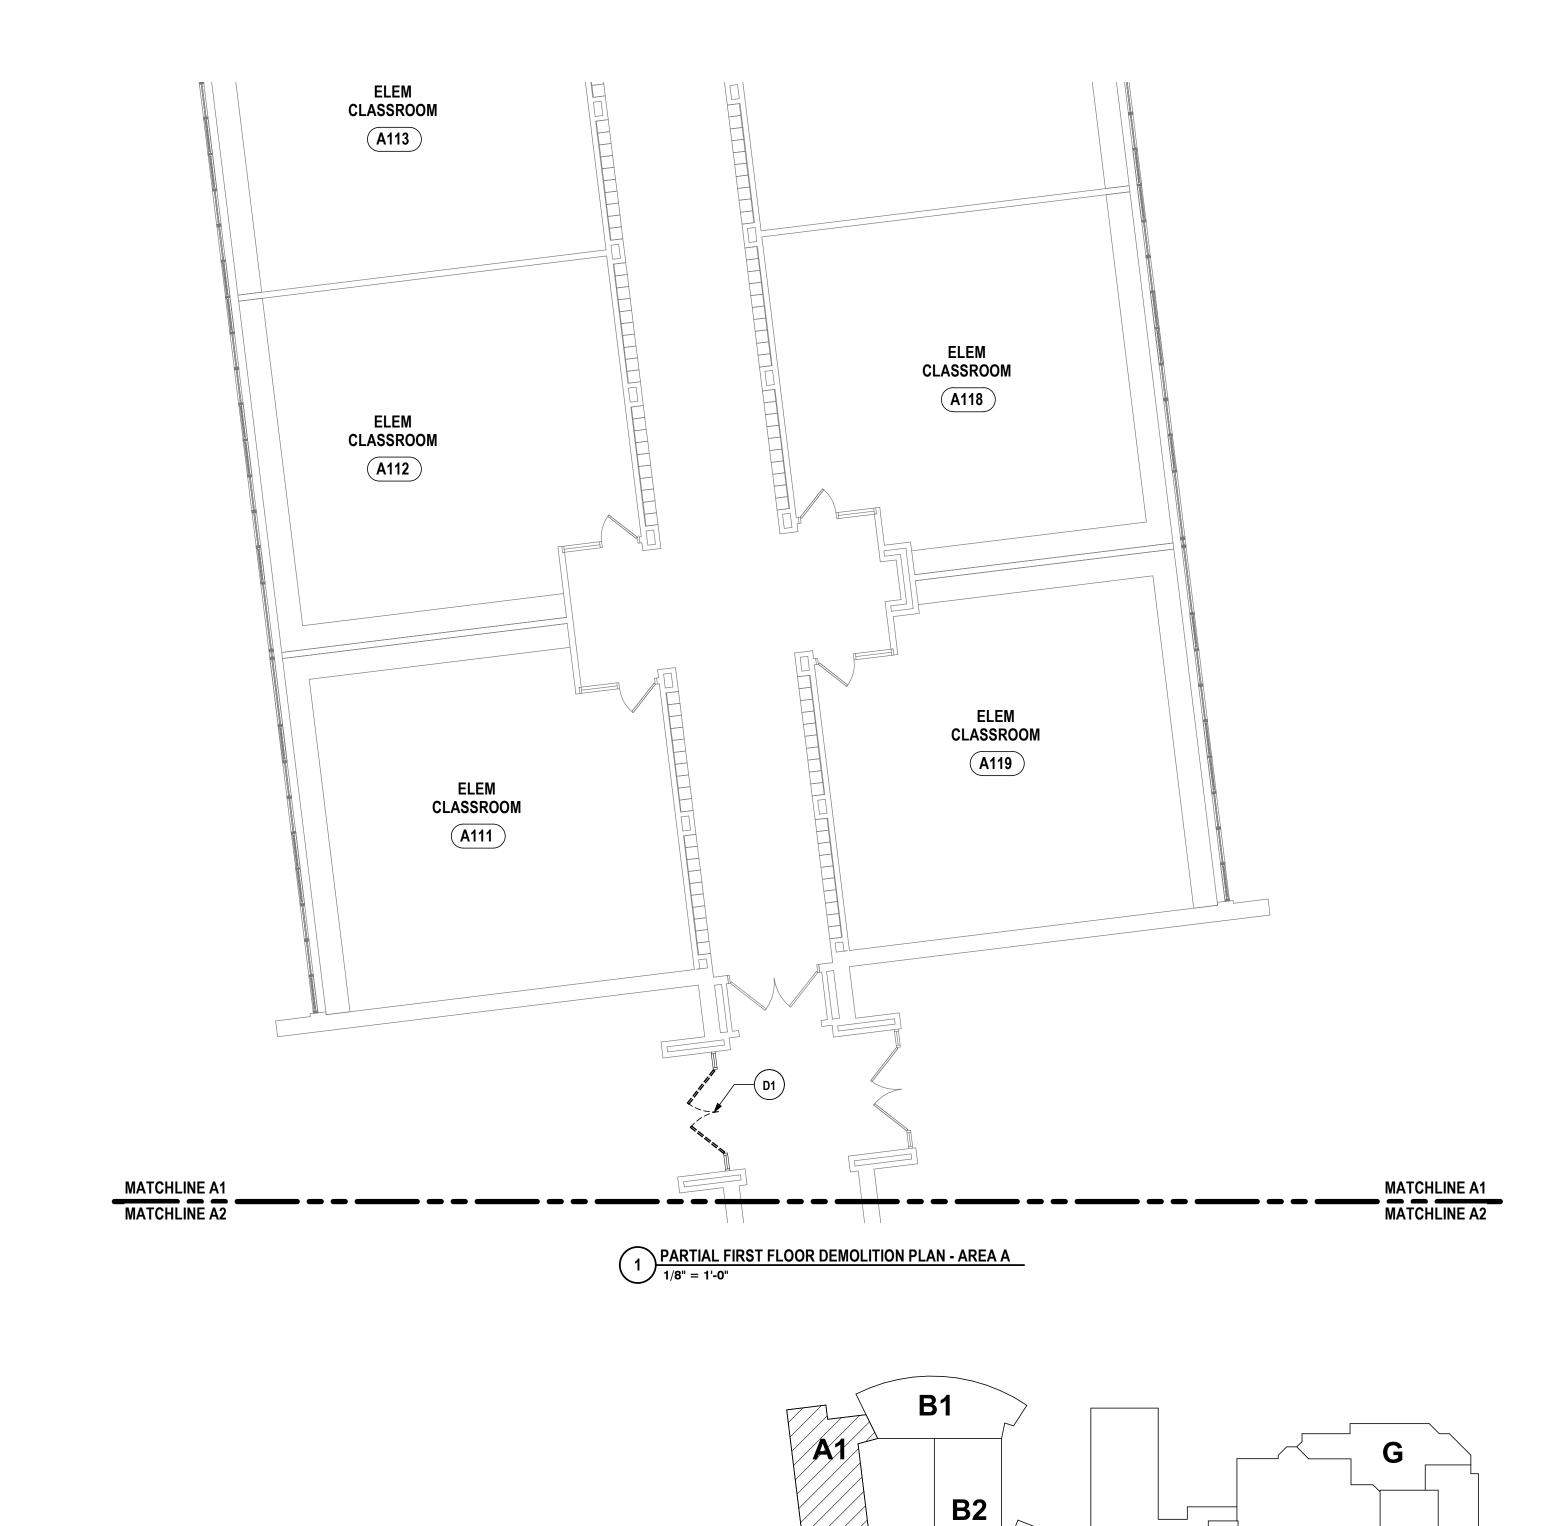

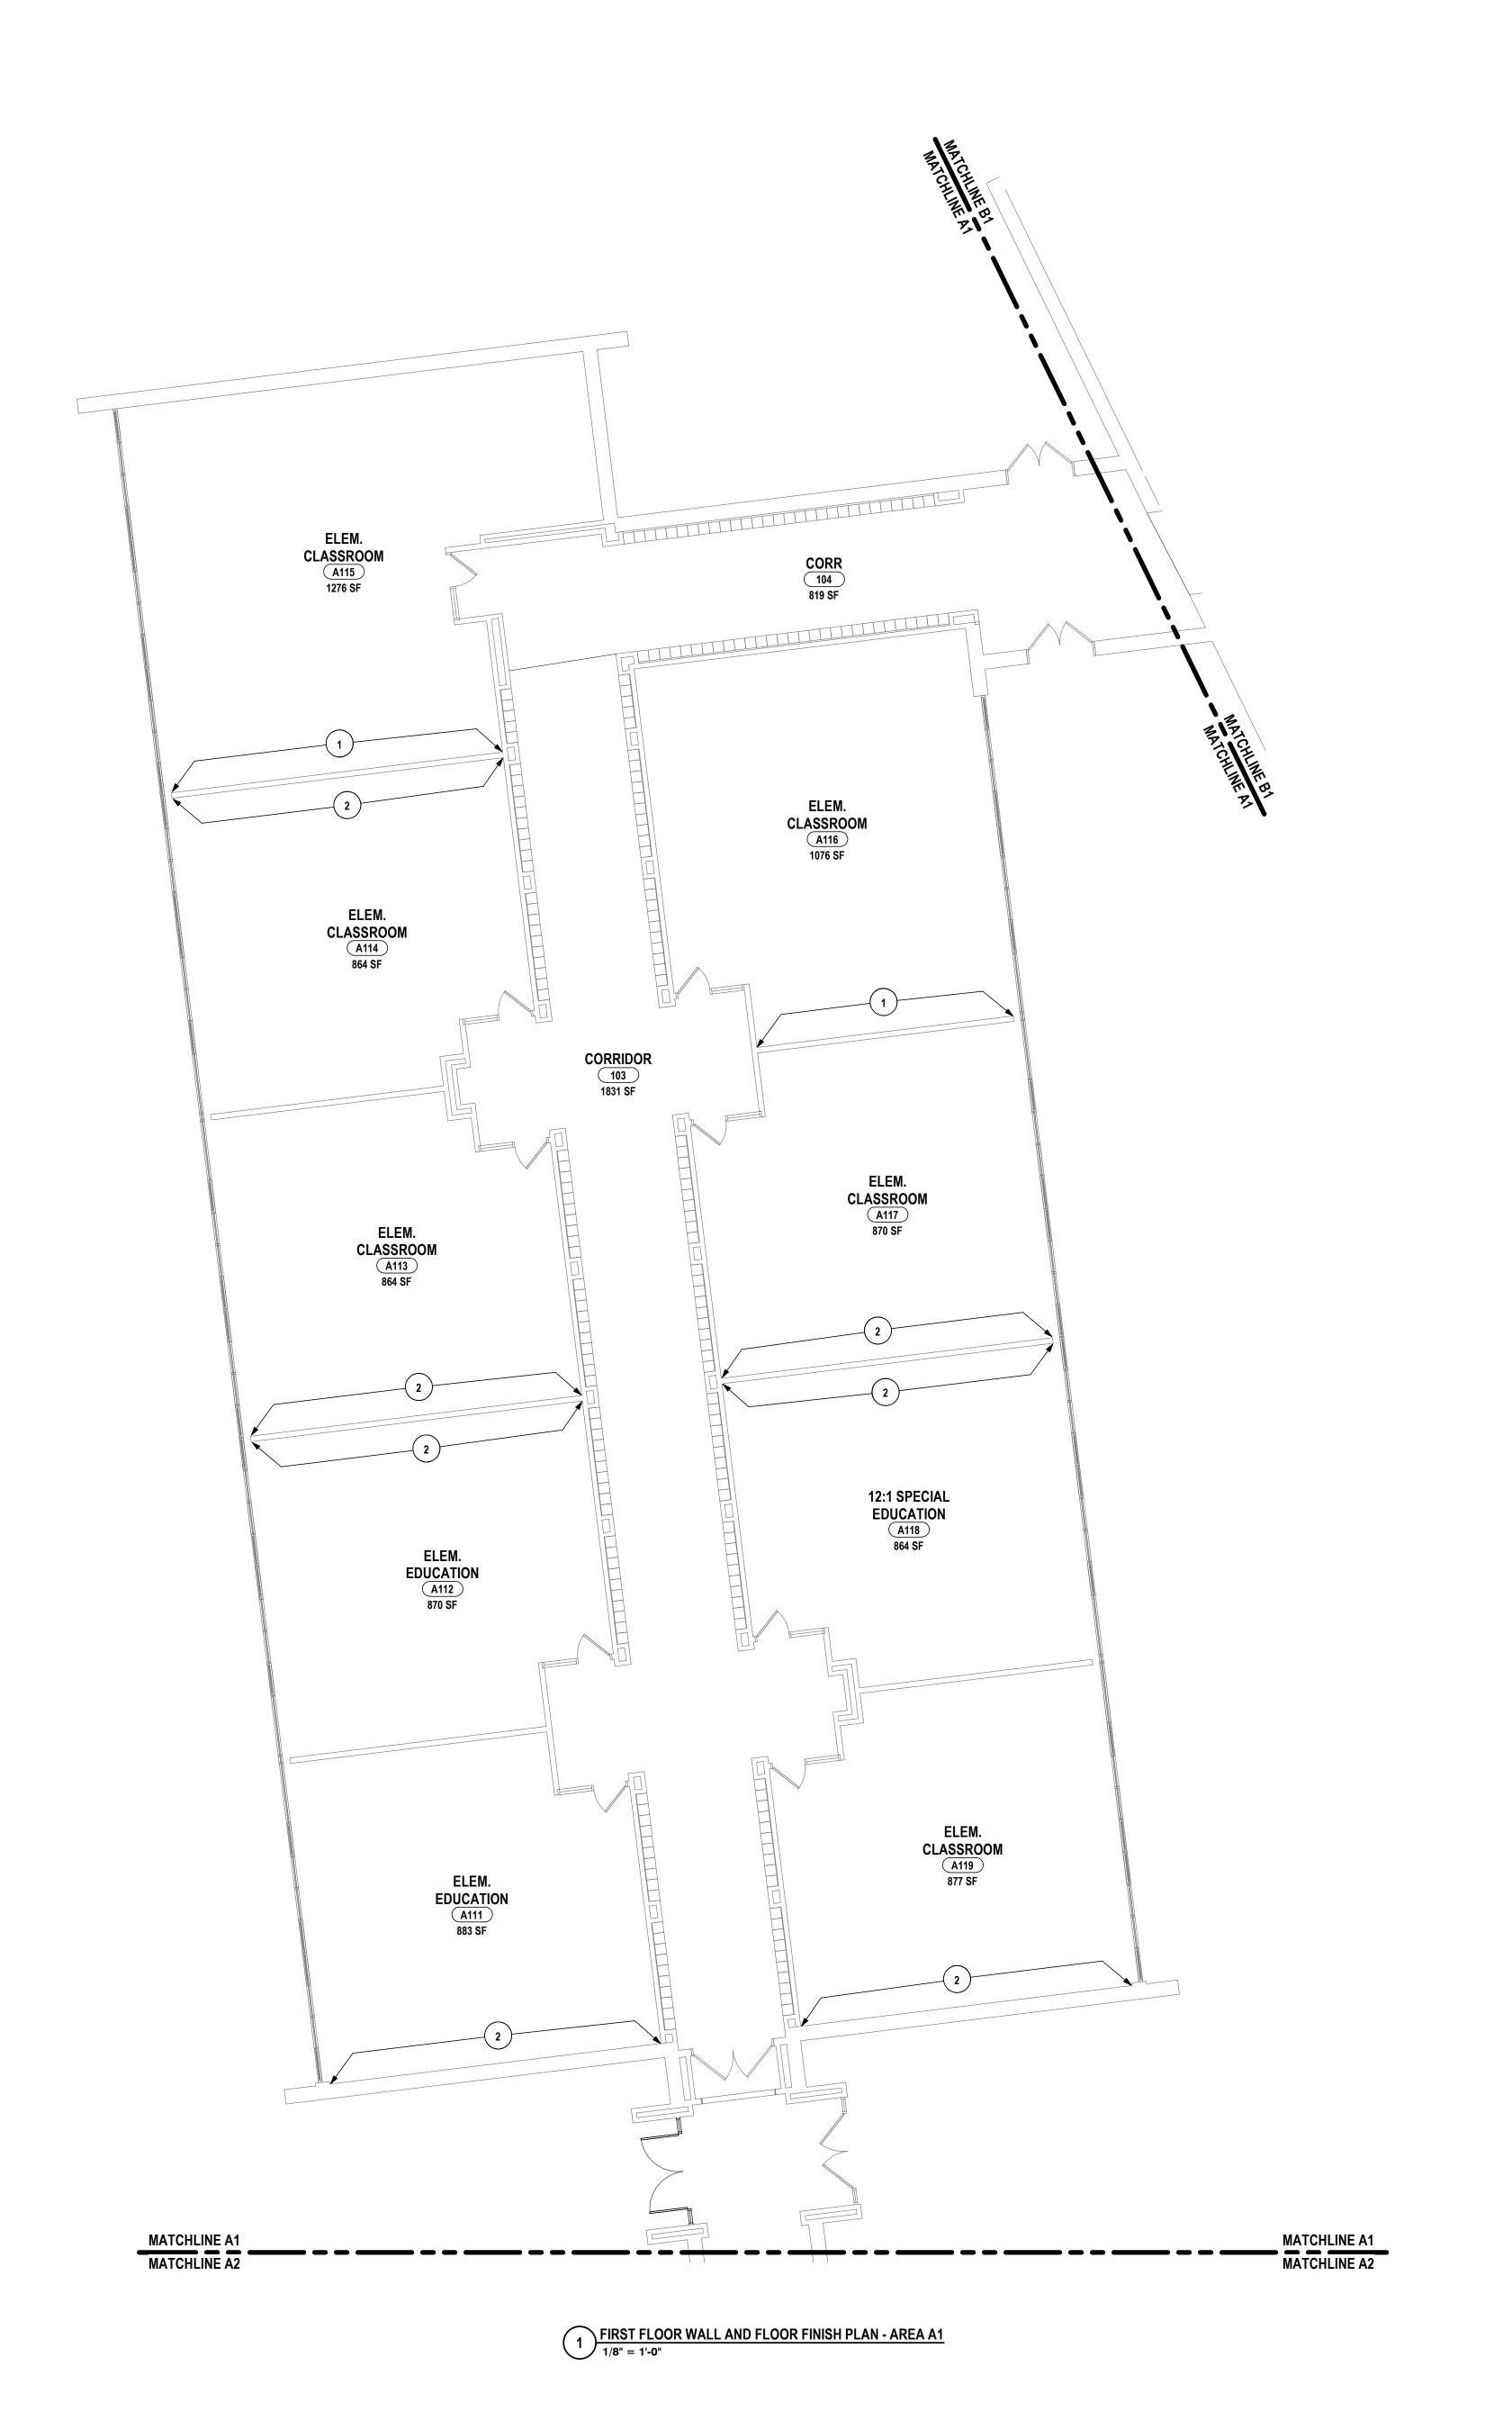

GENERAL NOTES - INTERIOR FLOOR FINISH:

REFER TO DRAWING A0.0 FOR GENERAL FINISH NOTES.

B2

D1

KEY PLAN

E1

GENERAL NOTES - INTERIOR WALL FINISH: REFER TO DRAWING A0.0 FOR GENERAL FINISH NOTES.

CONSTRUCTION NOTES - INTERIOR FLOOR AND WALL FINISH:

1 PAINT ENTIRE WALL CORNER TO CORNER FOLLOWING REMOVAL OF EXG. INTERACTIVE BOARD. PROVIDE NEW VCT TO MATCH EXG. WHERE EXG. BOARD MOUNTING SHOE(S) ARE TO BE REMOVED. (APPROXIMATELY 4 SF PER LOCATION)

PAINT ENTIRE WALL CORNER TO CORNER FOLLOWING REMOVAL OF EXG. INTERACTIVE BOARD. PAINT ENTIRE WALL CORNER TO CORNER FOLLOWING REMOVAL OF EXG. INTERACTIVE BOARD. PROVIDE NEW RUBBER FLOORING TO MATCH EXG. WHERE EXG. BOARD MOUNTING SHOE(S) ARE TO BE REMOVED. (APPROXIMATELY 4 SF PER CHECKED BY: 10/21/2022 1/8" = 1'-0"

ENGINEERS | ARCHITEC

 \sim 6

ND FLOOR FINISH PLAN - AREA A1 S 2023 RENOVATIONS (PHASE DISTRICT


BR-A8.1


REFER TO DRAWING A0.0 FOR GENERAL FINISH NOTES.

GENERAL NOTES - INTERIOR WALL FINISH: REFER TO DRAWING A0.0 FOR GENERAL FINISH NOTES.

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CHECKED BY: 10/21/2022 1/8" = 1'-0"

ENGINEERS | ARCHITEC

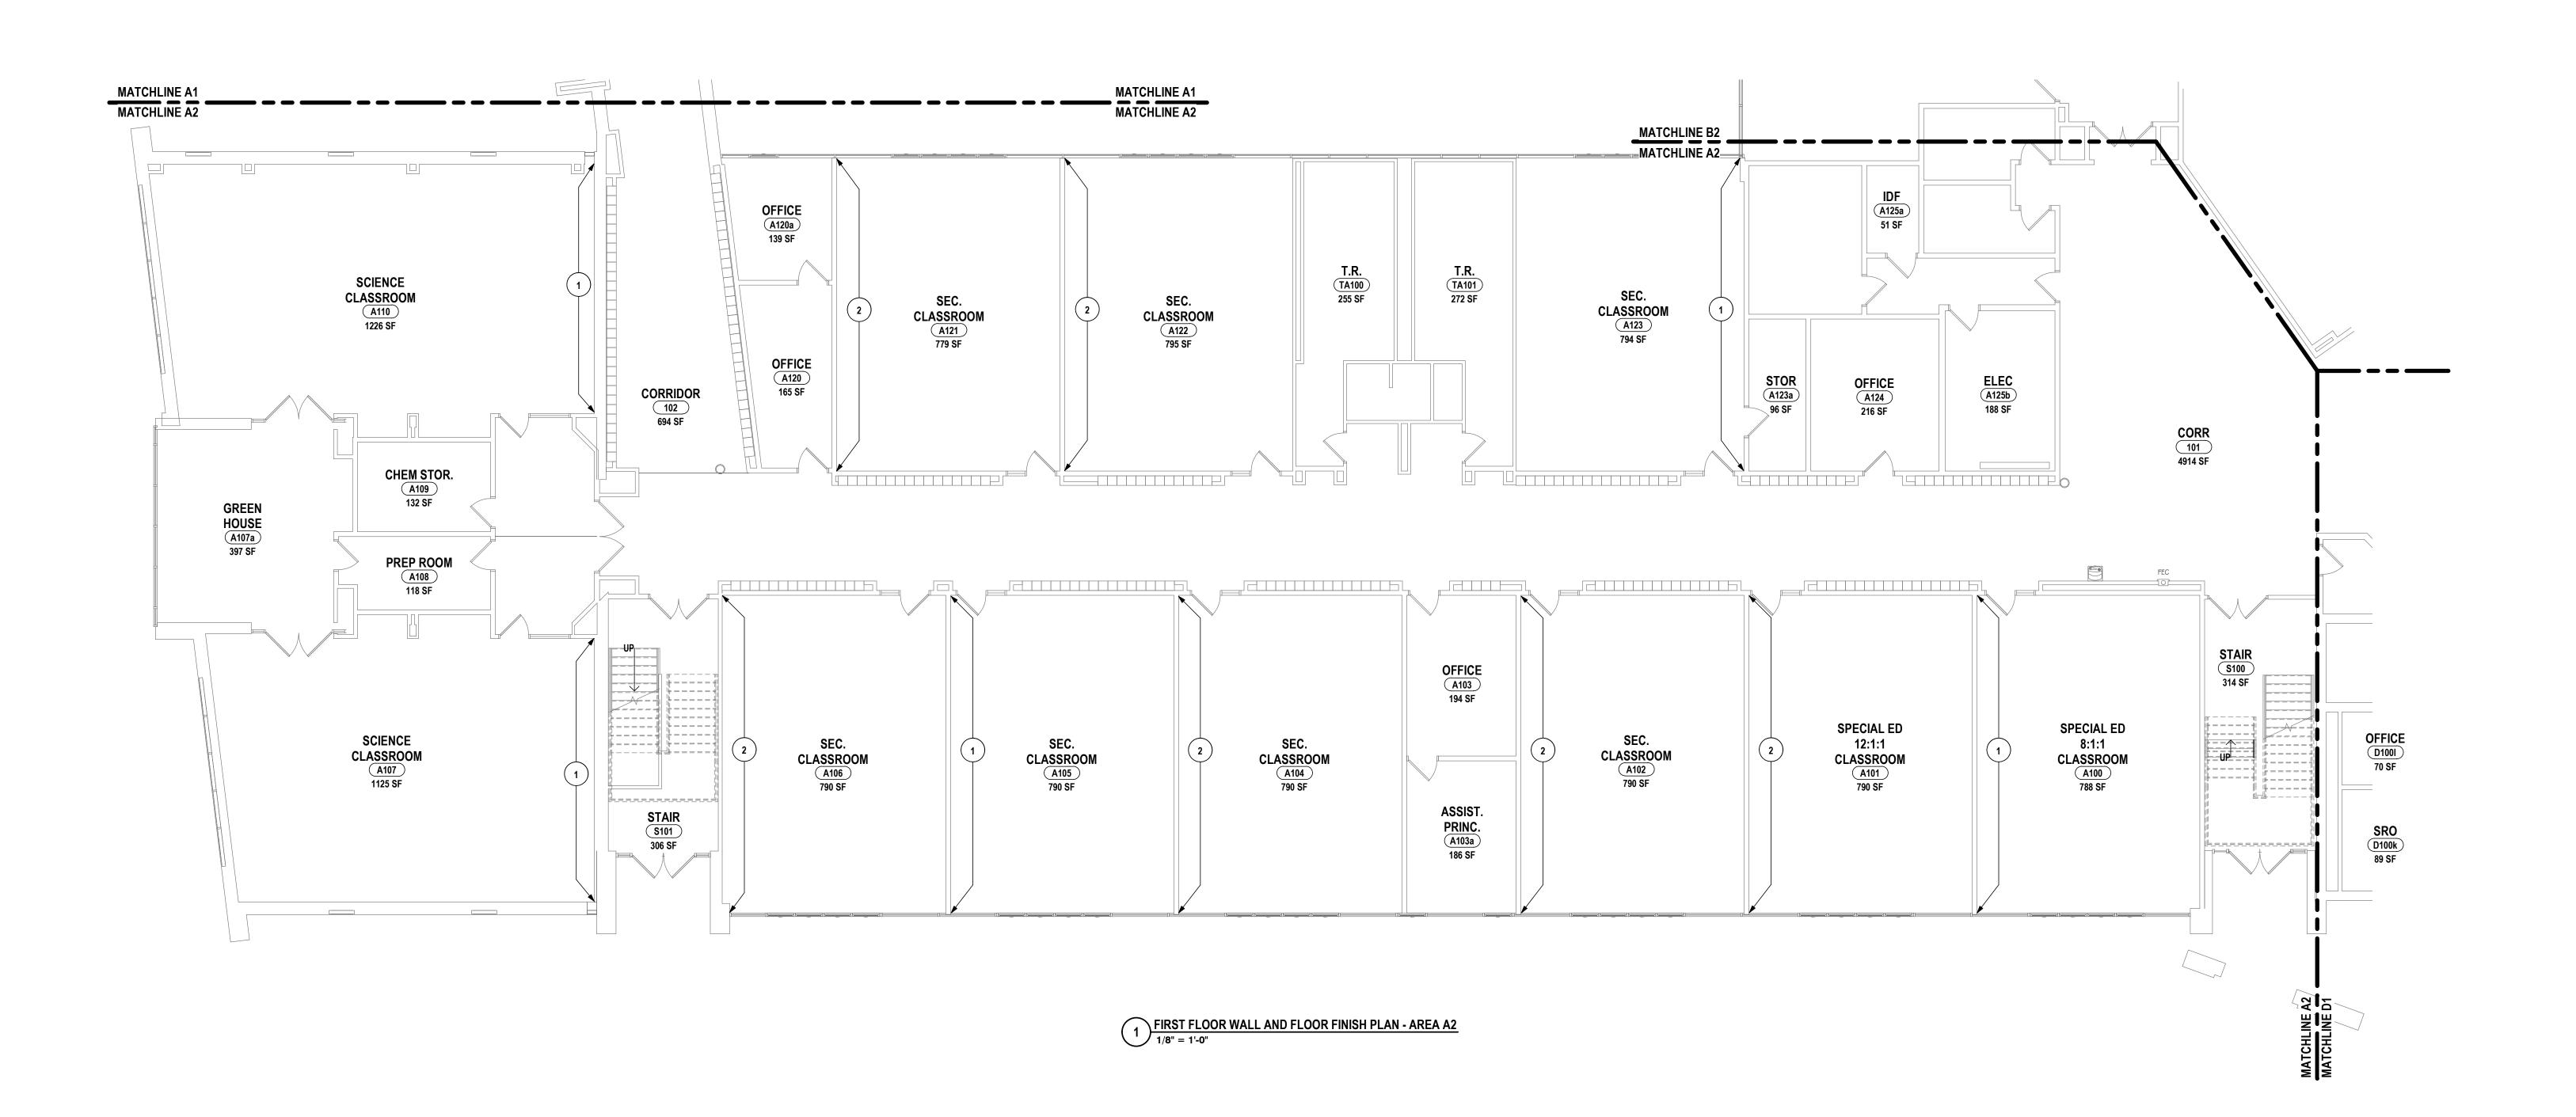ND FLOOR FINISH PLAN - AREA A2 S 2023 RENOVATIONS DISTRICT

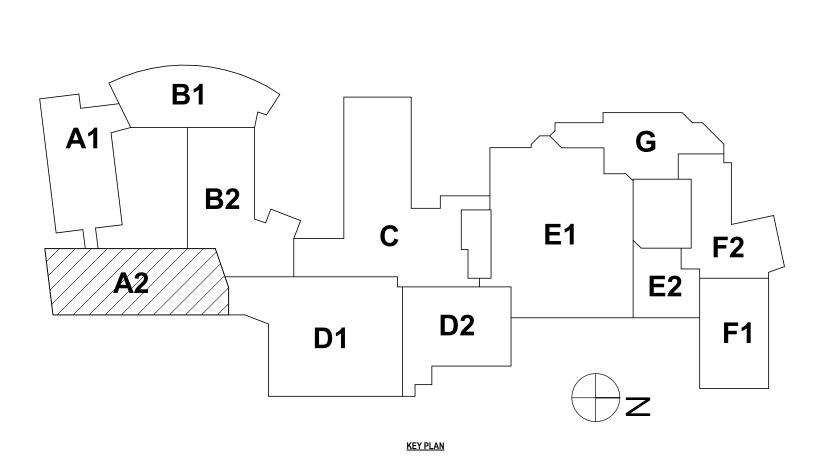BR-A8.2

REFER TO DRAWING A0.0 FOR GENERAL FINISH NOTES.

GENERAL NOTES - INTERIOR WALL FINISH:
REFER TO DRAWING A0.0 FOR GENERAL FINISH NOTES.

CONSTRUCTION NOTES - INTERIOR FLOOR AND WALL FINISH:


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CLASSROOM P. (B112c) 54 SF MIDILAB B113 685 SF VOCAL MUSIC CLASSROOM B111 1825 SF P. B112d 58 SF MUSIC CLASSROOM B114 849 SF P. B112f 182 SF MUSIC CLASSROOM B115 778 SF 155 SF 105 1424 SF TR TB101 56 SF P. B106 65 SF STOR.
B108
109 SF 8:1:1 SPECIAL ED CLASSROOM B116 556 SF OFFICE B109 TR TB103 209 SF JAN. OFFICE
B105
221 SF MATCHLINE B1
MATCHLINE B2 MATCHLINE B1

1 FIRST FLOOR WALL AND FLOOR FINISH PLAN - AREA B1
1/8" = 1'-0"



1/2023 ISSUED FOR BID

A VIOLATION OF THE LAW FOR ANY PERSON TO MAKE UNAUTHORIZED ALTERATIONS OR ADDITIONS TO PLANS

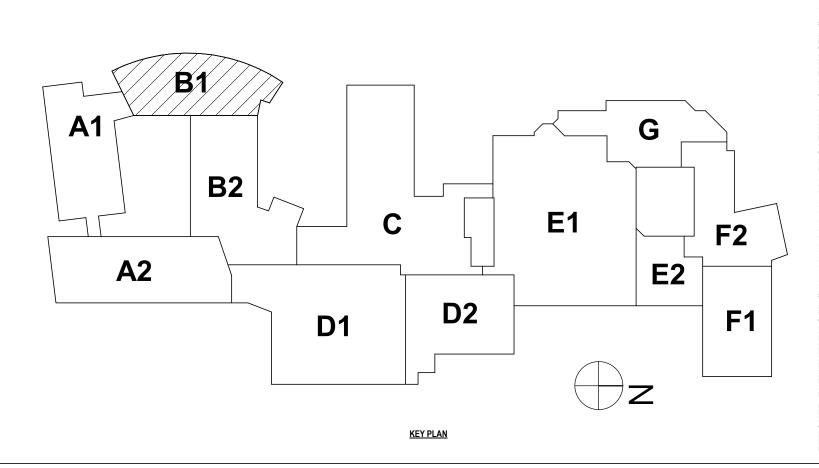BEARING A LICENSED ENGINEER'S, ARCHITECT'S OR SURVEYOR'S SEAL."

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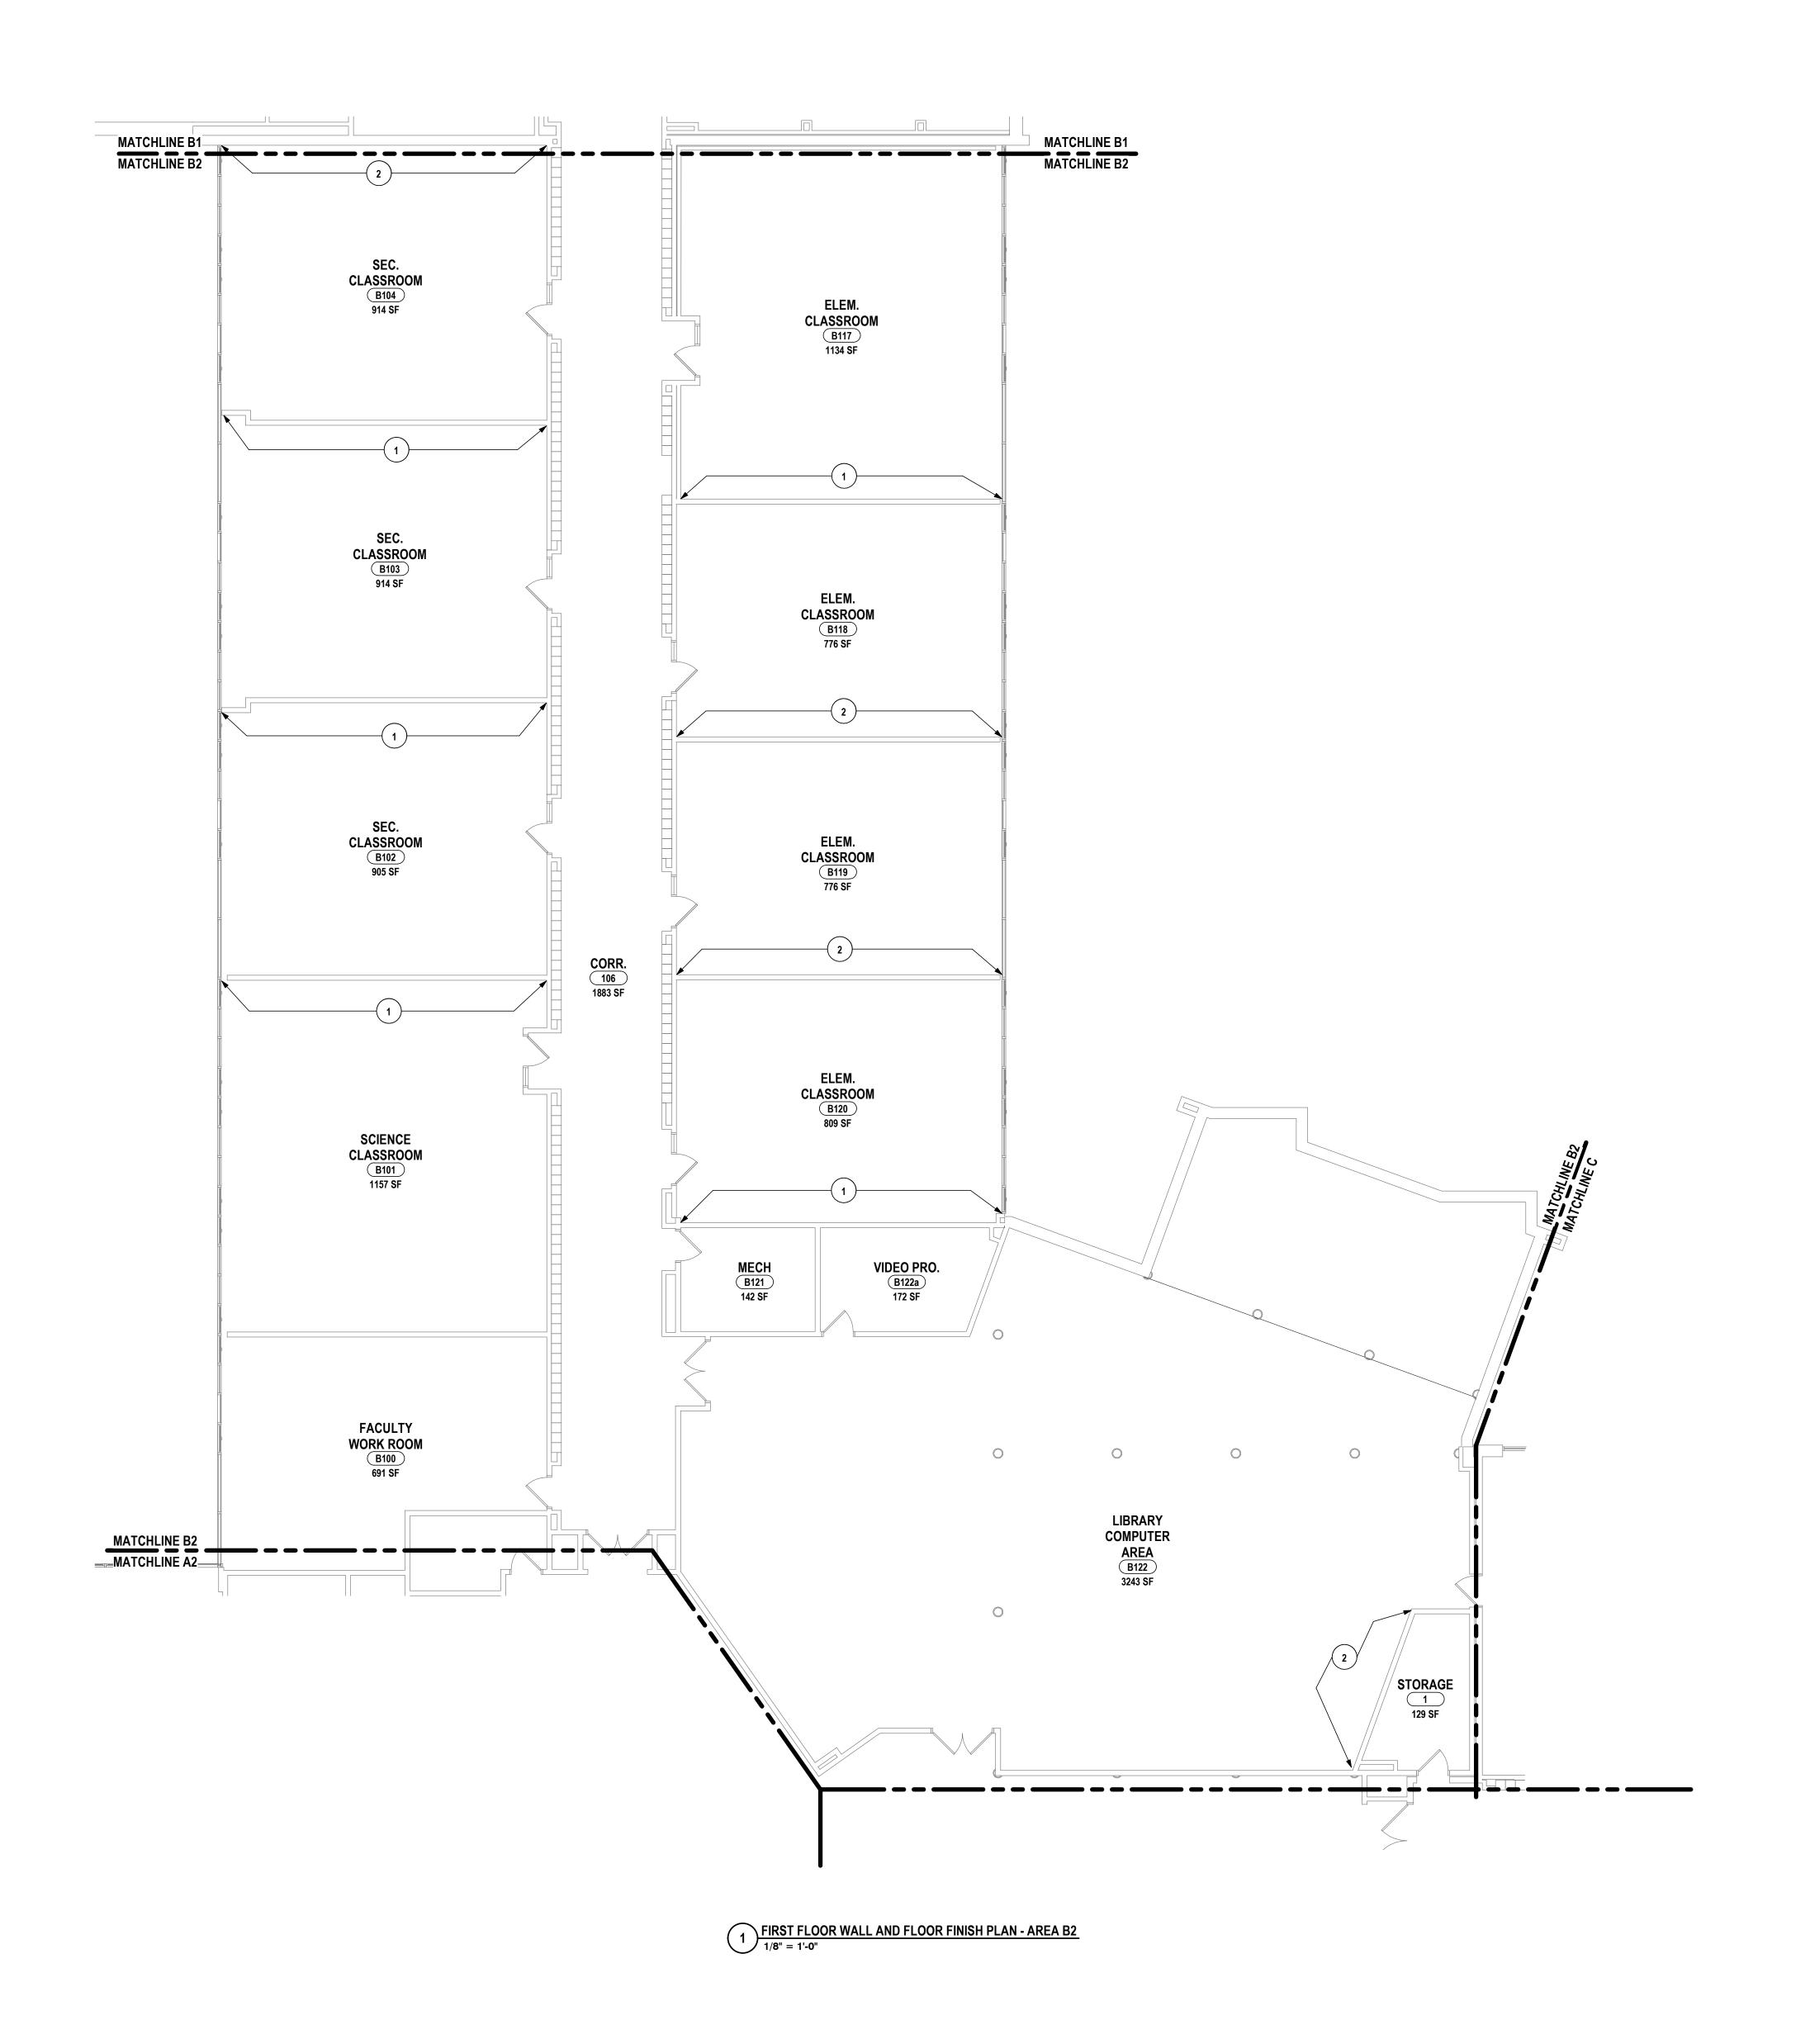
FLOOR WALL AND FLOOR FINISH PLAN - AREA B1

FLOOR WALL AND FLOOR FINISH PLAN - AREA B1

FNTARY SCHOOLS 2023 RENOVATIONS (PHASE II)

A CITY SCHOOL DISTRICT

BR-A8.3



GENERAL NOTES - INTERIOR FLOOR FINISH:

REFER TO DRAWING A0.0 FOR GENERAL FINISH NOTES.

GENERAL NOTES - INTERIOR WALL FINISH:

REFER TO DRAWING A0.0 FOR GENERAL FINISH NOTES.

B1


D1

KEY PLAN

CONSTRUCTION NOTES - INTERIOR FLOOR AND WALL FINISH:

1 PAINT ENTIRE WALL CORNER TO CORNER FOLLOWING REMOVAL OF EXG. INTERACTIVE BOARD. PROVIDE NEW VCT TO MATCH EXG. WHERE EXG. BOARD MOUNTING SHOE(S) ARE TO BE REMOVED. (APPROXIMATELY 4 SF PER LOCATION)
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FLOOR WALL AND FLOOR FINISH PLAN - AREA B2

ENTARY SCHOOLS 2023 RENOVATIONS (PHASE II)

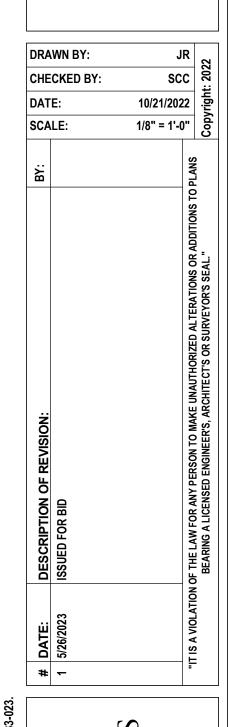A CITY SCHOOL DISTRICT

BR-A8.4

PROJECT NO: 2012-233

E1



A VIOLATION OF THE LAW FOR ANY PERSON TO MAKE UNAUTHORIZED ALTERATIONS OR ADDITIONS TO PLANS

TEN DESCRIPTION OF REVISION:


SOLUTION OF THE LAW FOR ANY PERSON TO MAKE UNAUTHORIZED ALTERATIONS OR ADDITIONS TO PLANS


REARING A LICENSED ENGINEER'S, ARCHITECT'S OR SURVEYOR'S SEAL."

Copyright: 2022

FLOOR WALL AND FLOOR FINISH PLAN - AREA C ENTARY SCHOOLS 2023 RENOVATIONS (PHASE II)

BR-A8.5

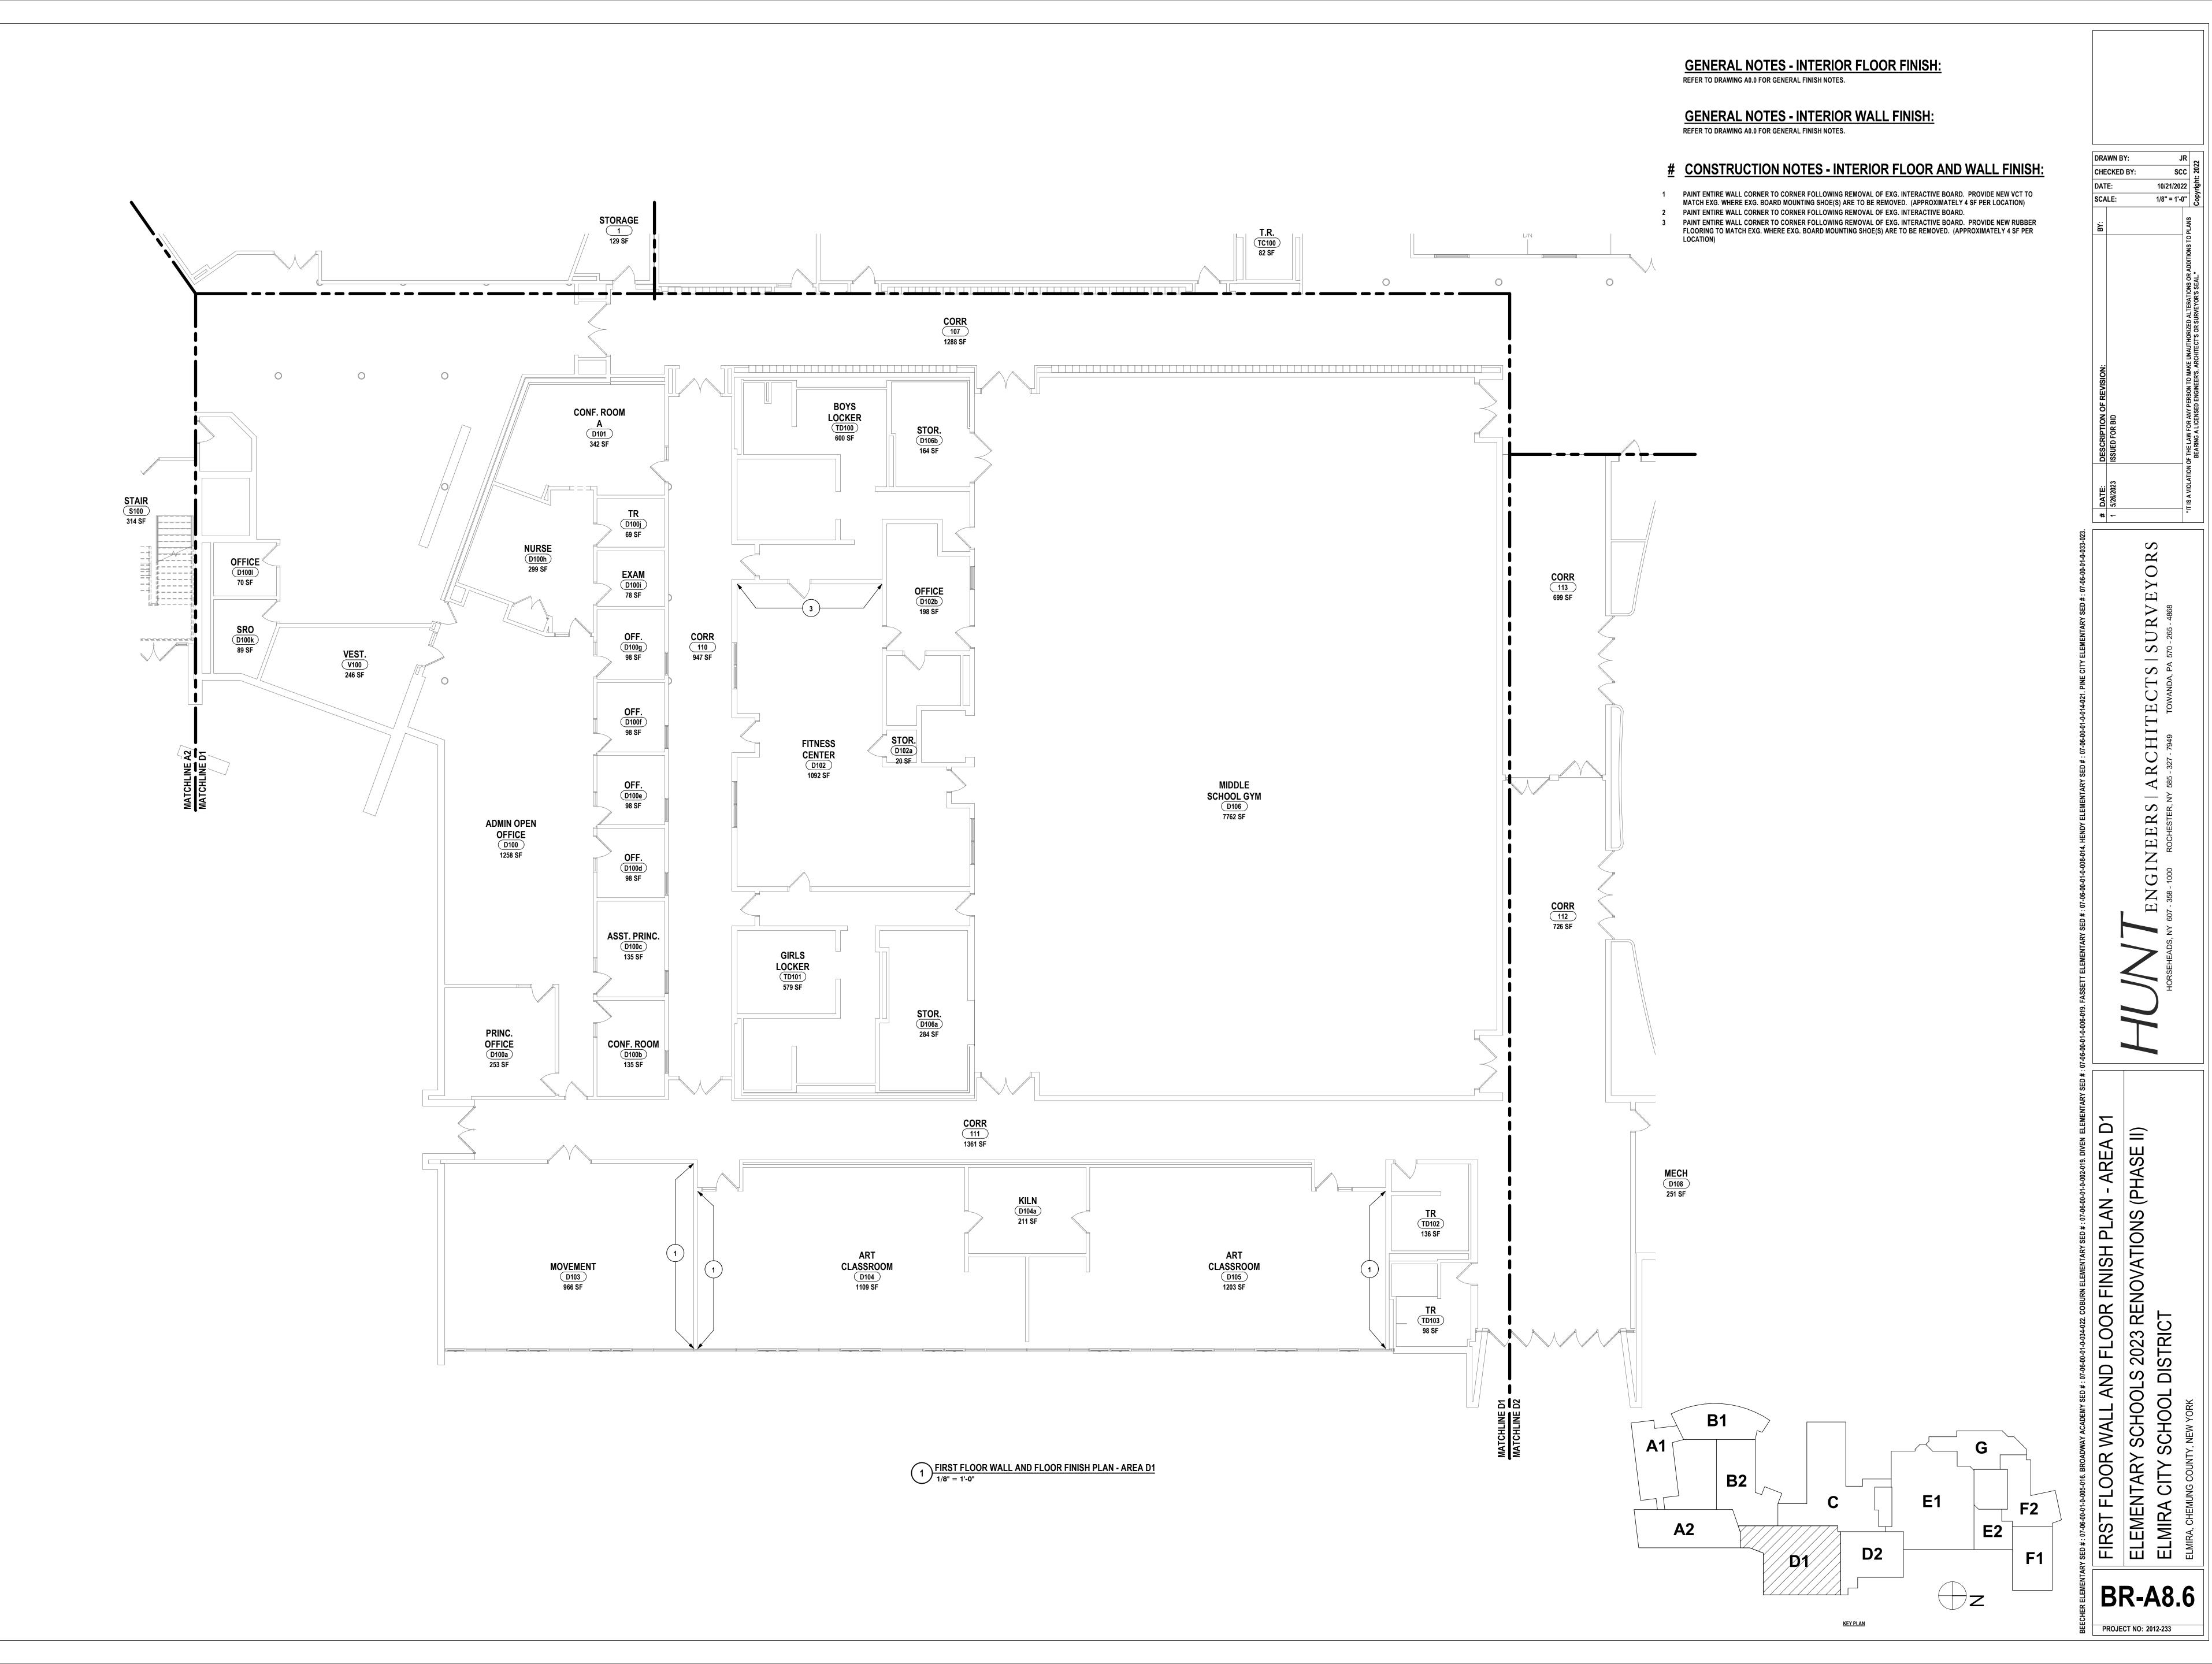

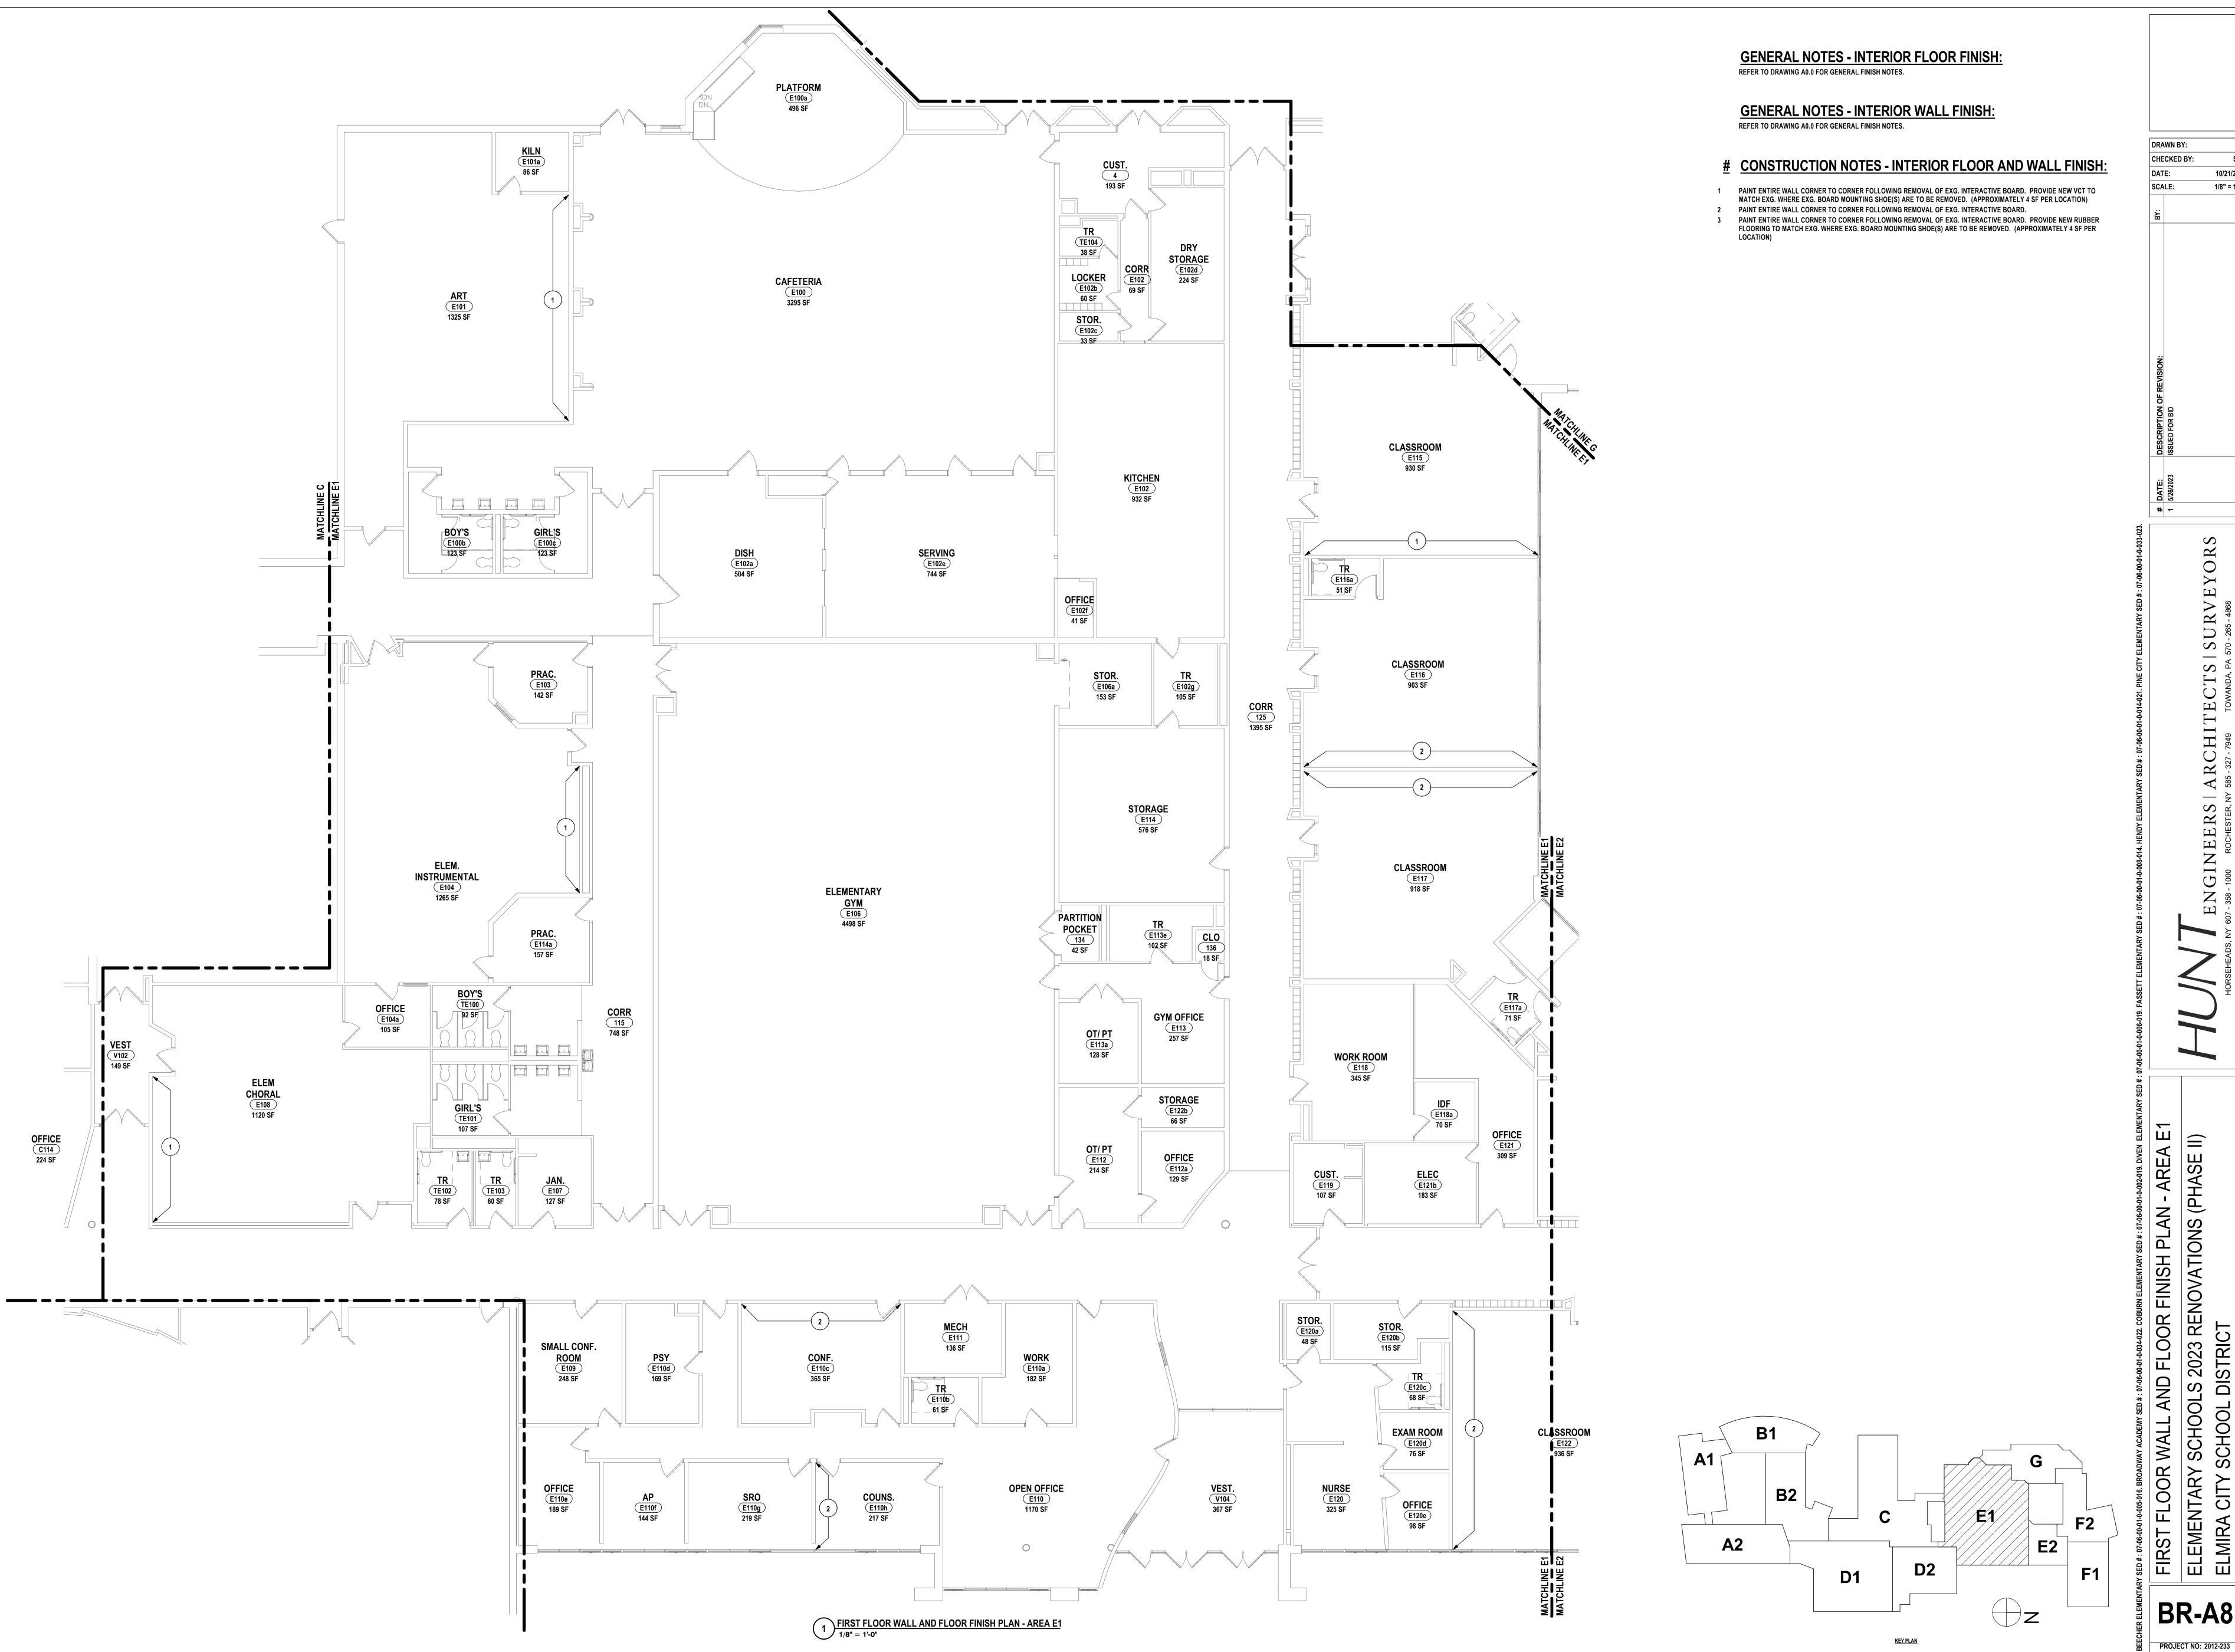

CHECKED BY: 10/21/2022 1/8" = 1'-0"

S ENGINEERS | ARCHITEC

S 2023 RENOVATIONS (PHASE DISTRICT FLOOR WALL AND FLOOR FINISH PLAN FIRST FLOOR WALL AN ELEMENTARY SCHOOL ELMIRA CITY SCHOOL ELMIRA, CHEMUNG COUNTY, NEW YORK

BR-A8.7

1 FIRST FLOOR WALL AND FLOOR FINISH PLAN - AREA E2 & F1

GENERAL NOTES - INTERIOR FLOOR FINISH:

REFER TO DRAWING A0.0 FOR GENERAL FINISH NOTES.

B2

E1

KEY PLAN

GENERAL NOTES - INTERIOR WALL FINISH:

REFER TO DRAWING A0.0 FOR GENERAL FINISH NOTES.

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- 1 PAINT ENTIRE WALL CORNER TO CORNER FOLLOWING REMOVAL OF EXG. INTERACTIVE BOARD. PROVIDE NEW VCT TO MATCH EXG. WHERE EXG. BOARD MOUNTING SHOE(S) ARE TO BE REMOVED. (APPROXIMATELY 4 SF PER LOCATION)
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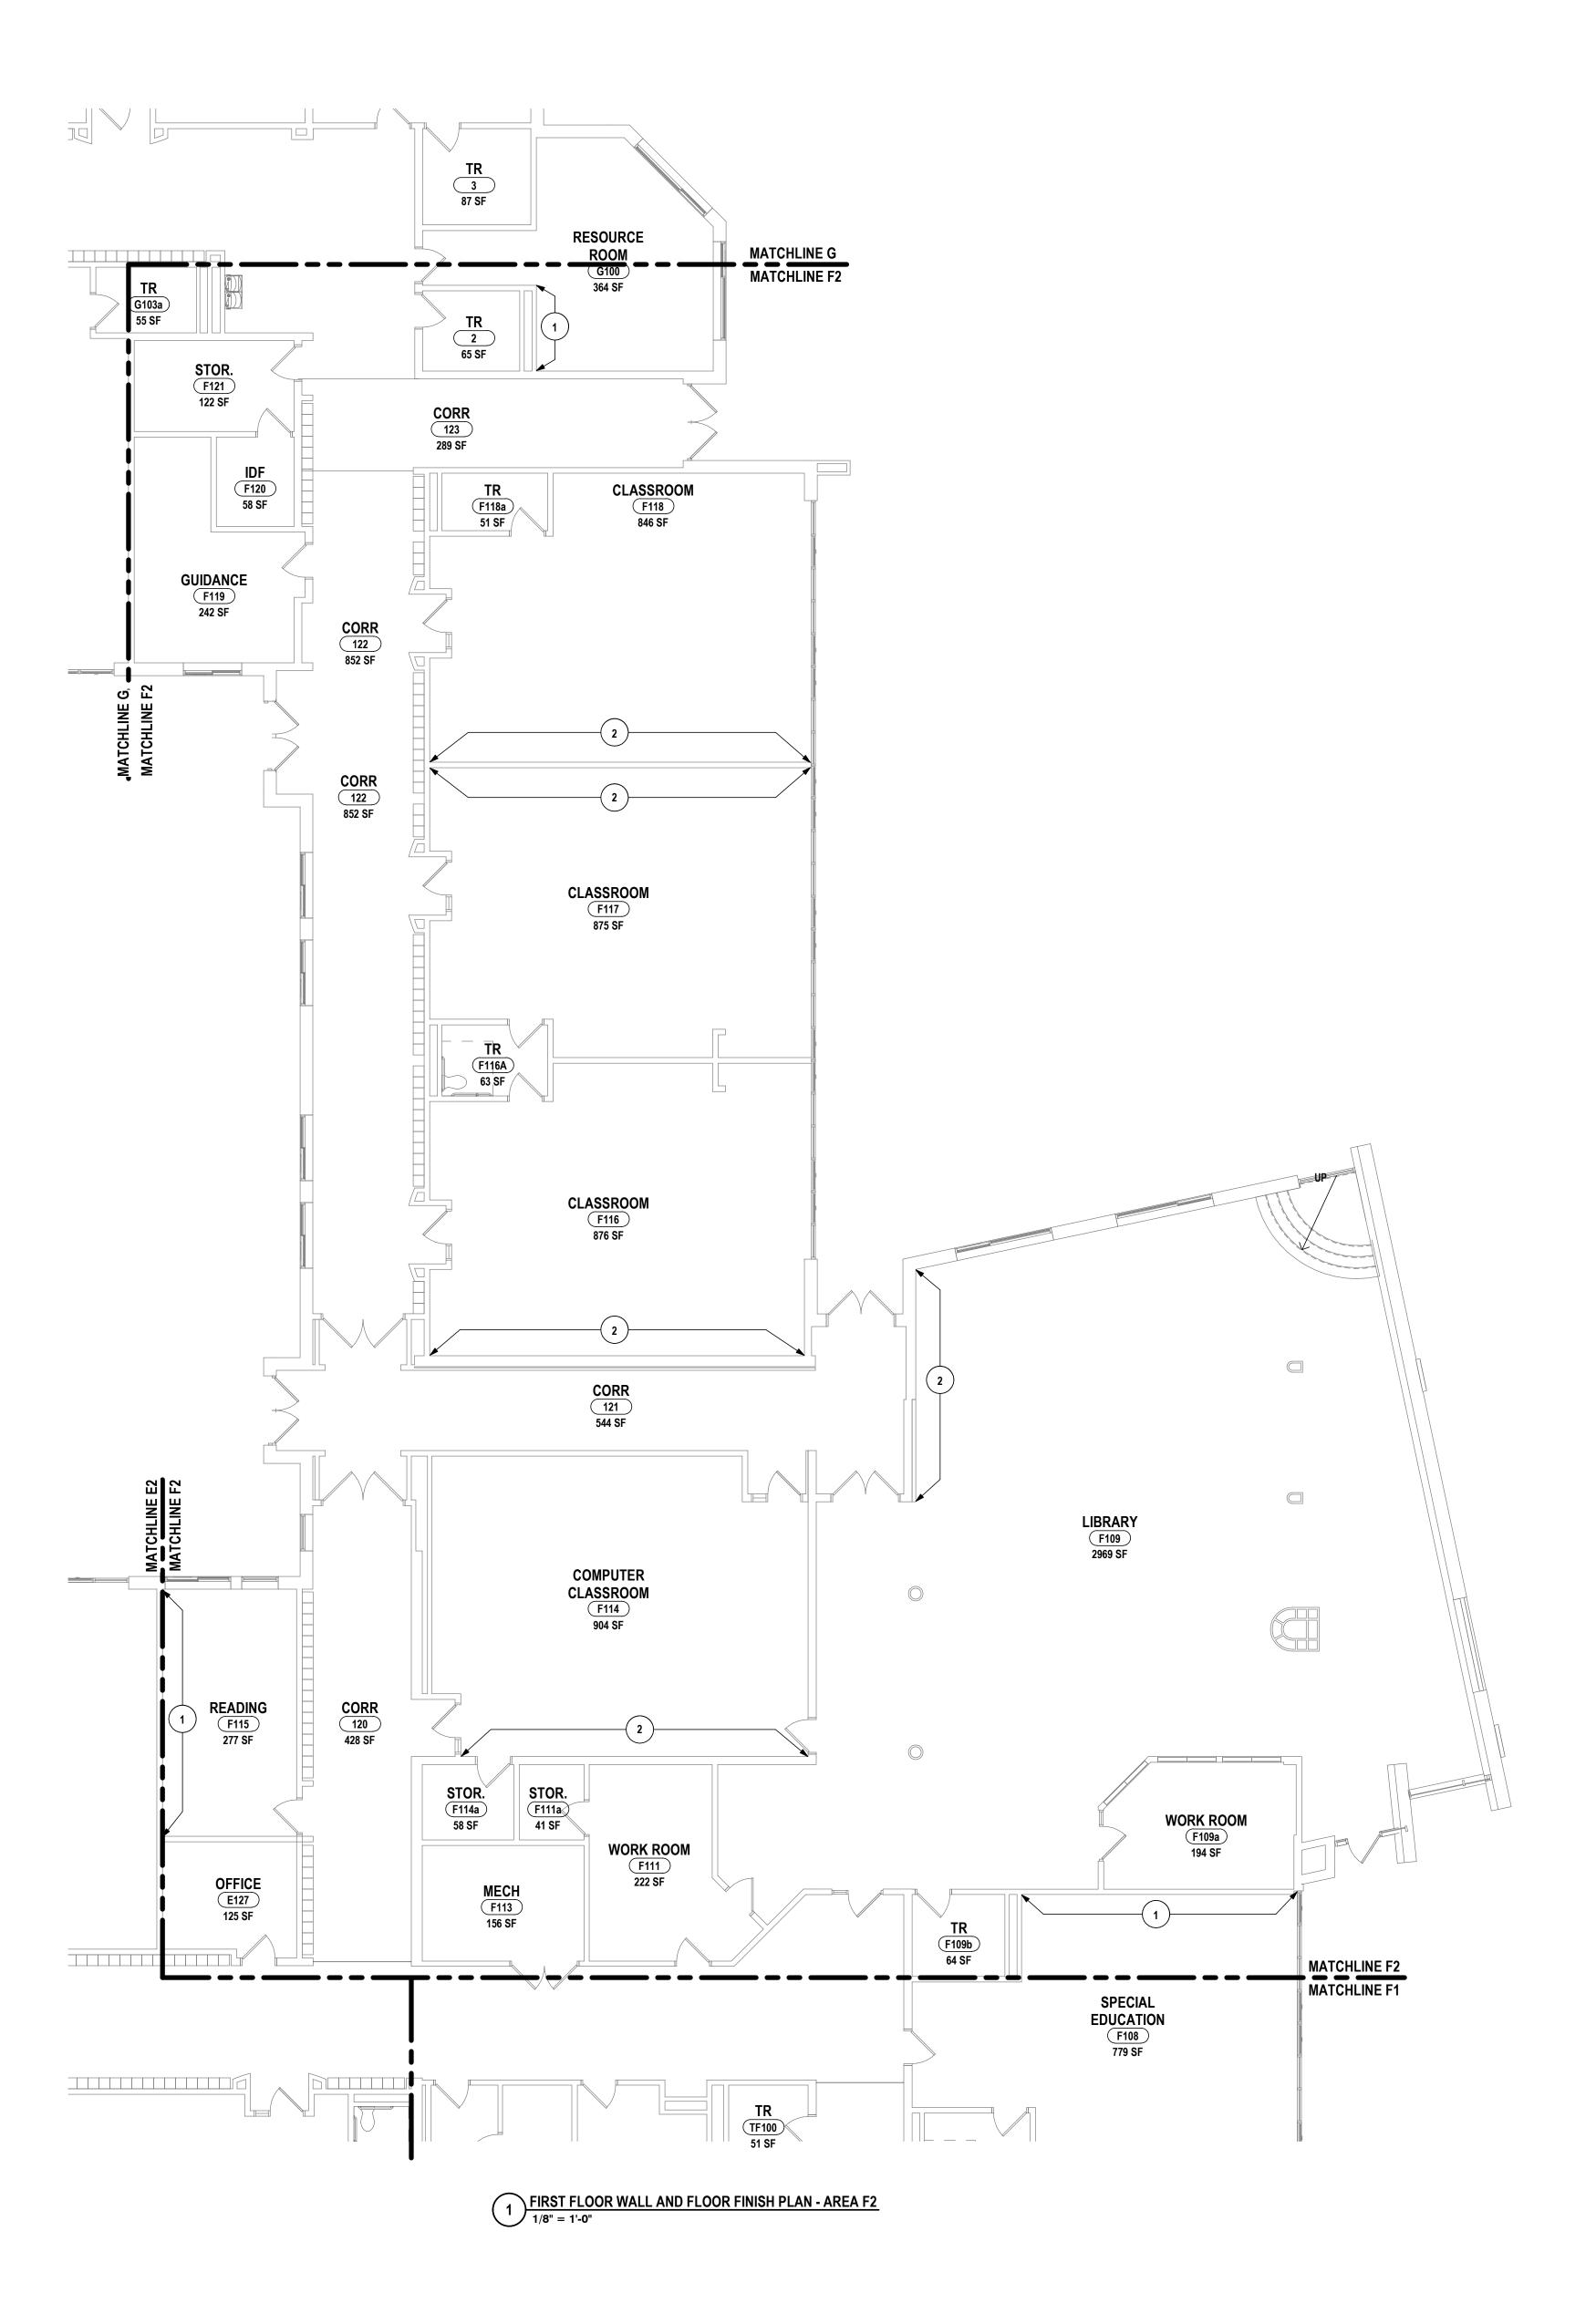
CHECKED BY: 10/21/2022 SCALE: 1/8" = 1'-0"

> \sim ENGINEERS | ARCHITEC

#: 07-06-00-01-0-034-022. COBURN ELEMENTARY SED #: 07-06-00-01-0-002-019. DIVEN ELEMENTARY NO FLOOR FINISH PLAN - AREA E2 &

S 2023 RENOVATIONS DISTRICT

BR-A8.8



GENERAL NOTES - INTERIOR FLOOR FINISH:


REFER TO DRAWING A0.0 FOR GENERAL FINISH NOTES.

GENERAL NOTES - INTERIOR WALL FINISH:

REFER TO DRAWING A0.0 FOR GENERAL FINISH NOTES.

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 \sim 6 ENGINEERS | ARCHITEC

- AREA F2 ND FLOOR FINISH PLAN S 2023 RENOVATIONS DISTRICT

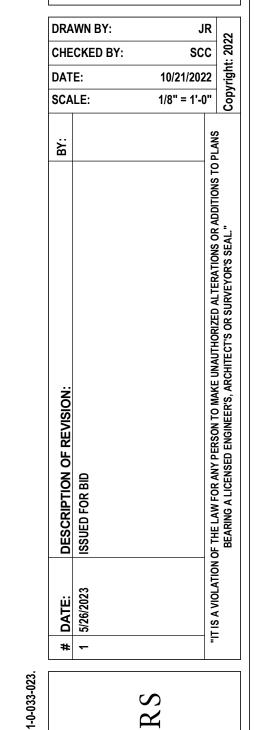E1

D1

KEY PLAN

BR-A8.9 PROJECT NO: 2012-233

GENERAL NOTES - INTERIOR WALL FINISH:


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CONSTRUCTION NOTES - INTERIOR FLOOR AND WALL FINISH:


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1 FIRST FLOOR WALL AND FLOOR FINISH PLAN - AREA G



HORSEHEADS, NY 607 - 358 - 1000 ROCHESTER, NY 585 - 327 - 7949 TOWANDA, PA 570 - 265 - 4868

11-0-005-016. BROADWAY ACADEMY SED #: 07-06-00-01-0-034-022. COBURN ELEMENTARY SED #: 07-06-00-01-0-002-019. DIVEN ELEN
FLOOR WALL AND FLOOR FINISH PLAN - AREA G
INTARY SCHOOLS 2023 RENOVATIONS (PHASE II)
A CITY SCHOOL DISTRICT

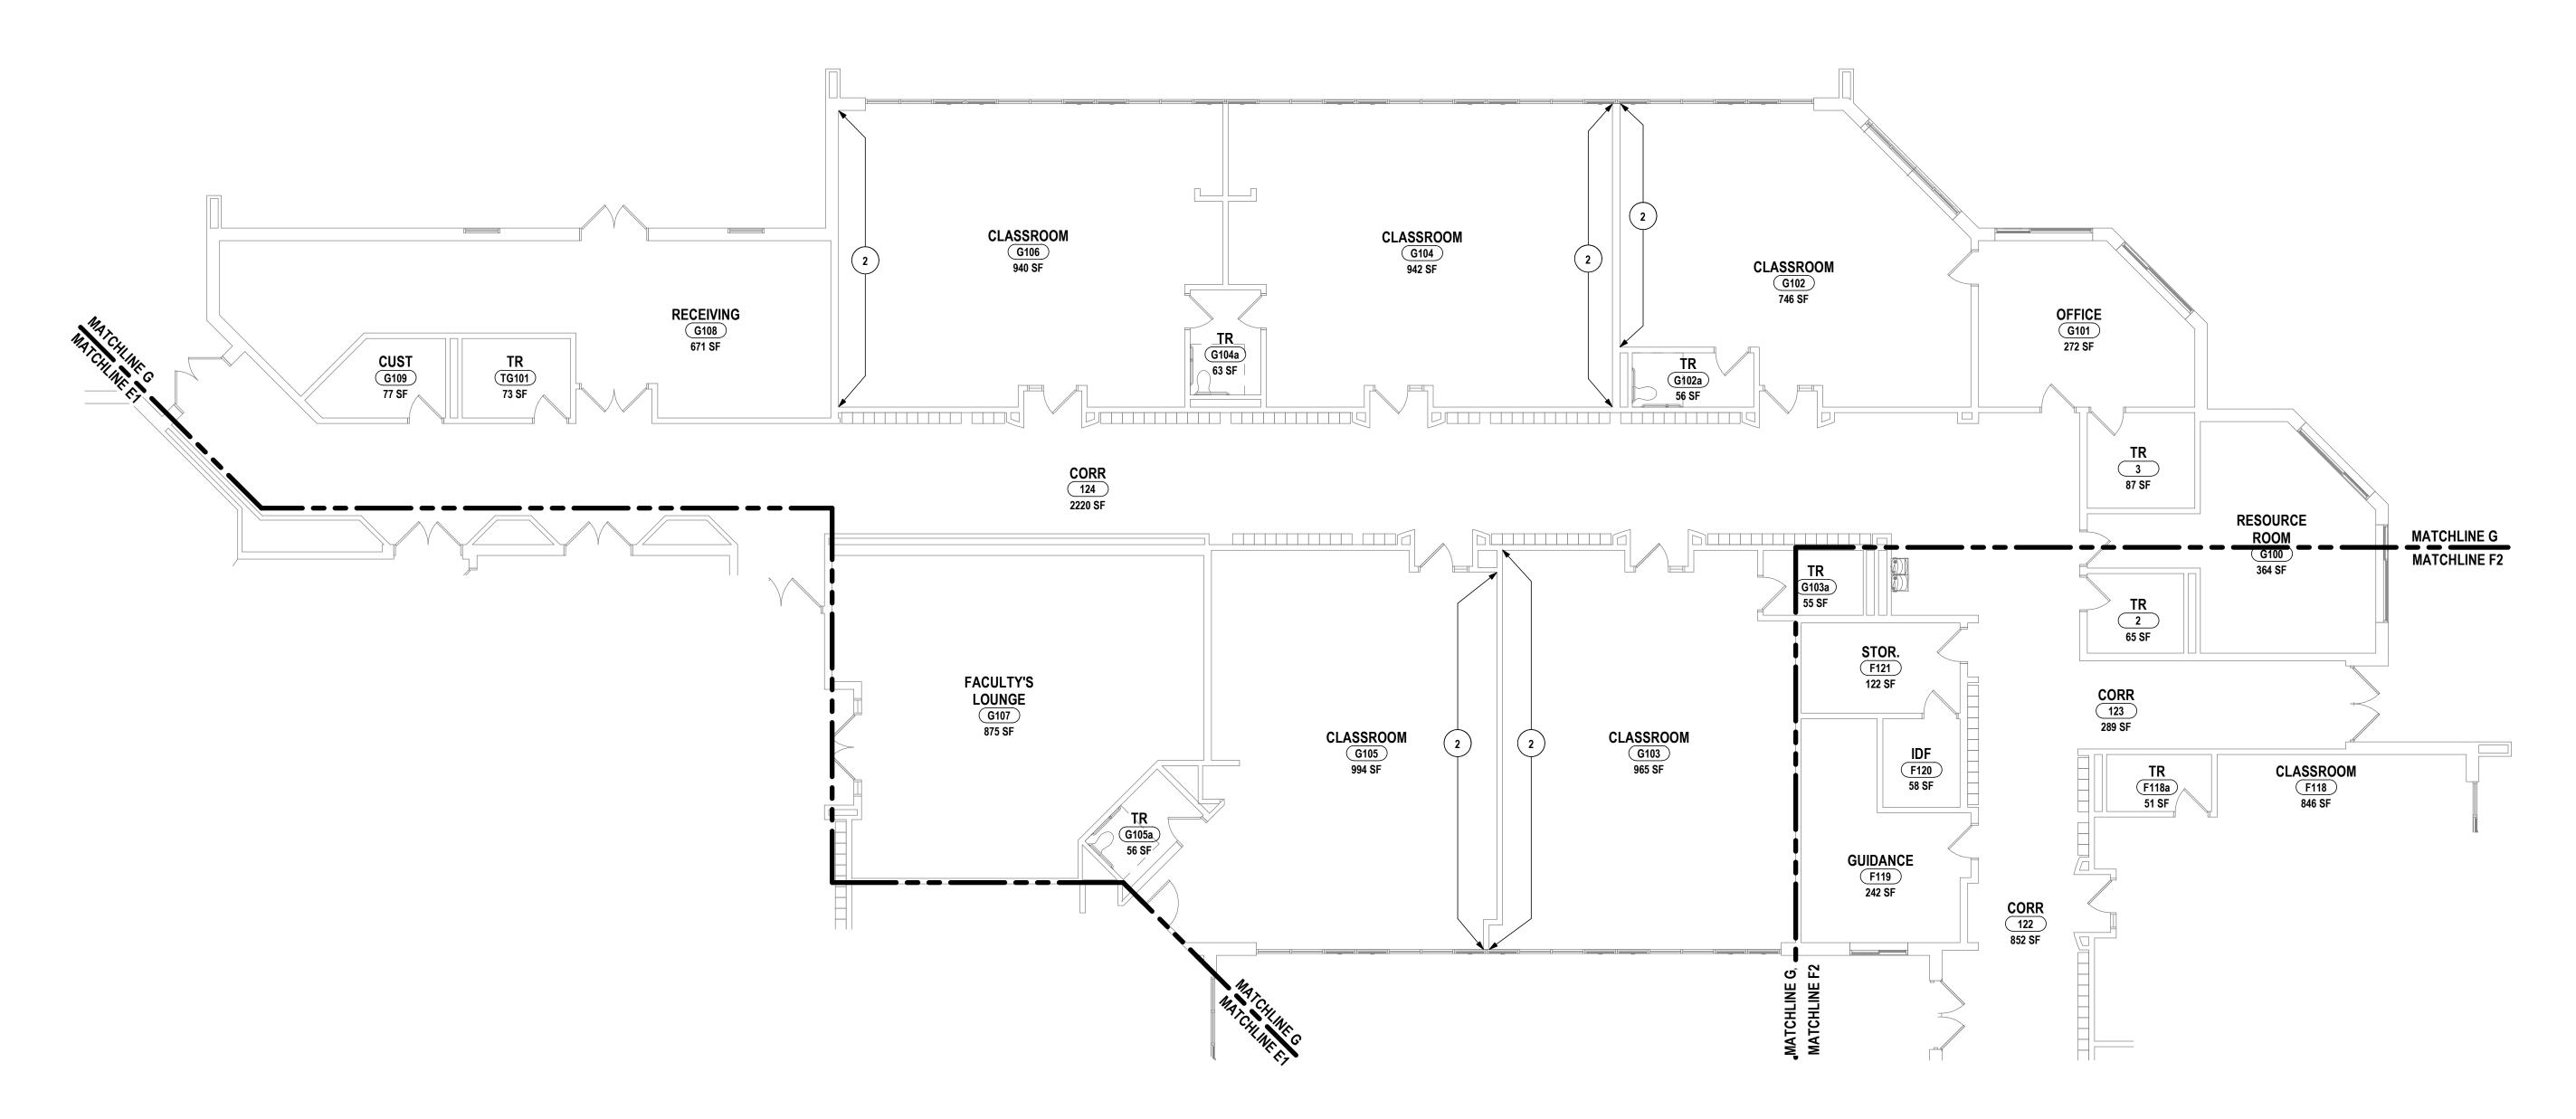ELEMENTA ELMIRA CI

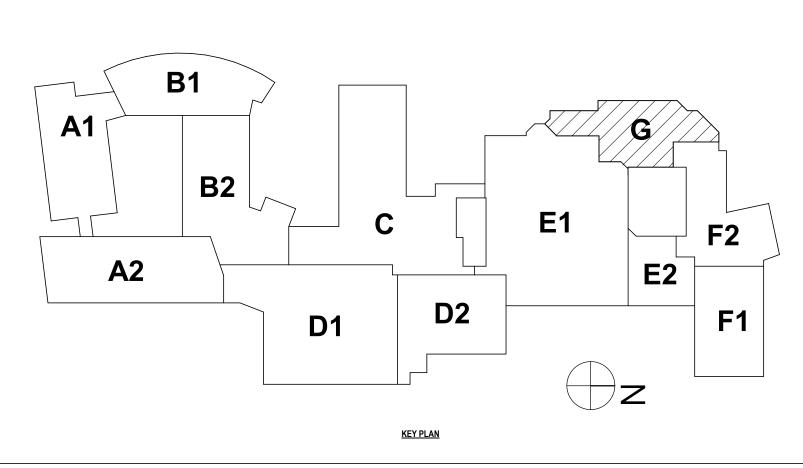BR-A8.10


REFER TO DRAWING A0.0 FOR GENERAL FINISH NOTES.


GENERAL NOTES - INTERIOR WALL FINISH:

REFER TO DRAWING A0.0 FOR GENERAL FINISH NOTES.

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DATE: DESCRIPTION OF REVISION:

1 5/26/2023 ISSUED FOR BID

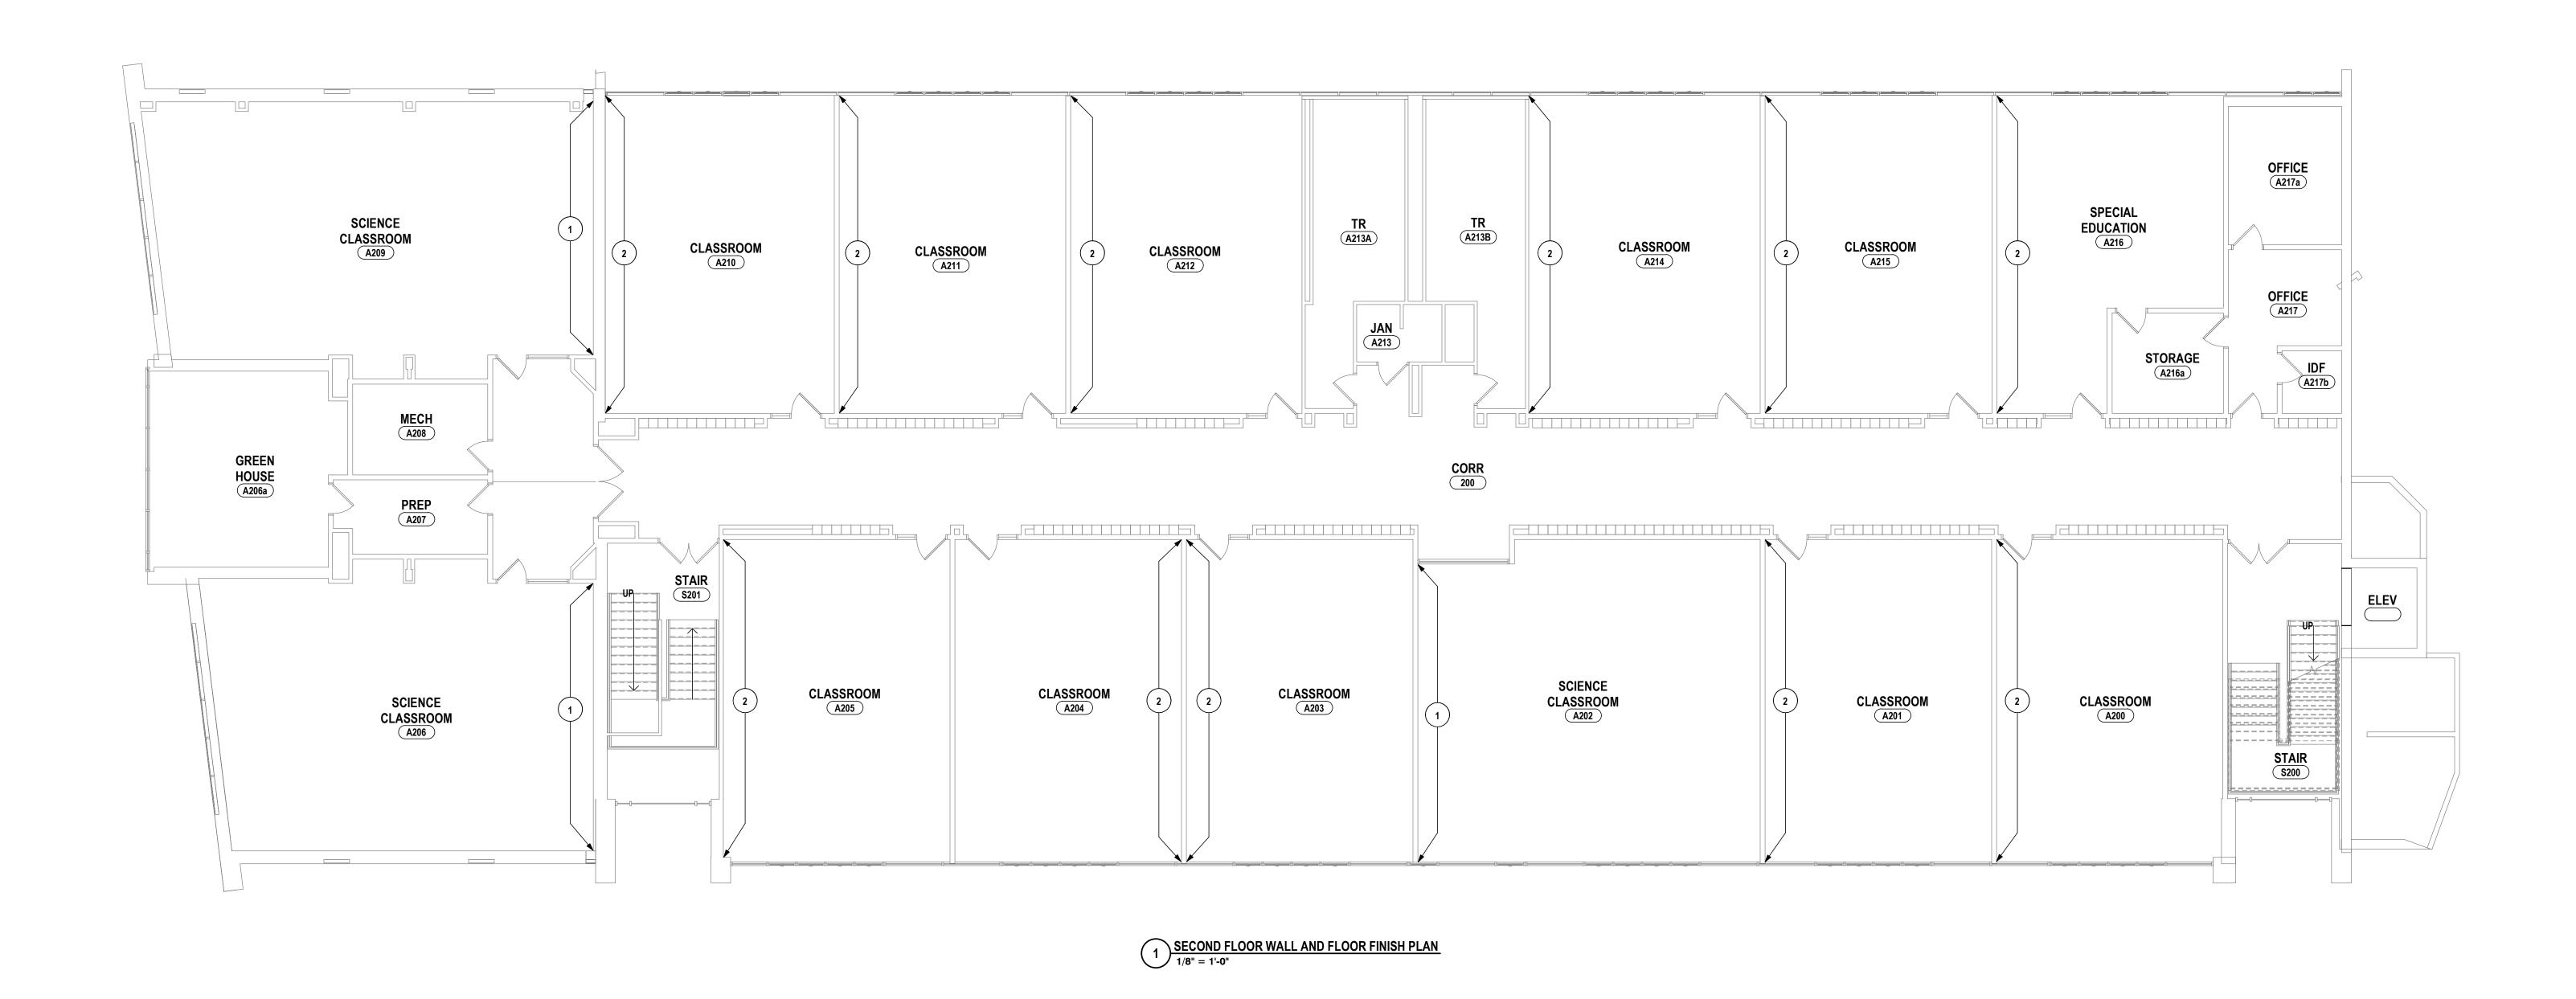2 5/26/2023 ISSUED FOR BID

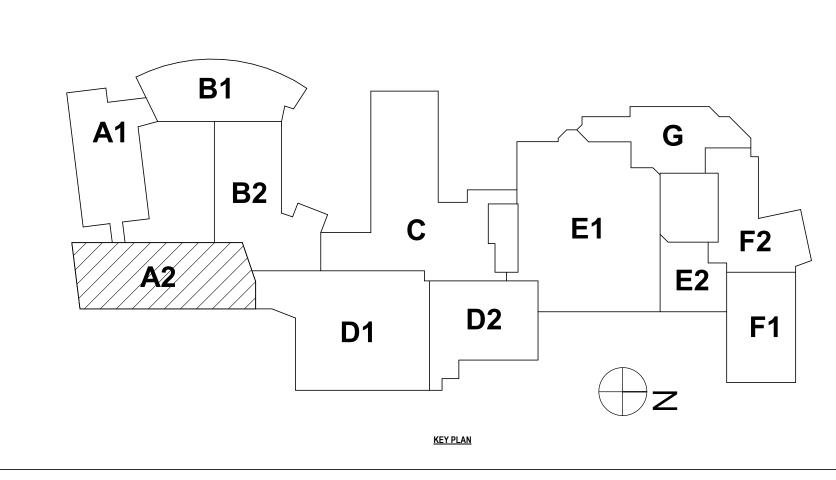3 6/2/2023 ISSUED FOR BID

3 7/2/2023 ISSUED FOR BID

4 7/2/2023 ISSUED FOR BID

5 7/2/2023 ISSUED FOR

HORSEHEADS, NY 607 - 358 - 1000 ROCHESTER, NY 585 - 327 - 7949 TOWANDA, PA 570 - 265 - 4868

D FLOOR WALL AND FLOOR FINISH PLAN - AREA A2
ITARY SCHOOLS 2023 RENOVATIONS (PHASE II)
CITY SCHOOL DISTRICT

BR-A8.1

ROOM FINISH SCHEDULE - BROADWAY

DOOR FRAME | CEILING | COUNTERTOP |

ROOM FINISH SCHEDULE GENERAL NOTES:
1. REFER TO MASTER FINISH KEY FOR MATERIAL DEFINITIONS.
2."ETR": EXISTING TO REMAIN
3. "PTM": PATCH TO MATCH EXISTING, ADJACENT FINISHES

PTM (CPT-3)

PTM (CPT-3)

PTM (VCT-1)

PTM (CPT-3)

PTM (CPT-3)

PTM (CPT-3)

PTM (VCT-1)

PTM (VCT-1)

PTM (CPT-3)

PTM (CPT-3)

PTM (CPT-3)

PTM (CPT-3)

PTM (CPT-3)

PTM (CPT-3)

PTM (RB-2)

PTM (PNT-1)

2ND FLOOR - AREA A

CLASSROOM

CLASSROOM

CLASSROOM

CLASSROOM

CLASSROOM
SCIENCE CLASSROOM

CLASSROOM

CLASSROOM

CLASSROOM

CLASSROOM

SPECIAL EDUCATION

SCIENCE CLASSROOM

ROOM NO. ROOM NAME | FLOOR FINISH | BASE FINISH | WALL FINISH

CHE					
CHECKED BY: DATE:					
SCA					
SCA					
# DATE: DESCRIPTION OF REVISION: BY:					

REMARKS

HORSEHEADS, NY 607 - 358 - 1000 ROCHESTER, NY 585 - 327 - 7949 TOWANDA, PA 570 - 265 - 4868


M FINISH SCHEDULE CHOOLS 2023 RENOVATIONS (PHASE II) CHOOL DISTRICT

INTERIOR ROOM FINISH
ELEMENTARY SCHOOLS
ELMIRA CITY SCHOOL DI
ELMIRA, CHEMUNG COUNTY, NEW YORK

BR-A9.1

		IDF A217b
VIRING ZONE 4		WIRING ZONE

SECOND FLOOR TECHNOLOGY KEY PLAN
1/32" = 1'-0"

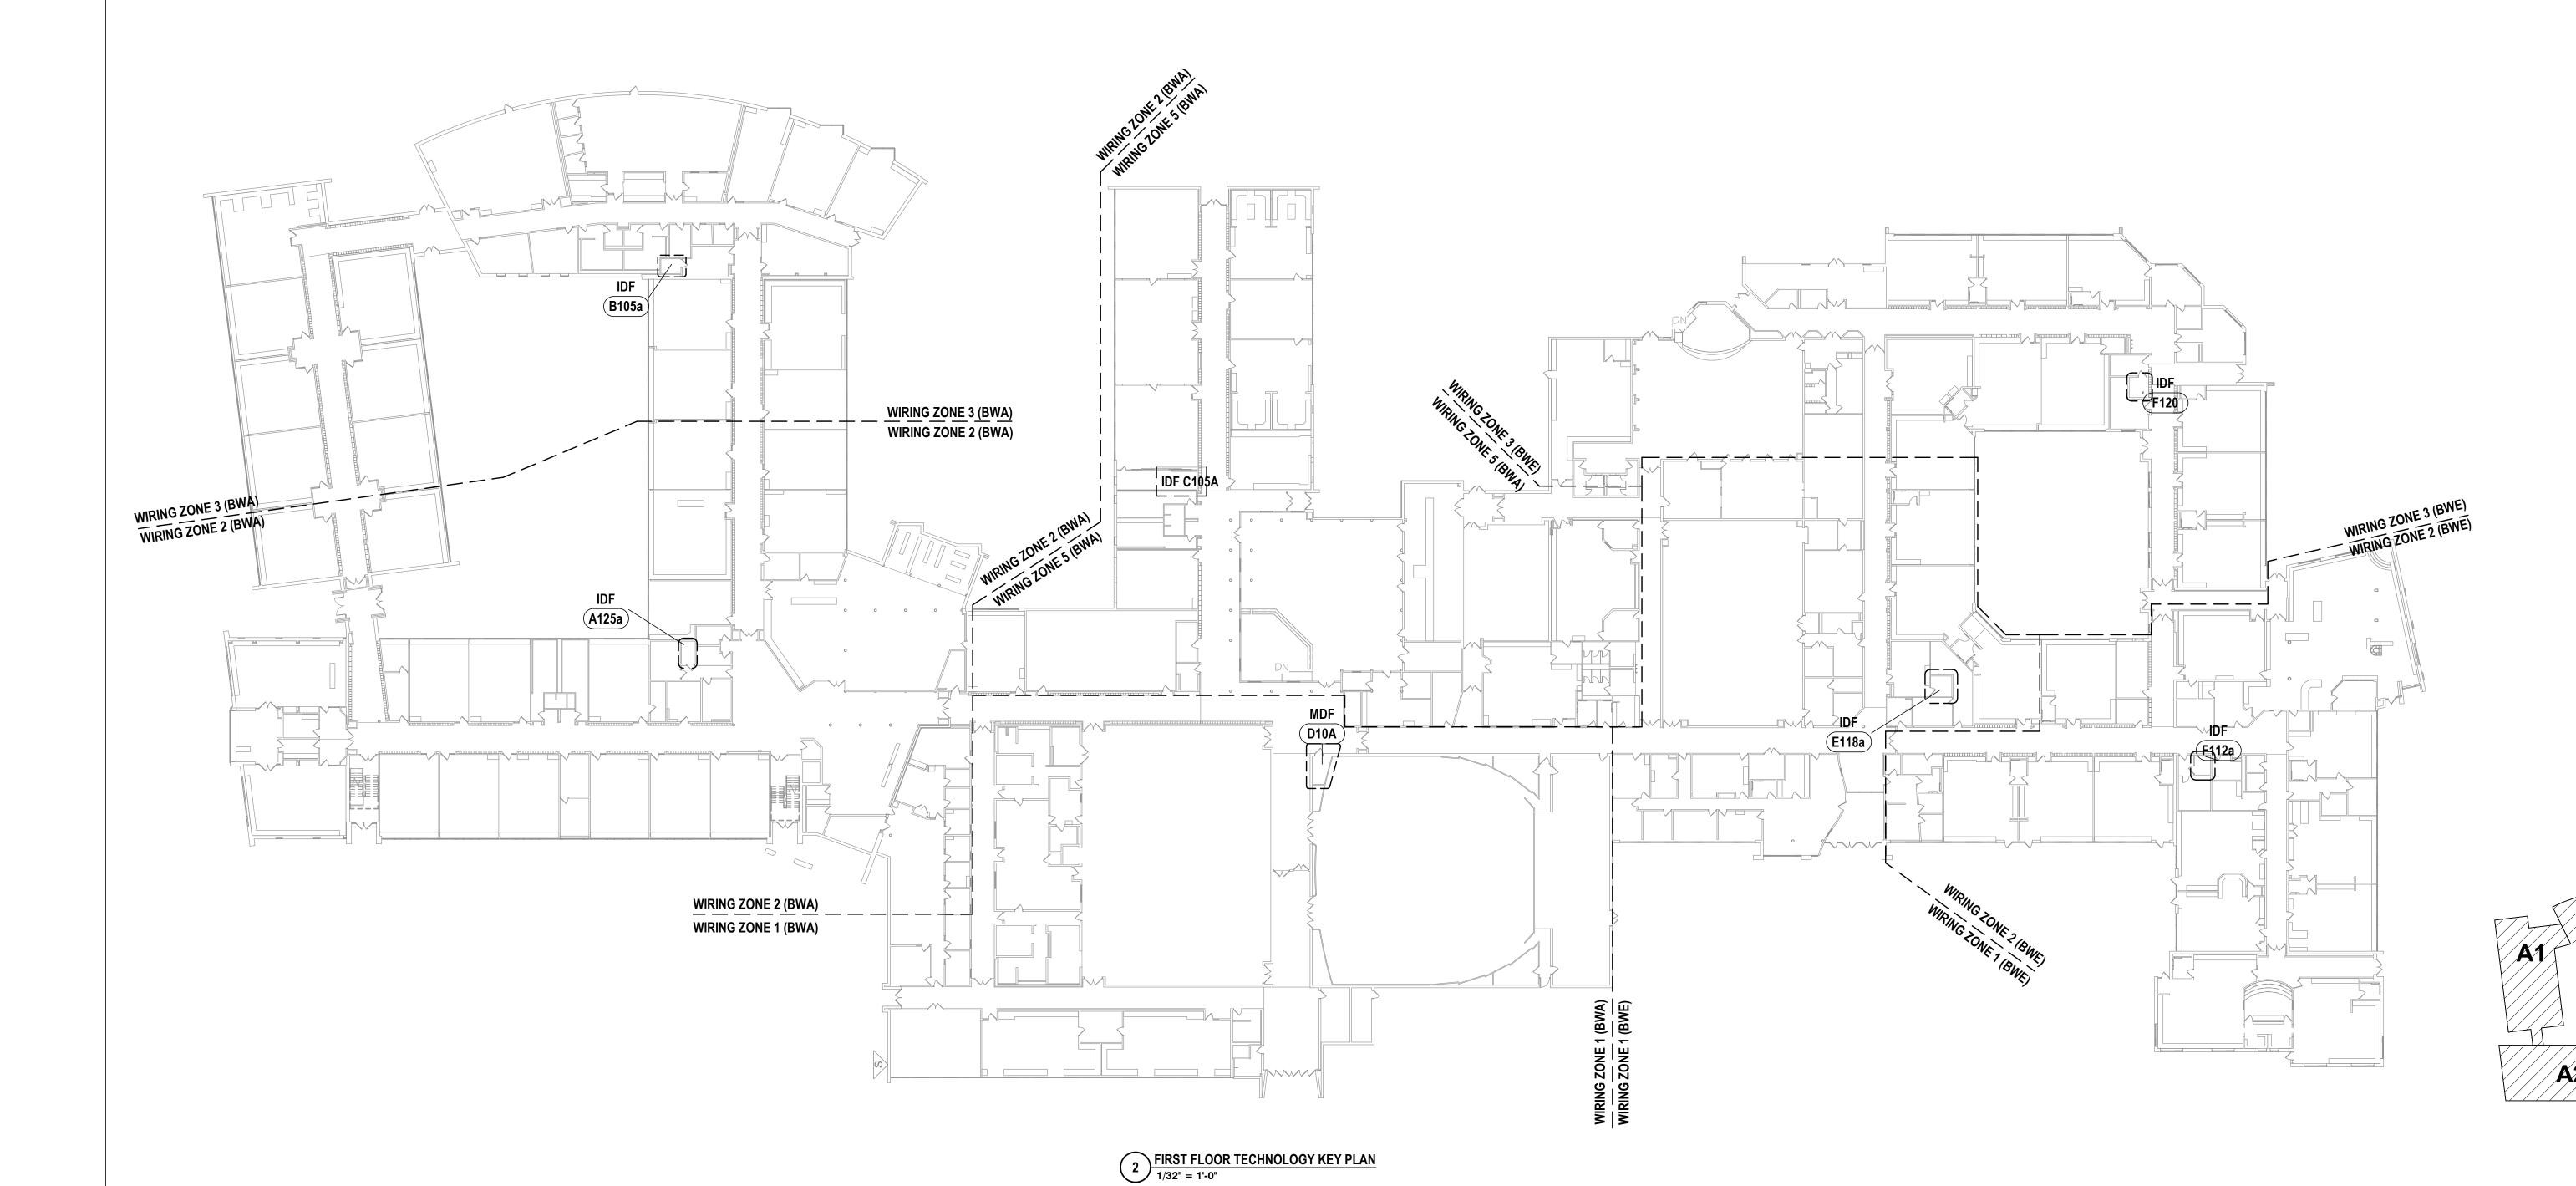

GENERAL NOTES - TECHNOLOGY

- A ALL CABLING INSTALLATION AND TERMINATION TO ADHERE TO CURRENT NEC CODES AND RELATED ANSI/TIA/EIA STANDARDS. B ALL CABLING INSTALLATION AND TERMINATION TO ADHERE TO CURRENT NEC CODES AND
- RELATED ANSI/TIA/EIA STANDARDS. C WHEN INSTALLING CEILING MOUNTED DEVICES, ADJUST LOCATION TO AVOID OTHER CEILING MOUNTED DEVICES SUCH AS EXIT SIGNS, ETC.
- D ALL DATA CABLING SHALL BE PLENUM RATED. E OWNER TO APPROVE FINAL LOCATION AND VIEW OF ALL CAMERAS.
- F ALL ELECTRONIC SERVICES NEED TO BE COORDINATED WITH OWNER PRIOR TO REMOVAL AND DISCONNECTION. G ALL CEILING MOUNTED DEVICES TO BE SUPPORTED BY STRUCTURE ABOVE. DO NOT USE CEILING GRID AS SOLE SUPPORT MECHANISM
- H ALL WALL OUTLETS SHALL BE LOCATED WITHIN 36" OF THE NEAREST POWER OUTLET AND AT THE SAME ELEVATION. ANY DAMAGE DONE TO A FUNCTIONING CABLING SYSTEM IS THE RESPONSIBILITY OF; AND WILL BE
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JLS CHECKED BY: 10/21/2022 | 훈 SCALE: 1/32" = 1'-0"

DRAWN BY:

CSH


S 6 ENGINEERS |

BR-T1.1 PROJECT NO: 2012-233

KEY PLAN

/E1/

B2

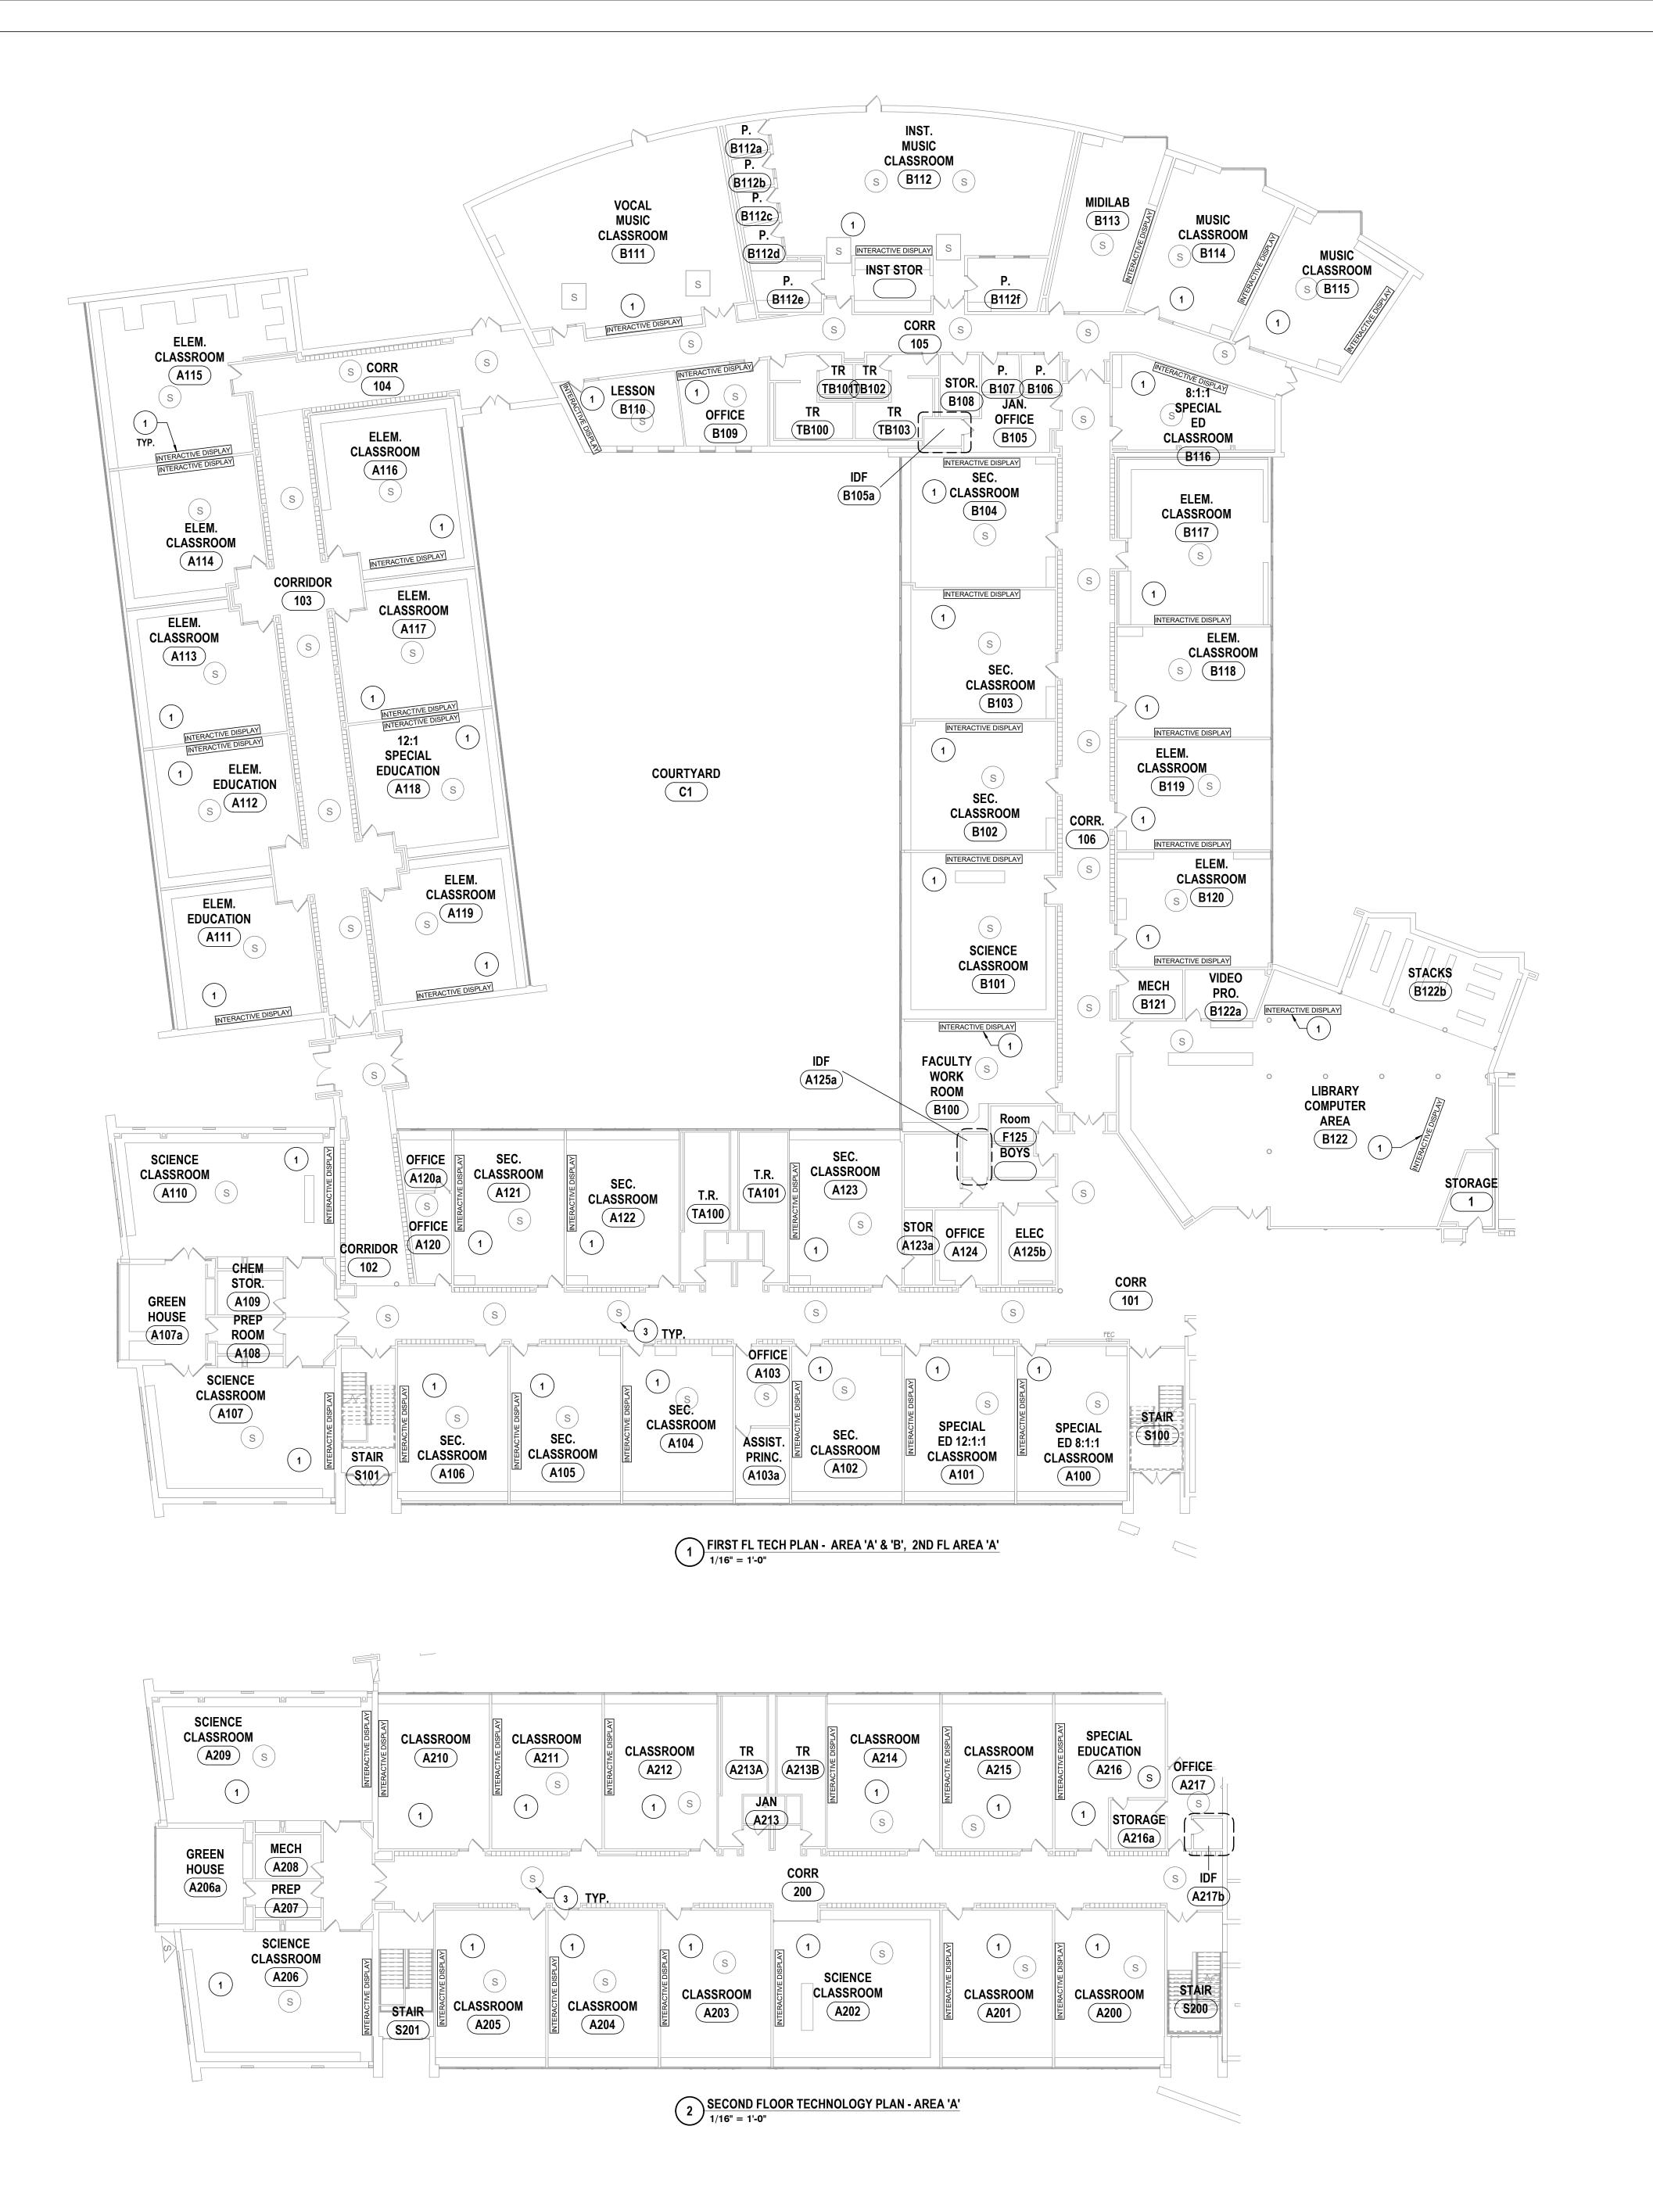

- A ALL CABLING INSTALLATION AND TERMINATION TO ADHERE TO CURRENT NEC CODES AND RELATED ANSI/TIA/EIA STANDARDS.
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CONSTRUCTION NOTES - TECHNOLOGY


B2

D1

KEY PLAN

E1

- 1 INTERACTIVE DISPLAY FURNISHED BY OWNER. PROVIDE (2) TESTED CATEGORY 6A CABLES TO EACH DISPLAY FROM THE NEAREST TELECOMMUNICATIONS ROOM.
- DIGITAL SIGN TO BE INSTALLED. PROVIDE COMMUNICATIONS OUTLET WITH (1) TESTED CATEGORY 6A CABLE AT DISPLAY LOCATION, PER SPECIFICATIONS. DISTRIBUTE CABLING FROM NEAREST
- TELECOMMUNICATIONS ROOM. 3 ALTERNATE BR-1: PAGING SYSTEM REPLACEMENT BY SYSTEM INTEGRATOR. PAGING SYSEM HEADEND AND SPEAKERS TO BE REPLACED.

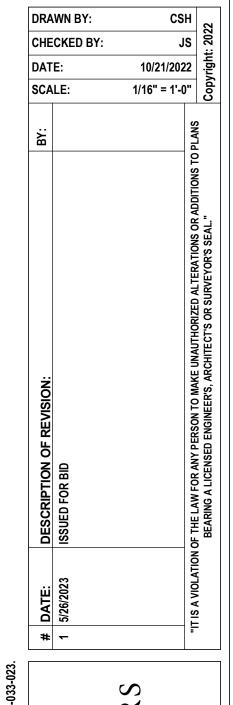


S ARCHI ENGINEERS |

ARE 2ND FL AREA 'A' & LS 2023 RE DISTRICT YEOLC FLOOR TECHNO

FIRST

BR-T1.2 PROJECT NO: 2012-233

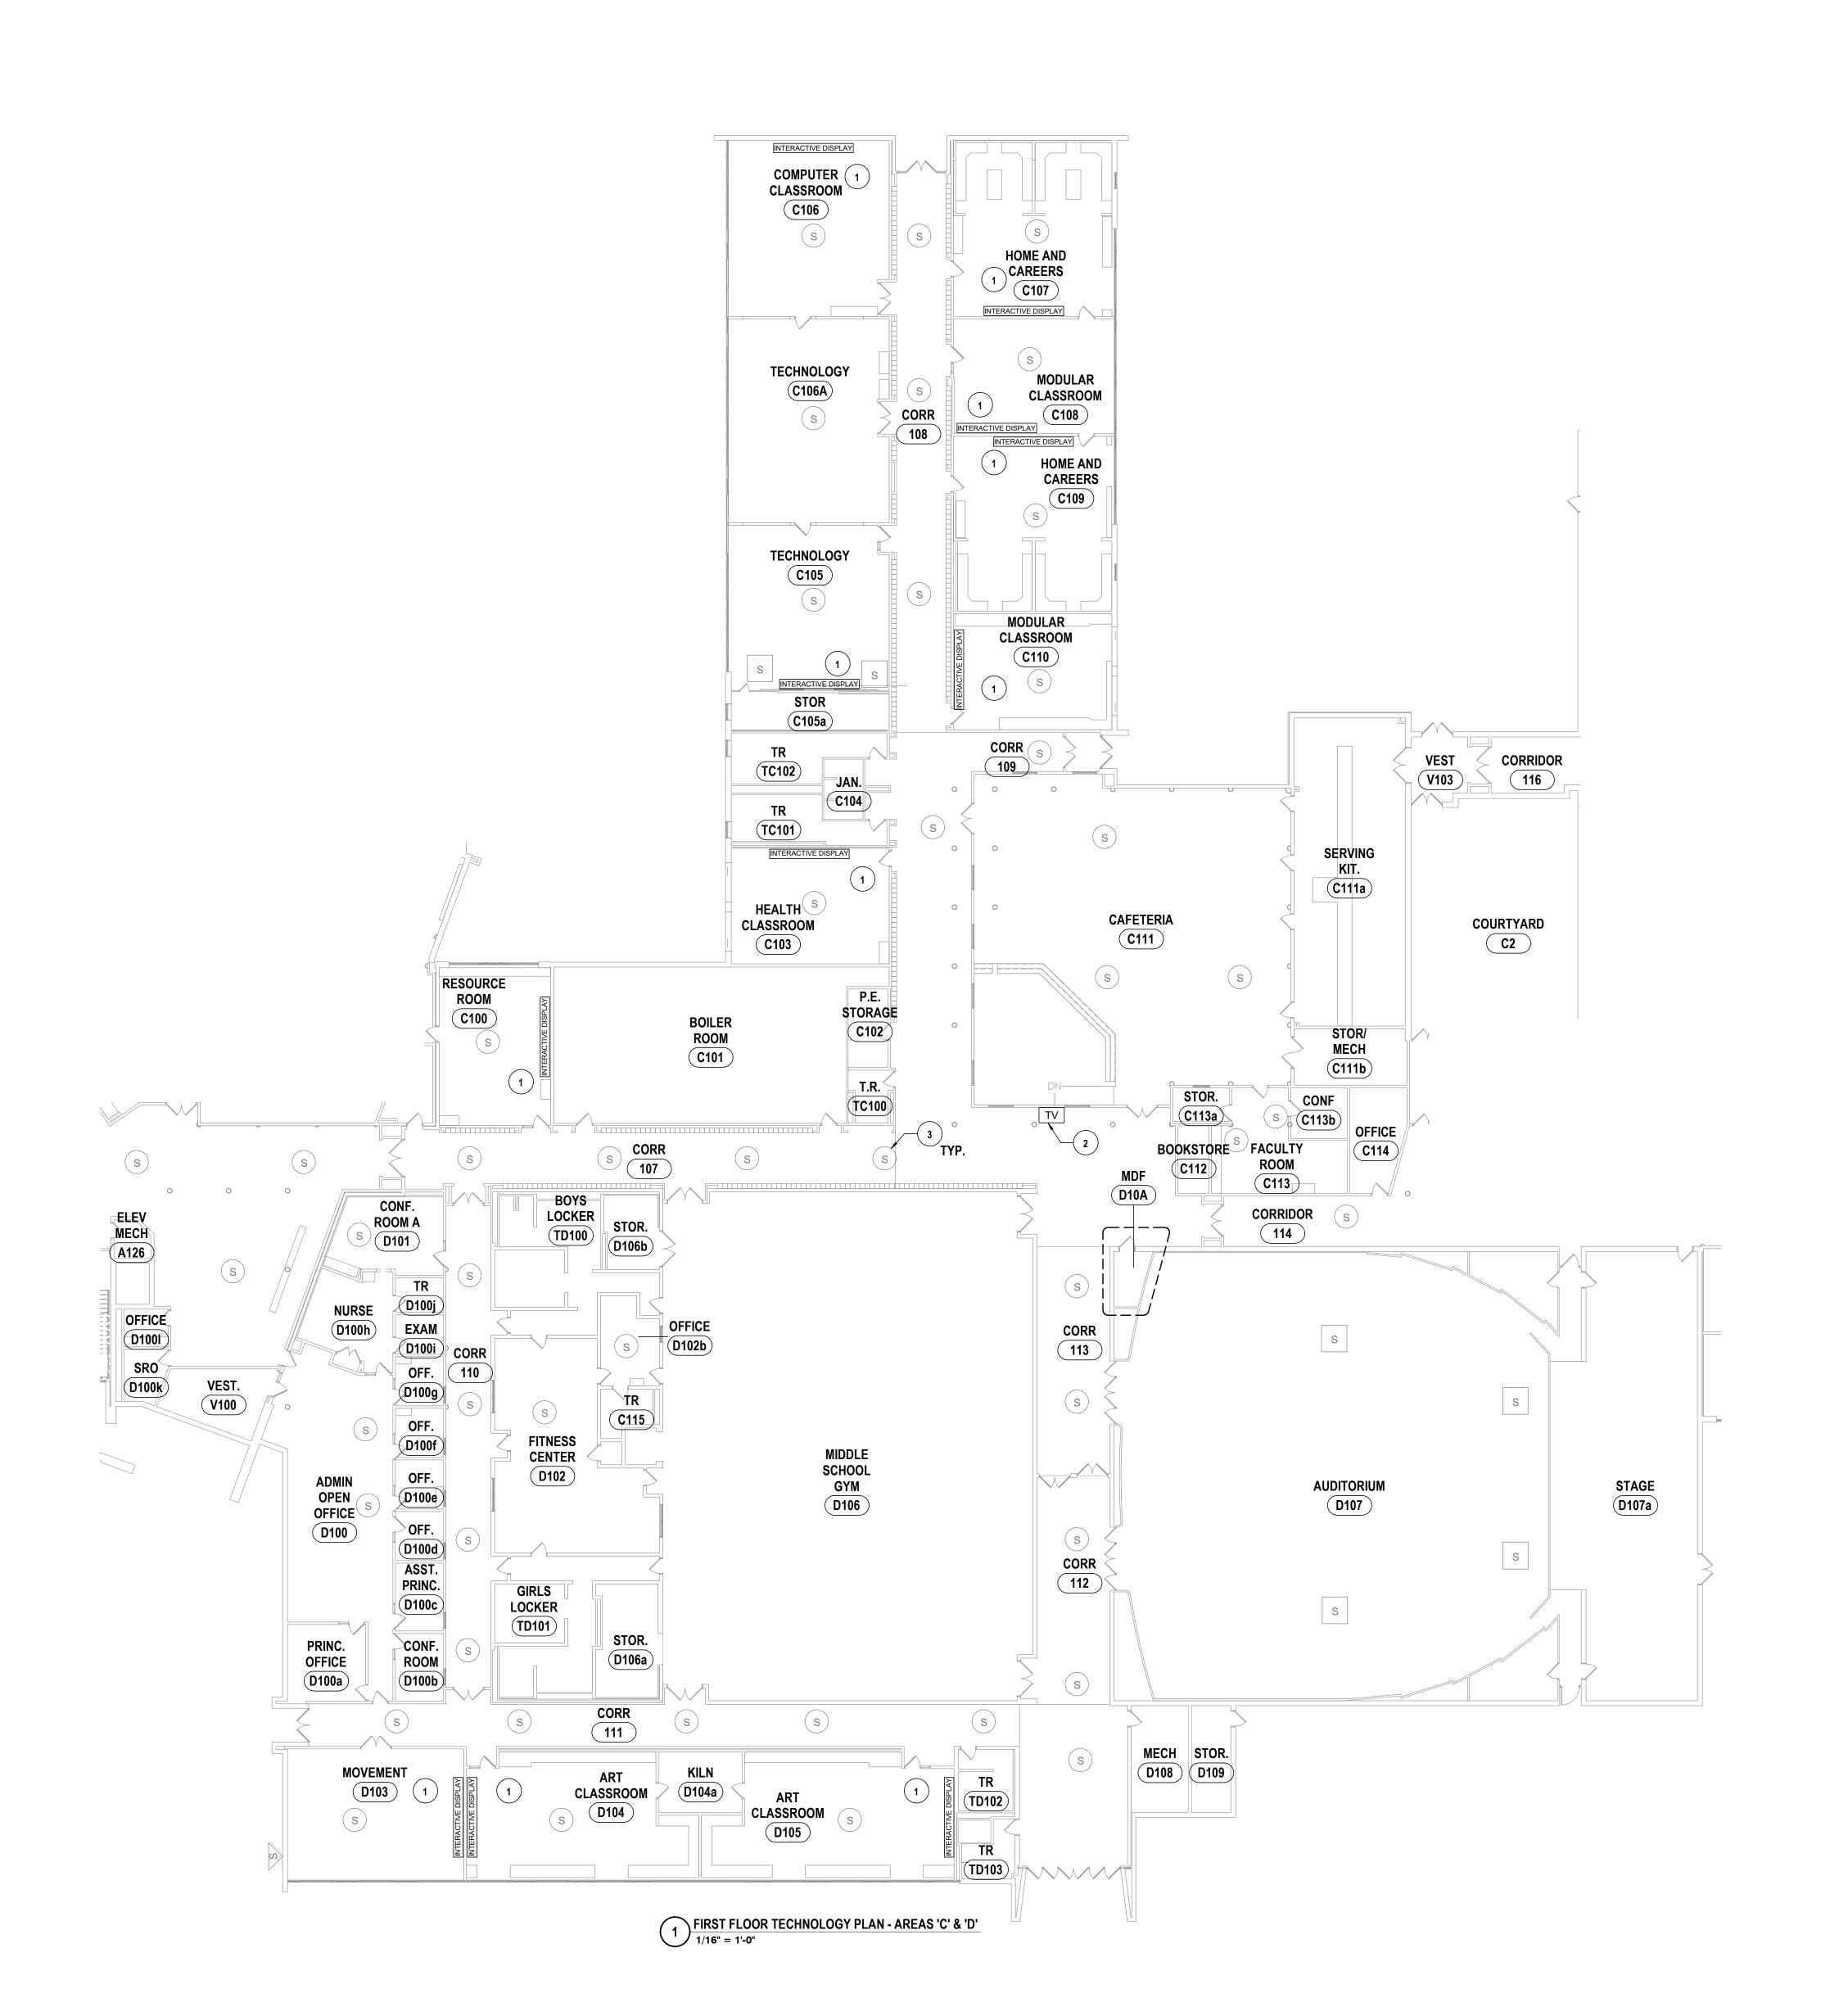

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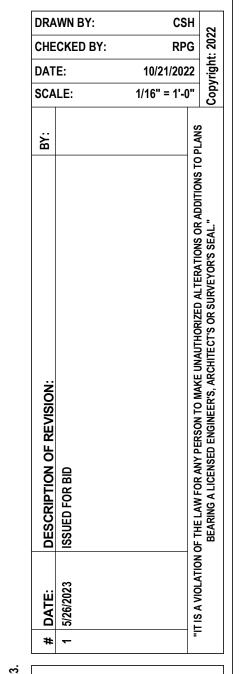
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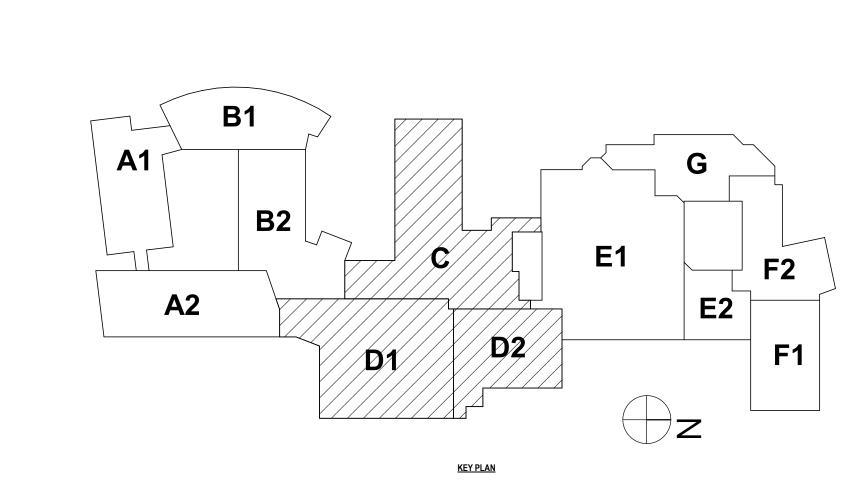



HORSEHEADS, NY 607 - 358 - 1000 ROCHESTER, NY 585 - 327 - 7949 TOWANDA, PA 570 - 265 - 4868

ST FLOOR TECHNOLOGY PLAN - AREAS C & D

IMENTARY SCHOOL DISTRICT

BR-T1.3



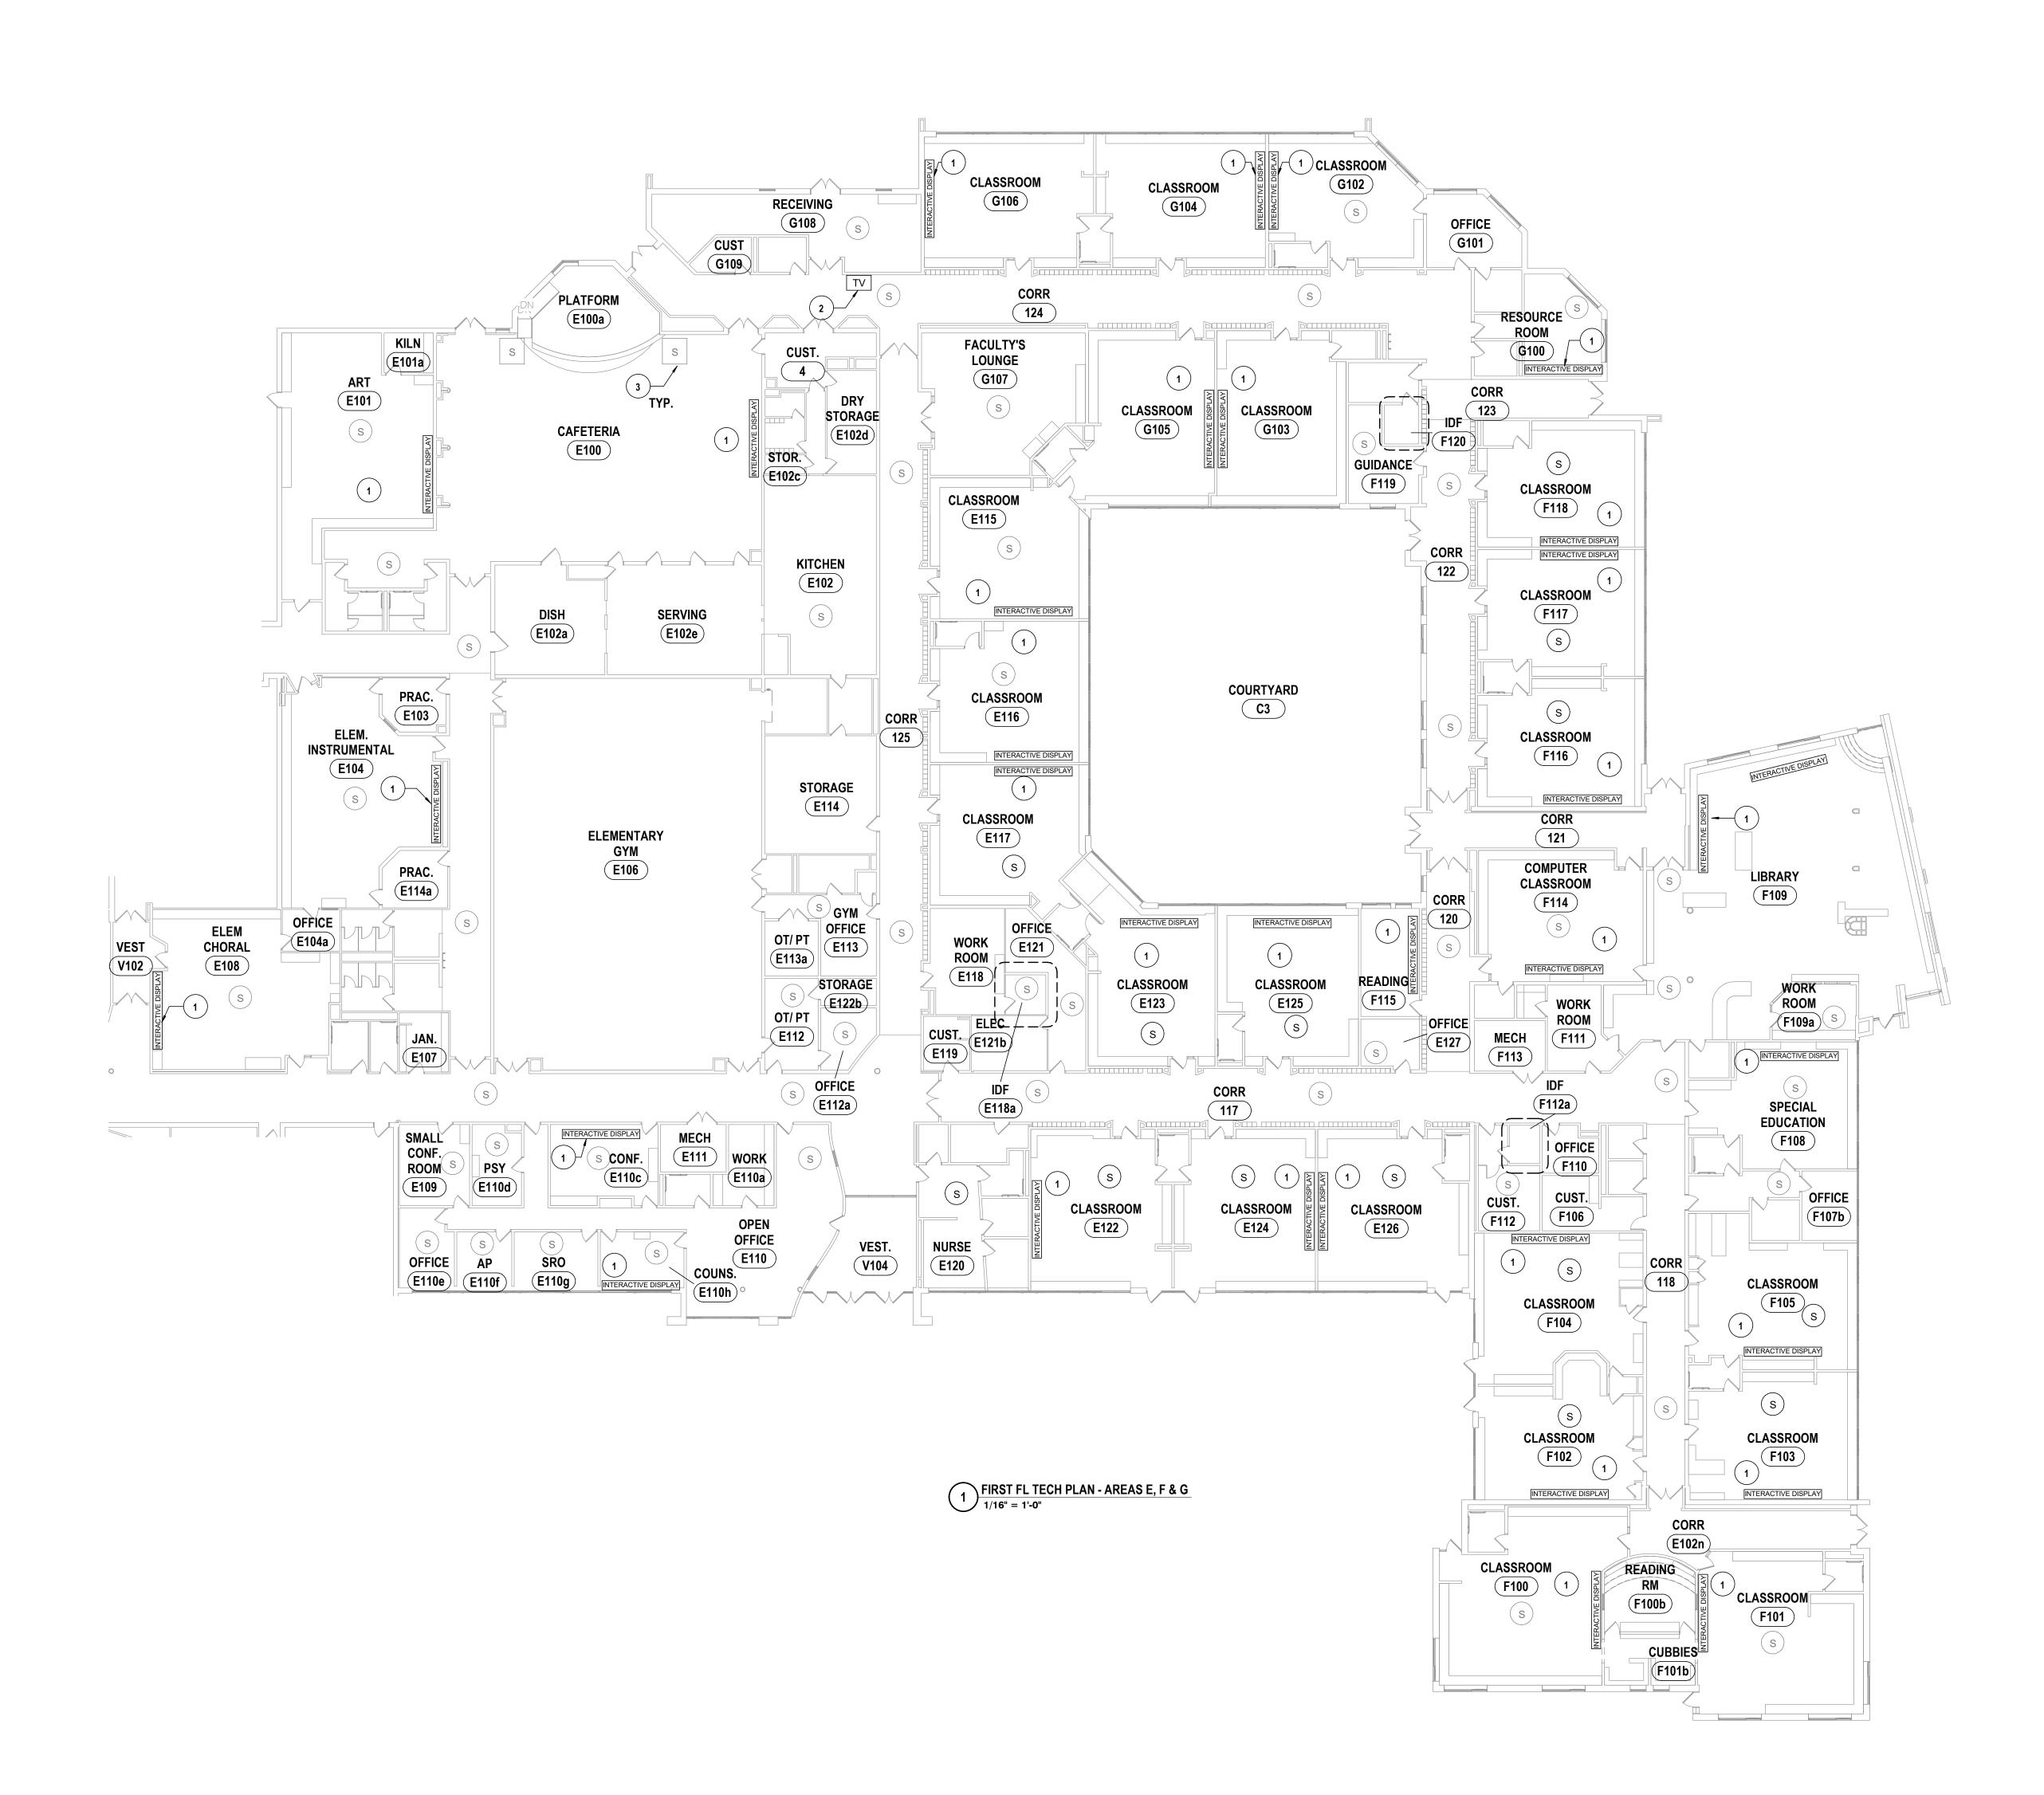

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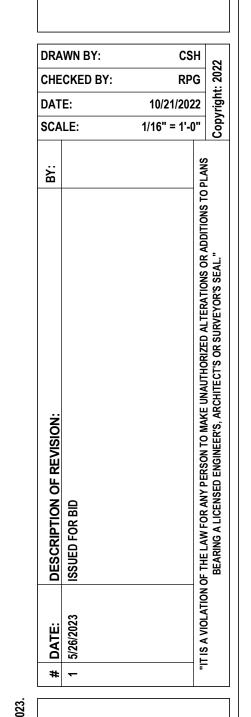
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CONSTRUCTION NOTES - TECHNOLOGY

SPECIFIED IN SECTION 08 71 00; VOLTAGE TO BE V.I.F.

TELECOMMUNICATIONS ROOM.


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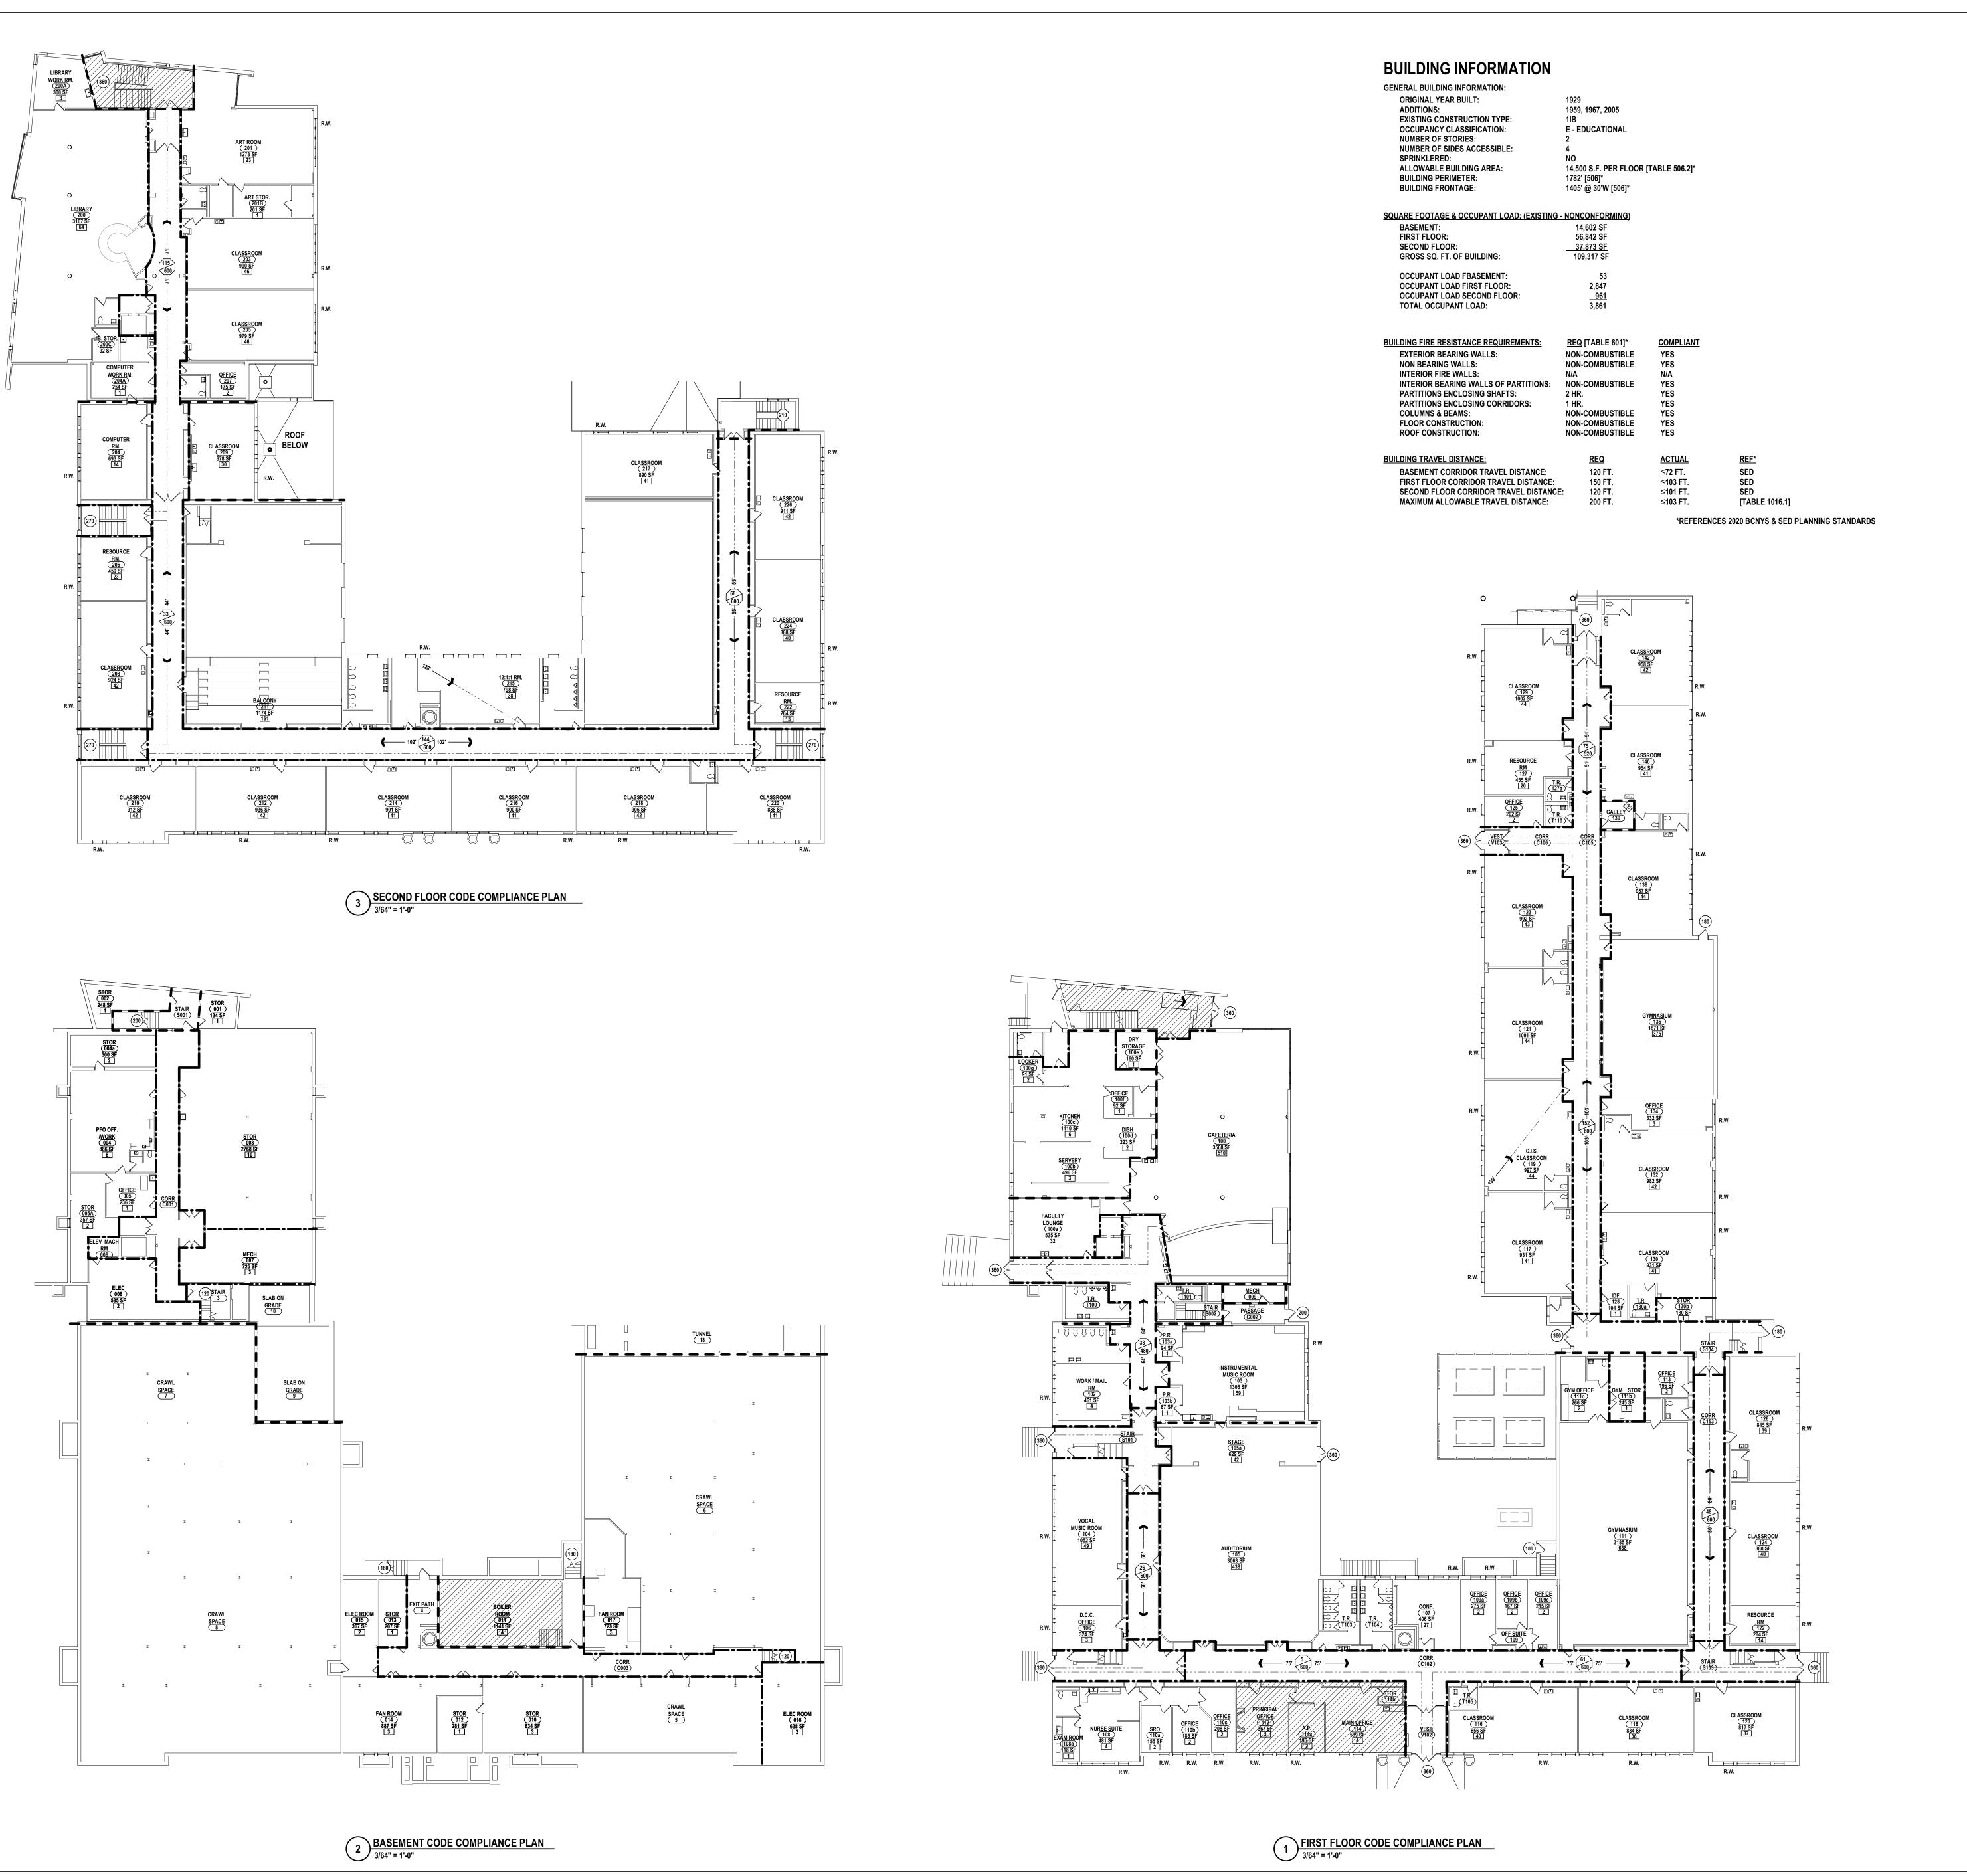


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FLOOR TECHNOLOGY PLAN - AREAS E, F & G
ENTARY SCHOOLS 2023 RENOVATIONS (PHASE
RA CITY SCHOOL DISTRICT

BR-T1.4



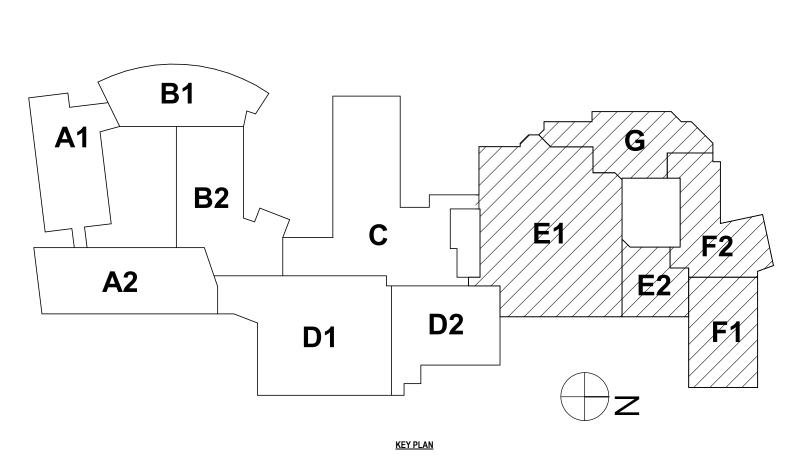

GRAPHIC KEY - CODE COMPLIANCE

R.W. RESCUE WINDOW + LABEL U.N.O.

HANDICAP ACCESSIBLE

E.C. FIRE EXTINCUISHED CARINET

F.E.C. FIRE EXTINGUISHER CABINET

F.E.C. NEW FIRE EXTINGUISHER & CABINET

D.F. DRINKING FOUNTAIN

1 HOUR FIRE PARTITION (ALL CORRIDOR WALLS)

2 HOUR FIRE BARRIER
4 HOUR FIRE WALL

PATH OF EGRESS

EXIT ACCESS TRAVEL DISTANCE. DENOTES THE MAXIMUM DISTANCE TRAVELED TO A BUILDING EXIT OR STAIRWELL ENCLOSURE IN EACH DIRECTION

COMMON PATH OF EGRESS TRAVEL. DENOTES THE TOTAL DISTANCE TRAVELED BETWEEN EXITS

OCCUPANT LOAD (MAXIMUM ALLOWABLE OCCUPANT LOAD, ACTUAL OCCUPANCY BASED ON HOME ROOM & STAFF OCCUPANCY)

EXIT DOOR OCCUPANT CAPACITY
EXIT WIDTH @ 0.2"/OCC. = OCCUPANT CAPACITY
STAIR WIDTH @ 0.3"/OCC. = OCCUPANT CAPACITY

*CUMULATIVE OCCUPANT LOAD
**MAX CORRIDOR OCCUPANT CAPACITY

ALTERATION LEVEL 1 - 2,340 SF

* "CUMULATIVE OCCUPANT LOAD" DETERMINED BY ADDING ALL OCCUPANTS FROM SPACES DISCHARGING INTO CORRIDOR AND DIVIDING BY NUMBER OF PATHS OF EGRESS (TYPICALLY 2)

** "MAX CORRIDOR OCCUPANT CAPACITY" DETERMINED BY DIVIDING CORRIDOR WIDTH (IN INCHES) BY 0.2"/OCC

S

DRAWN BY:

SCALE:

CHECKED BY:

KAB

scc

10/21/2022

As indicated

D

CODE COMPLIANCE


EMENTANDY SCHOOL SO 2003 DENIONATIONS (DUACE II)

COL ELMIRA, ELMIRA, ELMIRA,

ABATEMENT PLAN DRAWING NOTES:

1 REMOVE ALL BUILT UP ROOF FLASHING, ROOF CEMENT, CONTAMINATED SHEET METAL AND BUILT UP ROOF MEMBRANE

ON EXISTING CONCRETE DECK 2 REMOVE ROOF FLASHINGS AND MASTIC / CEMENT AS ASBESTOS CONTAINING MATERIAL

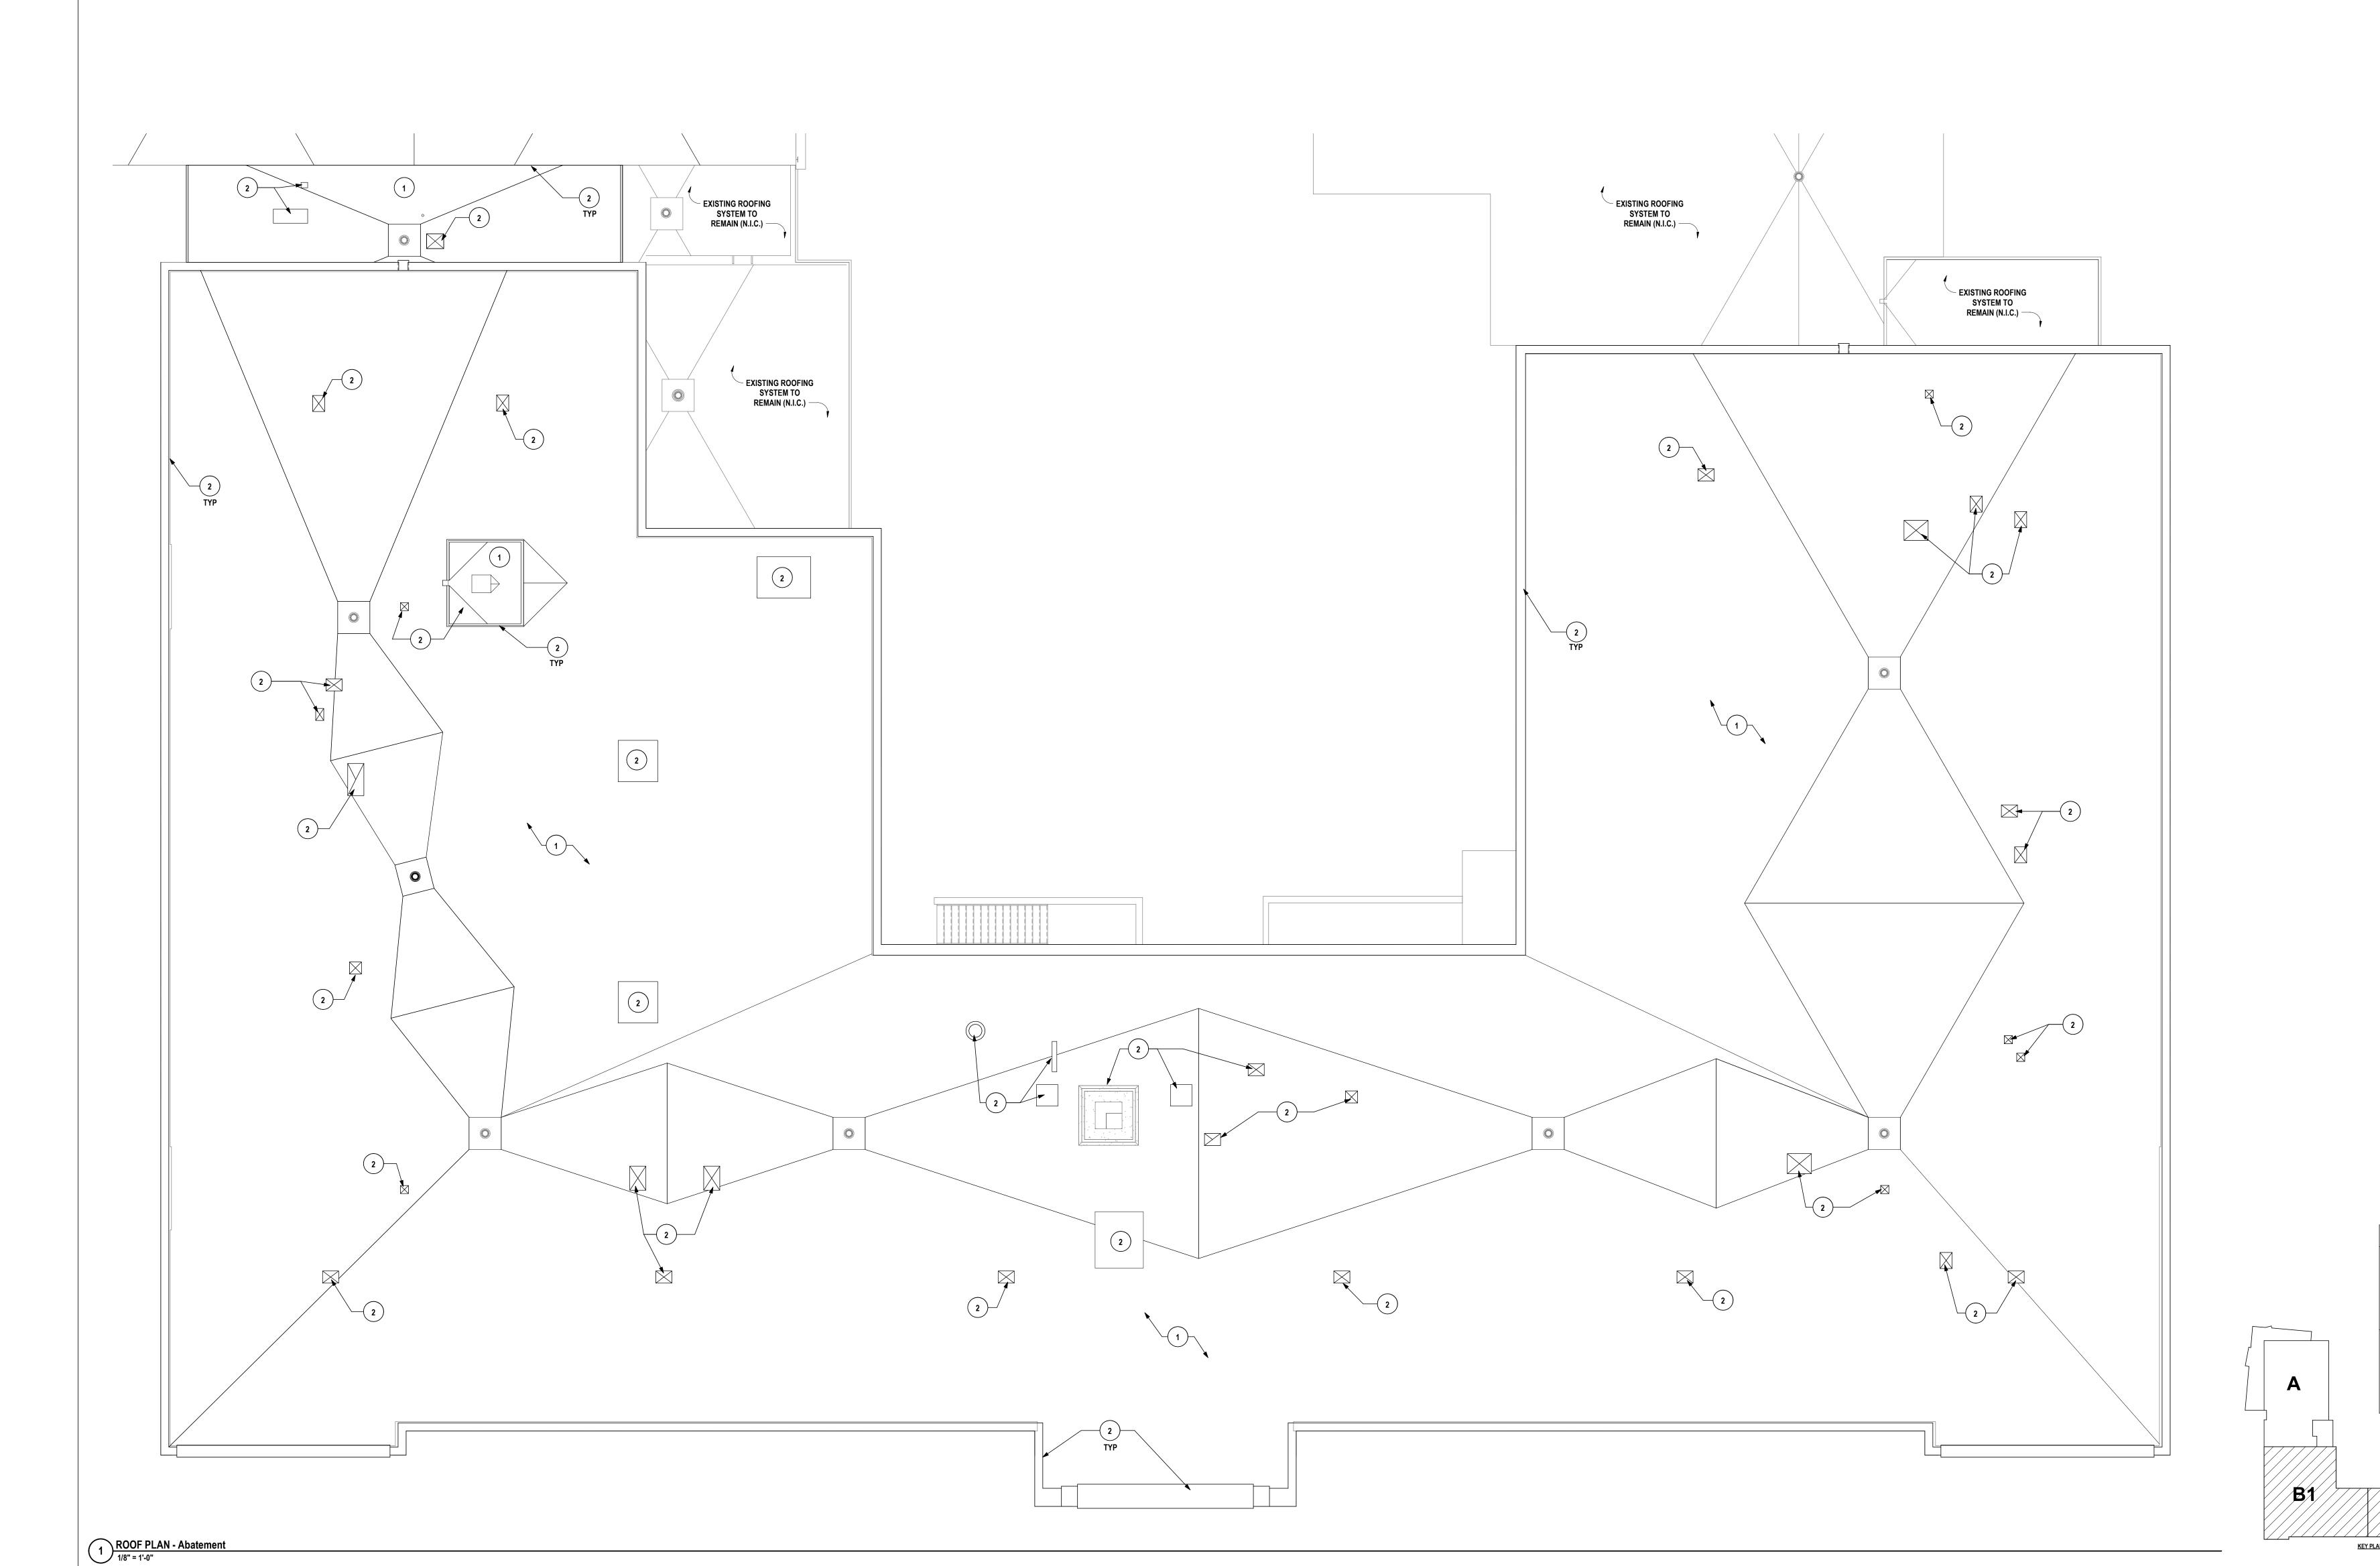

10/21/2022 ្តែ SCALE: 1/8" = 1'-0"

scc

DRAWN BY:

CHECKED BY:

SU.

LS 2023 RENOVATIONS (PHASE II) DISTRICT

C2

CB-AB1.1

GENERAL DEMO NOTES:

REFER TO DRAWING A0.0 FOR GENERAL DEMOLITION PLAN NOTES.

DEMOLITION NOTES:

- D1 REMOVE CARPET FLOORING IN ITS ENTIRETY, PREPARE EXISTING CONCRETE SLAB FOR NEW FLOORING
- D2 REMOVE VCT FLOORING IN ITS ENTIRETY, PREPARE EXISTING CONCRETE SLAB FOR NEW FLOORING
 D3 REMOVE RUBBER FLOORING AND RUBBER STAIR TREADS AND RISERS IN THEIR ENTIRETY TO EXTENTS
 SHOWN ON PLAN.

CHE DAT SCA		SC 10/21/202 1/8" = 1'-0	C 22	Copyright: 2022
DESCRIPTION OF REVISION:	ISSUED FOR BID		"IT IS A VIOLATION OF THE LAW FOR ANY PERSON TO MAKE LINALITHORIZED ALTERATIONS OR ADDITIONS TO PLANS	BEARING A LICENSED ENGINEER'S, ARCHITECT'S OR SURVEYOR'S SEAL."
	5/26/2023		I ATION	

SURVEYORS

ENGINEERS | ARCHITEC

S 2023 RENOVATIONS (PHASE DISTRICT

CB-A0.1


PROJECT NO: 2012-233

FLOOR DEMO PLAN - AREA B1

C2
C1
N
B1
B2

DEMOLITION NOTES:

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3 SAMPHINE SOURCE SOURCE

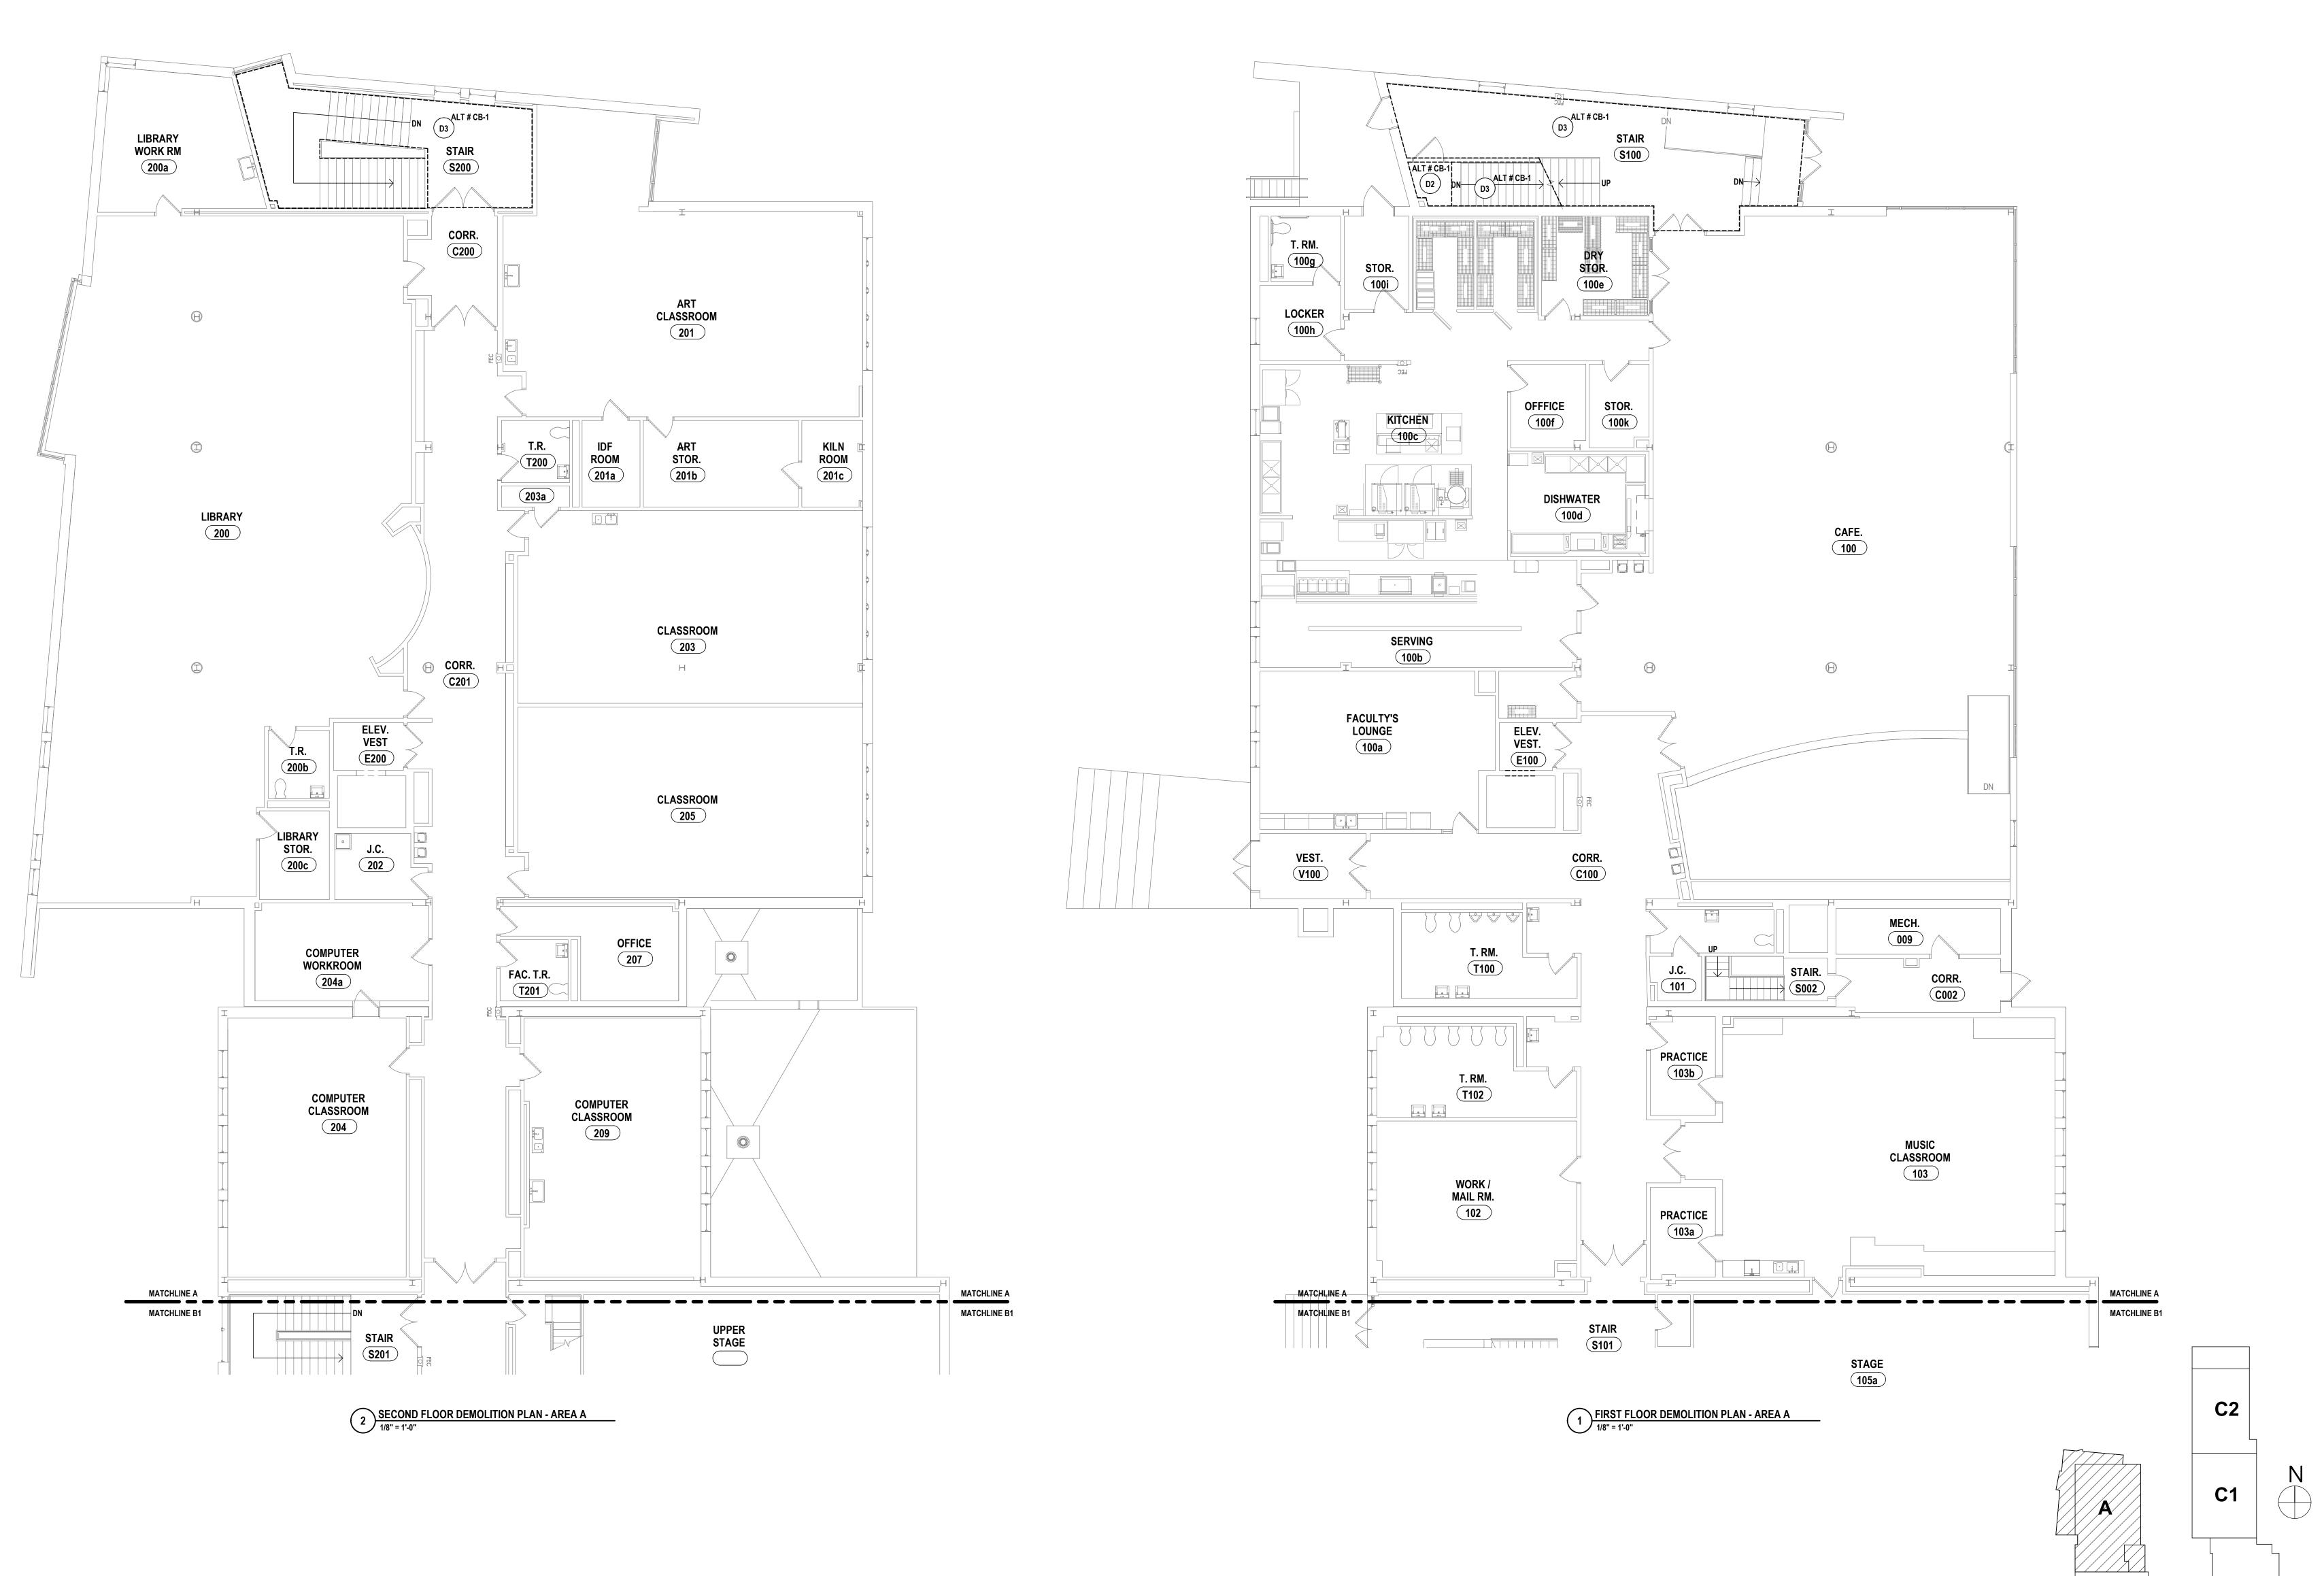HORSEHEADS, NY 607 - 358 - 1000 ROCHESTER, NY 585 - 327 - 7949 TOWANDA, PA 570 - 265 - 4868

CADEMY SED #: 07-06-00-01-0-034-022. COBURN ELEMENTARY SED #: 07-06-00-01-0-002-019. DIVEN ELEMENTARY

OND FLOOR DEMO PLAN - AREA A

CHOOLS 2023 RENOVATIONS (PHASE II)

FIRST AND SECOND FLOOR DEMO PL
ELEMENTARY SCHOOLS 2023 RENOVA
ELMIRA CITY SCHOOL DISTRICT
ELMIRA, CHEMUNG COUNTY, NEW YORK


CB-A0.2

PROJECT NO: 2012-233

B1

B2



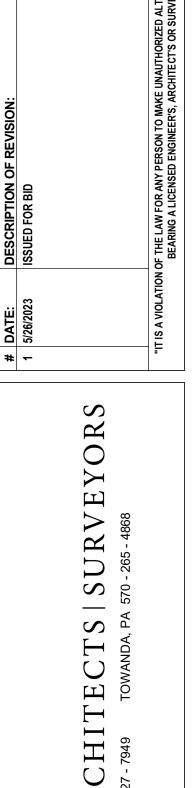

10/21/2022 1/8" = 1'-0"

ENGINEERS | ARCHITEC

VATIONS (PHASE FLOOR PLAN - AREA A LS 2023 RE DISTRICT HOOL SECOND AND

FIRST


C2

C1


B2


KEY PLAN

CB-A1.1 PROJECT NO: 2012-233

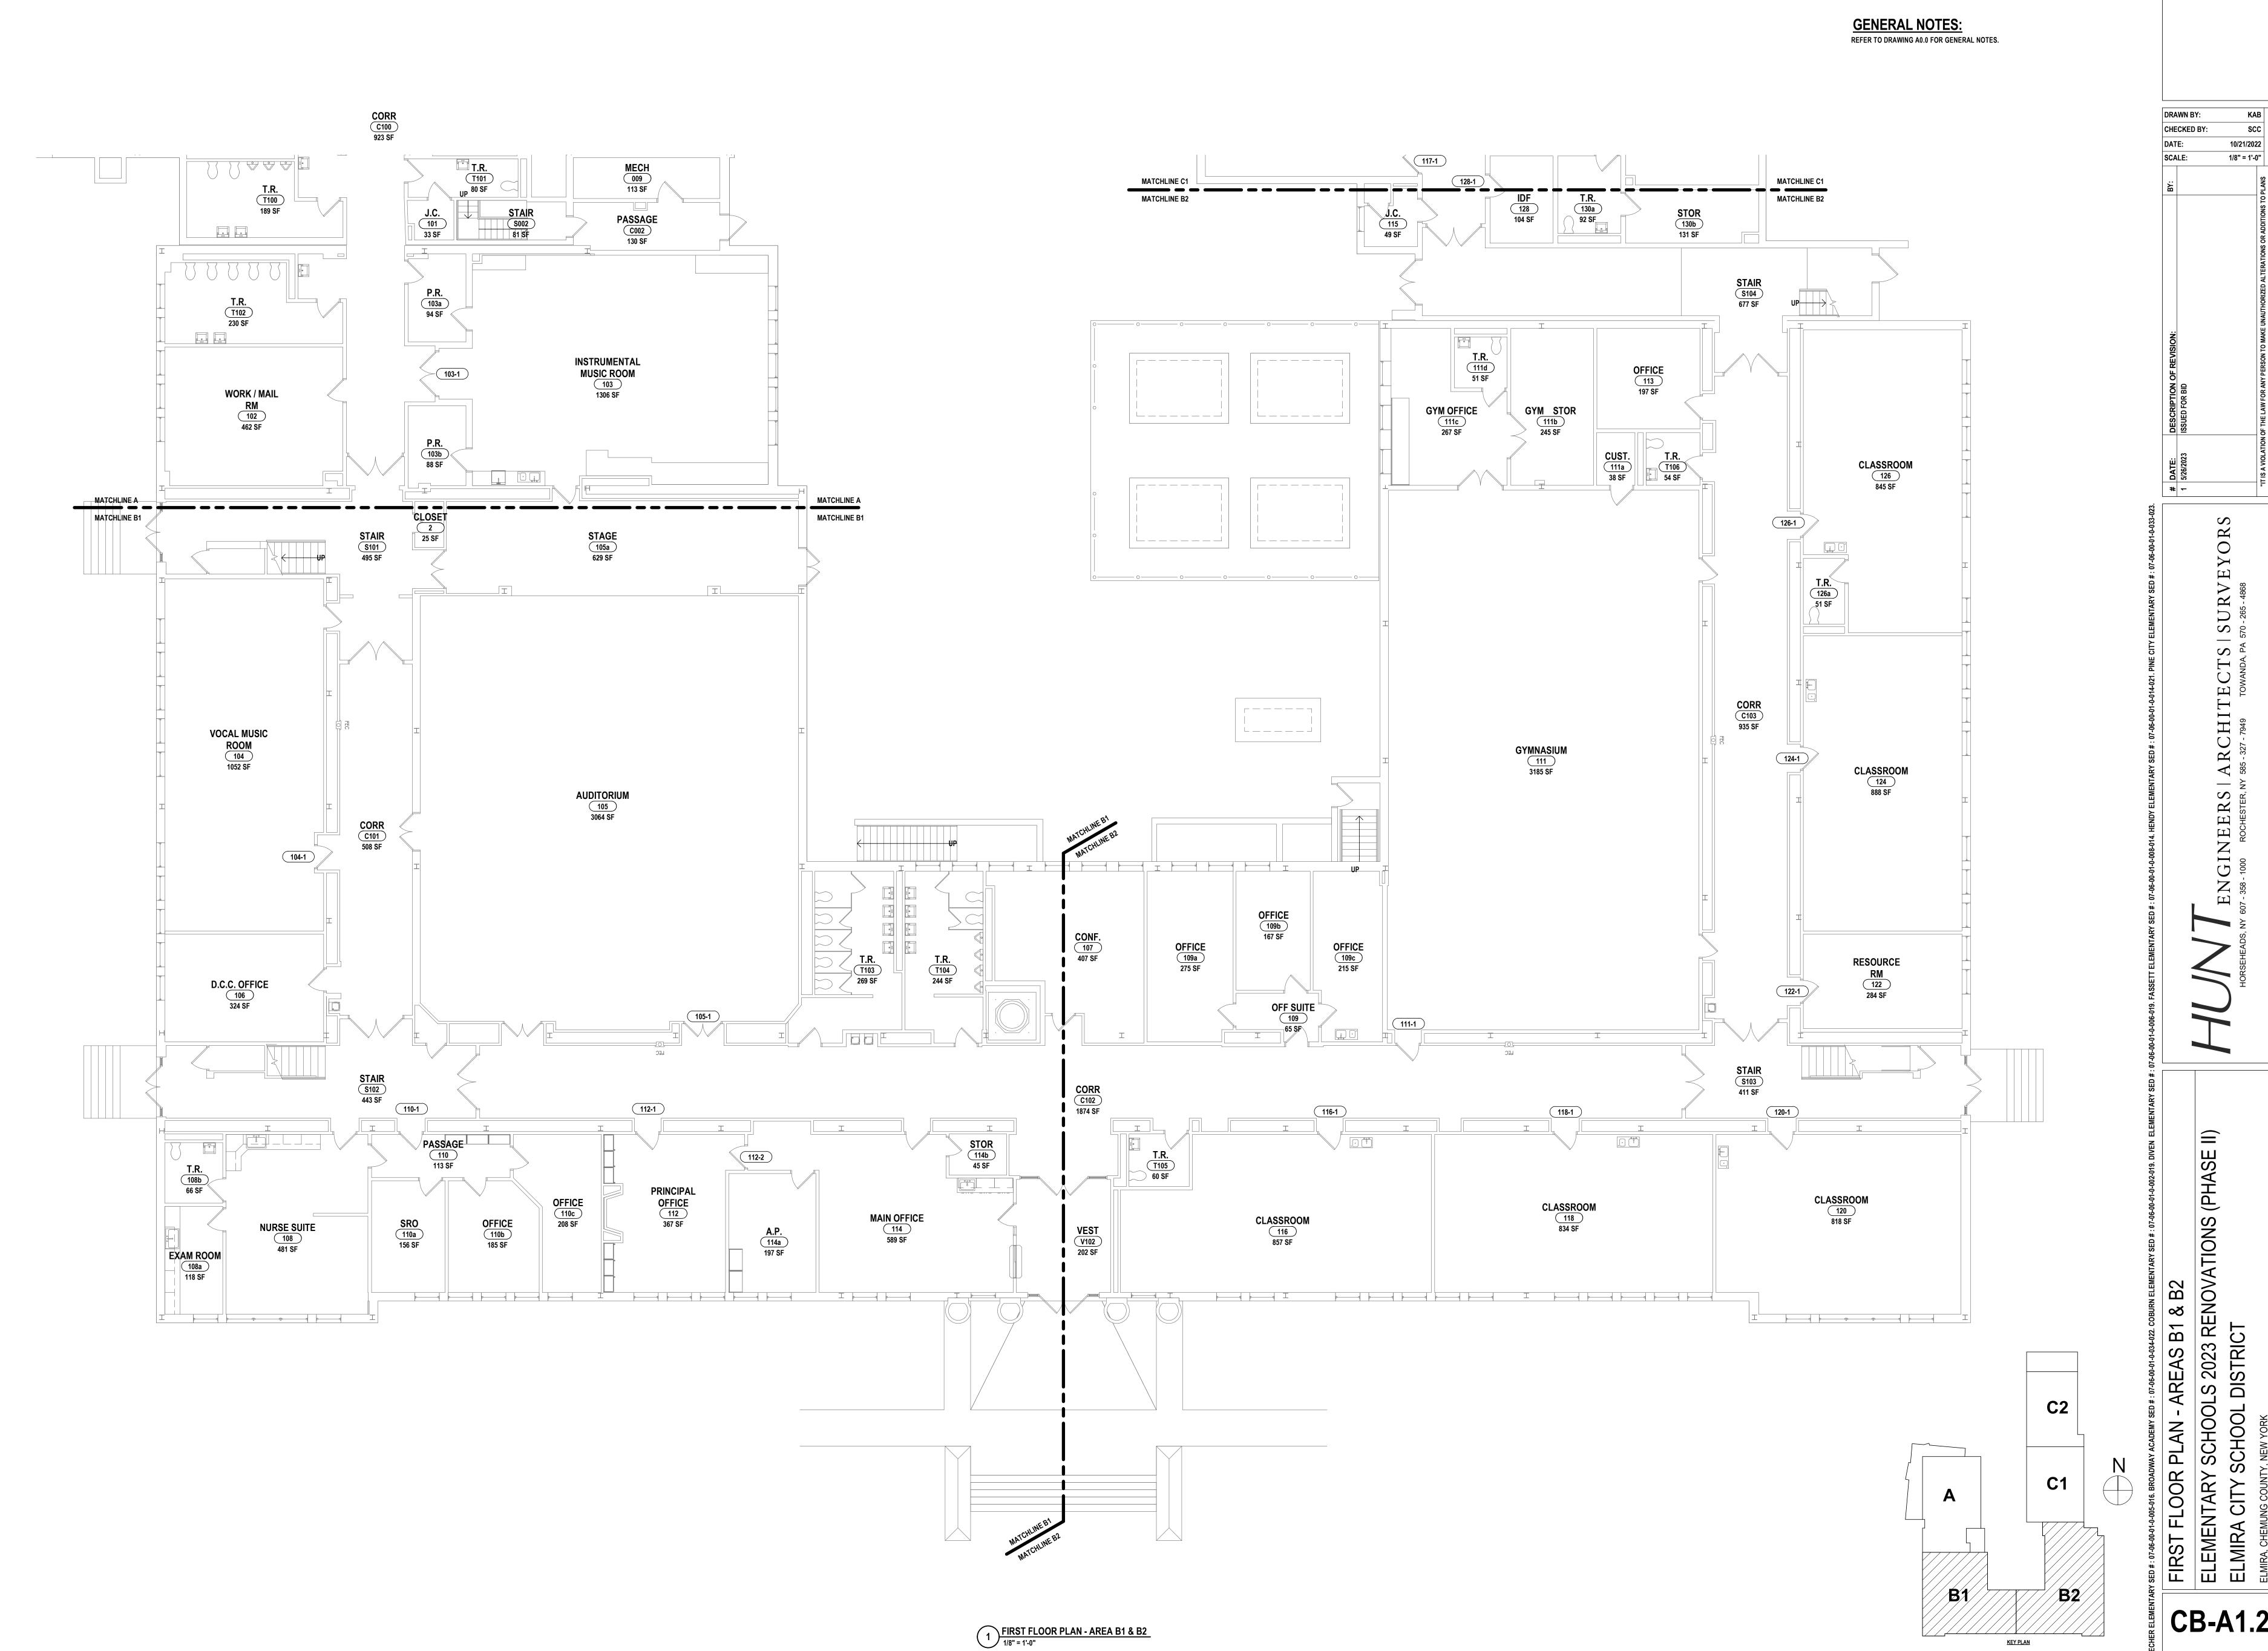

CB-A1.2

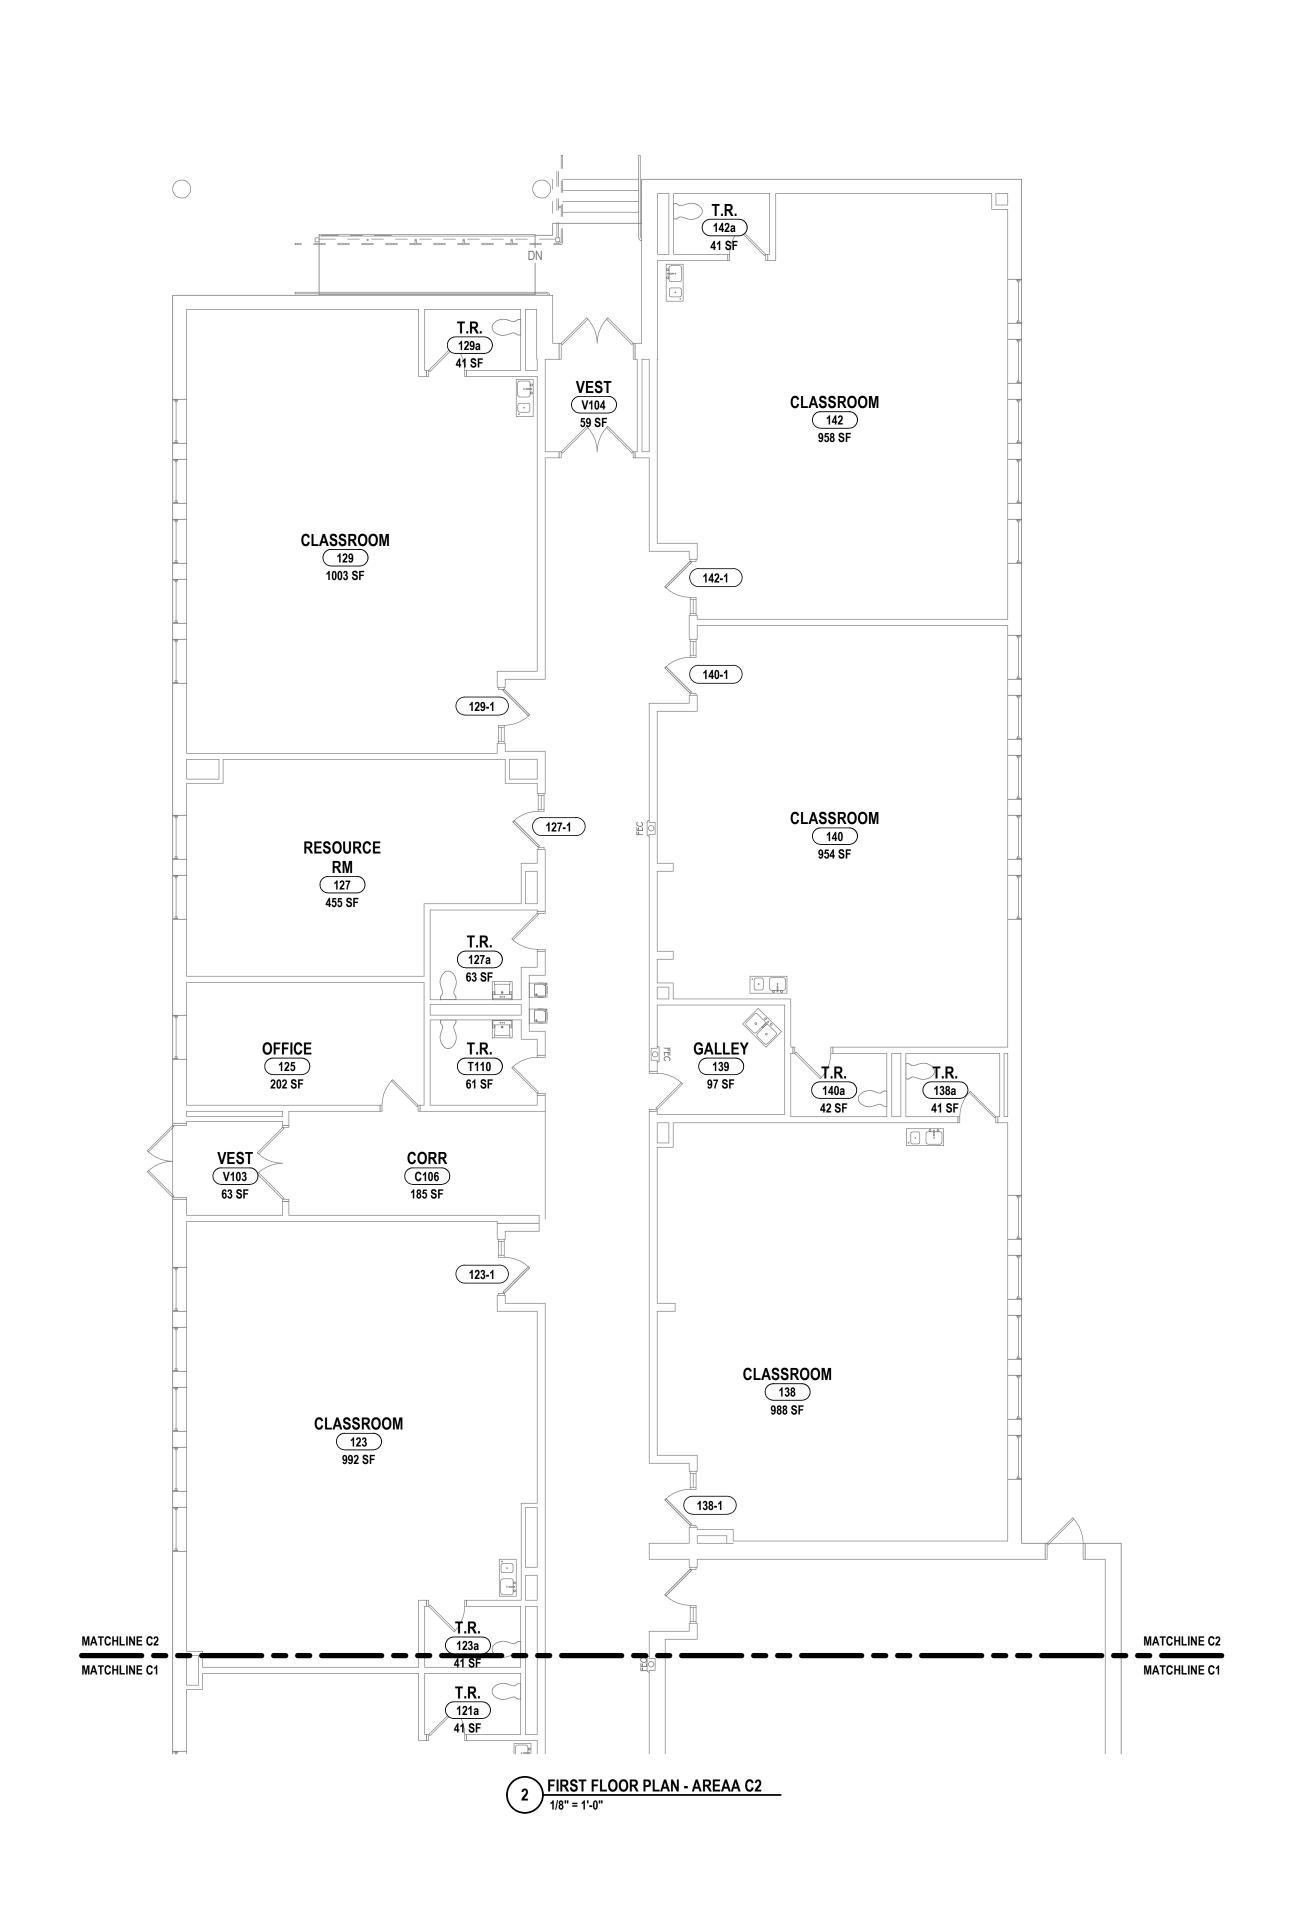

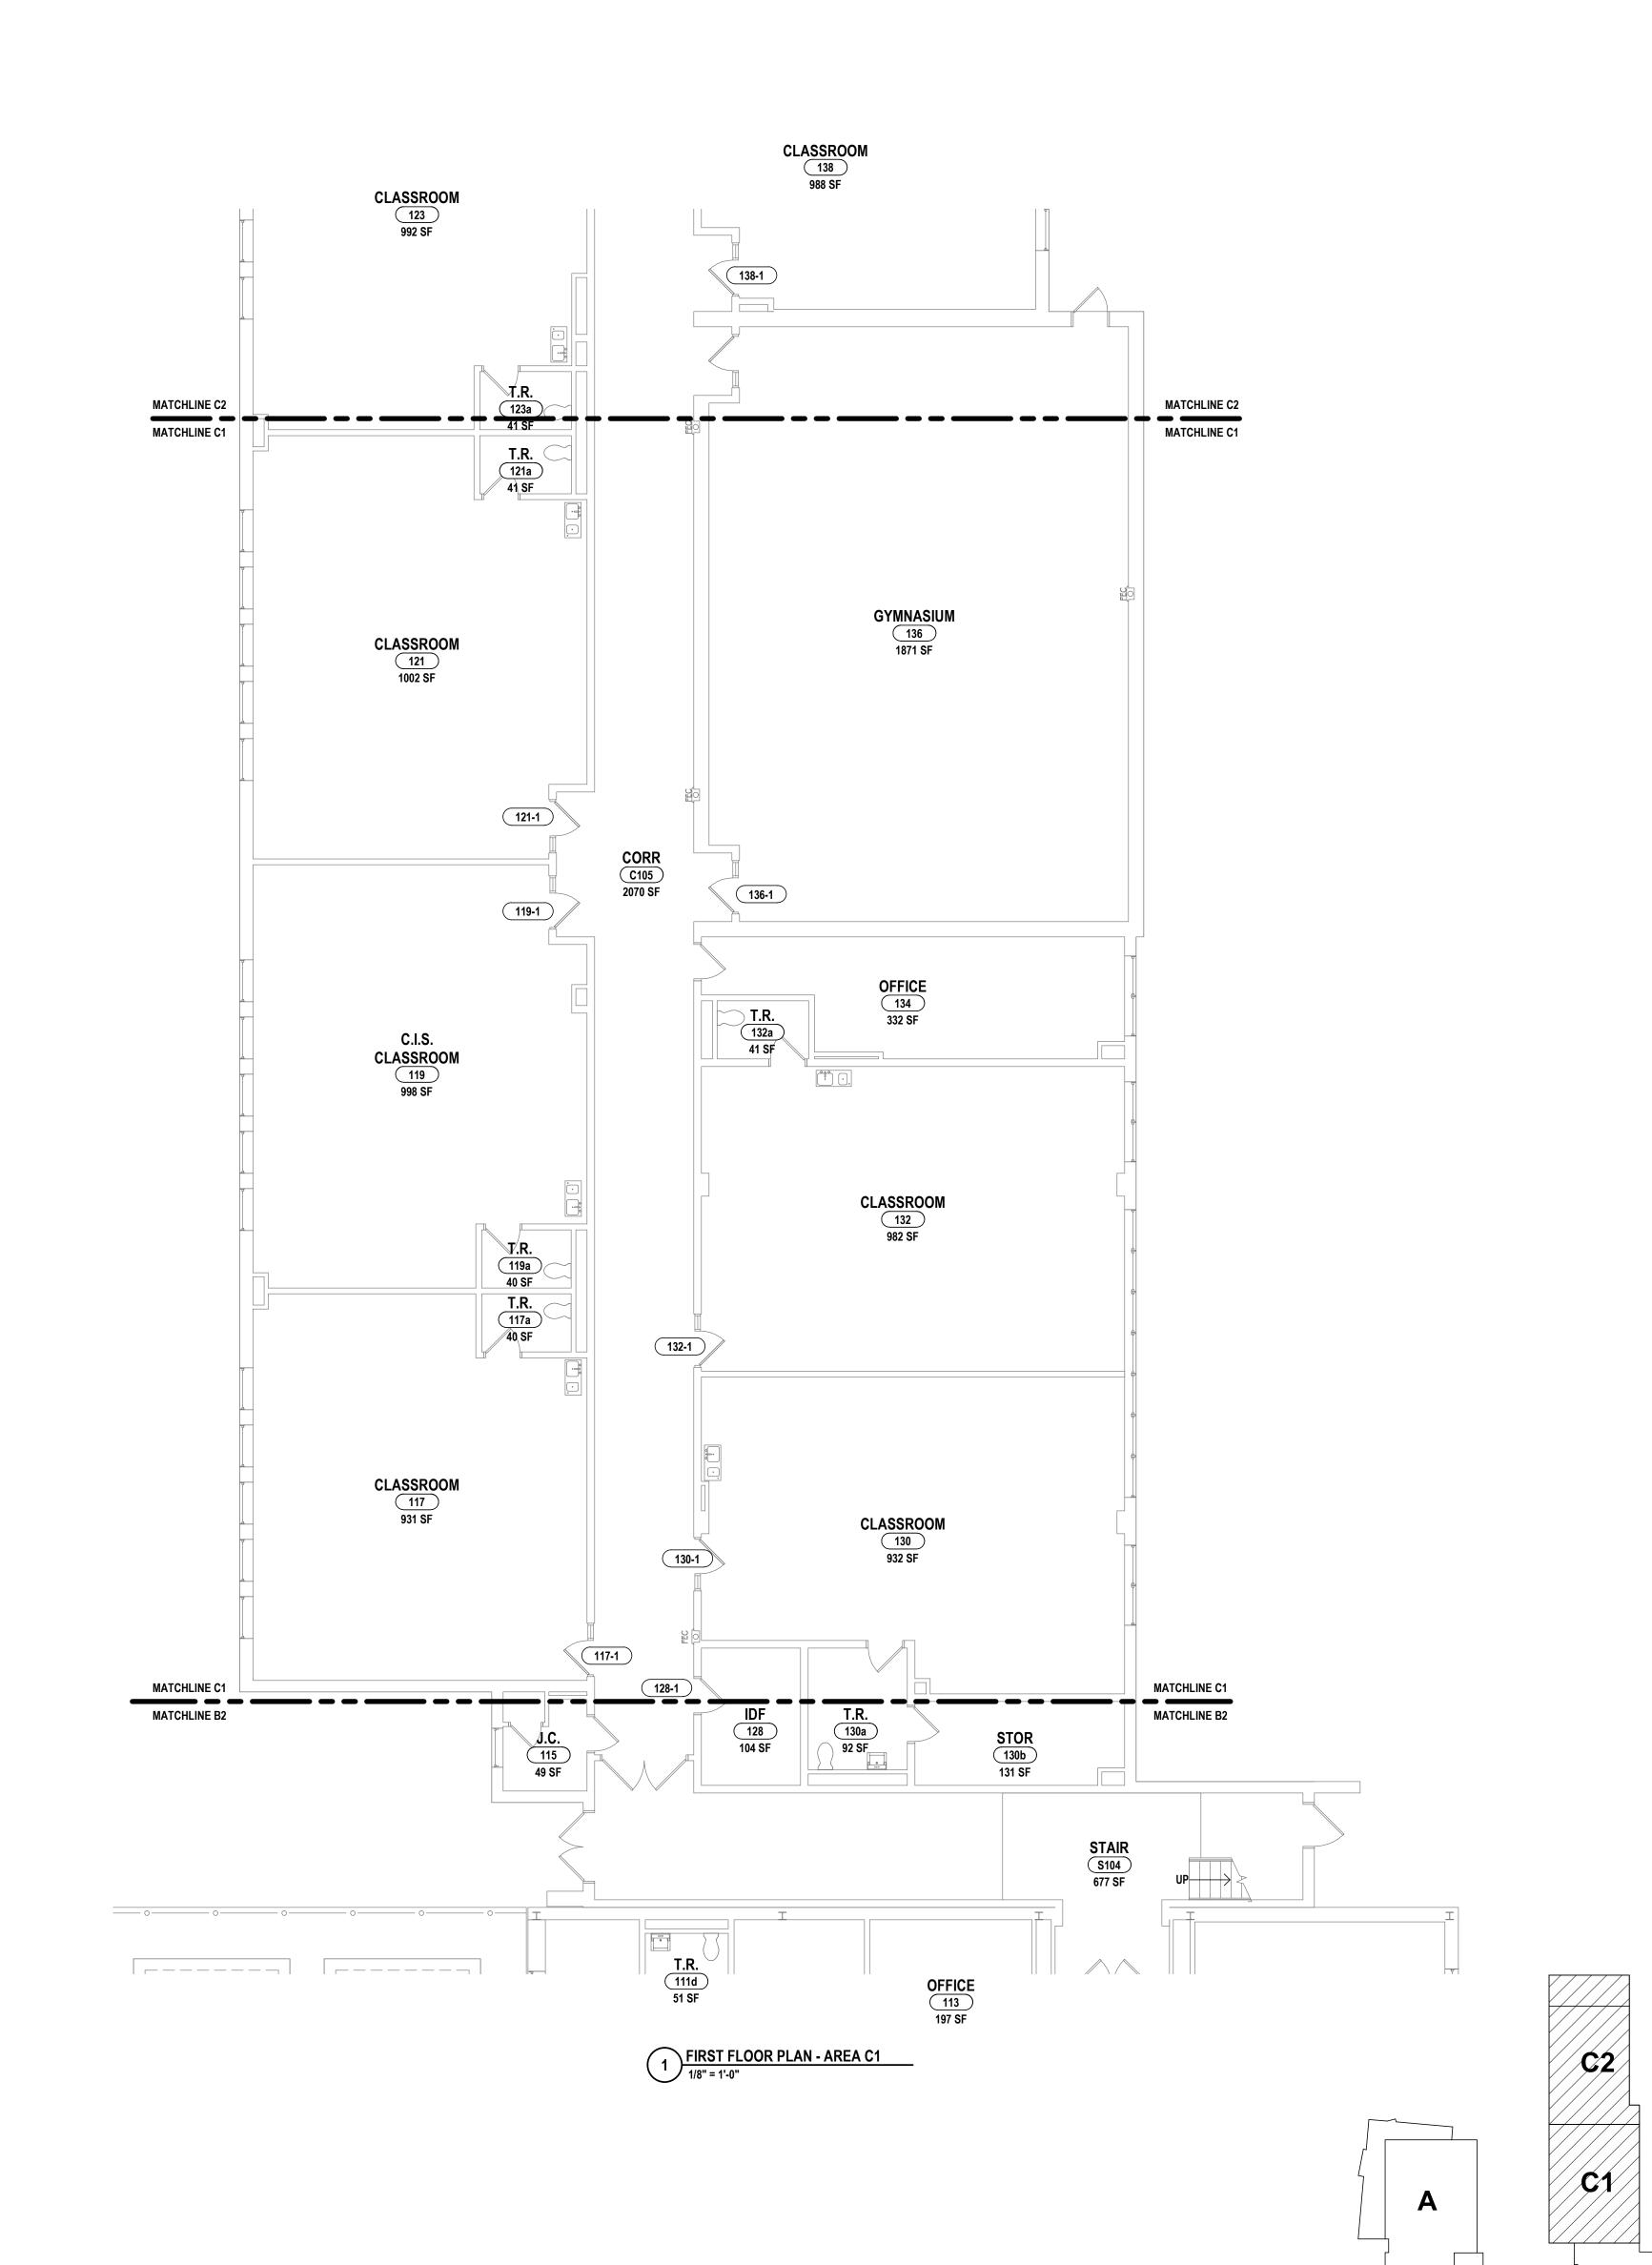

 SU_{265} ENGINEERS | ARCHITEC S 2023 RENOVATIONS (PHASE DISTRICT

AREAS C1 & C2

CB-A1.3


PROJECT NO: 2012-233

B1

B2

KEY PLAN

10/21/2022 1/8" = 1'-0"

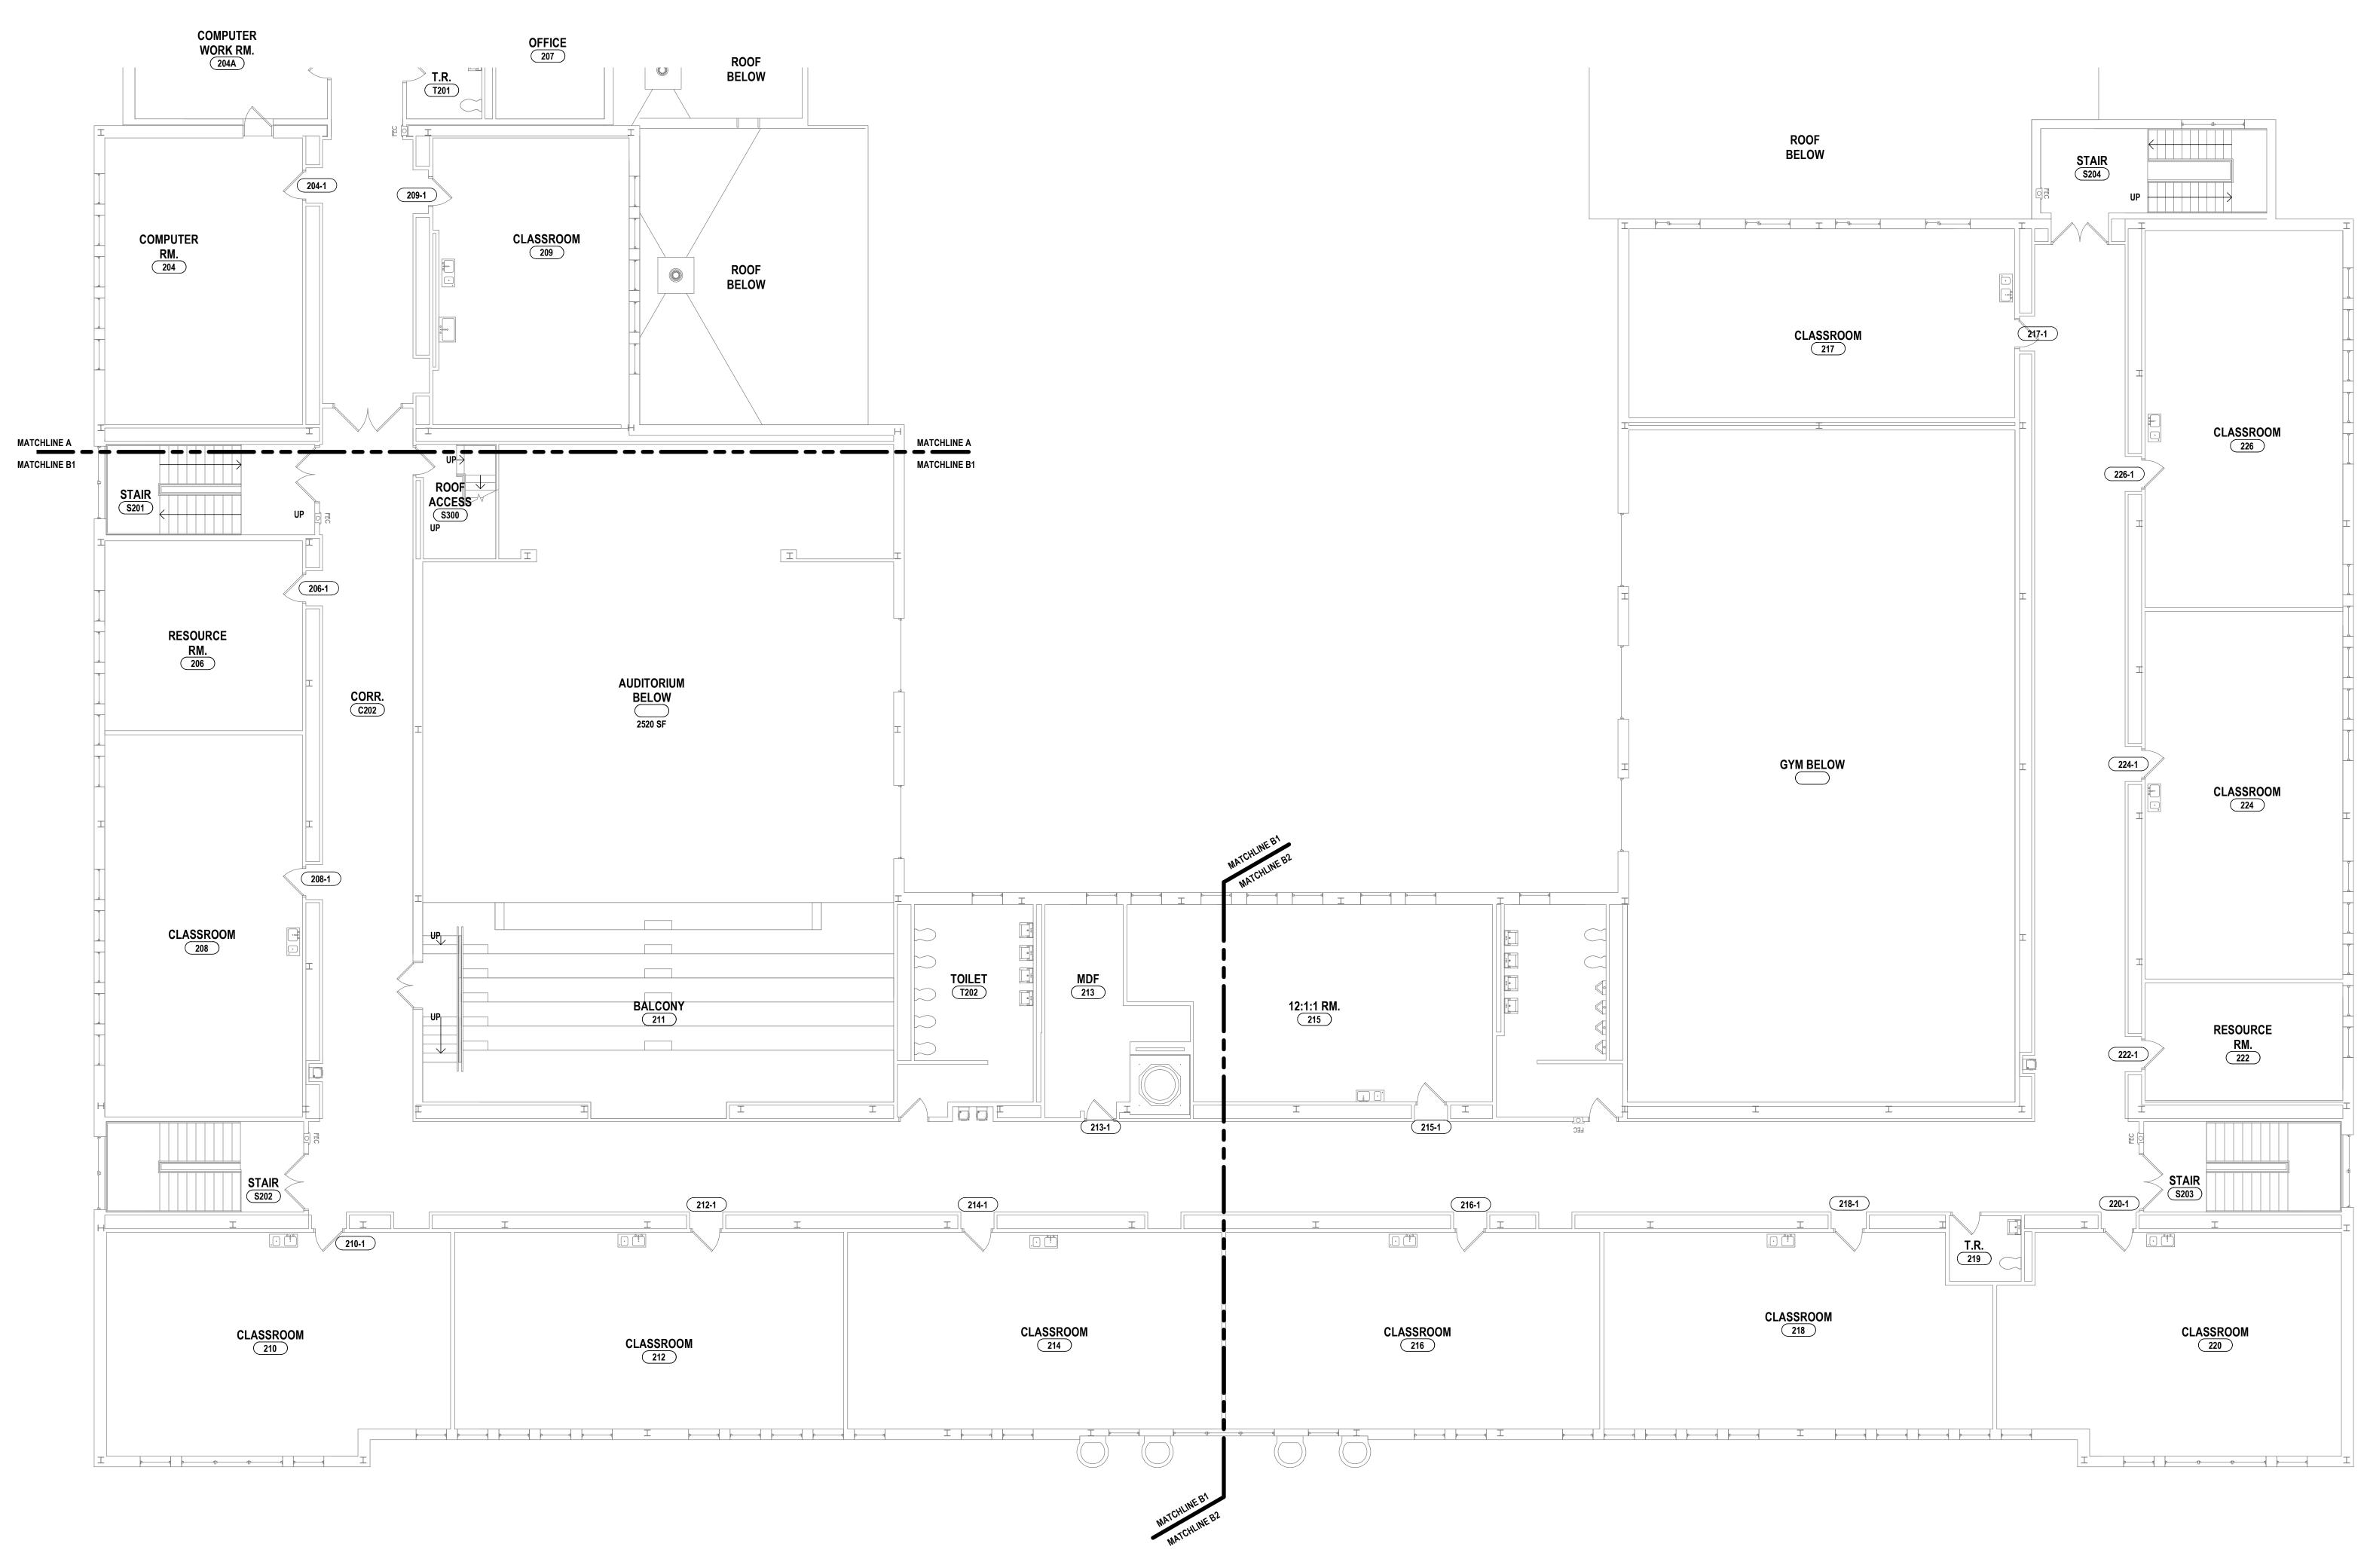

C2 C1

1 SECOND FLOOR PLAN - AREAS B1 & B2

SU. ENGINEERS | ARCHITEC

10/21/2022 1/8" = 1'-0"

S 2023 RENOVATIONS (PHASE DISTRICT

- AREAS B1 & B2

CB-A1.4

			DOOR	JOHLDOL			PLACMENT ONLY	
	DC	OR	ASSEMBLY	HDWR	FR	AME		
#	THICK.	MATL.	LABEL	SET	MATL.	FINISH	NOTES	ROOM
FIRST FL.								
100-1	1 3/4"	WD (EXG)	C-45 (EXG)	13.0	HM (EXG)			CAFETERIA (100)
103-1	1 3/4"	WD (EXG)	C-45 (EXG)	14.0	HM (EXG)			INSTRUMENTAL MUSIC
								ROOM (103)
104-1	1 3/4"	WD (EXG)	C-45 (EXG)	11.0	WD (EXG)			VOCAL MUSIC ROOM (
105-1	1 3/4"	WD (EXG)	C-45 (EXG)	18.0	WD (EXG)			AUDITORIUM (105)
110-1	1 3/4"	WD (EXG)	C-45 (EXG)	11.0	WD (EXG)	-		PASSAGE (110)
111-1	1 3/4"	WD (EXG)	C-45 (EXG)	13.0	WD (EXG)			GYMNASIUM (111)
112-1	1 3/4"	WD (EXG)	C-45 (EXG)	10.0	WD (EXG)			PRINCIPAL OFFICE (11
116-1 117-1	1 3/4"	WD (EXG)	C-45 (EXG)	10.0	WD (EXG)	-		CLASSROOM (116)
118-1	1 3/4" 1 3/4"	WD (EXC)	C-45 (EXG)	11.0	HM (EXG)			CLASSROOM (117)
119-1	1 3/4"	WD (EXG)	C-45 (EXG) C-45 (EXG)	11.0	WD (EXG) HM (EXG)	 		CLASSROOM (118) C.I.S. CLASSROOM (11
119-1 120-1	1 3/4"	WD (EXG)	C-45 (EXG)	10.0	WD (EXG)			CLASSROOM (120)
121-1	1 3/4"	WD (EXG)	C-45 (EXG)	11.0	HM (EXG)			CLASSROOM (121)
122-1	1 3/4"	WD (EXG)	C-45 (EXG)	10.0	WD (EXG)	 		RESOURCE RM (122)
123-1	1 3/4"	WD (EXG)	C-45 (EXG)	11.0	HM (EXG)	 		CLASSROOM (123)
124-1	1 3/4"	WD (EXG)	C-45 (EXG)	10.0	WD (EXG)			CLASSROOM (124)
126-1	1 3/4"	WD (EXG)	C-45 (EXG)	10.0	WD (EXG)			CLASSROOM (126)
127-1	1 3/4"	WD (EXG)	C-45 (EXG)	10.0	HM (EXG)			RESOURCE RM (127)
128-1	1 3/4"	WD (EXG)	C-45 (EXG)	12.0	HM (EXG)			IDF (128)
129-1	1 3/4"	WD (EXG)	C-45 (EXG)	11.0	HM (EXG)			CLASSROOM (129)
130-1	1 3/4"	WD (EXG)	C-45 (EXG)	10.0	HM (EXG)			CLASSROOM (130)
132-1	1 3/4"	WD (EXG)	C-45 (EXG)	11.0	HM (EXG)			CLASSROOM (132)
136-1	1 3/4"	WD (EXG)	C-45 (EXG)	13.0	HM (EXG)	-		GYMNASIUM (136)
138-1	1 3/4"	WD (EXG)	C-45 (EXG)	11.0	HM (EXG)			CLASSROOM (138)
140-1	1 3/4"	WD (EXG)	C-45 (EXG)	11.0	HM (EXG)			CLASSROOM (140)
142-1	1 3/4"	WD (EXG)	C-45 (EXG)	11.0	HM (EXG)			CLASSROOM (142)
E100A-1	0"	SS			SS (EXG)		PROVIDE ACCESS CONTROL AT ELEVATOR CALL BUTTON	ELEV VEST (E100)
SECOND FL.		1						
200-1	1 3/4"	WD (EXG)	C-45 (EXG)	13.0	HM (EXG)			LIBRARY (200)
201-1	1 3/4"	WD (EXG)	C-45 (EXG)	11.0	HM (EXG)			ART ROOM (201)
201A-1	1 3/4"	WD (EXG)		12.0	HM (EXG)			IDF (201A)
203-1	1 3/4"	WD (EXG)	C-45 (EXG)	11.0	HM (EXG)			CLASSROOM (203)
204-1	1 3/4"	WD (EXG)	C-45 (EXG)	10.0	HM (EXG)			COMPUTER RM. (204)
205-1	1 3/4"	WD (EXG)	C-45 (EXG)	11.0	HM (EXG)			CLASSROOM (205)
206-1	1 3/4"	WD (EXG)	C-45 (EXG)	10.0	WD (EXG)			RESOURCE RM. (206)
208-1	1 3/4"	WD (EXG)	C-45 (EXG)	10.0	WD (EXG)			CLASSROOM (208)
209-1	1 3/4"	WD (EXG)	C-45 (EXG)	10.0	HM (EXG)			CLASSROOM (209)
210-1	1 3/4"	WD (EXG)	C-45 (EXG)	11.0	WD (EXG)			CLASSROOM (210)
212-1	1 3/4"	WD (EXG)	C-45 (EXG)	11.0	WD (EXG)			CLASSROOM (212)
213-1	1 3/4"	WD (EXG)	C-45 (EXG)	12.0	HM (EXG)			MDF (213)
214-1	1 3/4"	WD (EXG)	C-45 (EXG)	10.0	HM (EXG)			CLASSROOM (214)
215-1	1 3/4"	WD (EXG)	C-45 (EXG)	10.0	WD (EXG)			12:1:1 RM. (215)
216-1	1 3/4"	WD (EXG)	C-45 (EXG)	10.0	WD (EXG)			CLASSROOM (216)
217-1	1 3/4"	WD (EXG)	C-45 (EXG)	11.0	WD (EXG)			CLASSROOM (217)
218-1	1 3/4"	WD (EXG)	C-45 (EXG)	10.0	WD (EXG)			CLASSROOM (218)
220-1	1 3/4"	WD (EXG)	C-45 (EXG)	10.0	WD (EXG)	-		CLASSROOM (220)
222-1	1 3/4"	WD (EXG)	C-45 (EXG)	10.0	WD (EXG)			RESOURCE RM. (222)
224-1	1 3/4"	WD (EXG)	C-45 (EXG)	10.0	WD (EXG)	-		CLASSROOM (224)
226-1	1 3/4"	WD (EXG)	C-45 (EXG)	10.0	WD (EXG)		PROVIDE ACCESS CONTROL AT ELEVATOR CONTROL	CLASSROOM (226)
E200A-1	0"	SS			SS (EXG)		PROVIDE ACCESS CONTROL AT ELEVATOR CALL BUTTON	ELEV VEST (E200)

ENGINEERS | ARCHITEC

DOOR AND WINDOW SCHEDULES

ELEMENTARY SCHOOLS 2023 RENOVATIONS (PHASE II)


ELMIRA, CHEMUNG COUNTY, NEW YORK


CB-A6.1

1 FLOOR TO RECEIVE CPT-1 IN QUARTER TURN INSTALLATION PATTERN. PROVIDE RESILIENT BASE, RB-1.


2 FLOOR TO RECEIVE VCT-2,3 IN GRID INSTALLATION PATTERN. PROVIDE RESILIENT BASE, RB-1. 3 FLOORS AND LANDING TO RECEIVE RF-1. PROVIDE RESILIENT BASE, RB-3. 4 TREADS AND RISERS TO RECEIVE RT-1. 5 ENTRY TO RECEIVE WALK OFF CARPET, CPT-2, IN QUARTER TURN INSTALLATION PATTERN. PROVIDE RESILIENT BASE RB-1.


FLOOR FINISH KEY

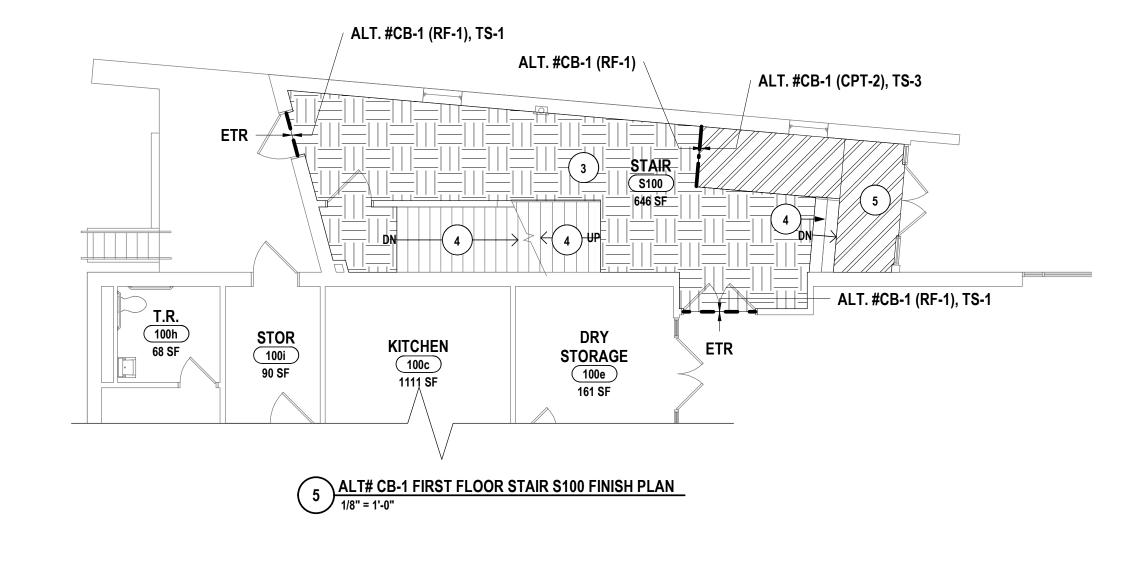


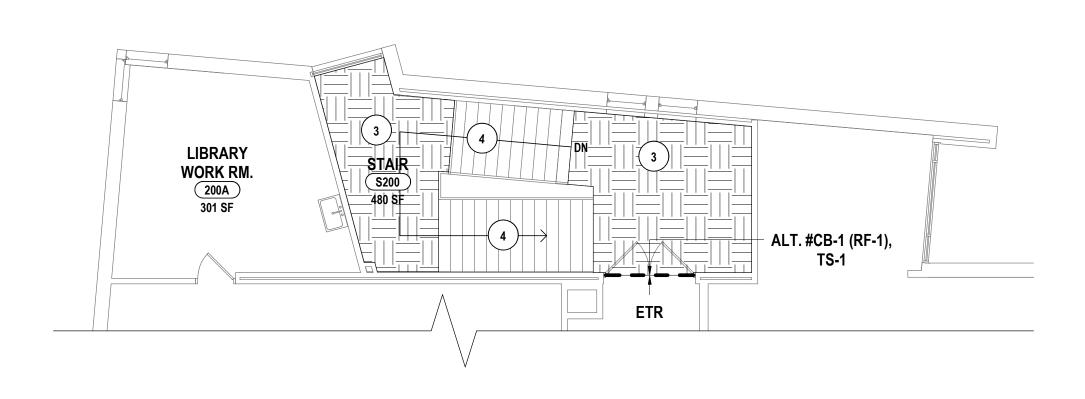

3 ALT# CB-1 SECOND FLOOR STAIR S200 FINISH PLAN 1/8" = 1'-0"

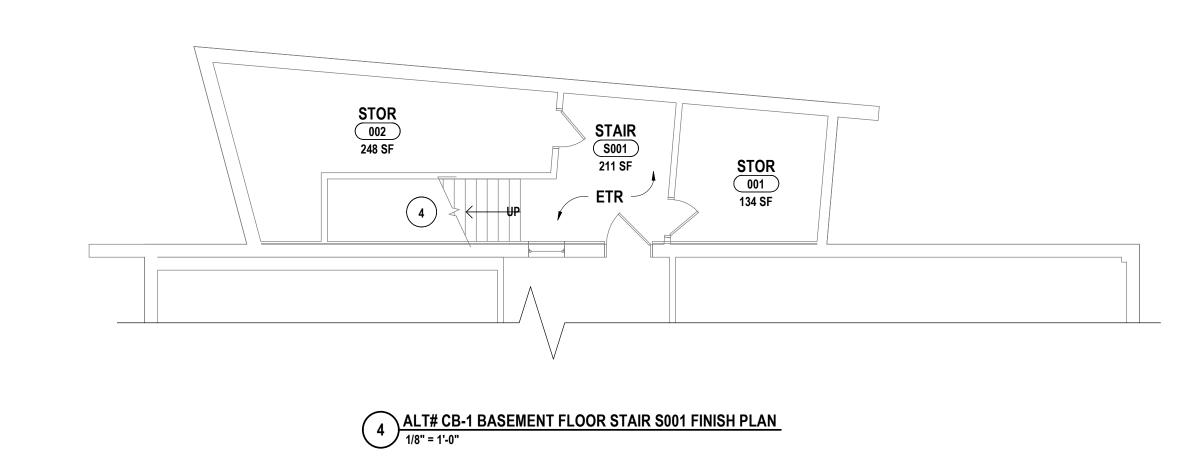

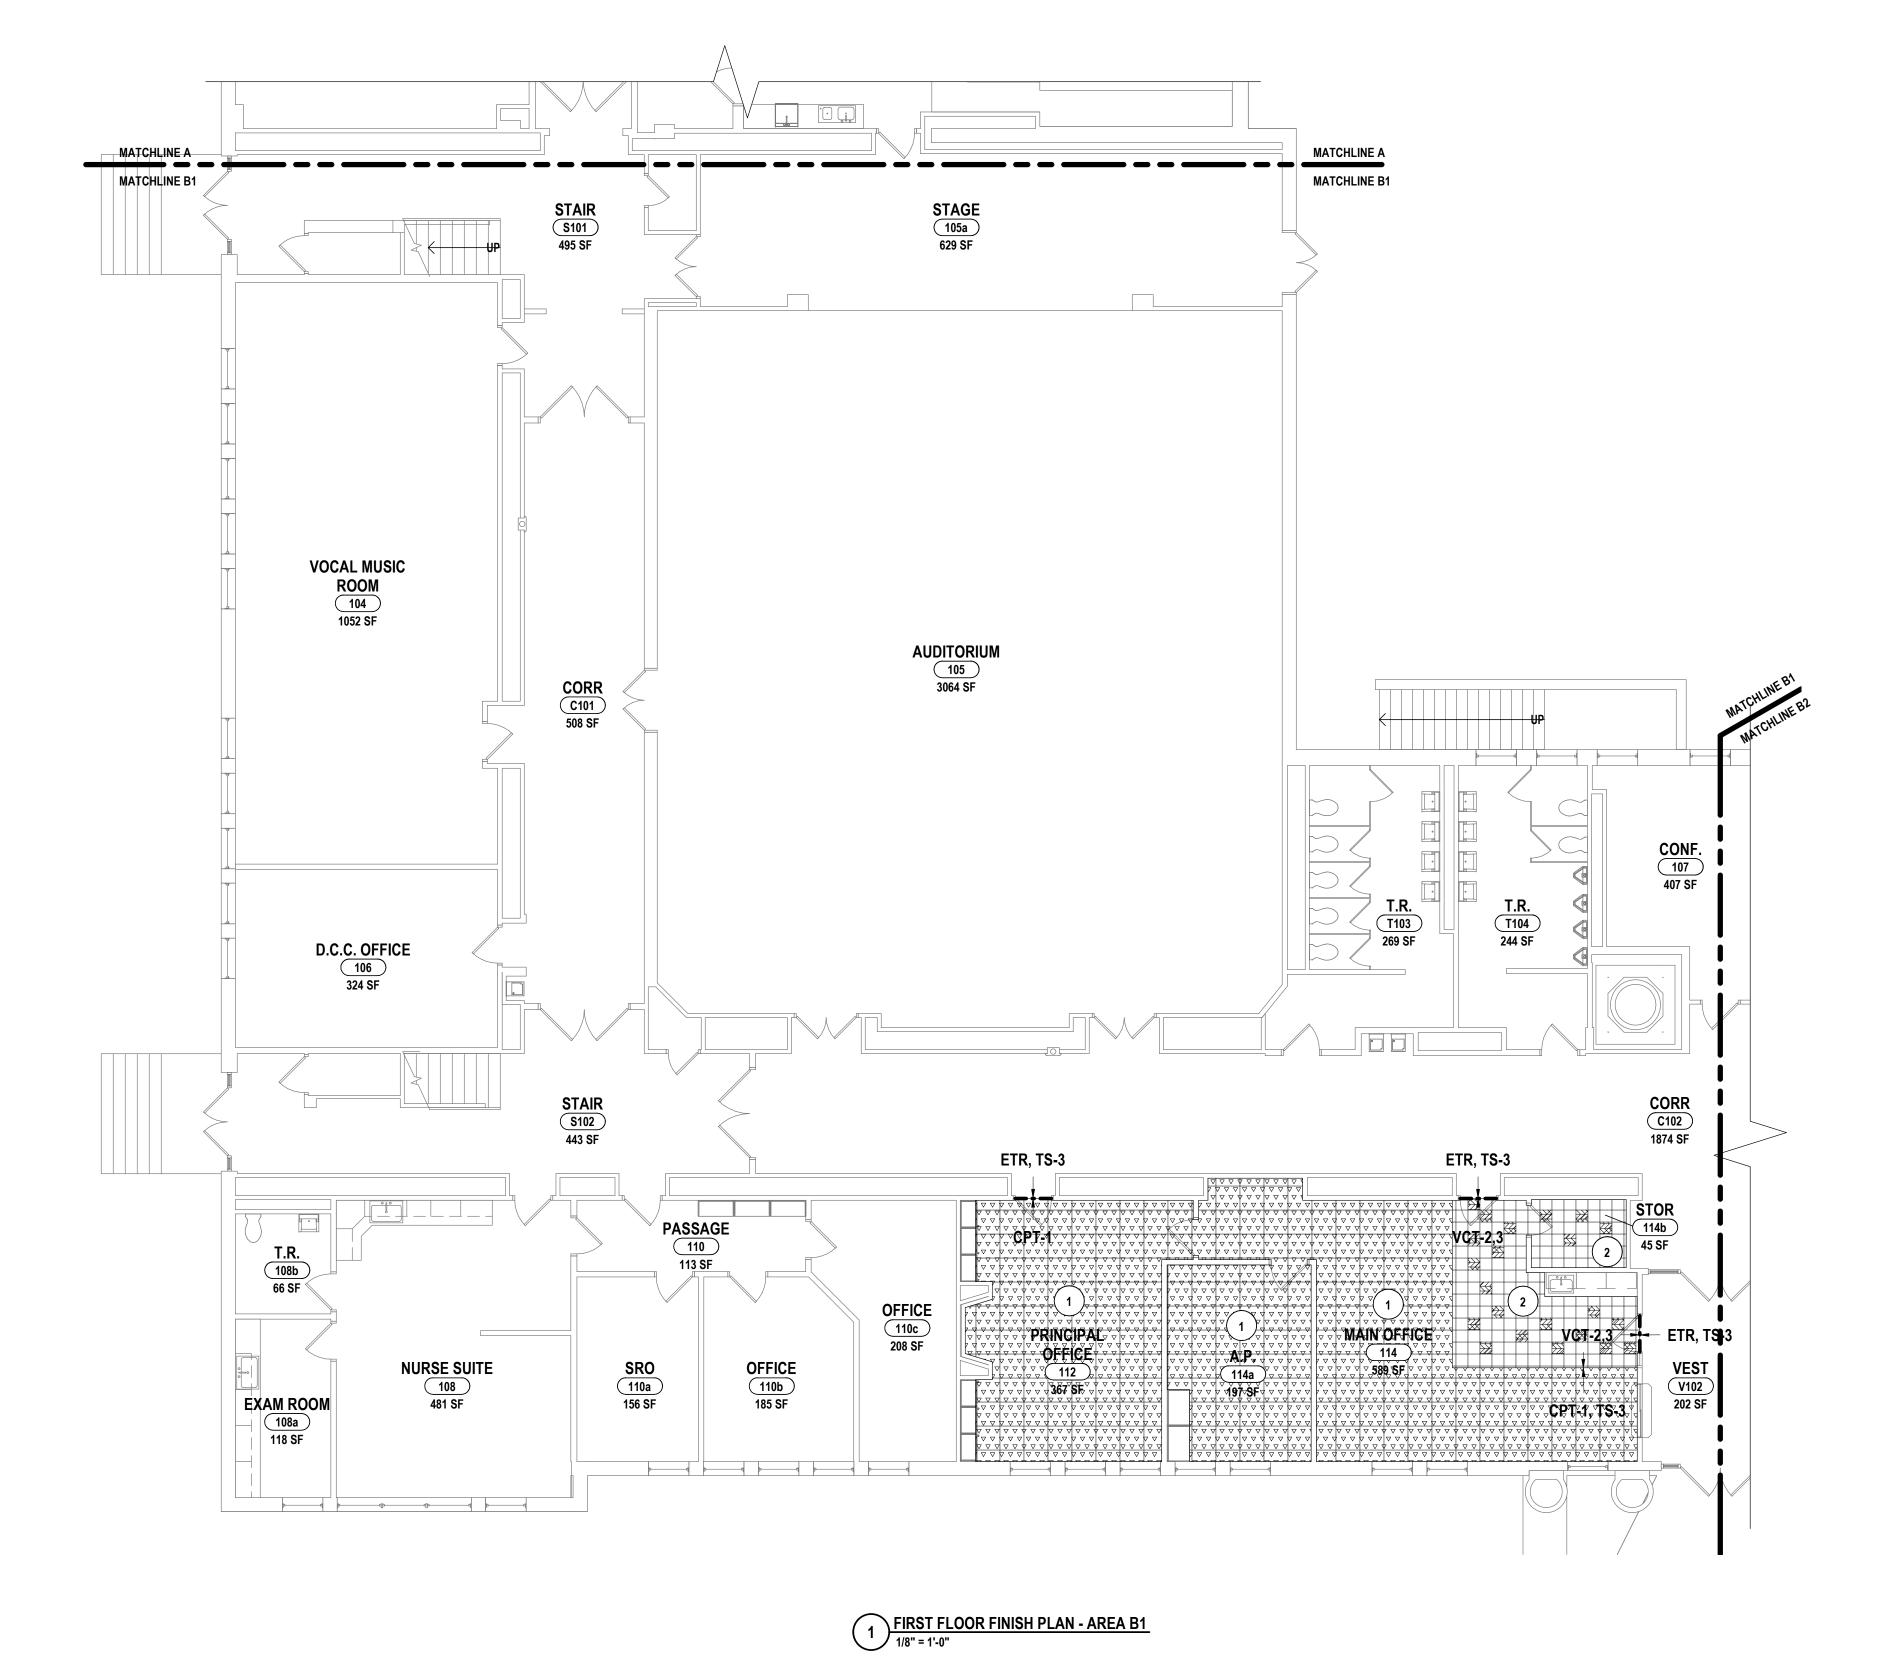

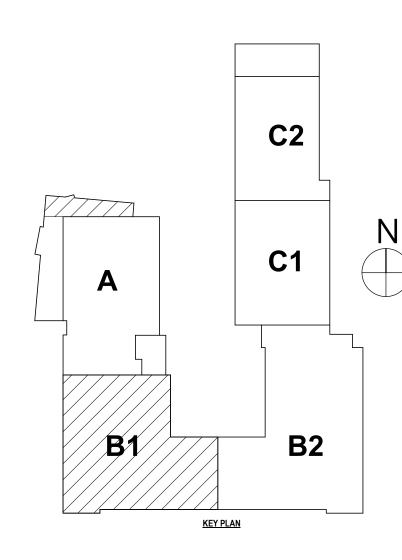

 \sim ENGINEERS | ARCHITEC

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SCALE:


CHECKED BY:

10/21/2022

As indicated

AREA A & AREA B1 PARTIAL - PARTIAL LS 2023 RE DISTRICT FLOOR FINISH

CB-A8.1

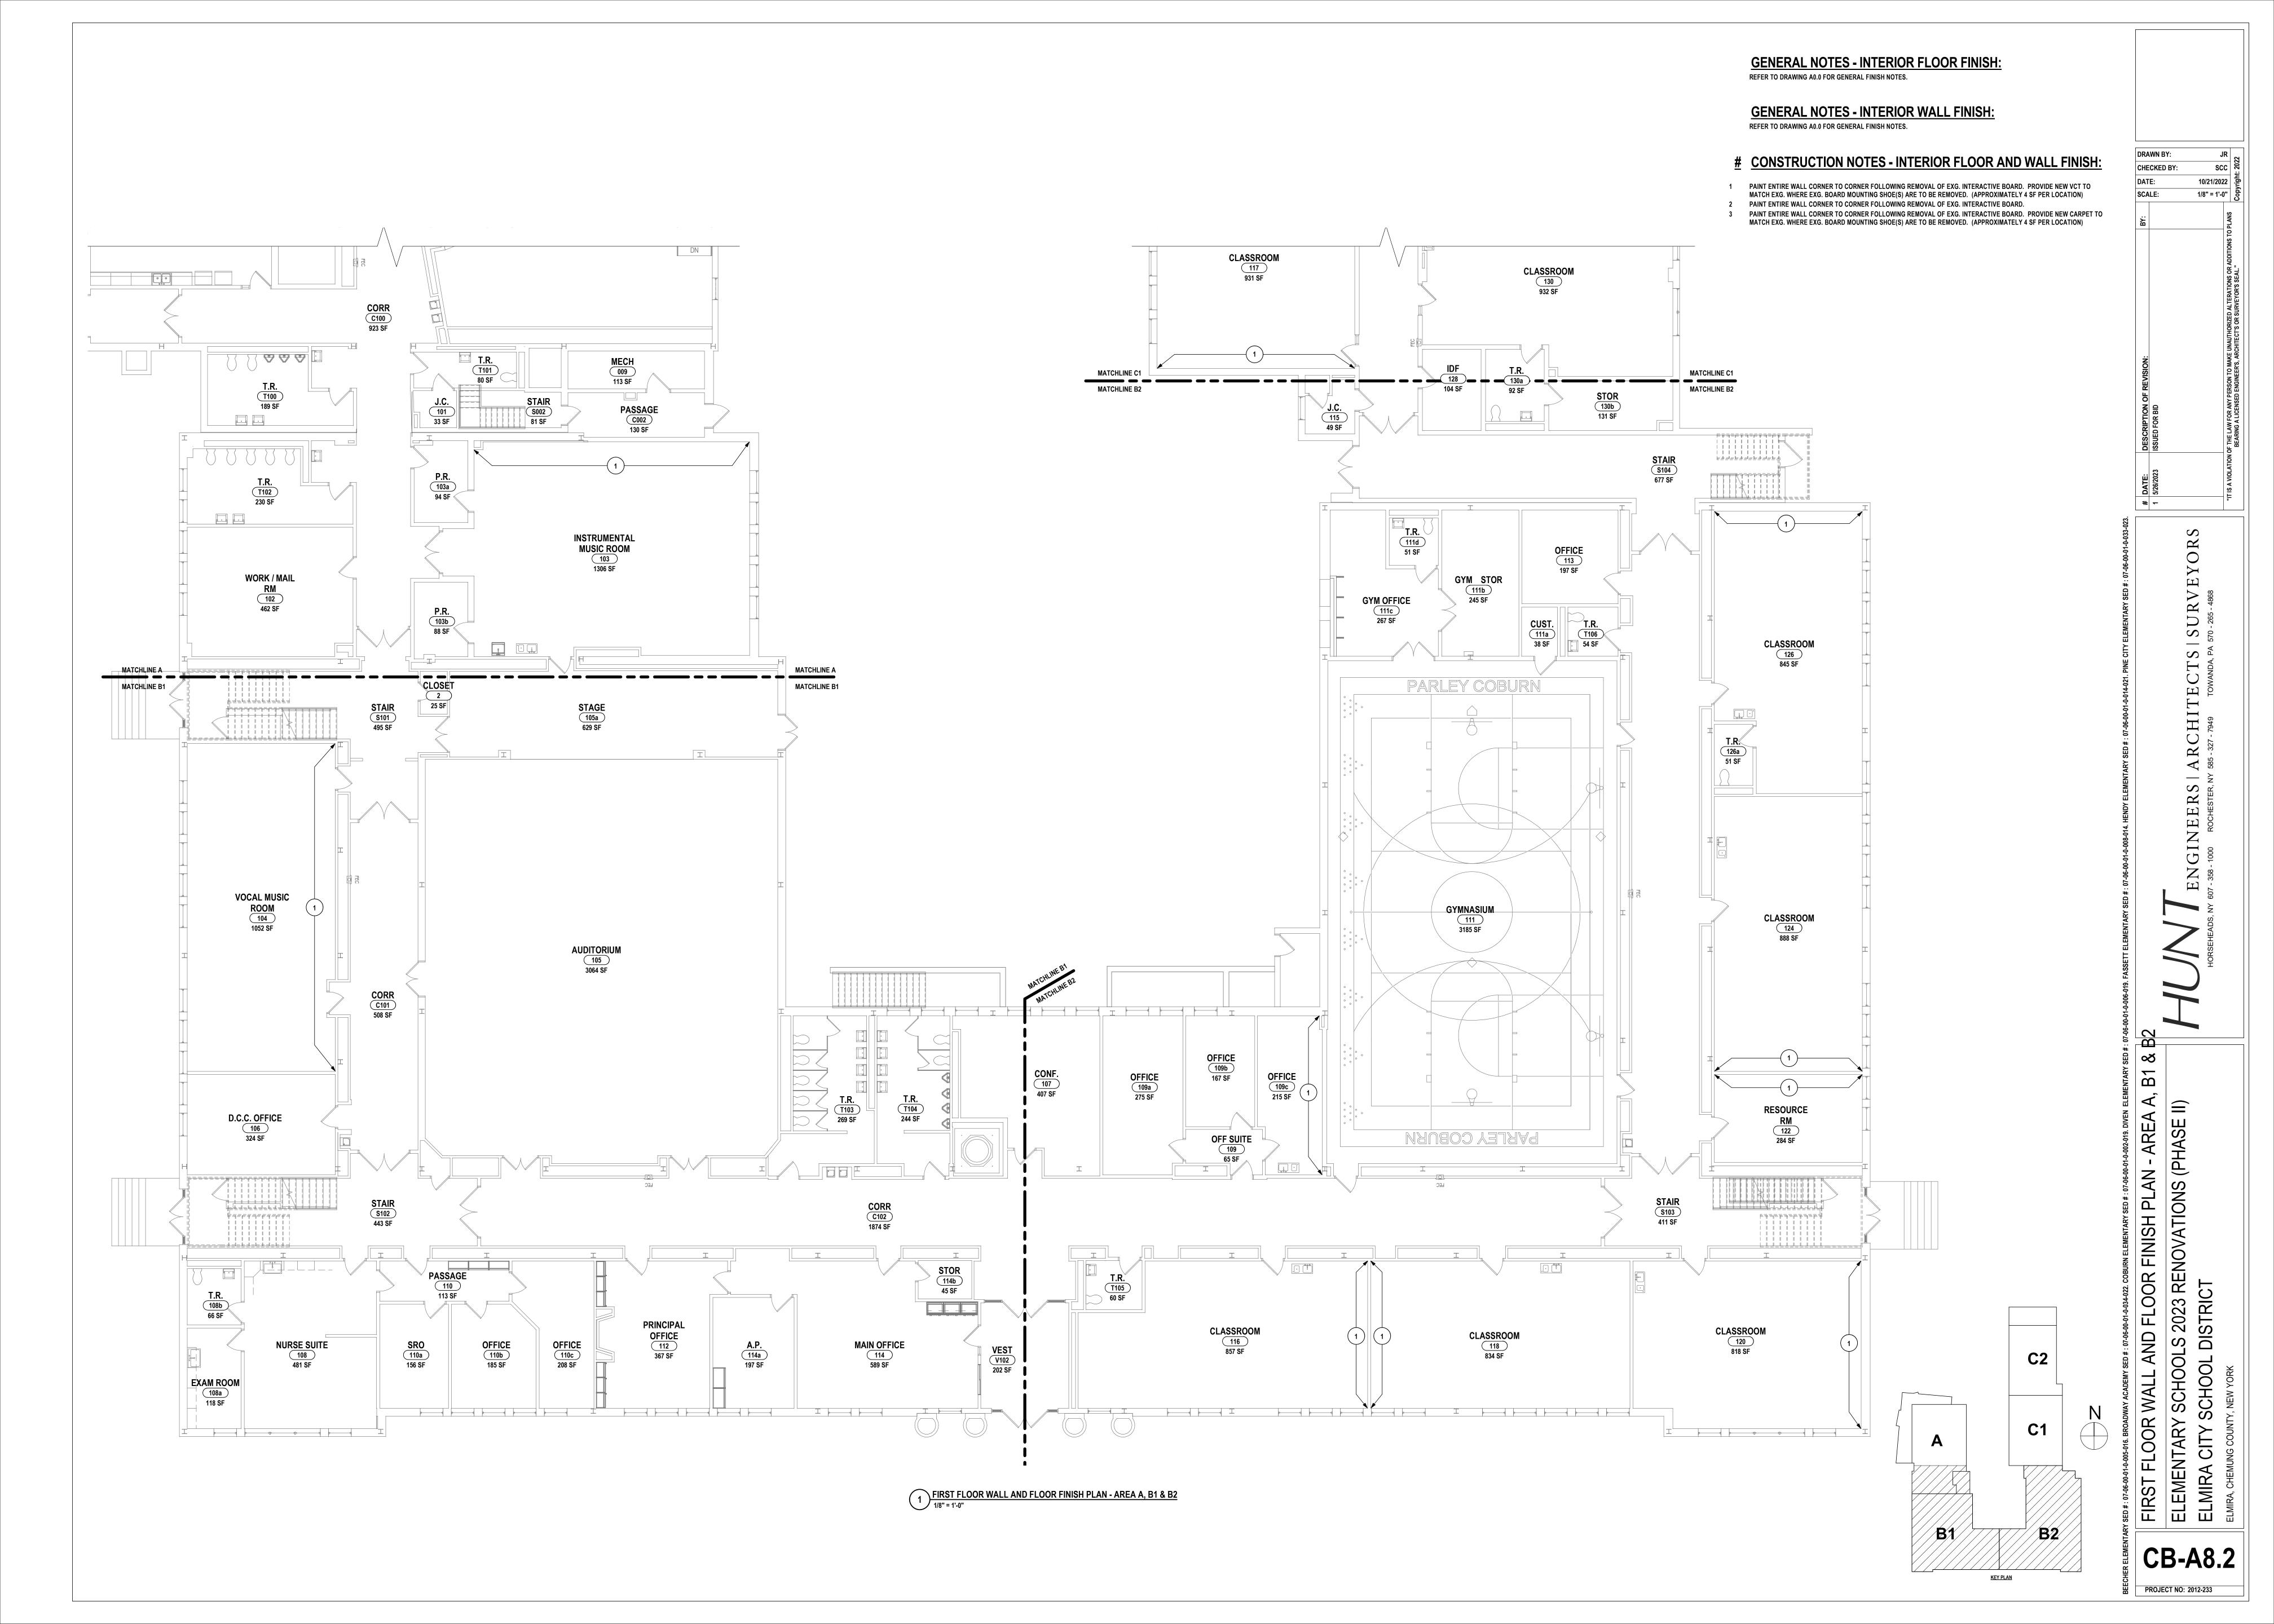


REFER TO DRAWING A0.0 FOR GENERAL FINISH NOTES.


GENERAL NOTES - INTERIOR WALL FINISH:


CONSTRUCTION NOTES - INTERIOR FLOOR AND WALL FINISH:


- 1 PAINT ENTIRE WALL CORNER TO CORNER FOLLOWING REMOVAL OF EXG. INTERACTIVE BOARD. PROVIDE NEW VCT TO MATCH EXG. WHERE EXG. BOARD MOUNTING SHOE(S) ARE TO BE REMOVED. (APPROXIMATELY 4 SF PER LOCATION)
- PAINT ENTIRE WALL CORNER TO CORNER FOLLOWING REMOVAL OF EXG. INTERACTIVE BOARD.

 PAINT ENTIRE WALL CORNER TO CORNER FOLLOWING REMOVAL OF EXG. INTERACTIVE BOARD. PROVIDE NEW CARPET TO

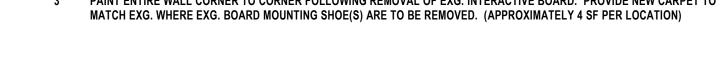

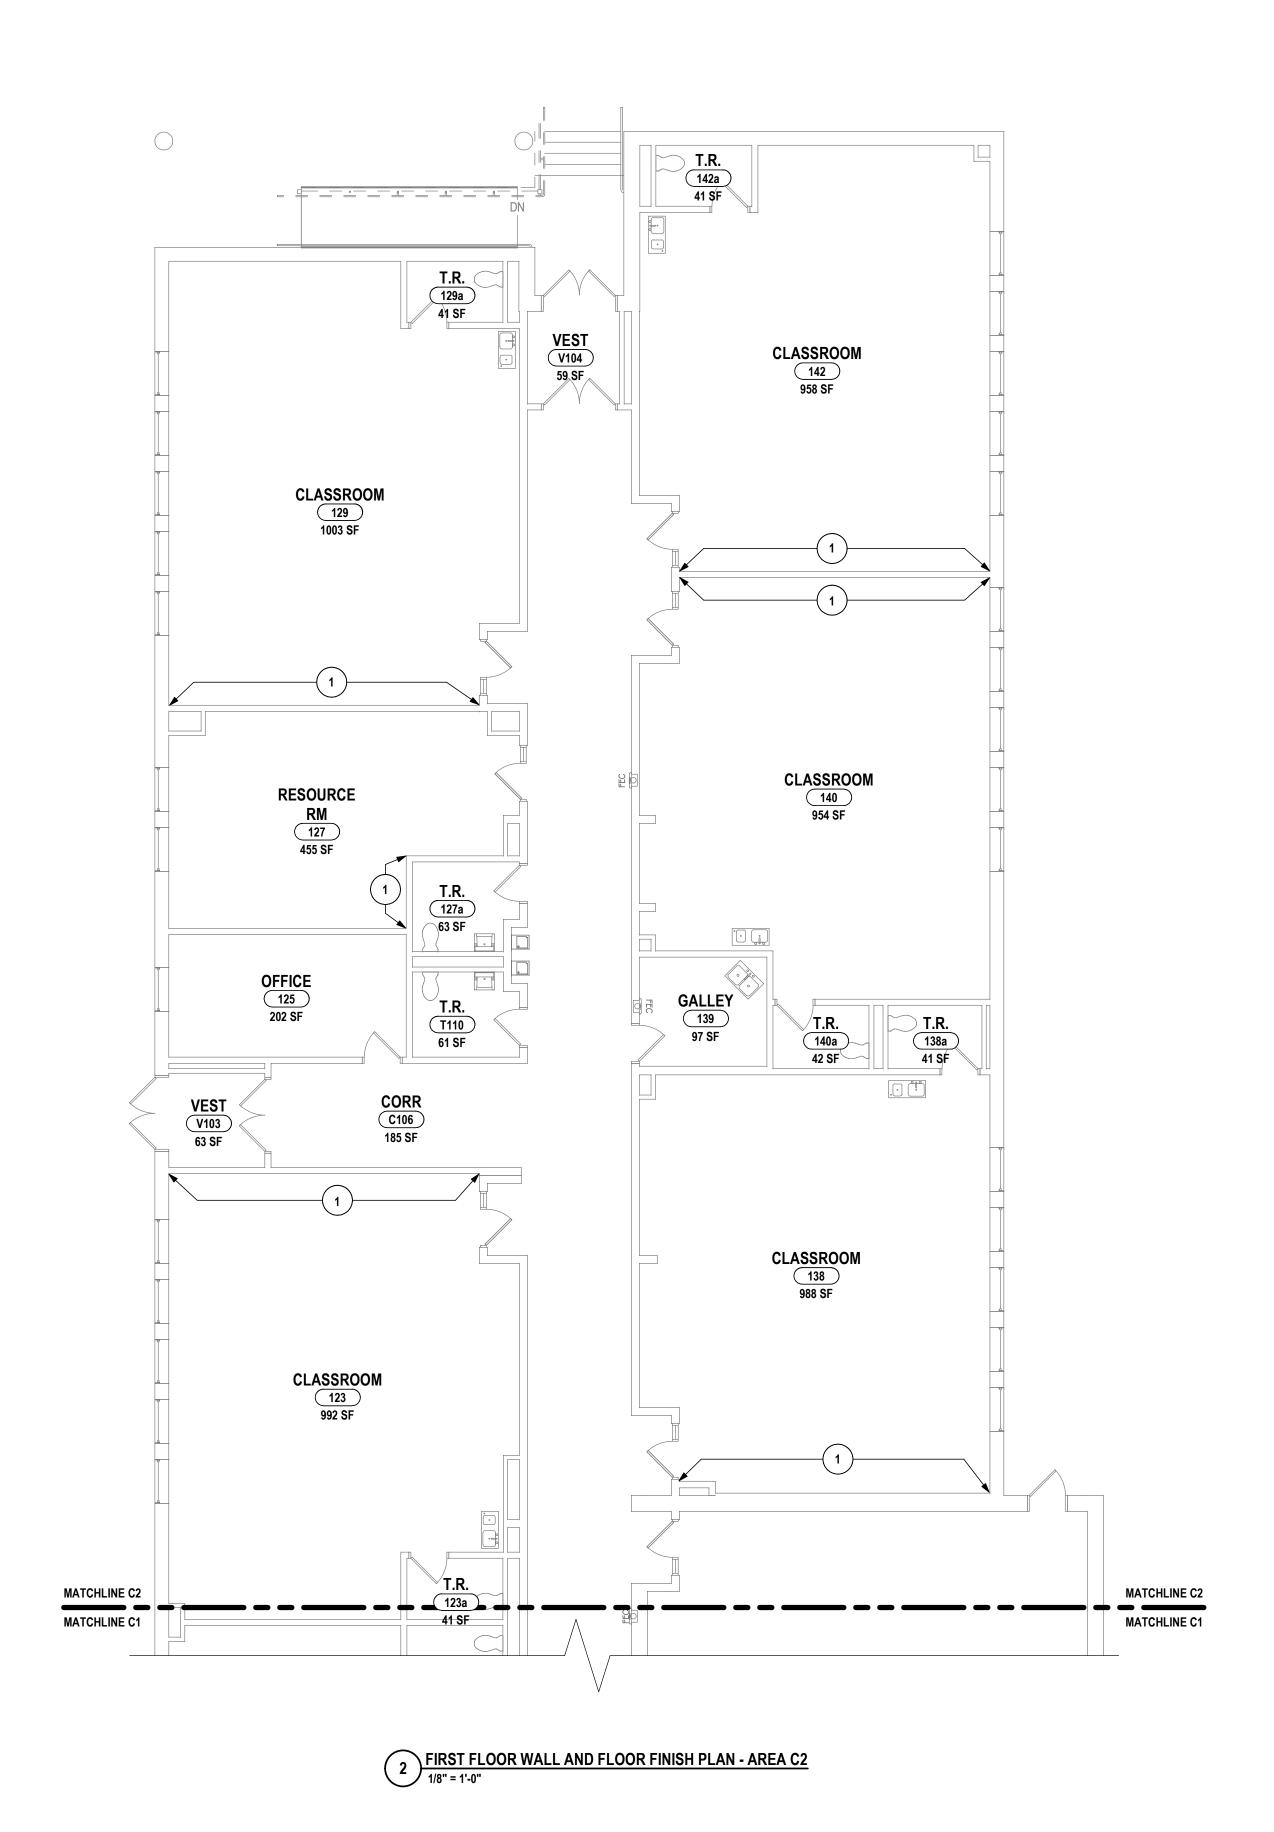

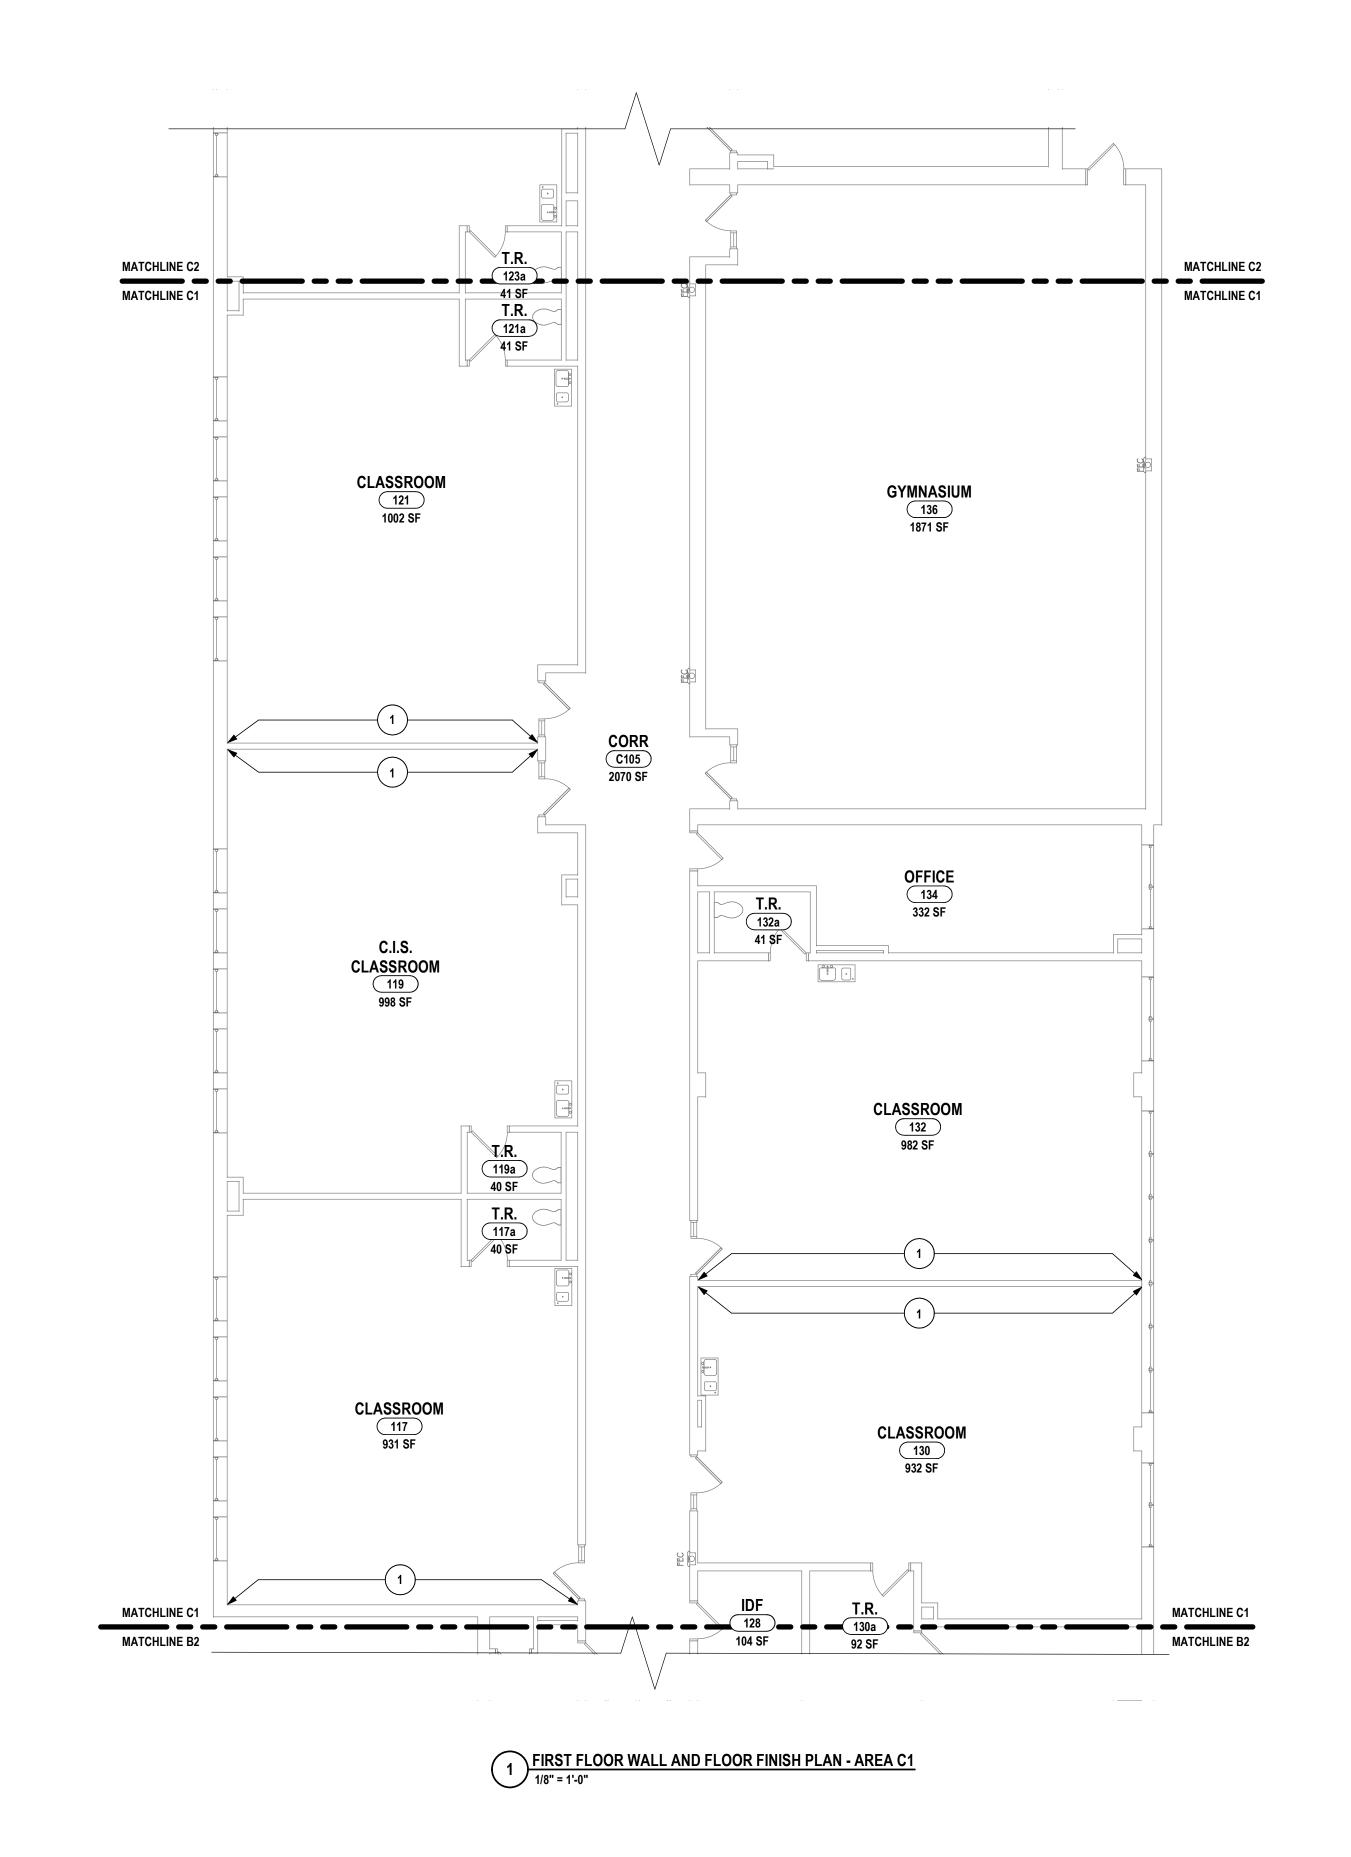

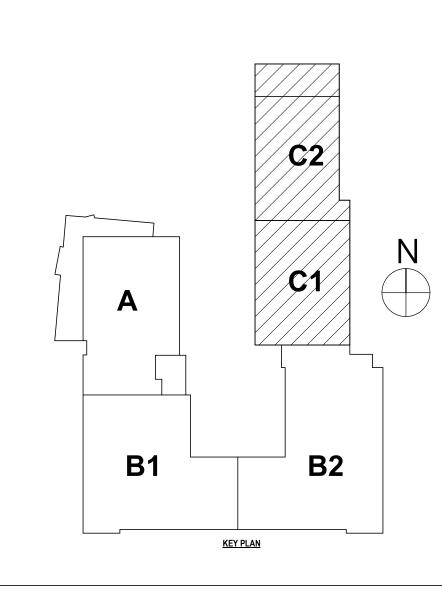

CHECKED BY:

THORSEHEADS, NY 607 - 358 - 1000 ROCHESTER, NY 585 - 327 - 7949 TOWAR

FLOOR WALL AND FLOOR FINISH PLAN - AREA

ENTARY SCHOOL DISTRICT

CB-A8.3



1 SECOND FLOOR WALL AND FLOOR FINISH PLAN - AREA A

GENERAL NOTES - INTERIOR FLOOR FINISH:
REFER TO DRAWING A0.0 FOR GENERAL FINISH NOTES.

GENERAL NOTES - INTERIOR WALL FINISH:
REFER TO DRAWING A0.0 FOR GENERAL FINISH NOTES.

CONSTRUCTION NOTES - INTERIOR FLOOR AND WALL FINISH:

PAINT ENTIRE WALL CORNER TO CORNER FOLLOWING REMOVAL OF EXG. INTERACTIVE BOARD. PROVIDE NEW VCT TO MATCH EXG. WHERE EXG. BOARD MOUNTING SHOE(S) ARE TO BE REMOVED. (APPROXIMATELY 4 SF PER LOCATION)
PAINT ENTIRE WALL CORNER TO CORNER FOLLOWING REMOVAL OF EXG. INTERACTIVE BOARD.
PAINT ENTIRE WALL CORNER TO CORNER FOLLOWING REMOVAL OF EXG. INTERACTIVE BOARD. PROVIDE NEW CARPET TO MATCH EXG. WHERE EXG. BOARD MOUNTING SHOE(S) ARE TO BE REMOVED. (APPROXIMATELY 4 SF PER LOCATION)

HORSEHEADS, NY 607 - 358 - 1000 ROCHESTER, NY 585 - 327 - 7949 TOWANDA, PA 570 - 265 - 4868

#: 07-06-00-01-0-005-016. BROADWAY ACADEMY SED #: 07-06-00-01-0-034-022. COBURN ELEMENTARY SED #: 07-06-00-01-0-002-019. DIVEN ELEME

ECOND FLOOR WALL AND FLOOR FINISH PLAN - AREA


EMENTARY SCHOOLS 2023 RENOVATIONS (PHASE II)

MIRA CITY SCHOOL DISTRICT

C2

СВ-A8.4

PROJECT NO: 2012-233

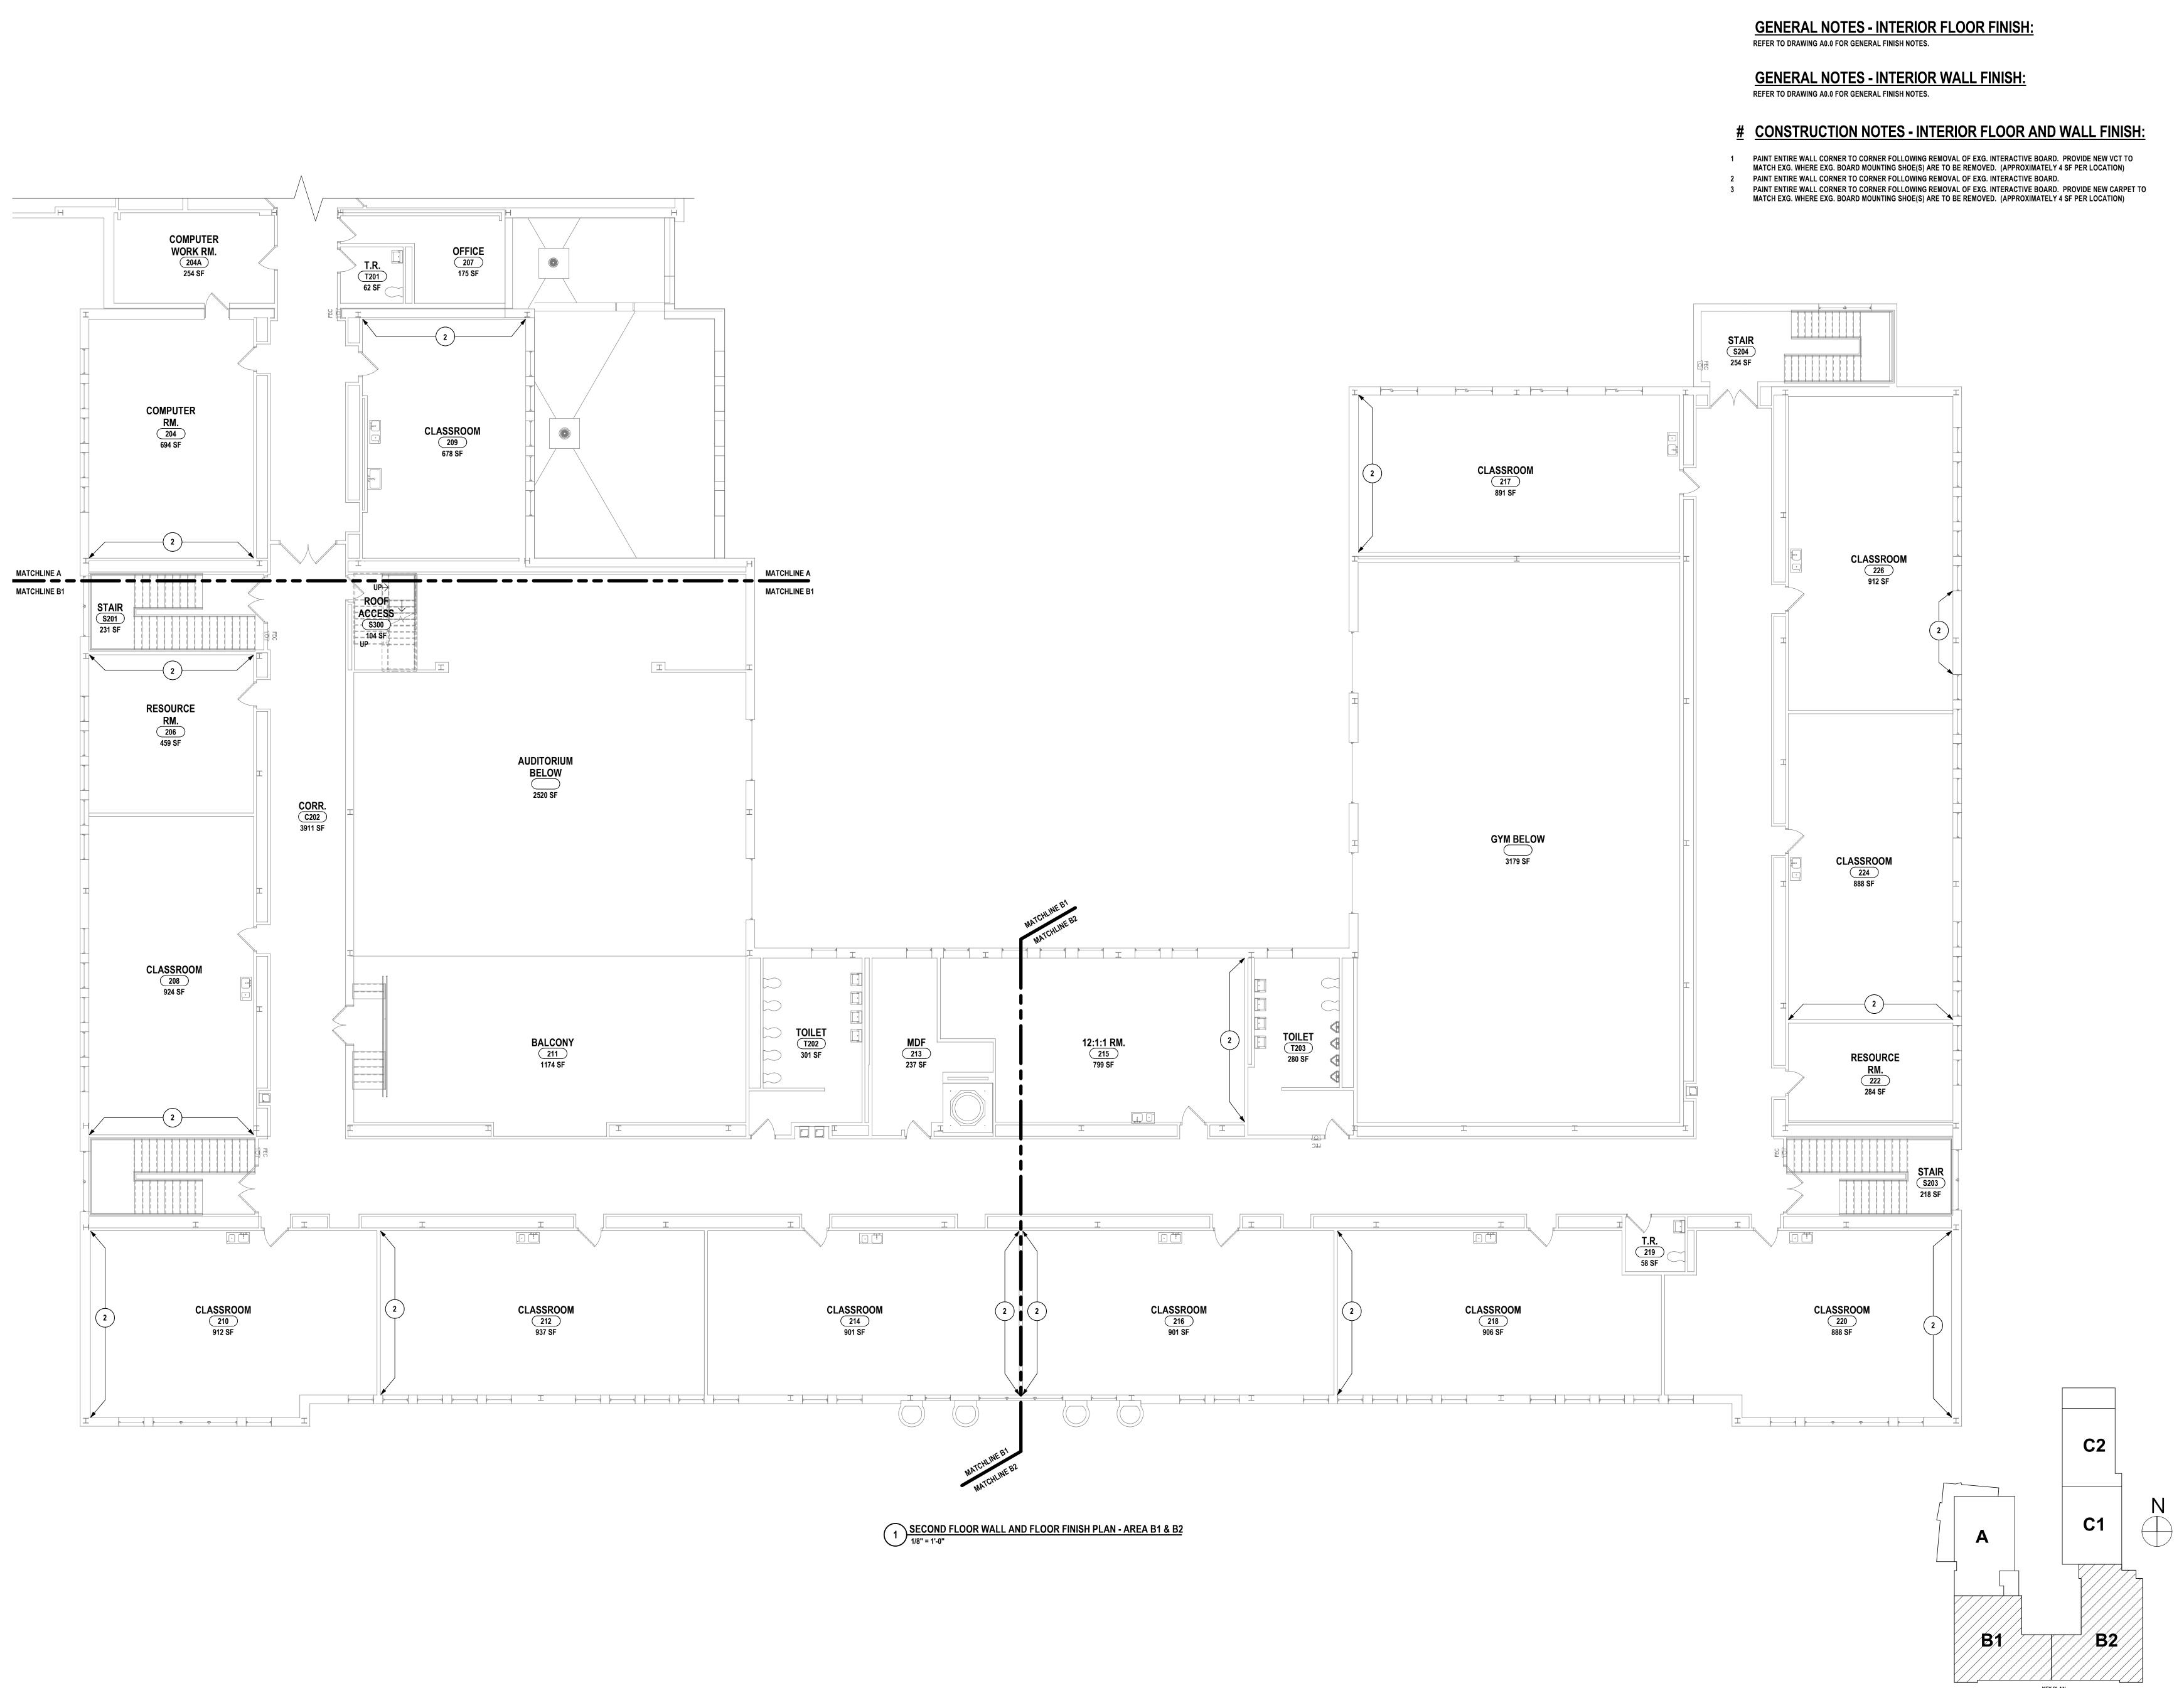

CHECKED BY: 10/21/2022 1/8" = 1'-0"

ENGINEERS | ARCHITEC

AND FLOOR FINISH PLAN - AREA B1 & B2

S 2023 RENOVATIONS (PHASE DISTRICT

CB-A8.5

ETR / PTM (PNT-1)

ETR / PTM (PNT-1)

ETR

ALT. #CB-1

ALT. #CB-1

RF-1, RT-1, TS-1

ROOM FINISH SCHEDULE GENERAL NOTES:

1. REFER TO MASTER FINISH KEY FOR MATERIAL DEFINITIONS.

2."ETR": EXISTING TO REMAIN

3. "PTM": PATCH TO MATCH EXISTING, ADJACENT FINISHES

SECOND FLOOR - AREA A

RF-1, RT-1, CPT-2, TS-1,3 RB-3

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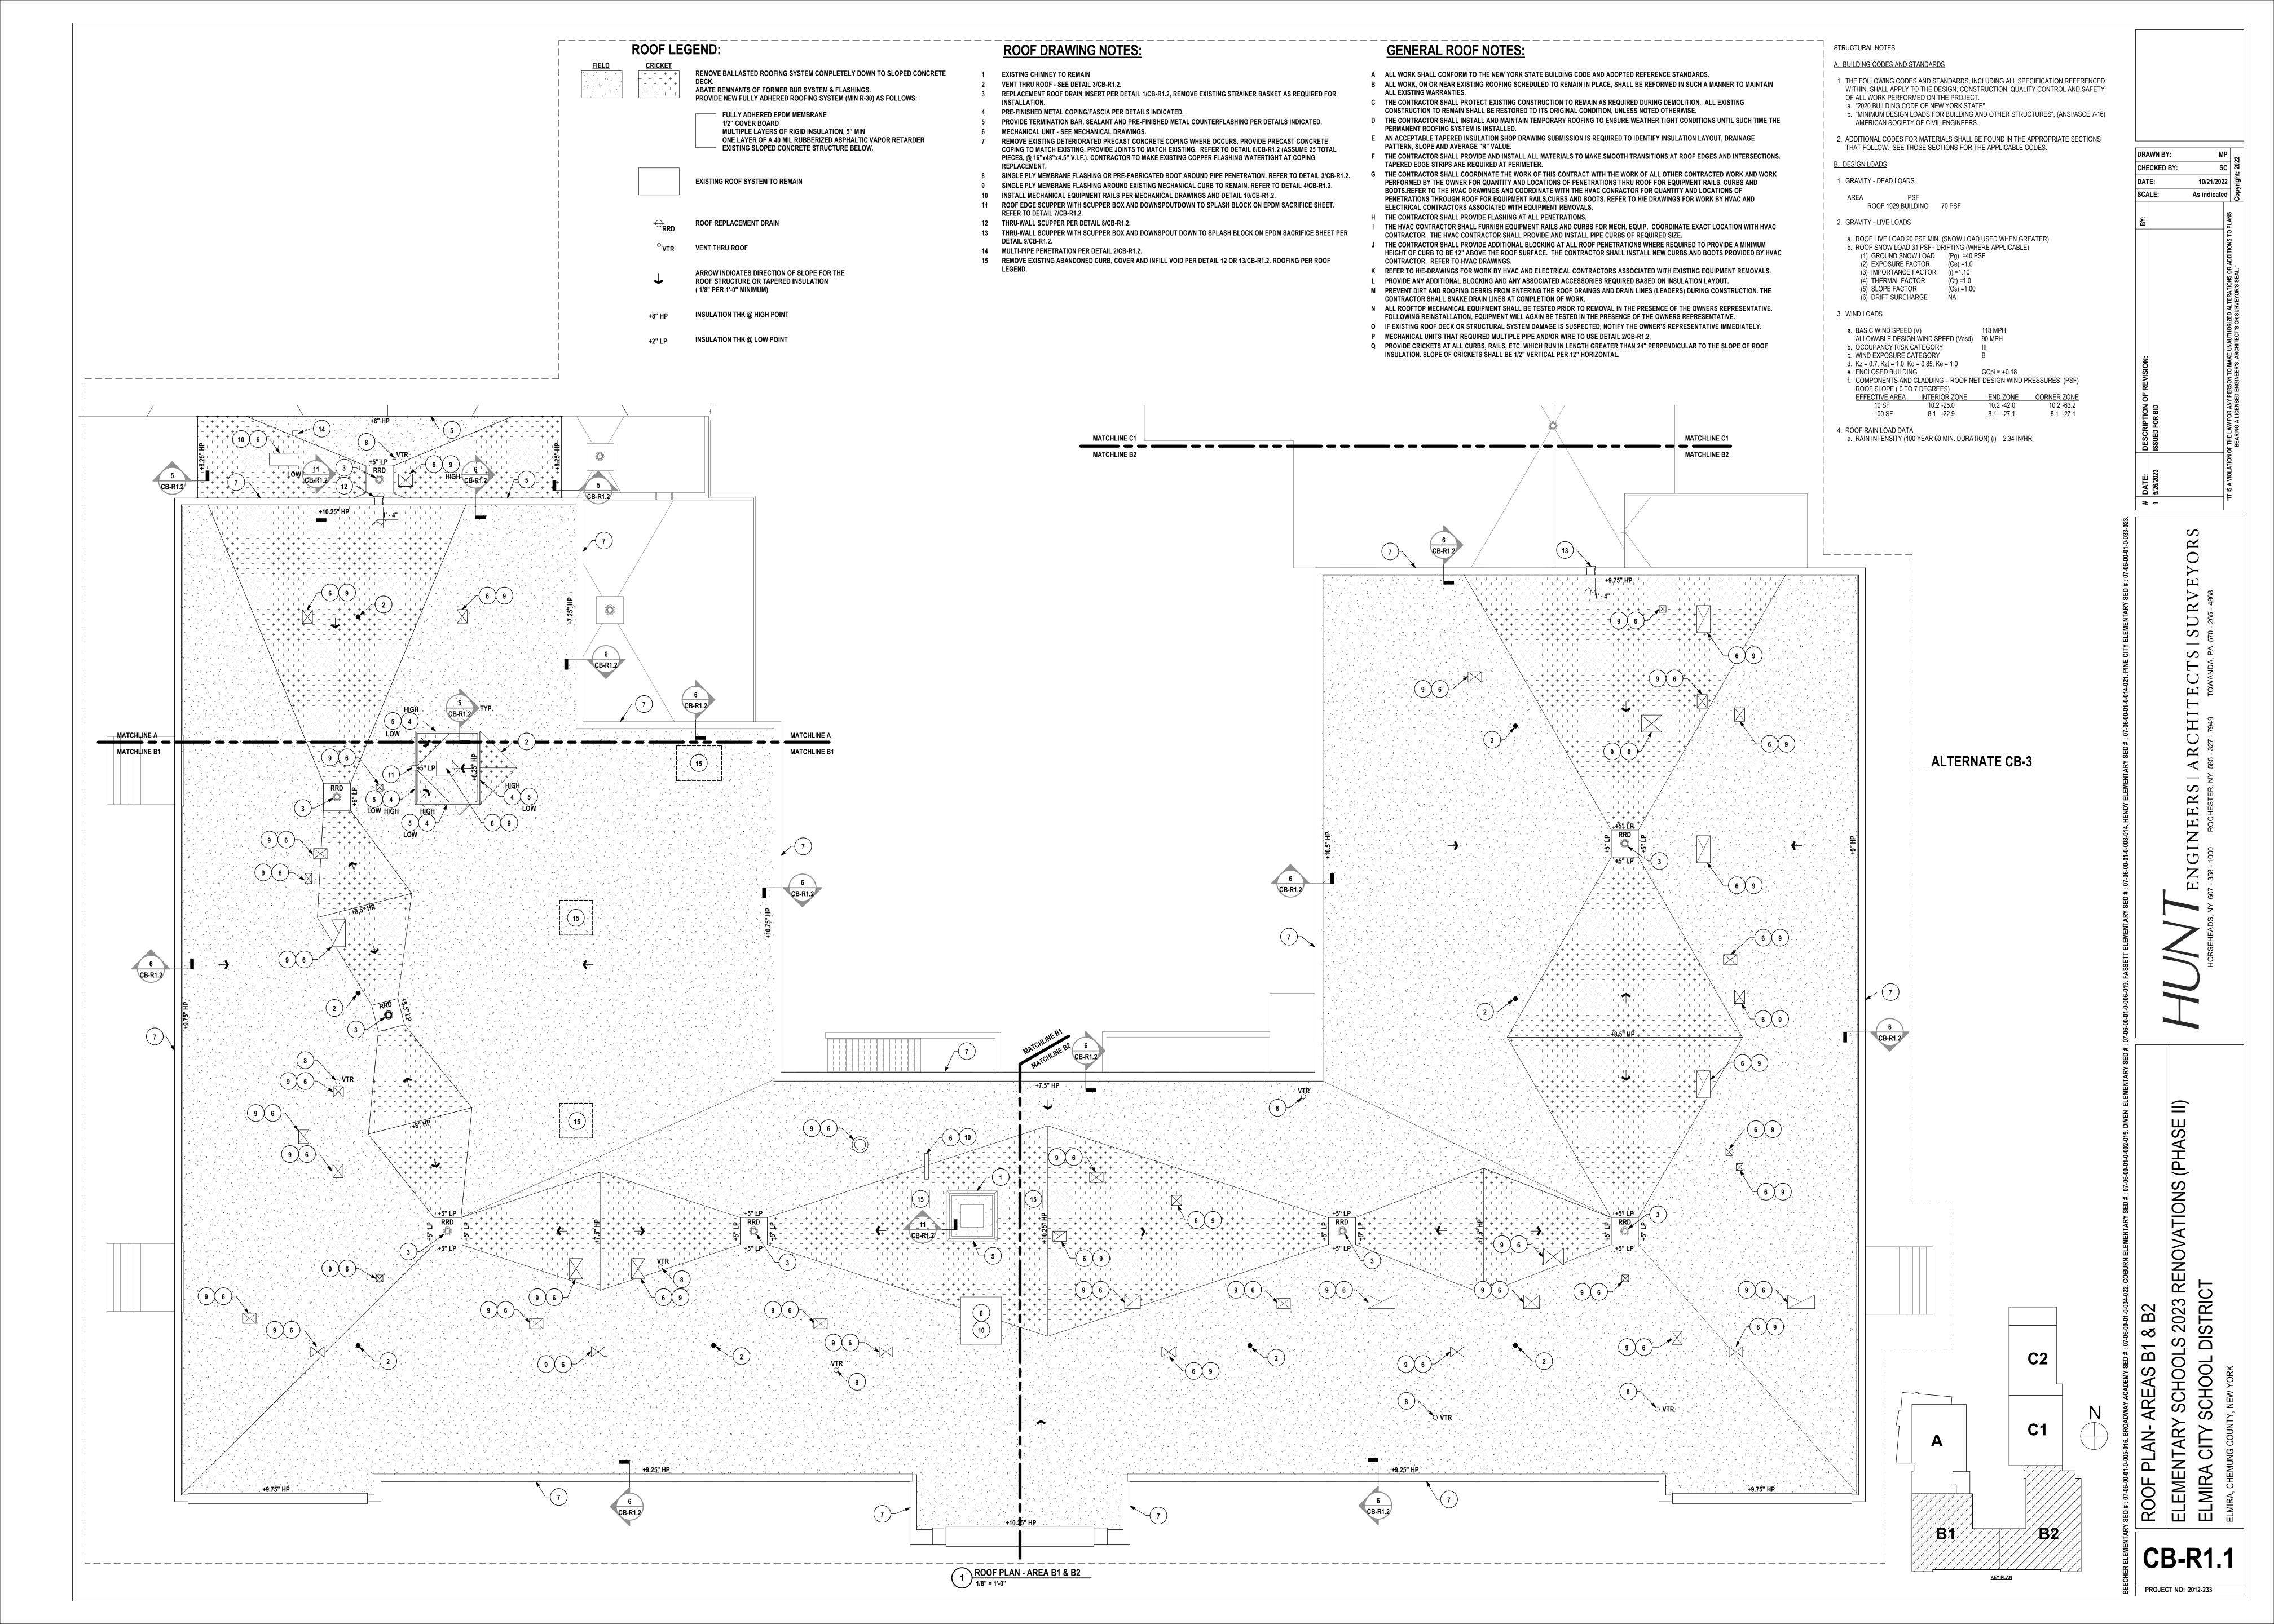
OM FINISH SCHEDULE


'SCHOOLS 2023 RENOVATIONS (PHASE II

SCHOOL DISTRICT

INTERIOR ROOM FINISH S
ELEMENTARY SCHOOLS 2
ELMIRA CITY SCHOOL DIS
ELMIRA, CHEMUNG COUNTY, NEW YORK

CB-A9.1



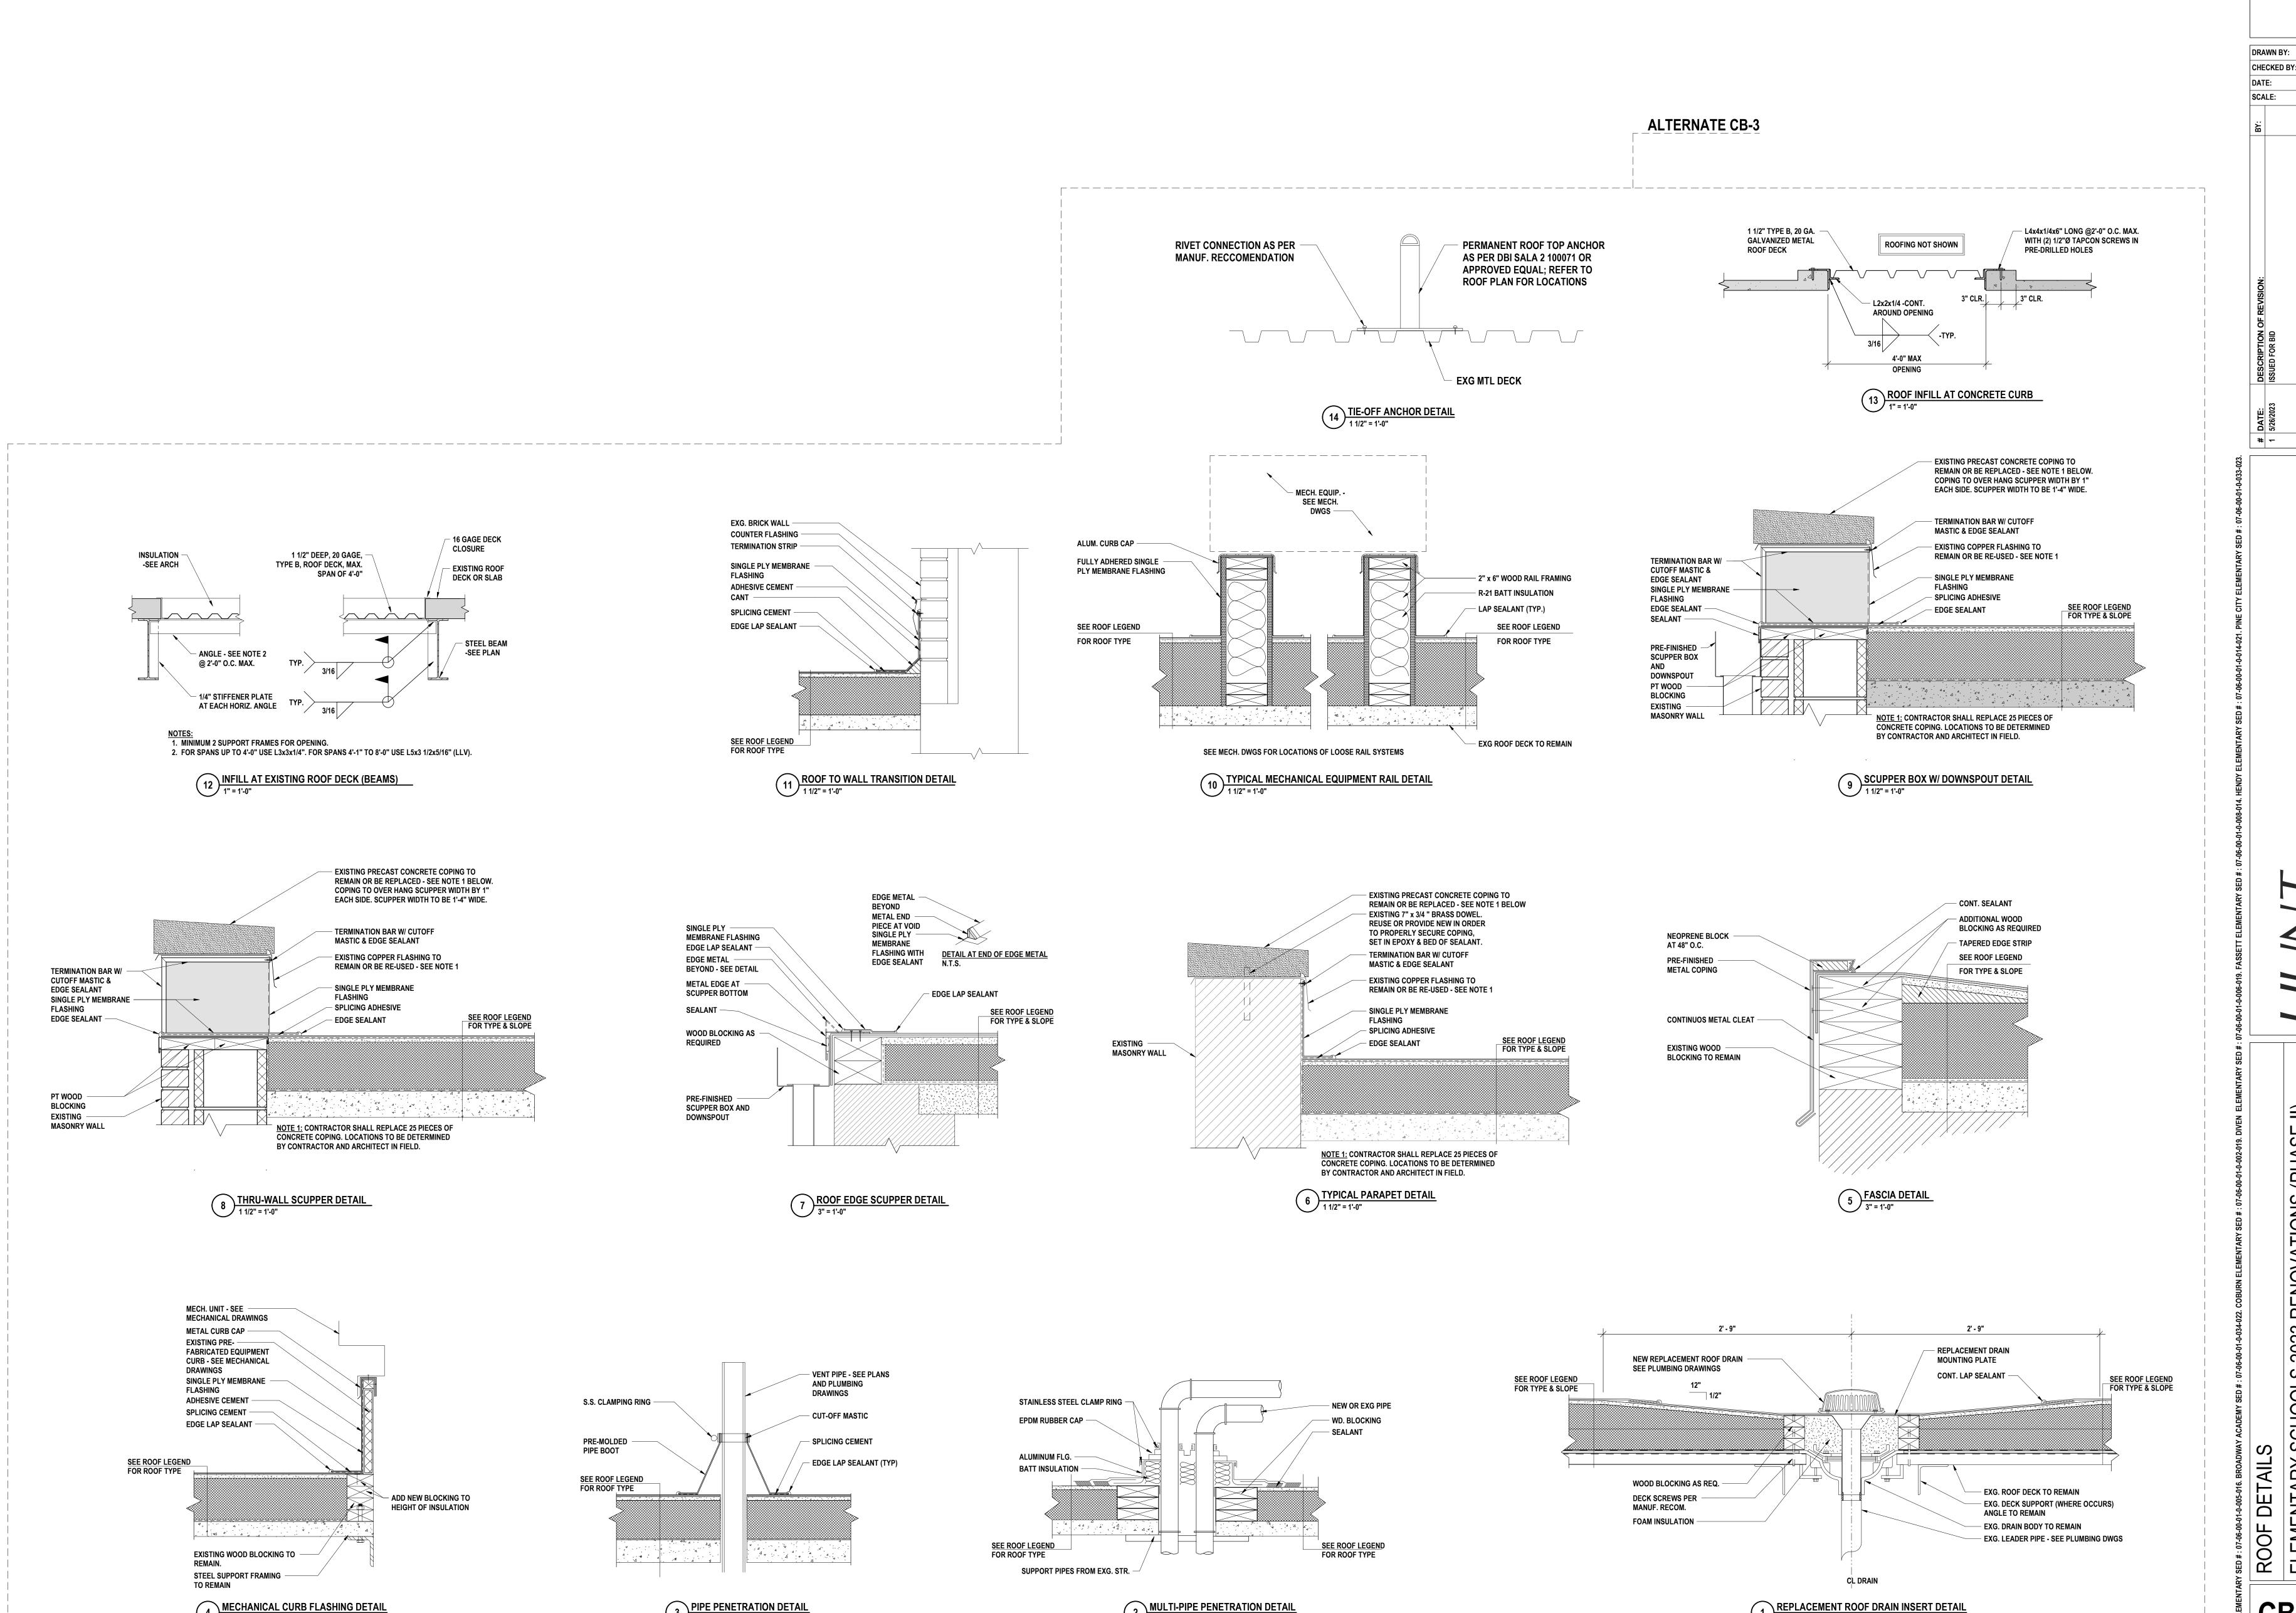

S H \sim $^{\circ}$ Z

10/21/2022

As indicated

S 2023 R DISTRICT

GENERAL NOTES - MECHANICAL

- A ALL EQUIPMENT INTENDED TO BE TURNED OVER TO THE OWNER, SHALL BE BALANCED, FULLY CONTROLLED & FUNCTIONALLY TESTED REGARDLESS OF SUBSTANTIAL COMPLETION
- B THIS DRAWING IS INTENDED TO SHOW THE GENERAL SCOPE OF ITEMS TO BE REMOVED. IT IS NOT INTENDED TO BE ALL INCLUSIVE. THE CONTRACTOR SHALL FIELD VERIFY ALL ITEMS TO BE REMOVED. ANY ITEM IN QUESTION SHOULD BE VERIFIED WITH THE ENGINEER PRIOR TO
- C ALL ITEMS SCHEDULED FOR DEMOLITION ARE THE PROPERTY OF THE OWNER. THE CONTRACTOR SHALL PLACE WANTED EQUIPMENT IN AREA DESIGNATED, ON SITE BY THE OWNER. ANY ITEM THE OWNER WISHES NOT TO KEEP SHALL BE DISPOSED OF BY THE
- CONTRACTOR.

 D THE CONTRACTOR WILL BE RESPONSIBLE FOR ALL CUTTING AND PATCHING UNLESS
 CLEARLY INDICATED TO BE PART OF ANOTHER PRIME CONTRACT. CONTRACTOR TO PATCH
 TO MATCH ALL EXISTING FINISHES RESULTING FROM DEMOLITION WORK UNLESS INDICATED
- TO BE PART OF ANOTHER PRIME CONTRACT.


 E THE CONTRACTOR SHALL REMOVE, PROTECT, REPLACE AND/OR REINSTALL ANY CEILING OR GRID DAMAGED OR REMOVED AS A RESULT OF EXECUTION OF CONTRACT SCOPE. UNLESS INDICATED TO BE PART OF ANOTHER PRIME CONTRACT.
- F COORDINATE ALL NEW ROOF, WALL, AND FLOOR PENETRATIONS WITH OTHER TRADES.
 G PRIOR TO CONSTRUCTION AND INSTALLATION OF NEW WORK, THE CONTRACTOR SHALL FIELD VERIFY ALL EXISTING CONDITIONS (FRAMING, ELECTRICAL, PLUMBING, HVAC, ETC.).
 NOTIFY ARCHITECT/ENGINEER OF ANY CONFLICTS THAT REQUIRE MODIFICATION TO NEW


DEMOLITION NOTES - MECHANICAL

D1 REMOVE HOT WATER HEATER FLUES IN THEIR ENTIRETY.

HVAC SYSTEM INSTALLATION.

D2 REMOVE BOILER IN ITS ENTIRETY. REMOVE HWS/R BACK TO POINTS INDICATED. REMOVE FLUE & INTAKE BACK TO POINTS INDICATED. ALTERNATE CB-2.

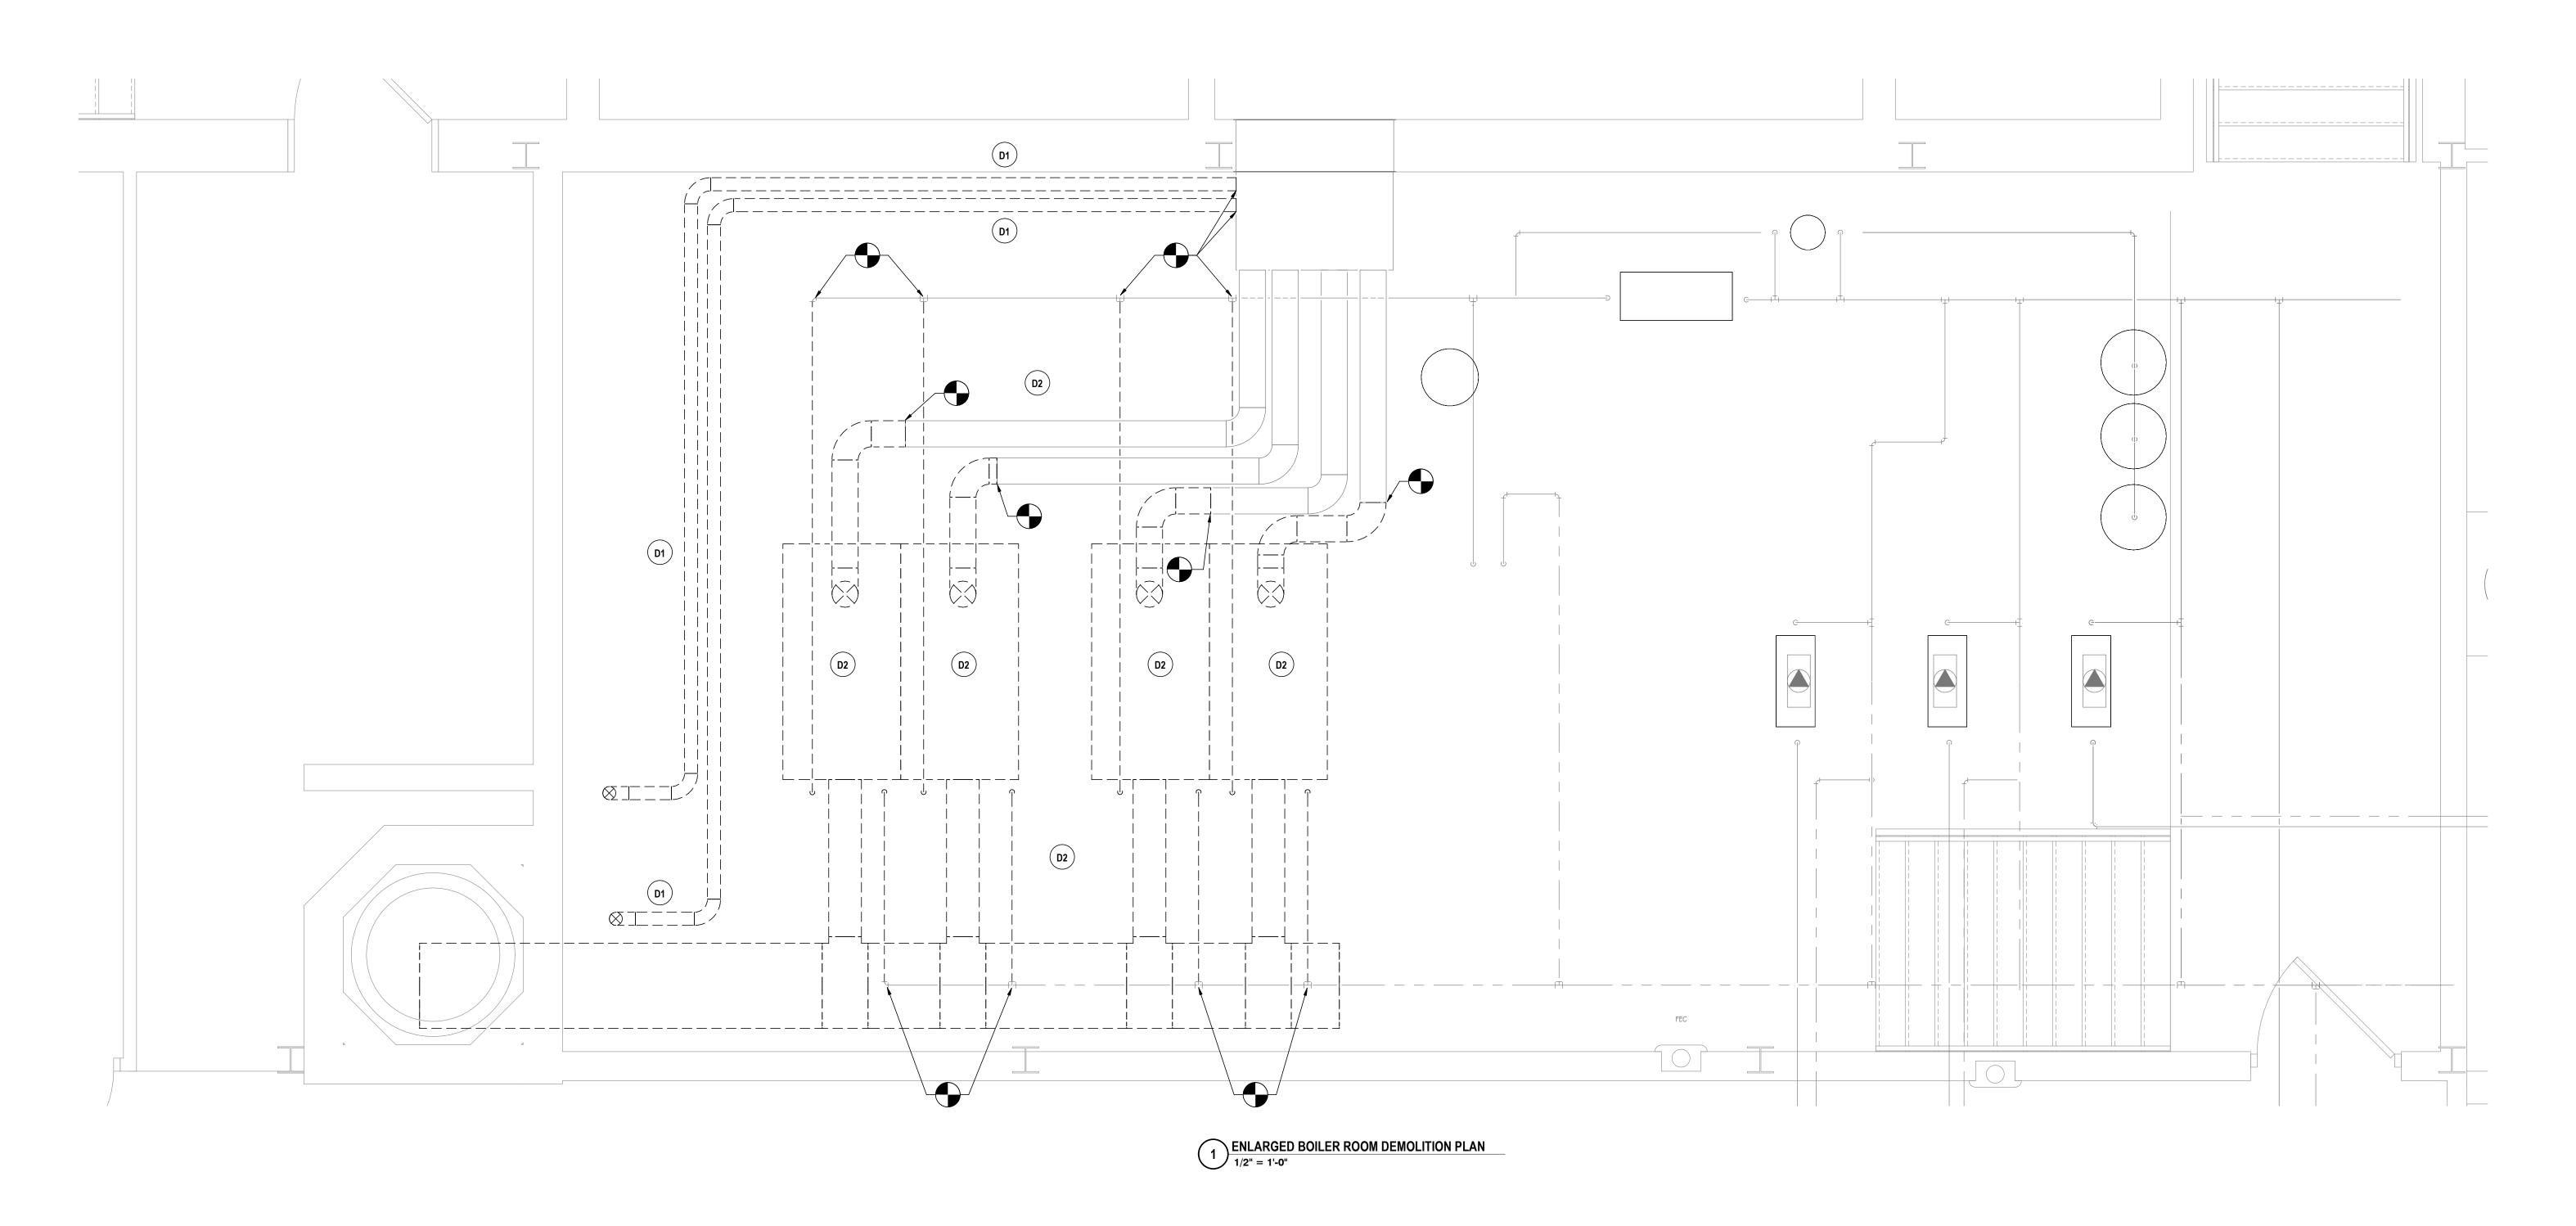

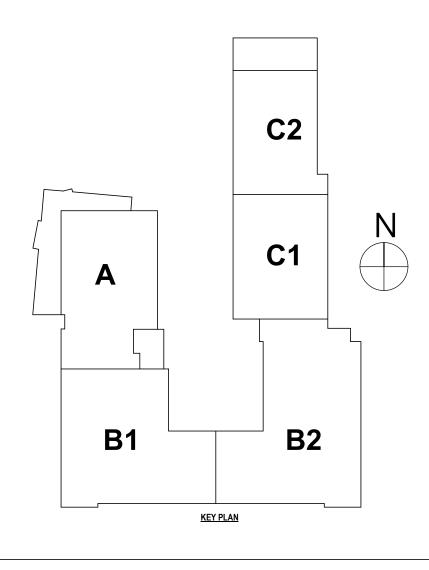

DATE: DESCRIPTION OF REVISION:

1 5/26/2023 ISSUED FOR BID

3 SA SOLITION OF THE LAW FOR ANY PERSON TO MAKE UNAUTHORIZED ALTERATIONS OR ADDITIONS TO PLANS

BEARING A LICENSED ENGINEER'S, ARCHITECT'S OR SURVEYOR'S SEAL."

2 SA DATE: DESCRIPTION OF REVISION: A SA DATE AND THE LAW FOR ANY PERSON TO MAKE UNAUTHORIZED ALTERATIONS OR ADDITIONS TO PLANS


COPYMIGHT: 2022

HORSEHEADS, NY 607 - 358 - 1000 ROCHESTER, NY 585 - 327 - 7949 TOWANDA, PA 570 - 265 - 4868

SEMY SED #: 07-06-00-01-0-034-022. COBURN ELEMENTARY SED #: 07-06-00-01-0-002-019. DIVEN ELEMENTARY SERVICE PROPERTY SET AND S

ENLARGED BOILER ROELEMENTARY SCHOOLELMIRA CITY SCHOOL

CB-H0.1

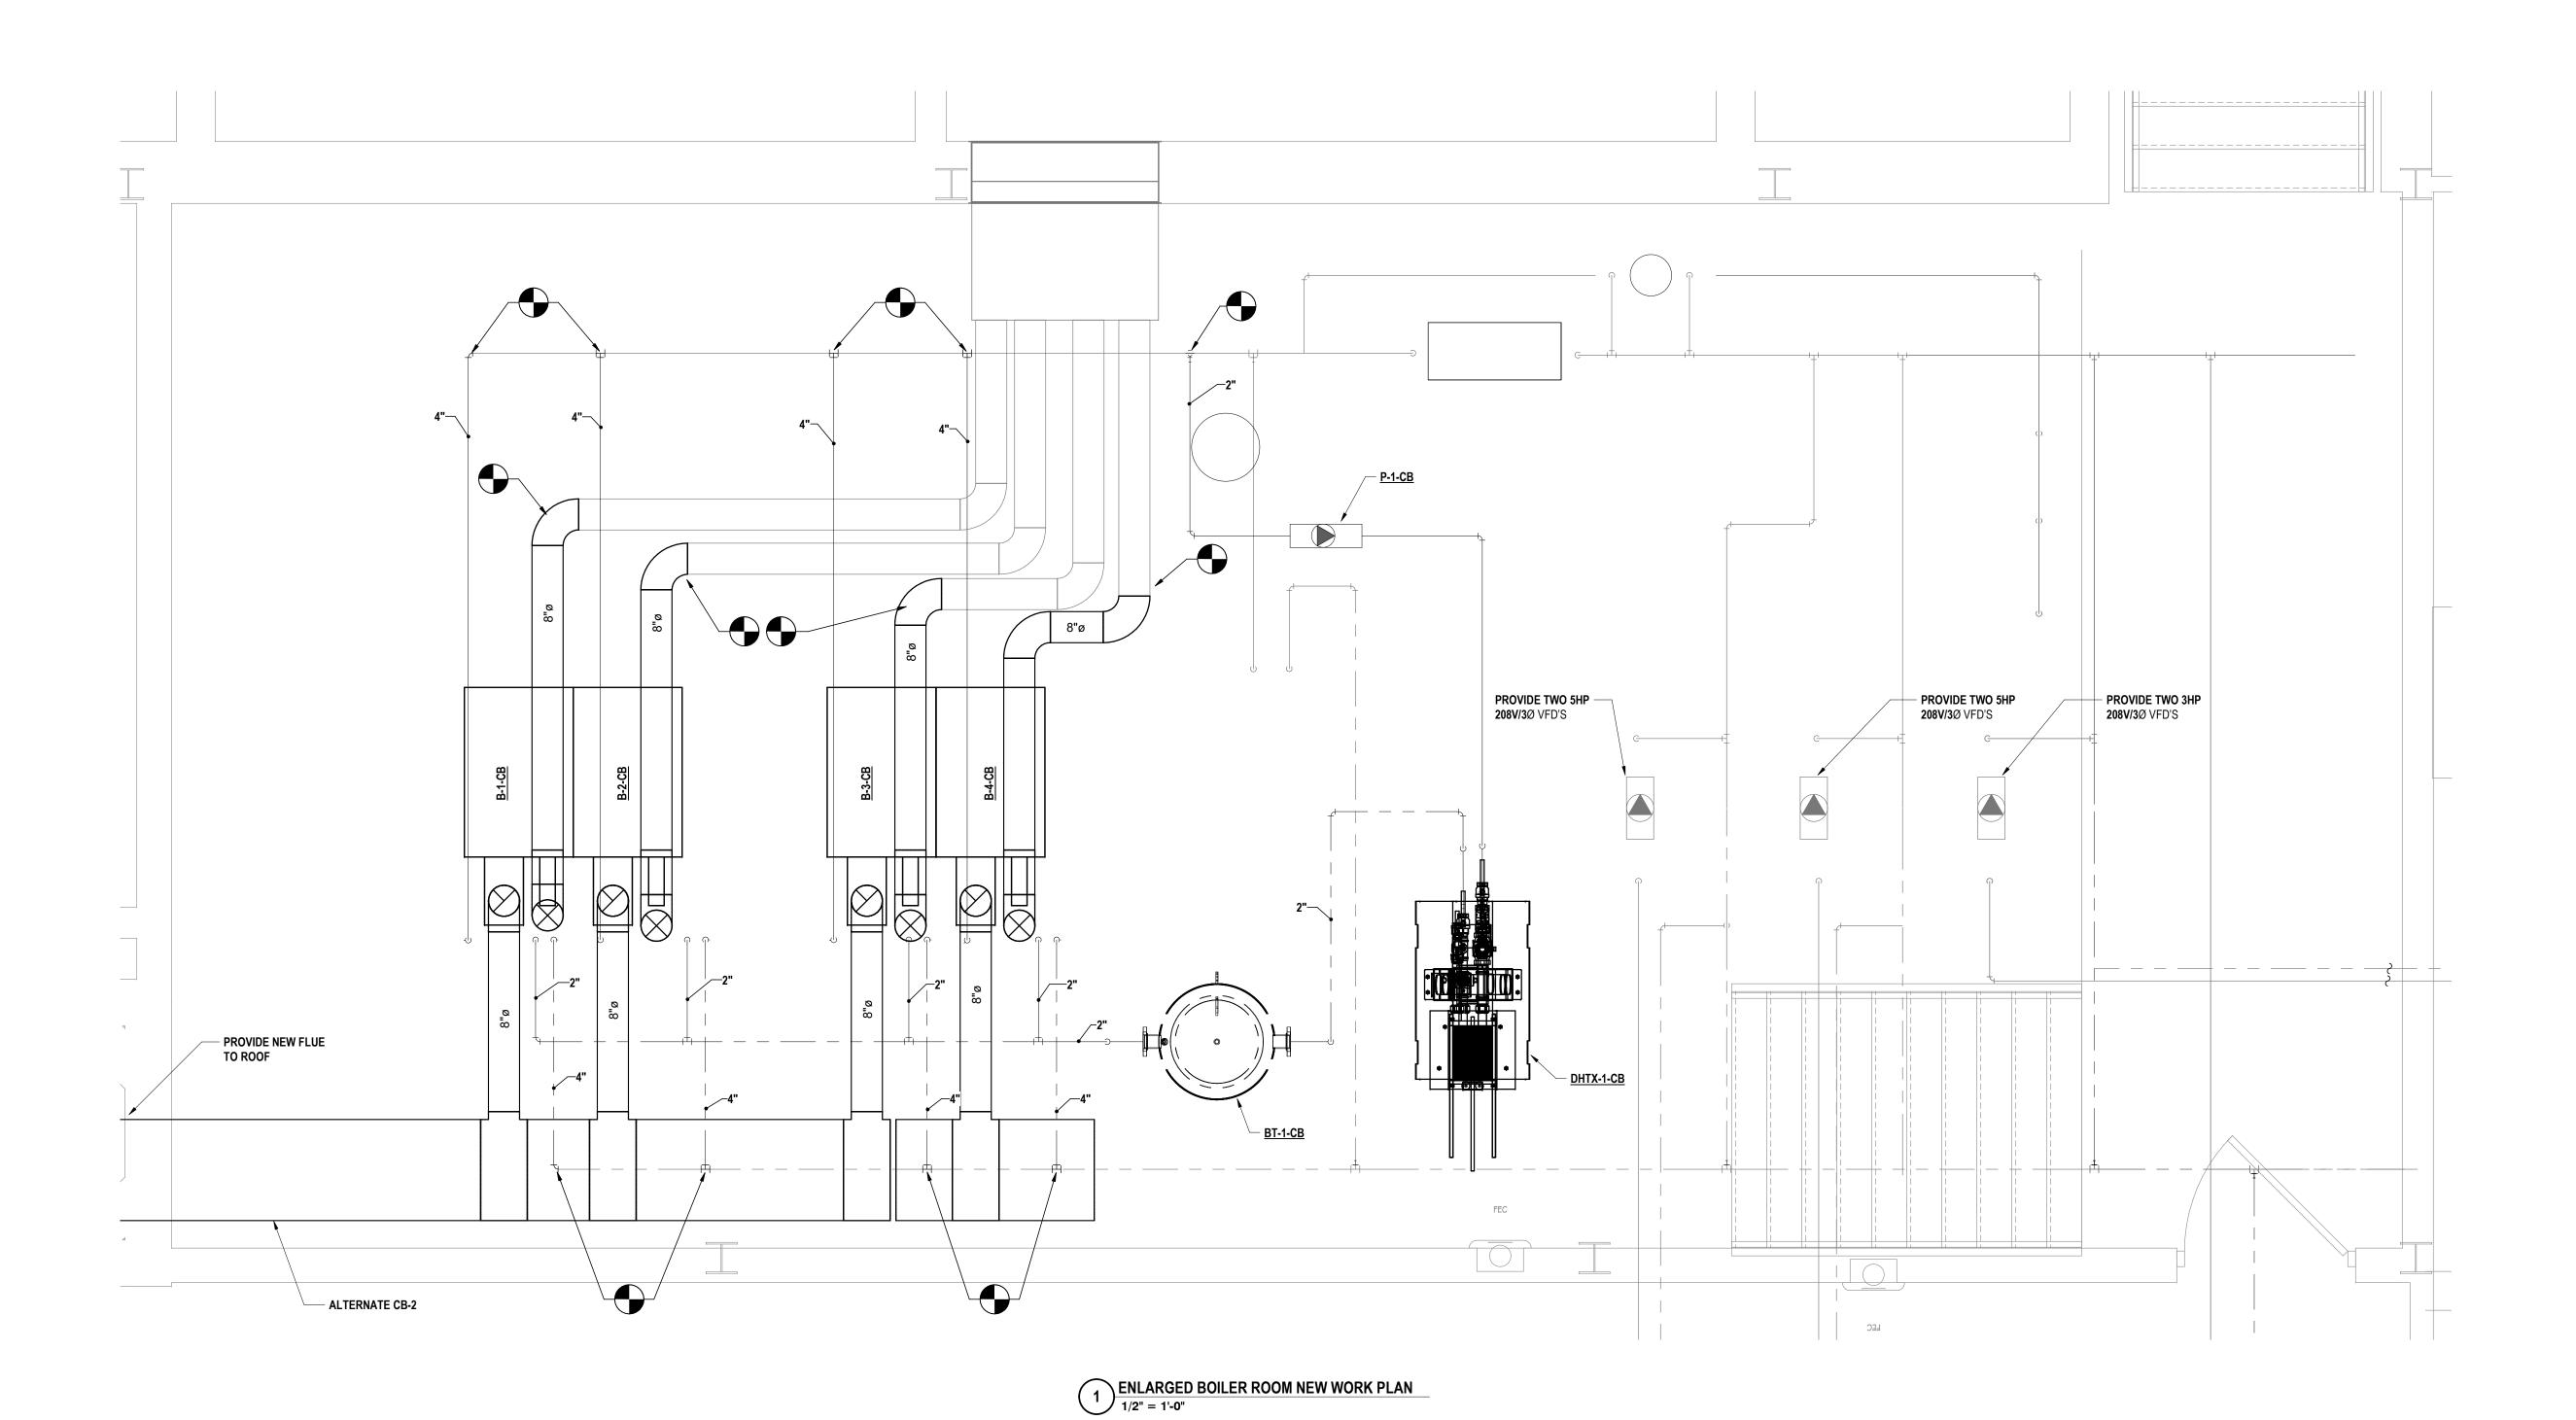

GENERAL NOTES - MECHANICAL REFER TO HS-H0.1.

CONSTRUCTION NOTES MECHANICAL

- REMOVE CONDENSING UNIT TO ALLOW FOR INSTALLATION OF NEW RAILS. FURNISH NEW RAILS & REINSTALL UNIT.
- REMOVE HOOD TO ALLOW FOR NEW ROOFING. REINSTALL HOOD AFTER ROOF IS COMPLETE.
- REMOVE EXHAUST FAN TO ALLOW FOR NEW ROOFING. REINSTALL EXHAUST FAN AFTER ROOF IS COMPLETE.

DRAWN BY: CHECKED BY: 10/21/2022 SCALE: 1/2" = 1'-0"

> S - 05 ARCHI7 ENGINEERS |


ENLARGED BOILER ROOM NEW WORK PLAN

ELEMENTARY SCHOOLS 2023 RENOVATIONS (PF

ELMIRA CITY SCHOOL DISTRICT

ELMIRA, CHEMUNG COUNTY, NEW YORK

CB-H1.1

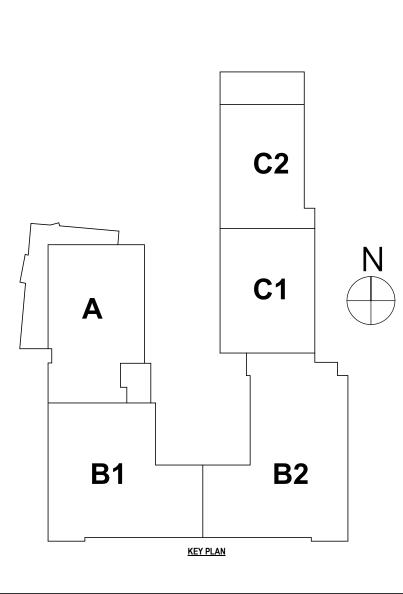

REFER TO HS-H0.1.

CONSTRUCTION NOTES MECHANICAL

REMOVE CONDENSING UNIT TO ALLOW FOR INSTALLATION OF NEW RAILS. FURNISH NEW RAILS & REINSTALL UNIT.

DRAWN BY:

SCALE:

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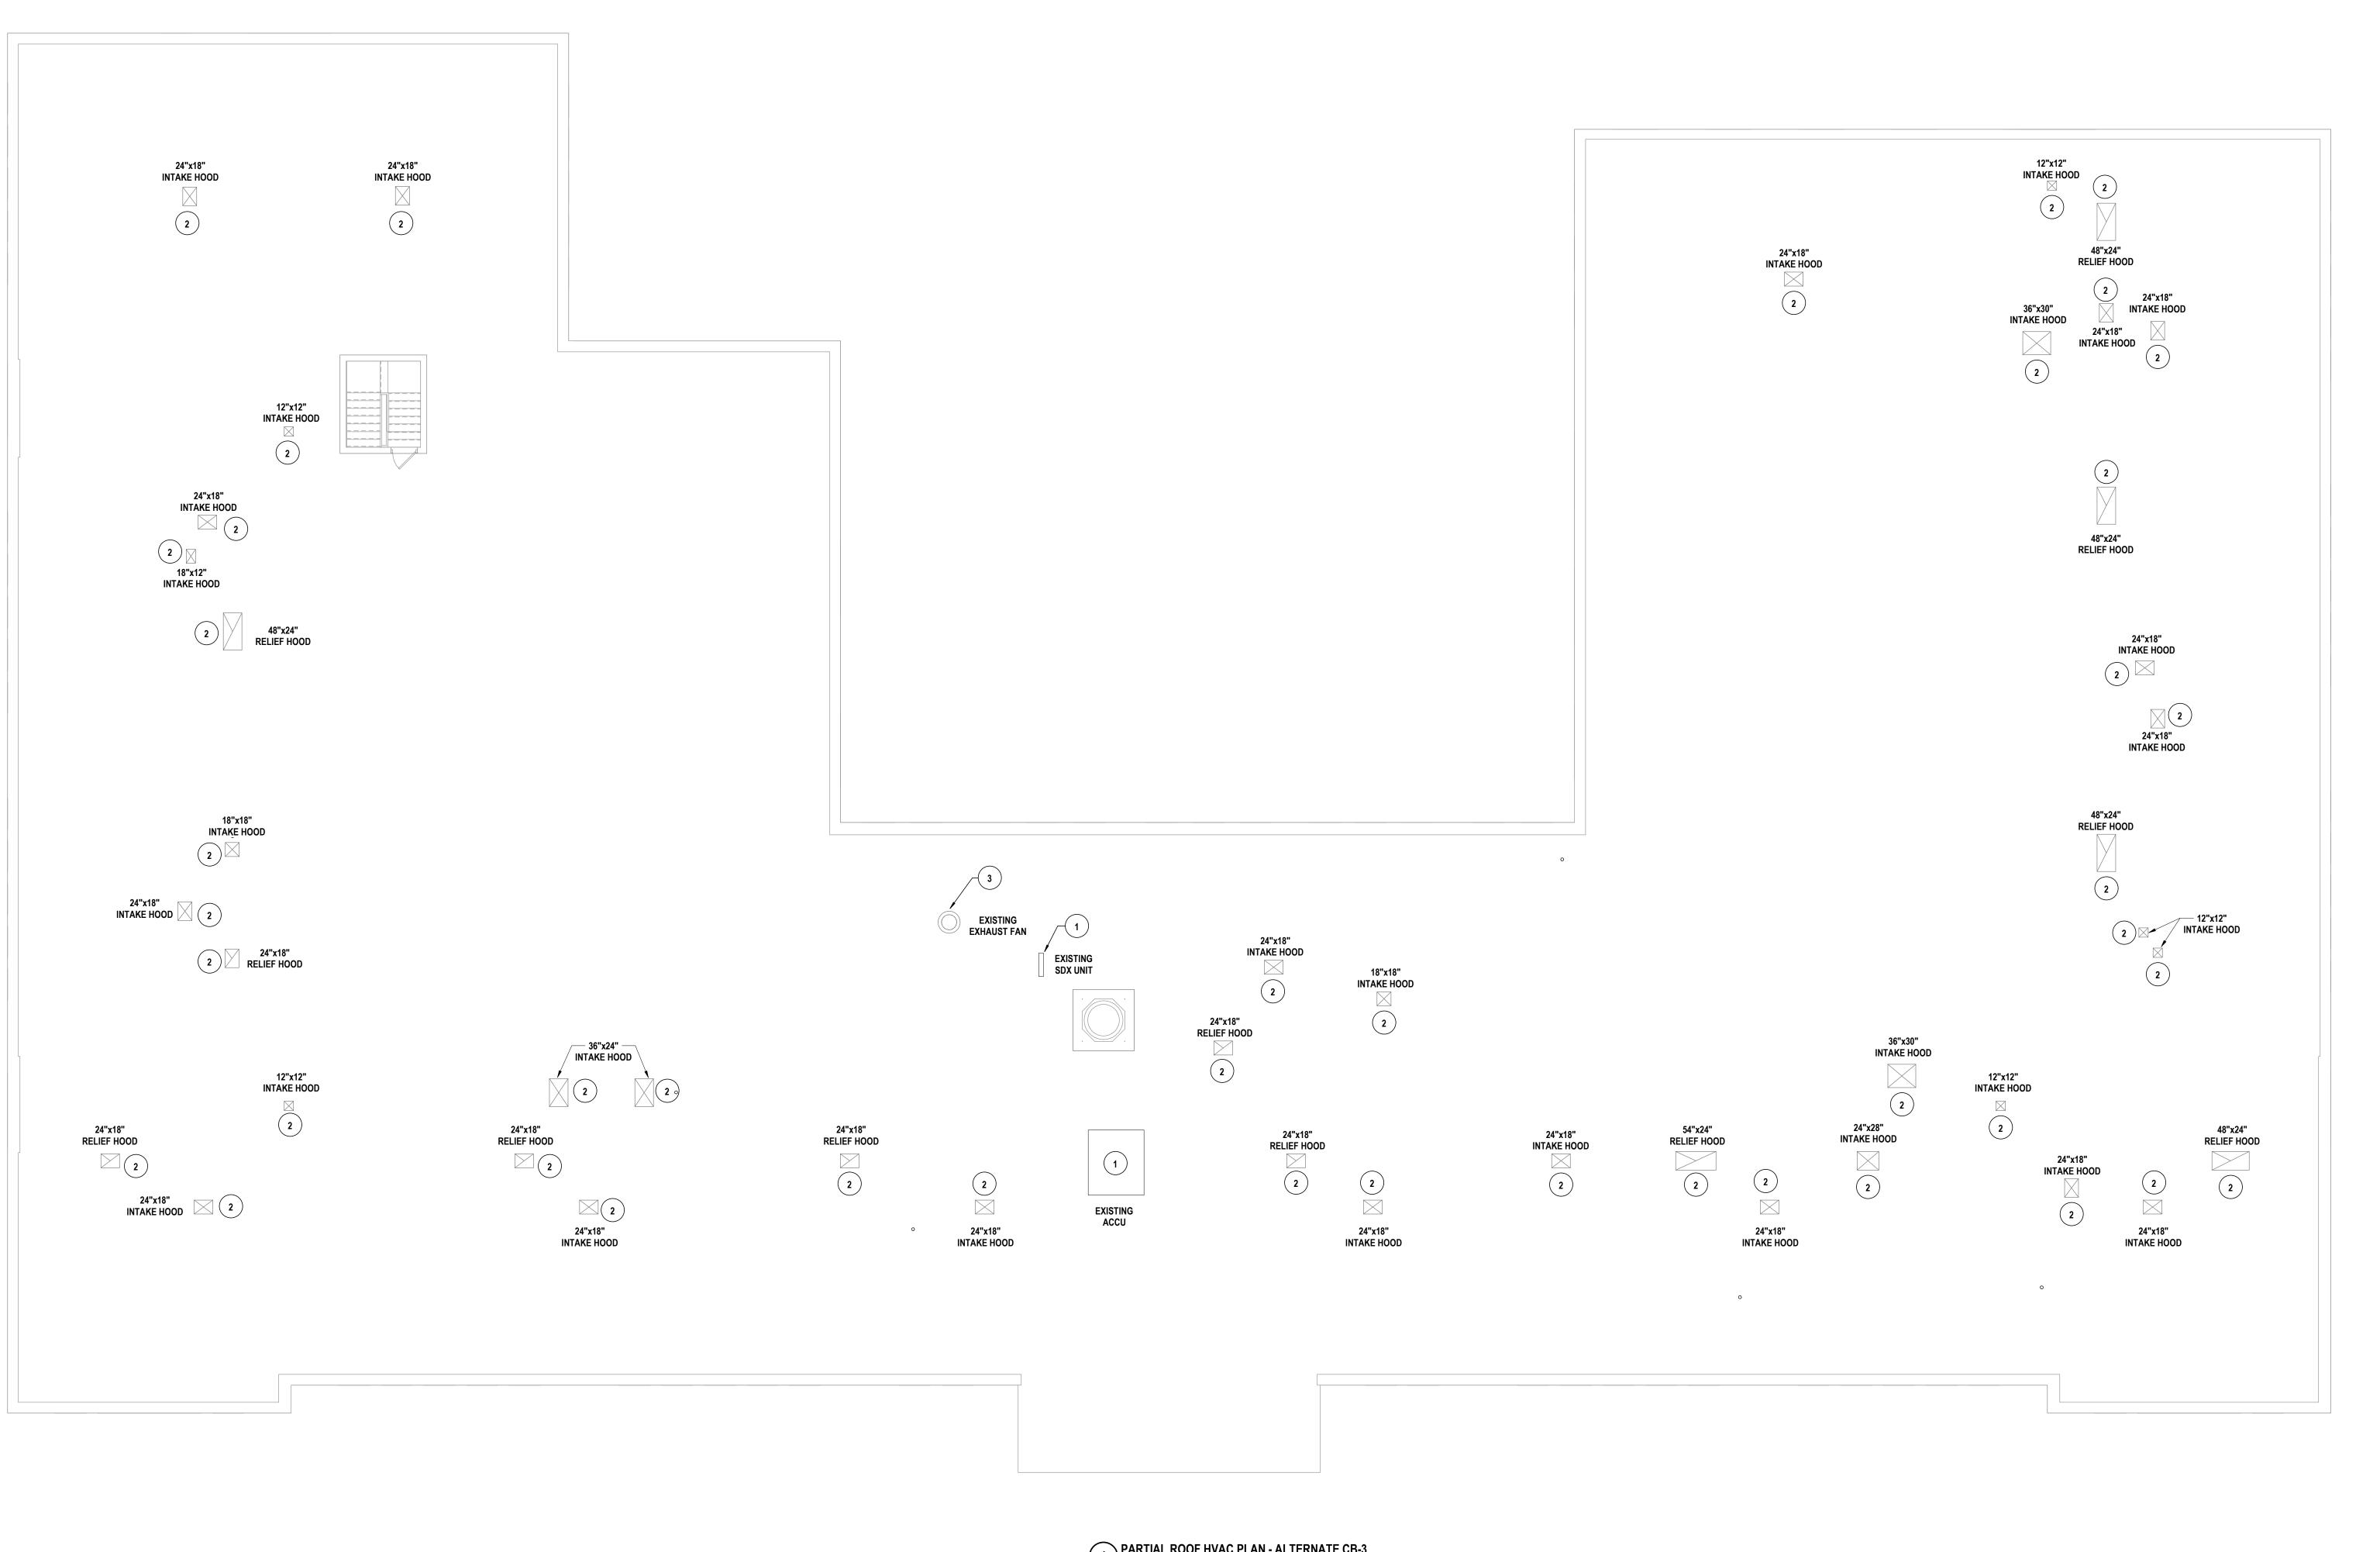
10/21/2022


1/8" = 1'-0"

 \sim 6

ENGINEERS | ARCHITEC

- REMOVE HOOD TO ALLOW FOR NEW ROOFING. REINSTALL HOOD AFTER ROOF IS
- REMOVE EXHAUST FAN TO ALLOW FOR NEW ROOFING. REINSTALL EXHAUST FAN AFTER ROOF IS COMPLETE.



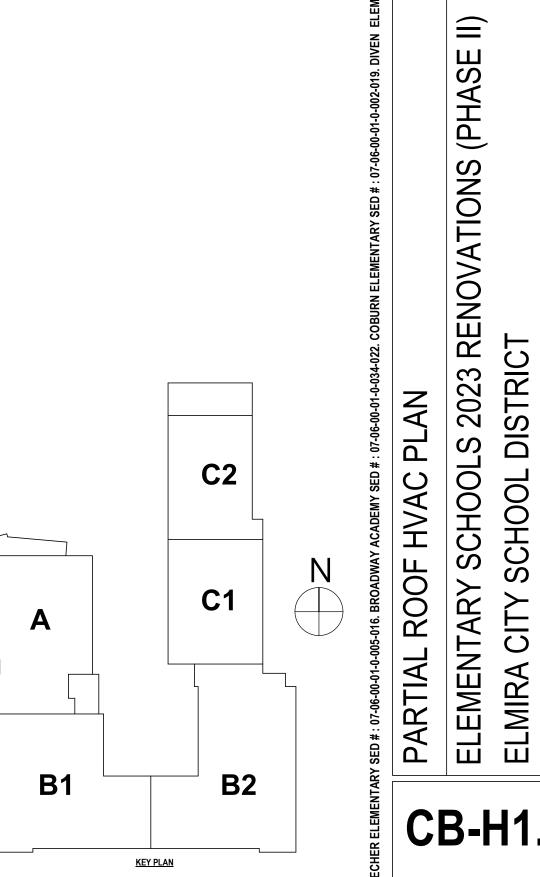

PARTIAL ROOF HVAC PLAN - ALTERNATE CB-3

1/8" = 1'-0"

CB-H1.2 PROJECT NO: 2012-233

	BOILER SCHEDULE														
			HEATIN	IG DATA				MANUFACTURER &							
UNIT NUMBER	LOCATION	MODEL#	INPUT MBH	OUTPUT MBH	FLUE SIZE	VOLTS	PHASE	AMPS	NOTES						
B-1-CB	CB-H-1.1	BMK-2000-PLATINUM	2000	1920	8"	120 V	1	16 A	AERCO 1,2,3						
B-2-CB	CB-H-1.1	BMK-2000-PLATINUM	2000	1920	8"	120 V	1	16 A	AERCO 1,2,3						
B-3-CB	CB-H-1.1	BMK-2000-PLATINUM	2000	1920	8"	120 V	1	16 A	AERCO 1,2,3						
B-4-CB	CB-H-1.1	BMK-2000-PLATINUM	2000	1920	8"	120 V	1	16 A	AERCO 1,2,3						

NOTES: 1. E.C. TO PROVIDE SEPERATE 20 A CIRCUIT FOR EACH BOILER.
2. RECONNECT TO EXISTING EMEGENCY BOILER SHUTDOWN SWITCHES.
3. ALTERNATE CB-2.

BUFFER TANK SCHEDULE														
							MAX WORKING							
UNIT NUMBER	SERVES	MODEL#	LOCATION	TANK VOLUME	TANK DIA. (IN)	TANK HEIGHT (IN)	PRESSURE	PIPE CONNECTION SIZE	NOTES					
BT-1-CB	DW-HTX-1CB	AERCO 2 PORT		210	2' - 6"	73.5	125 PSIG	3" NPT	1,2,3					

DTES: 1. DESIGN MAKE BASED ON AERCO.
2. PROVIDE TANK WITH ASME CERTIFICATION.
3. PROVIDE CONNECTIONS FOR AIR VENT AND DRAIN.

DOMESTIC HOT WATER HEAT EXCHANGER														
				DOMESTIC WATER SID	E	BOILER WA	ATER SIDE							
UNIT NUMBER	LOCATION	MODEL#	GPM	TOTAL PRESSURE DROP (PSI)	INLET/OUTLET WATER TEMP °F	FLOW GPM	EWT (°F)	LWT (°F)	TOTAL PRESSURE DROP (PSI)	NOTES				
DW-HTX-1-CB	CB-H1.1	SPDW 23	9	1	40/100	26	125	96	5	1,2,3,4,5				

NOTES: 1. DESIGN BASED ON AERCO.

PROVIDE PACKAGED 3-WAY ELECTRONIC CONTROL VALVE.
PROVIDE STAINLESS STEEL POTABLE WATER SIDE SURFACES.
UNIT TO BE ASEM B&PV CODE SECTION VIII DIVISION 1 STAMPED.


ELECTRICAL REQUIREMENTS 120V/1PH, 2AMP.


	PUMP SCHEDULE												
	LOCATION					ELEC	CTRIC						
UNIT NUMBE	R (SHEET #)	GPM	HEAD FEET	RPM	MOTOR HP	VOLTS	PHASE	MAKE & MODEL#	NOTES				
P-1-CB	CB-H1.1	30	35	2713	1	480 V	3	ARMSTRONG PUMPS 4300DC 1206-000.7	1,2,3				


NOTES: 1. E.C. TO FURNISH AND WIRE DISCONNECT.
2. E.C. TO FURNISH STARTER WITH CONTACT CLOSURE FOR USE BY DDC SYSTEM.

B PUMPS REPRESENT STAND-BYE.

START STOP SHALL BE BY DDC SYSTEM.
 PUMP MUST BE SUITABLE FOR CHLORINE SERVICE.

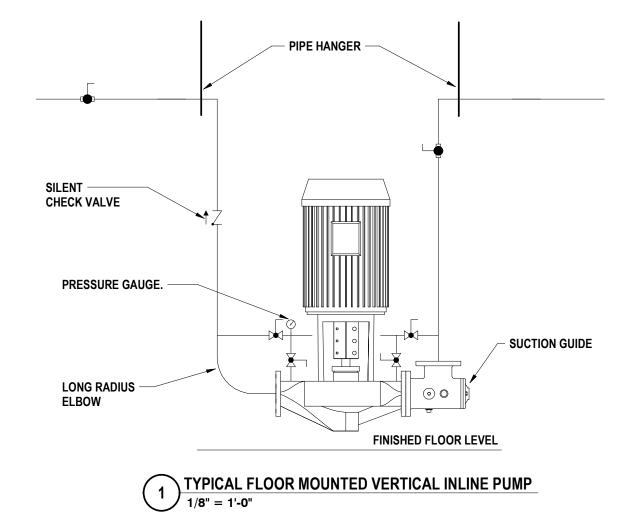

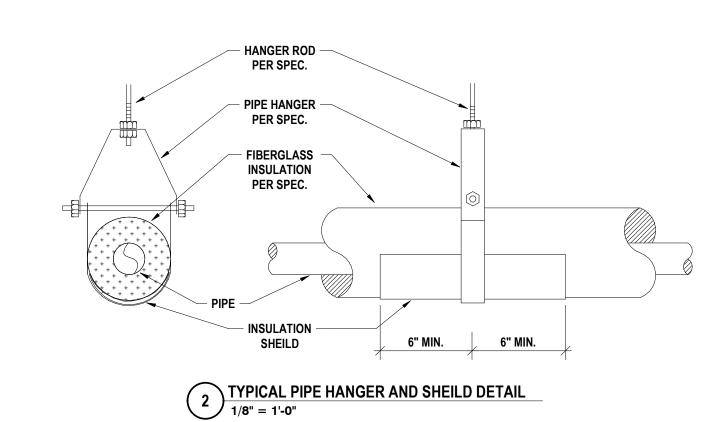

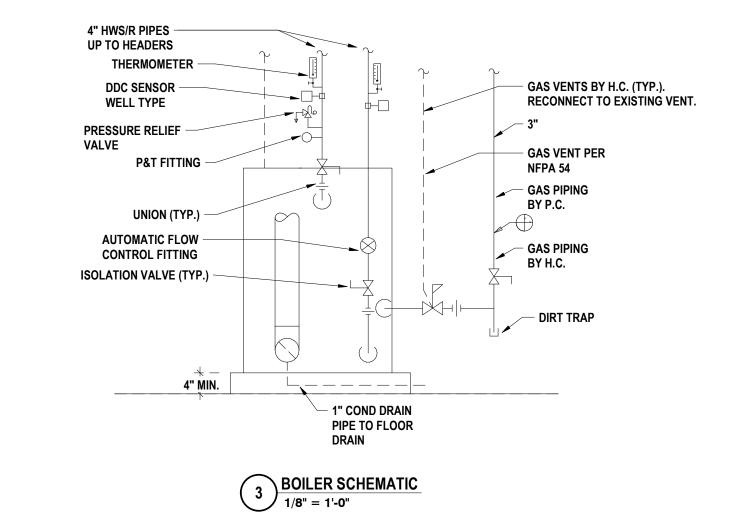

DATE: DESCRIPTION OF REVISION:

1 5/26/2023 ISSUED FOR BID

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HORSEHEADS, NY 607 - 358 - 1000 ROCHESTER, NY 585 - 327 - 7949 TOWANDA, PA 570 - 265 - 4868

SCHEDULES

ELEMENTARY SCHOOLS 2023 RENOVATIONS (PHASE II)

ELMIRA CITY SCHOOL DISTRICT

ELMIRA, CHEMUNG COUNTY, NEW YORK

CB-H2.1

BOILER ROOM DOMESTIC PLAN

1/4" = 1'-0"

1 BOILER ROOM DEMOLITION PLAN
1/4" = 1'-0"

GENERAL NOTES - PLUMBING

- A ALL WORK ON THIS DRAWING IS THE RESPONSIBILITY OF THE PLUMBING CONTRACTOR UNLESS CLEARLY INDICATED TO BE PART OF ANOTHER CONTRACT. B THESE DRAWINGS ARE INTENDED TO SHOW THE GENERAL SCOPE OF ITEMS TO BE REMOVED. IT IS NOT INTENDED TO BE ALL INCLUSIVE. THE CONTRACTOR SHALL FIELD
- VERIFY ALL ITEMS TO BE REMOVED. ANY ITEM IN QUESTION SHOULD BE VERIFIED WITH **ENGINEER PRIOR TO REMOVAL** C ALL ITEMS SCHEDULED FOR DEMOLITION ARE THE PROPERTY OF THE OWNER. THE CONTRACTOR SHALL PLACE WANTED EQUIPMENT IN AREA DESIGNATED ON SITE BY OWNER. ANY ITEM THE OWNER WISHES NOT TO KEEP SHALL BE PROPERLY DISPOSED
- OF BY THE CONTRACTOR. D THE CONTRACTOR SHALL REMOVE, PROTECT, REPLACE AND/OR REINSTALL ANY CEILING OR GRID DAMAGED OR REMOVED AS A RESULT OF EXECUTION OF CONTRACT
- SCOPE. UNLESS OTHERWISE INDICATED TO BE PART OF ANOTHER PRIME CONTRACT. E THE PLUMBING CONTRACTOR SHALL FIELD VERIFY ALL EXISTING CONDITIONS (FRAMING, ELECTRICAL, PLUMBING, HVAC, ETC) PRIOR TO CONSTRUCTION AND
- REQUIRE MODIFICATION TO NEW PLUMBING SYSTEM INSTALLATION. F THE CONTRACTOR IS TO REINSULATE ALL PORTIONS OF EXISTING PLUMBING SYSTEM DISTURBED DURING EXECUTION OF CONTRACT SCOPE.
- G THE PLUMBING CONTRACTOR WILL BE RESPONSIBLE FOR ALL NEW FLOOR OPENINGS, EXCAVATIONS OF EXISTING SUBSTRATES AND WALL PENETRATIONS TO INSTALL NEW PIPING. UNLESS OTHERWISE NOTED, ALL PIPE PENETRATIONS THROUGH WALLS AND

INSTALLATION OF NEW WORK. NOTIFY ARCHITECT/ENGINEER OF ANY CONFLICTS THAT

- FLOORS WILL BE SEALED WITH FIRE-STOPPING H UNLESS NOTED OTHERWISE THE PLUMBING CONTRACTOR IS RESPONSIBLE FOR INSTALLATION OF ALL PIPING WITHIN 5 FEET FROM BUILDING. COORDINATE
- CONNECTIONS. THE PLUMBING CONTRACTOR WILL BE RESPONSIBLE FOR PATCHING AND SEALING OF
- ALL DISTURBED SUBSTRATE, WALLS AND CEILING TO EXISTING FINISHES UNLESS OTHERWISE NOTED. J THE PLUMBING CONTRACTOR TO COORDINATE ALL NEW ROOF, WALL & FLOOR
- PENETRATIONS.
- K INVERT DIMENSION IS TO BOTTOM OF PIPE.
- L ALL PIPING TO BE ROUTED AS HIGH AND AS TIGHT TO STEEL STRUCTURE AS POSSIBLE. M THE CONTRACTOR WILL BE RESPONSIBLE FOR FINAL CONNECTION OF PLUMBING UTILITIES TO ALL EQUIPMENT REQUIRING SAID UTILITIES, INCLUDING THOSE PROVIDED
- BY OTHERS. COORDINATE AS REQUIRED. N THE CONTRACTOR IS TO PROVIDE ADA COMPLIANT VINYL PIPE COVER ON EXPOSED COLD WATER, HOT WATER AND SANITARY PIPING BELOW ADA LAVATORY/SINK.
- SANITARY PIPE COVER SHALL BE INSTALLED UP TO BOTTOM OF FIXTURE. O REFER TO ARCH DRAWINGS FOR INDICATION OF ADA FIXTURES & ACCESSORIES, & ASSOCIATED MOUNTING HEIGHTS.

DEMOLITION NOTES - PLUMBING

- D1 DISCONNECT AND REMOVE BOOSTER HEATER AND ALL ASSOCIATED ACCESSORIES IN ITS ENTIRETY. PREPARE FOR RECONNECTION IN NEW WORK.
- D2 DISCONNECT AND REMOVE WATER HEATER AND ALL ASSOCIATED ACCESSORIES IN ITS ENTIRETY. DISCONNECT AND REMOVE COLD WATER, HOT WATER, HOT WATER RETURN AND GAS PIPING BACK TO POINTS INDICATED. PREPARE FOR
- D3 DISCONNECT AND REMOVE ROOF DRAIN AND ALL ASSOCIATED ACCESSORIES IN ITS ENTIRETY. PREPARE FOR RECONNECTION IN NEW WORK.

CONSTRUCTION NOTES - PLUMBING

- NEW GAS BOOSTER HEATER SIMILAR TO VANGUARD MODEL PM200. PROVIDE VENT KIT. CONNECT TO EXISTING 3/4" GAS AND 1" HOT WATER.
- EXISTING VENT THROUGH ROOF. EXTEND TO 18 INCHES ABOVE FINISHED ROOF. NEW RETROFIT ROOF DRAIN SIMILAR TO ZURN MODEL RD2150.

DRAWN BY:

CHECKED BY:

CJH

JDG

10/21/2022

1/4" = 1'-0"

C2


KEY PLAN


CB-P1.1

GENERAL NOTES - PLUMBING REFER TO HS-P0.1.

DEMOLITION NOTES - PLUMBING

- D1 DISCONNECT AND REMOVE BOOSTER HEATER AND ALL ASSOCIATED ACCESSORIES IN ITS ENTIRETY. PREPARE FOR RECONNECTION IN NEW WORK.
- D2 DISCONNECT AND REMOVE WATER HEATER AND ALL ASSOCIATED ACCESSORIES IN ITS ENTIRETY. DISCONNECT AND REMOVE COLD WATER, HOT WATER, HOT WATER RETURN AND GAS PIPING BACK TO POINTS INDICATED. PREPARE FOR RECONNECTION IN NEW WORK.
- D3 DISCONNECT AND REMOVE ROOF DRAIN AND ALL ASSOCIATED ACCESSORIES IN ITS ENTIRETY. PREPARE FOR RECONNECTION IN NEW WORK. **CONSTRUCTION NOTES - PLUMBING**
- 1 NEW GAS BOOSTER HEATER SIMILAR TO VANGUARD MODEL PM200. PROVIDE VENT KIT.
- CONNECT TO EXISTING 3/4" GAS AND 1" HOT WATER. EXISTING VENT THROUGH ROOF. EXTEND TO 18 INCHES ABOVE FINISHED ROOF. NEW RETROFIT ROOF DRAIN SIMILAR TO ZURN MODEL RD2150.

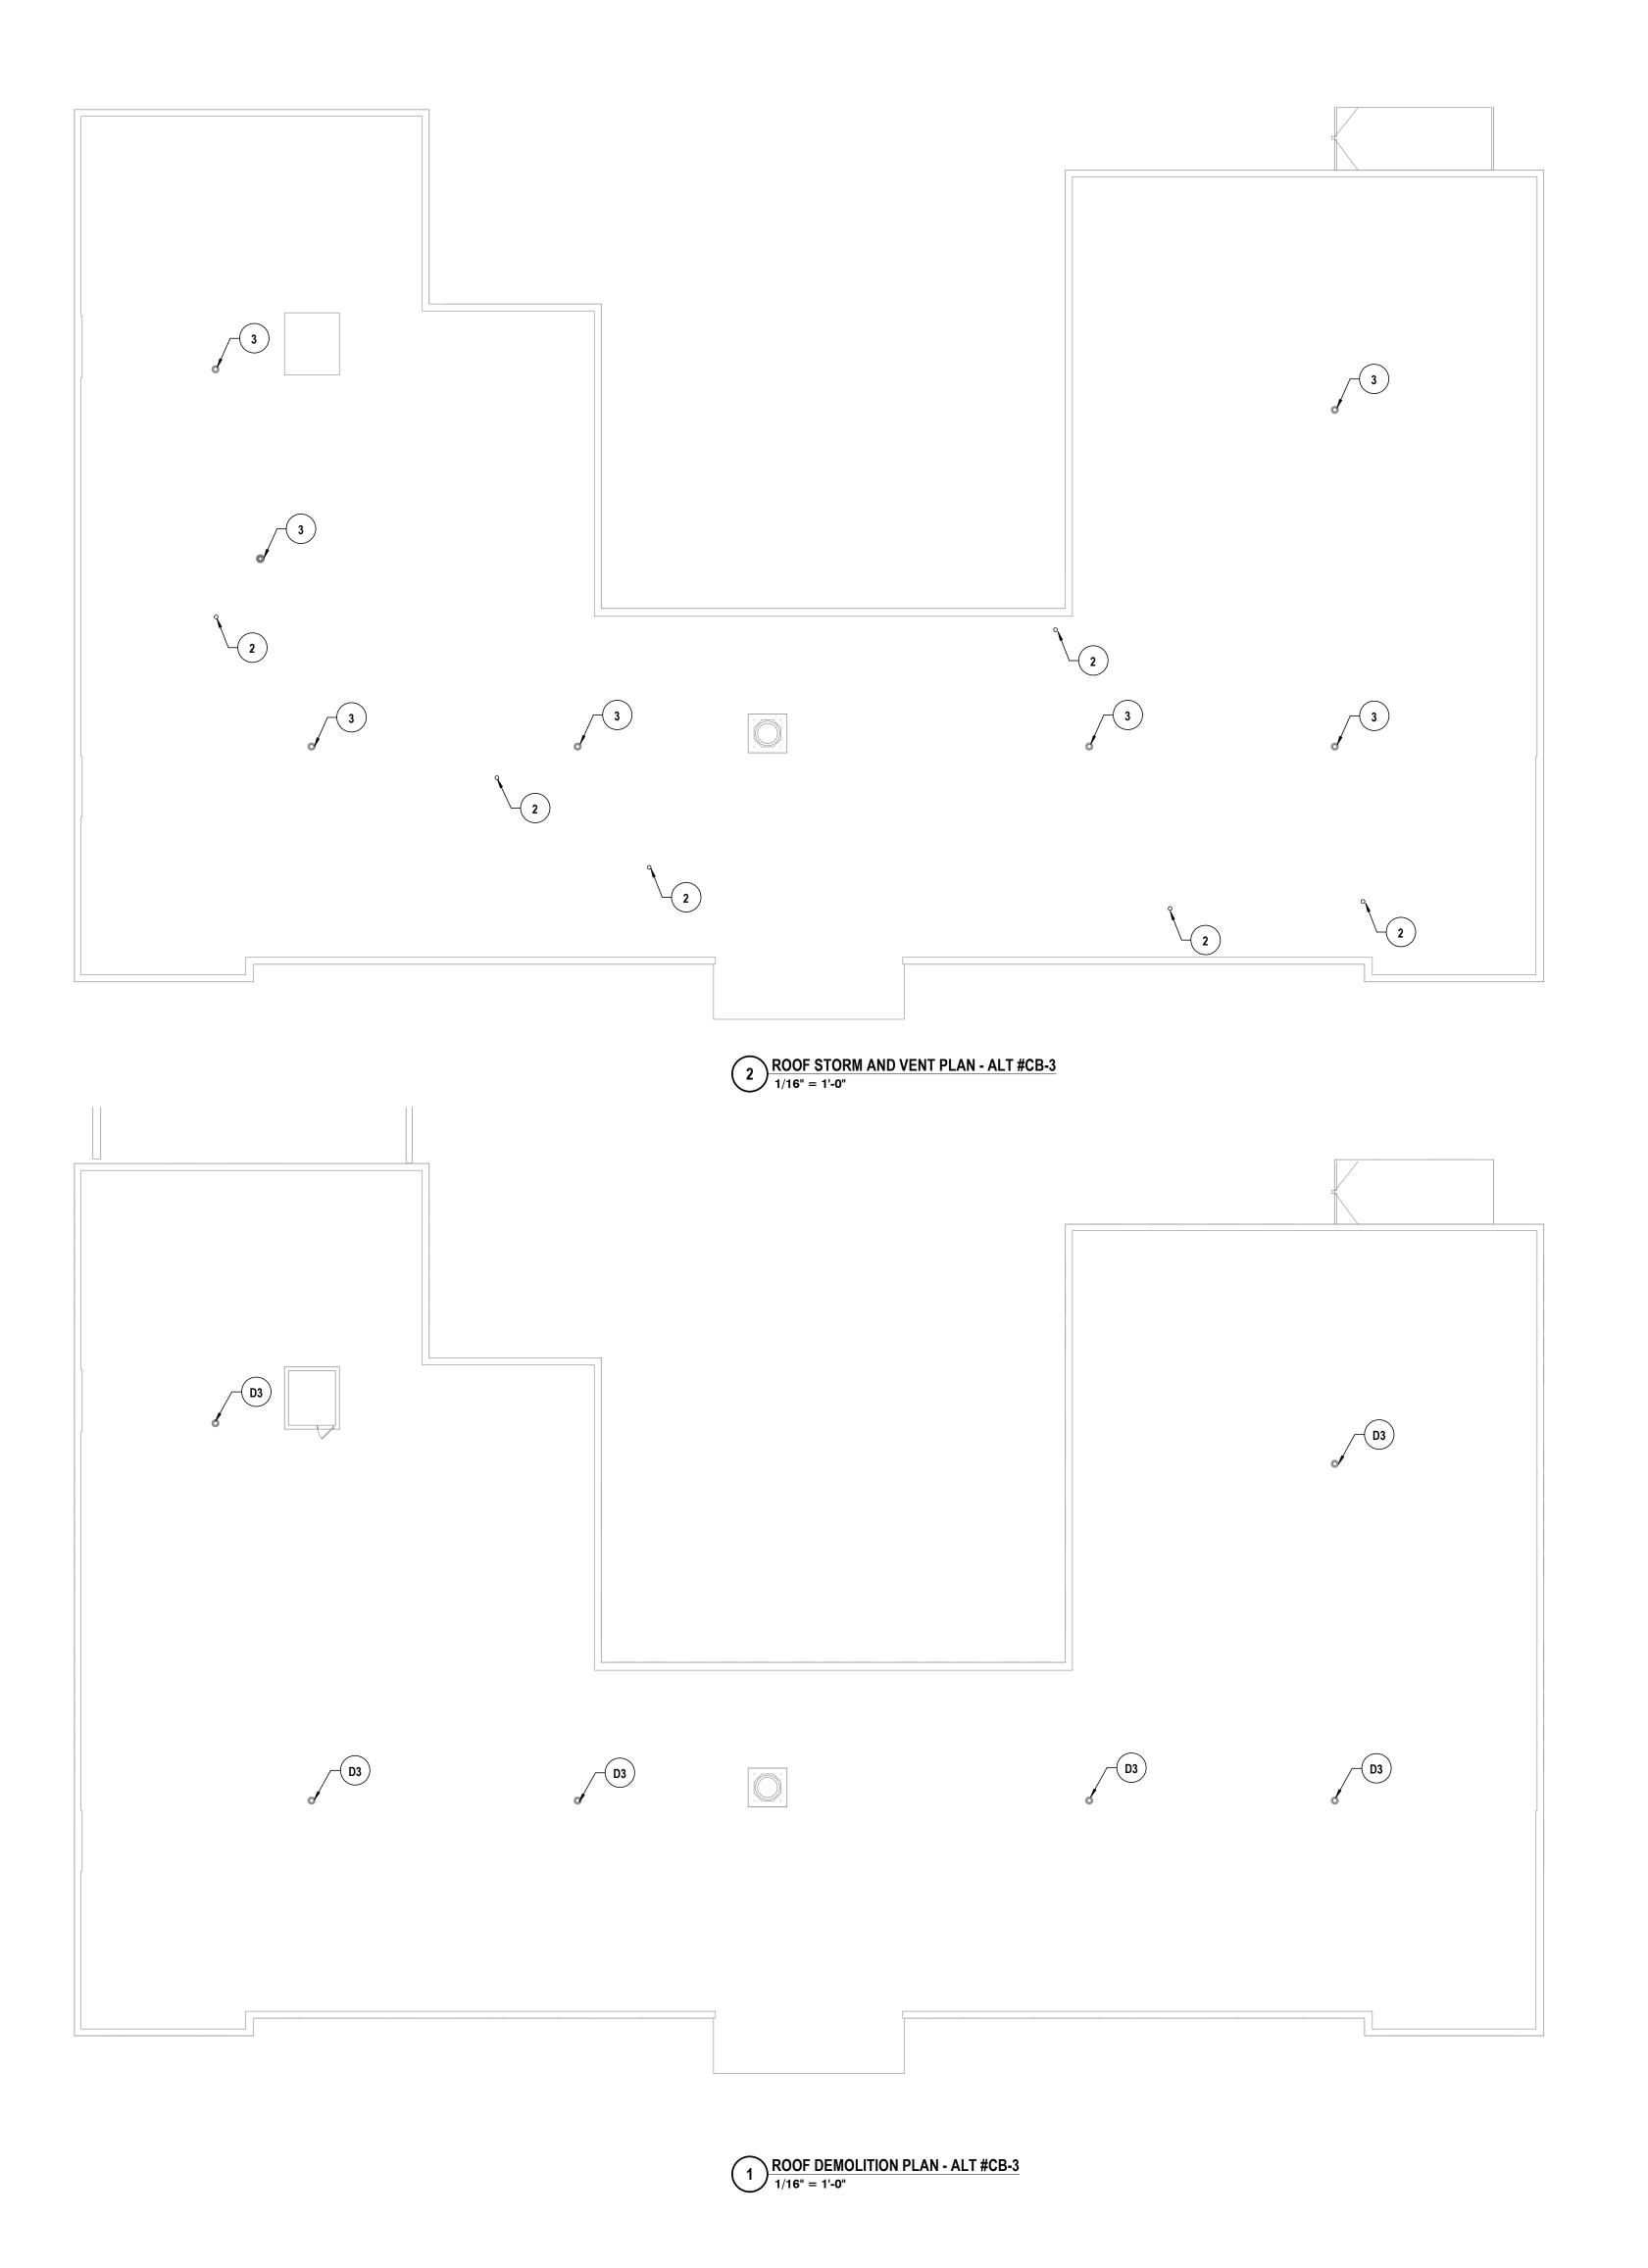

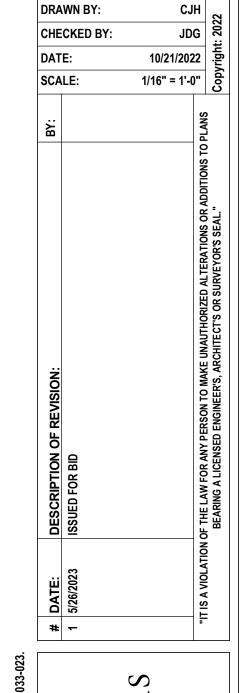

S 65 ENGINEERS | ARCHITEC

S 2023 RENOVATIONS (PHASE DISTRICT


STORM AND VENT PLANS

C2


C1

CB-P1.2 PROJECT NO: 2012-233

		MECHANICAL EQUIPMENT CONNECTION AND CONTROL SCHEDULE																								
	EQUIPMENT									PPLY		CONTROL DEVICES / COMPONENTS / ACCESSORIES MOUNTED IN ROOMS AS SCHEDULED														
UNIT #	DESCRIPTION	HORSEPOWER	WATTS	FULL LOAD AMPS Q	MINIMUM CURCUIT AMPACITY	NOMINAL VOLTAGE	PHASE Φ	PANEL / CONTROL CENTER	CIRCUIT BREAKER	WIRE SIZE	REFERENCE NOTES	DISCONNECT SWITCH (PROVIDED BY EC)	DISCONNECT SWITCH (FURNISHED BY HC & INSTALLED BY EC)	PRE-WIRED/FACTORY MOUNTED DISCONNECT SWITCH (BY MFR)	MANUAL MOTOR STARTER (PROVIDED BY EC)	MAGNETIC STARTER (PROVIDED BY EC)	VARIABLE SPEED DRIVE (PROVIDED BY EC)	VFD PACKAGE (PROVIDED BY HC, CONNECTED BY EC)	VFD WITH CHOKE (FURNISHED BY H.C.& INSTALLED BY EC)	PACKAGED CONTROL UNIT	SINGLE PUINT CONNECTION FAN SHUTDOWN UPON FACP ACTIVATION	DUCT SMOKE DETECTOR IN RETURN DUCT	BOILER SHUTDOWN SAFETY SWITCH	LINE VOLTAGE THERMOSTAT (FURNISHED BY HC & INSTALLED BY EC)	FACTORY MOUNTED STARTER & DISCONNECT (BY MFR)	CONNECT AQUASTAT PROVIDE 20A, 120V GFCI RECEPT. IN WEATHERPROOF ENCLOSURE AT UNIT
B-1-CB	BOILER			16 A		120 V	1	B1	20A 1P EXG	2#12, 1#12G, 3/4"C		X														
B-2-CB	BOILER			16 A		120 V	1	B1	20A 1P EXG	2#12, 1#12G, 3/4"C		Х														
B-3-CB	BOILER			16 A		120 V	1	B1	20A 1P EXG	2#12, 1#12G, 3/4"C		Х														
B-4-CB	BOILER			16 A		120 V	1	B1	20A 1P EXG	2#12, 1#12G, 3/4"C		Х														
DW-HTX-1-CB	HOT WATER PLATE			2 A		120 V	1	B1	20A 1P	2#12, 1#12G, 3/4"C																
P-1-CB	PUMP	1				480 V	3	HV1	20A 3P	3#12, 1#12G, 3/4"C		Х				X										

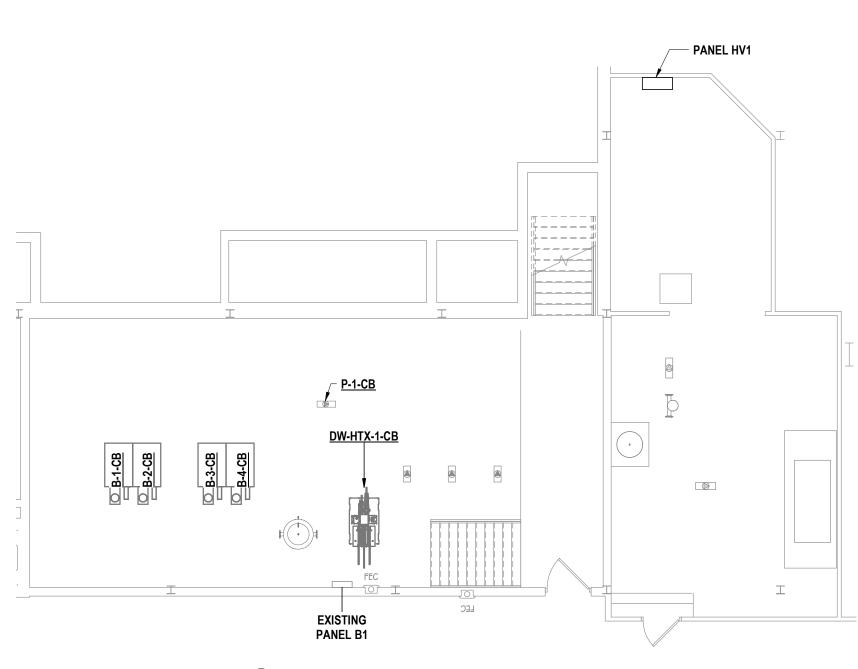

2 BASEMENT POWER PLAN - BOILER RM PLAN 1/8" = 1'-0"

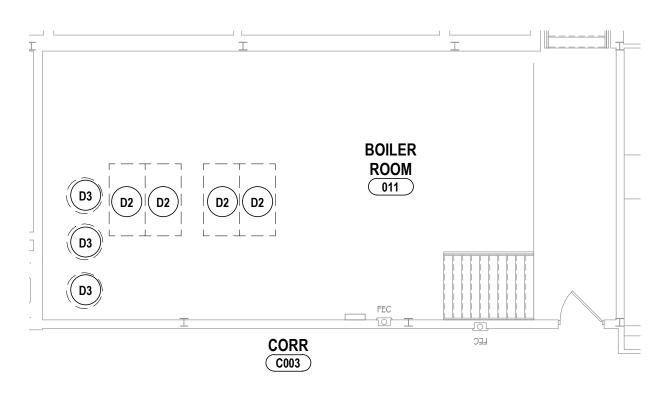

1 BASEMENT ELECTRICAL DEMOLITION PLAN - BOILER RM PLAN 1/8" = 1'-0"

GENERAL NOTES - ELECTRICAL

- A CONTRACTOR IS RESPONSIBLE FOR ALL WORK ON THIS DRAWING UNLESS CLEARLY INDICATED TO BE PART OF ANOTHER PRIME CONTRACT.

 B CONTRACTOR SHALL VERIFY EXISTING CONDITIONS PRIOR TO CONSTRUCTION AND INSTALLATION AND NOTIFY ENGINEER/ARCHITECT OF CONFLICTS
- AND CONDITIONS WHICH INTERFERE WITH INSTALLATION AS SET FORTH IN CONTRACT DOCUMENTS.

 C CONTRACTOR IS RESPONSIBLE FOR ALL NEW WALL OPENINGS, EXCAVATIONS, AND PENETRATIONS, UNLESS SPECIFICALLY NOTED. UPON
- CONTRACTOR IS RESPONSIBLE FOR ALL NEW WALL OPENINGS, EXCAVATIONS, AND PENETRATIONS, UNLESS SPECIFICALLY NOTED. UPON COMPLETION, ALL PENETRATIONS TO BE SEALED TO MAINTAIN FIRE RATING AS SPECIFIED ON ARCHITECTURAL DRAWINGS.

 D CONTRACTOR IS RESPONSIBLE FOR ALL CUTTING AND PATCHING UNLESS CLEARLY INDICATED AS PART OF ANOTHER PRIME CONTRACT.
- E MINIMUM CONDUIT SIZE USED ON THIS PROJECT SHALL BE 3/4" UNLESS OTHERWISE NOTED.
- MINIMUM WIRE SIZE USED ON THIS PROJECT SHALL BE #12 THHN/THWN UNLESS OTHERWISE NOTED.
 ALL CABLING INSTALLATIONS AND TERMINATIONS TO ADHERE TO CURRENT NEC CODES AND RELATED ANSI/TIA/EIA STANDARDS.
- H DURING DEMOLITION OF EXISTING CABLING, ANY DAMAGE TO FUNCTIONING CABLING SYSTEM IS THE RESPONSIBILITY OF AND WILL BE REPAIRED BY THE CONTRACTOR.

 I CONTRACTOR SHALL BE AWARE OF THE PRESENCE OF EXISTING ASBESTOS CONTAINING MATERIAL SCHEDULED TO REMAIN IN PLACE WITHIN THE PROJECT SCOPE. ANY WORK REQUIRED THAT HAS THE POTENTIAL TO DISTURB HAZARDOUS MATERIALS SHALL BE COORDINATED DIRECTLY WITH
- THE OWNER.

 J ALL ELECTRICAL DEVICES, MATERIALS, AND PACKAGED EQUIPMENT SHALL BE LISTED AND LABELED BY UNDERWRITERS LABORATORIES INC. (UL).

 K NEW CIRCUIT BREAKER(S) THAT ARE TO BE ADDED TO EXISTING PANELBOARD(S) SHALL BE LISTED/LABELED FOR USE WITH THE EXISTING PANELBOARD(S).
- L THE SHORT-CIRCUIT RATINGS OF ALL PROTECTIVE DEVICES SHALL BE EQUAL TO OR EXCEED THE AVAILABLE SHORT-CIRCUIT CURRENT.

 M ALL WORK TO CONFORM TO CURRENT NEC AND ALL APPLICABLE CODES.
- CONTRACTOR TO NOTIFY ELECTRICAL ENGINEER FOR INSPECTION OF ALL INSTALLATIONS BEFORE BEING BURIED OR COVERED.

 ALL ELECTRICAL DEVICES AND EQUIPMENT SCHEDULED FOR REMOVAL ARE CONSIDERED PROPERTY OF THE OWNER. ELECTRICAL DEVICES AND
- EQUIPMENT SHALL BE PLACED IN AN AREA DESIGNATED BY THE OWNER. ANY DEVICE OR EQUIPMENT THE OWNER WISHES NOT TO KEEP SHALL BE DISPOSED OF BY THE CONTRACTOR.

 CONTRACTOR IS RESPONSIBLE FOR DISCONNECTING POWER TO ANY EQUIPMENT SCHEDULED TO BE REMOVED OR REPLACED. COORDINATE WORK
- WITH OTHER PRIME CONTRACTORS AND DRAWINGS.

 CONTRACTOR IS RESPONSIBLE FOR PROVIDING POWER TO ANY EQUIPMENT SCHEDULED TO BE NEWLY INSTALLED. COORDINATE WORK WITH OTHER PRIME CONTRACTORS AND DRAWINGS.
- R CONTRACTOR IS RESPONSIBLE FOR COORDINATING ALL CONDUIT LOCATIONS IN FIREWALLS. A MAXIMUM OF ONE PIECE OF CONDUIT IS ALLOWED IN A NON-REINFORCED CORE. NO CONDUIT SHALL BE PLACED IN A VERTICALLY REINFORCED CORE IN A FIREWALL.

 S ALL NEW ELECTRICAL DEVICES SUCH AS, BUT NOT LIMITED TO, FIRE ALARM DEVICES, SMOKE DETECTORS, LIGHT FIXTURES, EXIT SIGNS, OCCUPANCY/VACANCY SENSORS, AND NON-KEYED SWITCHES ARE REQUIRED TO HAVE IMPACT PROTECTION THROUGH MEANS OF IMPACT RESISTANT COVERS, OR WIRE GUARDS IN LOCKER ROOMS, GYMNASIUMS, WEIGHT ROOMS, FITNESS CENTERS, WRESTLING ROOMS, AND


DEMOLITION NOTES - ELECTRICAL


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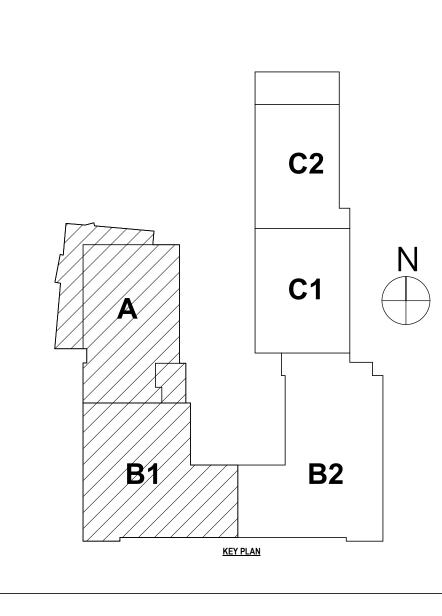
- DISCONNECT POWER SERVING EXISTING KITCHEN EQUIPMENT. SECURE CIRCUITRY FOR REUSE.
- D2 BY ALTERNATE #CB-2 DISCONNECT POWER SERVING EXISTING BOILERS. SECURE CIRCUITRY FOR REUSE.
 DISCONNECT AND REMOVE EXISTING POWER SERVING WATER HEATERS. REMOVE ALL ASSOCIATED DEVICES, WIRE AND CONDUIT BACK TO SOURCE.

CONSTRUCTION NOTES - POWER

P1 RECONNECT EXISTING CIRCUITRY TO NEW KITCHEN EQUIPMENT. EXTEND CIRCUITRY AS NEEDED.
P2 AS PART OF ALTERNATE #CB-3 DISCONNECT POWER SERVING EXISTING MECHANICAL UNIT AND SECURE EXISTING CIRCUITRY WHILE ROOF WORK IS BEING COMPLETE. AFTER ROOFING IS COMPLETE RECONNECT EXISTING CIRCUITRY BACK TO EXISTING MECHANICAL UNIT AND EXTEND WIRE AS NEEDED.



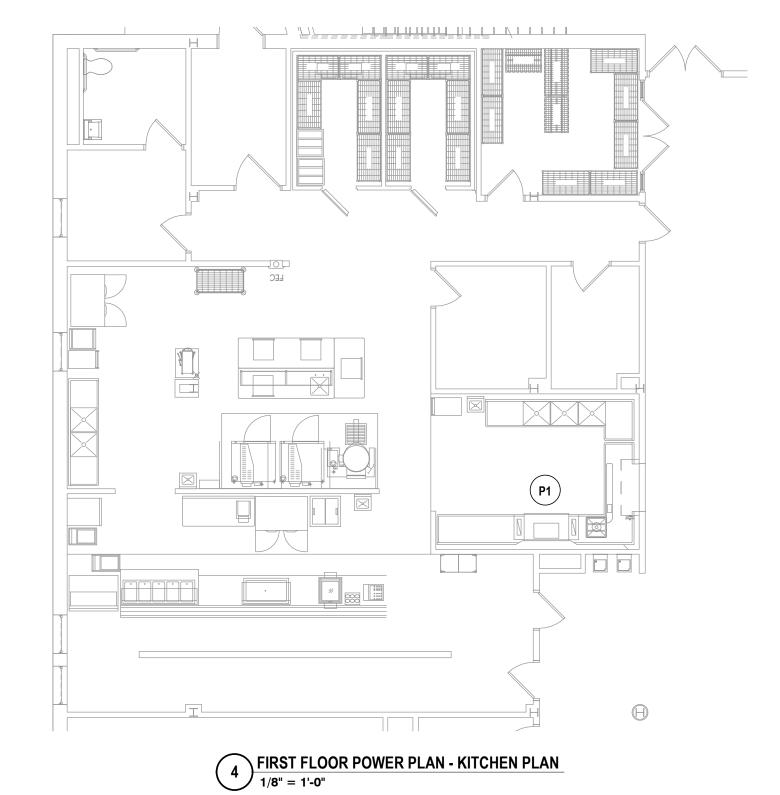

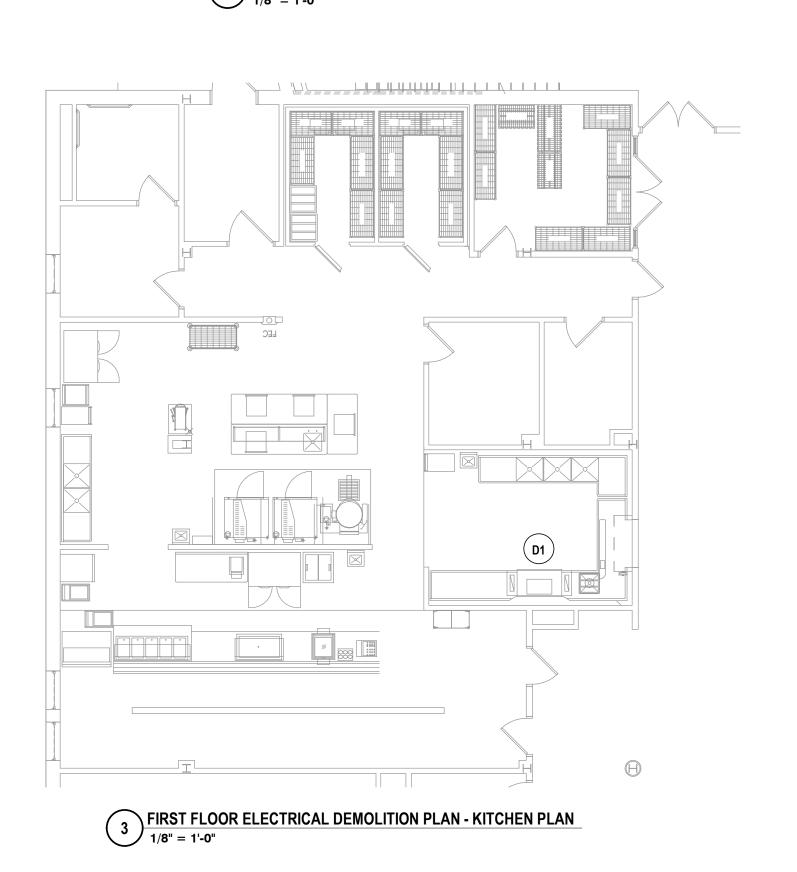

DATE: DESCRIPTION OF REVISION:

3 5/26/2023 ISSUED FOR BID

4 CAPACITIES A VIOLATION OF THE LAW FOR ANY PERSON TO MAKE UNAUTHORIZED ALTERATIONS OR ADDITIONS TO PLANS

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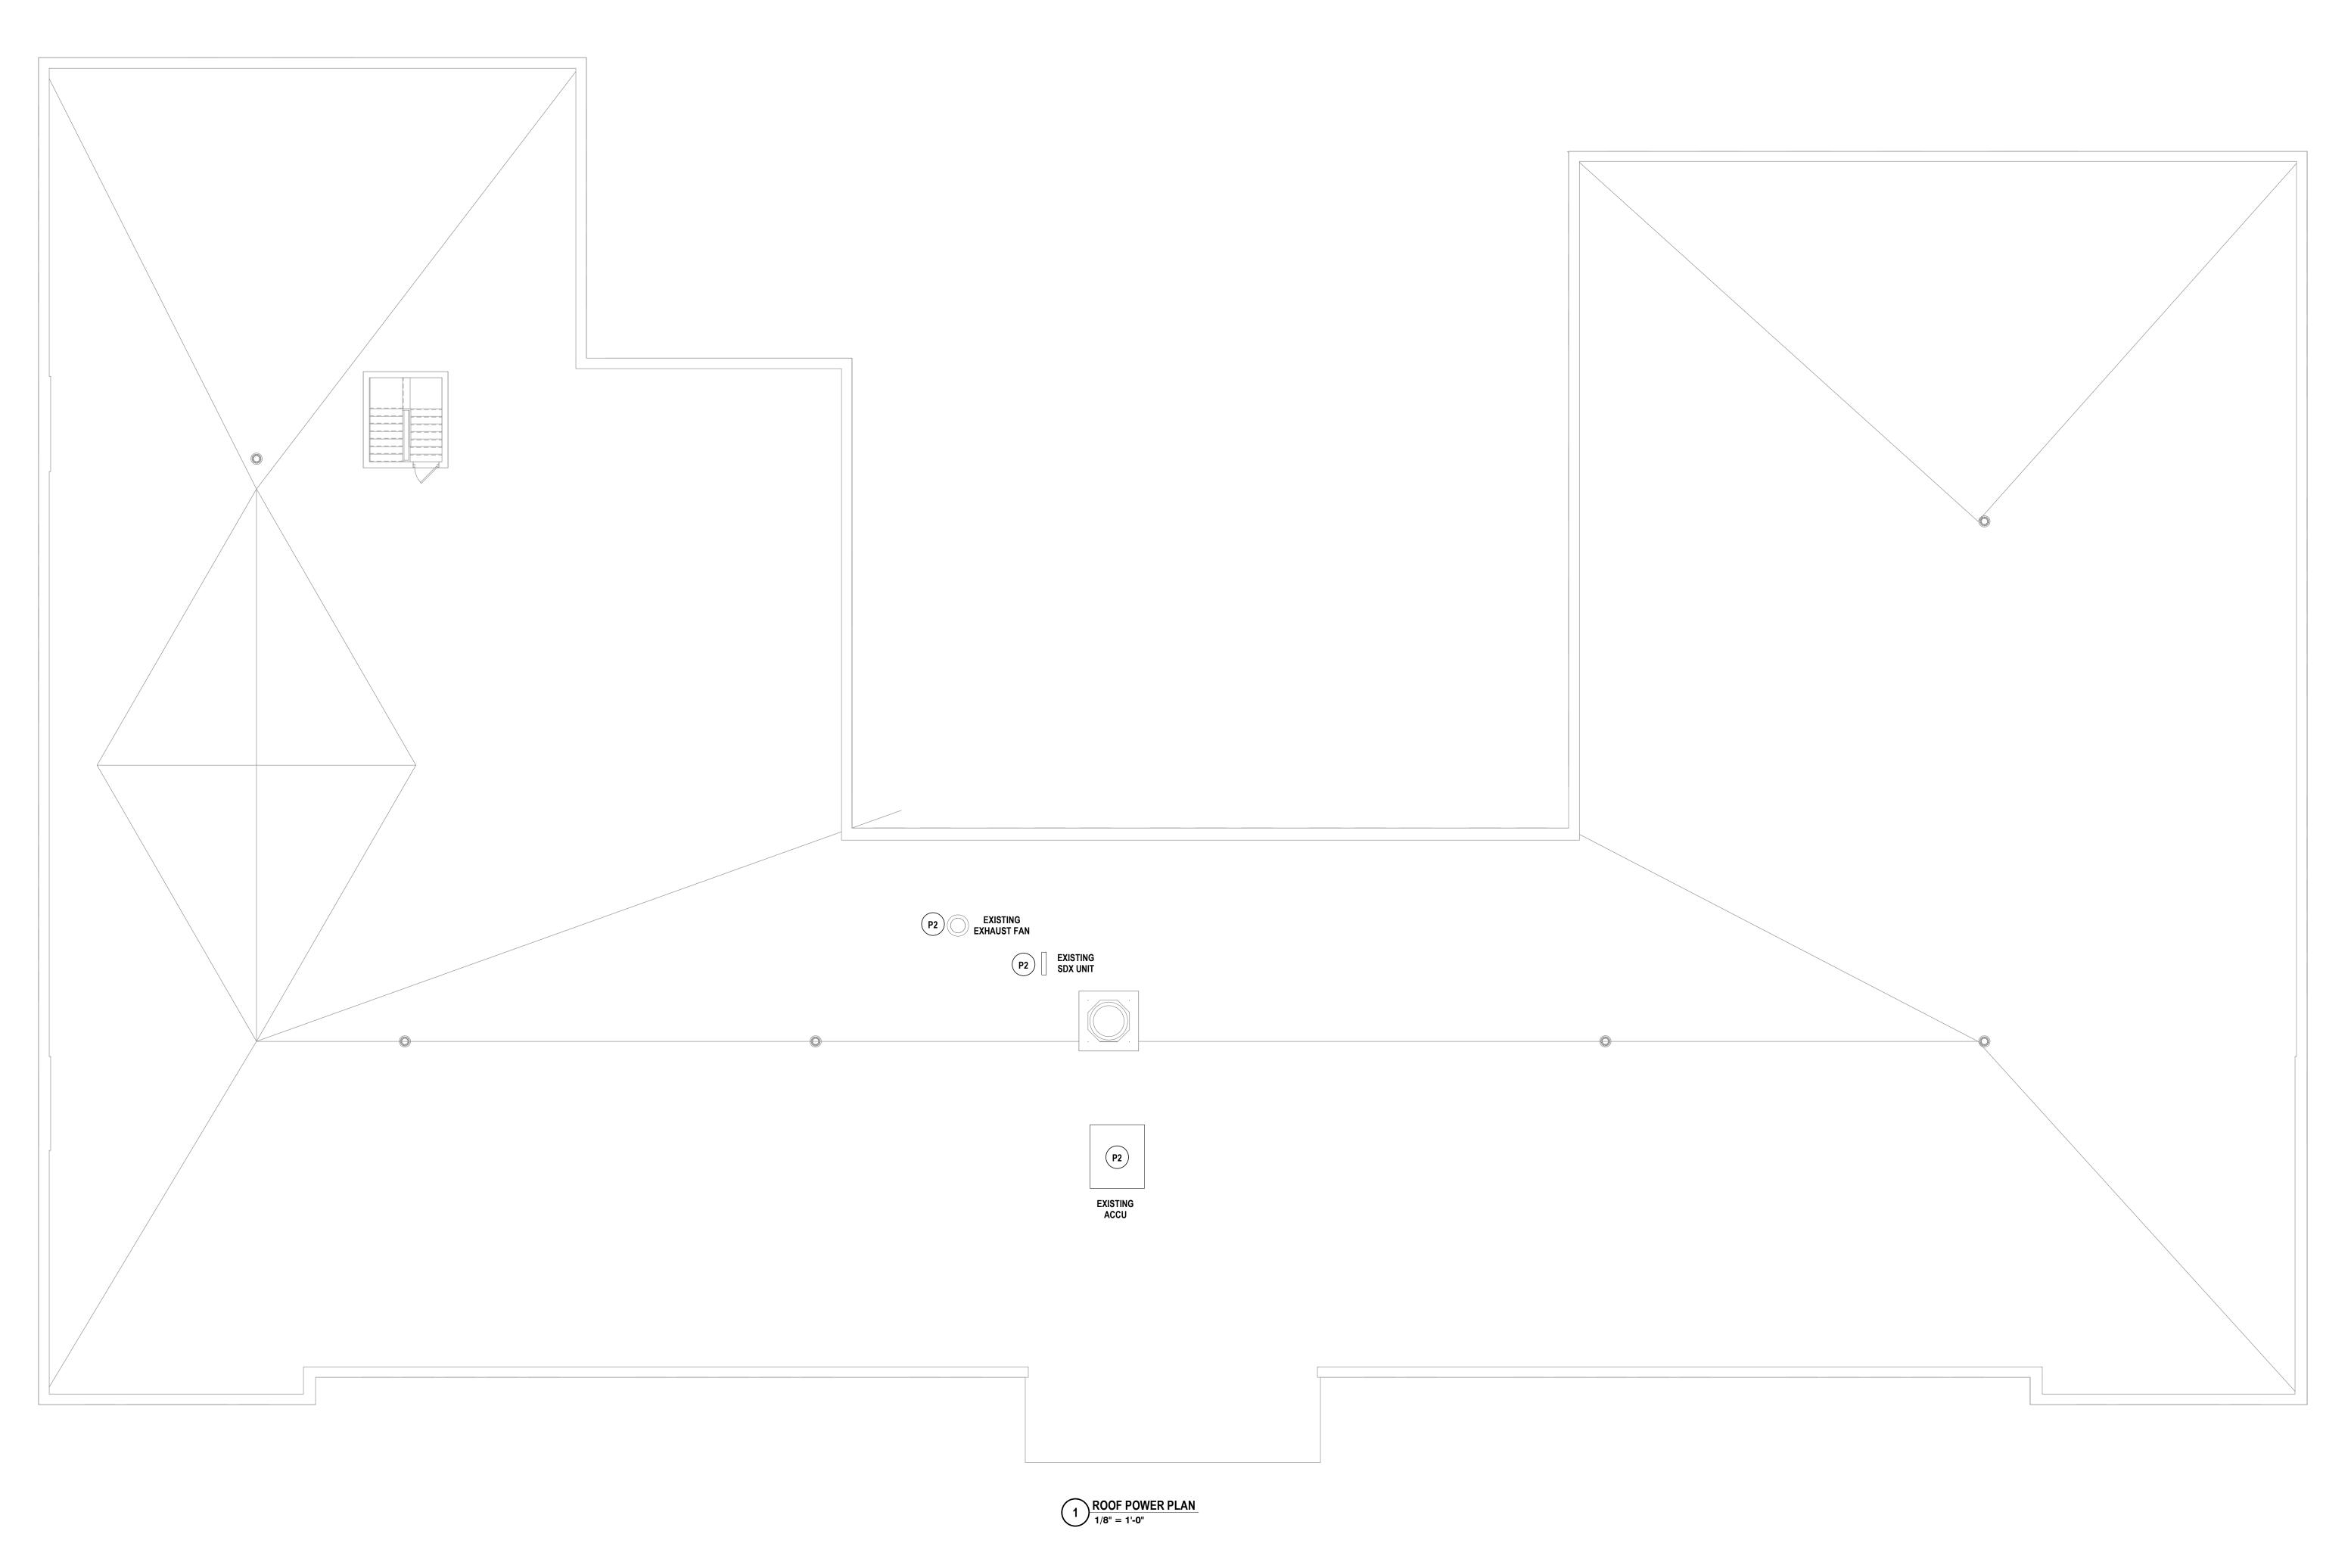
LANS LS 2023 RENOVATIONS (PHASE II)


LER & KITCHEN PLANS
MENTARY SCHOOLS 2023 RENOV,
IRA CITY SCHOOL DISTRICT

BOILEI BMBJ ELTIT

CONSTRUCTION NOTES - POWER

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HORSEHEADS, NY 607 - 358 - 1000 ROCHESTER, NY 585 - 327 - 7949 TOWANDA, PA 570 - 265 - 486

STECT RICAL PLAN

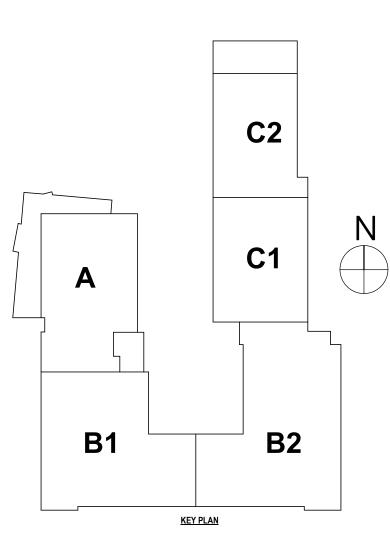NTARY SCHOOLS 2023 RENOVATIONS (PHASE I

CITY SCHOOL DISTRICT

CB-E1.2

PROJECT NO: 2012-233

GENERAL NOTES - ELECTRICAL REFER TO SHEET CB-E0.1.

CONSTRUCTION NOTES - LIGHTING & FA

L1 DOOR OPENS IN BOLD ON DOORS SHOWN FOR INTEGRATION WITH LOCKDOWN/SECURITY REQUIRE FIRE ALARM CONNECTION BUT ARE INSTALLED AND FURNISHED BY OTHERS WITH M BEING STANDARD MAG AND C BEING DOOR CLOSER.

10/21/2022 SCALE: 1/16" = 1'-0"

> S ENGINEERS | ARCHITEC

S 2023 RENOVATIONS (PHASE DISTRICT

C2/

CB-E2.1



GENERAL NOTES - ELECTRICAL

REFER TO SHEET CB-E0.1.

CONSTRUCTION NOTES - LIGHTING & FA

L1 DOOR OPENS IN BOLD ON DOORS SHOWN FOR INTEGRATION WITH LOCKDOWN/SECURITY REQUIRE FIRE ALARM CONNECTION BUT ARE INSTALLED AND FURNISHED BY OTHERS WITH M BEING STANDARD MAG AND C BEING DOOR CLOSER.


10/21/2022 1/16" = 1'-0"


ENGINEERS | ARCHITEC


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PROJECT NO: 2012-233

C2



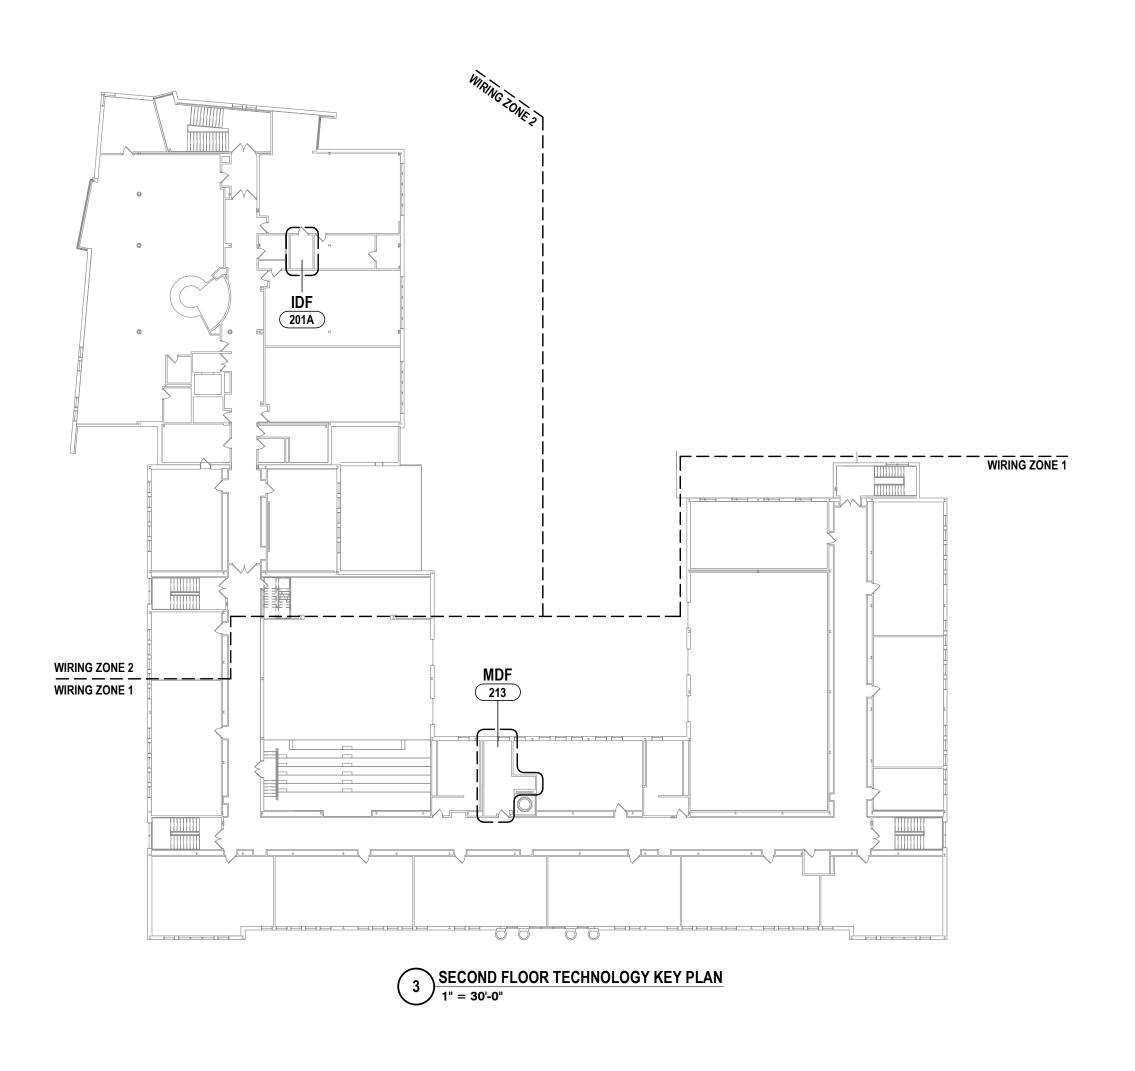

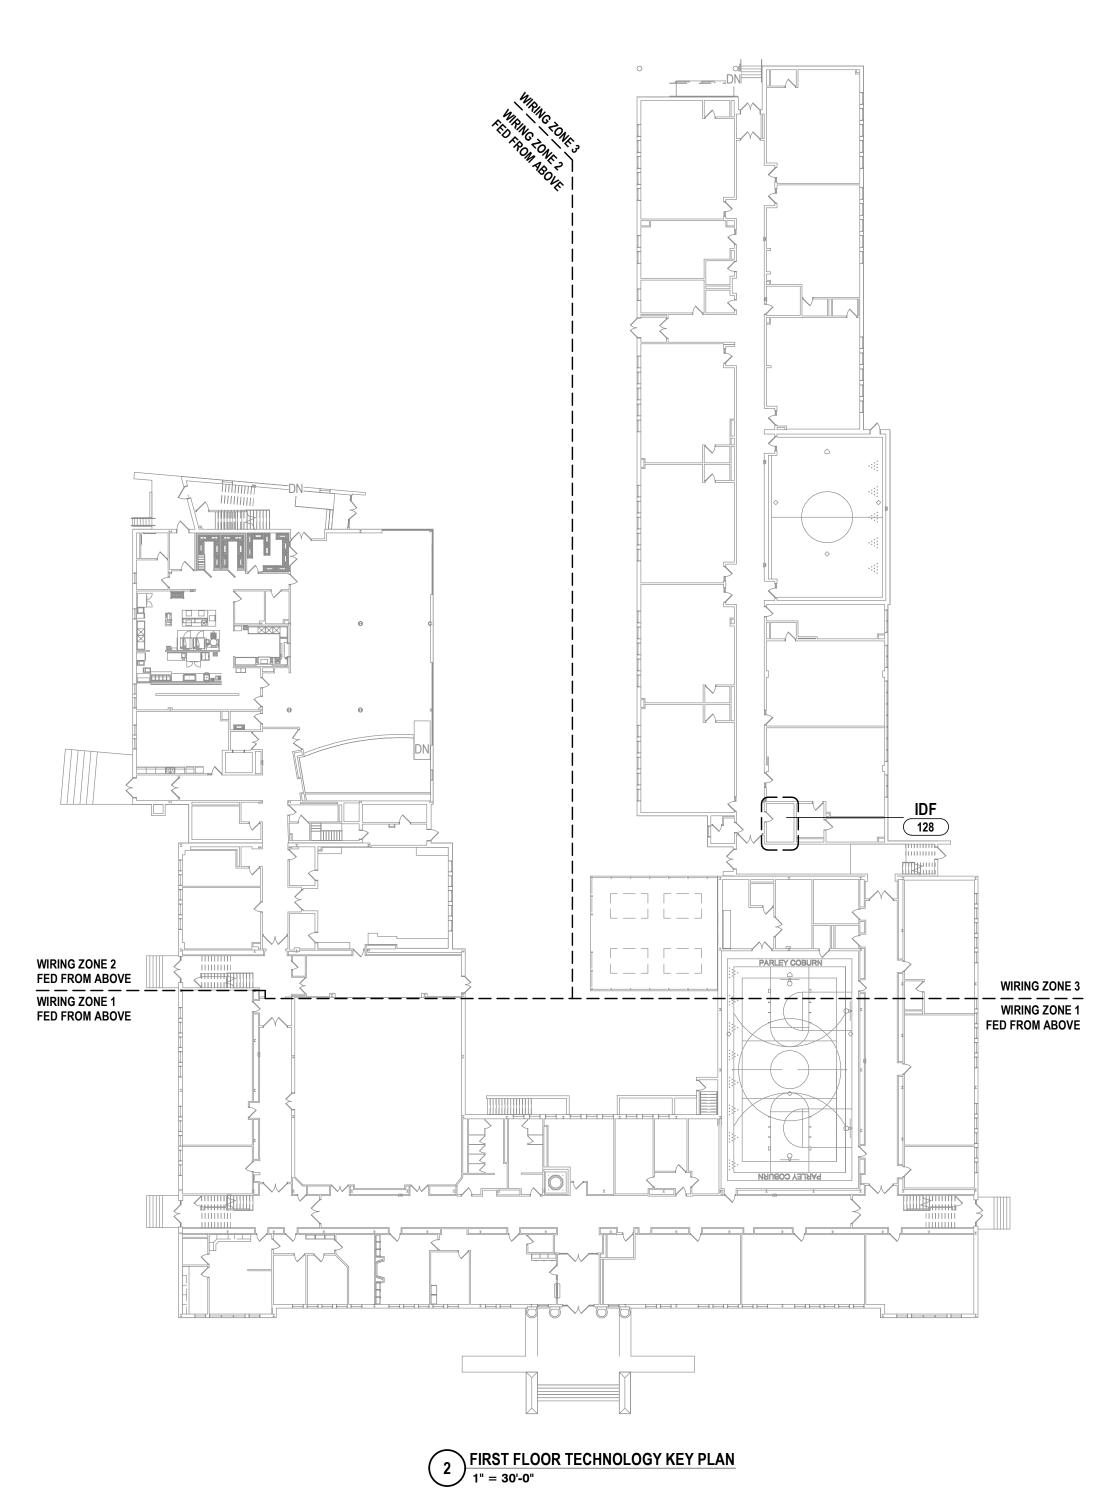


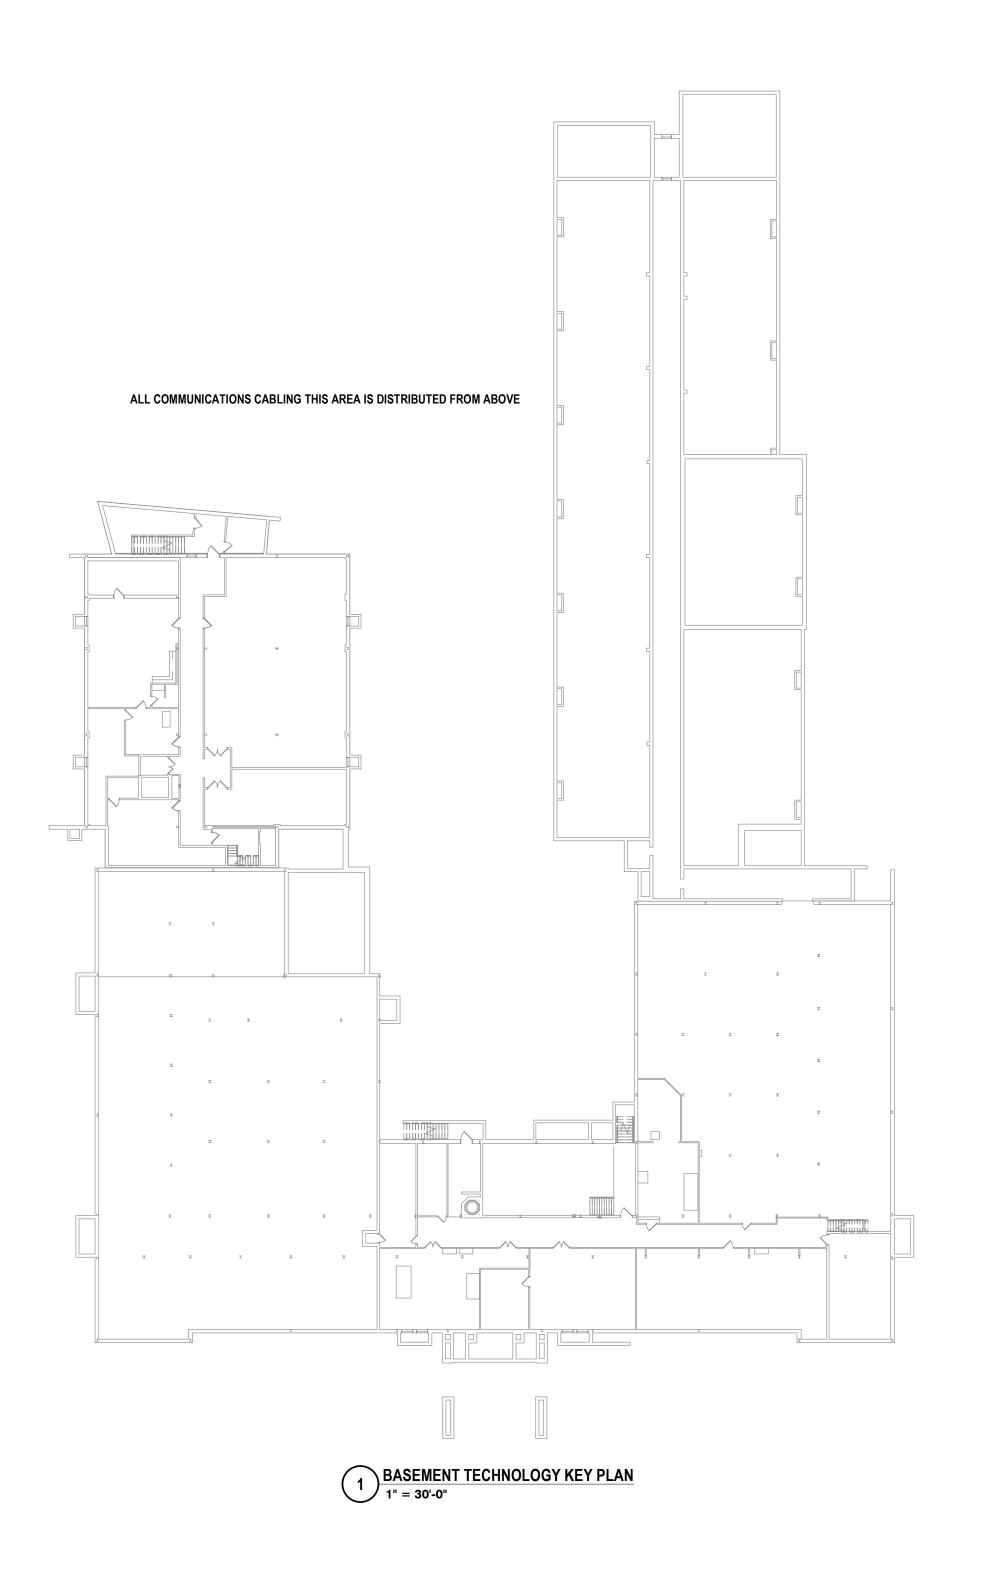- A ALL CABLING INSTALLATION AND TERMINATION TO ADHERE TO CURRENT NEC CODES AND RELATED ANSI/TIA/EIA STANDARDS.
- B WHEN INSTALLING CEILING MOUNTED DEVICES, ADJUST LOCATION TO AVOID OTHER CEILING MOUNTED DEVICES SUCH AS EXIT SIGNS, ETC.
- ALL DATA CABLING SHALL BE PLENUM RATED. OWNER TO APPROVE FINAL LOCATION AND VIEW OF ALL CAMERAS.
- E ALL ELECTRONIC SERVICES NEED TO BE COORDINATED WITH OWNER PRIOR TO REMOVAL AND DISCONNECTION. F ALL CEILING MOUNTED DEVICES TO BE SUPPORTED BY STRUCTURE ABOVE. DO NOT
- USE CEILING GRID AS SOLE SUPPORT MECHANISM G ALL WALL OUTLETS SHALL BE LOCATED WITHIN 36" OF THE NEAREST POWER OUTLET AND AT THE SAME ELEVATION.
- H ANY DAMAGE DONE TO A FUNCTIONING CABLING SYSTEM IS THE RESPONSIBILITY OF; AND WILL BE REPAIRED BY THE CONTRACTOR, AT NO ADDITIONAL COST TO THE I CONTRACTOR TO PROVIDE ADDITIONAL CONDUIT PATHWAYS AS REQUIRED FOR ALL NEW CABLING, PER SPECIFICATIONS.
- J THE CONTRACTOR SHALL PROVIDE TEMPORARY PROTECTIVE COVERING ON EXISTING FLOOR AND WALL SURFACES SCHEDULED TO REMAIN IN ALL WORK AREAS. THE CONTRACTOR SHALL USE EXTREME CARE TO PREVENT DAMAGE TO EXISTING FINISHES AND SHALL BE RESPONSIBLE FOR REPAIRING ALL SURFACES AND FINISHES DAMAGED AS A RESULT OF THE WORK.
- K EXISTING CONDUITS THAT ARE RE-USED OR REQUIRED TO BE REMOVED/INFILLED, SHALL BE FIRESTOPPED ACCORDING TO SPECIFICATIONS AND ALL APPLICABLE
- L ELECTRONIC LOCKING HARDWARE PROVIDED AS PART OF DOOR HARDWARE SET UNLESS NOTED OTHERWISE SHALL HAVE POWER SUPPLIES TO BE COMPATIBLE WITH DOOR HARDWARE AS SPECIFIED IN SECTION 08 71 00; VOLTAGE TO BE V.I.F.

S ARCHI ENGINEERS |

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CB-T1.1

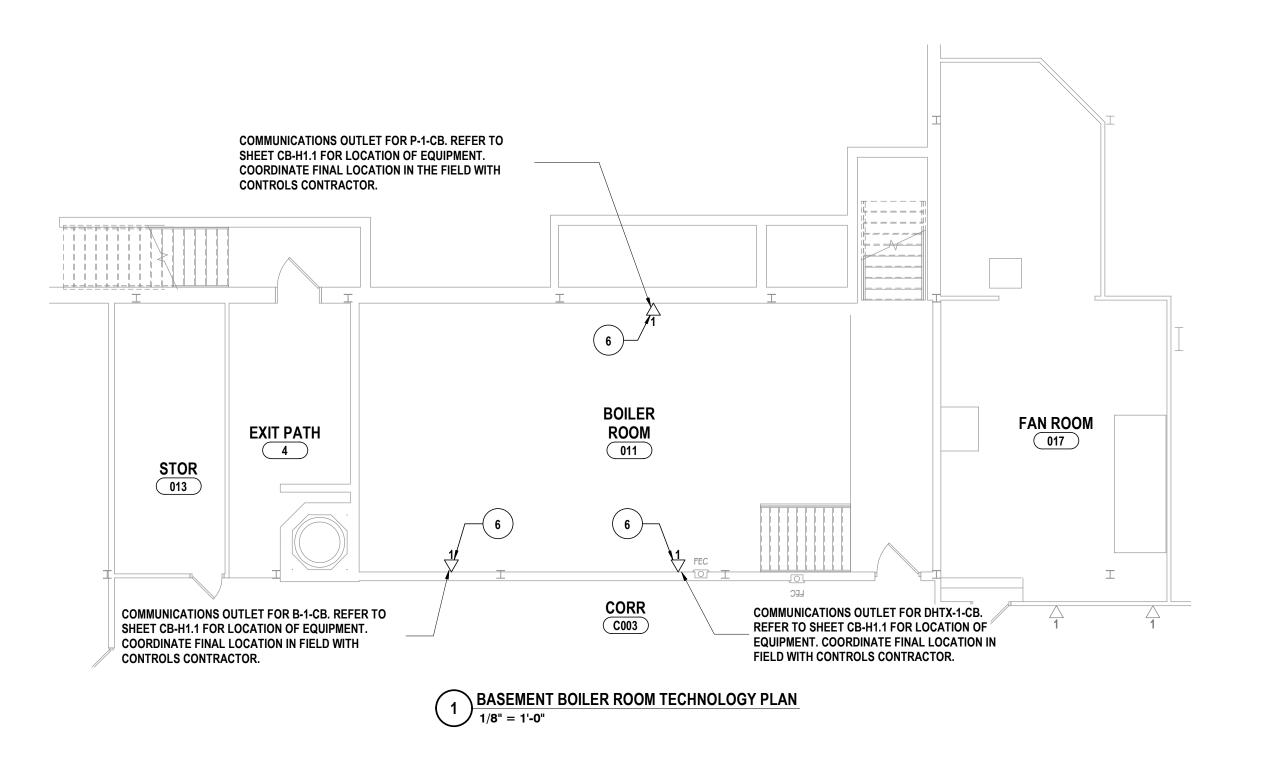

- A ALL CABLING INSTALLATION AND TERMINATION TO ADHERE TO CURRENT NEC CODES AND RELATED ANSI/TIA/EIA STANDARDS.
- B WHEN INSTALLING CEILING MOUNTED DEVICES, ADJUST LOCATION TO AVOID OTHER CEILING MOUNTED DEVICES SUCH AS EXIT SIGNS, ETC.
- C ALL DATA CABLING SHALL BE PLENUM RATED.

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- NEW CABLING, PER SPECIFICATIONS.

 J THE CONTRACTOR SHALL PROVIDE TEMPORARY PROTECTIVE COVERING ON

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WITH DOOR HARDWARE AS SPECIFIED IN SECTION 08 71 00; VOLTAGE TO BE V.I.F.

- EXISTING FLOOR AND WALL SURFACES SCHEDULED TO REMAIN IN ALL WORK
 AREAS. THE CONTRACTOR SHALL USE EXTREME CARE TO PREVENT DAMAGE TO
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 K EXISTING CONDUITS THAT ARE RE-USED OR REQUIRED TO BE REMOVED/INFILLED,
- L ELECTRONIC LOCKING HARDWARE PROVIDED AS PART OF DOOR HARDWARE SET UNLESS NOTED OTHERWISE SHALL HAVE POWER SUPPLIES TO BE COMPATIBLE

CONSTRUCTION NOTES - TECHNOLOGY

- 1 REMOVE EXISTING INTERACTIVE DISPLAY AND TURN OVER TO OWNER. INSTALL NEW OWNER FURNISHED INTERACTIVE DISPLAY USING OWNER FURNISHED STANDING MOUNT. PROVIDE (2) TESTED CATEGORY 6A CABLES TO EACH DISPLAY FROM THE NEAREST TELECOMMUNICATIONS ROOM.
- 2 NEW INTERACTIVE DISPLAY FURNISHED BY OWNER.

AND WIRING BY INTEGRATOR.

- INSTALL OWNER FURNISHED DIGITAL SIGN. MOUNT WITH ONWER FURNISHED HARDWARE AND PROVIDE (1) CATEGORY 6A DATA OUTLET AT DISPLAY LOCATION. DISTRIBUTE CABLING FROM NEAREST TELECOMMUNICATIONS ROOM.
- 4 NEW WIRED/WIRELESS ELECTRONIC DOOR TRIM PROVIDED AS PART OF DOOR HARDWARE SET. SYSTEM INTEGRATOR TO INSTALL, TEST AND PROGRAM.

 ADDITIONALLY, DOOR TO RECEIVE NEW ELECTRICALLY RELEASED DOOR CLOSER, REFER TO DOOR SCHEDULE AND DOOR CONFIGURATION VIEWS ON SHEET T2.1. PROVIDE ALL PROGRAMMING TO ACCESS CONTROL SYSTEM FOR RELEASE OF DOOR CLOSER DURING SUPERVISORY ALARM STATUS
- DURING SUPERVISORY ALARM STATUS.

 5 NEW WIRELESS HUB PROVIDED AS PART OF DOOR HARDWARE SET. HUB HAS WIRELESS TRANSMISSION TO WIRELESS LOCK UNITS PER HUB ZONE. HUB TO BE WIRED FOR INTEGRATION INTO ACCESS CONTROL SYSTEM SERVER \ SOFTWARE. HUB INSTALLATION
- 6 COMMUNICATIONS OUTLET TO BE INSTALLED. REQUIRES CABLING FROM NETWORK CLOSET PER WIRING ZONE PER DETAILS & SPECIFICATIONS.

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CHECKED BY:		JLS		t: 20%
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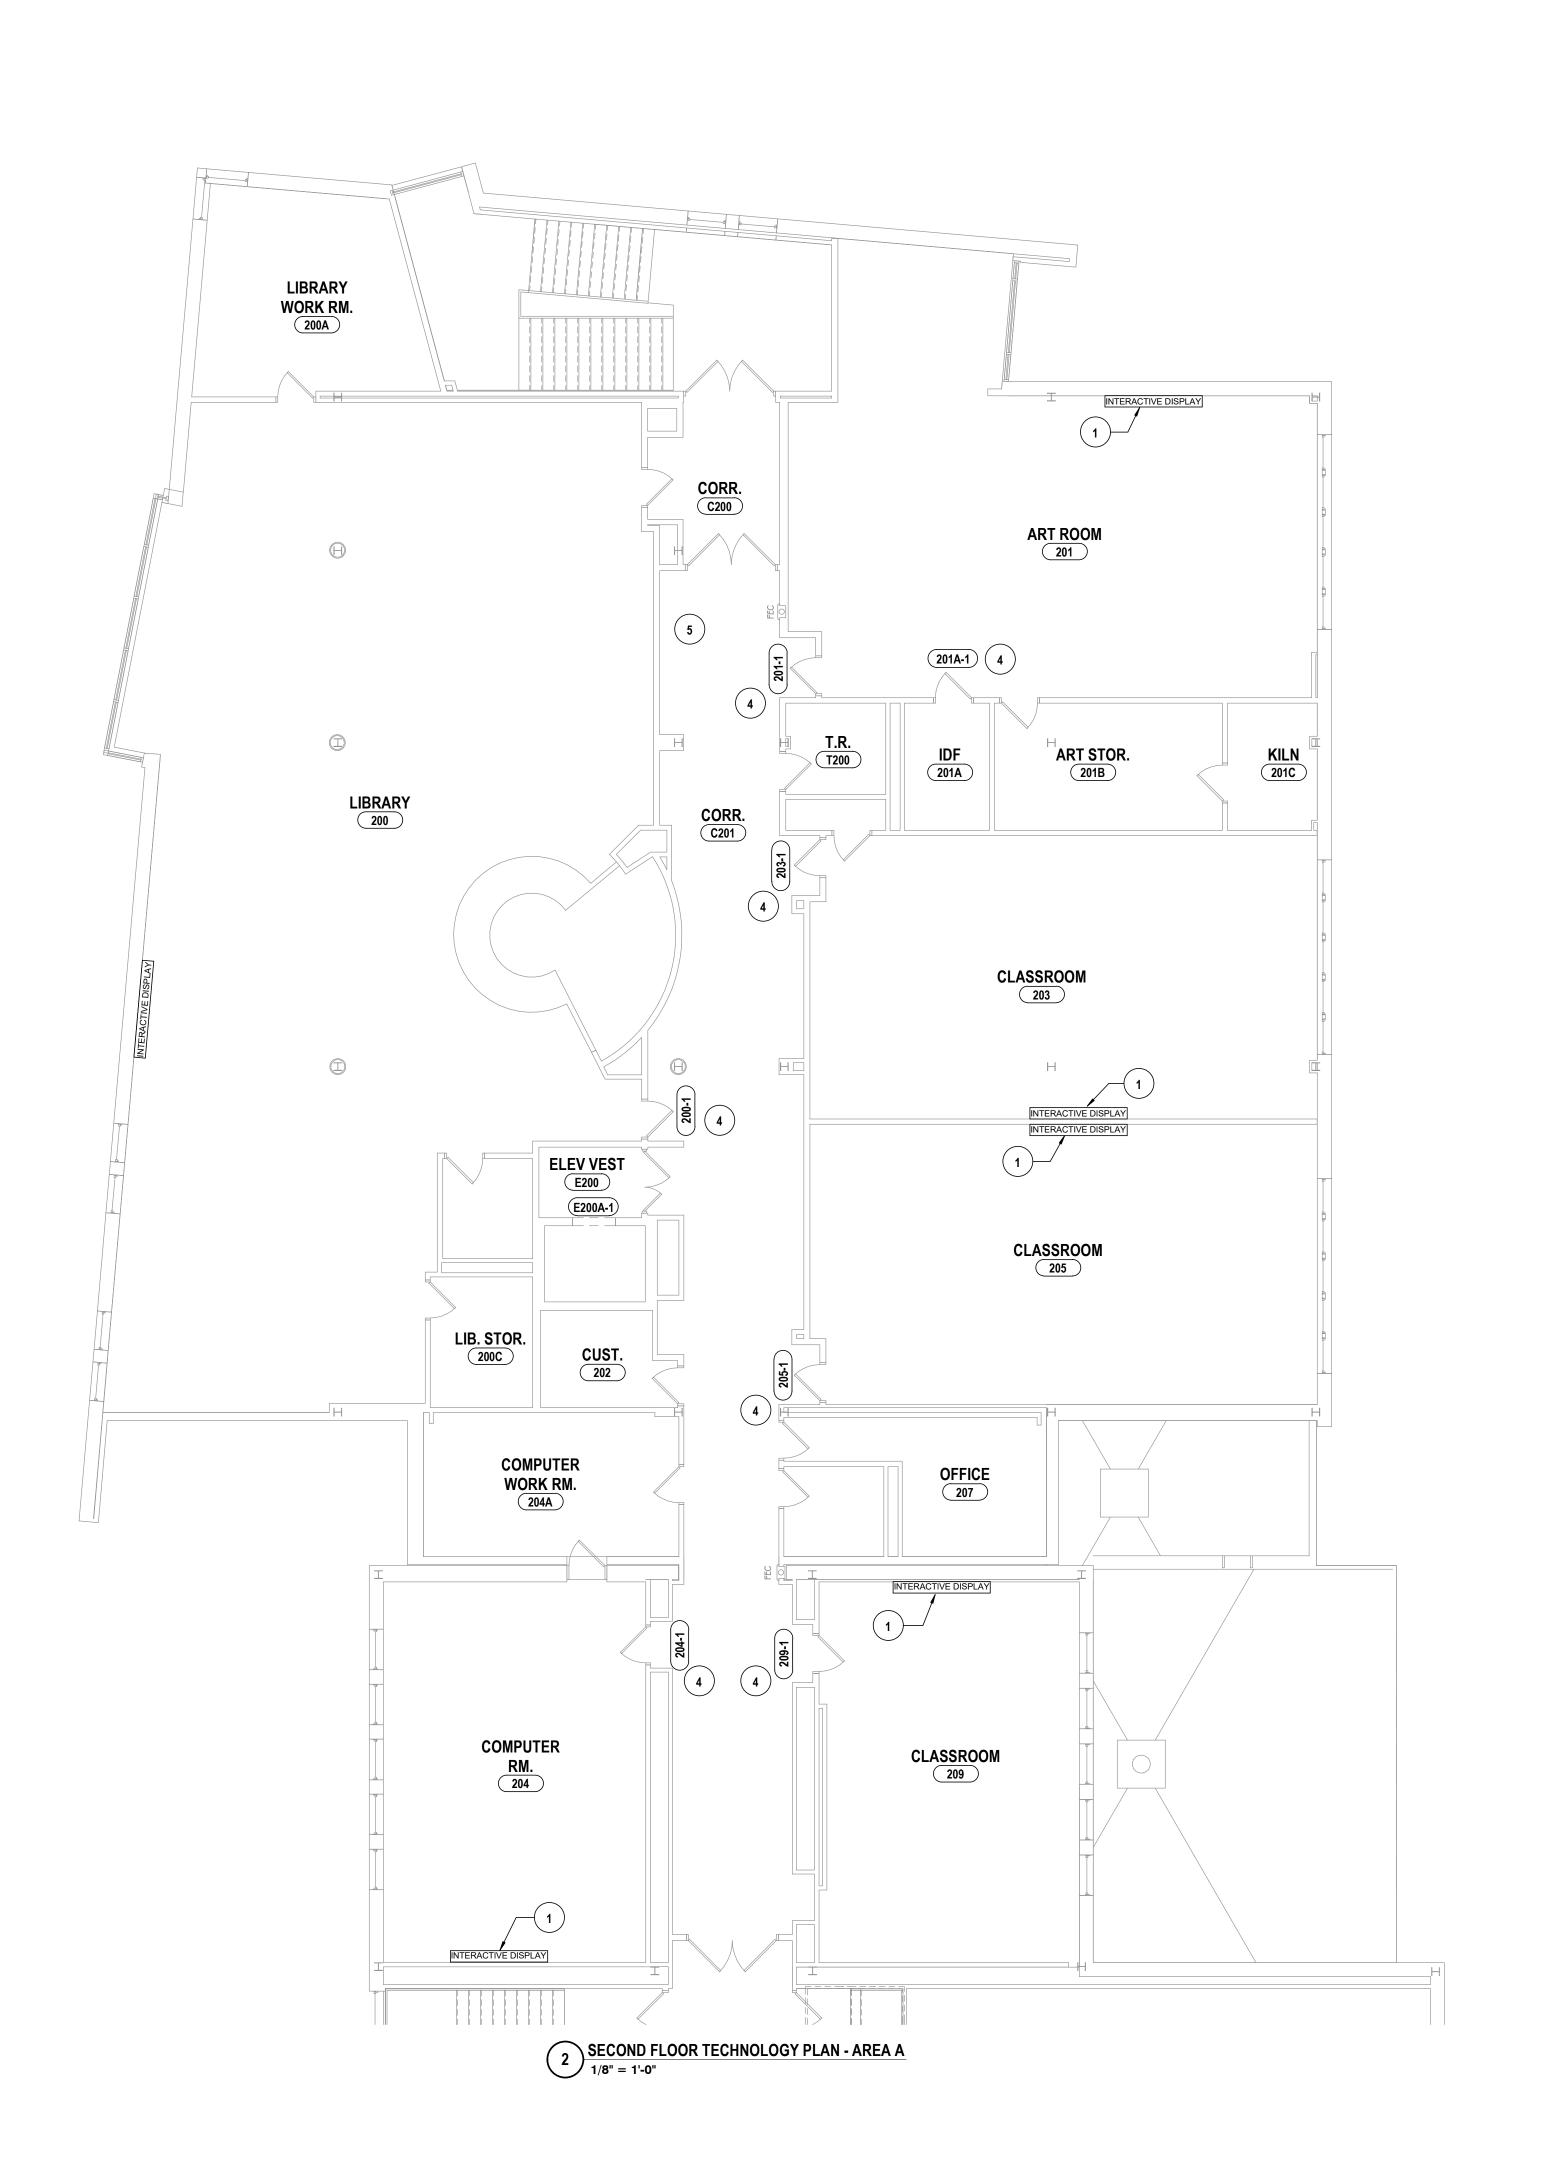
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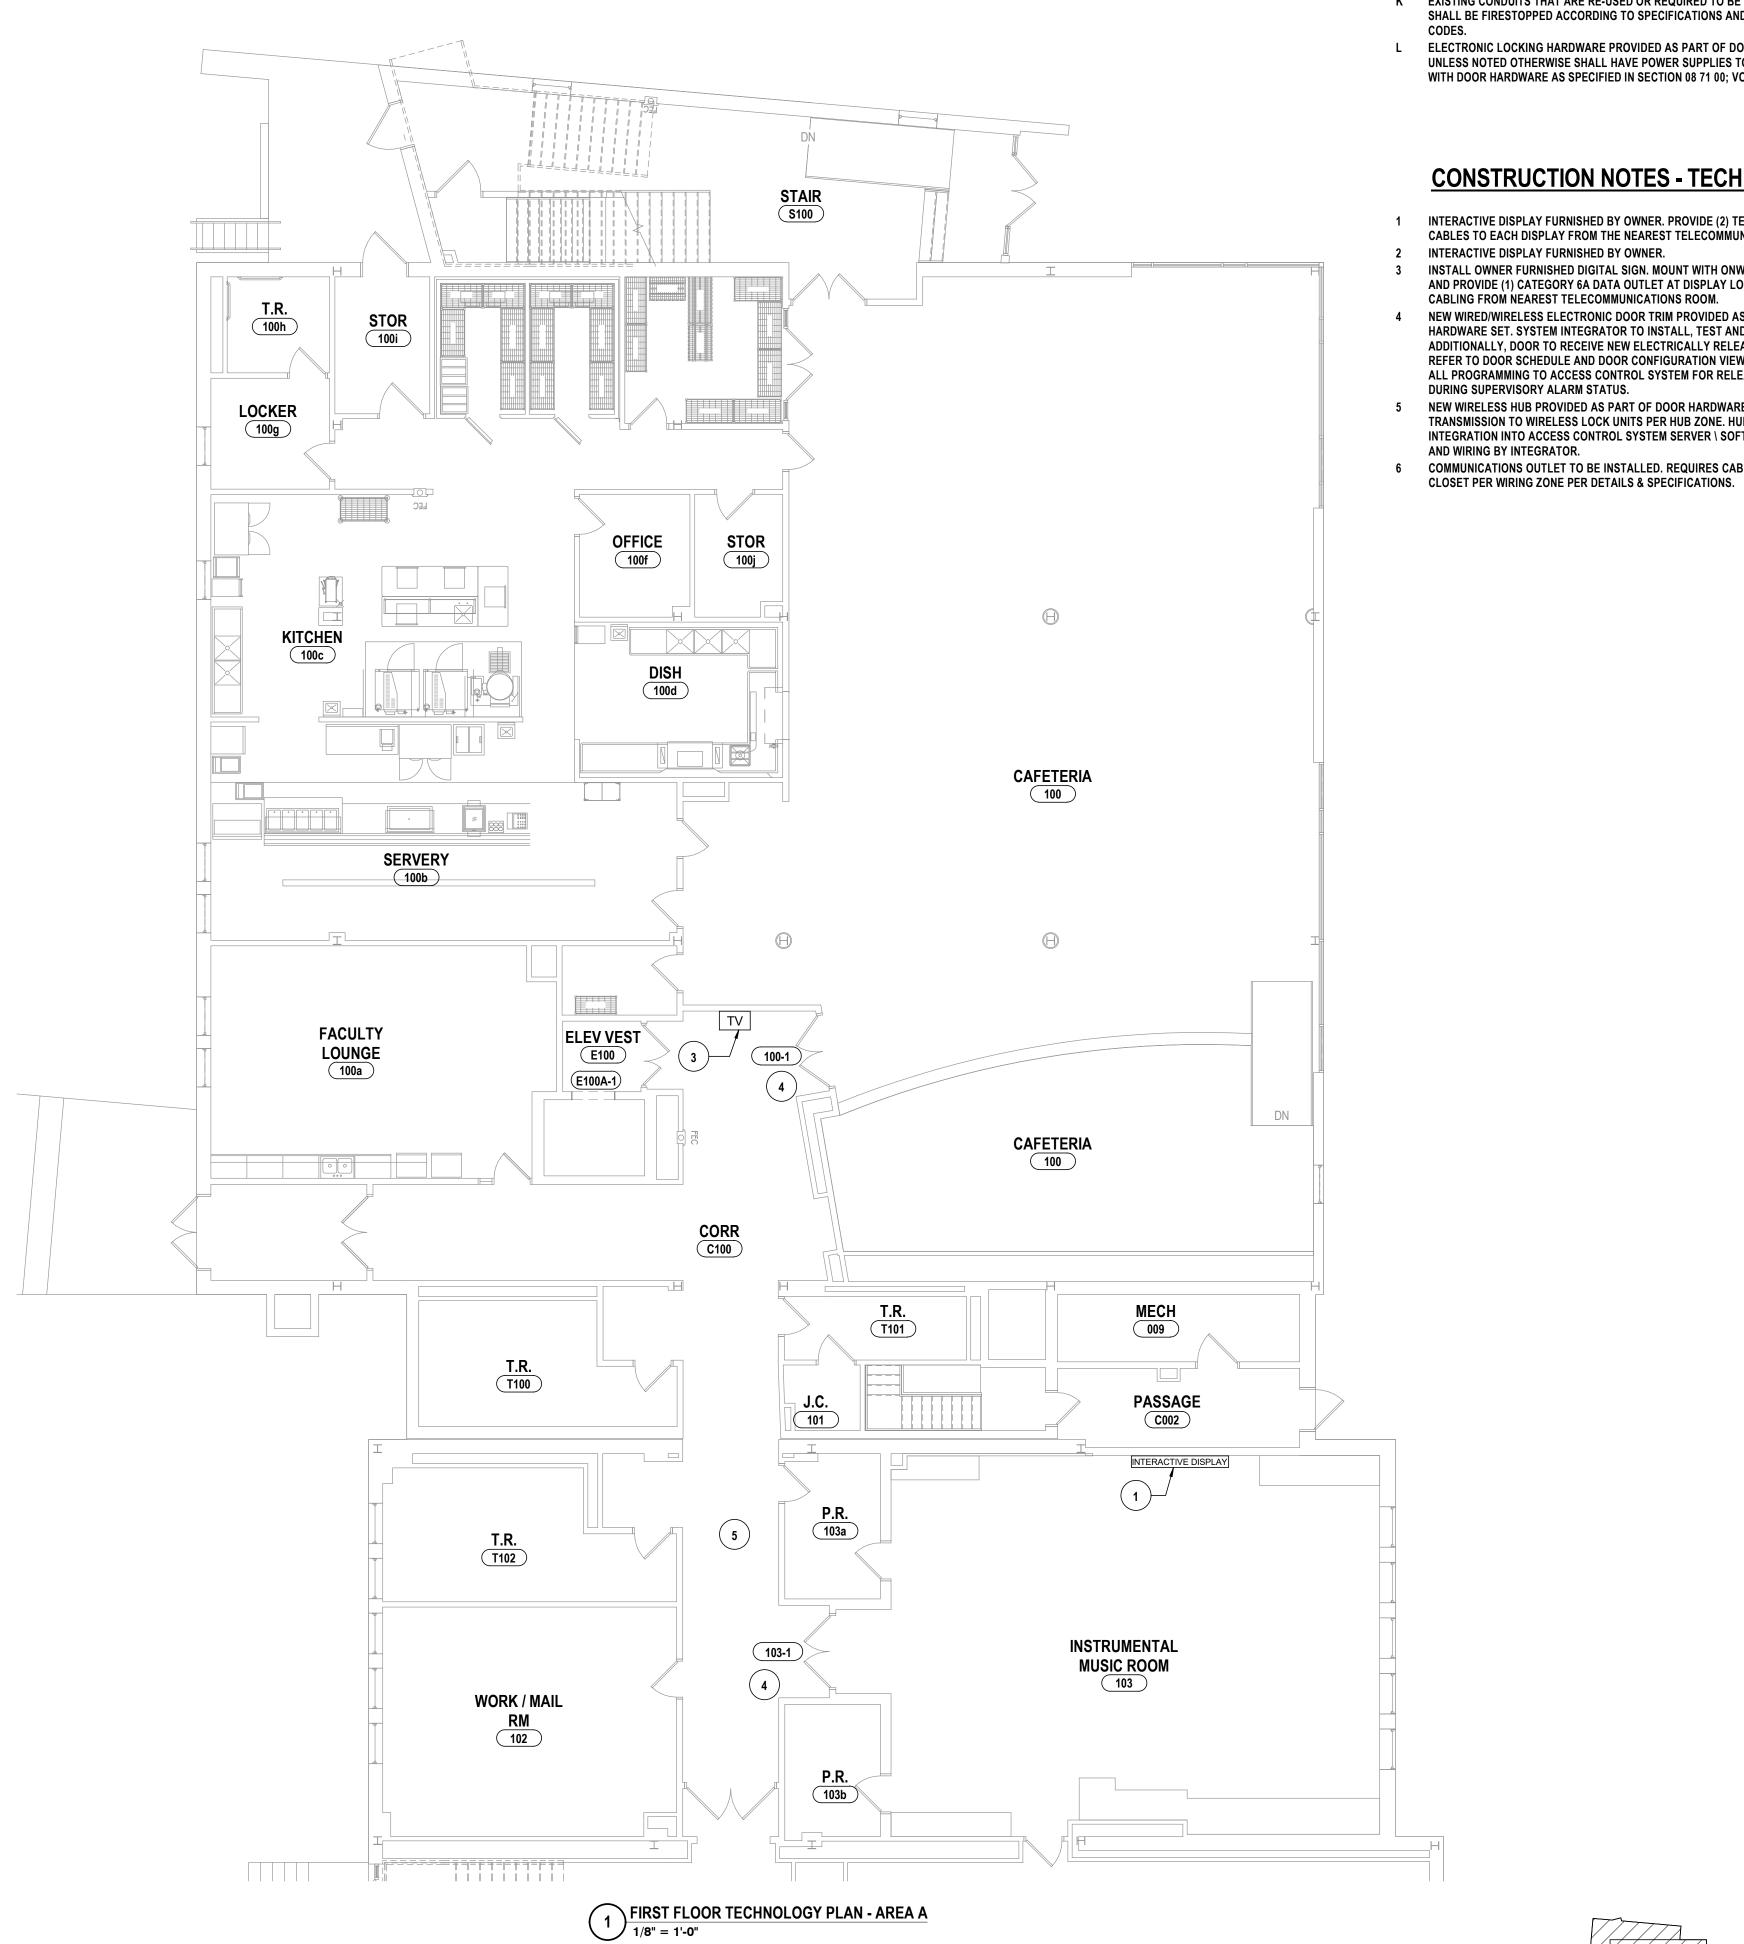
CB-T1.2

PROJECT NO: 2012-233

C2

B1





- A ALL CABLING INSTALLATION AND TERMINATION TO ADHERE TO CURRENT NEC
- CODES AND RELATED ANSI/TIA/EIA STANDARDS. B WHEN INSTALLING CEILING MOUNTED DEVICES, ADJUST LOCATION TO AVOID OTHER CEILING MOUNTED DEVICES SUCH AS EXIT SIGNS, ETC.
- C ALL DATA CABLING SHALL BE PLENUM RATED. D OWNER TO APPROVE FINAL LOCATION AND VIEW OF ALL CAMERAS.
- E ALL ELECTRONIC SERVICES NEED TO BE COORDINATED WITH OWNER PRIOR TO REMOVAL AND DISCONNECTION.
- F ALL CEILING MOUNTED DEVICES TO BE SUPPORTED BY STRUCTURE ABOVE. DO NOT USE CEILING GRID AS SOLE SUPPORT MECHANISM
- G ALL WALL OUTLETS SHALL BE LOCATED WITHIN 36" OF THE NEAREST POWER
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- L ELECTRONIC LOCKING HARDWARE PROVIDED AS PART OF DOOR HARDWARE SET UNLESS NOTED OTHERWISE SHALL HAVE POWER SUPPLIES TO BE COMPATIBLE WITH DOOR HARDWARE AS SPECIFIED IN SECTION 08 71 00; VOLTAGE TO BE V.I.F.

CONSTRUCTION NOTES - TECHNOLOGY

- 1 INTERACTIVE DISPLAY FURNISHED BY OWNER. PROVIDE (2) TESTED CATEGORY 6A CABLES TO EACH DISPLAY FROM THE NEAREST TELECOMMUNICATIONS ROOM. INTERACTIVE DISPLAY FURNISHED BY OWNER.
- 3 INSTALL OWNER FURNISHED DIGITAL SIGN. MOUNT WITH ONWER FURNISHED HARDWARE AND PROVIDE (1) CATEGORY 6A DATA OUTLET AT DISPLAY LOCATION. DISTRIBUTE CABLING FROM NEAREST TELECOMMUNICATIONS ROOM. 4 NEW WIRED/WIRELESS ELECTRONIC DOOR TRIM PROVIDED AS PART OF DOOR HARDWARE SET. SYSTEM INTEGRATOR TO INSTALL, TEST AND PROGRAM.
- ADDITIONALLY, DOOR TO RECEIVE NEW ELECTRICALLY RELEASED DOOR CLOSER, REFER TO DOOR SCHEDULE AND DOOR CONFIGURATION VIEWS ON SHEET T2.1. PROVIDE ALL PROGRAMMING TO ACCESS CONTROL SYSTEM FOR RELEASE OF DOOR CLOSER DURING SUPERVISORY ALARM STATUS. 5 NEW WIRELESS HUB PROVIDED AS PART OF DOOR HARDWARE SET. HUB HAS WIRELESS TRANSMISSION TO WIRELESS LOCK UNITS PER HUB ZONE. HUB TO BE WIRED FOR
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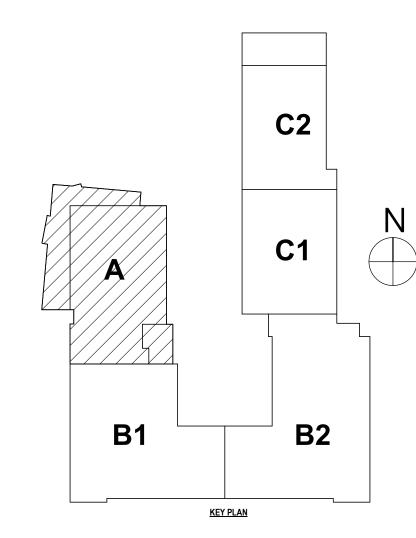
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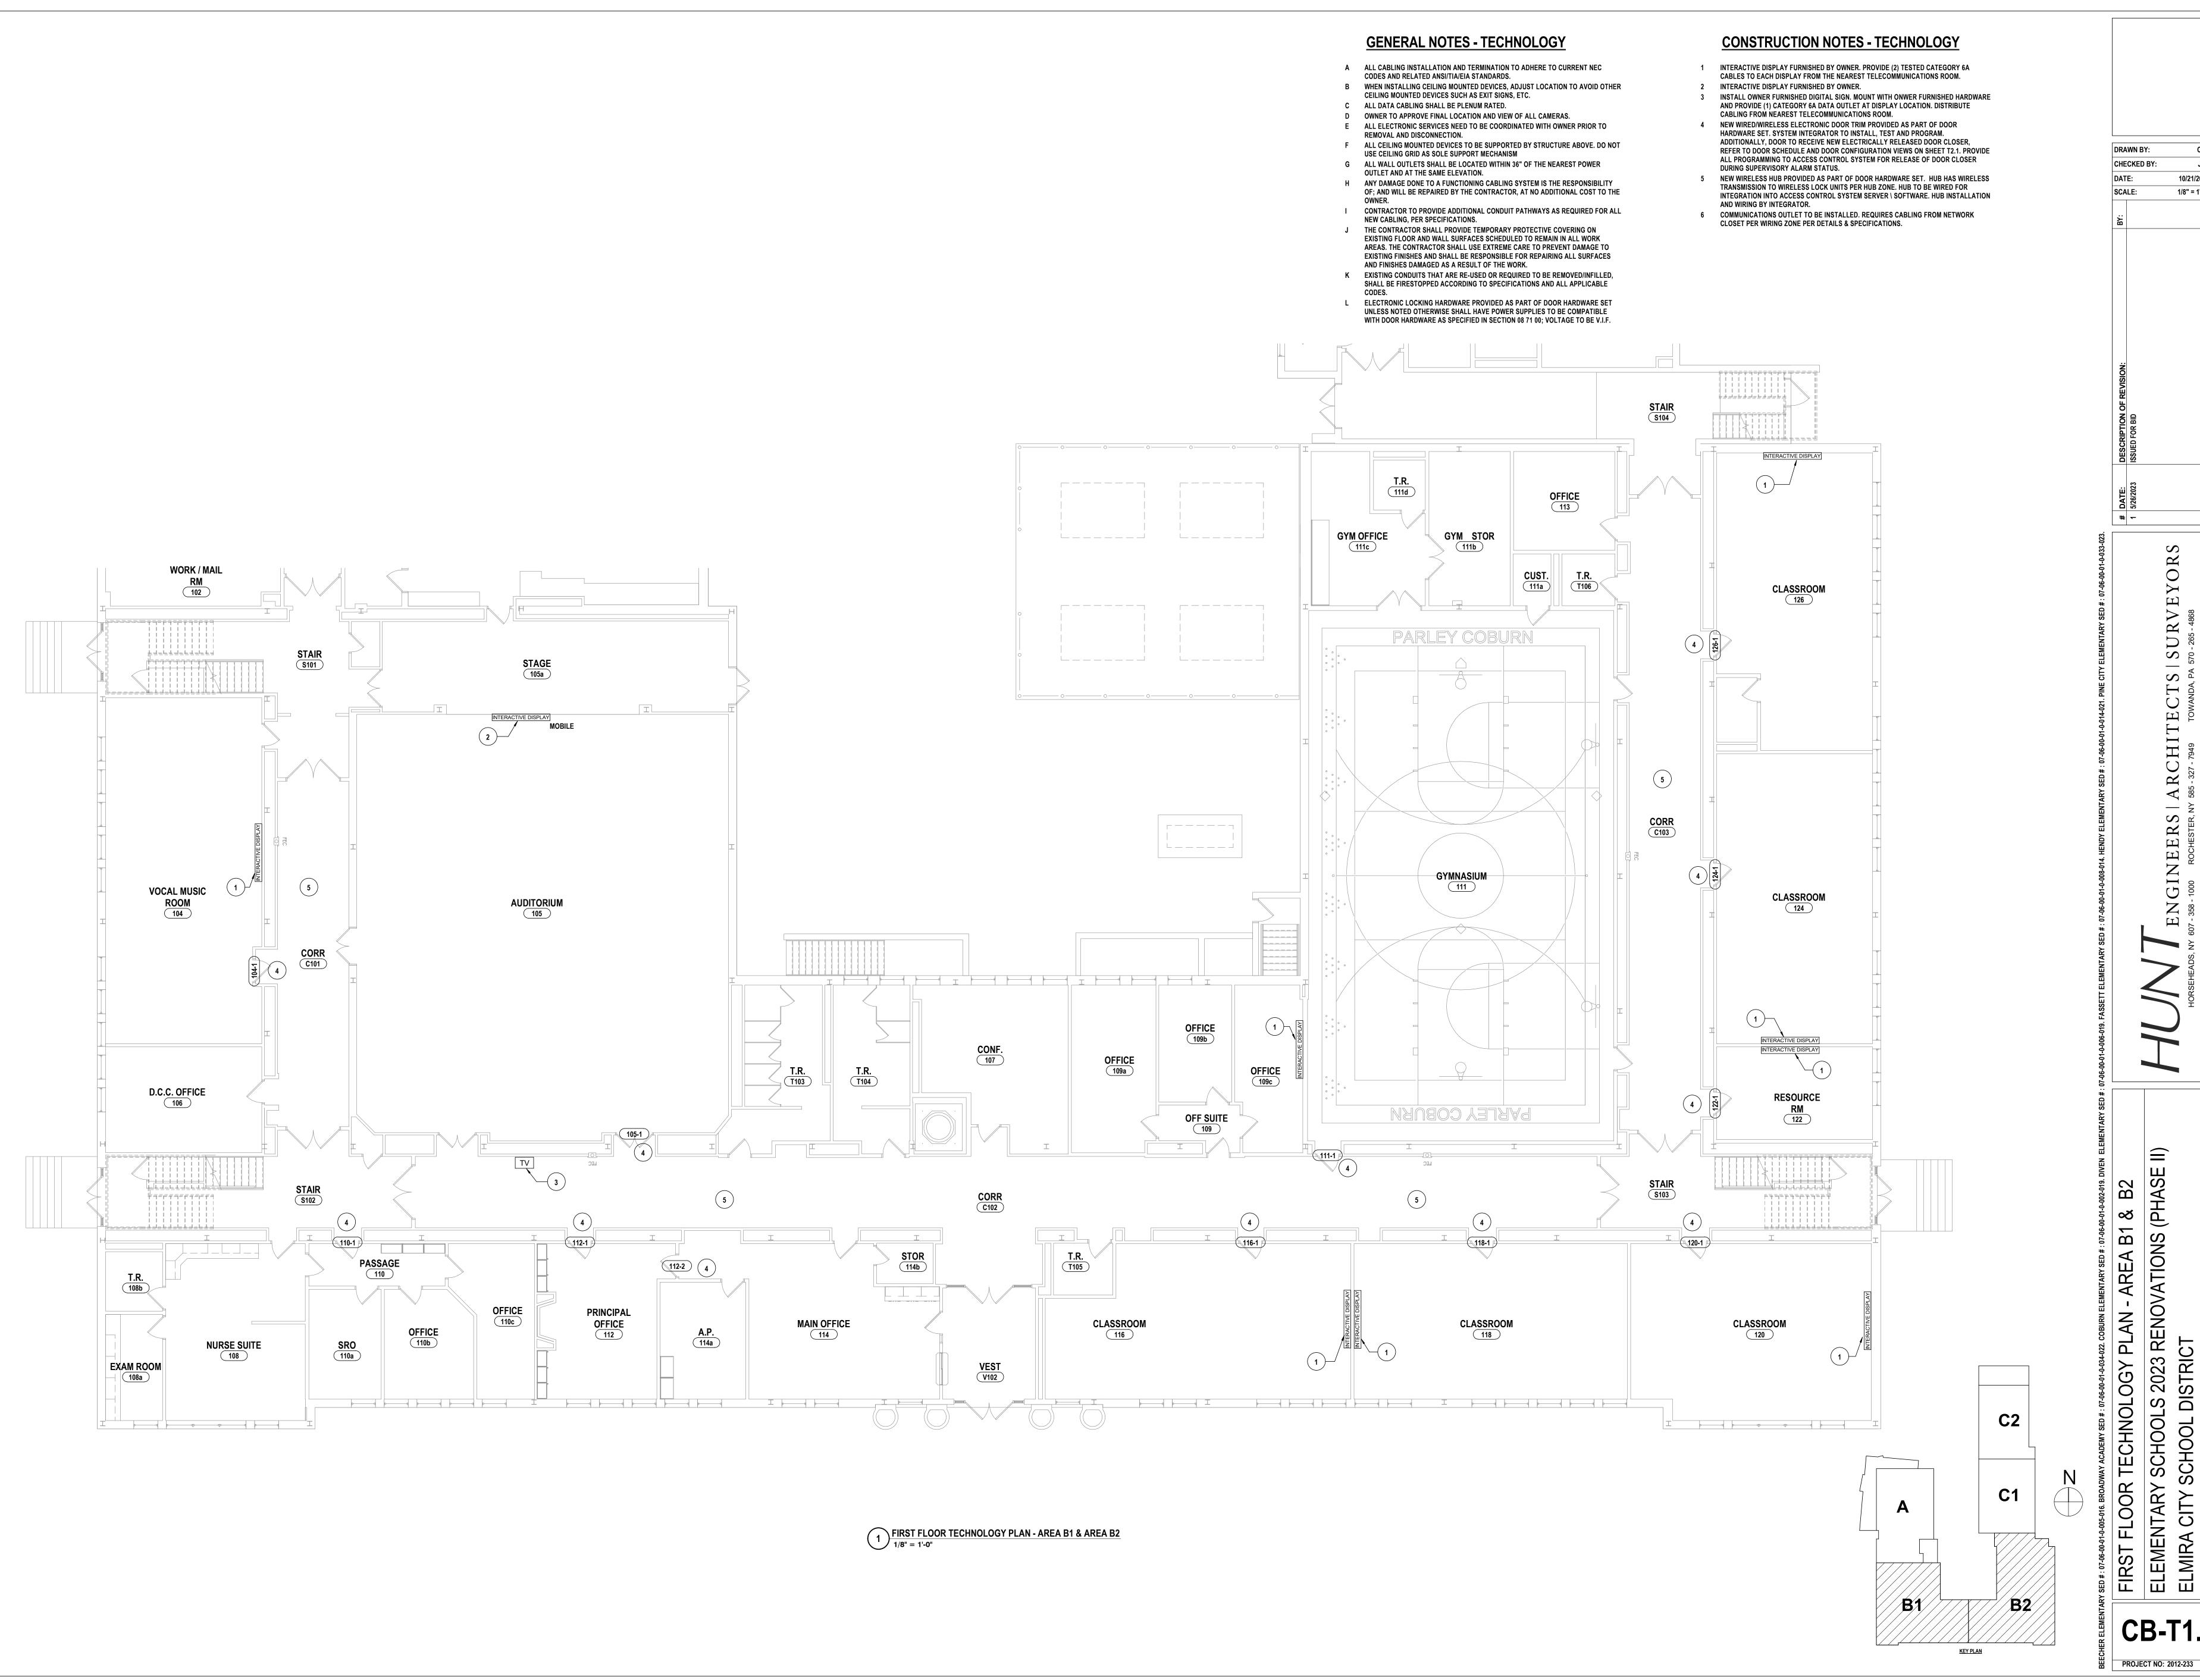
> S ENGINEERS | ARCHITEC

AREA A OR TECHNOLOGY

DISTRICT

CB-T1.3







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S $^{'}EC$ ARCHI ENGINEERS |

- AREA B1 & TECHNOLOGY PLAN LS 2023 RE DISTRICT

CB-T1.4



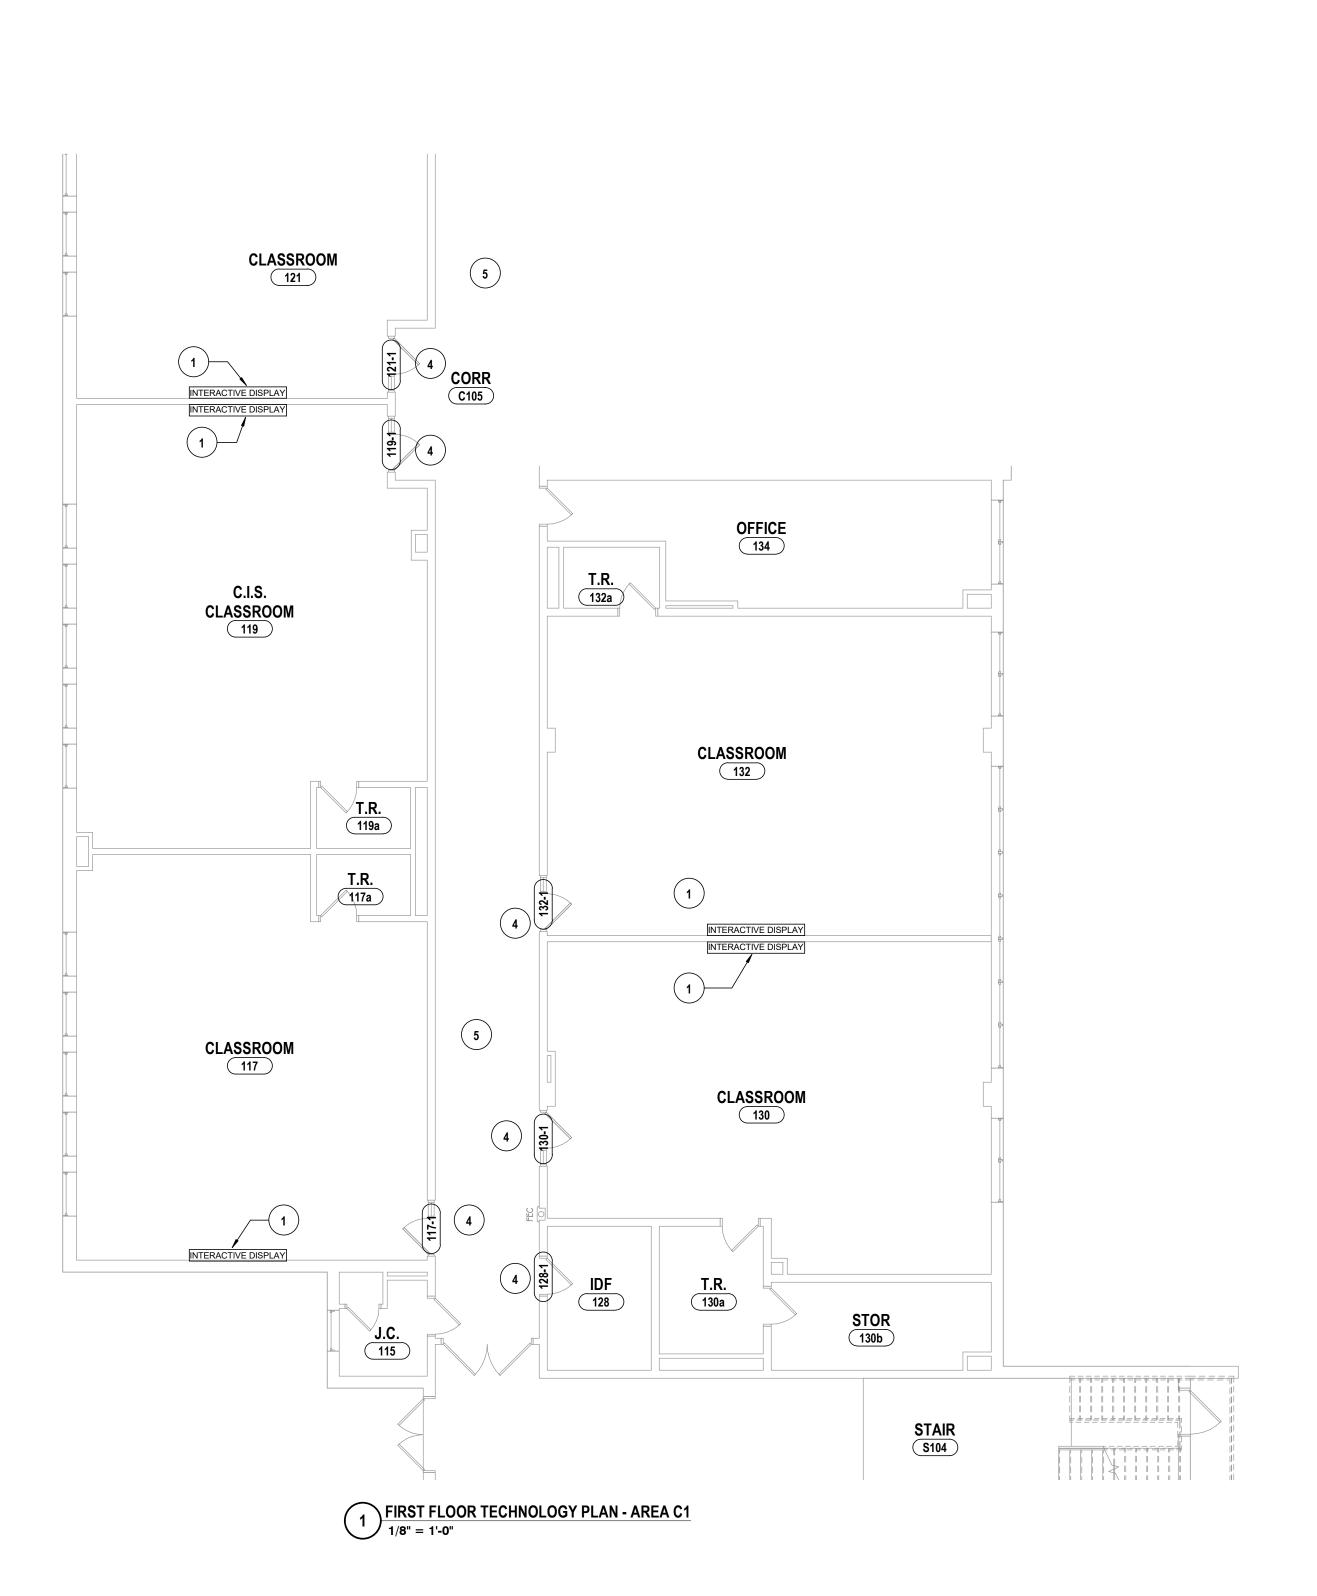

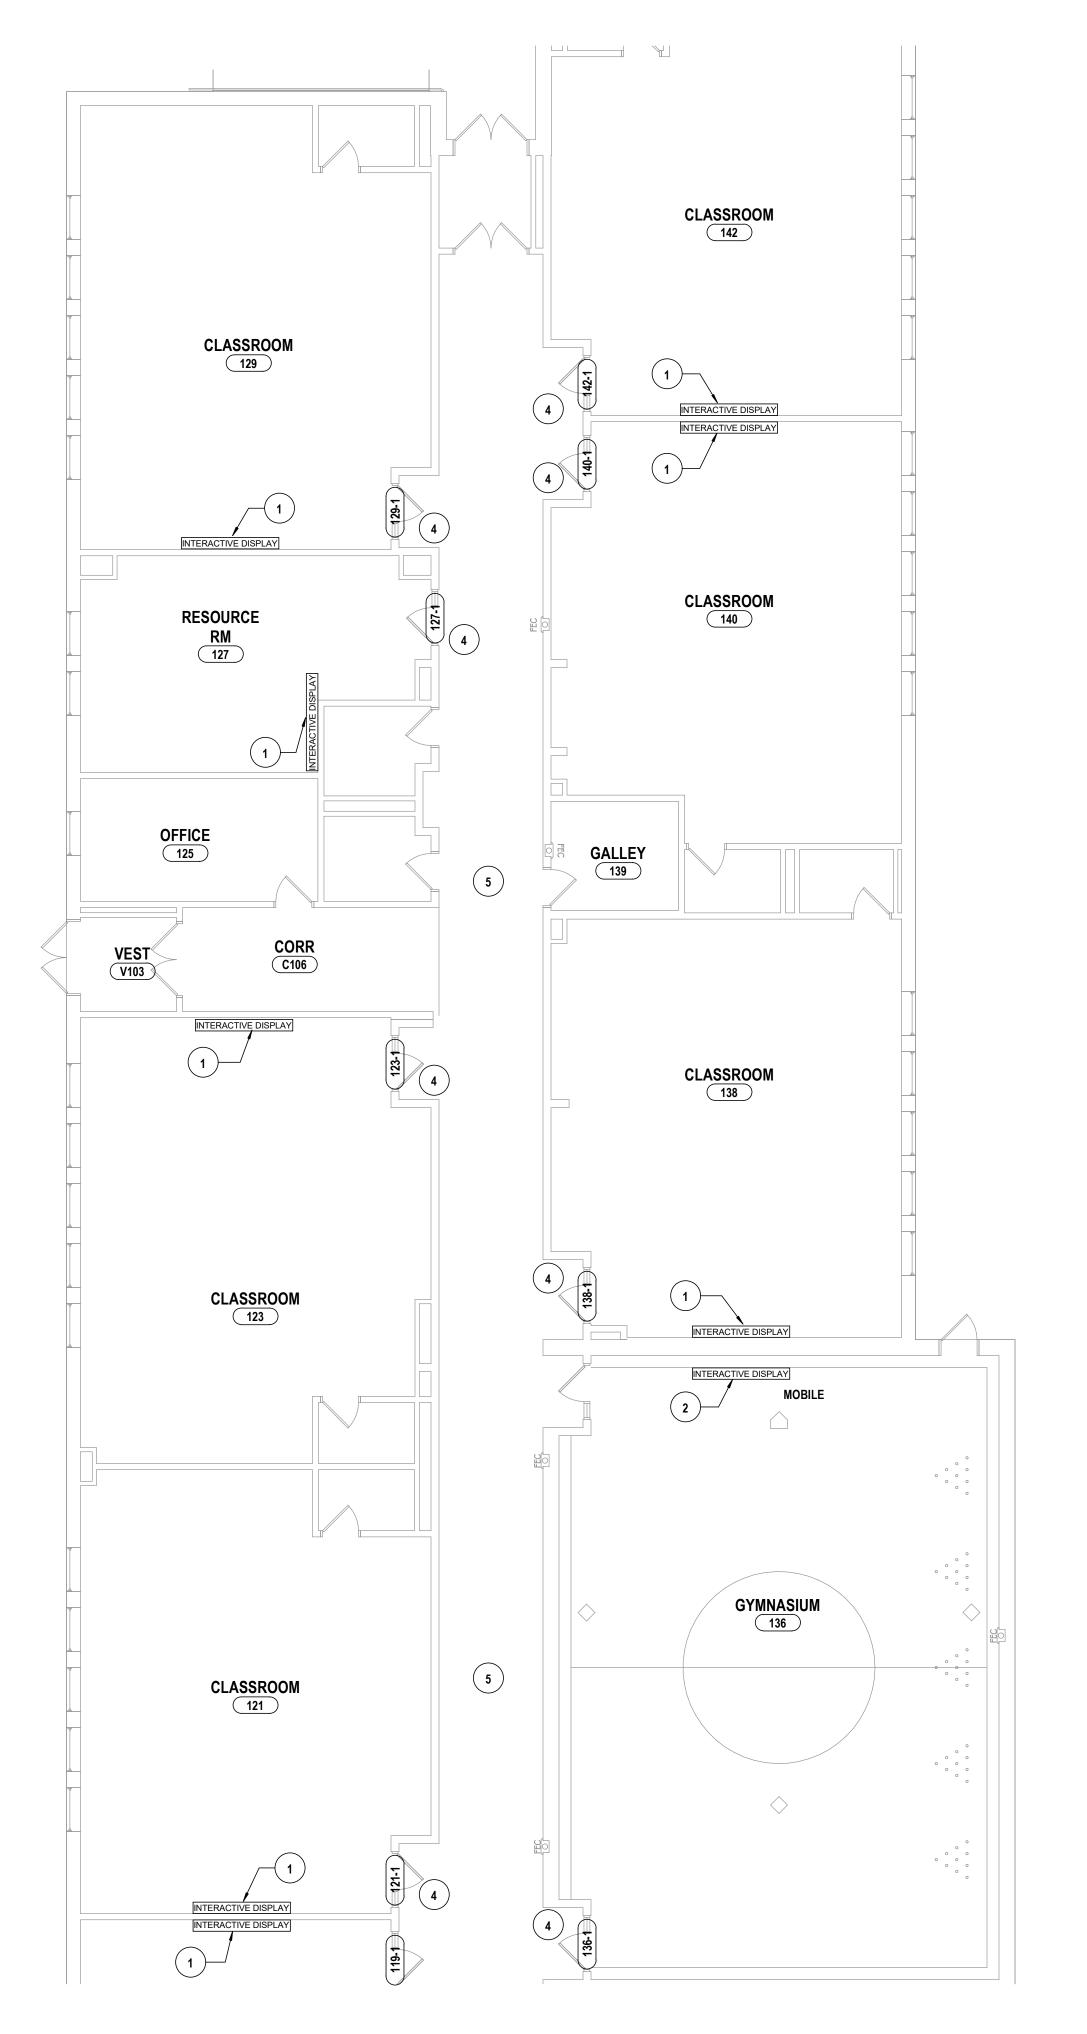FIRST FLOOR TECHNOLOGY PLAN - AREA C2
1/8" = 1'-0"

- A ALL CABLING INSTALLATION AND TERMINATION TO ADHERE TO CURRENT NEC CODES AND RELATED ANSI/TIA/EIA STANDARDS.
- B WHEN INSTALLING CEILING MOUNTED DEVICES, ADJUST LOCATION TO AVOID OTHER CEILING MOUNTED DEVICES SUCH AS EXIT SIGNS, ETC.
- C ALL DATA CABLING SHALL BE PLENUM RATED. D OWNER TO APPROVE FINAL LOCATION AND VIEW OF ALL CAMERAS.

AND FINISHES DAMAGED AS A RESULT OF THE WORK.

- E ALL ELECTRONIC SERVICES NEED TO BE COORDINATED WITH OWNER PRIOR TO REMOVAL AND DISCONNECTION.
- F ALL CEILING MOUNTED DEVICES TO BE SUPPORTED BY STRUCTURE ABOVE. DO NOT USE CEILING GRID AS SOLE SUPPORT MECHANISM
- G ALL WALL OUTLETS SHALL BE LOCATED WITHIN 36" OF THE NEAREST POWER OUTLET AND AT THE SAME ELEVATION. H ANY DAMAGE DONE TO A FUNCTIONING CABLING SYSTEM IS THE RESPONSIBILITY
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- K EXISTING CONDUITS THAT ARE RE-USED OR REQUIRED TO BE REMOVED/INFILLED, SHALL BE FIRESTOPPED ACCORDING TO SPECIFICATIONS AND ALL APPLICABLE
- L ELECTRONIC LOCKING HARDWARE PROVIDED AS PART OF DOOR HARDWARE SET UNLESS NOTED OTHERWISE SHALL HAVE POWER SUPPLIES TO BE COMPATIBLE WITH DOOR HARDWARE AS SPECIFIED IN SECTION 08 71 00; VOLTAGE TO BE V.I.F.

CONSTRUCTION NOTES - TECHNOLOGY

- 1 INTERACTIVE DISPLAY FURNISHED BY OWNER. PROVIDE (2) TESTED CATEGORY 6A CABLES TO EACH DISPLAY FROM THE NEAREST TELECOMMUNICATIONS ROOM.
- 2 INTERACTIVE DISPLAY FURNISHED BY OWNER.
- 3 INSTALL OWNER FURNISHED DIGITAL SIGN. MOUNT WITH ONWER FURNISHED HARDWARE AND PROVIDE (1) CATEGORY 6A DATA OUTLET AT DISPLAY LOCATION. DISTRIBUTE
- CABLING FROM NEAREST TELECOMMUNICATIONS ROOM. 4 NEW WIRED/WIRELESS ELECTRONIC DOOR TRIM PROVIDED AS PART OF DOOR
- HARDWARE SET. SYSTEM INTEGRATOR TO INSTALL, TEST AND PROGRAM. ADDITIONALLY, DOOR TO RECEIVE NEW ELECTRICALLY RELEASED DOOR CLOSER, REFER TO DOOR SCHEDULE AND DOOR CONFIGURATION VIEWS ON SHEET T2.1. PROVIDE ALL PROGRAMMING TO ACCESS CONTROL SYSTEM FOR RELEASE OF DOOR CLOSER DURING SUPERVISORY ALARM STATUS.
- 5 NEW WIRELESS HUB PROVIDED AS PART OF DOOR HARDWARE SET. HUB HAS WIRELESS TRANSMISSION TO WIRELESS LOCK UNITS PER HUB ZONE. HUB TO BE WIRED FOR INTEGRATION INTO ACCESS CONTROL SYSTEM SERVER \ SOFTWARE. HUB INSTALLATION AND WIRING BY INTEGRATOR. 6 COMMUNICATIONS OUTLET TO BE INSTALLED. REQUIRES CABLING FROM NETWORK

CLOSET PER WIRING ZONE PER DETAILS & SPECIFICATIONS.

DRAWN BY: CSH JLS CHECKED BY: DATE: 10/21/2022 SCALE: 1/8" = 1'-0"

> S ENGINEERS | ARCHITEC

FLOOR TECHNOLOGY PLAN - AREA C1 & C2

LS 2023 RE DISTRICT

CB-T1.5

