CHABAD DOWNTOWN

30 WALL STREET, BINGHAMTON NY, 13901

OWNER:

CHABAD OF BINGHAMTON 420 MURRAY HILL ROAD VESTAL, NY 13850 TEL: 607-797-0015

ARCHITECT:

FIFIELD I PIAKER I ELMAN I ARCHITECTS, PC 740 BROADWAY, SUITE 601 NEW YORK, NY 10003 TEL: 212-979-9272

INTERIOR DESIGNER:

HH DESIGNERS 1876 LAKEWOOD RD, UNIT 7 TOMS RIVER, NJ 08755 TEL: 732-400-5338

STRUCTURAL ENGINEER:

STRUCTURAL CONSULTING SERVICES, P.C. 67 FEDERAL ROAD, BLDG A BROOKFIELD, CT 06804 TEL: 203-740-7578

MEP ENGINEER:

AVCON ENGINEERING PC 580 8TH AVENUE, 14TH FLOOR NEW YORK, NY 10018 TEL: 570 342-3700

LIGHTING CONSULTANT:

CONSUMER'S LIGHTING AND LAMPS 23 WASHINGTON AVE, SUITE 1 SUFFERN, NY 10901 TEL: 845-533-1622 ext. 110

MIKVAH CONSULTANT:

MIKVAH DESIGN & CONSULTANCY 1816 ROME AVENUE SAINT PAUL, MN 55116 TEL: 651-690-4867


CIVIL ENGINEER:

KEYSTONE ASSOCIATES 58 EXCHANGE STREET BINGHAMTON, NY 13901 TEL: 607-722-1100

DESIGN CONSULTANT:

URIEL ZOHAR DESIGN STUDIO JERUSALEM, ISRAEL 93629

TEL: +972 54-793-9506

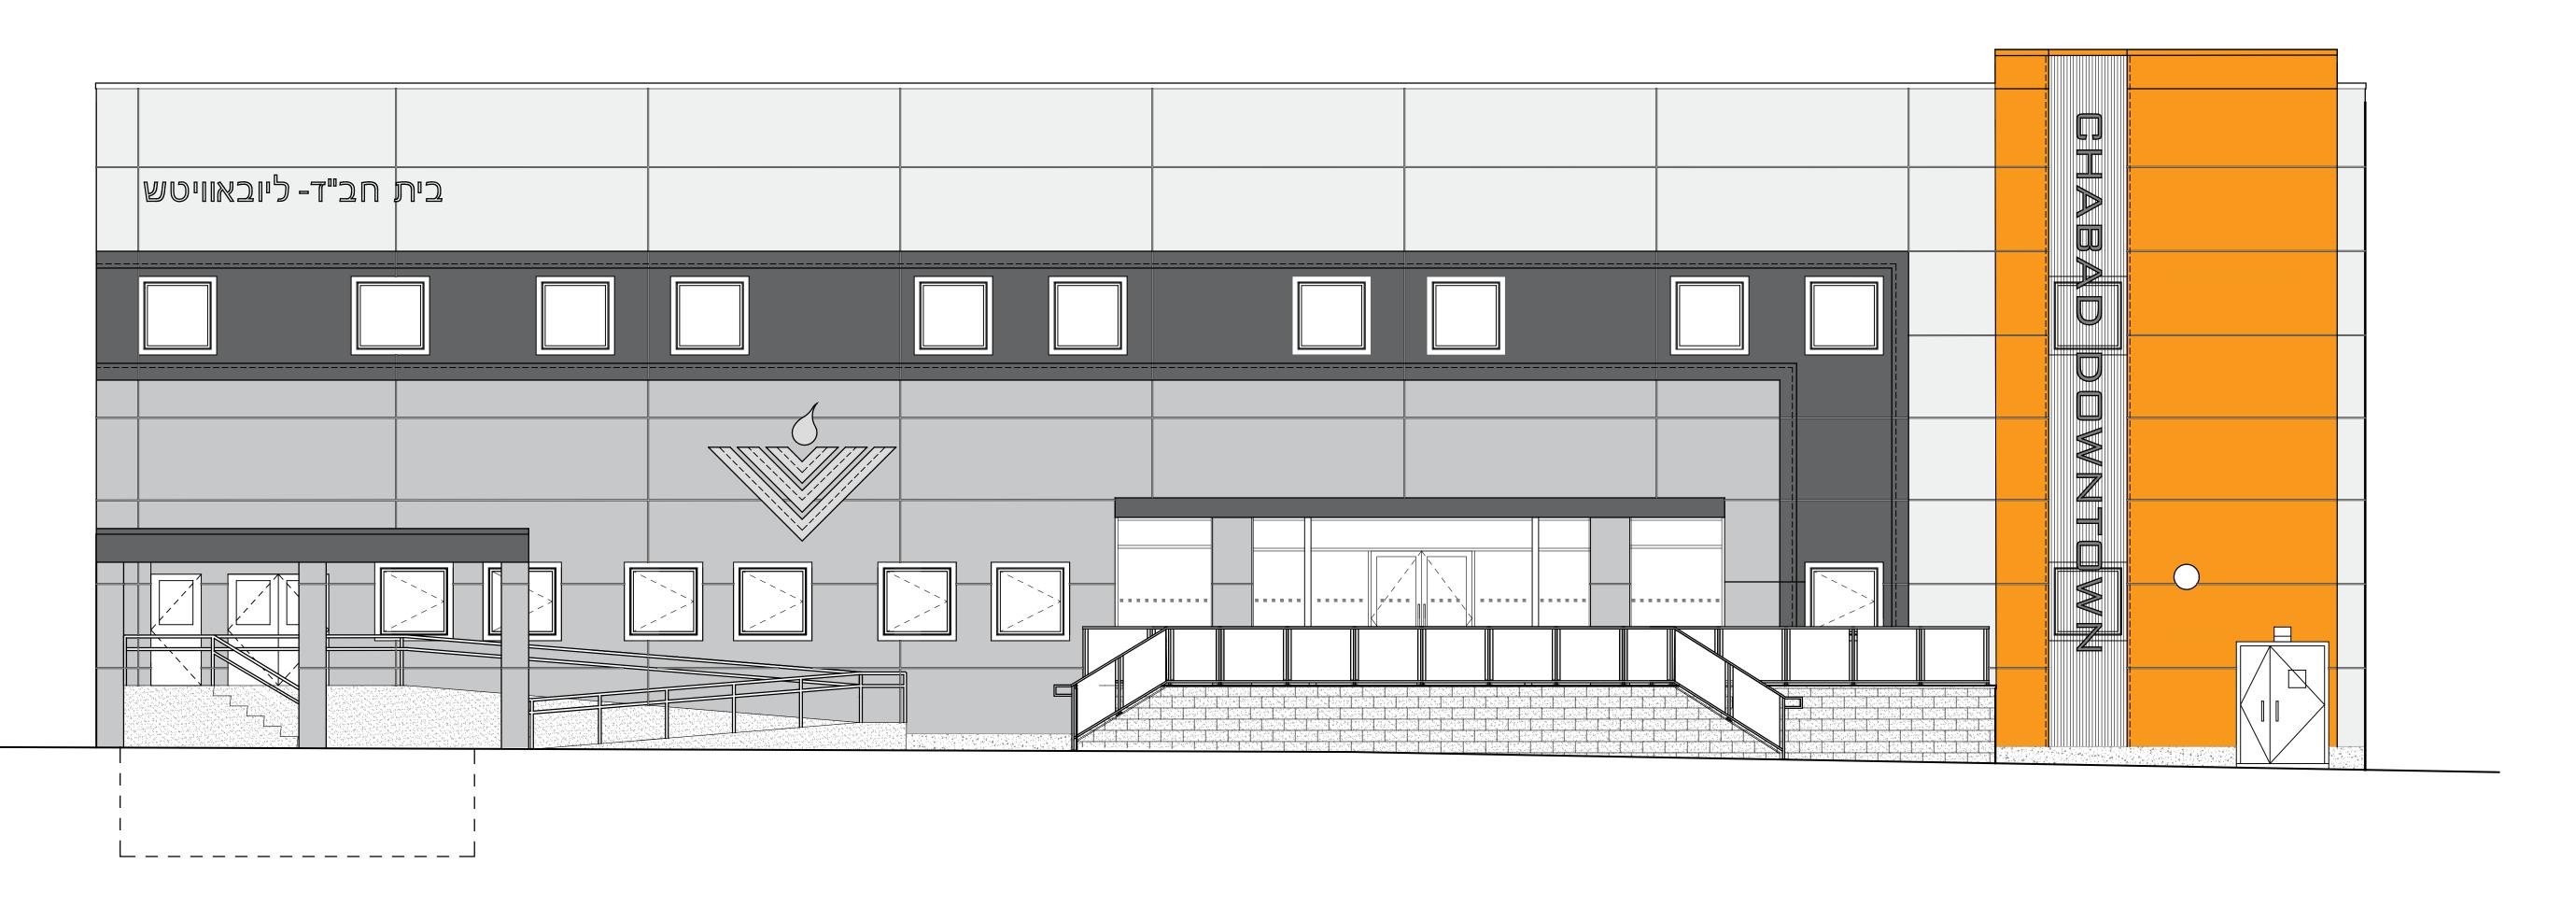

NORTH ELEVATION 3/16"= 1'-0"

FIFIELD PIAKER ELMAN ARCHITECTS, PC

740 Broadway, Suite 601 New York, NY 10003 tel 212 979 9272 www.fpe-architects.com

NO USE, REPRODUCTION OR DISSEMINATION MAY BE MADE OF THIS DRAWING & CONCEPTS SET FORTH HEREON WITHOUT THE PRIOR WRITTEN CONSENT OF FIFIELD PIAKER ELMAN ARCHITECTS P.C. COPYRIGHT © 2024

CHABAD DOWNTOWN

30 WALL STREET BINGHAMTON, NY 13901


	BID SET	10/03/2			
	100% SUBMISSION	5/01/25			
01	98% SUBMISSION	1/28/25			
No:	Description:	Date:			
Revisions:					

Sheet Title: 2022037.00 **AS SHOWN**

Scale: 01/28/25 Date: CE Drawn:

Job No:


COVER SHEET

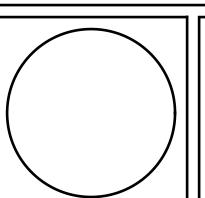

Drawing No.:

CHABAD DOWNTOWN

30 WALL STREET, BINGHAMTON NY, 13901

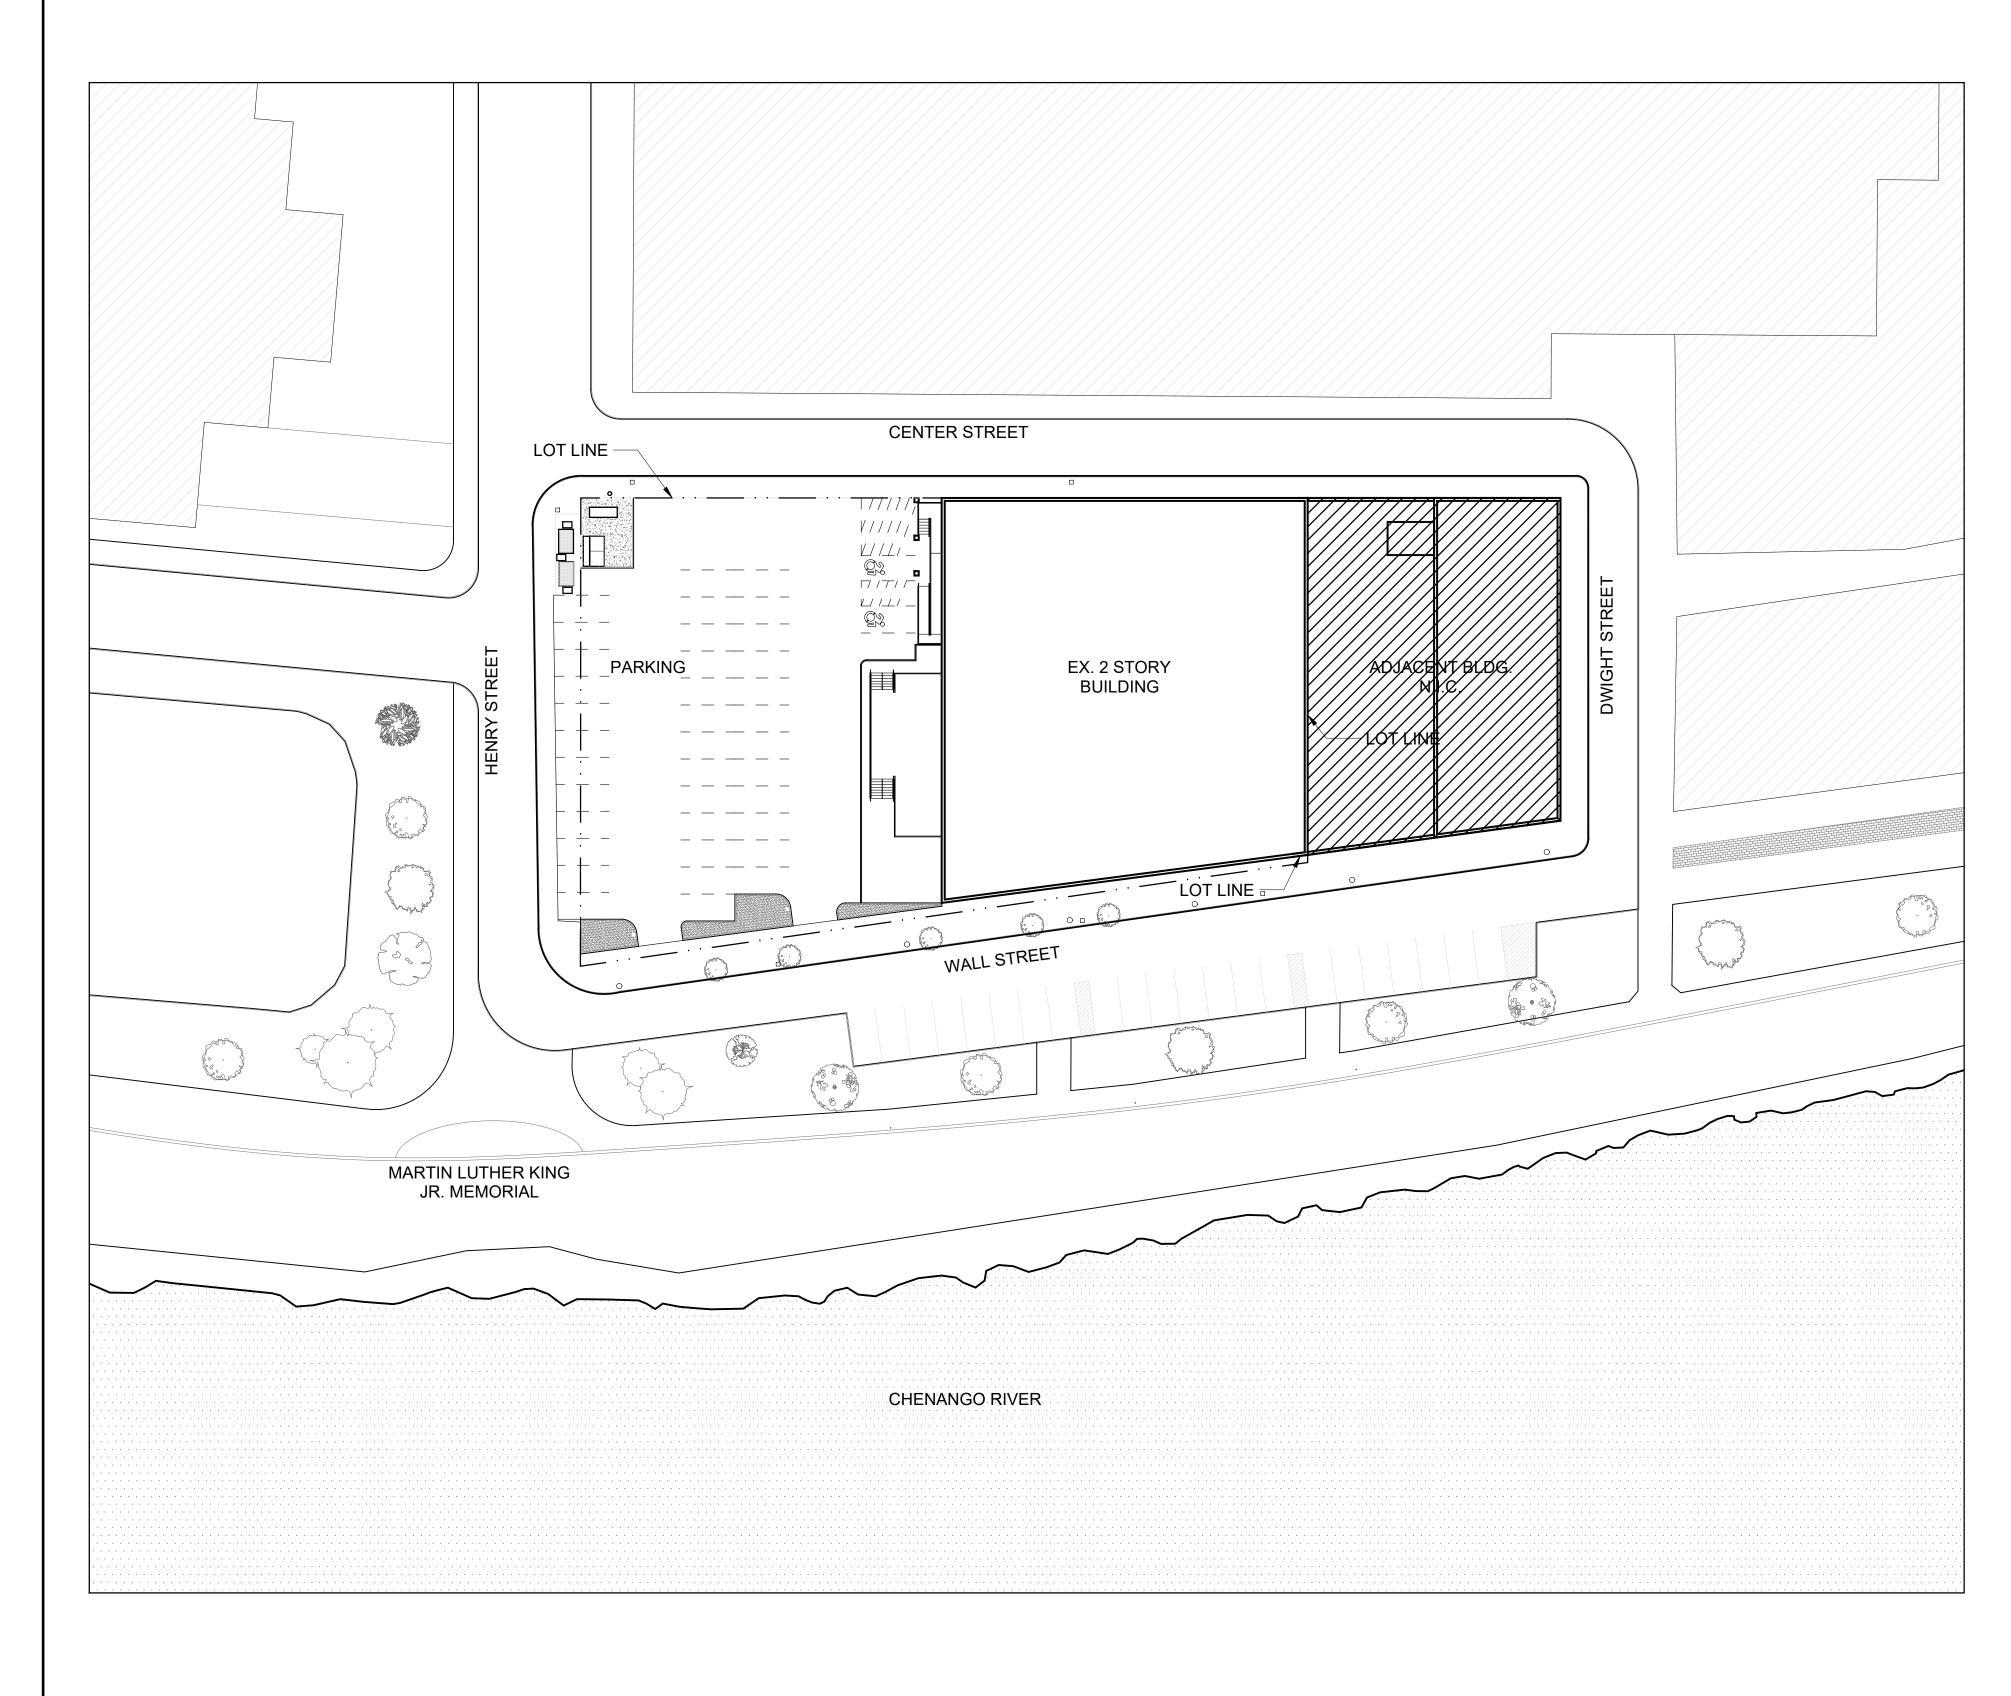

GENERAL NOTES

1. BEFORE SUBMITTING A BID, THE CONTRACTOR SHALL CAREFULLY EXAMINE THE DRAWINGS, READ THE SPECIFICATIONS AND ALL OTHER PROPOSED CONTRACT DOCUMENTS, AND VISIT THE SITE OF THE WORK. THE CONTRACTOR SHALL FULLY INFORM HIMSELF PRIOR TO BIDDING AS TO ALL EXISTING CONDITIONS AND LIMITATIONS UNDER WHICH THE WORK IS TO BE PERFORMED, AND INCLUDE ALL COSTS OF ALL ITEMS NECESSARY TO PERFORM THE WORK AS SET FORTH IN THE CONTRACT DOCUMENTS. NO ALLOWANCE WILL BE MADE TO THE CONTRACTOR BECAUSE OF LACK OF SUCH EXAMINATION OR KNOWLEDGE.

2. ALL CONSTRUCTION TO CONFORM TO STATE & LOCAL BUILDING LAWS, ZONING REGULATIONS, LOCAL FIRE DEPARTMENT REGULATIONS, UTILITY COMPANY REQUIREMENTS, OSHA, AND THE BEST TRADE

3. CONTRACTOR SHALL PERFORM ALL WORK PROCEDURES WITHIN REQUIREMENTS OF LOCAL AUTHORITIES, NEIGHBORHOOD ASSOCIATIONS, AND THE OWNER.

4. CONTRACTOR TO VERIFY ALL INDICATED CONDITIONS AND DIMENSIONS BEFORE STARTING WORK AND REPORT ANY DISCREPANCIES TO THE ARCHITECT. THE DRAWINGS REFLECT CONDITIONS REASONABLY INTERPRETED FROM THE EXISTING VISIBLE CONDITIONS, OR FROM DRAWINGS AND INFORMATION FURNISHED BY THE OWNER, BUT CANNOT BE GUARANTEED BY THE ARCHITECT.

5. MINOR DETAILS NOT USUALLY SHOWN OR SPECIFIED BUT NECESSARY FOR THE PROPER AND ACCEPTABLE CONSTRUCTION, INSTALLATION, OR OPERATION OF ANY PART OF THE WORK, AS DETERMINED BY THE ARCHITECT, SHALL BE INCLUDED IN THE WORK AS IF IT WERE SPECIFIED OR INDICATED IN THE DRAWINGS.

6. CONTRACTOR SHALL OBTAIN AND PAY FOR ALL REQUIRED PERMITS, SCHEDULE ALL REQUIRED INSPECTIONS, AND OBTAIN ALL REQUIRED APPROVALS. INCLUDING A NEW CERTIFICATE OF OCCUPANCY.

7. CONTRACTOR SHALL BE RESPONSIBLE FOR ALL EQUAL OPPORTUNITY REQUIREMENTS.

8. CONTRACTOR SHALL KEEP THE CONSTRUCTION SITE FREE AND CLEAR OF ALL DEBRIS AND ALL UNAUTHORIZED PERSONS.

9. DRAWINGS MAY BE ROUGH-SCALED FOR ESTIMATING AND GENERAL REFERENCE PURPOSE ONLY, AND NOT FOR LAYOUT OR FABRICATION.

10. ALL WORK SHALL BE GUARANTEED FOR ONE YEAR AFTER FINAL APPROVAL UNLESS OTHERWISE INDICATED IN THE SPECIFICATIONS. ALL DEFECTS DISCOVERED DURING THE GUARANTEE PERIOD SHALL BE REPAIRED TO THE OWNER'S SATISFACTION AT NO COST TO THE OWNER.

11. ALL PIPING, CONDUIT, AND DUCTWORK SHALL RUN CONCEALED, EXCEPT AS OTHERWISE INDICATED.

12. ELECTRICAL WORK TO BE FILED SEPARATELY.

13. ALL ELECTRICAL WORK TO BE PERFORMED BY A LICENSED ELECTRICIAN.

14. ALL PLUMBING WORK TO BE PERFORMED BY A LICENSED PLUMBER.

15. SPRINKLER WORK TO BE FILED SEPARATELY

ENERGY NOTES

PER NYS ECC TABLE C402.4 FIXED FENESTRATION REQUIRES MAX U FACTOR OF 0.36 (MIN R 2.77), OPERABLE FENESTRATION REQUIRES MAX U-FACTOR OF 0.43 (MIN R 2.32), AND ENTRANCE DOORS REQUIRE MAX U-FACTOR OF

EXTERIOR MASS WALLS REQUIRE R 13.3 INSULATION PER NYS ECC TABLE C402.1.3

ROOFING REQUIRES R 30 INSULATION PER NYS ECC TABLE C402.1.3

BUILDING NOTES

ALL WORK IS TO CONFORM TO LOCAL BUILDING DEPARTMENT REQUIREMENTS, FIRE DEPARTMENT REGULATIONS, UTILITY COMPANY REQUIREMENTS, OSHA, OR THE BEST TRADE PRACTICES, WHICH EVER IS STRICTEST.

ALL BUILDING DEPARTMENT NOTES REFER TO THE CODES, RULES, AND REGULATIONS OF NEW YORK STATE

PLUMBING CONTRACTOR TO MEET WITH BINGHAMTON BUILDING DEPARTMENT PRIOR TO COMMENCEMENT OF

THE MAXIMUM OCCUPANT LOAD MUST BE POSTED AT THE TIME OF THE FINAL BUILDING DEPT. INSPECTION

NO LOCKS OR FASTENING DEVICES TO PREVENT FREE ESCAPE SHALL BE INSTALLED ON EXITS. THESE DOORS SHALL BE EQUIPPED WITH FIRE EXIT BOLTS. MAIN ENTRANCE DOORS MAY HAVE CYLINDER LOCKS. HOWEVER A THUMB TURN MUST BE IN STALLED ON THE INSIDE. NO DOUBLE KEYED CYLINDER LOCKS MAY BE INSTALLED

2. INTERIOR FLOOR FINISHES 804.4

INTERIOR FLOOR FINISHES SHALL BE CLASS I IN:

A. EXITS AND STAIRWAYS

B. PASSAGEWAYS AND AREAS OF PUBLIC ASSEMBLY

C. A CERTIFICATE FROM THE CARPET MANUFACTURER MUST BE SUBMITTED TO THE BINGHAMTON BUILDING

3. EXIT FINISHES 772.3 (b) (3)

ENCLOSED EXIT FINISHES MUST BE CLASS A

4. COMBUSTIBLE DECORATIVE MATERIALS 806.2

DRAPES AND DECORATIVE MATERIALS MUST BE NON-COMBUSTIBLE OR FLAME RETARDANT. IN ADDITION, A CERTIFICATE MUST BE SUBMITTED TO THE BINGHAMTON BUILDING DEPARTMENT TO ASSURE COMPLIANCE.

5. FIRE AND SMOKE DETECTING 907

ALL AREAS OF PUBLIC ASSEMBLY AND MEANS OF EGRESS MUST PROVIDED WITH A FIRE AND SMOKE DETECTING SYSTEM CONFORMING TO N.F.P.A.72E. A LOCATION PLAN MUST BE SUBMITTED TO THE TOWN OF VESTAL BUILDING DEPT. PRIOR TO INSTALLATION.

6. EMERGENCY LIGHTING 1008

A FINAL DETERMINATION OF EMERGENCY LIGHTING LOCATIONS WILL BE ESTABLISHED AT THE TIME OF FINAL BUILDING DEPT. INSPECTION SEE ALT 2 PAGE 51

7. EXIT SIGNS 1013.1

EXITS AND EXIT ACCESS DOORS SHALL BE MARKED BY AN APPROVED EXIT SIGN READILY VISIBLE FROM ANY DIRECTION OF EGRESS TRAVEL.

8. HANDICAPPED ACCESSIBILITY

HANDICAPPED ACCESSIBILITY IS REQUIRED, INCLUDING, BUT NOT LIMITED TO: ALL, DOORS, BATHROOMS, CONTROLS, ALARMS, SIGNAGE, TELEPHONES, EXTERIOR EXITS, ETC.

SPECIAL PERMIT

SITE PLAN AND SPECIAL USE PERMIT FOR THE CONVERSION OF THE GROUND FLOOR OF AN EXISTING OFFICE BUILDING INTO A PLACE OF WORSHIP IN THE C-2 DOWNTOWN BUSINESS DISTRICT AT 26-34 WALL ST. APPROVED 12/20/2022 BY THE CITY OF BINGHAMTON PLANNING DEPARTMENT.

CODE & ZONING NOTES

30 WALL STREET, BINGHAMTON NY, 13901 BLOCK 2; LOT 1 & 4

ZONING DISTRICT C-2.

OCCUPANCY: A-3 - PLACE OF WORSHIP, PLACE OF ASSEMBLY

B - OFFICES E - EDUCATION R-1 - HOSPITALITY

R-2 - RESIDENTIAL

MAXIMUM OCCUPANTS: 3,442 SF DIVIDED BY 15 SF PER PERSON = 229

OCCUPANTS (FOR SOCIAL HALL)

TYPE OF CONSTRUCTION: INCOMBUSTIBLE CMU WALL & STEEL

CMU WALLS WITH METAL PANEL CLADDING

INTERIOR FINISH: STEEL STUDS WITH GYP WB EXISTING CONCRETE **EXISTING STEEL ROOFING TRUSS**

APPLICABLE CODES: 2020 BUILDING CODES OF NEW YORK STATE, 2020 ENERGY CONSERVATION CONSTRUCTION CODE OF NEW YORK STATE, 2020 PLUMBING CODE OF NEW YORK STATE

BUILDING HEIGHT: 37'-8". 2 STORIES

LOT AREA: 32,671 SF

FLOOR:

EXISTING BUILDING FLOOR AREA: CELLAR:

6,556 SF 1ST FLOOR: 15,435 SF 2ND FLOOR: 15.597 SF TOTAL AREA (EXCL. CELLAR): 30,932 SF

PROPOSED BUILDING FLOOR AREA CELLAR: 6,556 SF

1ST FLOOR: 15,435 SF 2ND FLOOR: 15,597 SF TOTAL AREA (EXCL. CELLAR): 30,932 SF

CONSTRUCTION CLASSIFICATION: TYPE IIA, PROTECTED NON COMBUSTIBLE. 1HR RATED EXTERIOR WALLS, FLOOR, AND ROOF, INTERIOR STRUCTURAL SUPPORT

	wo	C/U	LA	٧.	SHOWER	DRINKING FOUNTAIN	UTILITY SINK
CELLAR	M/W		M & W				
1ST FLOOR							
REQUIRED - A3 1/125 1/65 1 2			1/200 2		-	1	1
PROPOSED	5	4	4	4		1	1
REQUIRED - B	1/25	= 1		1	1	-	
PROPOSED	INC	INCLUDED IN A3 OCCUPANCY					
REQUIRED - R1	REQUIRED - R1 3 3 PROPOSED - R1 5 11 REQUIRED - R3 1 1 PROPOSED - R3 3 3		3		3	-	
PROPOSED - R1			5		1		
REQUIRED - R3			1		1	-	1
PROPOSED - R3			3		3		
2ND FLOOR						•	
REQUIRED	3		3		-	1	
PROPOSED	3		3			1	

ADDITIONAL BLDG. NOTES

ADDRESS:30 WALL STREET, BINGHAMTON, NY 13901

BLOCK NO.:#2

LOT NO.:1 & 4

ZONING MAP NO.:CITY OF BINGHAMTON OFFICIAL ZONING MAP (UPDATED 2008)

ZONING DISTRICT: C-2 DOWNTOWN BUSINESS

SPECIAL USE PERMIT:DECEMBER 20, 2022 SITE PLAN REVIEW AND SPECIAL USE PERMIT APPROVED BY CITY OF BINGHAMTON PLANNING DEPARTMENT FOR THE CONVERSION OF THE GROUND FLOOR OF EXISTING OFFICE BUILDING INTO A PLACE OF WORSHIP AT 26-34 WALL ST.

LOT AREA:32,671 SQ FT.

HEIGHT TO ROOF:EXISTING HEIGHT IS 37'-8"

NO. OF FLOORS:TWO (2)

S. F. BY FLOOR: CELLAR: 6,556 SQ. FT. 1ST FLOOR: 15,543 SQ. FT.

2ND FLOOR: 15,597 SQ. FT. NO CHANGE TO FLOOR AREA PROPOSED.

TOTAL GROSS FLOOR AREA:30,932 SQ. FT. (EXCLUDING CELLAR)

SIDEWALK VAULT: NO VAULT. PARTIAL CELLAR.

FIFIELD PIAKER ELMAN ARCHITECTS, PC

740 Broadway, Suite 601 New York, NY 10003 tel 212 979 9272 www.fpe-architects.com

NO USE, REPRODUCTION OR DISSEMINATION MAY BE MADE OF THIS DRAWING & CONCEPTS SET FORTH HEREON WITHOUT THE PRIOR WRITTEN CONSENT OF

FIFIELD PIAKER ELMAN ARCHITECTS P.C. COPYRIGHT (C) 2024

CHABAD DOWNTOWN

30 WALL STREET BINGHAMTON, NY 13901

03 BID SFT 02 100% SUBMISSION No: Description: Date: Revisions:


Job No: 2022037.00 **AS SHOWN** Scale: 01/28/25 Date:

Drawn:

CE

COVER SHEET

Sheet Title:

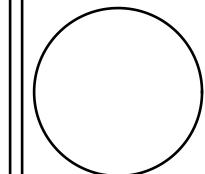

Drawing No.:

DRAWING LISTS

ARCHITECTURAL: COVER SHEET GENERAL NOTES DRAWING LISTS & FLOOD PLAN G-003 ADA DIAGRAMS G-004 FIRST FLOOR EGRESS PLAN

DM-001 SITE DEMOLITION PLAN DM-100 CELLAR DEMOLITION PLAN FIRST FLOOR DEMOLITION PLAN DM-101 SECOND FLOOR DEMOLITION PLAN DM-102 DM-103 ROOF DEMOLITION PLAN DM-201

N. DEMOLITION ELEVATION DM-202 E. DEMOLITION ELEVATION DM-203 W. DEMOLITION ELEVATION A-001 A-002 PARKING LOT PLAN

A-100 CELLAR PLAN A-101 FIRST FLOOR PLAN SECOND FLOOR PLAN A-103 **ROOF PLAN** A-201 N. ELEVATION A-202 E. ELEVATION A-203 W. ELEVATION

A-210 SECTION LOOKING NORTH A-211 SECTION LOOKING WEST A-220 STOREFRONT DETAILS **EXTERIOR WALL DETAILS** A-221 STOREFRONT AND CANOPY DETAILS A-223 PATIO AND SIDEWALK DETAILS A-224 LOADING DOCK CANOPY DETAILS

A-400 CELLAR RCP A-401 FIRST FLOOR RCP A-500 PARSONAGE STAIR DETAILS A-501 PARSONAGE LOFT FRAMING DETAILS A-502 STAIR C DETAILS

TYPICAL DETAILS A-600 A-601 DOOR SCHEDULES AND DETAILS DOOR, FRAME, AND SADDLE TYPES A-603 WINDOW SCHEDULE AND DETAILS A-604 COVE DETAILS A-605 MIKVAH DETAILS

A-606 MIKVAH SECTIONS A-700 CELLAR ELECTRICAL PLAN A-701 FIRST FLOOR ELECTRICAL PLAN LIGHTING AND FINISH SCHEDULES A-900

STRUCTURAL:

STRUCTURAL NOTES S-100 STRUCTURAL PATIO FOUNDATION, FRAMING, SECTIONS &

STRUCTURAL CANOPY FRAMING, PLAN, SECTIONS & DETAILS STRUCTURAL FIRST FLOOR FRAMING, SECTIONS & DETAILS S-102

MECHANICAL:

HVAC NOTES AND SYMBOLS M-100 ROOF HVAC DEMOLITION PLAN M-200 FIRST FLOOR HVAC PLAN FIRST FLOOR HVAC PIPING PLAN M-201 M-202 ROOF HVAC PLAN HVAC SCHEDULES-I M-601 HVAC SCHEDULES-II M-700 **HVAC DETAILS-I HVAC DETAILS-II** M-702 HVAC DETAILS-III M-800 HVAC SCHEDULES-M-801 HVAC SCHEDULES-II

HVAC SCHEDULES-III

ELECTRICAL:

M-802

ELECTRICAL NOTES, SYMBOLS & ABBREVIATIONS CELLAR ELECTRICAL DEMOLITION POWER PLAN FIRST FLOOR ELECTRICAL POWER PLAN E-200 E-201 ROOF ELECTRICAL POWER PLAN FIRST FLOOR ELECTRICAL LIGHTING PLAN ELECTRICAL POWER PART PLANS ELECTRICAL RISER DIAGRAM ELECTRICAL PANEL SCHEDULES I ELECTRICAL PANEL SCHEDULES II E-700 ELECTRICAL DETAILS I ELECTRICAL DETAILS II E-800 ELECTRICAL SPECIFICATIONS I E-801 ELECTRICAL SPECIFICATIONS II

PLUMBING:

PLUMBING COVER SHEET PLUMBING CELLAR FLOOR PLAN PLUMBING FIRST FLOOR PLAN P-201 PLUMBING ROOF PLAN P-500 PLUMBING RISER DIAGRAMS P-600 PLUMBING SCHEDULES P-700 PLUMBING DETAILS P-701 PLUMBING DETAILS II P-800 PLUMBING SPECIFICATIONS PLUMBING SPECIFICATIONS II P-801 P-802 PLUMBING SPECIFICATIONS III

SPRINKLER:

SP-001 SPRINKLER COVER SHEET SPRINKLER FIRST FLOOR PLAN SP-200 SP-700 SPRINKLER DETAILS SP-800 SPRINKLER SPECIFICATIONS I SP-801 SPRINKLER SPECIFICATIONS II

FIRE ALARM:

FIRE ALARM NOTES, SYMBOL LIST, RISER DIAGRAM FA-200 FIRST FLOOR FIRE ALARM PLAN FA-800 FIRE ALARM SPECIFICATIONS I FA-801 FIRE ALARM SPECIFICATIONS II

DESIGN:

A-23

A-24

A-25

A-26

A-27

A-28

A-29

A-30

A-31

A-32

A-33

A-34

A-35

A-36

A-37

A-38

A-39

A-42

A-43

A-45

A-46

A-47

A-48

A-50

A-51

A-52

A-55

A-56

A-56.2

A-59

A-00 A-01 FURNITURE AND PLUMBING SCHEDULES A-01.2 WALL, FLOORING, LIGHTING, AND FINISH SCHEDULES FIRST FLOOR PLAN A-02 A-02.2 REFLECTED CEILING PLAN A-03 PROPOSED LOBBY PLAN A-04 PROPOSED LOBBY ELEVATIONS A-05 PROPOSED SOCIAL HALL PLANS A-06 PROPOSED SOCIAL HALL PLANS

A-07 PROPOSED SOCIAL HALL PLANS A-08 PROPOSED SOCIAL HALL ELEVATIONS PROPOSED CORRIDOR FLOOR PLAN A-09 A-10 PROPOSED CORRIDOR FLOOR PLAN PROPOSED CORRIDOR ELEVATIONS A-11 A-12 PROPOSED CORRIDOR FLOOR PLAN A-13 PROPOSED CORRIDOR ELEVATIONS A-14 PROPOSED CORRIDOR ELEVATIONS A-15 PROPOSED CORRIDOR ELEVATIONS

A-16 PROPOSED MIKVAH FLOOR PLAN A-17 PROPOSED MIKVAH ELEVATIONS A-18 PROPOSED MIKVAH BATHROOM FLOOR PLAN A-19 PROPOSED MIKVAH BATHROOM ELEVATIONS PROPOSED MIKVAH VESTIBULE FLOOR PLAN A-20 PROPOSED MIKVAH VESTIBULE ELEVATIONS A-21 A-22

PROPOSED LIBRARY FLOOR PLAN PROPOSED LIBRARY ELEVATIONS PROPOSED PROGRAMMING FLOOR PLAN PROPOSED PROGRAMMING ELEVATIONS PROPOSED WOMEN'S RESTROOM FLOOR PLAN

PROPOSED WOMEN'S RESTROOM ELEVATIONS PROPOSED MEN'S RESTROOM FLOOR PLAN PROPOSED MEN'S RESTROOM ELEVATIONS PROPOSED RESTROOM 1 FLOOR PLAN PROPOSED RESTROOM 1 ELEVATIONS PROPOSED RESTROOM 2 FLOOR PLAN

PROPOSED RESTROOM 2 ELEVATIONS PROPOSED RECEPTION FLOOR PLAN PROPOSED RECEPTION ELEVATIONS PROPOSED OFFICE 1 FLOOR PLAN PROPOSED OFFICE 1 ELEVATIONS

PROPOSED OFFICE 2 FLOOR PLAN PROPOSED OFFICE 2 ELEVATIONS PROPOSED CONFERENCE FLOOR PLAN PROPOSED CONFERENCE ELEVATIONS PROPOSED MASTER BEDROOM FLOOR PLAN

PROPOSED MASTER BEDROOM ELEVATIONS PROPOSED MASTER BATHROOM FLOOR PLAN PROPOSED MASTER BATHROOM ELEVATIONS

PROPOSED BATHROOM 2 FLOOR PLAN PROPOSED BATHROOM 2 ELEVATIONS PROPOSED POWDER ROOM FLOOR PLAN PROPOSED POWDER ROOM ELEVATIONS PROPOSED SUITE FULL FLOOR PLAN PROPOSED RAVE SUITE ELEVATIONS PROPOSED RAVE SUITE ELEVATIONS

PROPOSED UPSTAIRS FLOOR PLAI PROPOSED UPSTAIRS ELEVATIONS PROPOSED SUITE 2 FULL SIZE FLOOR PLAN PROPOSED SUITE 2 FULL SIZE ELEVATIONS PROPOSED SUITE 3 FILL SIZE FLOOR PLAN PROPOSED SUITE BATHROOM FLOOR PLAN PROPOSED SUITE BATHROOM ELEVATIONS PROPOSED SUITE 1 - TWIN SIZE FLOOR PLAN

A-60 PROPOSED SUITE 1 - TWIN SIZE ELEVATIONS A-60.2 PROPOSED SUITE 4 - TWIN SIZE FLOOR PLAN A-60.3 PROPOSED SUITE 5 - TWIN SIZE FLOOR PLAN A-61 PROPOSED COFFEE ROOM FLOOR PLAN A-62 PROPOSED COFFEE ROOM ELEVATIONS PROPOSED KITCHEN PASSOVER FLOOR PLAN A-63 PROPOSED KITCHEN PASSOVER ELEVATIONS

PROPOSED MAIN KITCHEN A-66 CLASSROOM A-67 POSITIVITY SPACE A-68 RAV SUITE BEDROOM A-69 **RAV SUITE BEDROOM 2**

A-70 RAV SUITE BEDROOM 3 A-71 PROPOSED SUITE 5 ADA BATHROOM FLOOR PLAN A-72 PROPOSED SUITE 5 ADA BATHROOM ELEVATIONS

A-FC FACADE ELEVATIONS

CIVIL:

EXISTING SITE CONDITIONS C010 C050 DEMOLITION PLAN C100 LAYOUT PLAN C110 GRADING PLAN C130 LANDSCAPE PLAN C200 DETAILS C300 **SPECIFICATIONS**

NOTES TO USERS

This map is for use in administering the National Flood Insurance Program. It does not necessarily identify all areas subject to flooding, particularly from local drainage sources of small size. The **community map repository** should be

o obtain more detailed information in areas where Base Flood Elevation (BFEs) and/or **floodways** have been determined, users are encouraged to consult the Flood Profiles and Floodway Data and/or Summary of Stillwater Elevations tables contained within the Flood Insurance Study (Fl.S) report that accompanies this FIRM. Users should be aware that BFEs shown on the FIRM represent rounded whole-foot elevations. These BFEs are intended for flood insurant rating purposes only and should not be used as the sole source of floo elevation information. Accordingly, flood elevation data presented in the FI report should be utilized in conjunction with the FIRM for purposes

Coastal Base Flood Elevations shown on this map apply only landward be aware that coastal flood elevations are also provided in the Summary of illwater Elevations tables in the Flood Insurance Study report for this jurisdicti Elevations shown in the Summary of Stillwater Elevations tables should be used for construction and/or floodplain management purposes when they are higher than the elevations shown on this FIRM.

Boundaries of the floodways were computed at cross sections and interpolated between cross sections. The floodways were based on hydraulic considerations with regard to requirements of the National Flood Insurance Program. Floodway widths and other pertinent floodway data are provided in the Flood Insurance Certain areas not in Special Flood Hazard Areas may be protected by **flood control structures**. Refer to Section 2.4 "Flood Protection Measures" of the

Flood Insurance Study report for information on flood control structures for this

The **projection** used in the preparation of this map was New York State Plane IPSZONE 3102. The horizontal datum was NAD 83. GRS80 spheroid Differences in datum, spheroid, projection or State Plane zones used in the production of FIRMs for adjacent jurisdictions may result in slight positional differences in map features across jurisdiction boundaries. These differences do

Flood elevations on this map are referenced to the North American Vertical Datun of 1988. These flood elevations must be compared to structure and groun elevations referenced to the same vertical datum. For information regarding conversion between the National Geodetic Vertical Datum of 1929 and the North American Vertical Datum of 1988, visit the National Geodetic Surve rebsite at http://www.ngs.noaa.gov or contact the National Geodetic Survey a

NGS Information Services NOAA, N/NGS12 National Geodetic Survey SSMC-3, #9202 Silver Spring, Maryland 20910-3282

> To obtain current elevation, description, and/or location information for **benchmarks** shown on this map, please contact the Information Services Branch of the National Geodetic Survey at (301) 713-3242, or visit its website a

Base map information shown on this FIRM was derived from digital orthophotography provided by the New York Office of Cyber Security & Critical Infrastructure Coordination. This information was provided as 12-inch and 24-inch

Based on updated topographic information, this map reflects more detailed an up-to-date stream channel configurations and floodplain delineations than those shown on the previous FIRM for this jurisdiction. As a result, the Flood Profiles and Floodway Data tables in the Flood Insurance Study Report (which contains authoritative hydraulic data) may reflect stream channel distances that differ from what is shown on this map. Also, the road to floodplain relationships for unrevised streams may differ from what is shown on previous maps.

Corporate limits shown on this map are based on the best data available at the

time of publication. Because changes due to annexations or de-annexations may have occurred after this map was published, map users should contact appropriate ommunity officials to verify current corporate limit locations Please refer to the separately printed Man Index for an overview man of the county showing the layout of map panels; community map repository addresses; and a Listing of Communities table containing National Flood Insurance Program dates for each community as well as a listing of the panels on which each

available products associated with this FIRM. Available products may include previously issued Letters of Map Change, a Flood Insurance Study report, and/or digital versions of this map. The FEMA Map Service Center may also be reached If you have **questions about this map** or questions concerning the National Floor Insurance Program in general, please call **1-877-FEMA MAP** (1-877-336-2627) or

visit the FEMA website at http://www.fema.gov/business/nfip.

Contact the FEMA Map Service Center at 1-800-358-9616 for information of



LEGEND

SPECIAL FLOOD HAZARD AREAS SUBJECT TO INUNDATION BY THE 1% ANNUAL CHANCE FLOOD The 1% annual flood (100-year flood), also known as the base flood, is the flood that has a 1% chance of being equaled or exceeded in any given year. The Special Flood Hazard Area is the area subject to flooding by the 1% annual chance flood. Areas of Special Flood Hazard include Zones A, AE, AH, AO, AR, A99, V, and VE. The Base Flood Elevation is the water-surface elevation of the 1% annual chance flood.

> No Base Flood Elevations determined. Base Flood Elevations determined.

Flood depths of 1 to 3 feet (usually areas of ponding); Base Flood Flood depths of 1 to 3 feet (usually sheet flow on sloping terrain); average depths determined. For areas of alluvial fan flooding, velocities also

Special Flood Hazard Area formerly protected from the 1% annual char

flood by a flood control system that was subsequently decertified. Zone AR indicates that the former flood control system is being restored to provide protection from the 1% annual chance or greater flood. Area to be protected from 1% annual chance flood by a Federal flood protection system under construction; no Base Flood Elevations Coastal flood zone with velocity hazard (wave action); no Base Flood

Coastal flood zone with velocity hazard (wave action); Base Flood FLOODWAY AREAS IN ZONE AE The floodway is the channel of a stream plus any adjacent floodplain areas that must be kept free of encroadment so that the 1% annual chance flood can be carried without substantial increases

OTHER FLOOD AREAS

Areas of 0.2% annual chance flood; areas of 1% annual chance flood with average depths of less than 1 foot or with drainage areas less than 1 square mile; and areas protected by levees from 1% annual chance flood. OTHER AREAS Areas determined to be outside the 0.2% annual chance floodplain. Areas in which flood hazards are undetermined, but possible.

COASTAL BARRIER RESOURCES SYSTEM (CBRS) AREAS OTHERWISE PROTECTED AREAS (OPAs) CBRS areas and OPAs are normally located within or adjacent to Special Flood Hazard Areas.

1% annual chance floodplain boundary 0.2% annual chance floodplain boundary Floodway boundary Zone D boundary

Boundary dividing Special Flood Hazard Area Zones and boundary dividing Special Flood Hazard Areas of different Flood Elevations, flood depths or flood velocities. Limit of Moderate Wave Action

513 Sase Flood Elevation line and value; elevation in feet* (EL 987) Base Flood Elevation value where uniform within zone; elevation * Referenced to the North American Vertical Datum of 1988 Cross section line


Transect line 87°07'45", 32°22'30" Geographic coordinates referenced to the North American Datum of 1983 (NAD 83), Western Hemisphere 1000-meter Universal Transverse Mercator grid ticks, zone 600000 FT


Bench mark (see explanation in Notes to Users section of this FIRM panel) DX5510 X ■ M1.5

MAP REPOSITORY Refer to listing of Map Repositories on Map Index

EFFECTIVE DATE(S) OF REVISION(S) TO THIS PANEL

To determine if flood insurance is available in this community, contact your Insurance agent or call the National Flood Insurance Program at 1-800-638-6620.

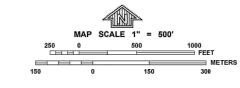

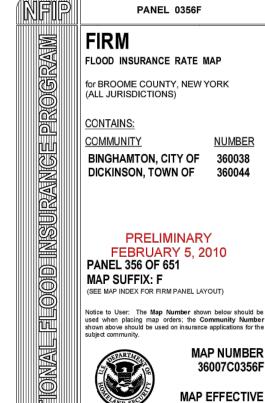

Federal Emergency Management Agency

30 WALL STREET BINGHAMTON NY, 13901

ZONE AE: SPECIAL FLOOD HAZARD AREAS SUBJECT TO INUNDATION BY THE 1% ANNUAL CHANCE FLOOD

2022037.00

AS SHOWN

01/28/25

CE





FIFIELD PIAKER ELMAN ARCHITECTS, PC

740 Broadway, Suite 601 New York, NY 10003 tel 212 979 9272 www.fpe-architects.com

NO USE, REPRODUCTION OR DISSEMINATION MAY BE MADE OF THIS DRAWING & CONCEPTS SET FORTH HEREON WITHOUT THE PRIOR WRITTEN CONSENT OF

FIFIELD PIAKER ELMAN ARCHITECTS P.C. COPYRIGHT (C) 2024

Project: CHABAD DOWNTOWN

30 WALL STREET

BINGHAMTON, NY 13901


Job No: Scale: Date: 02 100% SUBMISSION 5/01/25 98% SUBMISSION No: Description: Date: Drawn: Revisions:


DRAWING LISTS FLOOD PLAN


Sheet Title:


Drawing No.:


G-002

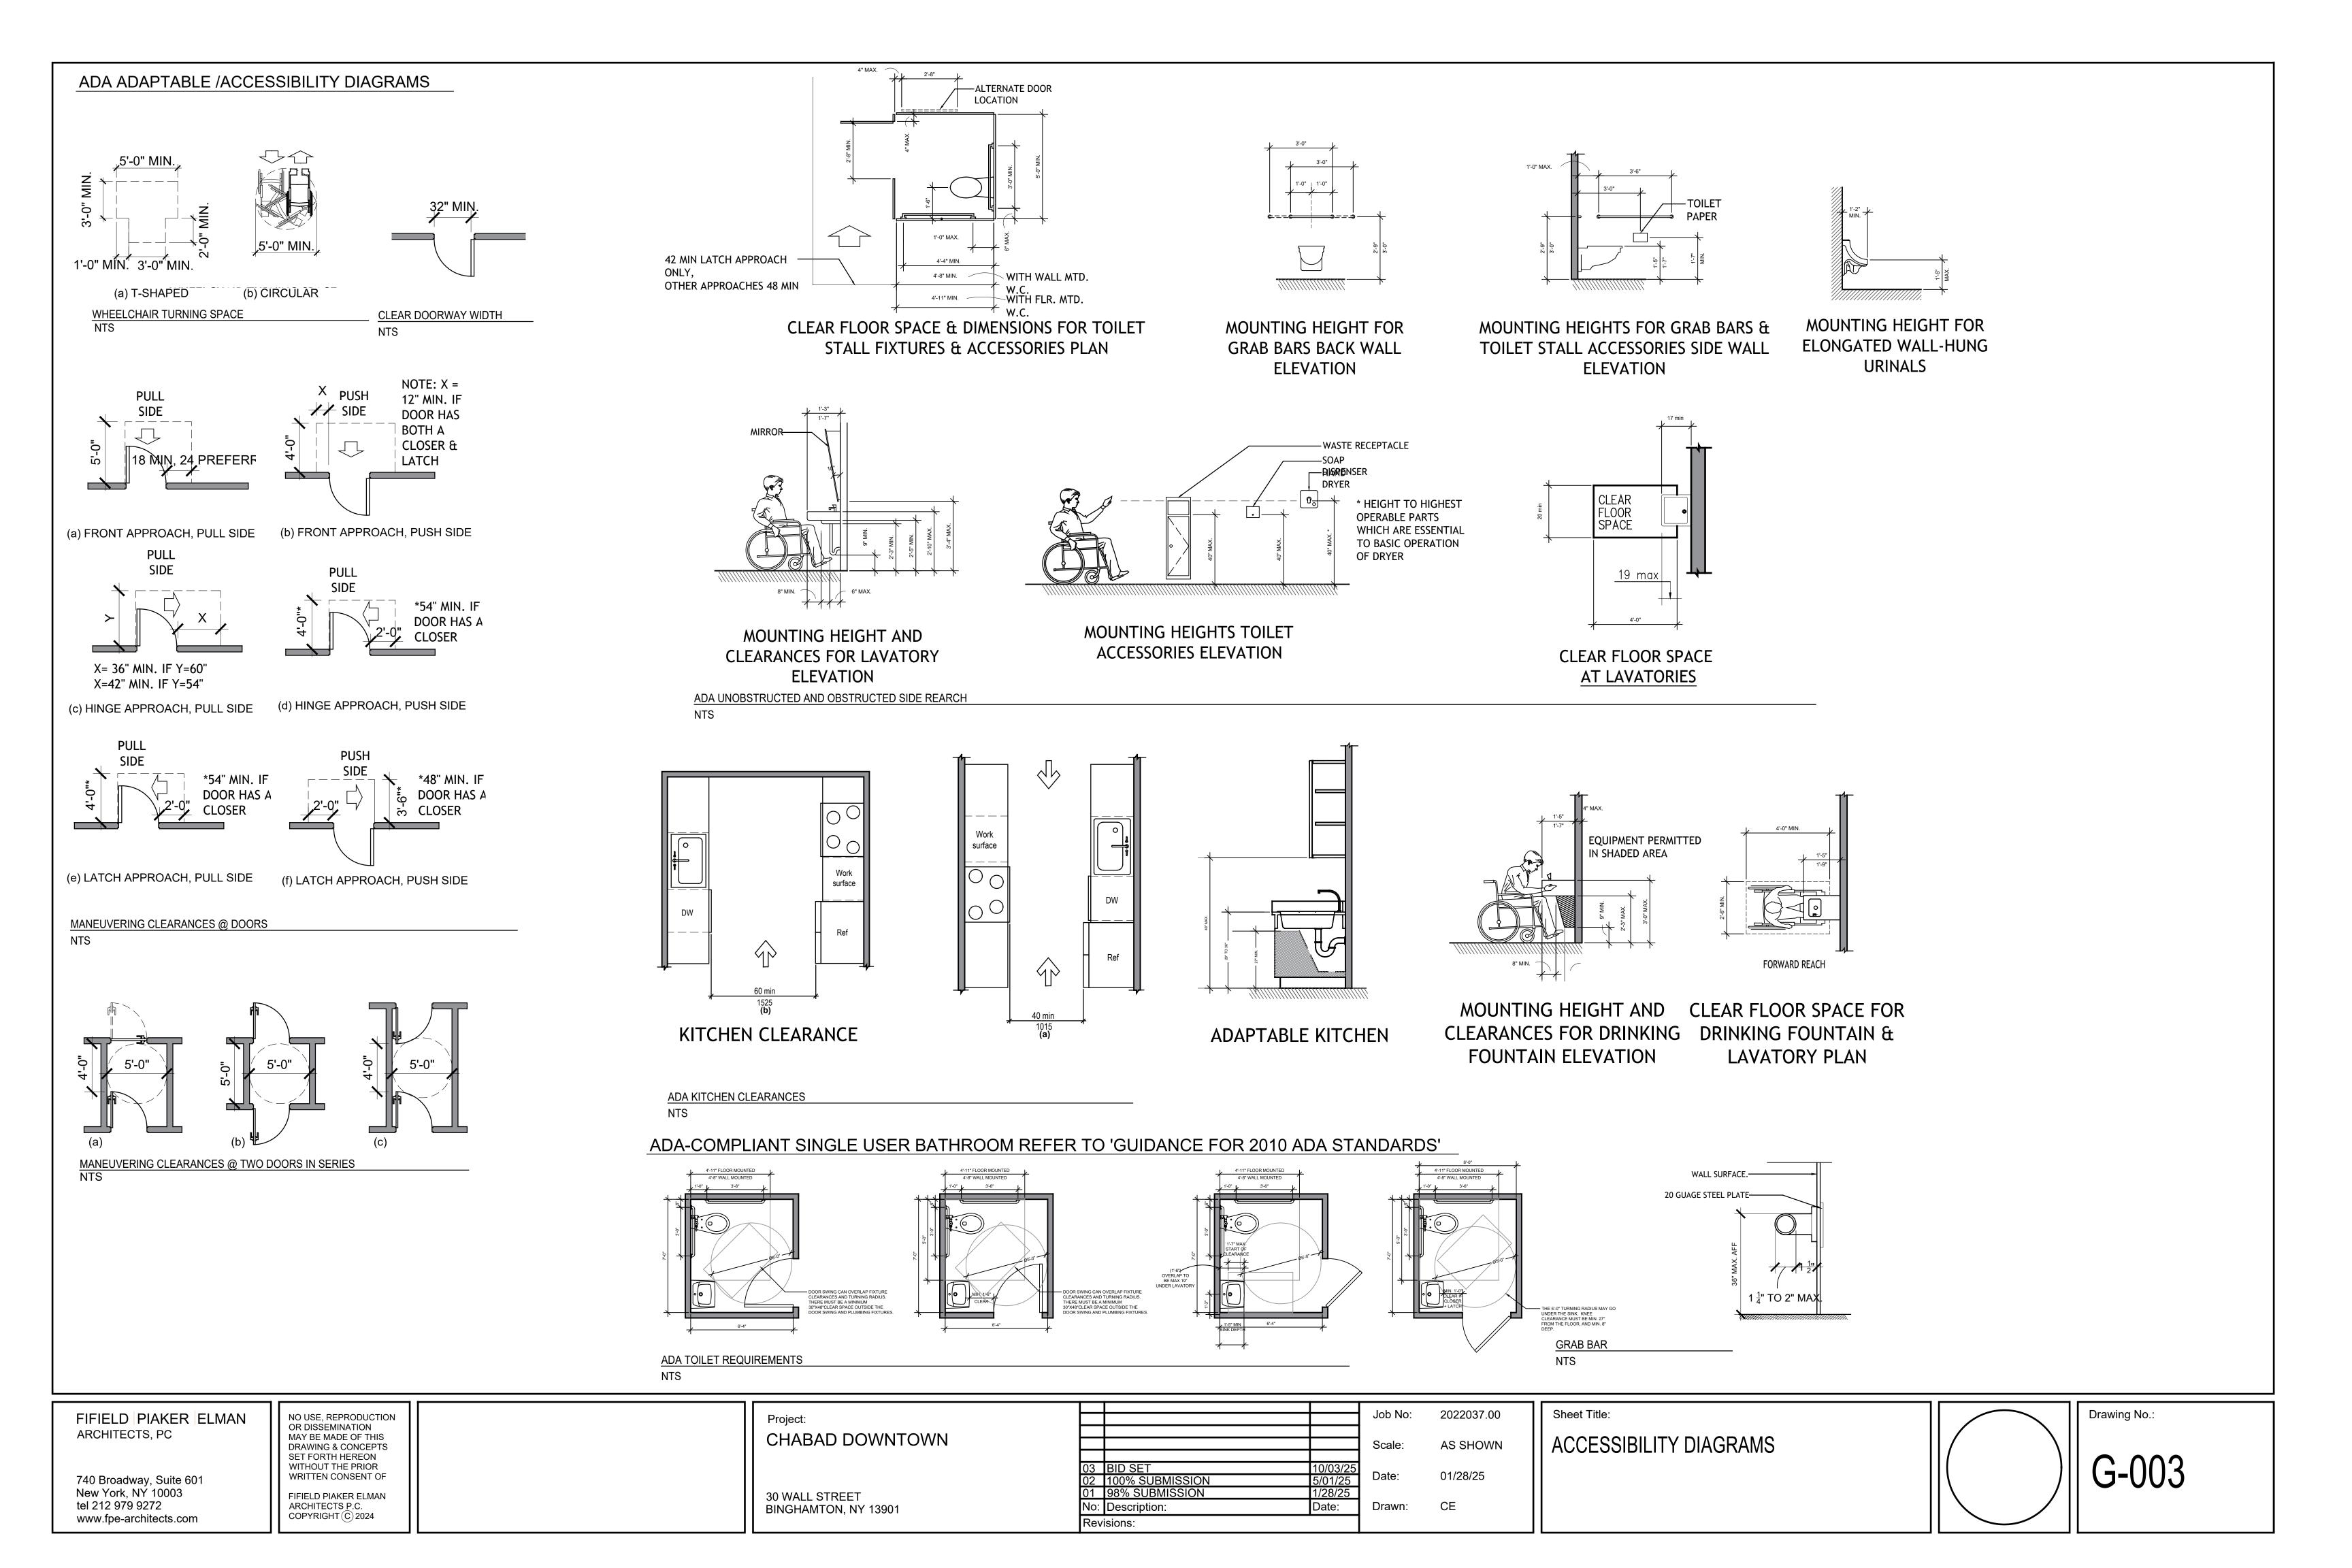


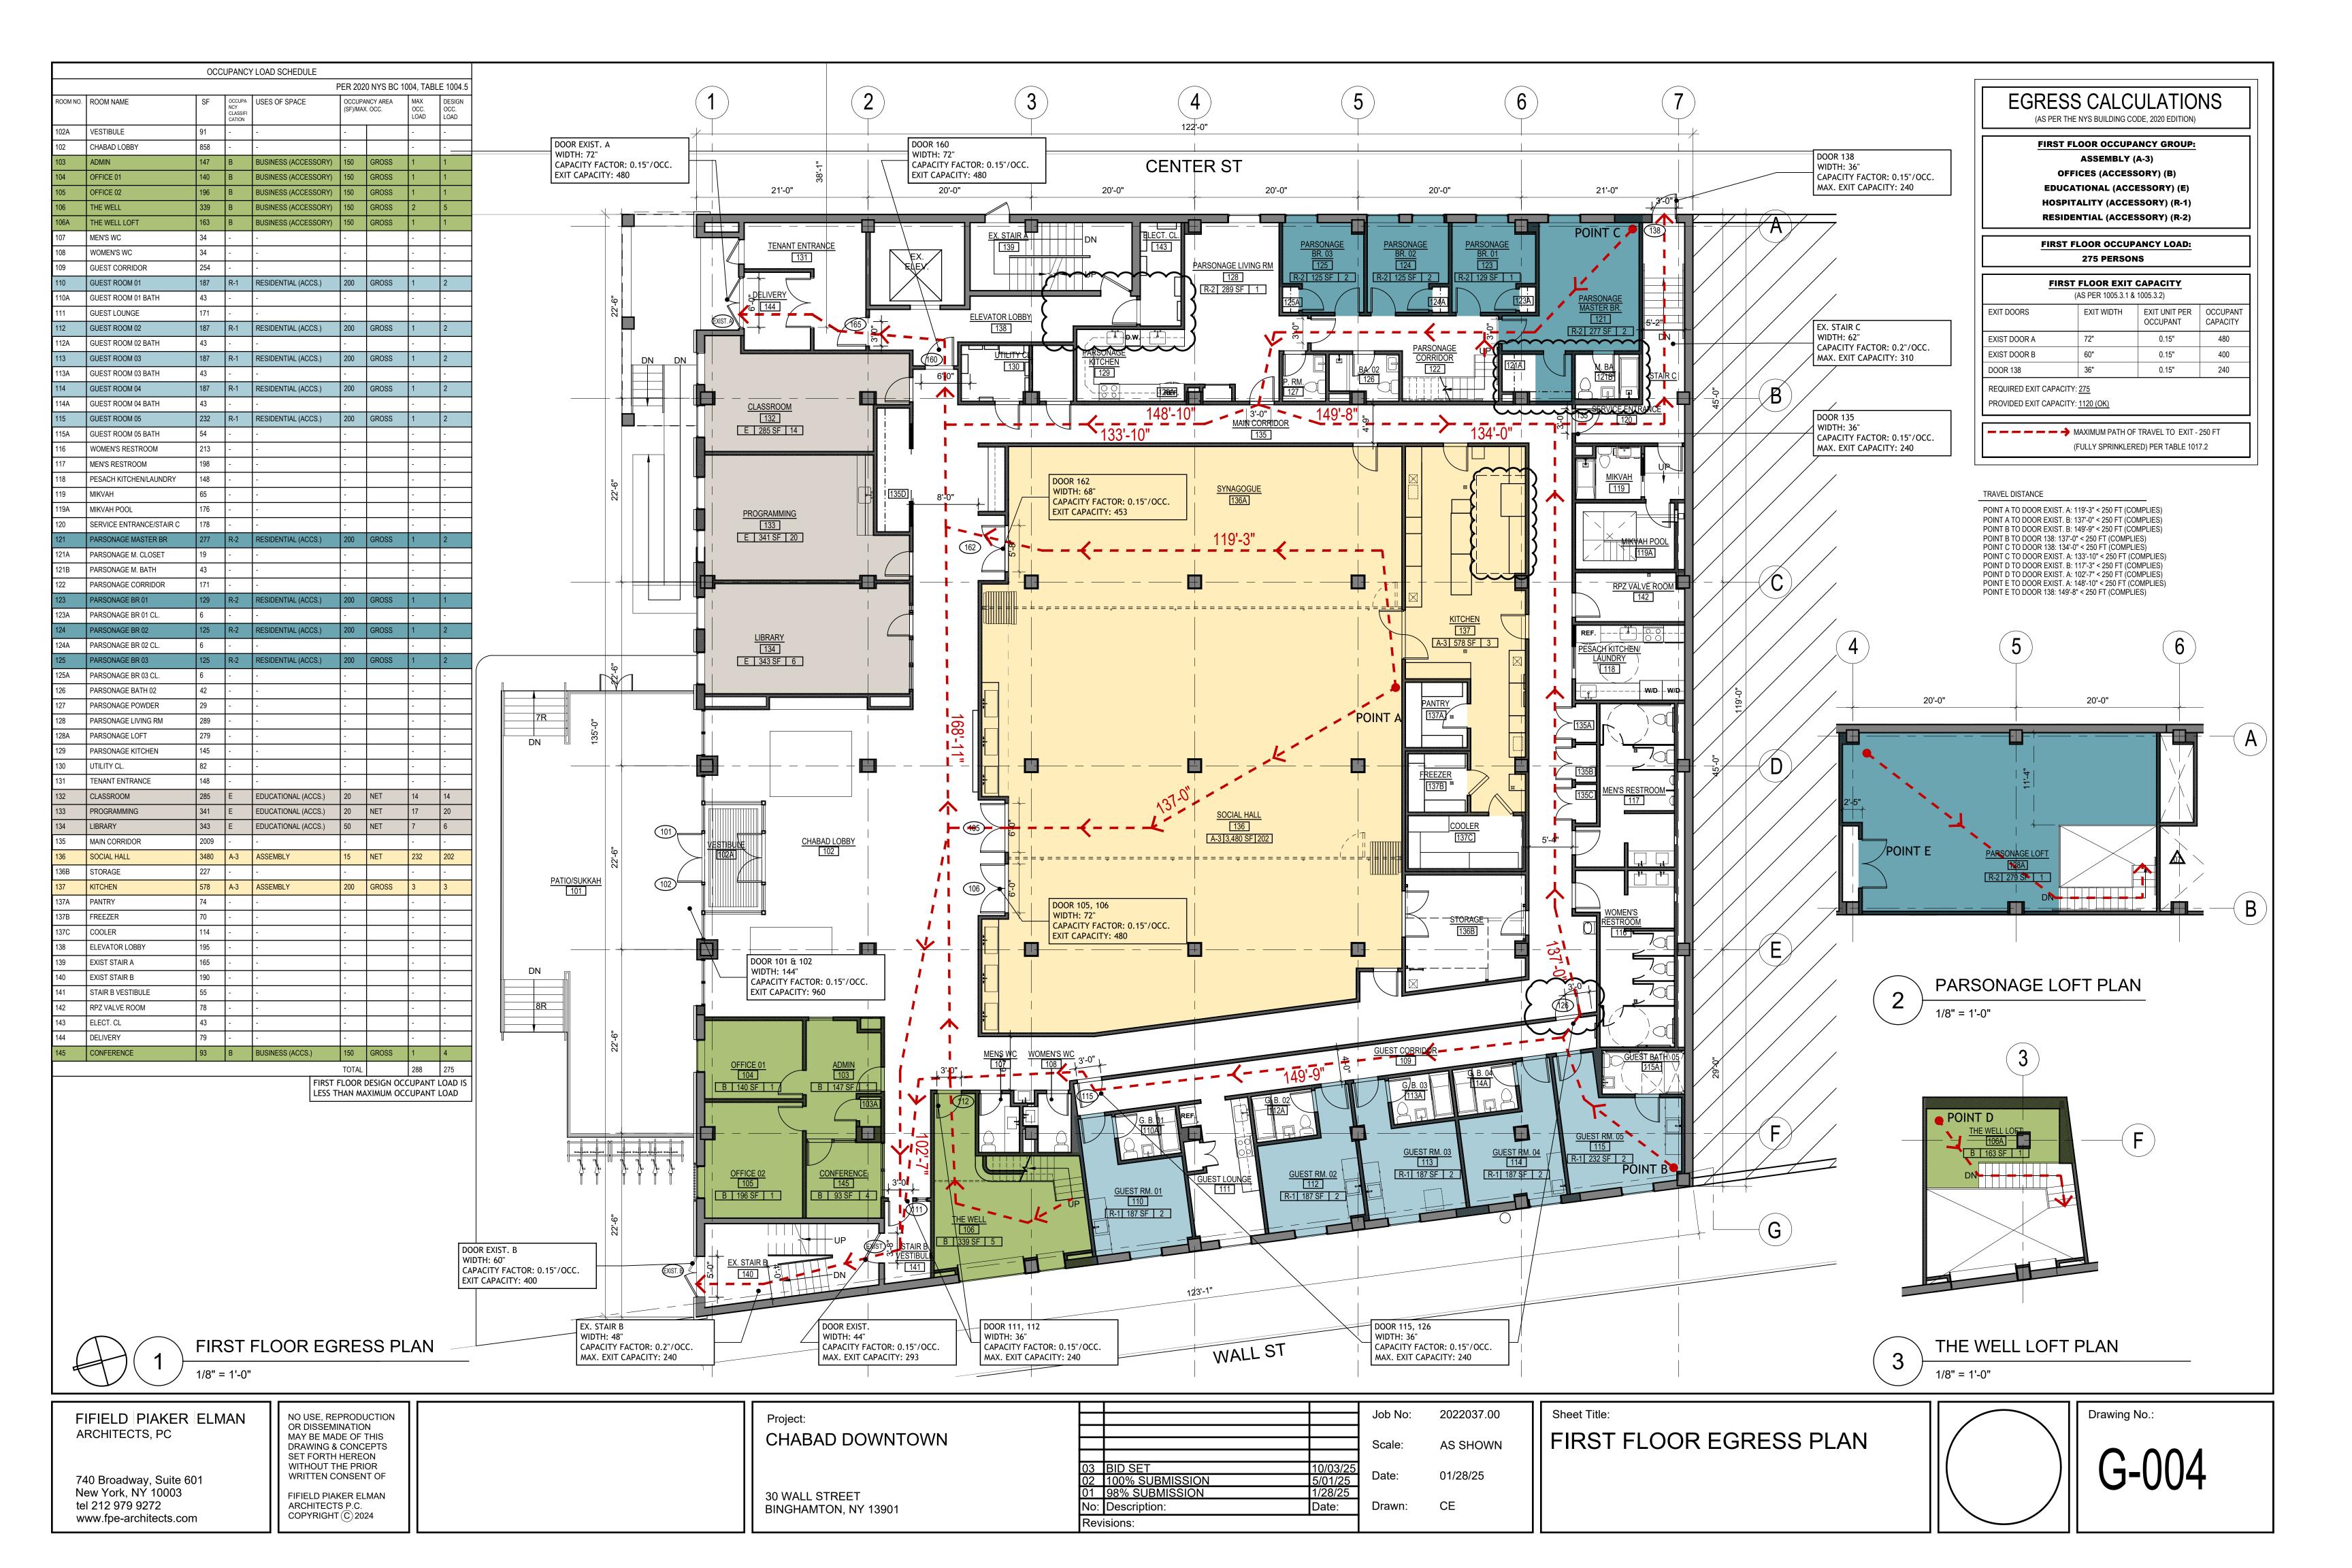


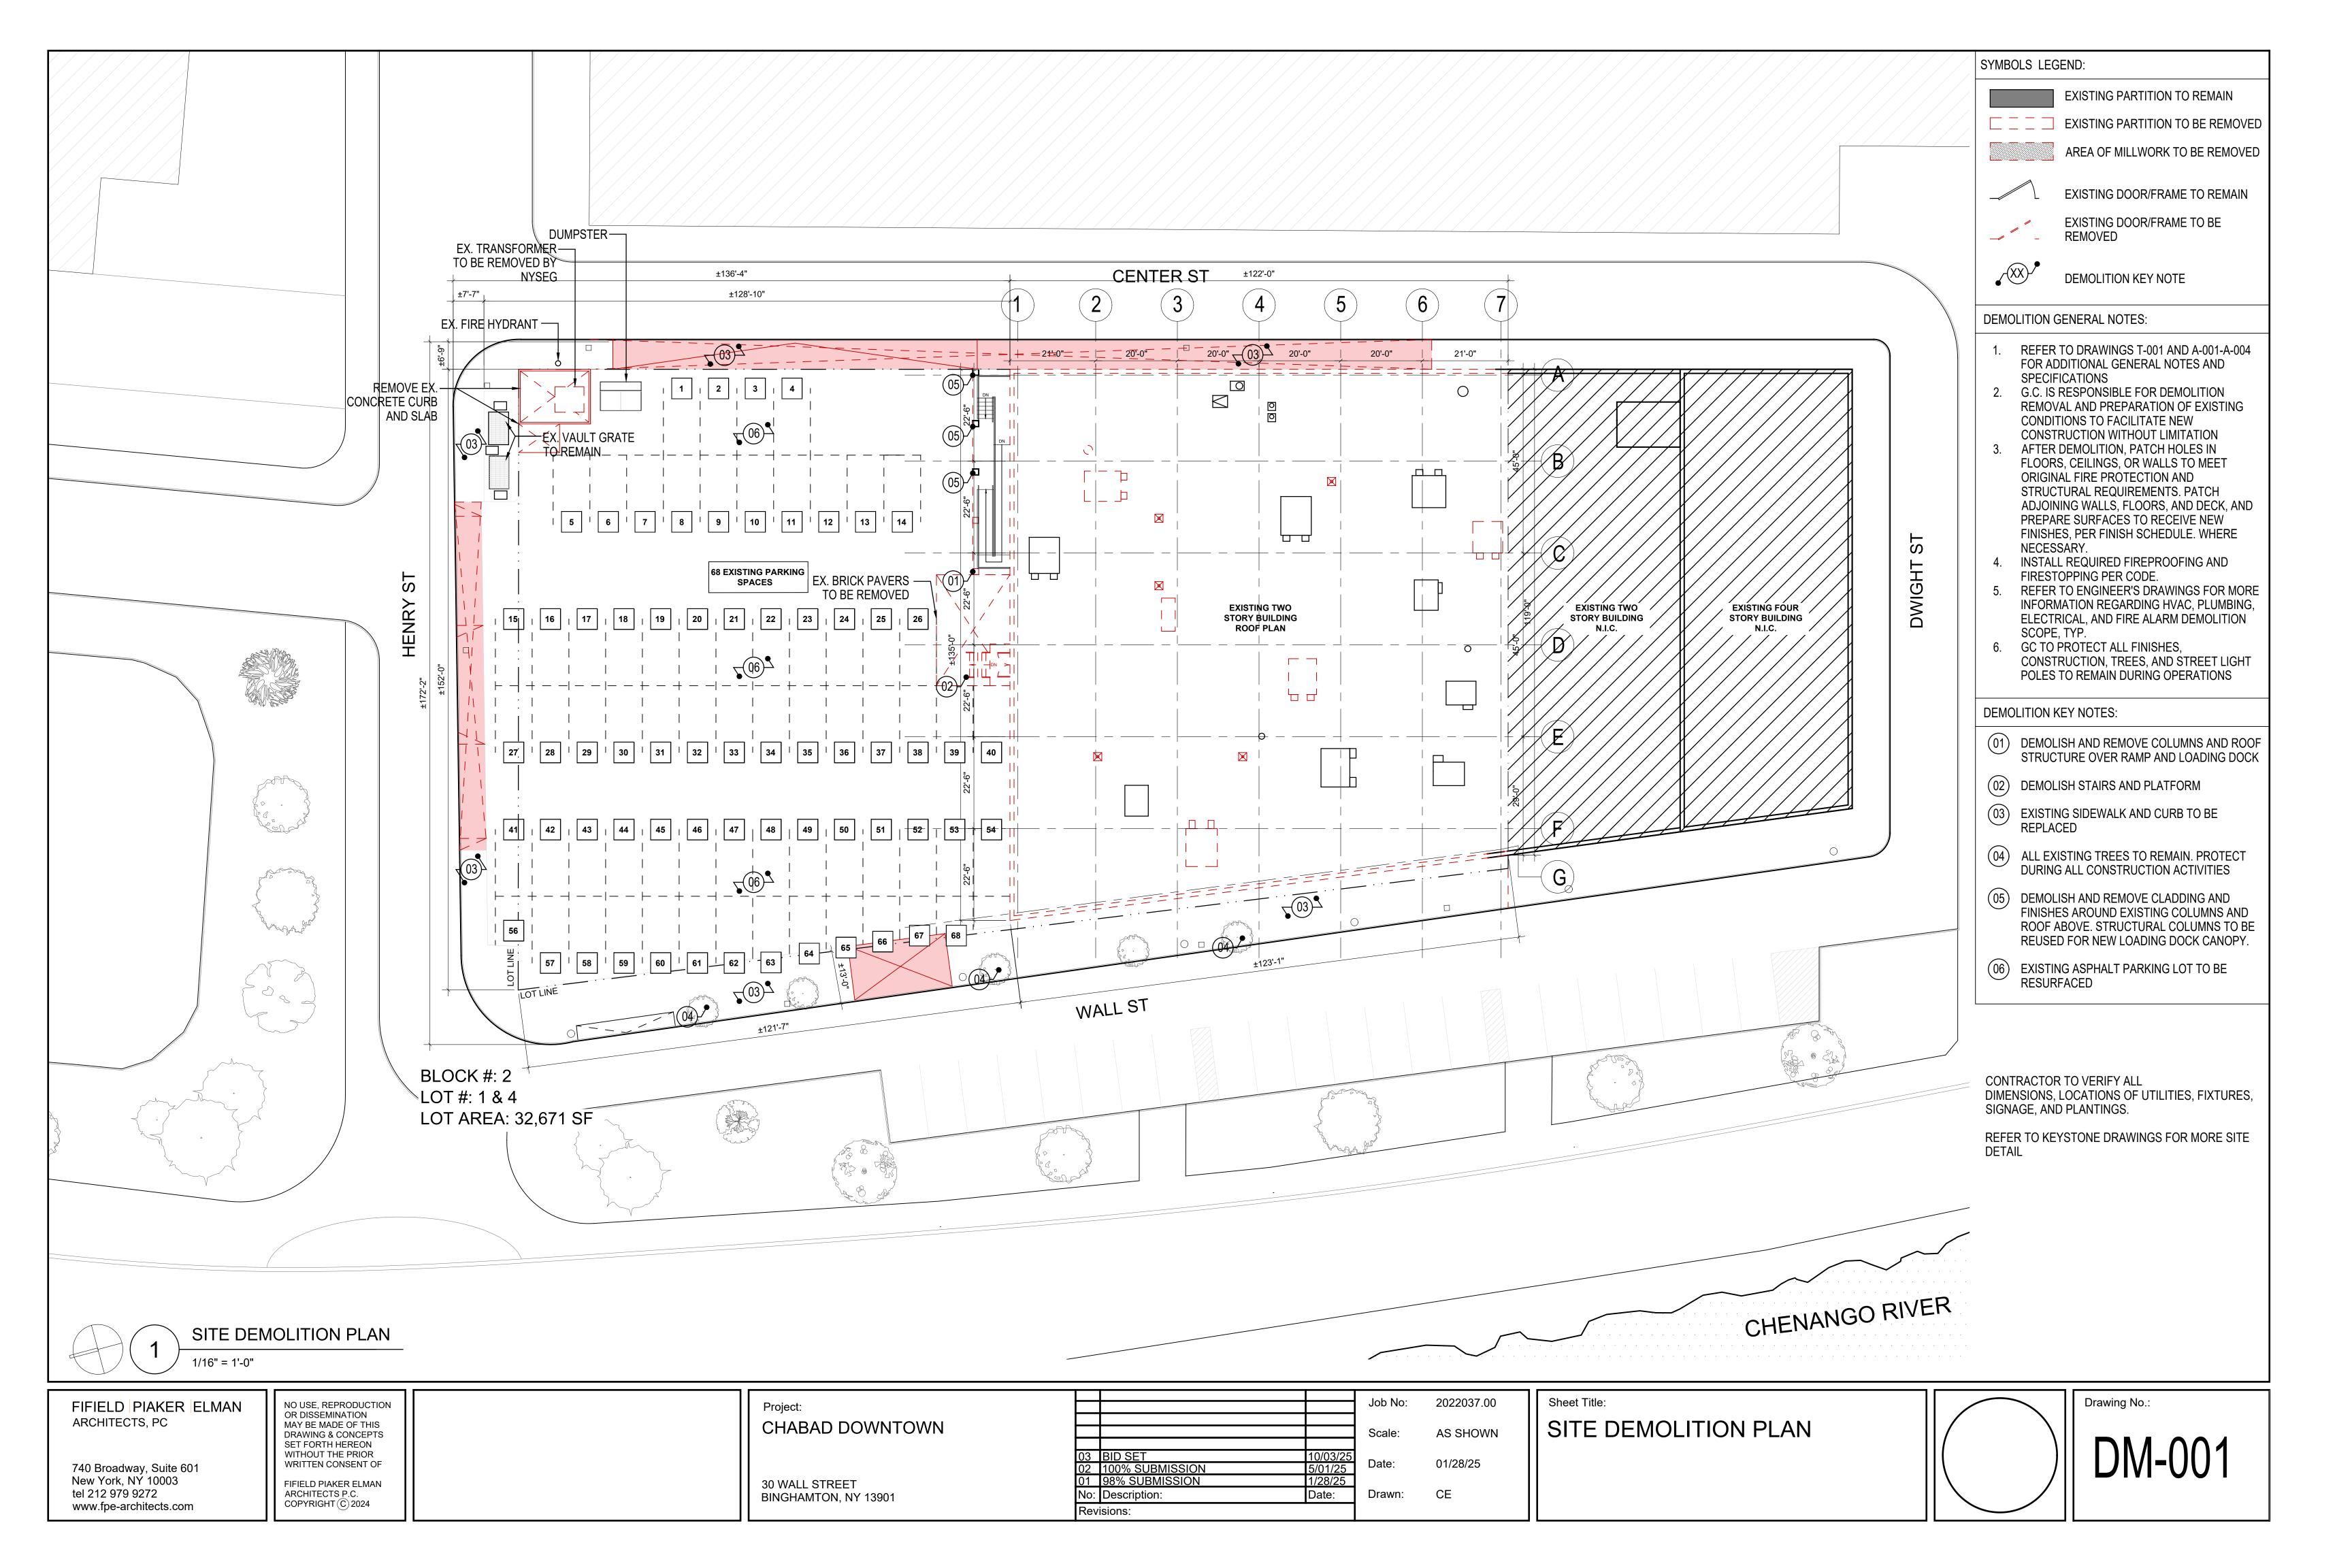


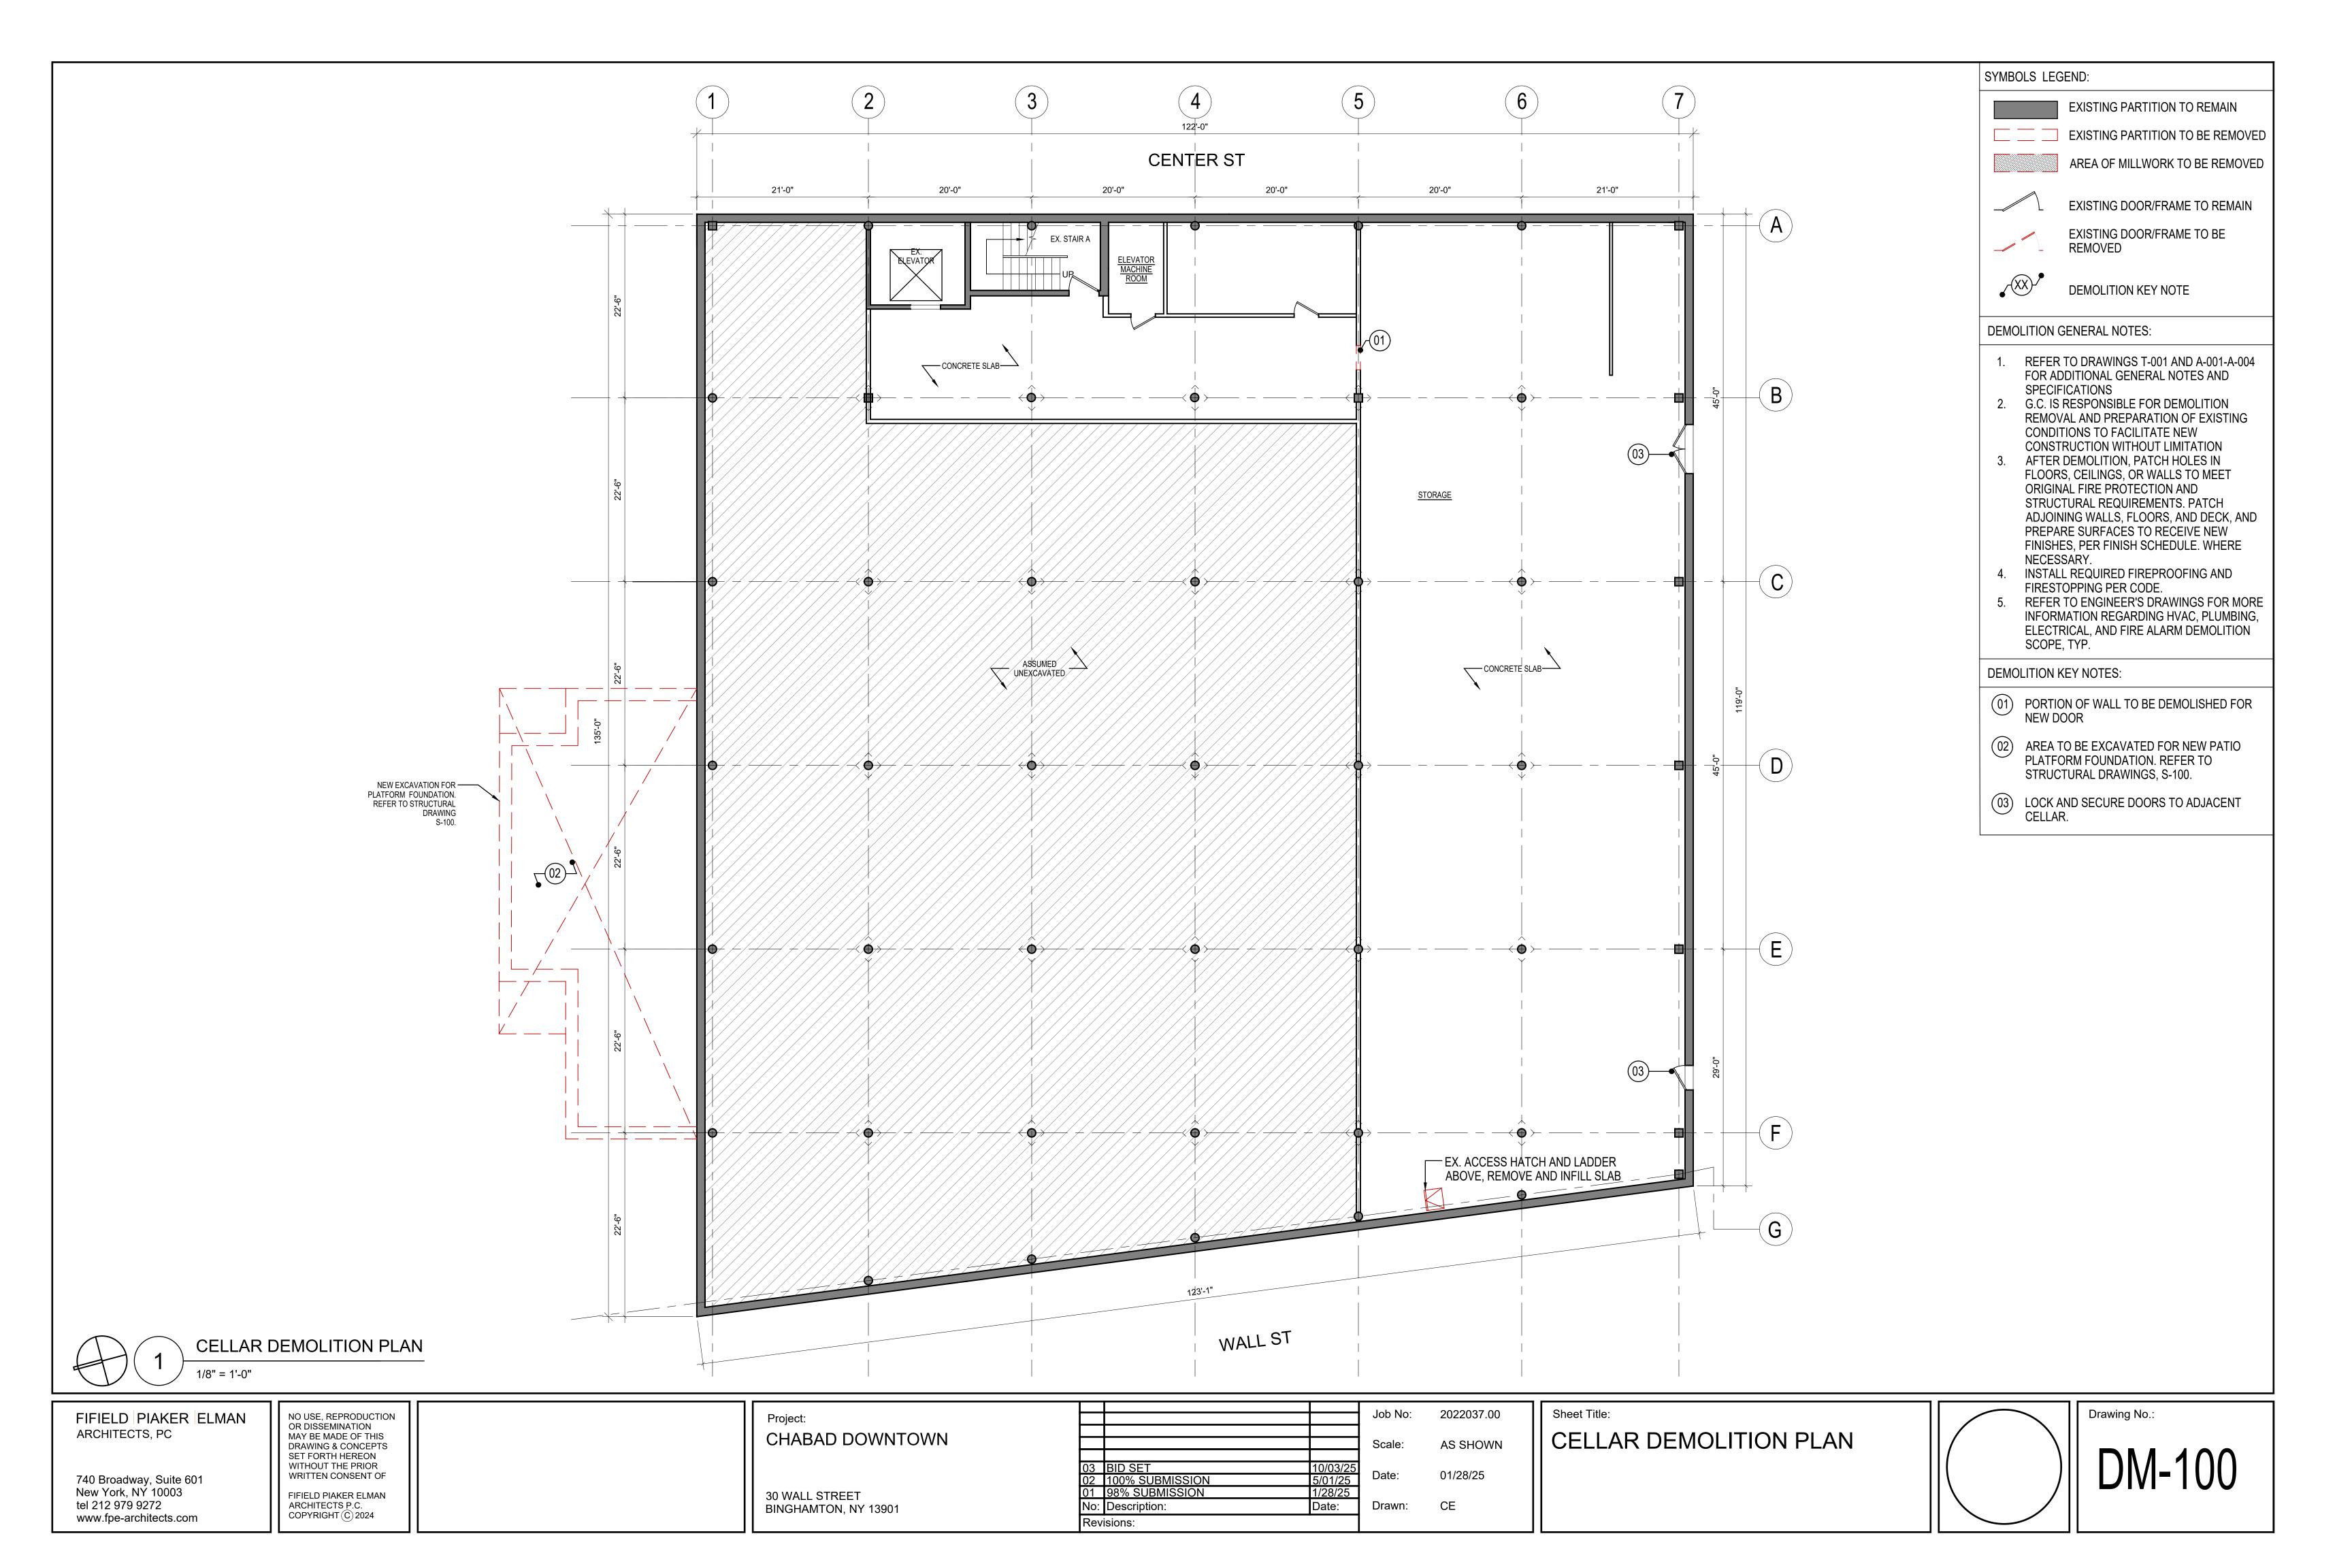

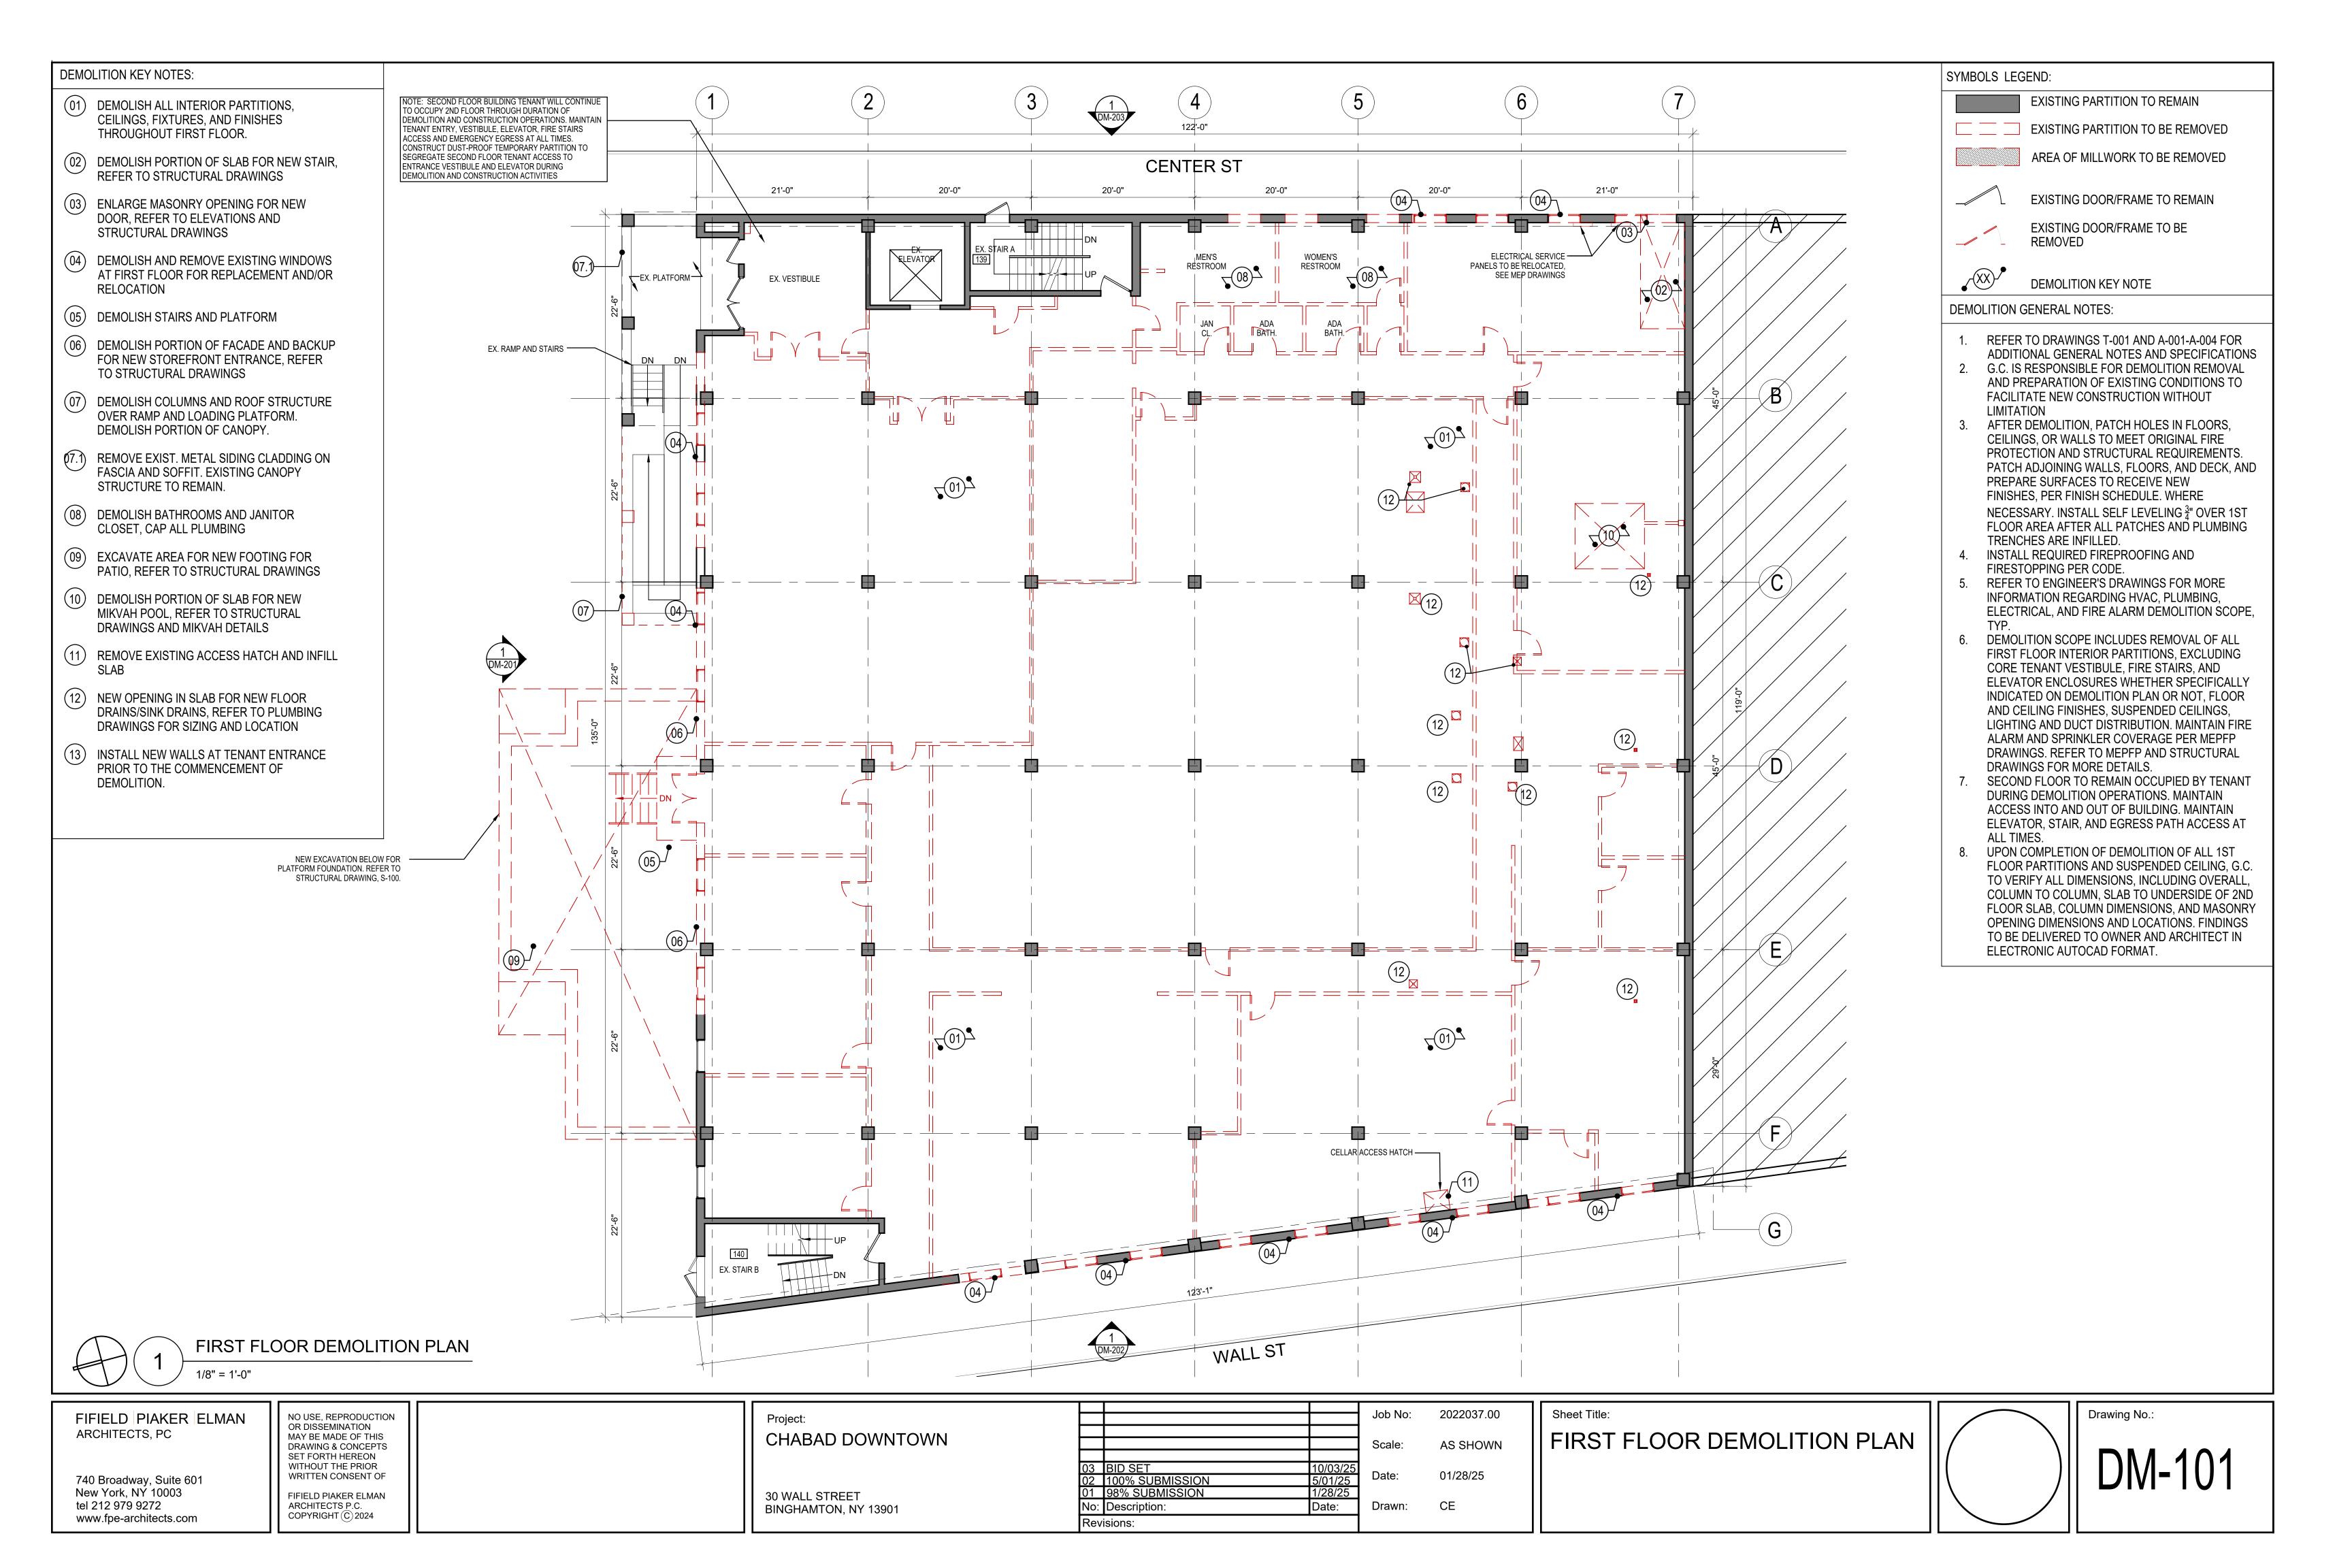


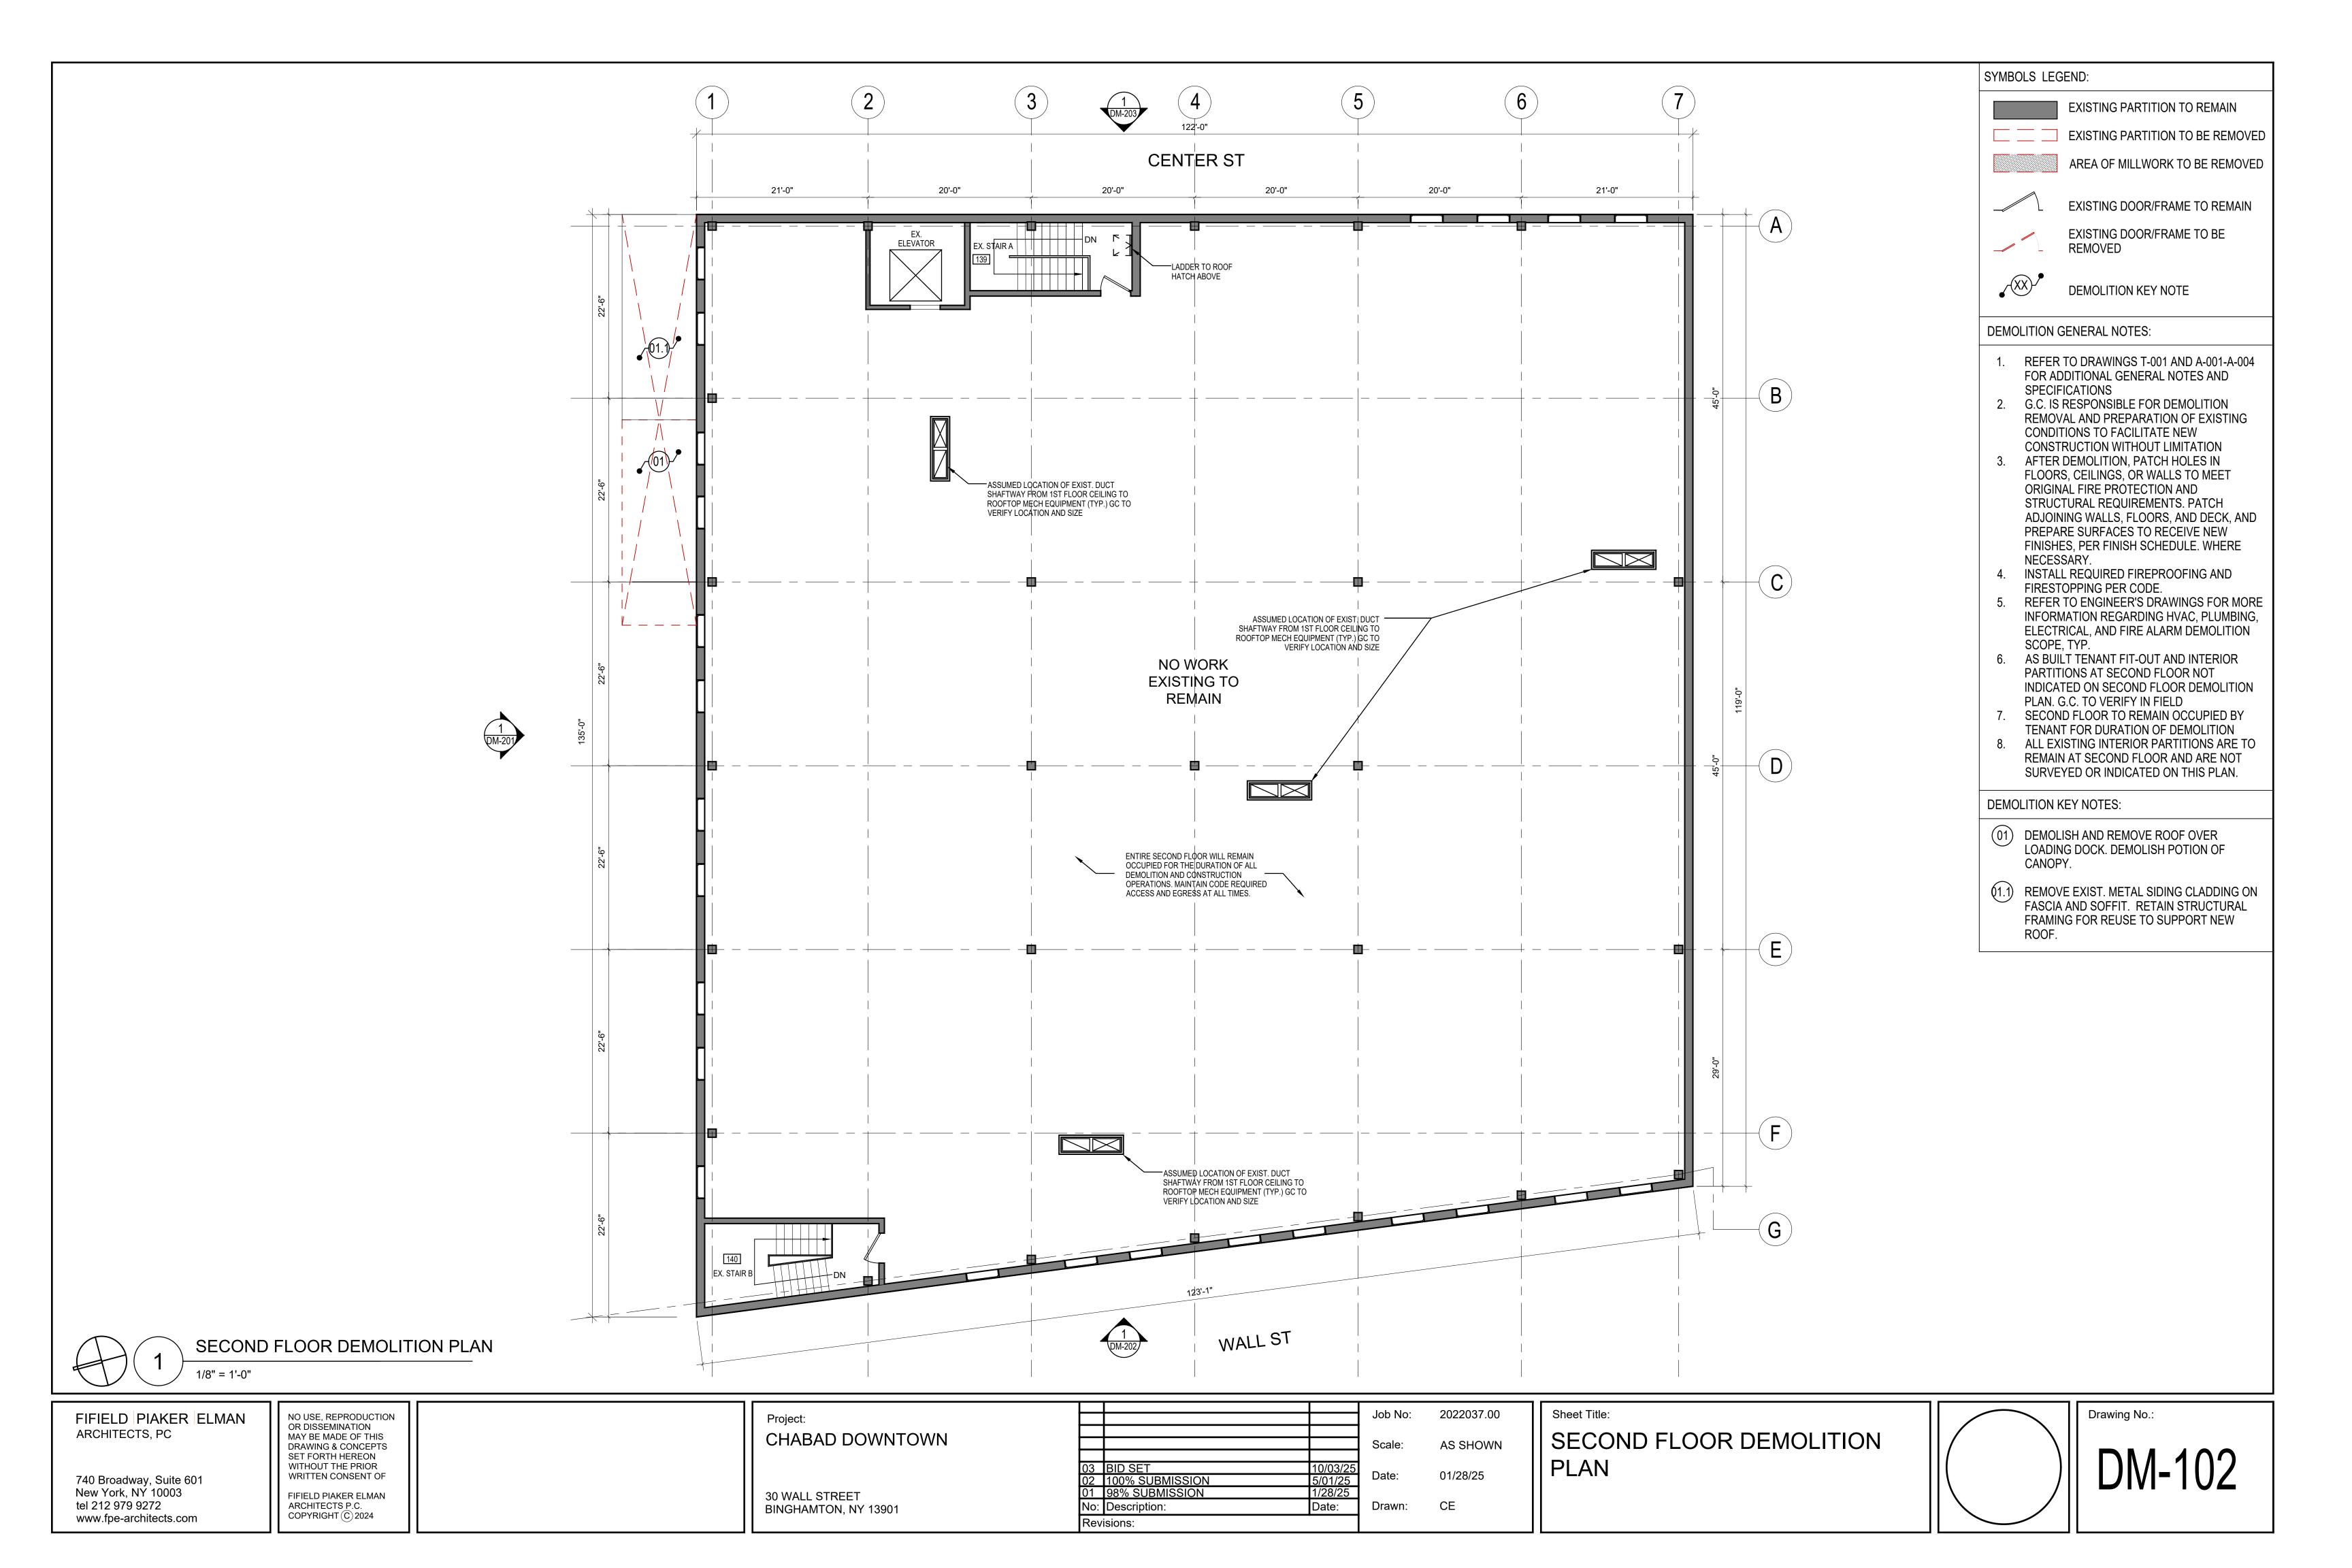

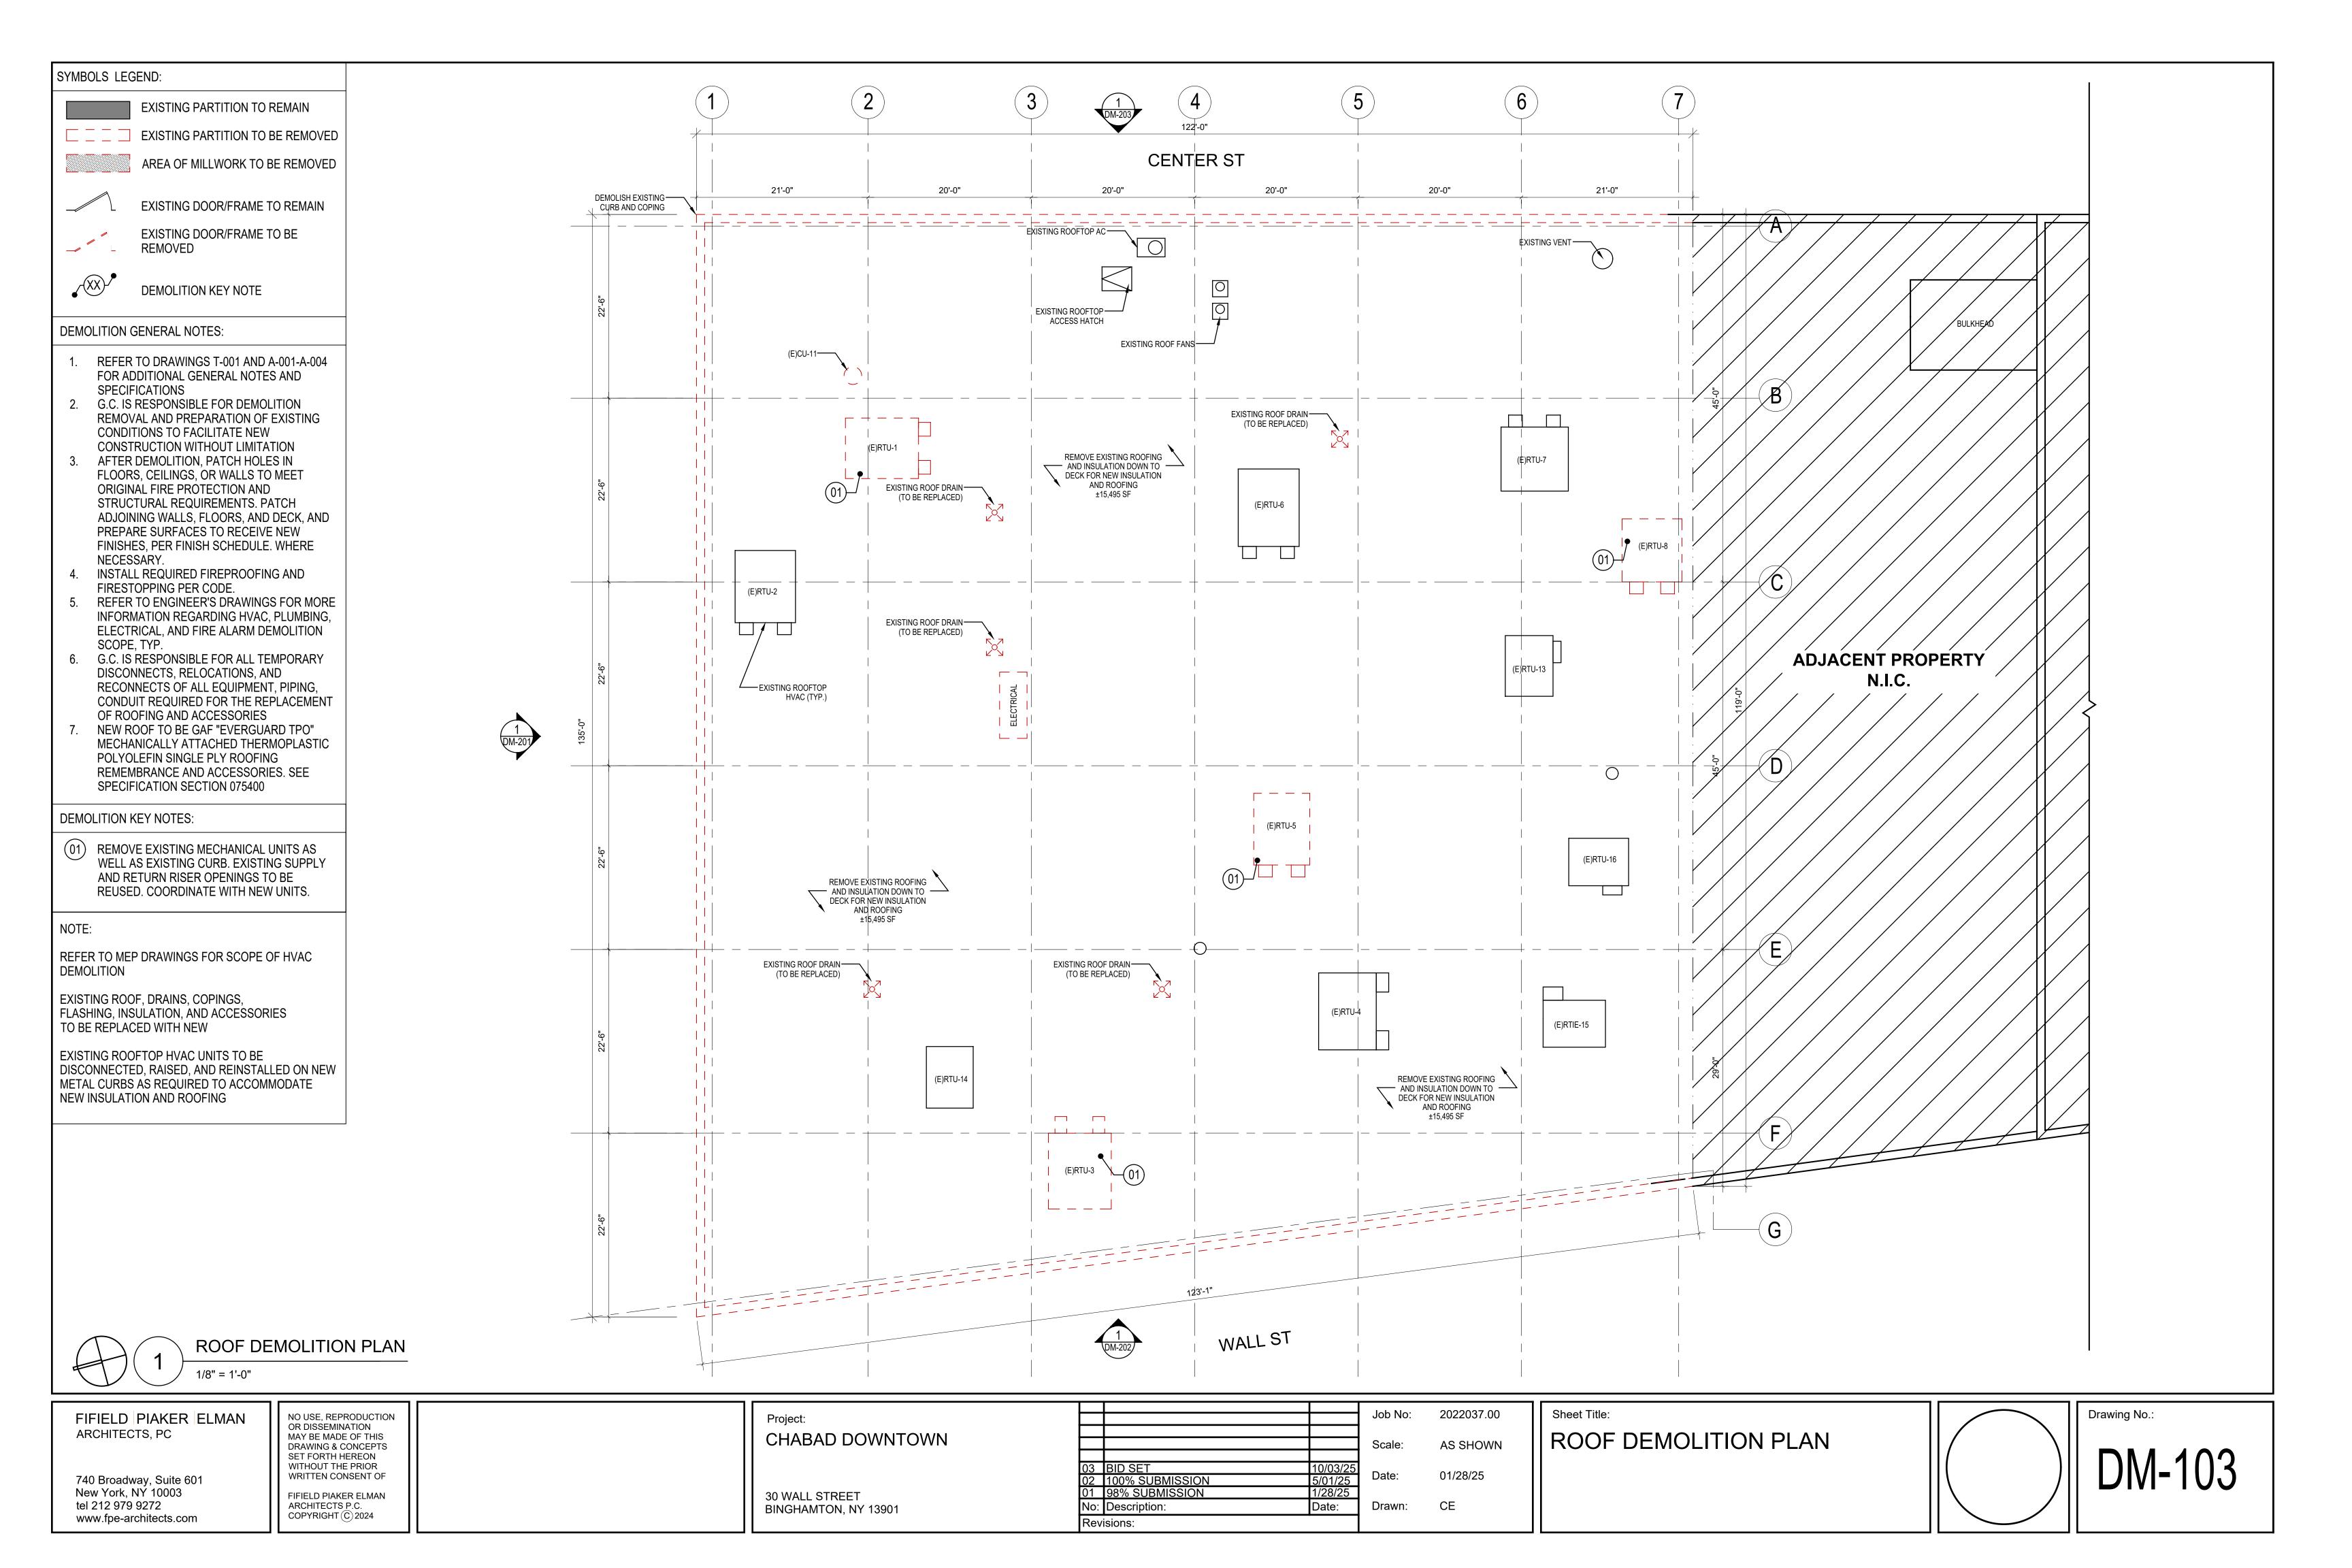

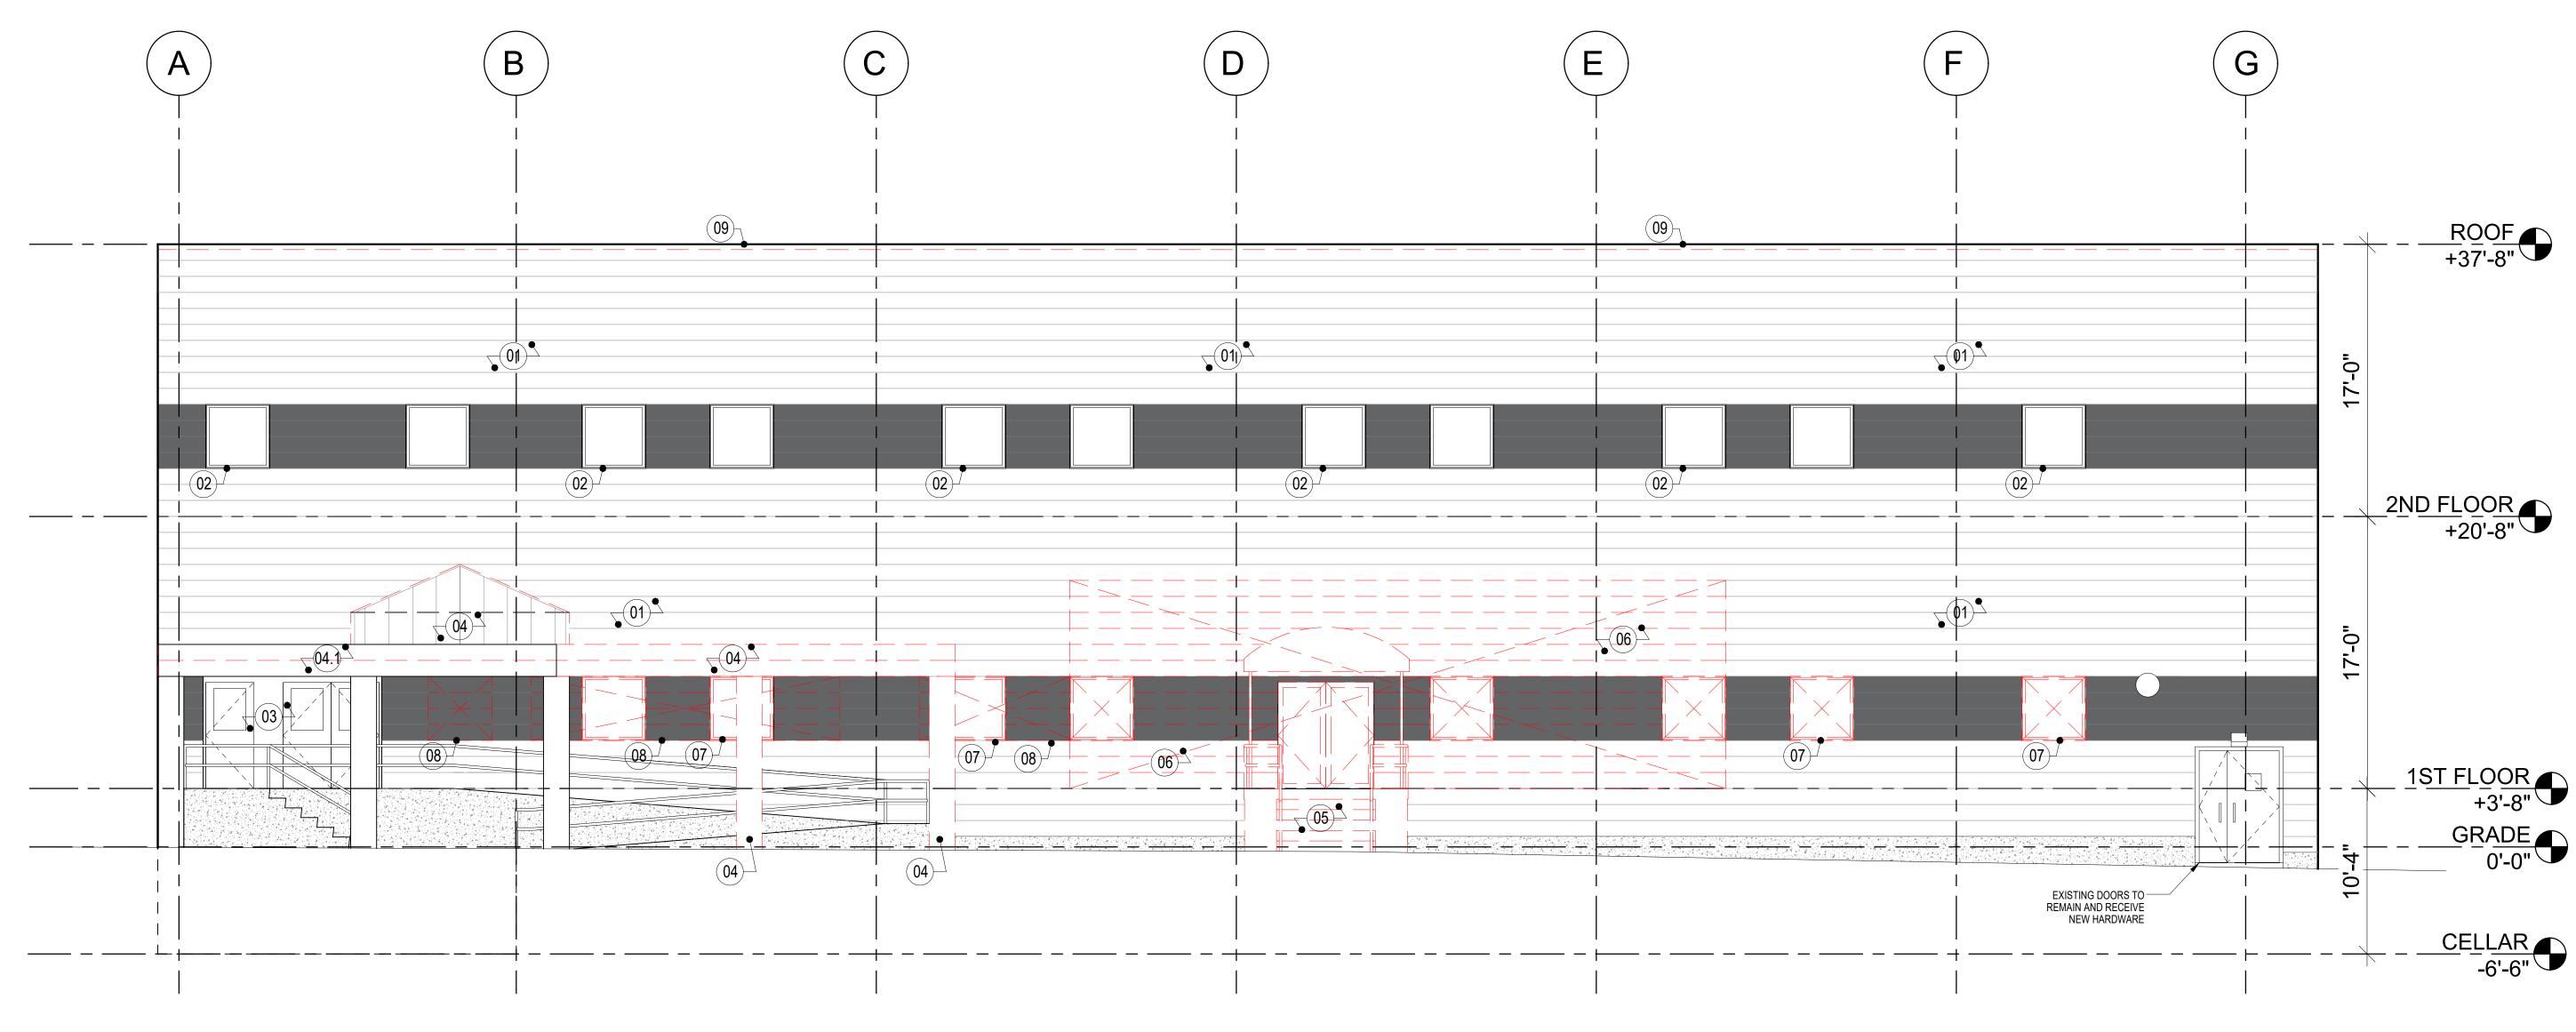

NORTH DEMOLITION ELEVATION 3/16"= 1'-0"

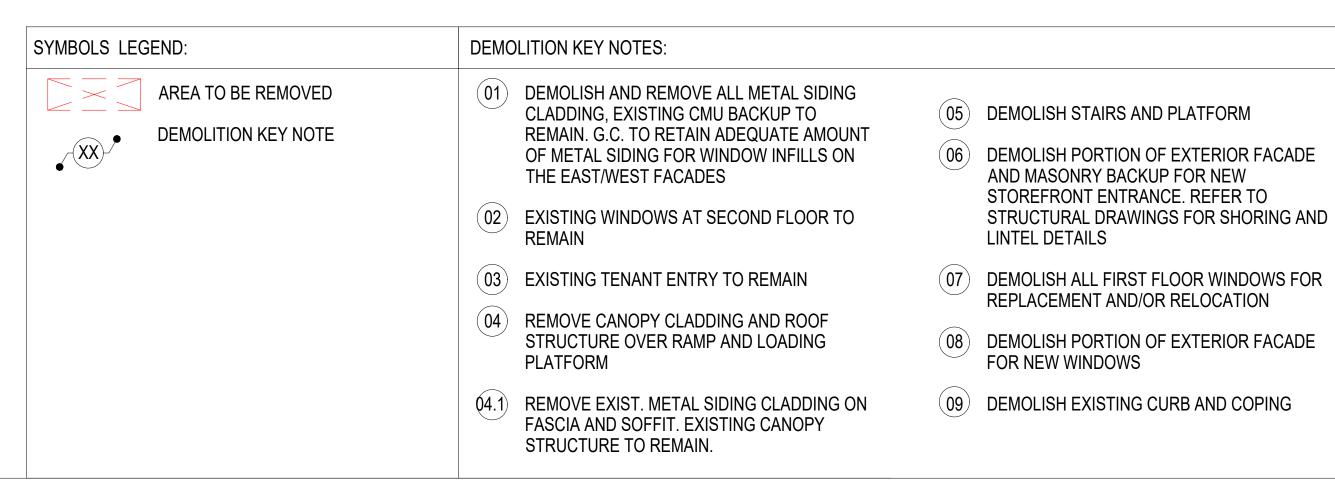

FIFIELD PIAKER ELMAN ARCHITECTS, PC

740 Broadway, Suite 601 New York, NY 10003 tel 212 979 9272 www.fpe-architects.com

NO USE, REPRODUCTION OR DISSEMINATION MAY BE MADE OF THIS DRAWING & CONCEPTS SET FORTH HEREON WITHOUT THE PRIOR WRITTEN CONSENT OF FIFIELD PIAKER ELMAN


ARCHITECTS P.C. COPYRIGHT © 2024

Project: CHABAD DOWNTOWN

30 WALL STREET BINGHAMTON, NY 13901


2022037.00 Job No: AS SHOWN Scale: 03 BID SET 02 100% SUBMISSION 01 98% SUBMISSION 10/03/25 5/01/25 1/28/25 Date: 01/28/25 CE No: Description: Date: Drawn: Revisions:


Sheet Title: NORTH DEMOLITION ELEVATION

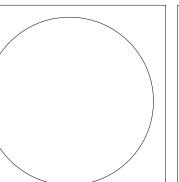



Drawing No.:


DM-201

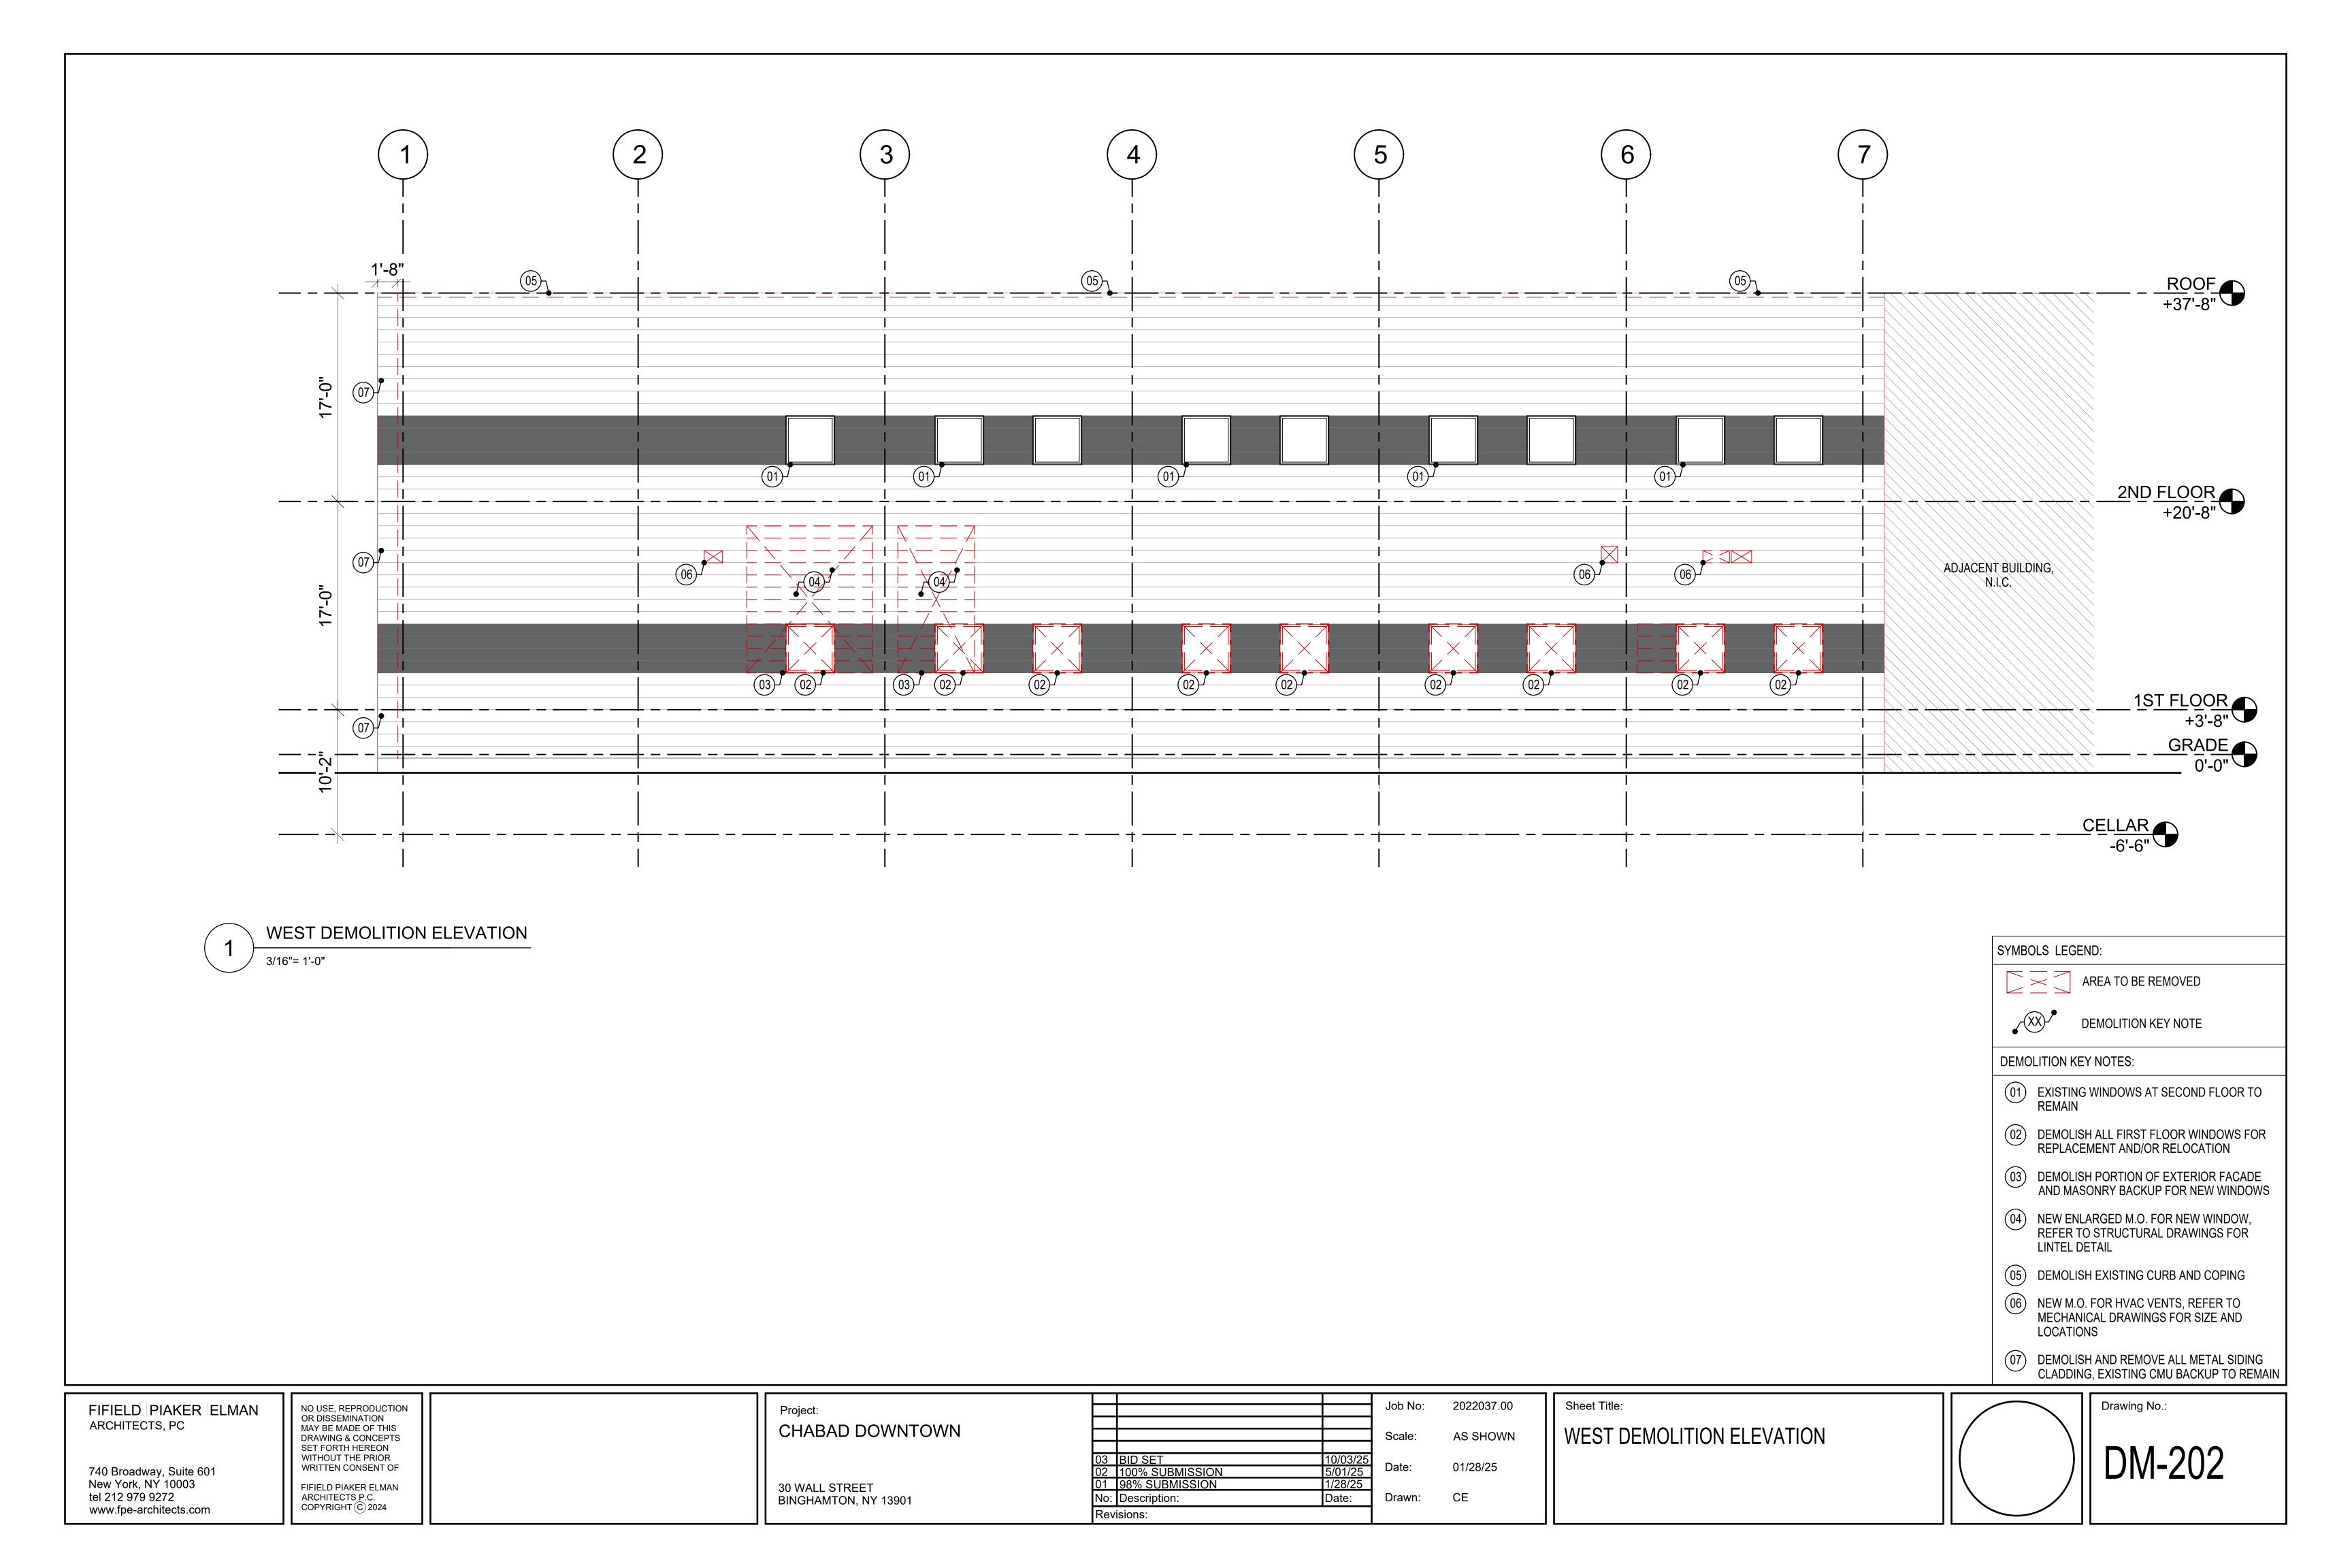


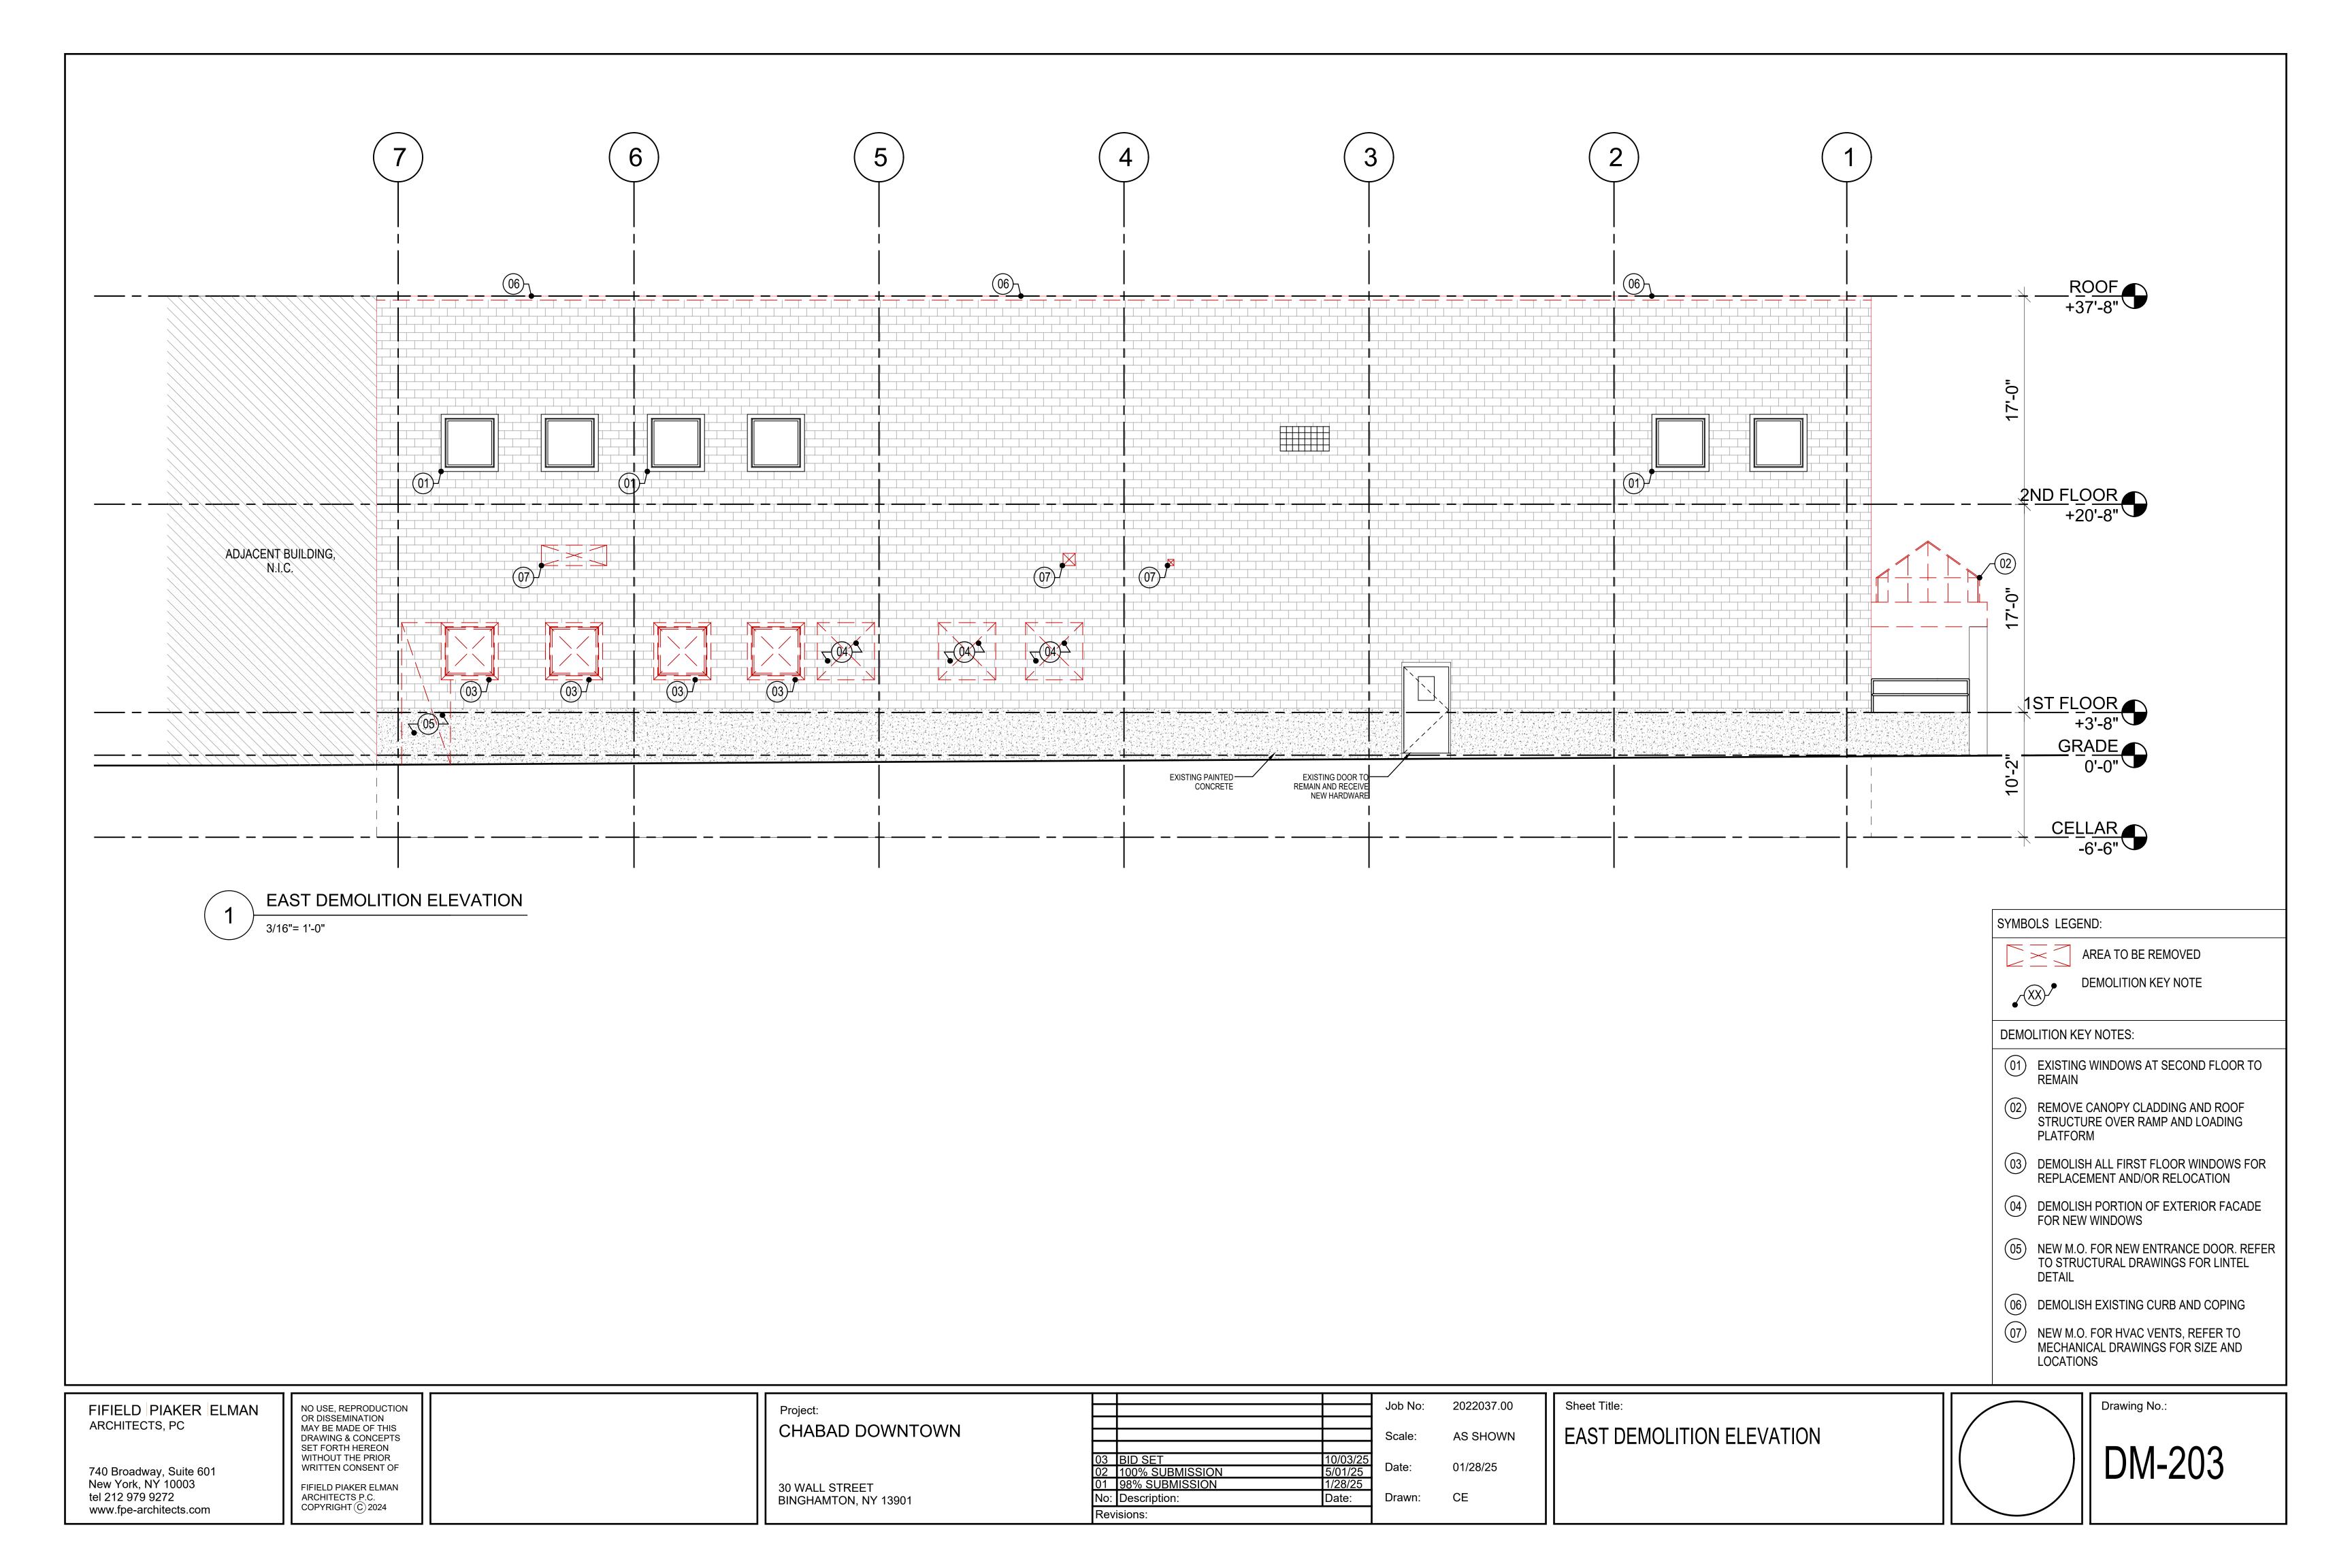


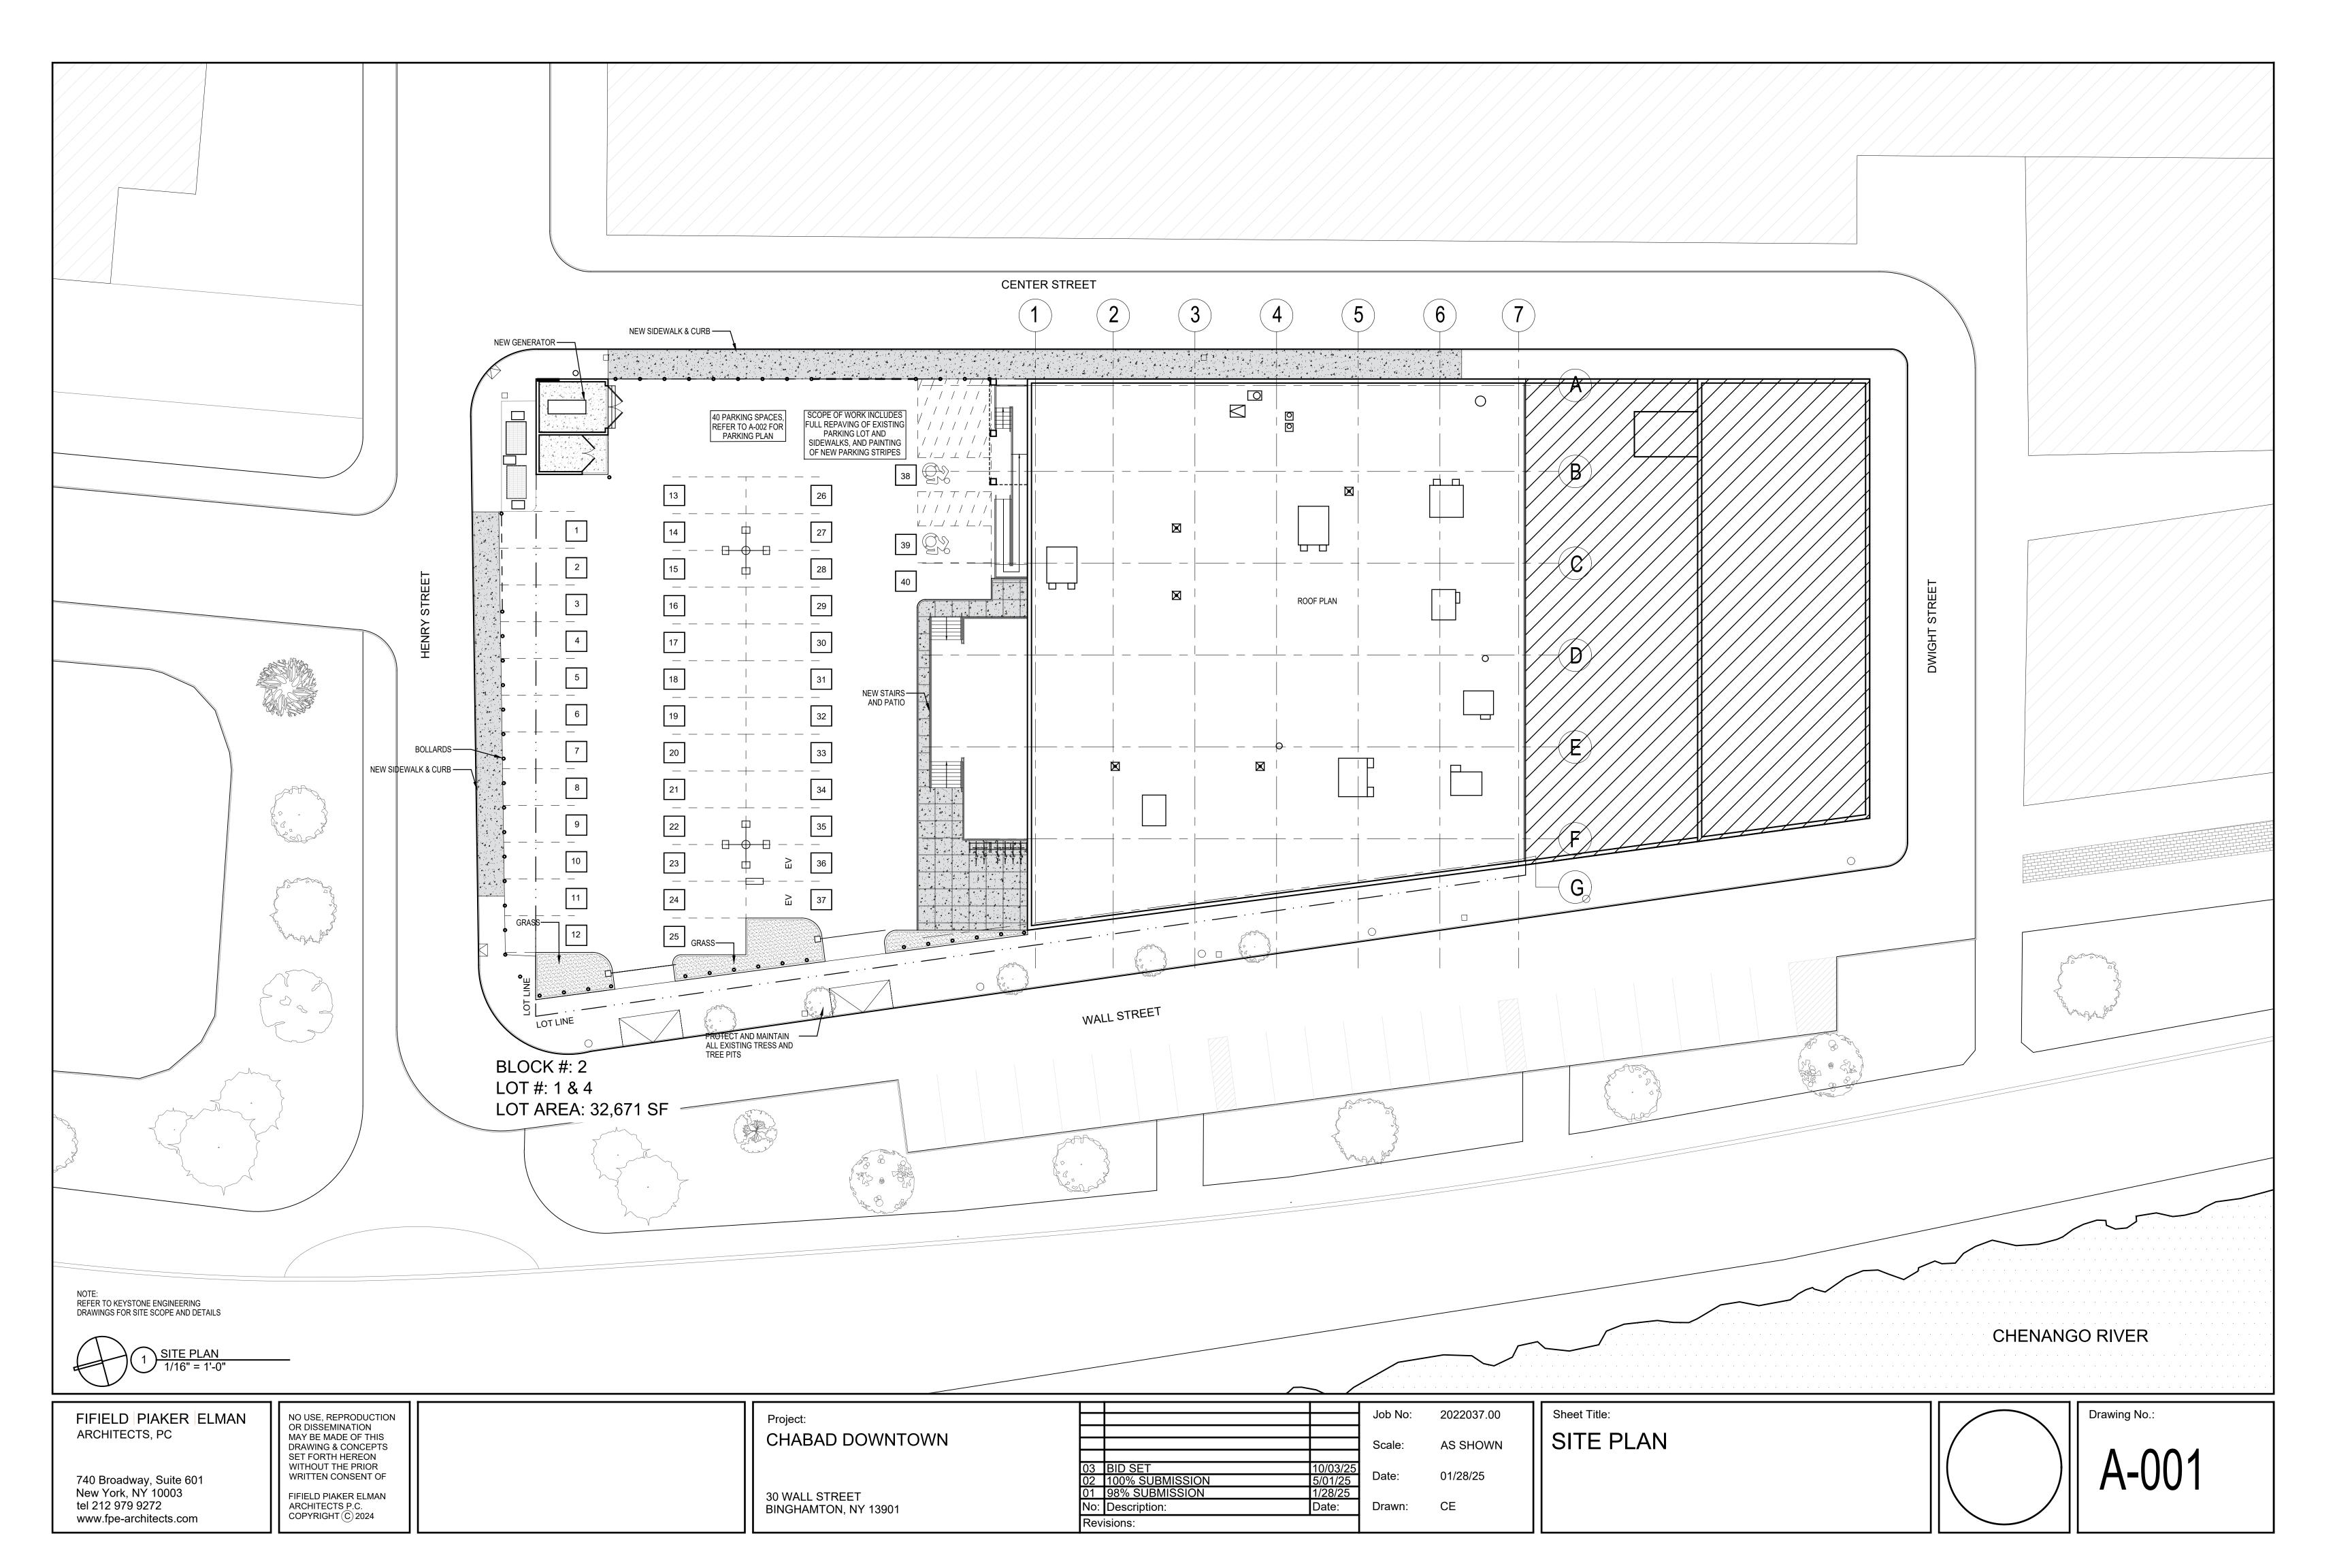


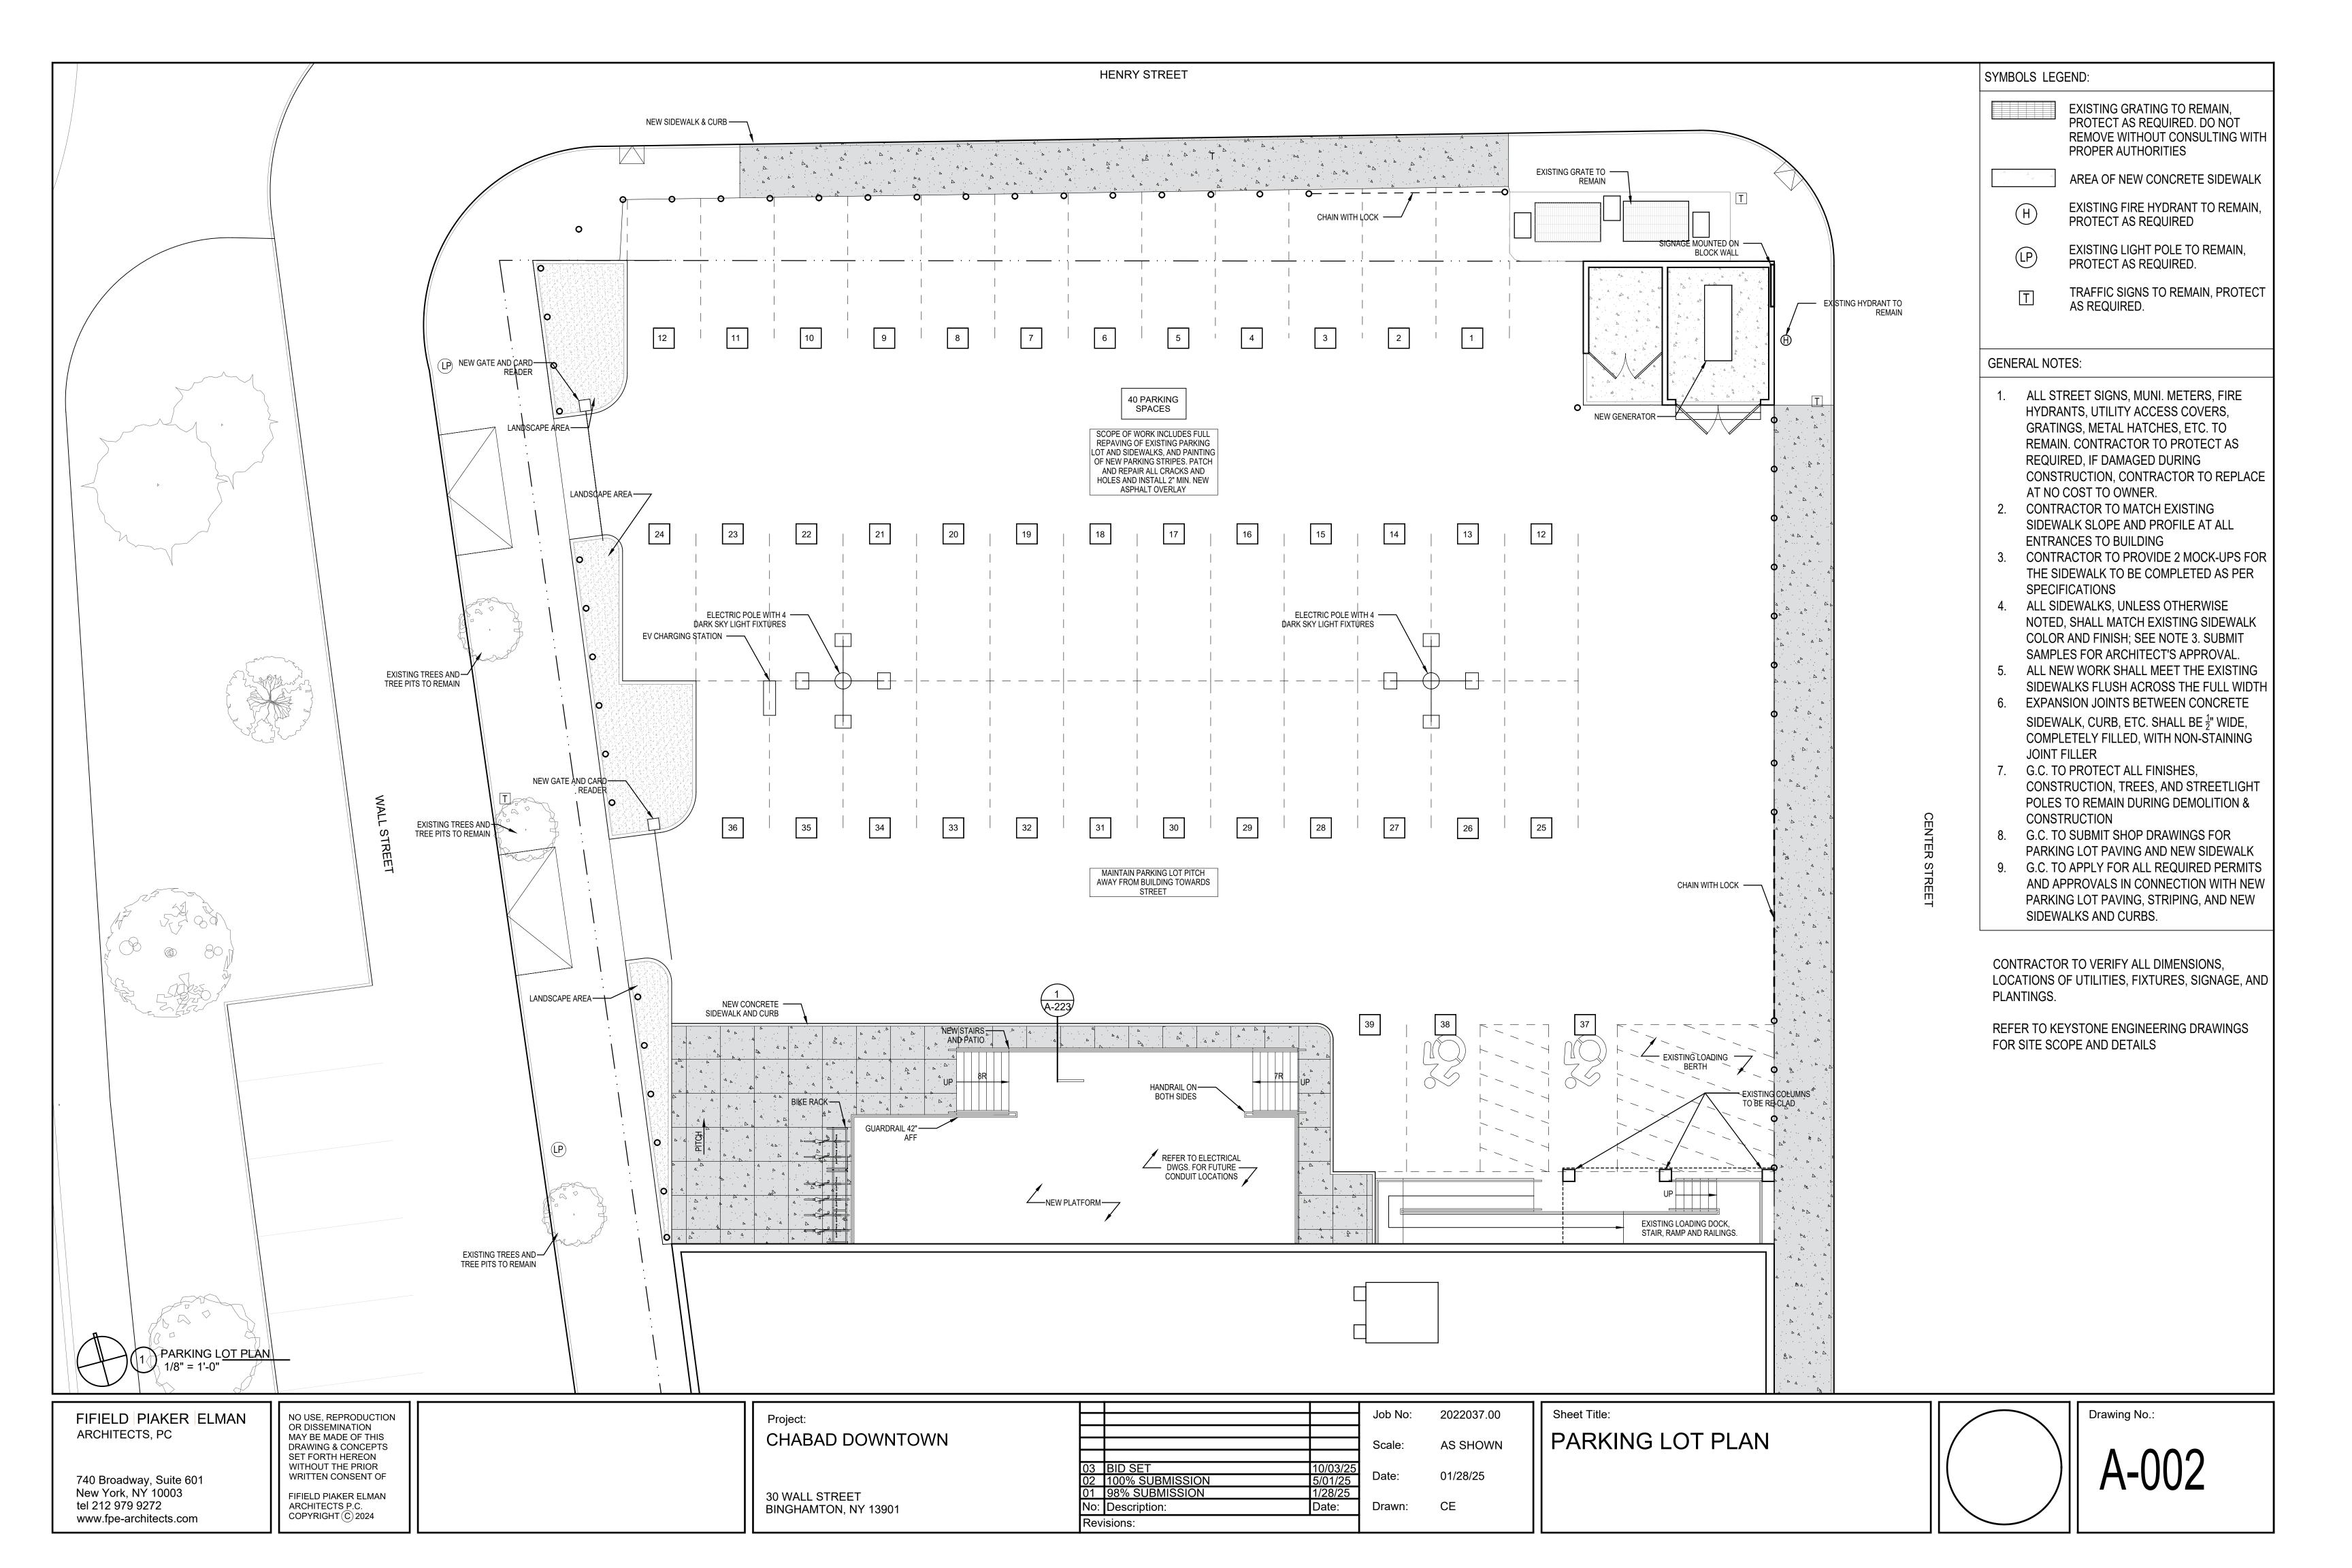


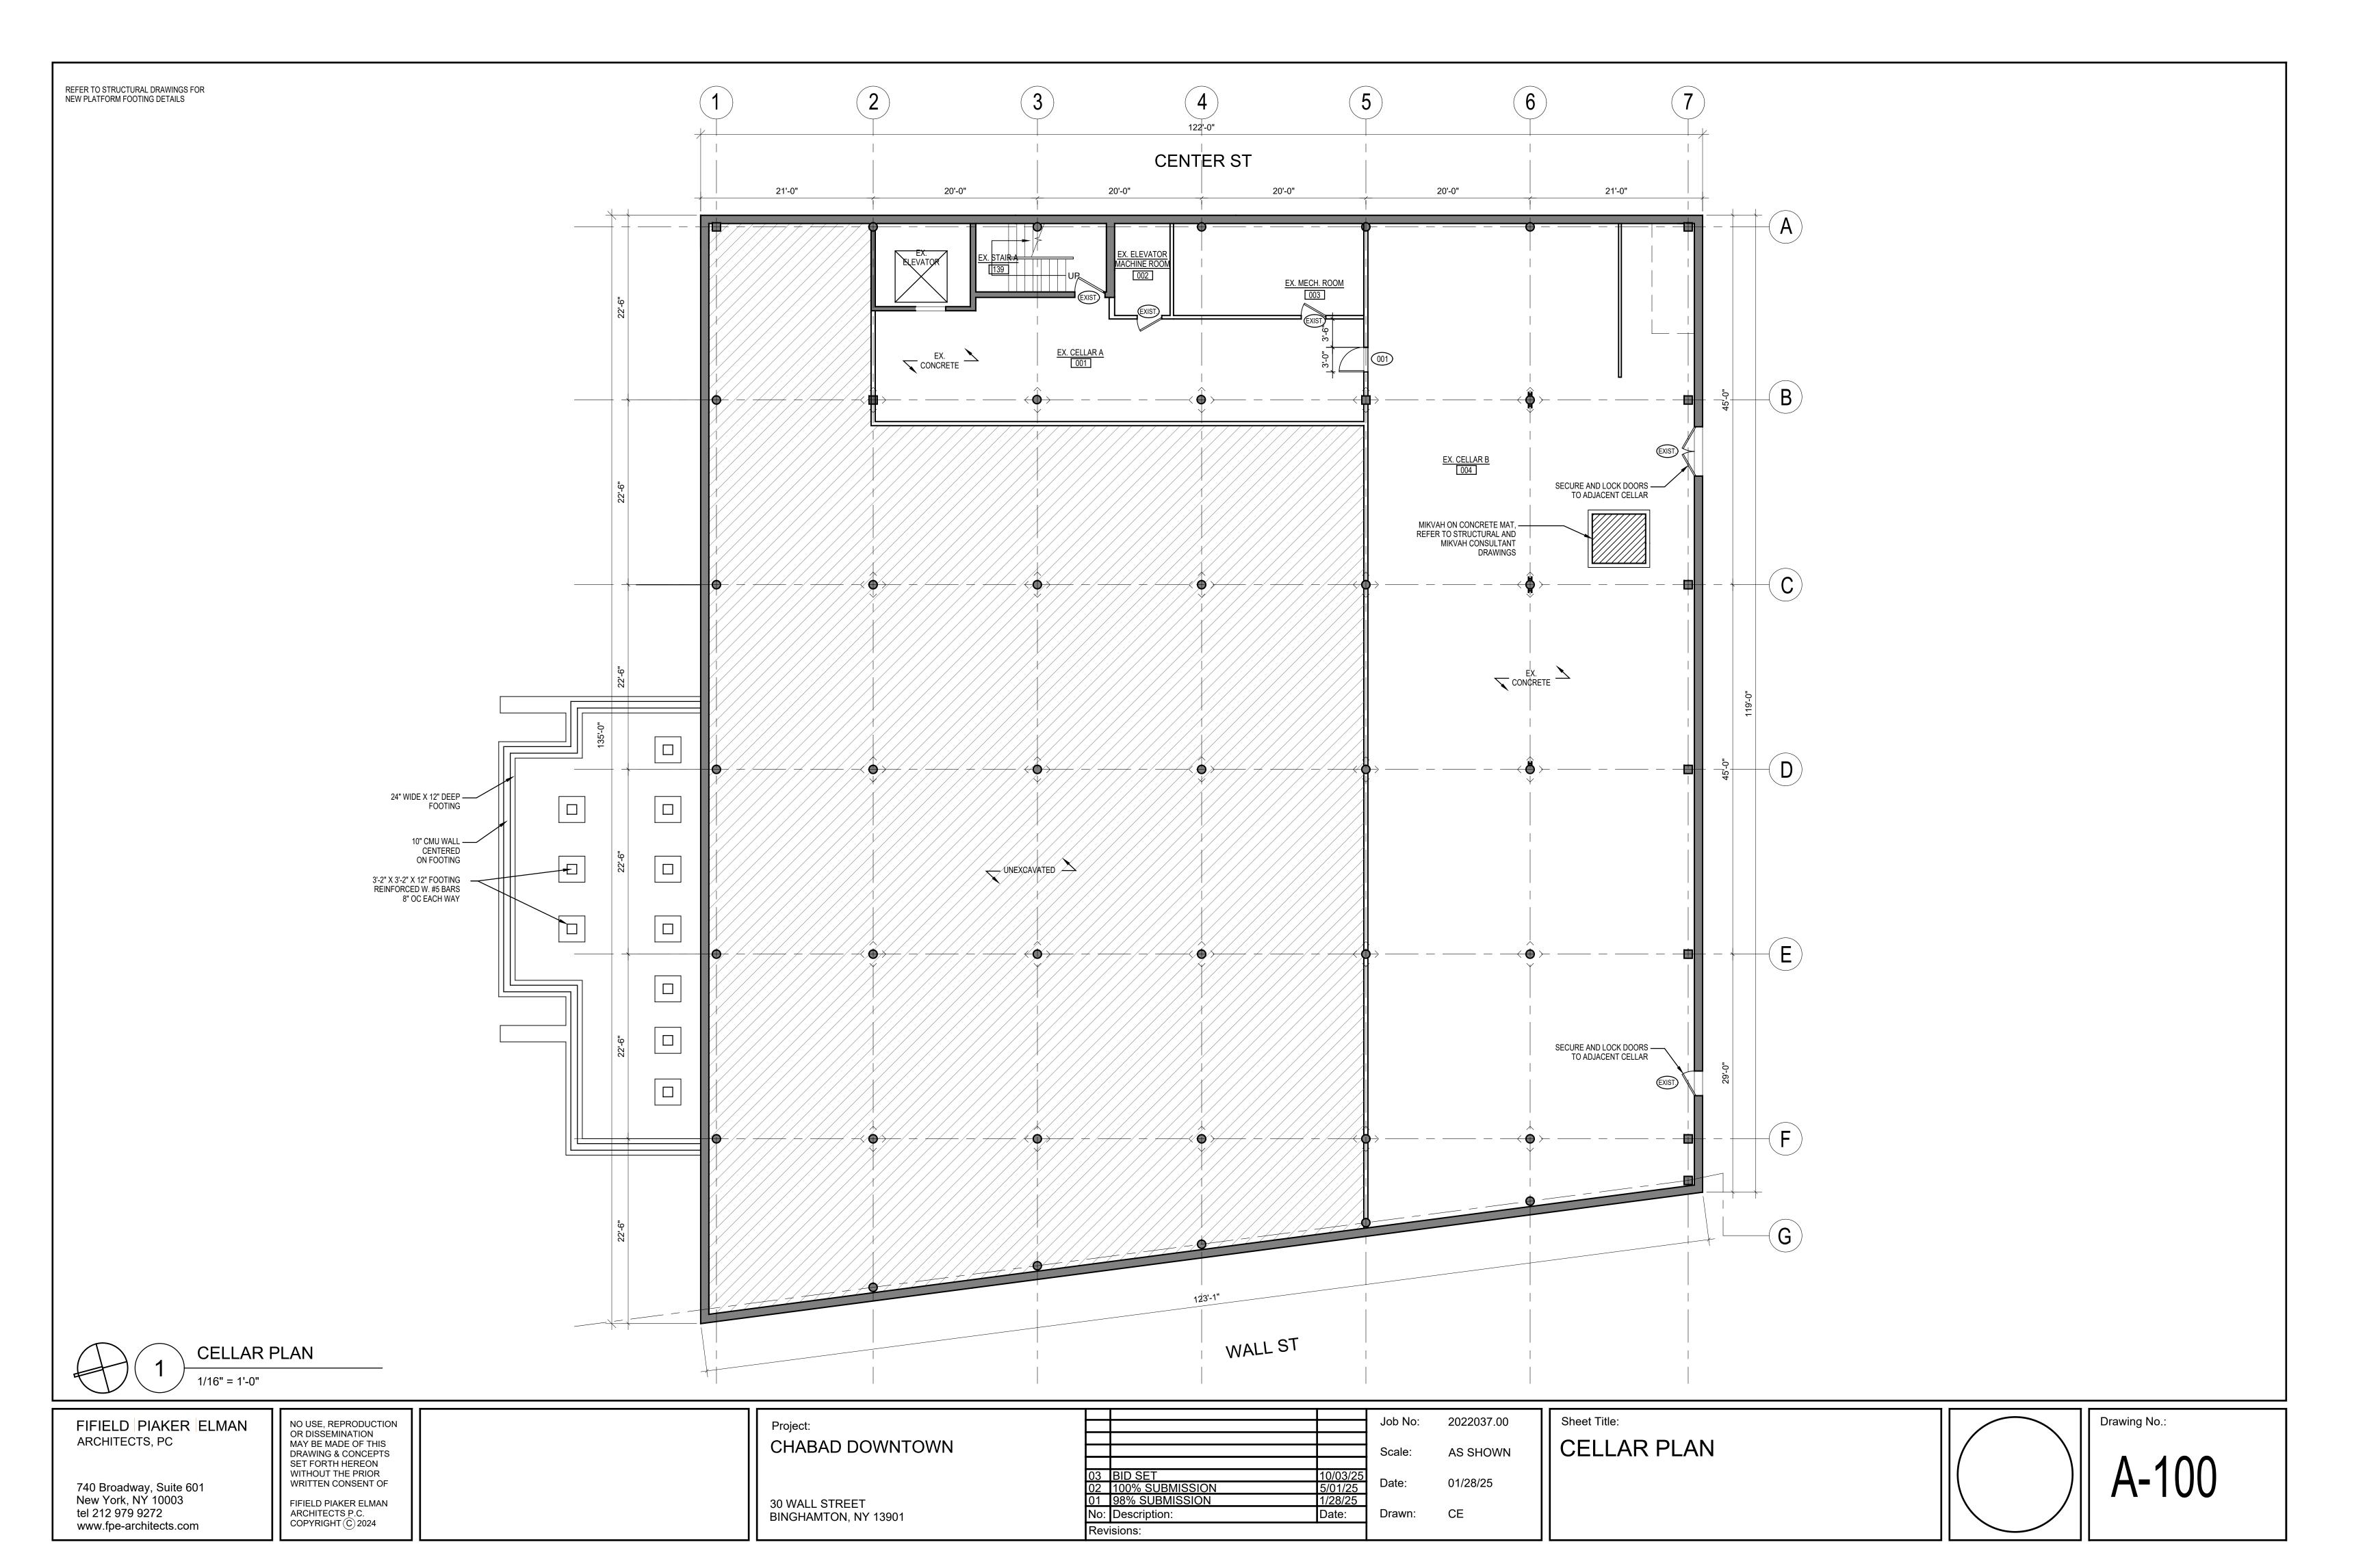


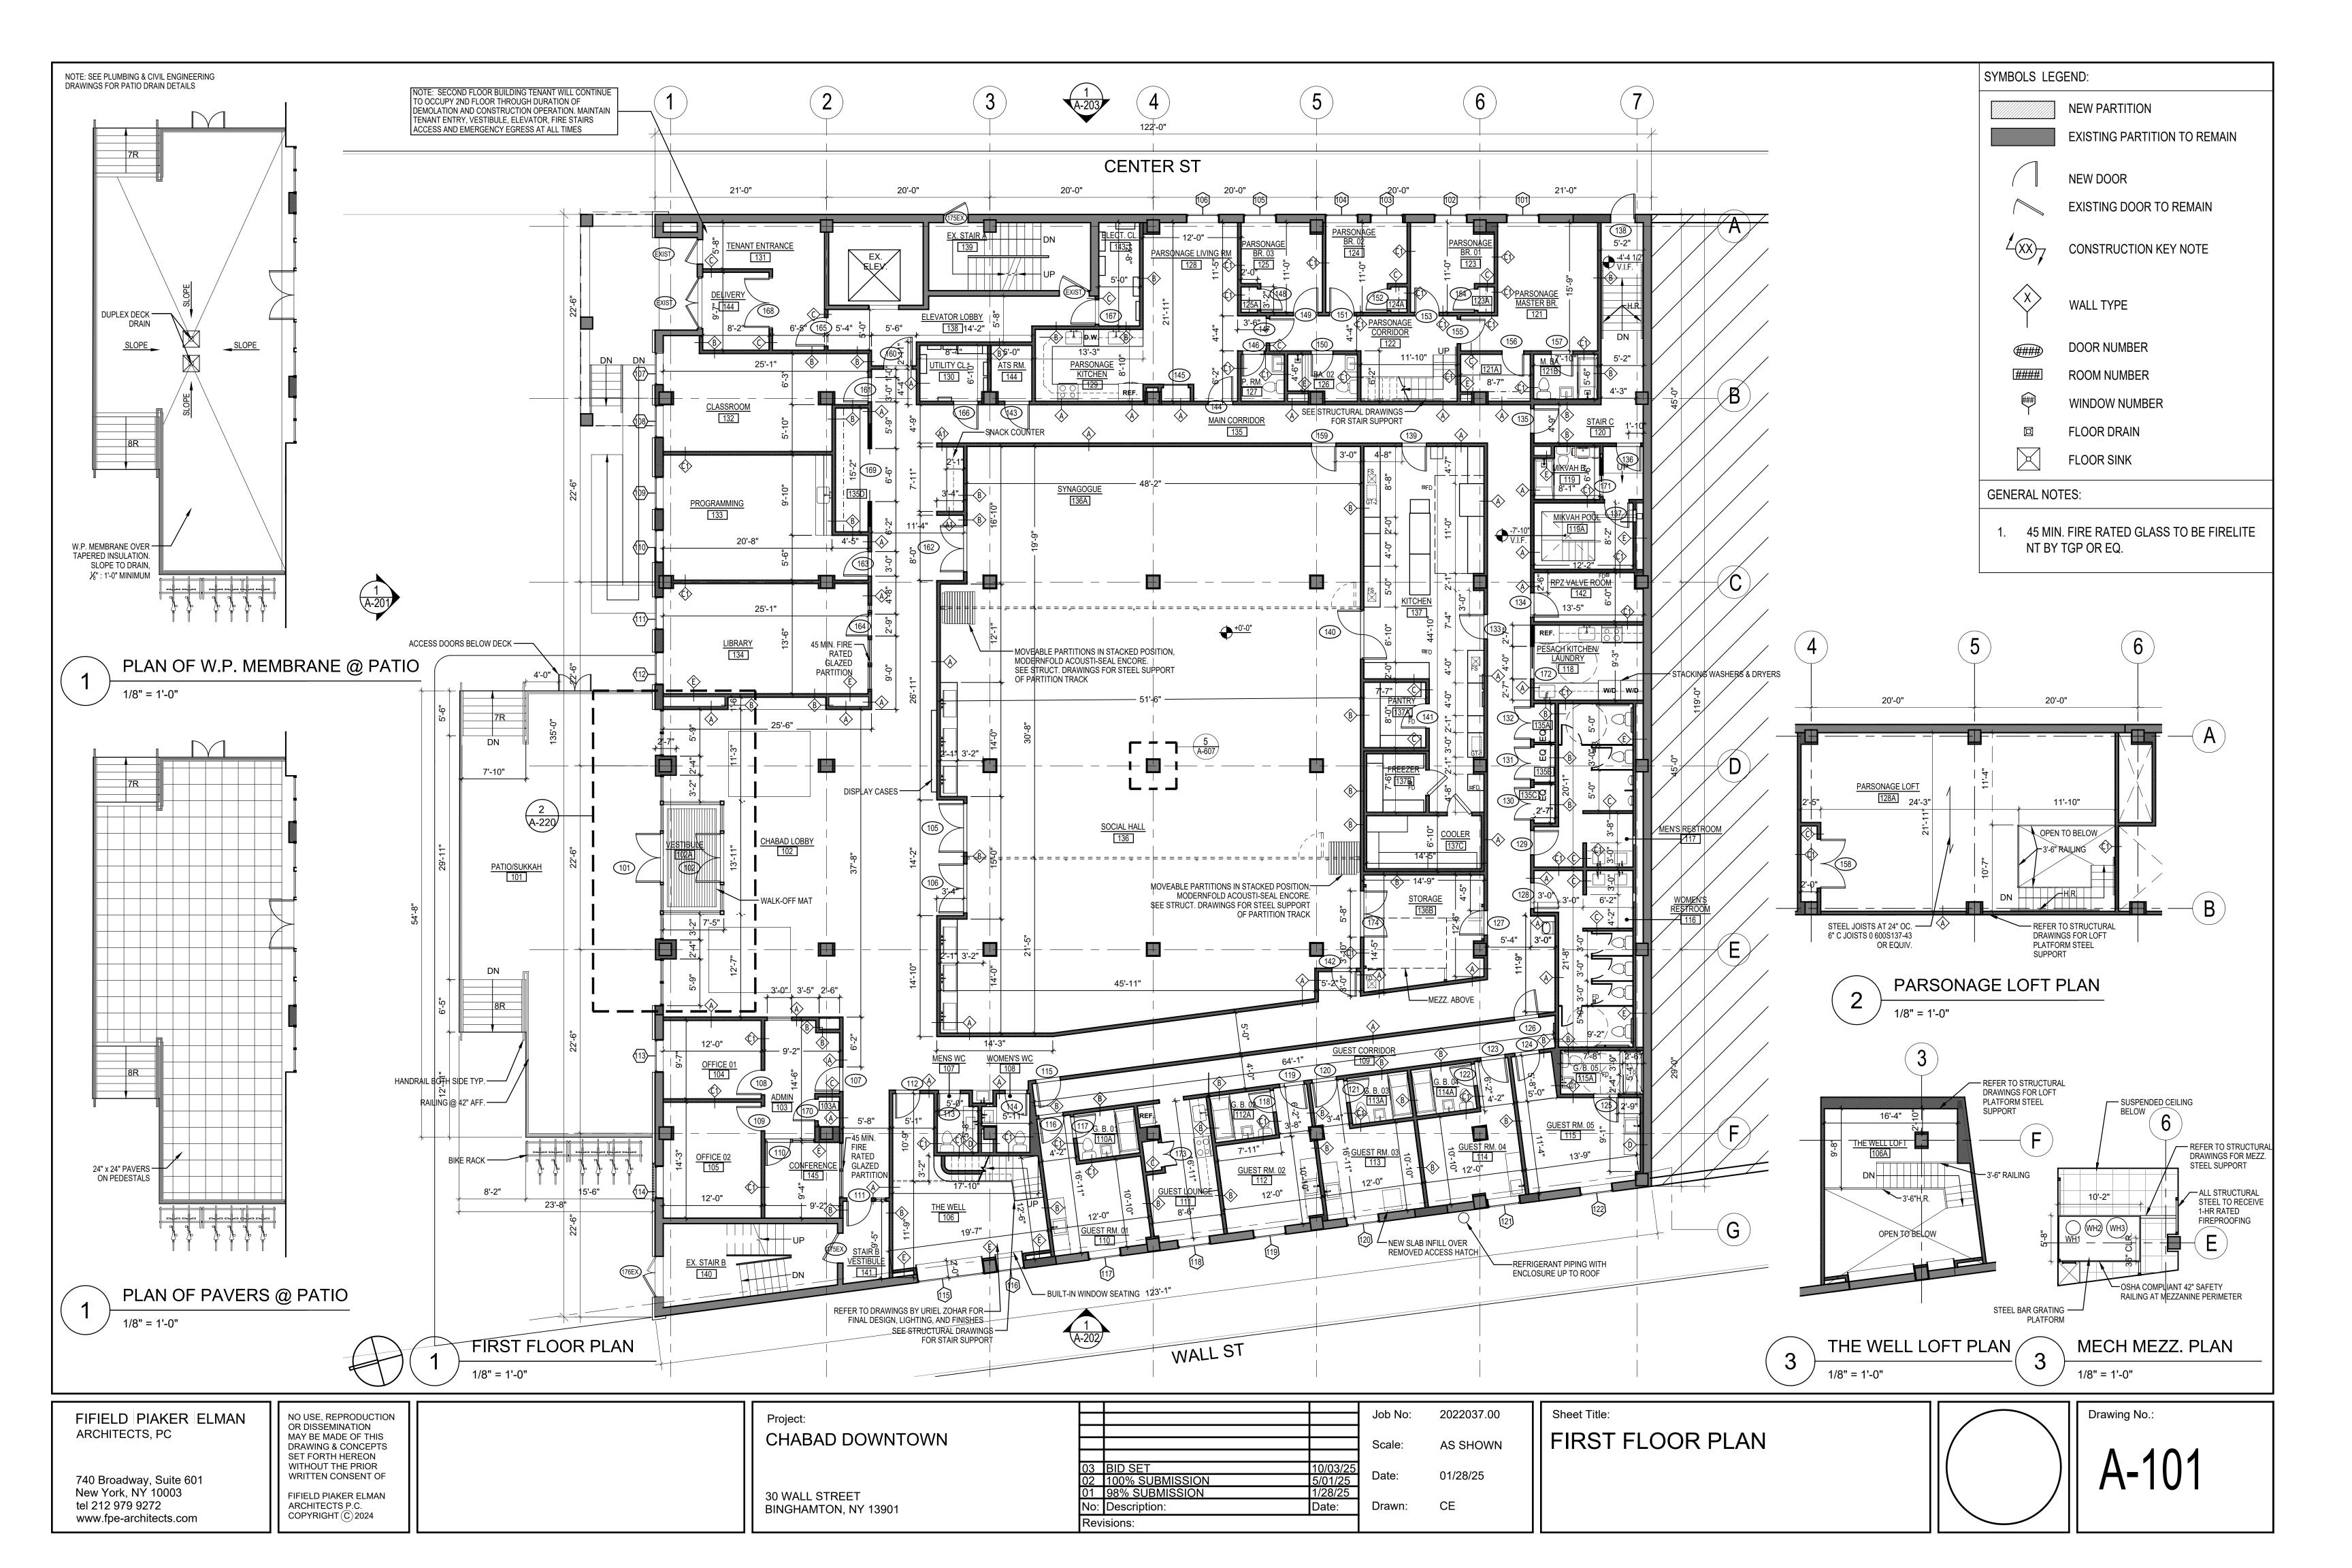

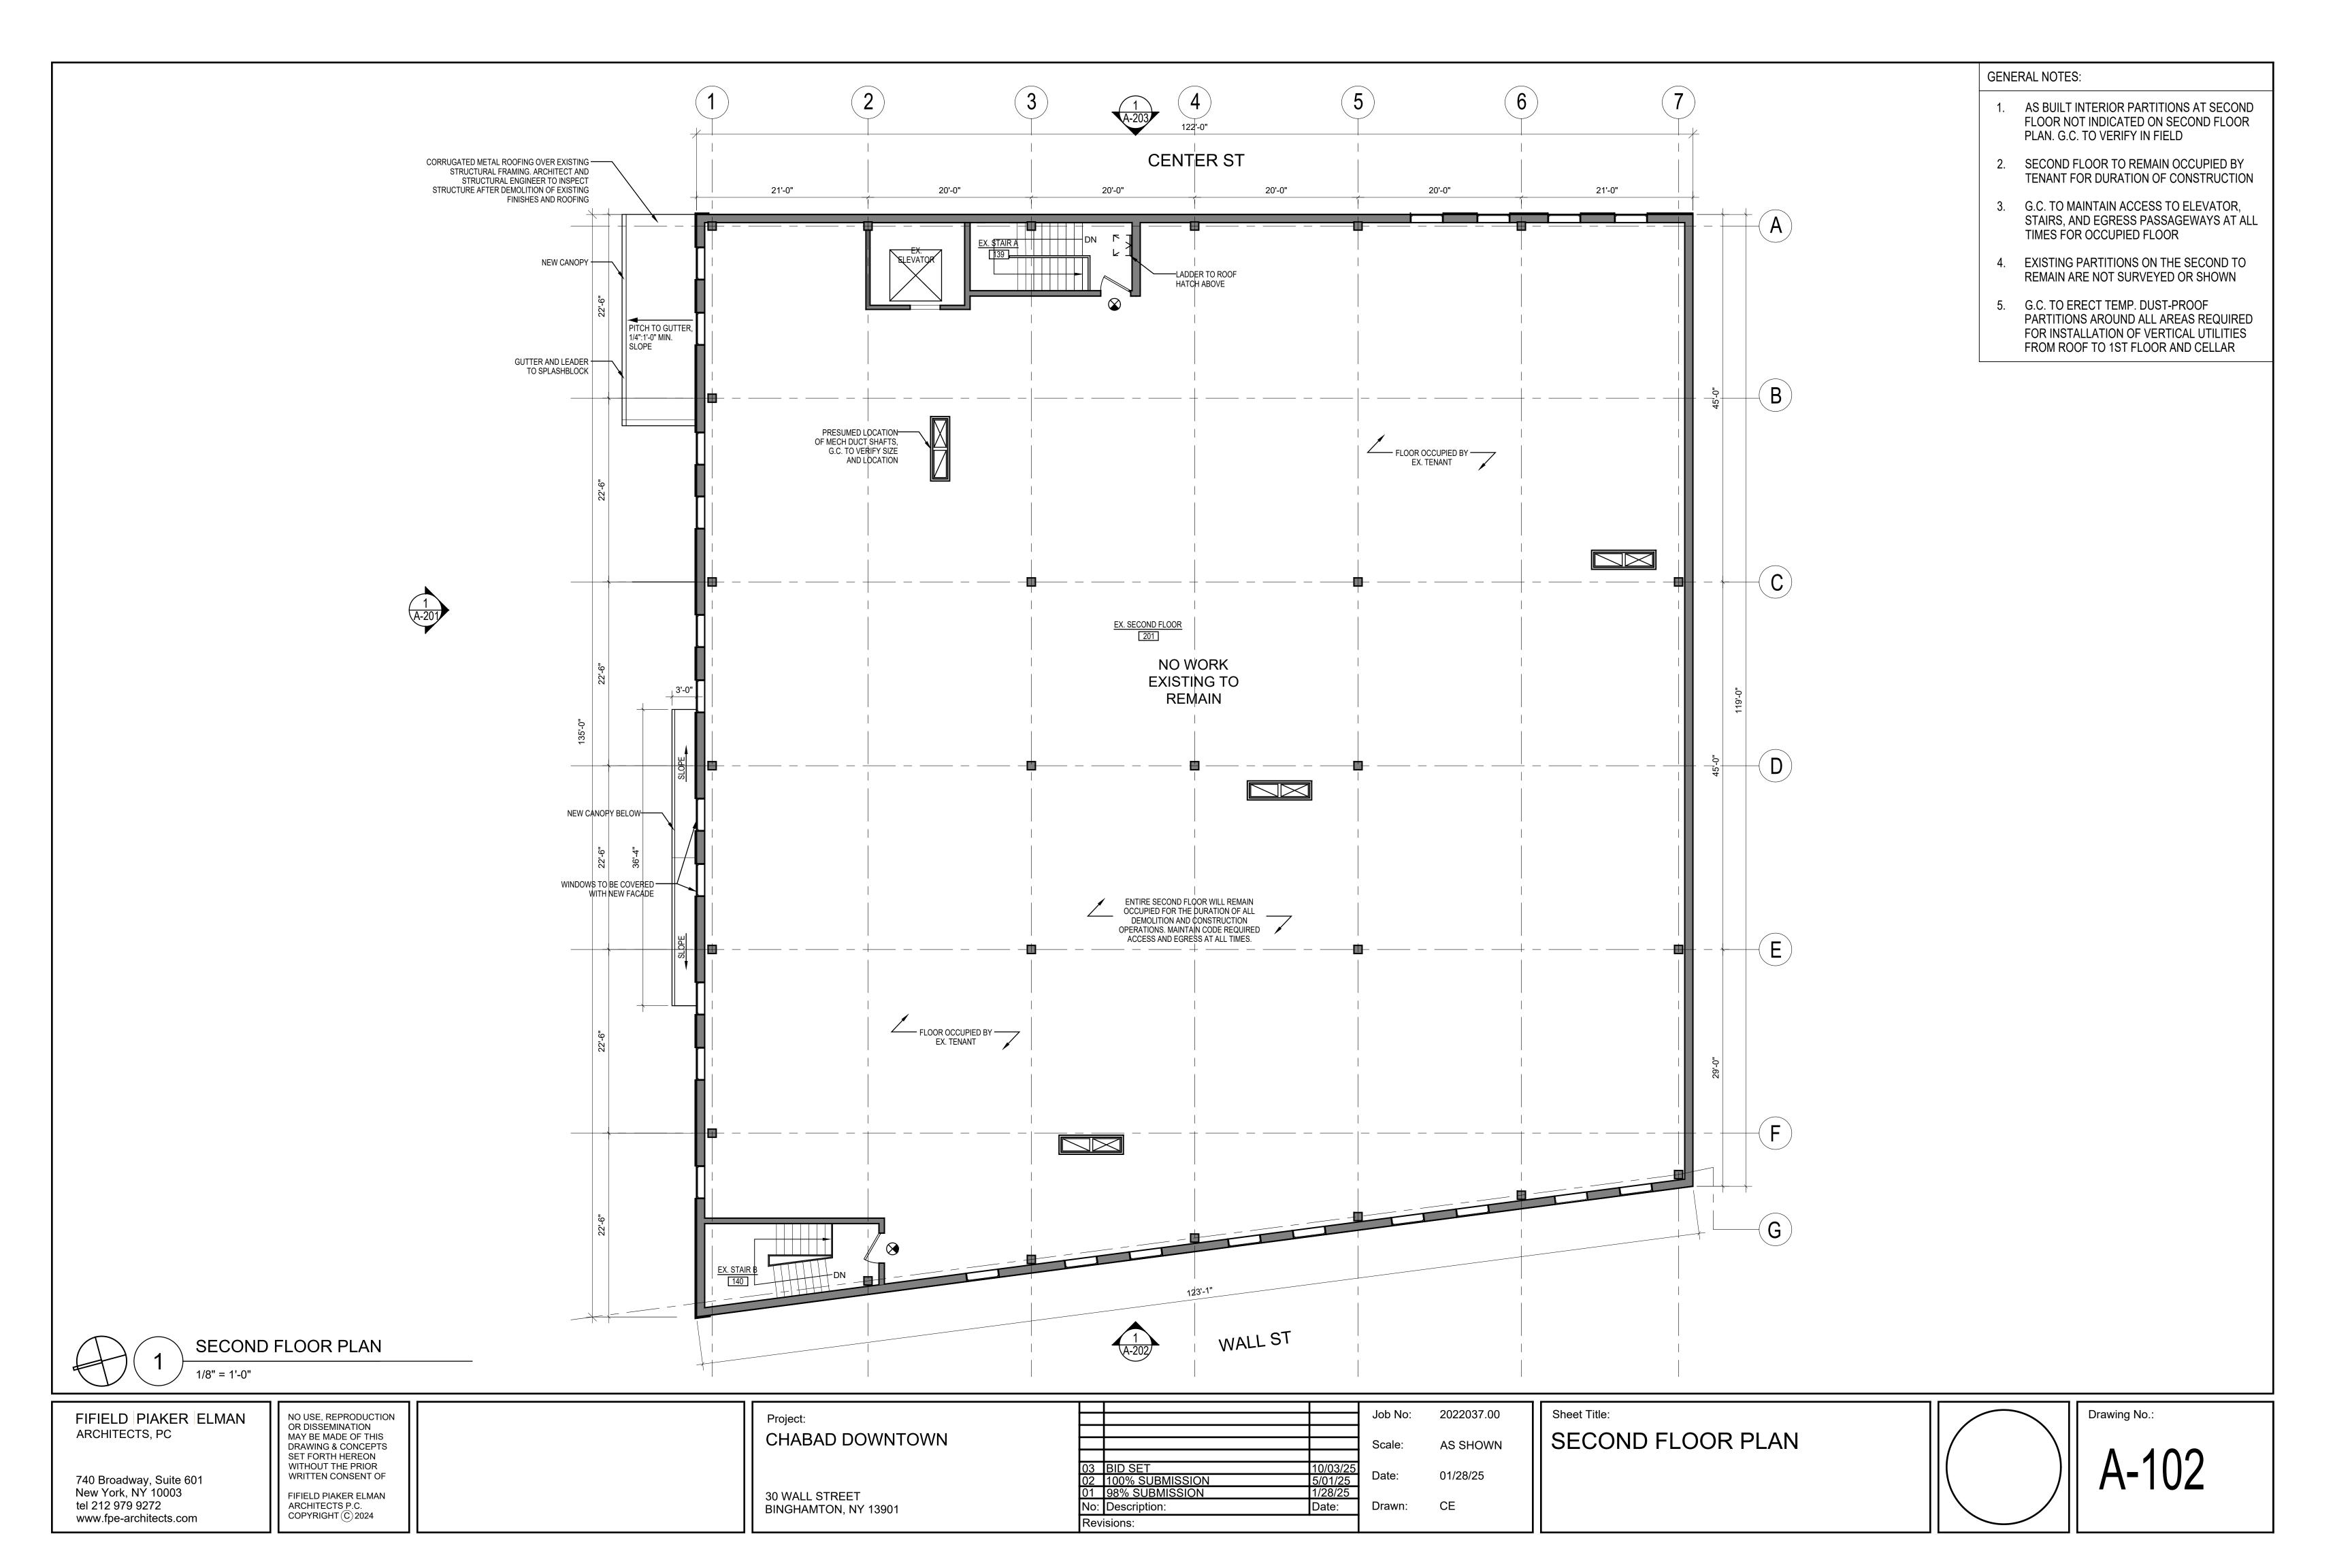

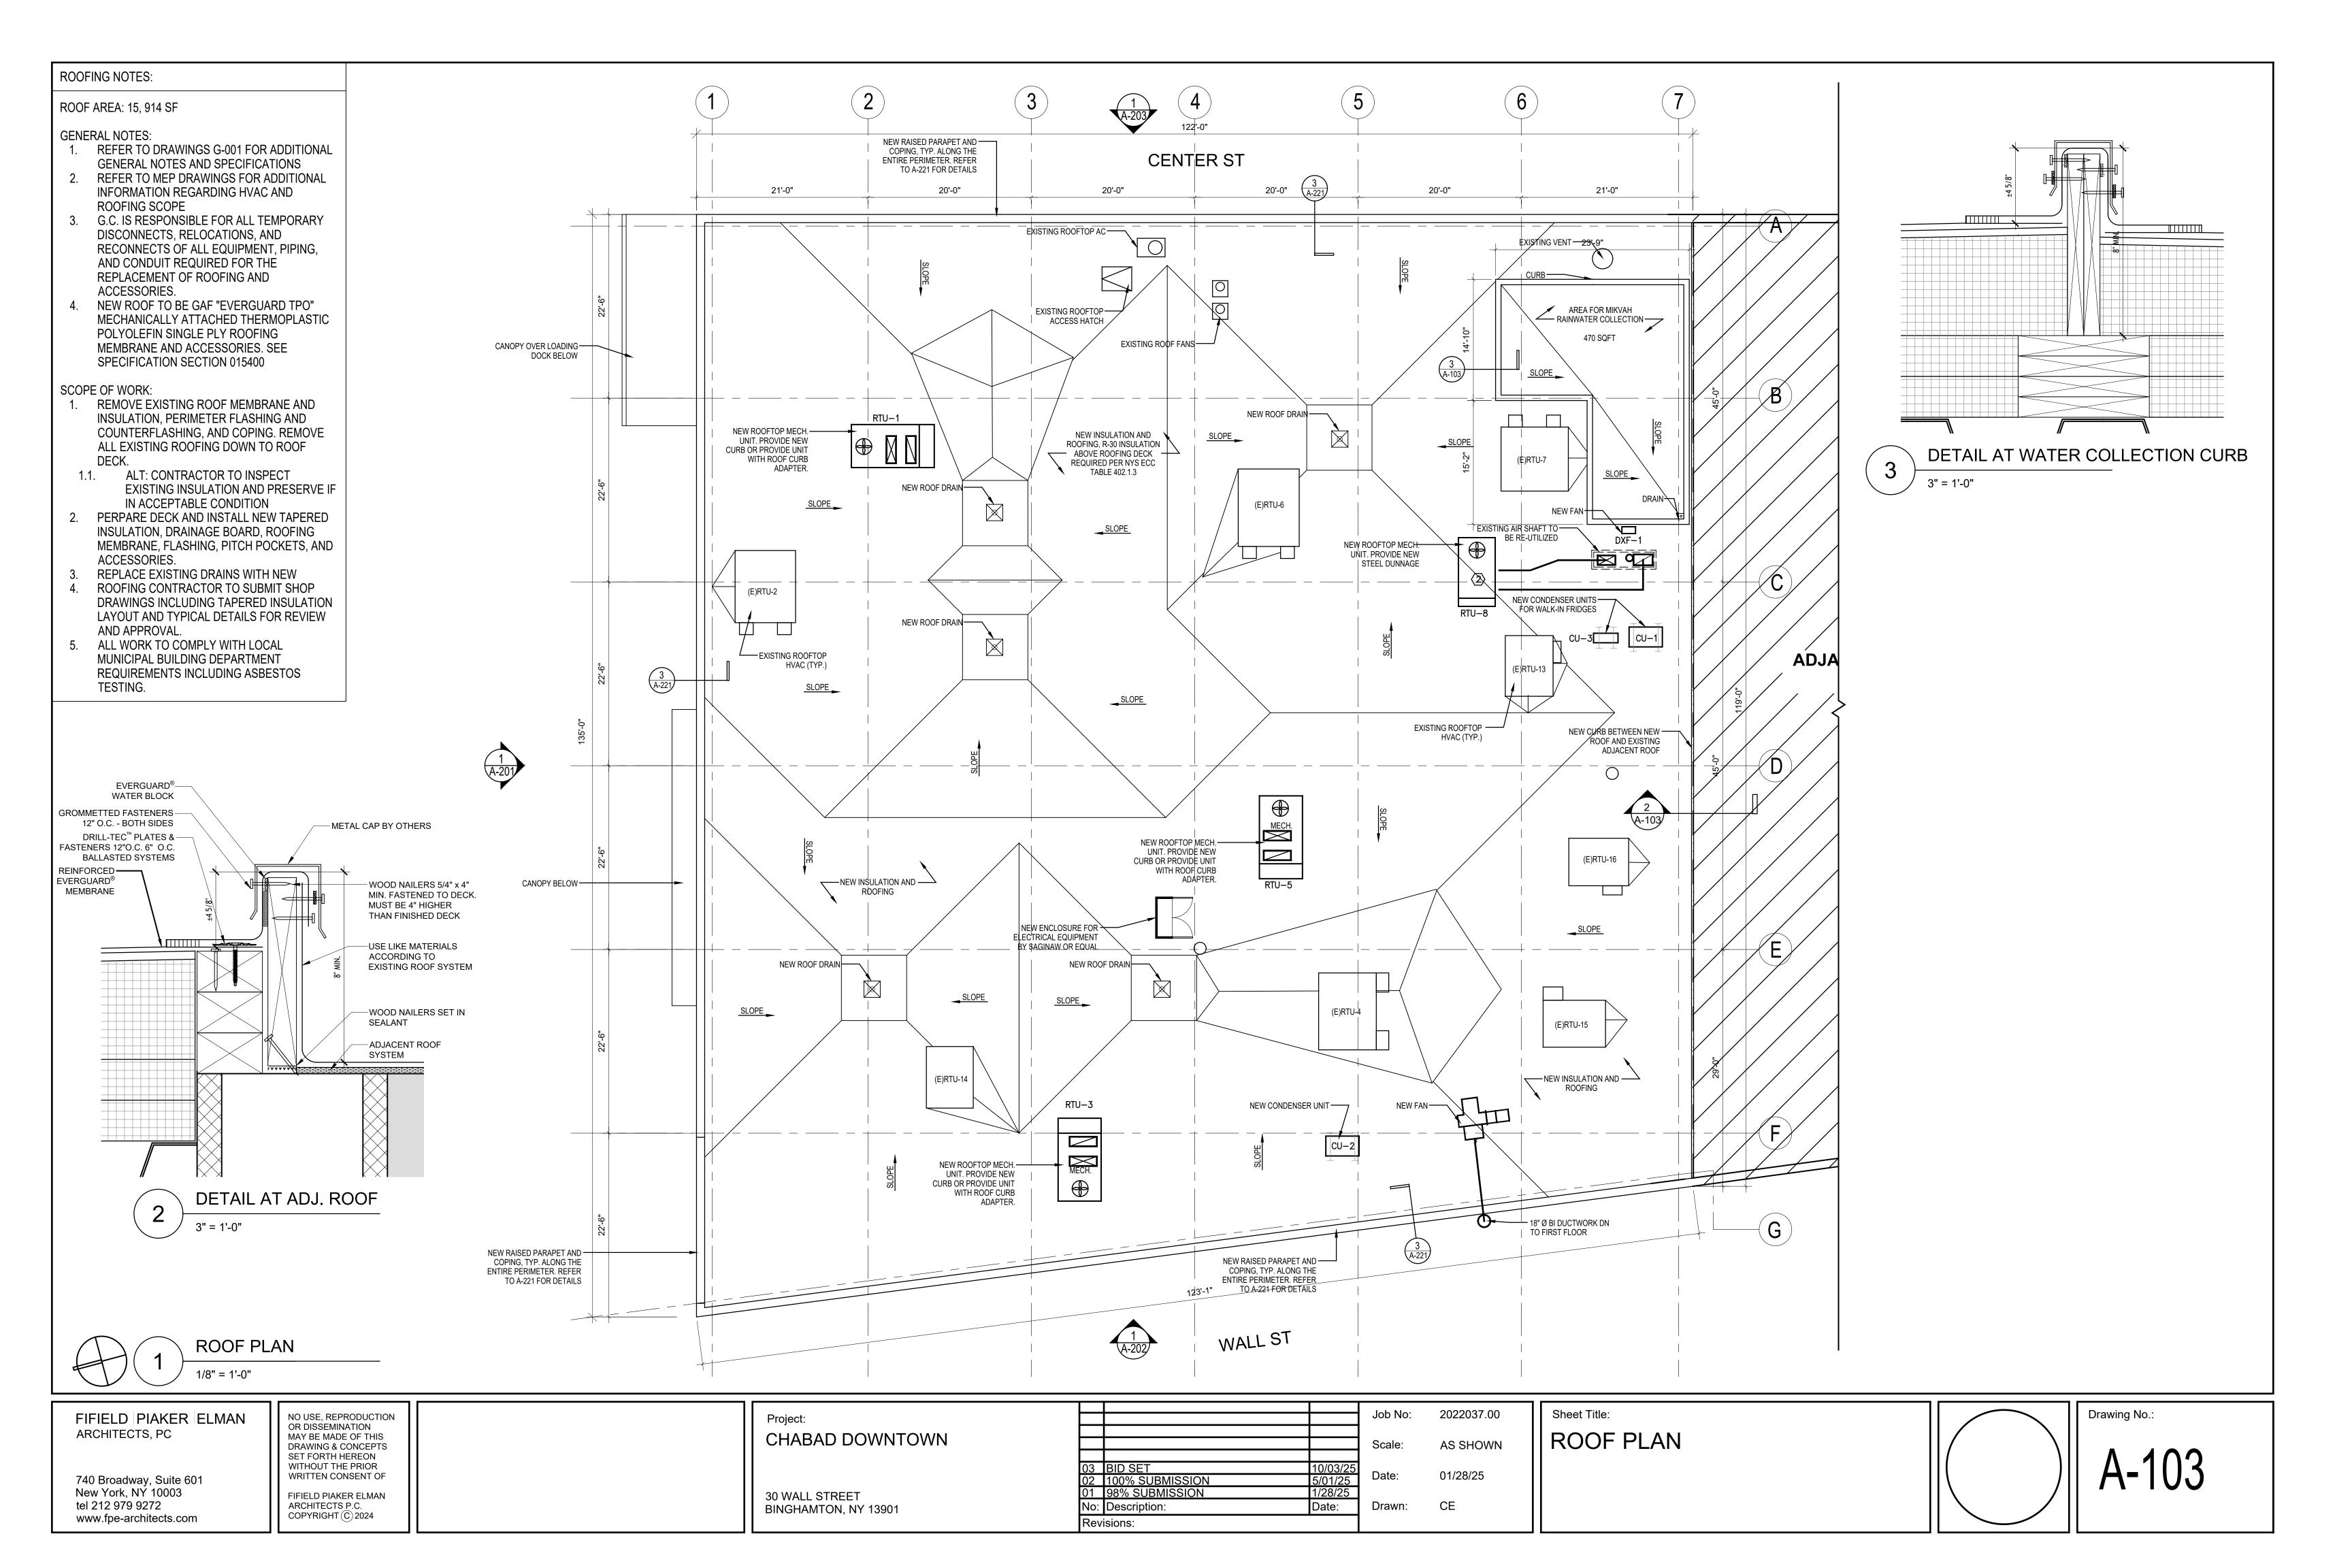

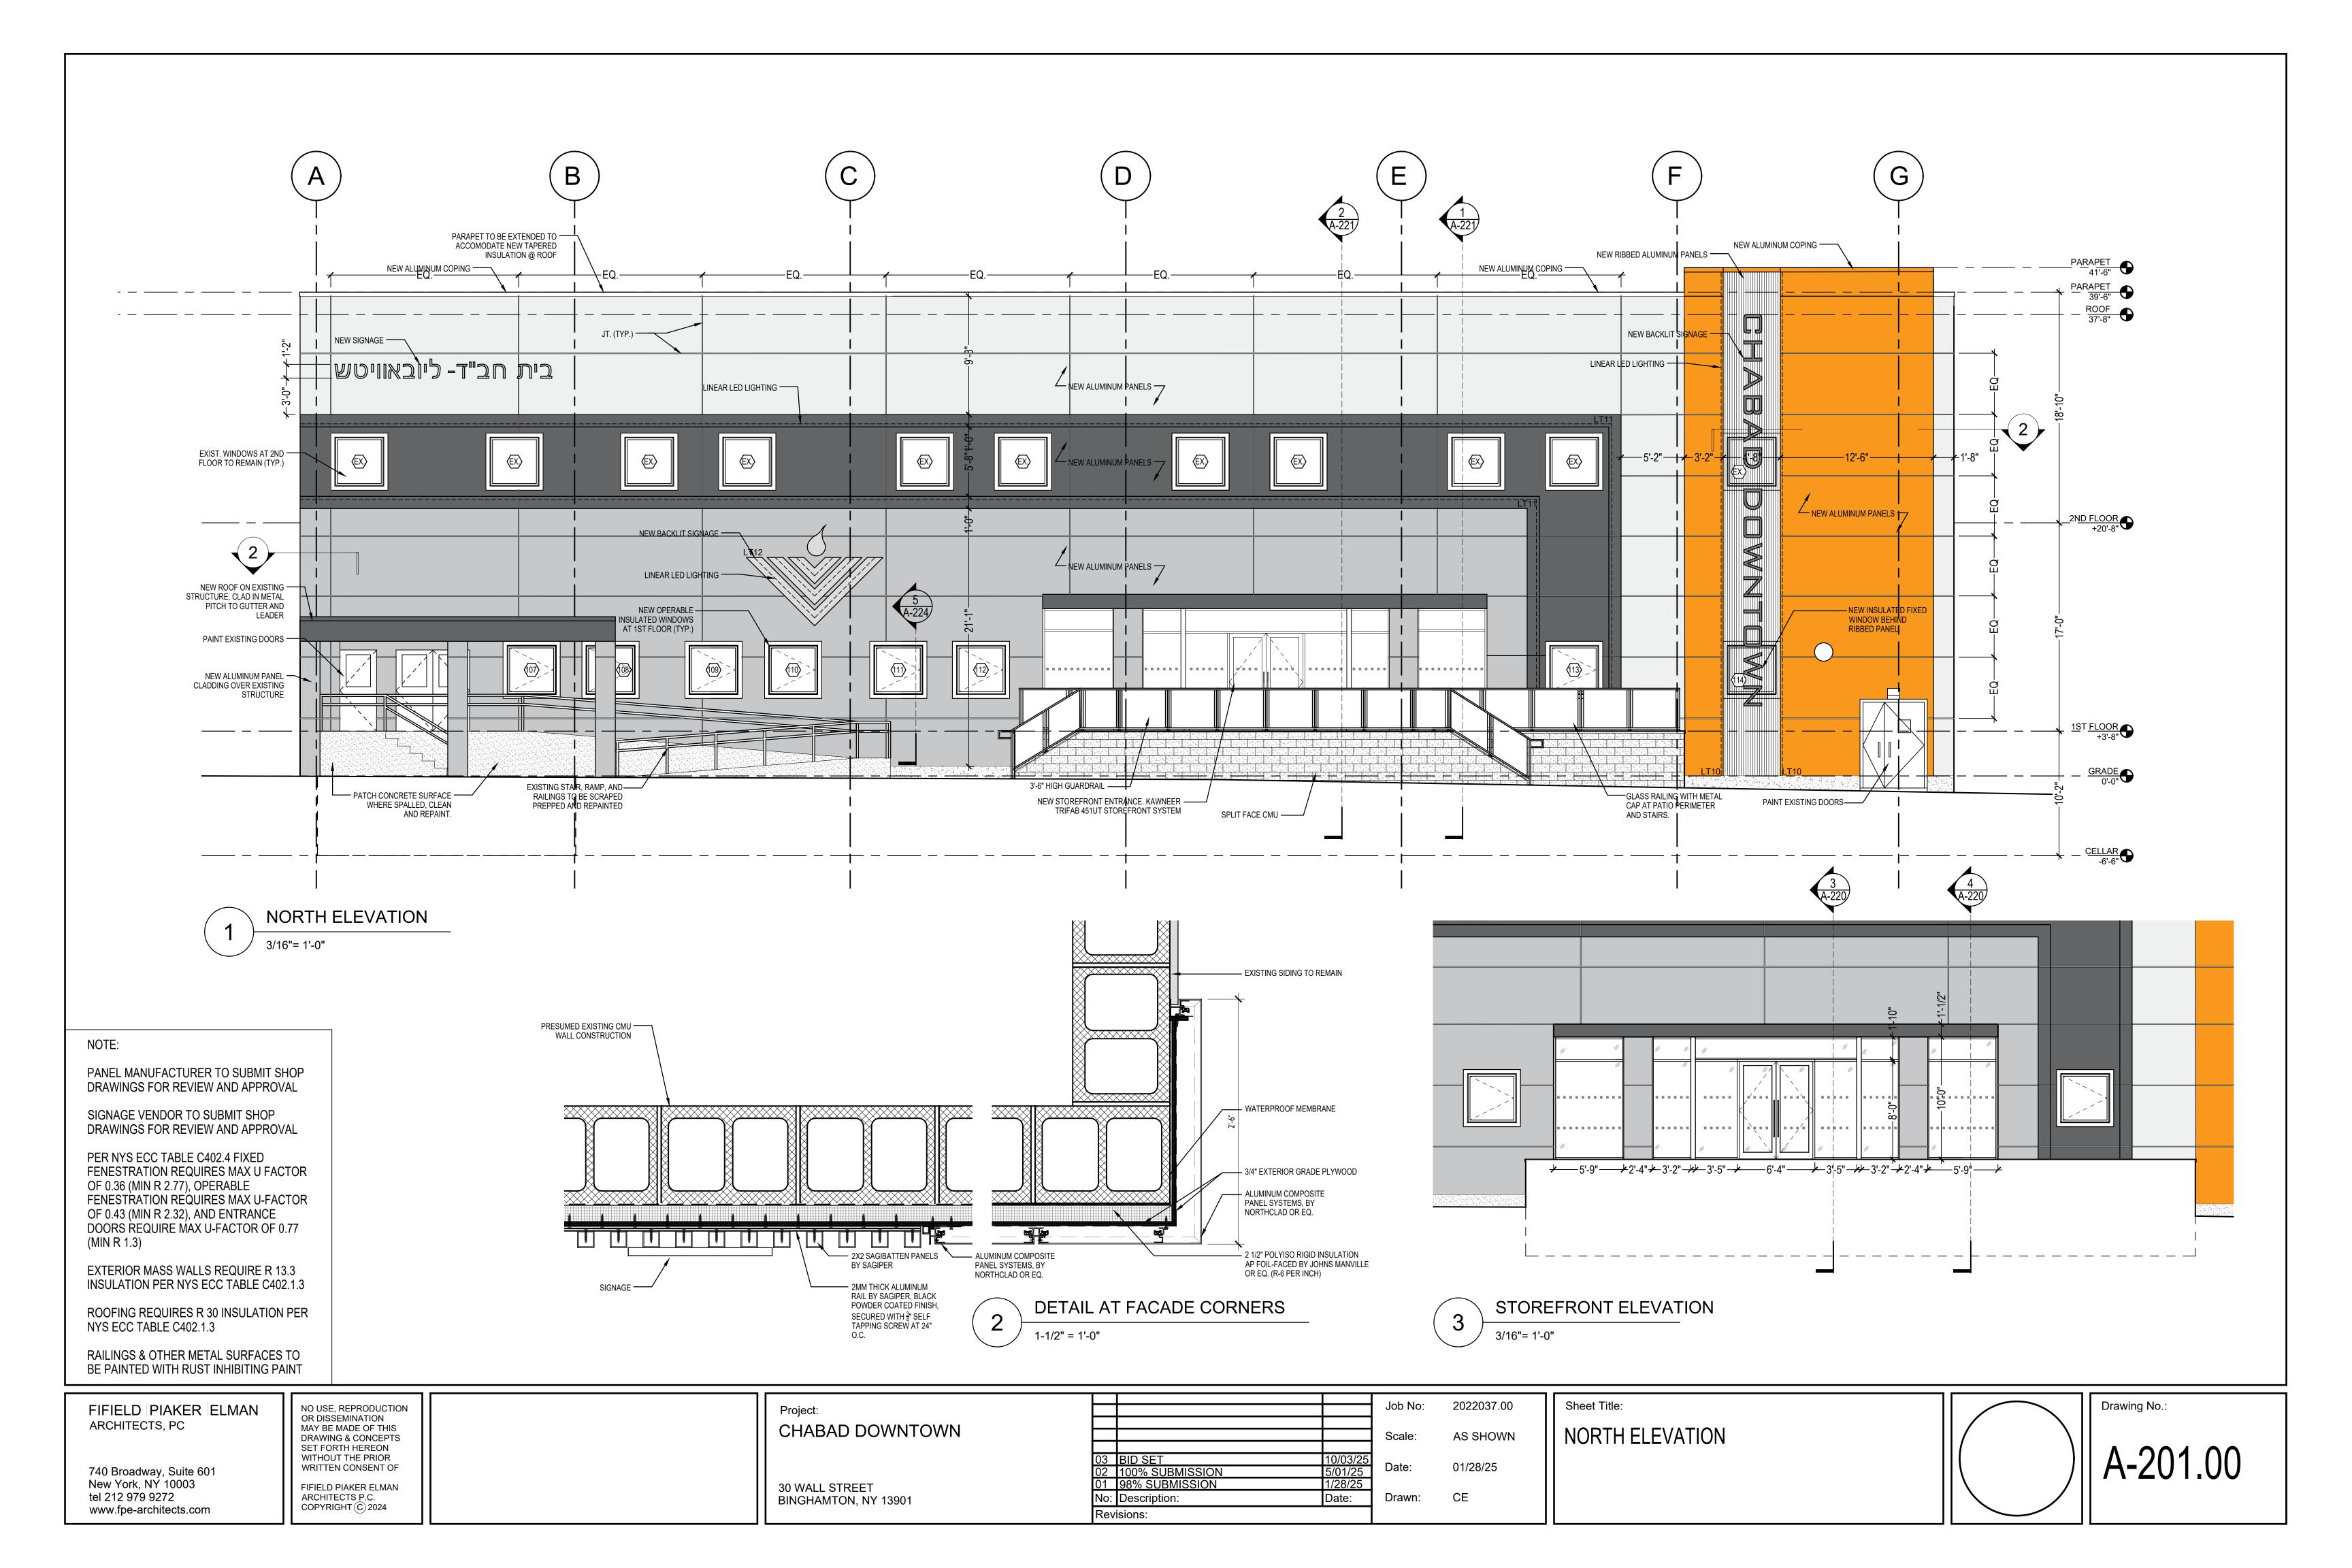

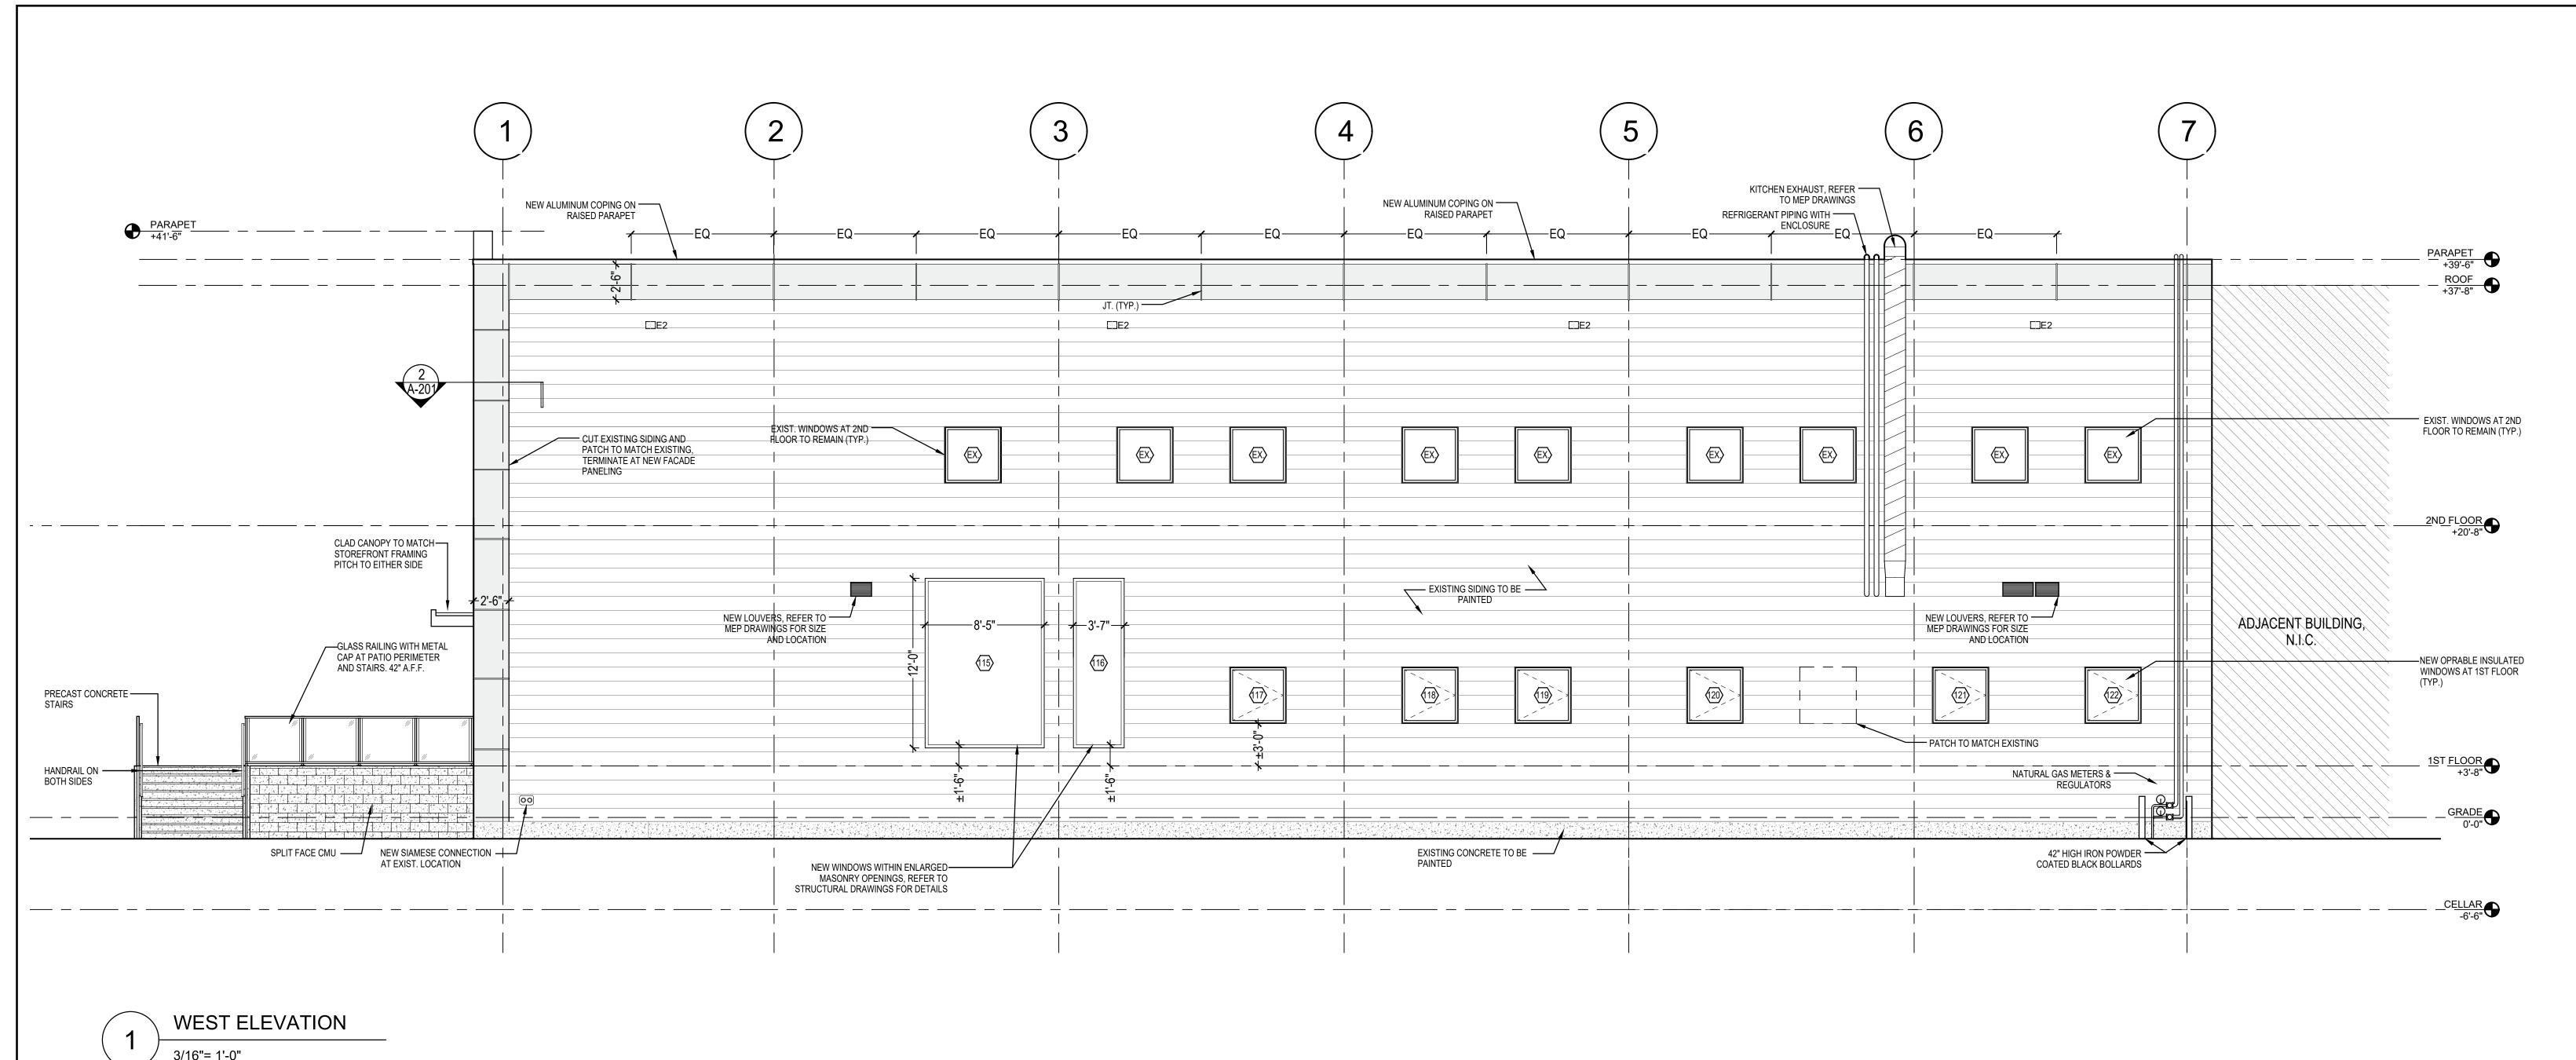

3/16"= 1'-0"

NOTE:

PER NYS ECC TABLE C402.4 FIXED FENESTRATION REQUIRES MAX U FACTOR OF 0.36 (MIN R 2.77), OPERABLE FENESTRATION REQUIRES MAX U-FACTOR OF 0.43 (MIN R 2.32), AND ENTRANCE DOORS REQUIRE MAX U-FACTOR OF 0.77 (MIN R 1.3)

EXTERIOR MASS WALLS REQUIRE R 13.3 INSULATION PER NYS ECC TABLE C402.1.3

ROOFING REQUIRES R 30 INSULATION PER NYS ECC TABLE C402.1.3

RAILINGS & OTHER METAL SURFACES TO BE PAINTED WITH RUST INHIBITING PAINT

FIFIELD PIAKER ELMAN ARCHITECTS, PC

740 Broadway, Suite 601 New York, NY 10003 tel 212 979 9272 www.fpe-architects.com

NO USE, REPRODUCTION OR DISSEMINATION MAY BE MADE OF THIS DRAWING & CONCEPTS
SET FORTH HEREON
WITHOUT THE PRIOR
WRITTEN CONSENT OF FIFIELD PIAKER ELMAN ARCHITECTS P.C. COPYRIGHT © 2024

Project: CHABAD DOWNTOWN

30 WALL STREET

BINGHAMTON, NY 13901

03 BID SET 02 100% SUBMISSION 10/03/25 5/01/25 01 98% SUBMISSION 1/28/25 No: Description: Date: Revisions:

Sheet Title: SOUTH ELEVATION

Job No: 2022037.00

Scale:


Drawn:


AS SHOWN

01/28/25

CE


Drawing No.: A-202.00

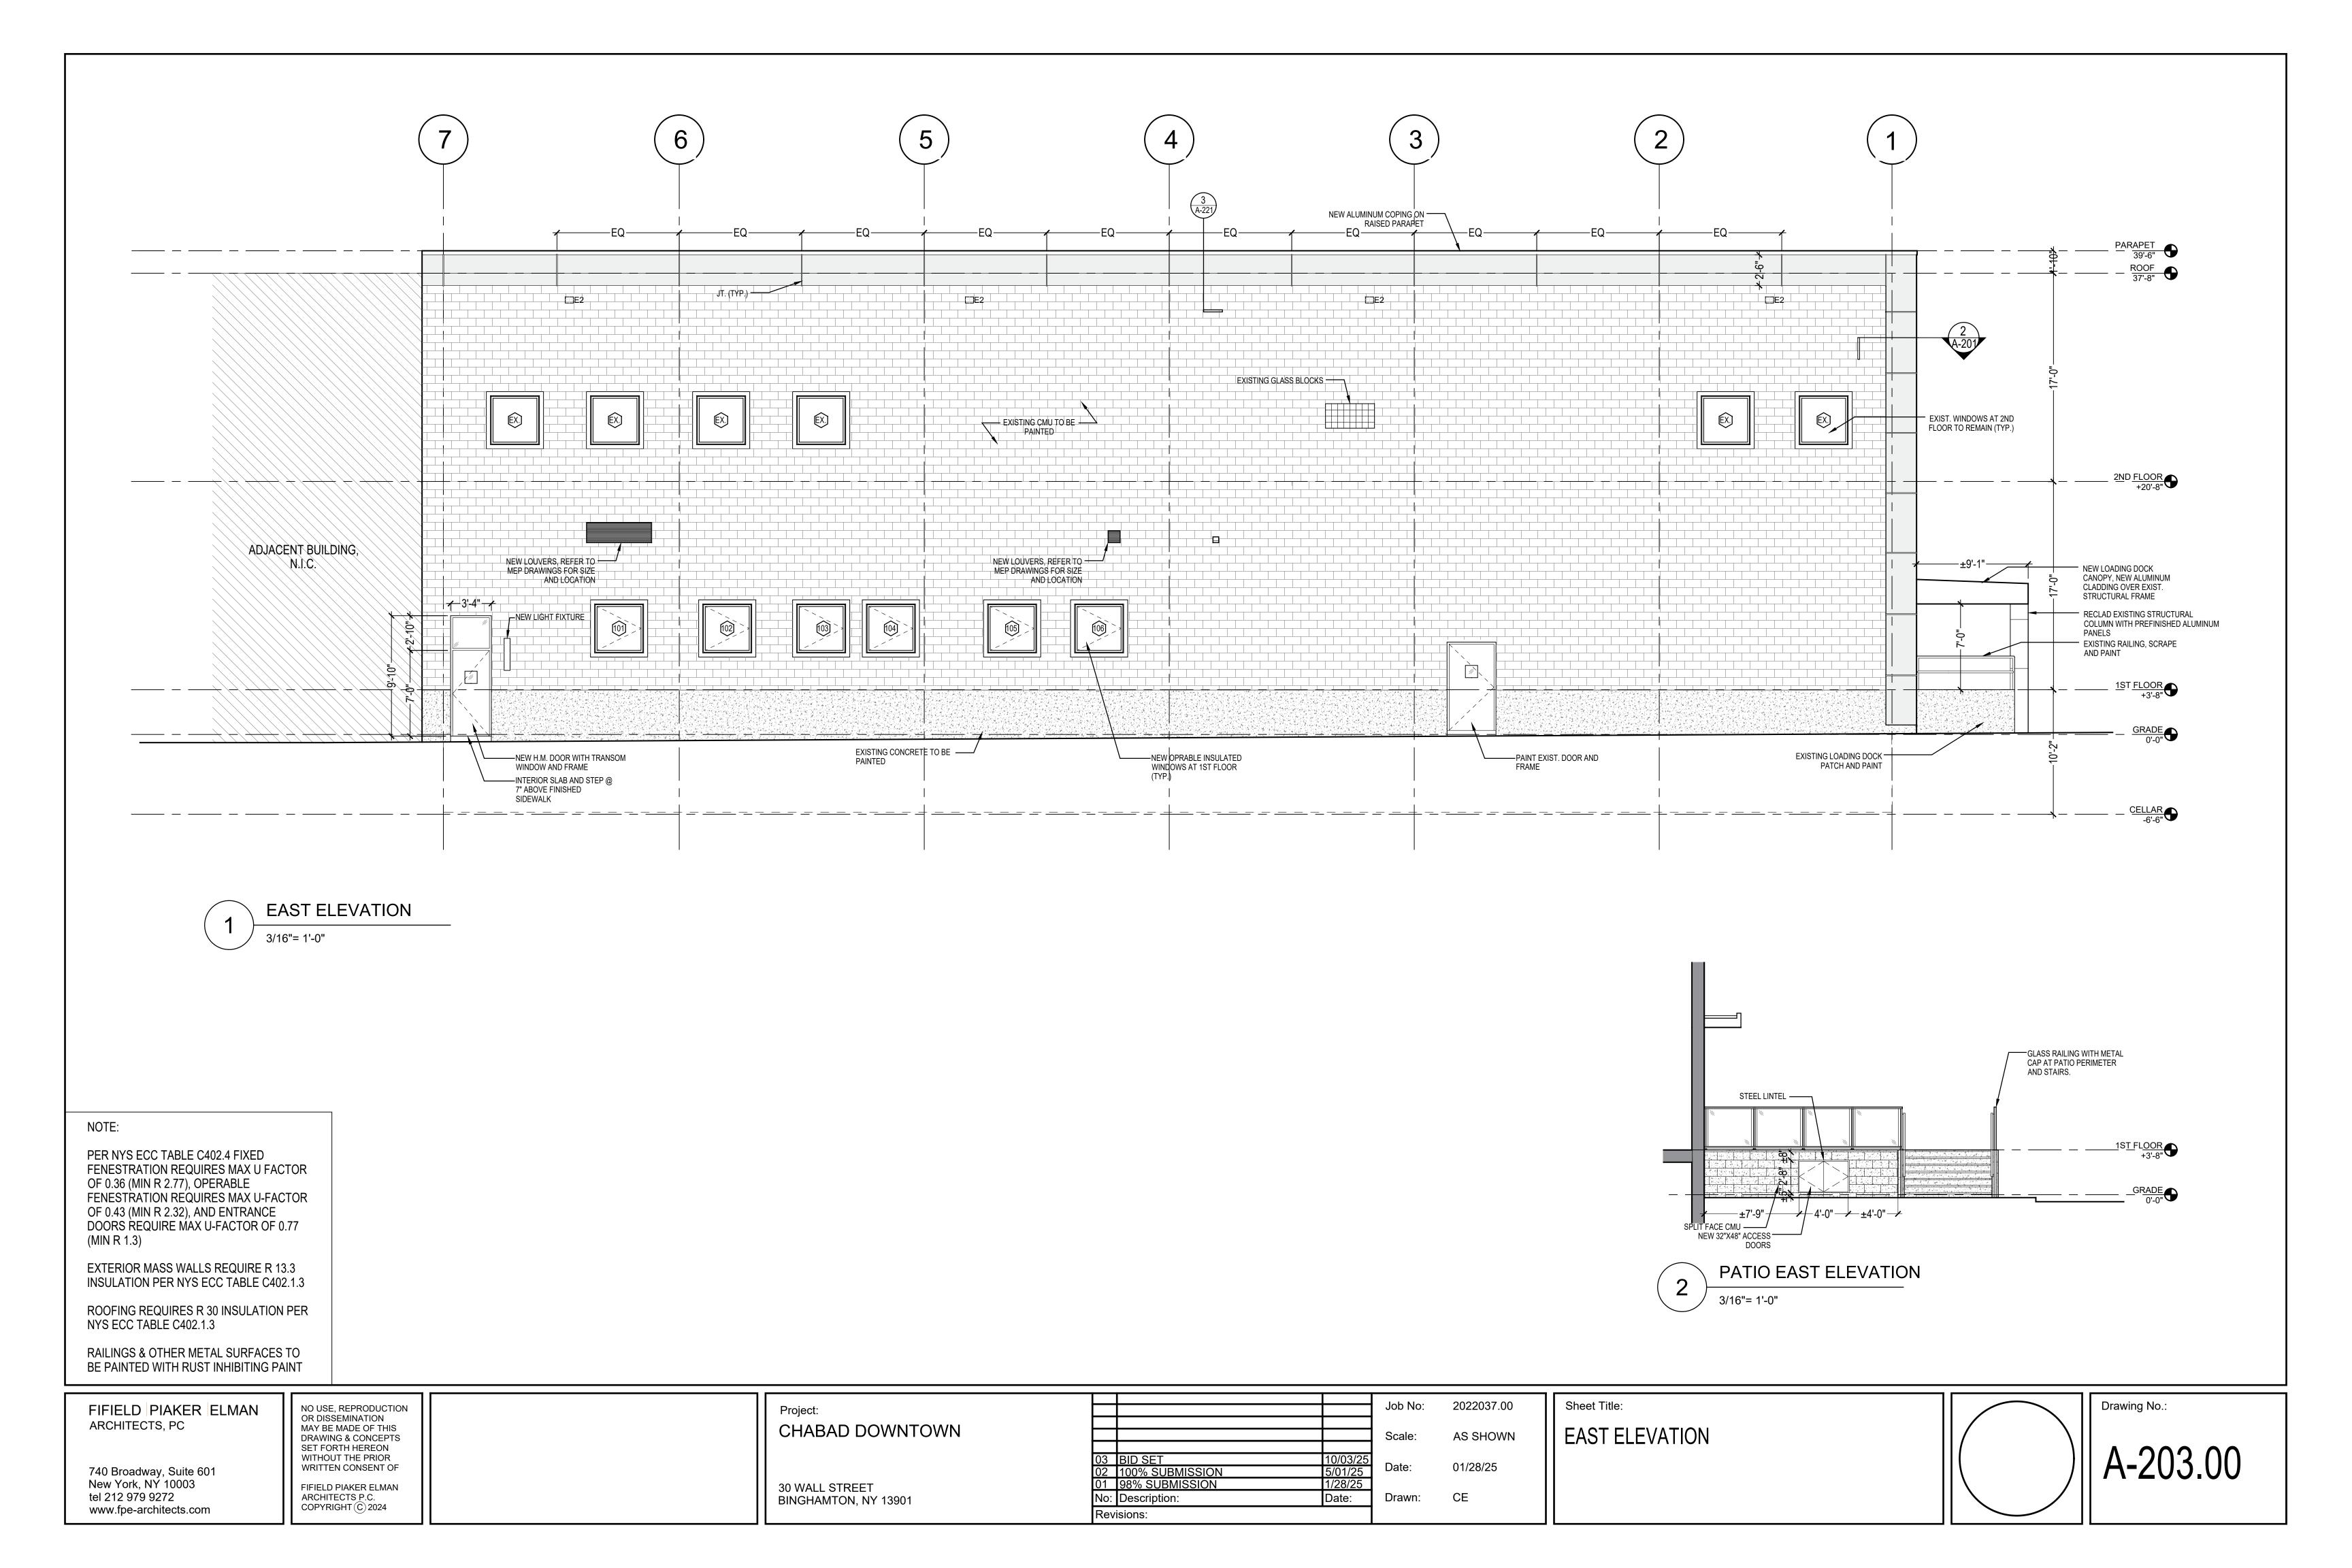

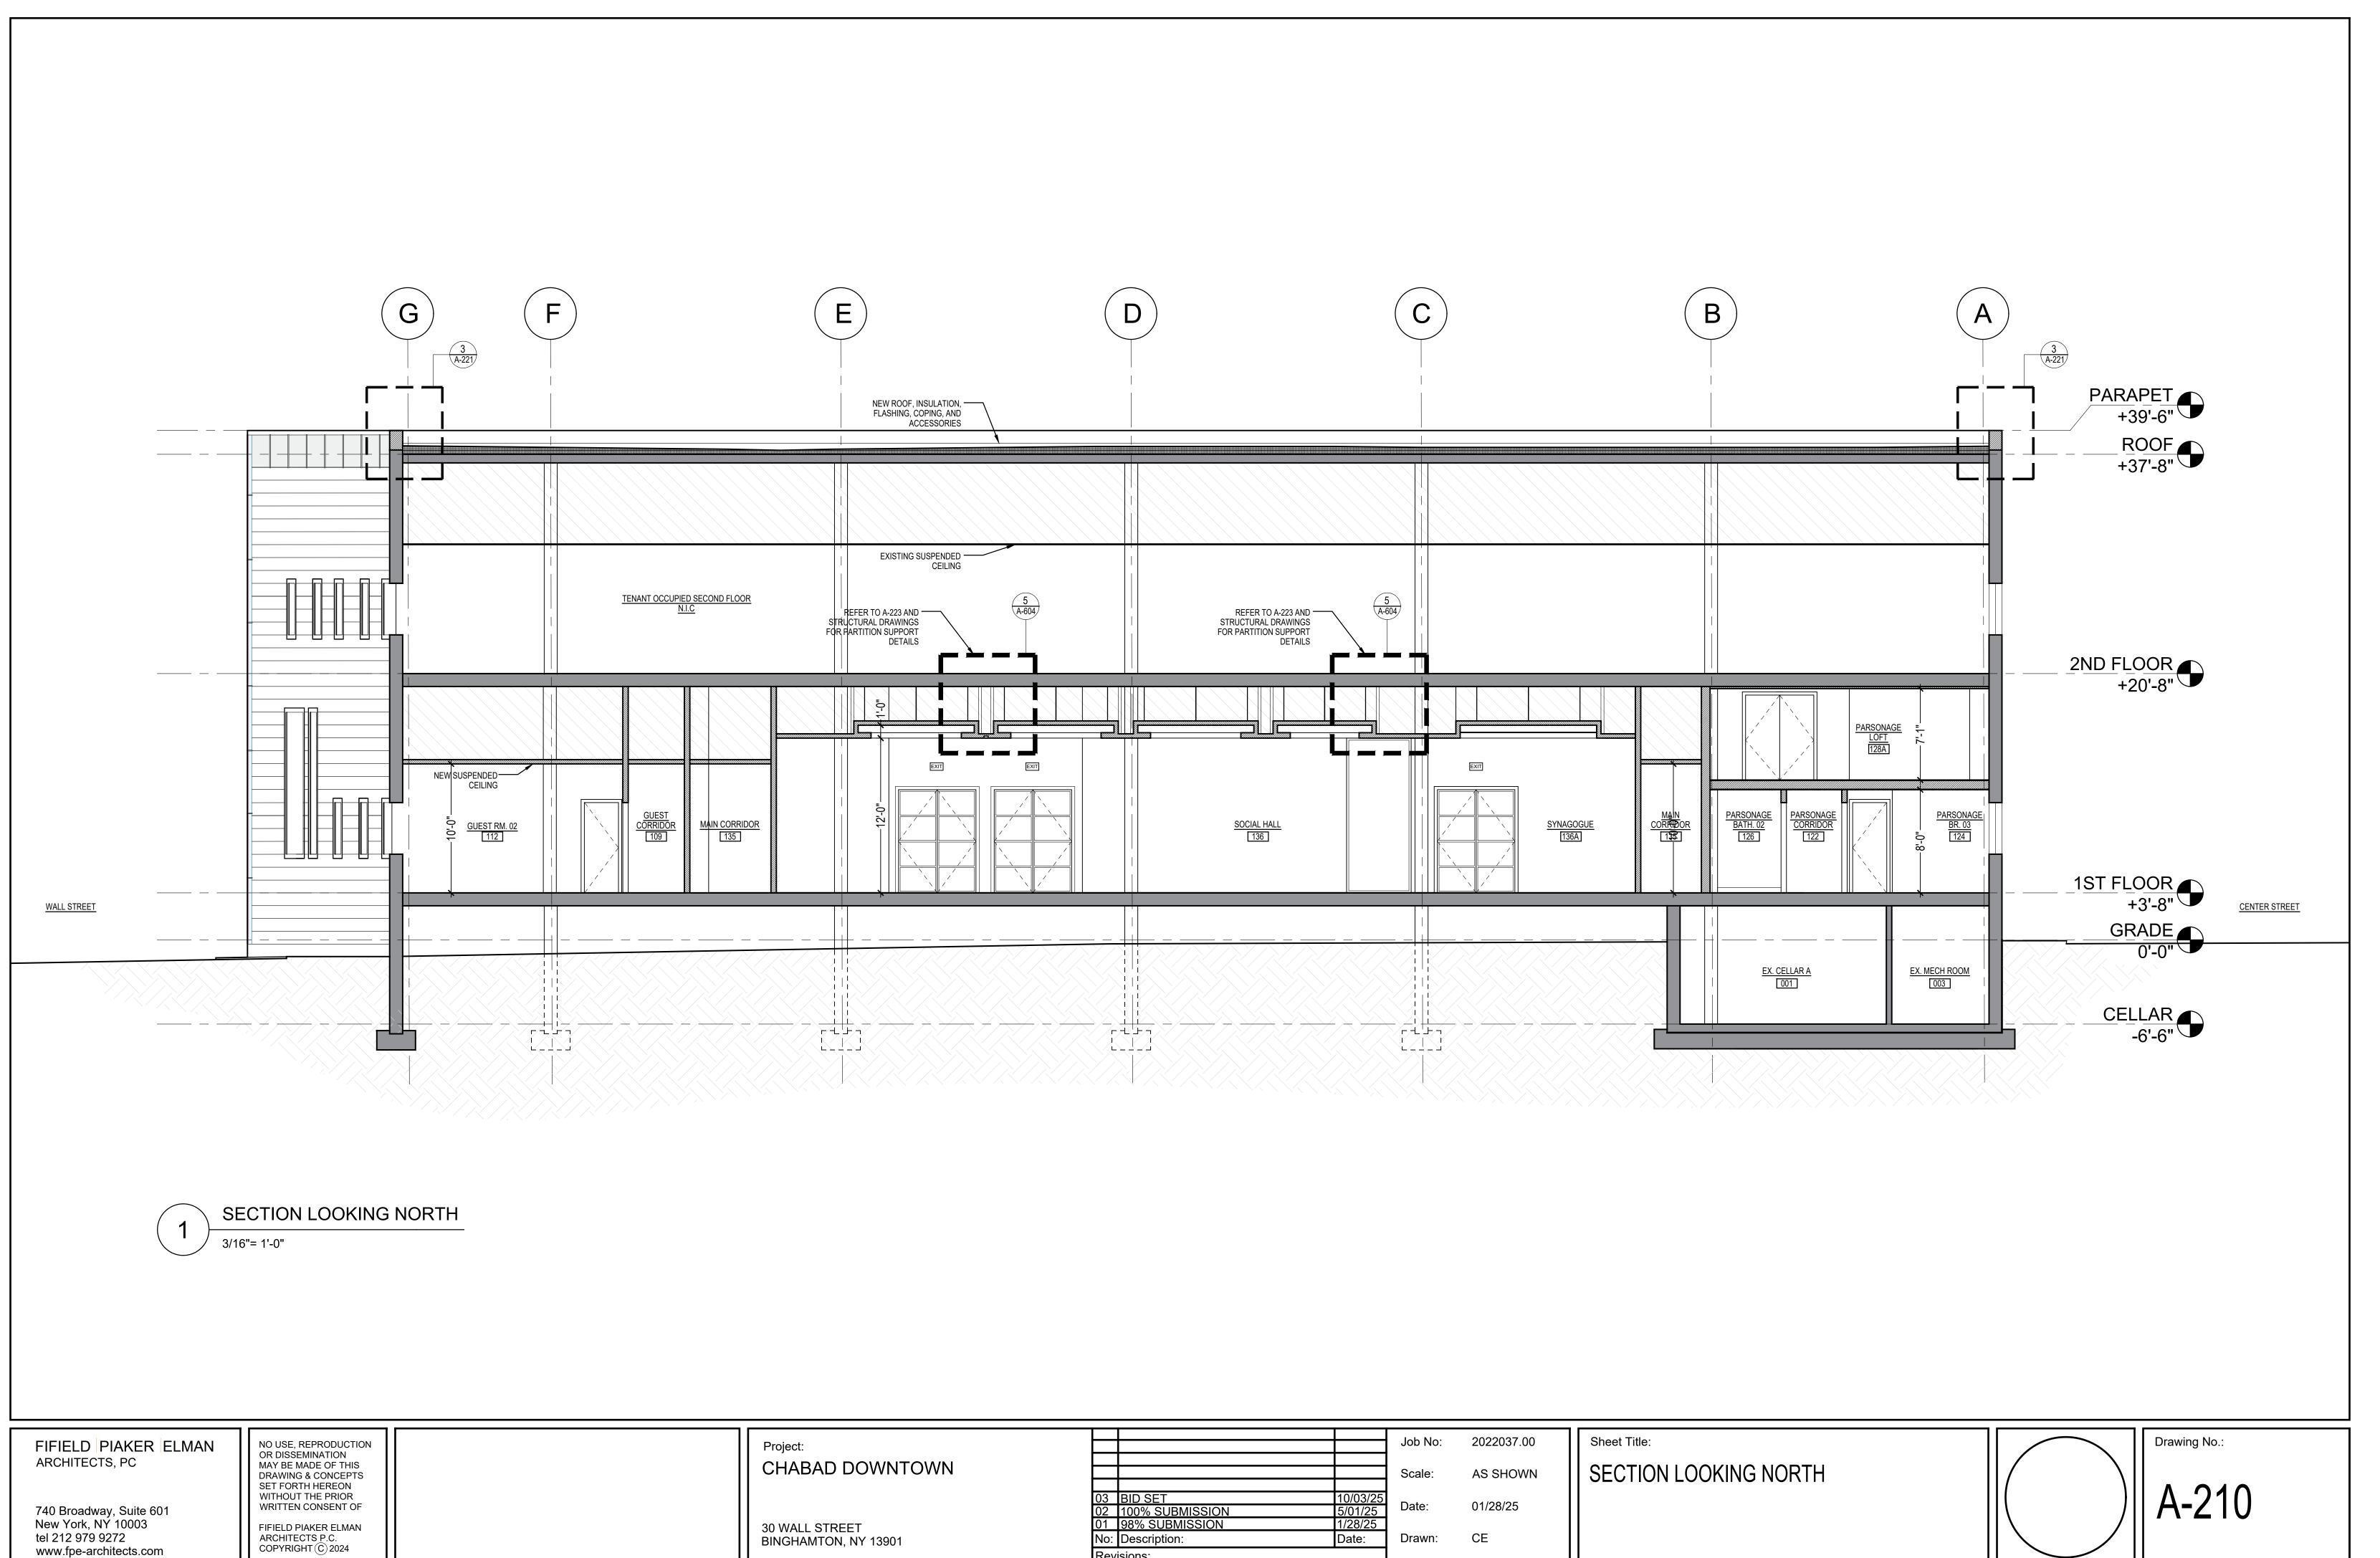

tel 212 979 9272 www.fpe-architects.com 30 WALL STREET BINGHAMTON, NY 13901

Date: No: Description: CE Drawn: Revisions:

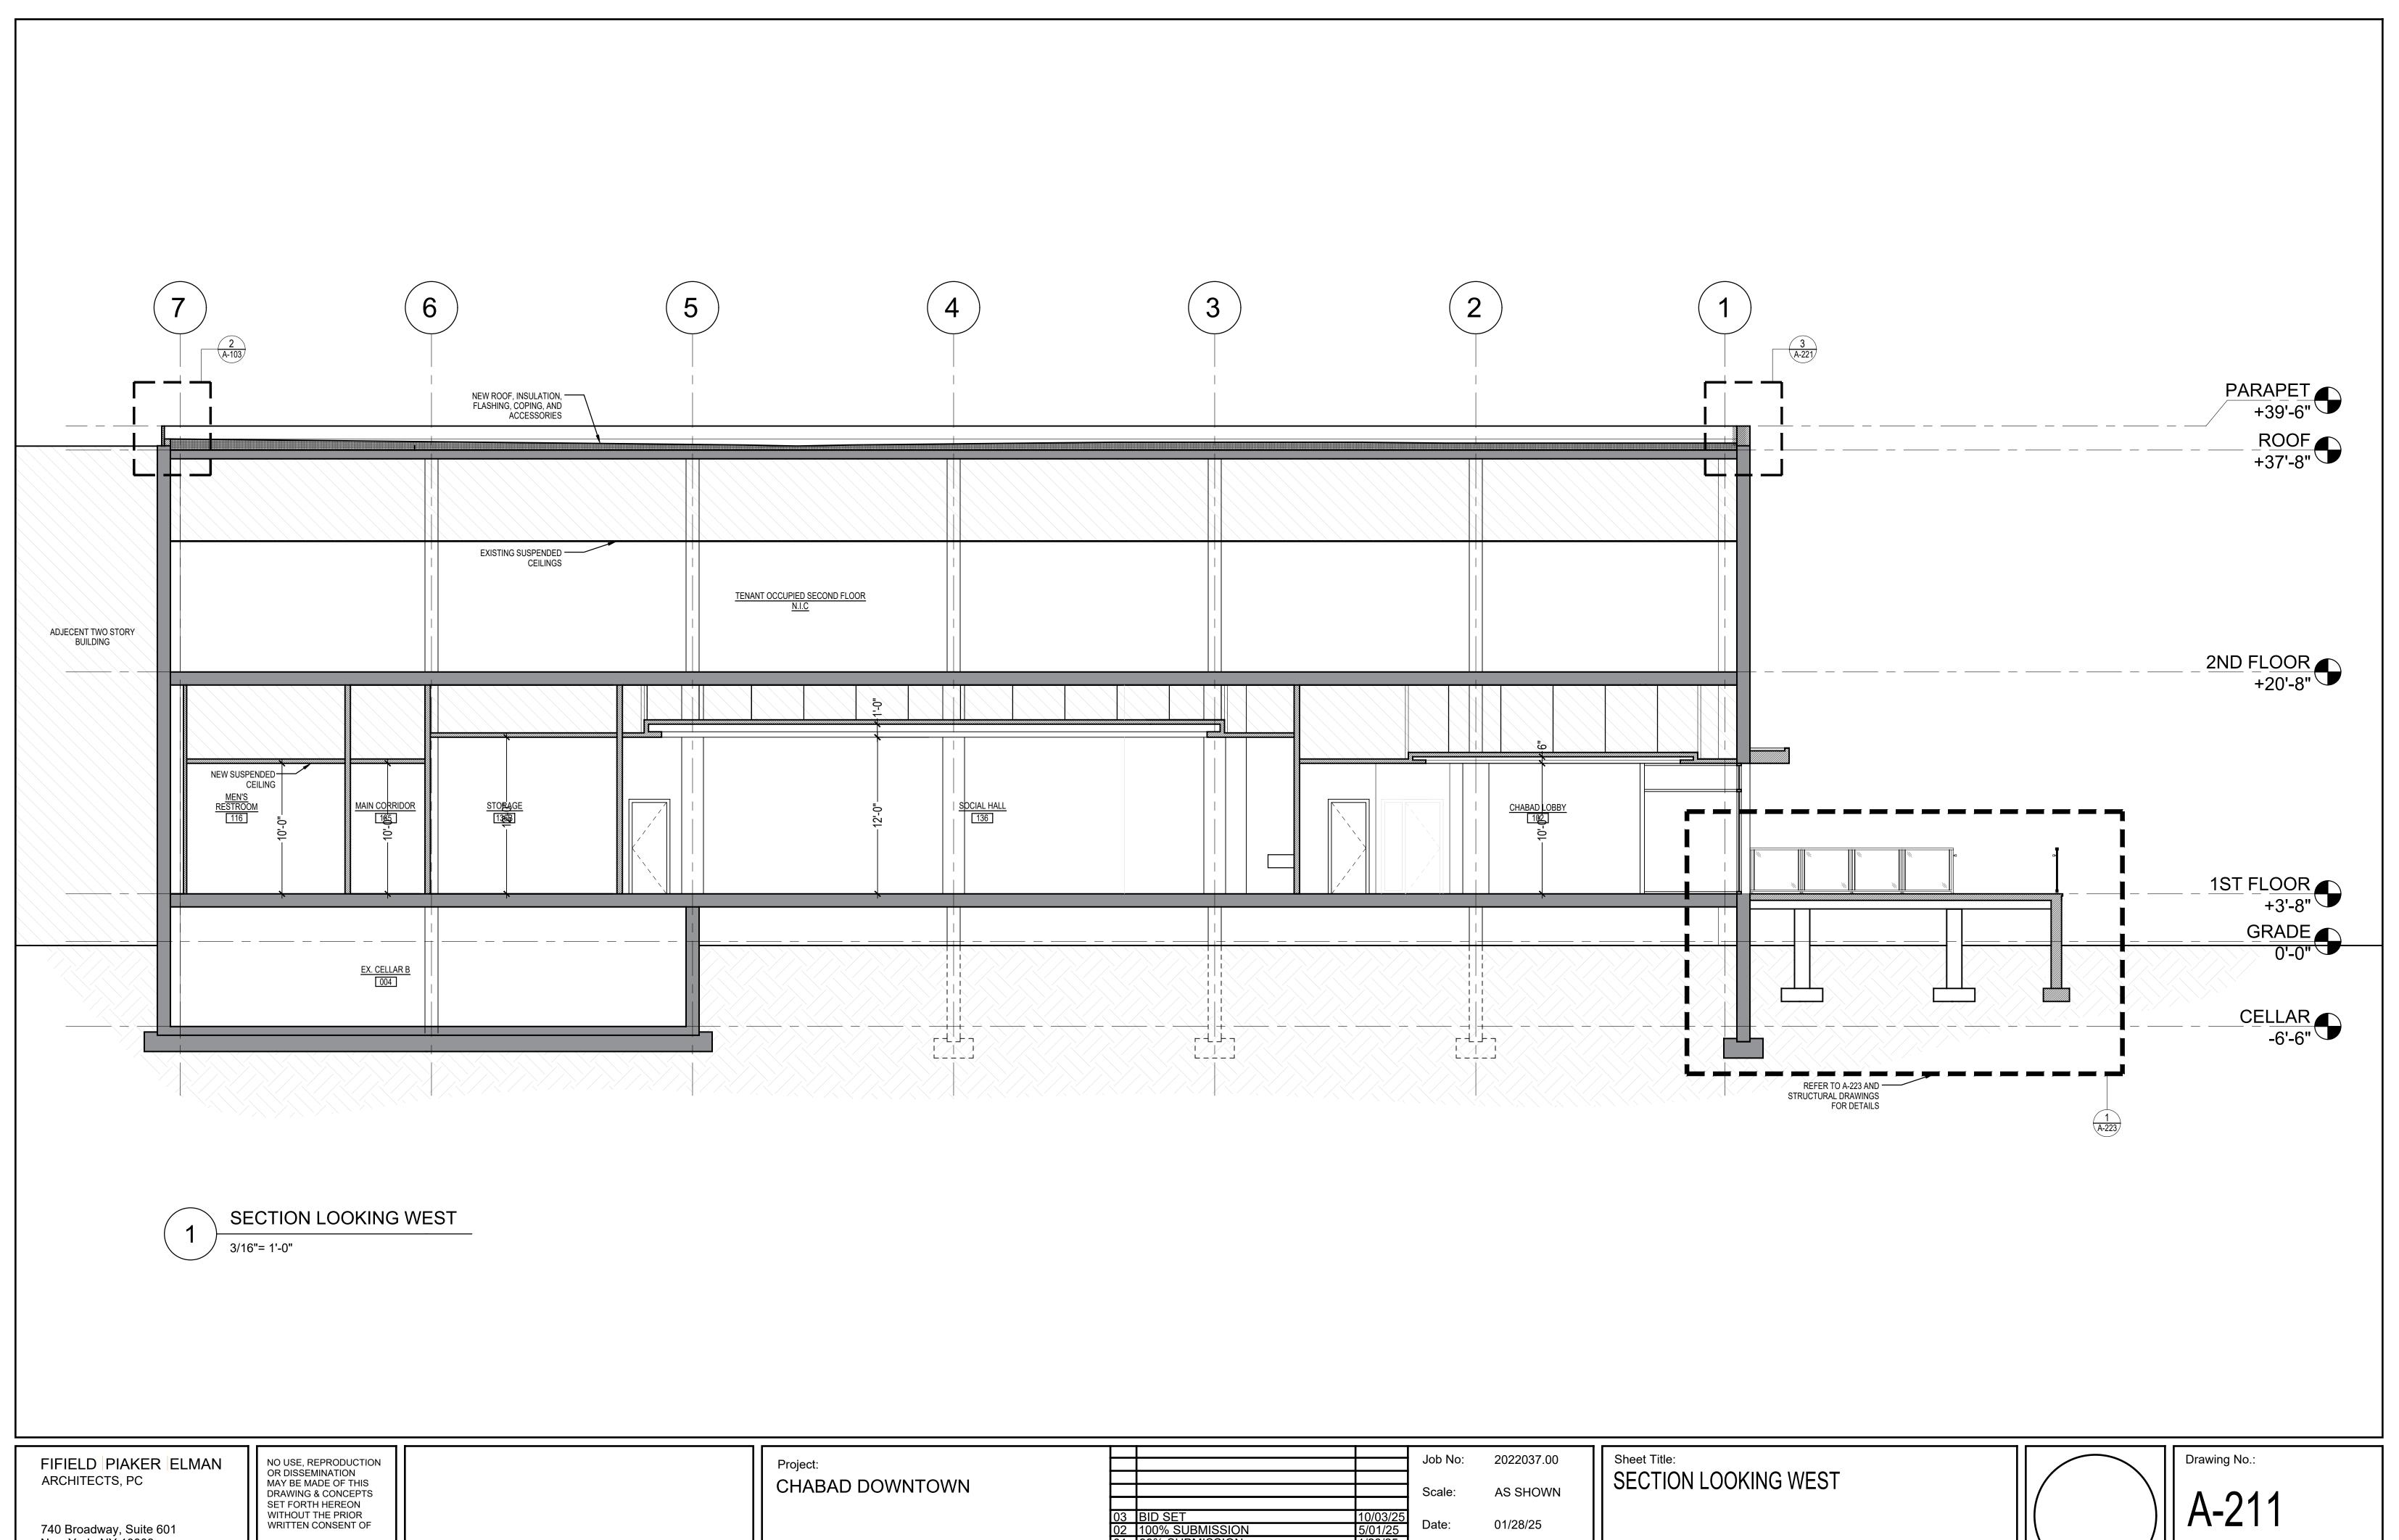



740 Broadway, Suite 601 New York, NY 10003 tel 212 979 9272 www.fpe-architects.com


FIFIELD PIAKER ELMAN ARCHITECTS P.C. COPYRIGHT © 2024


30 WALL STREET BINGHAMTON, NY 13901


03 BID SET
02 100% SUBMISSION
01 98% SUBMISSION
No: Description: 10/03/25 5/01/25 1/28/25 Date: Drawn: Revisions:

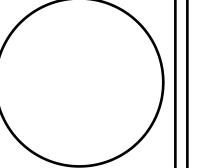


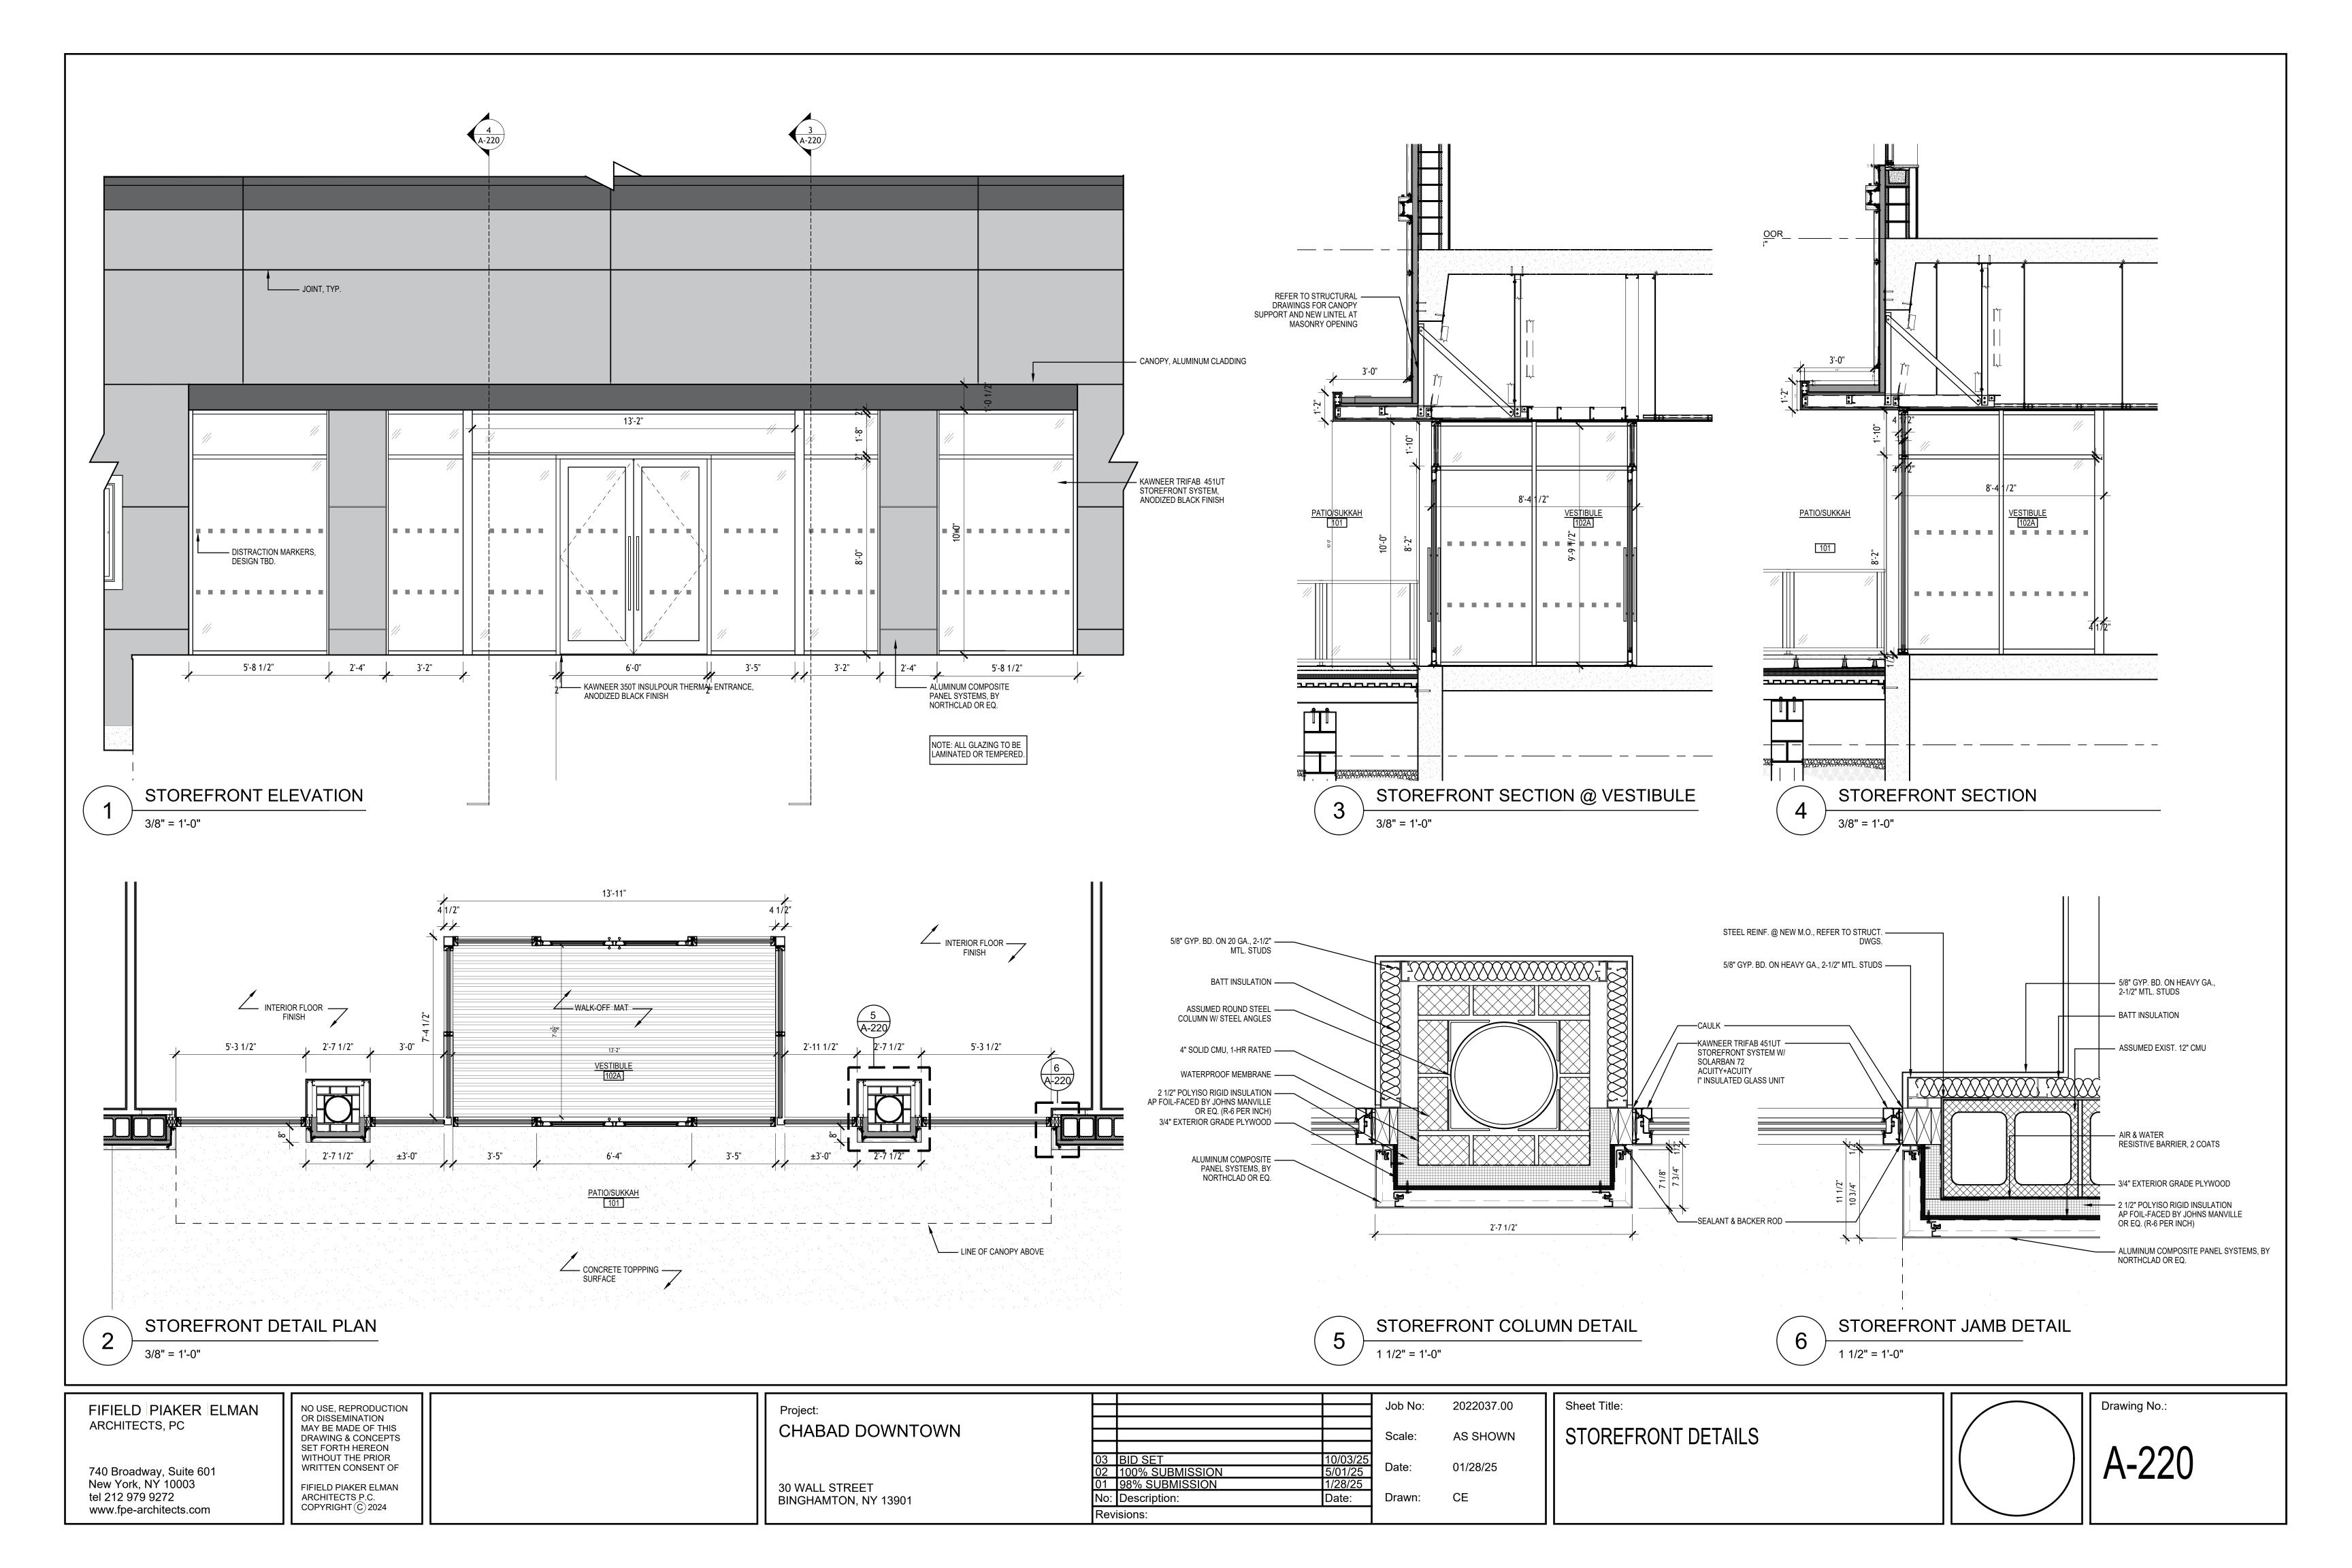


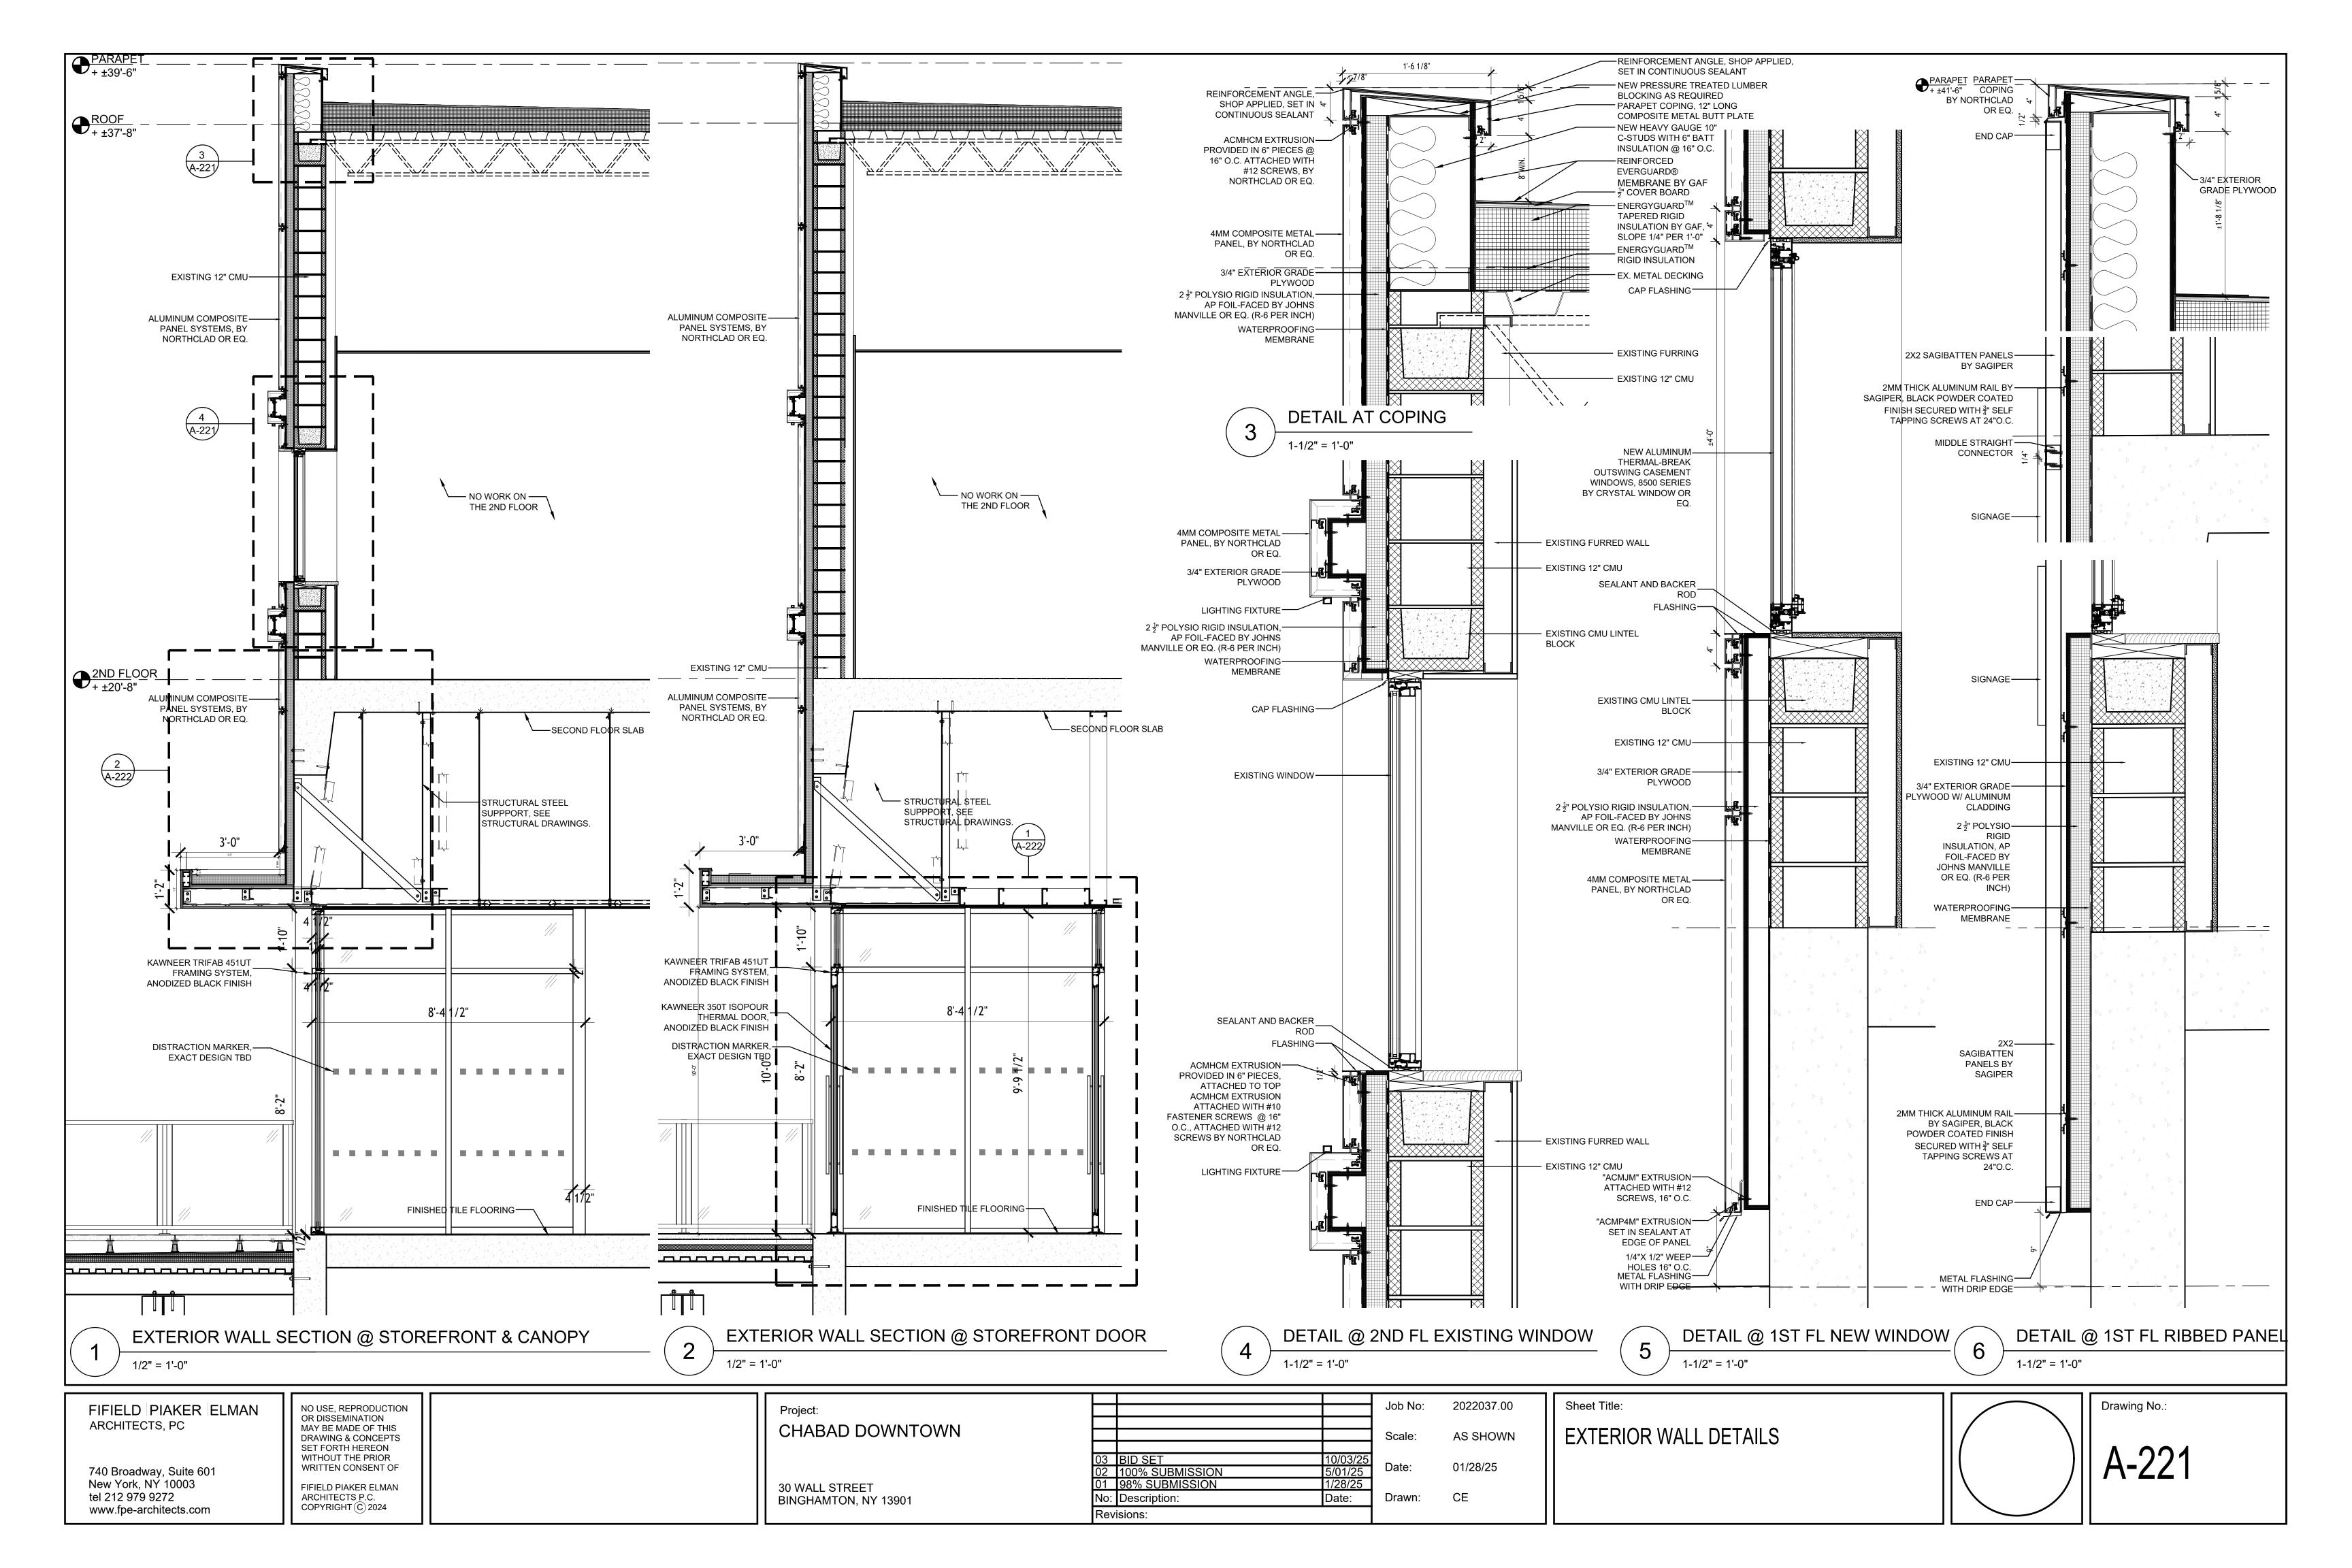


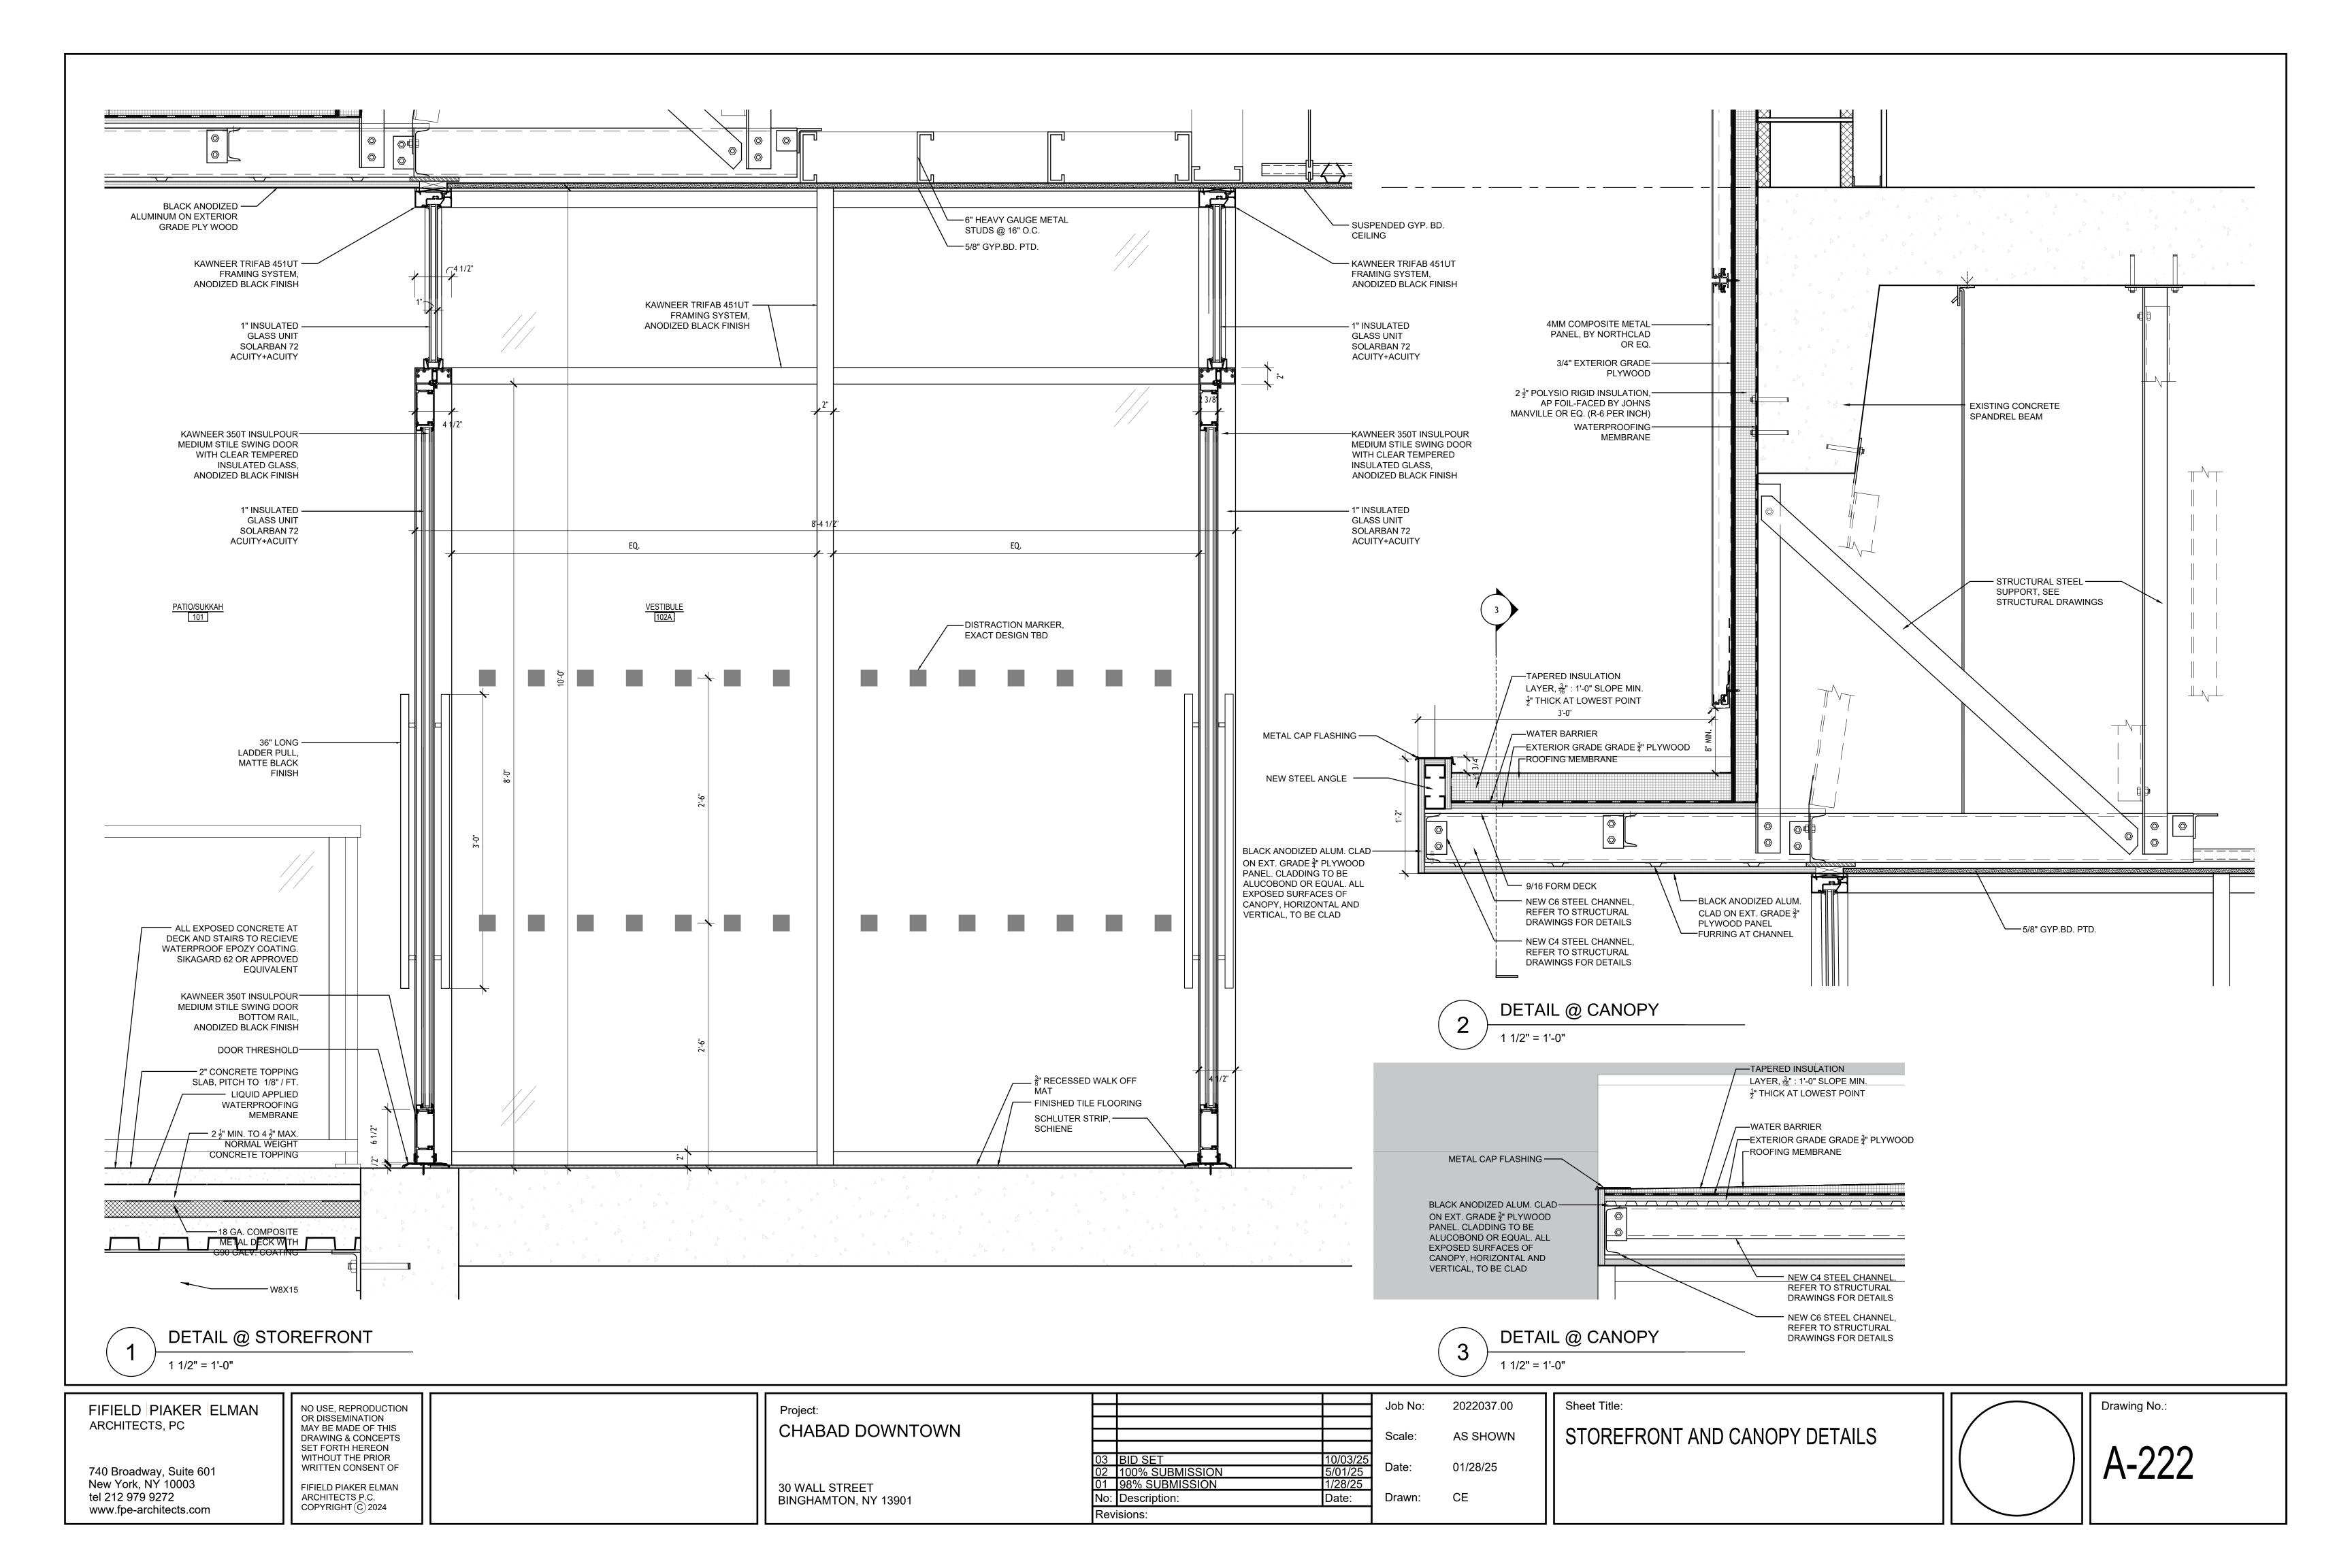


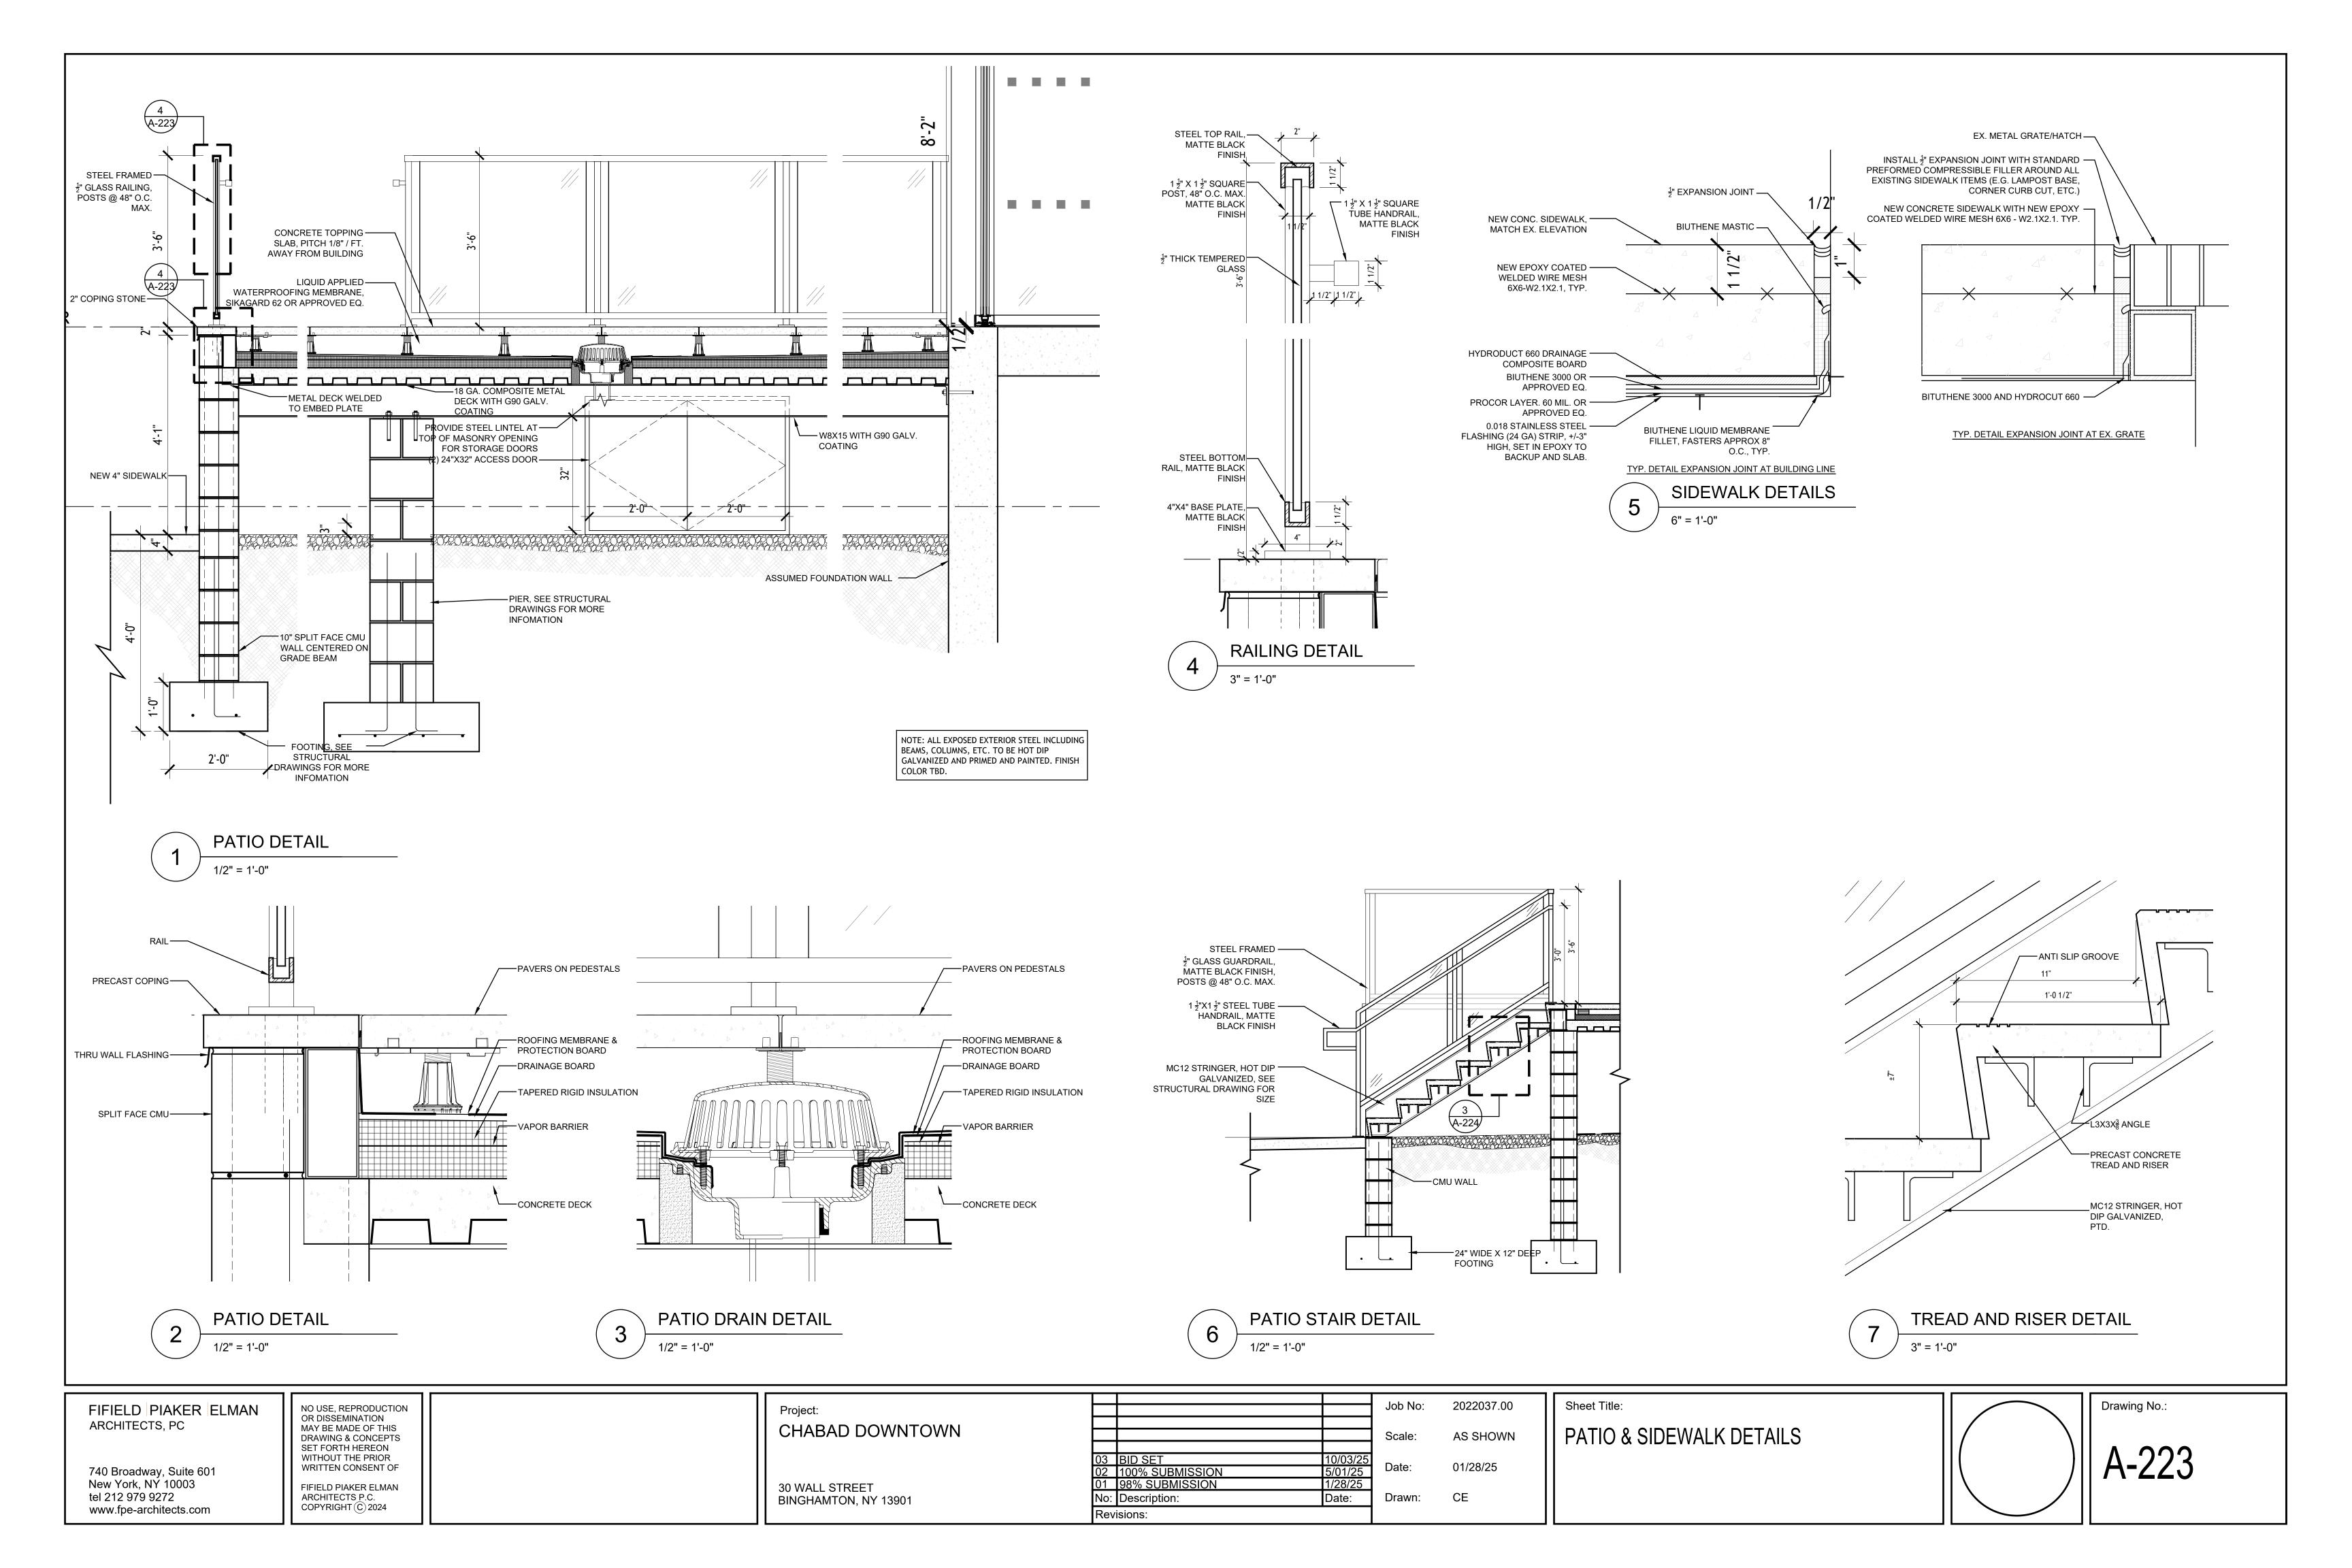


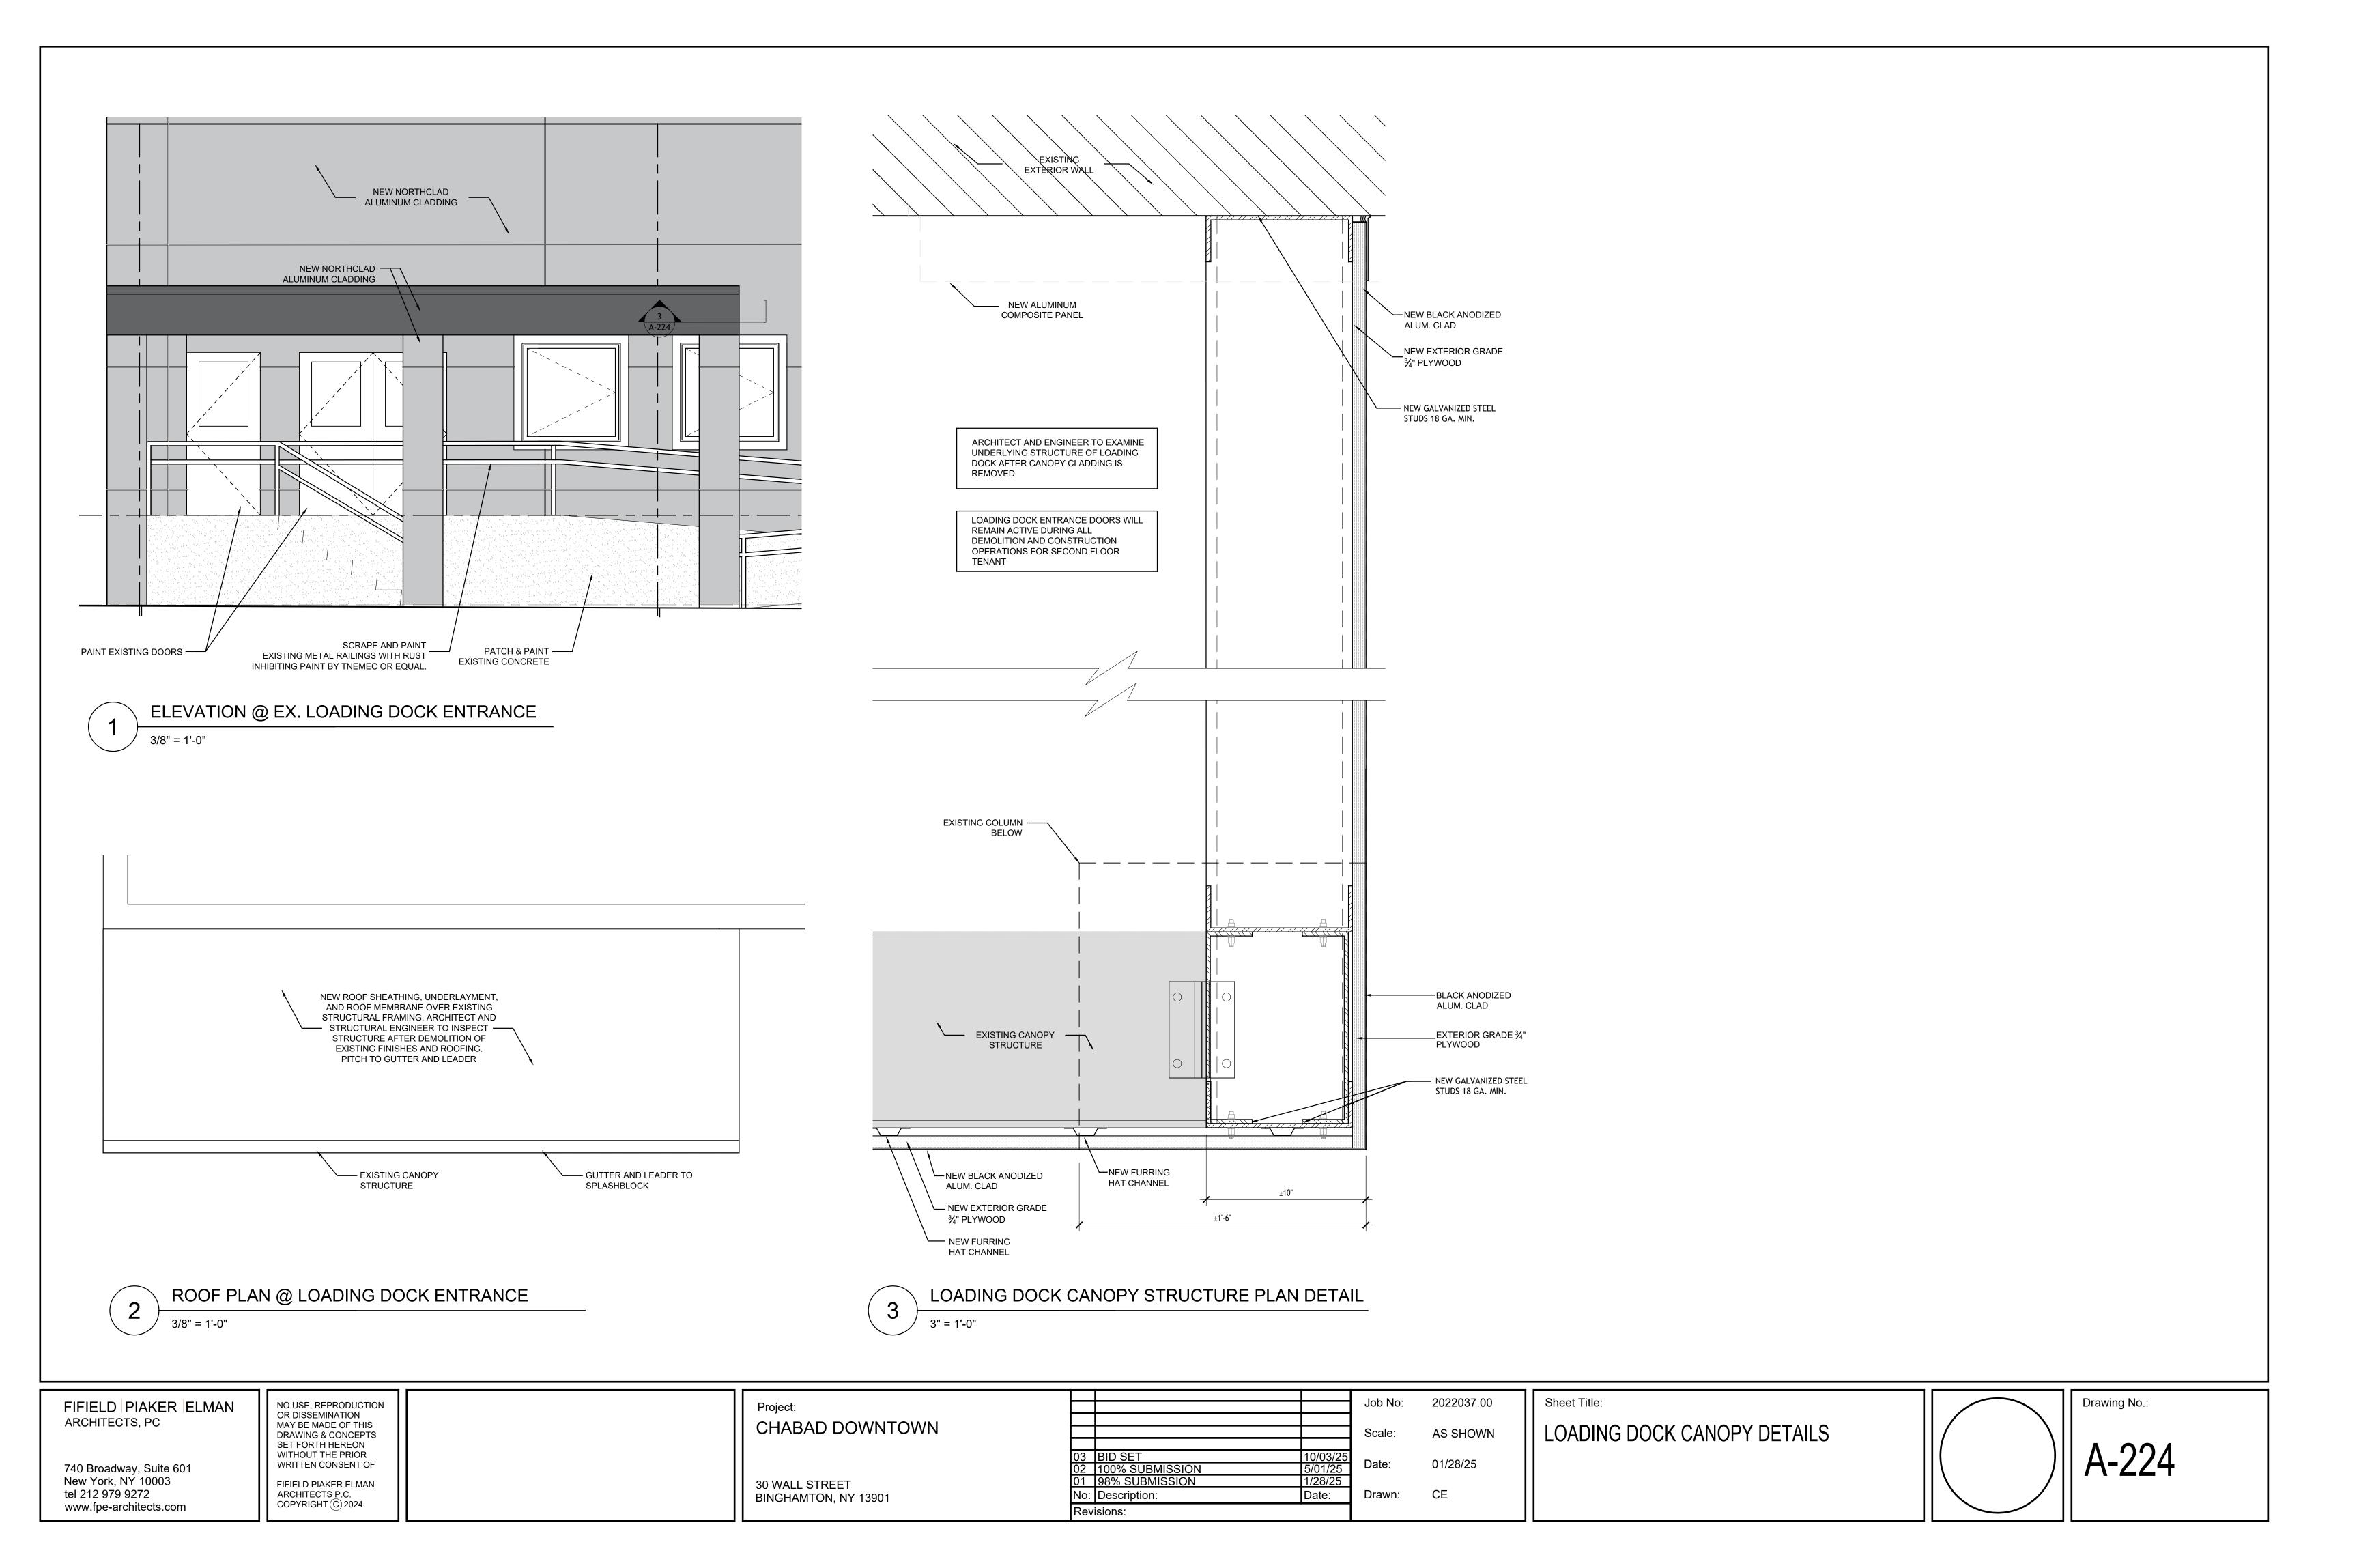


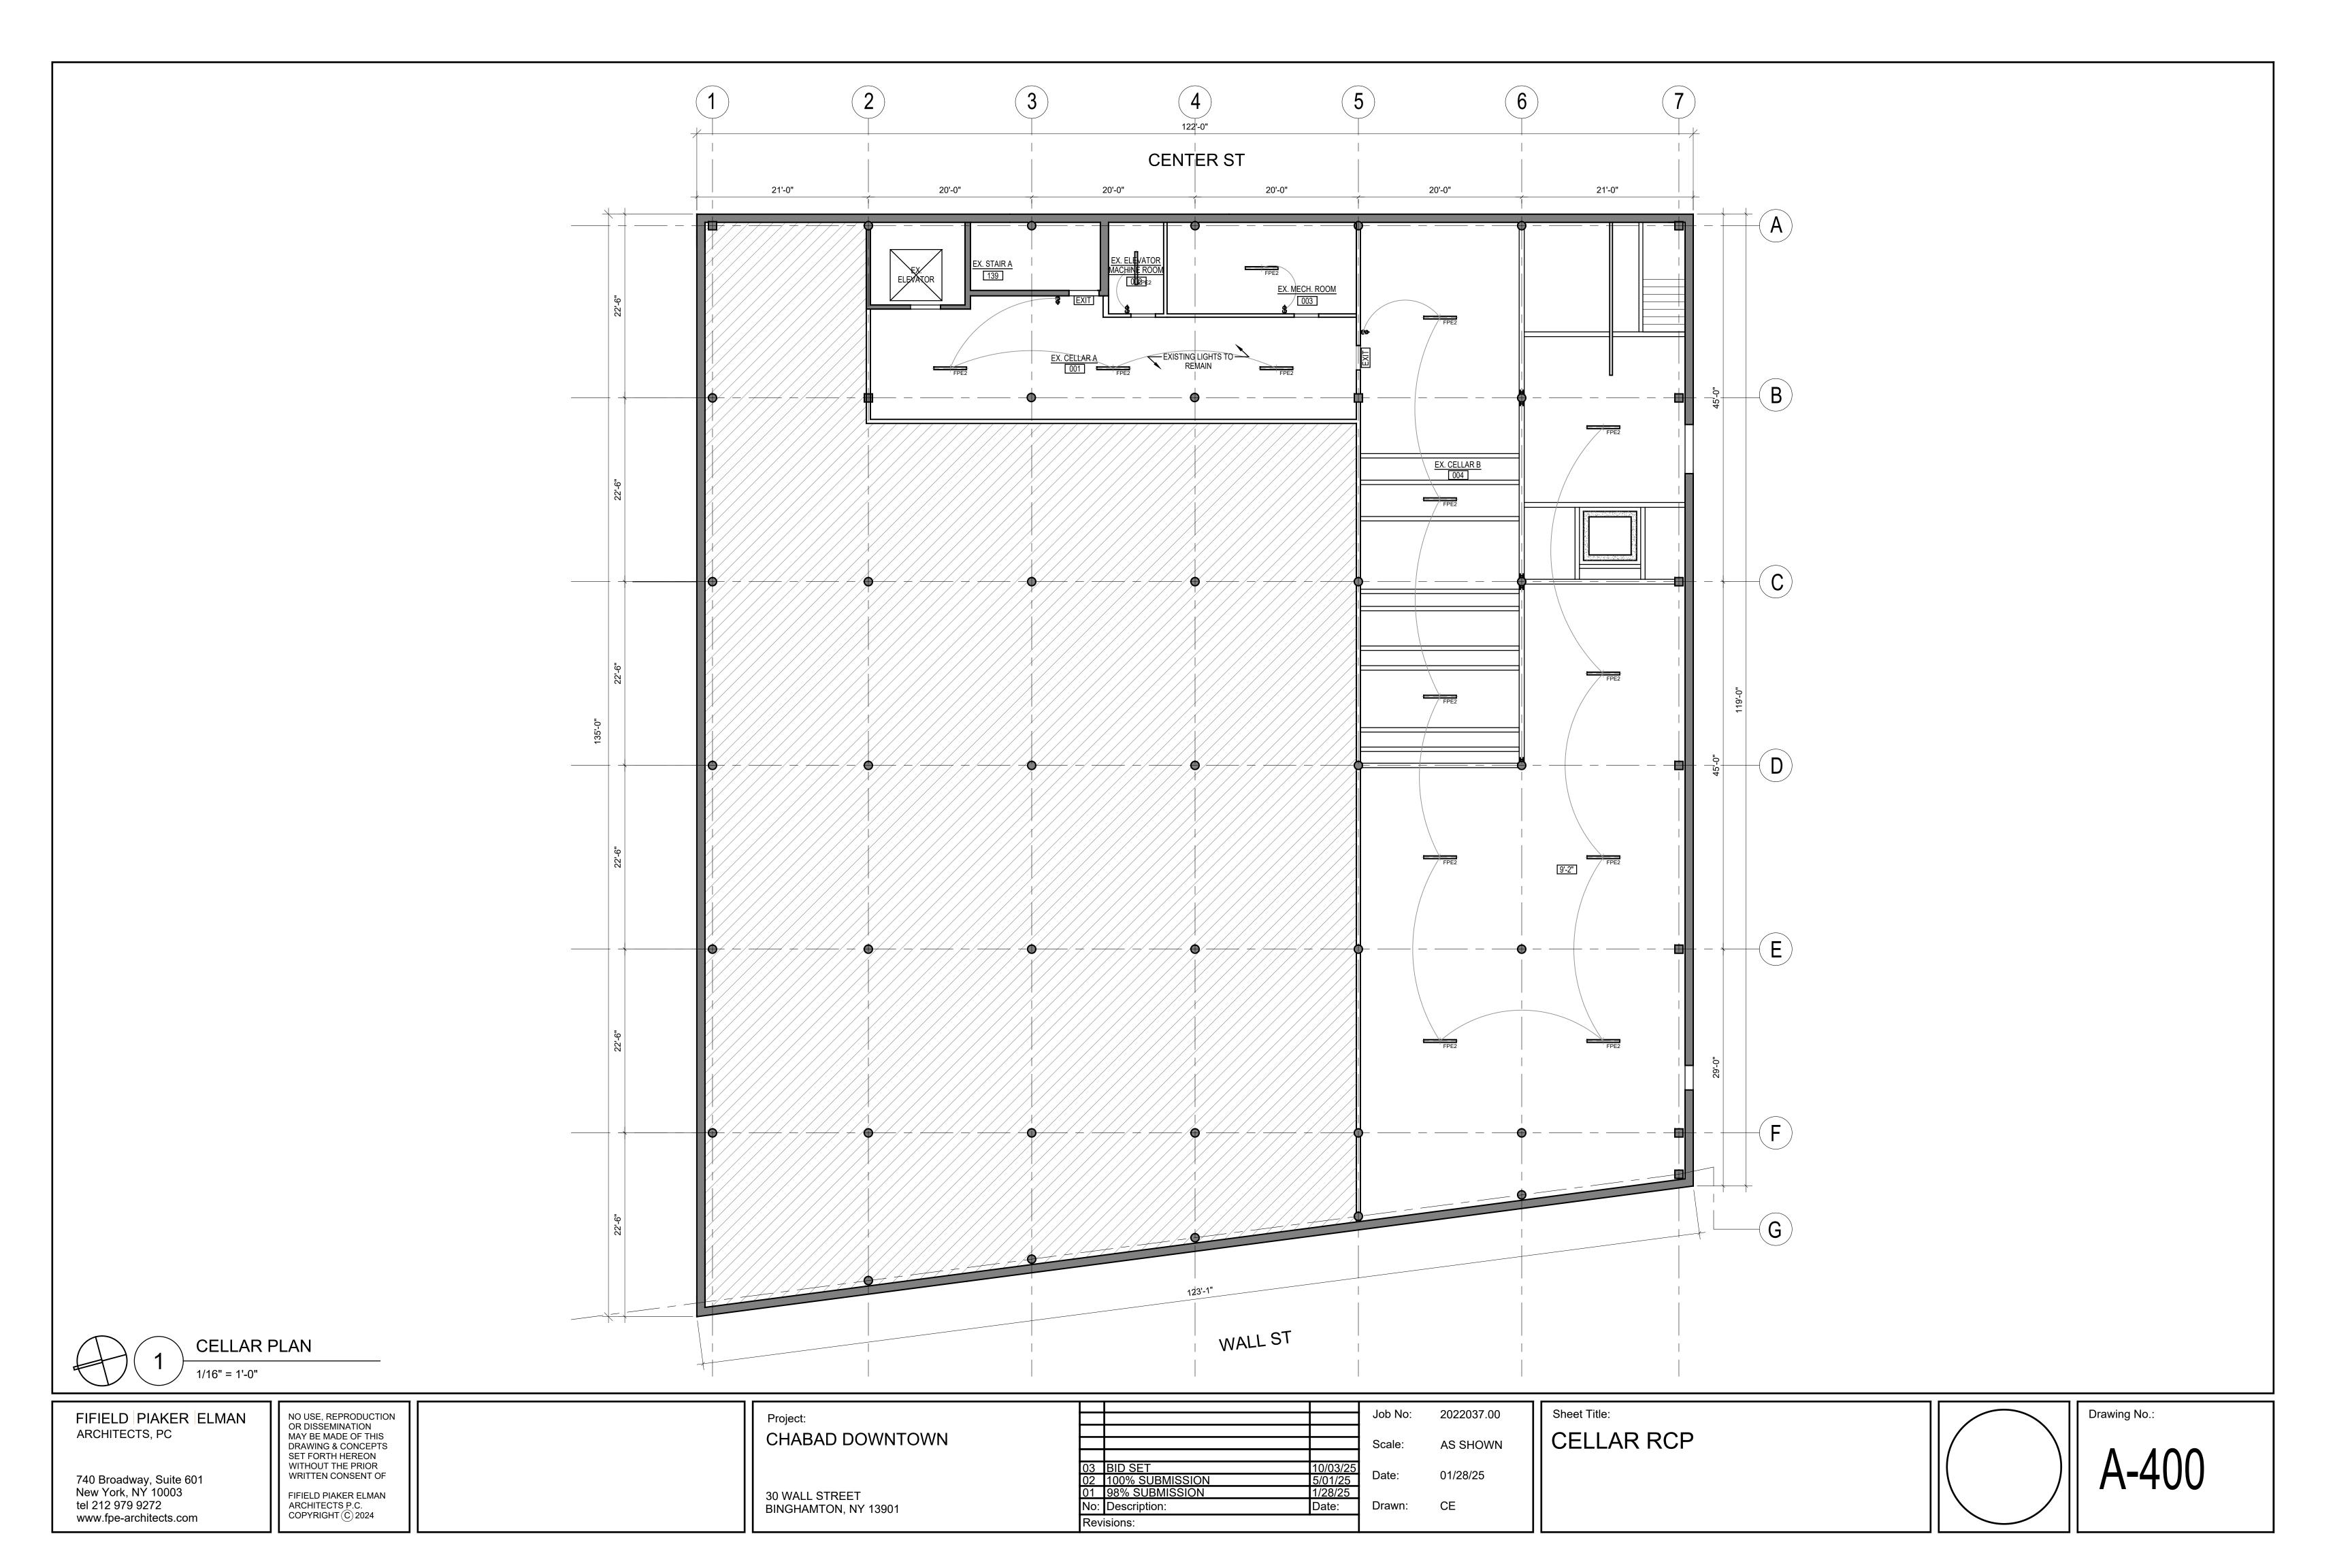


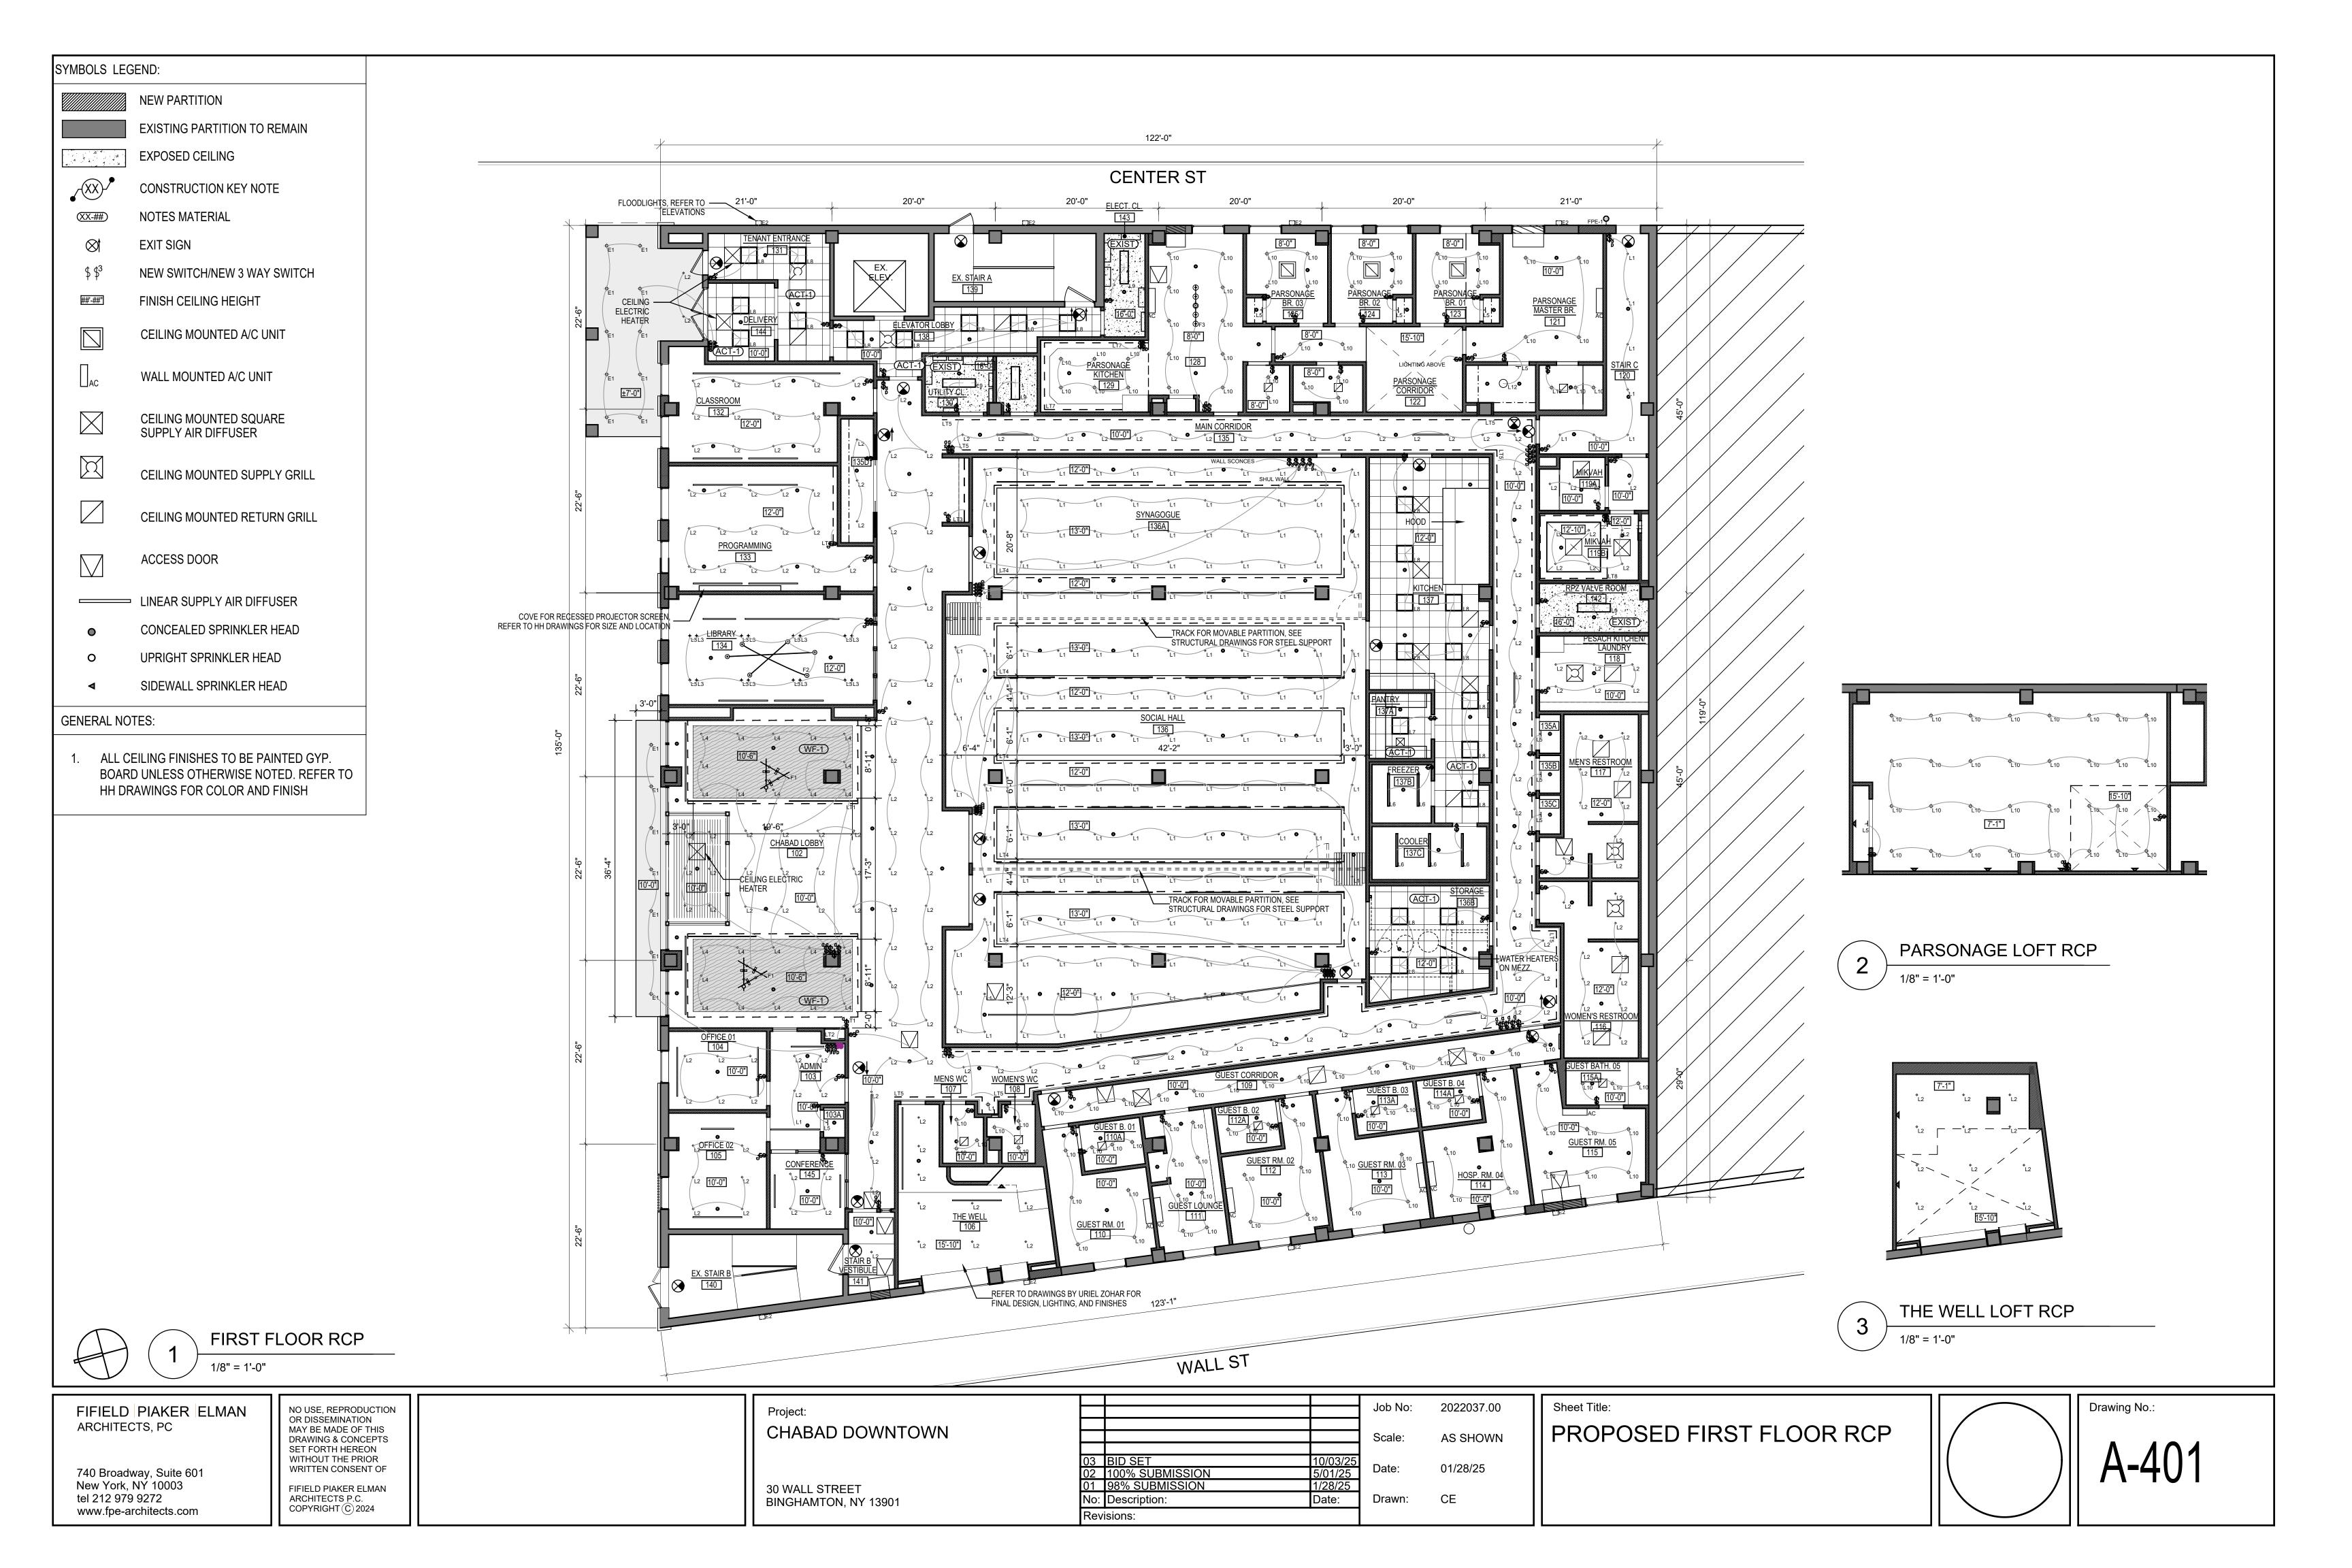


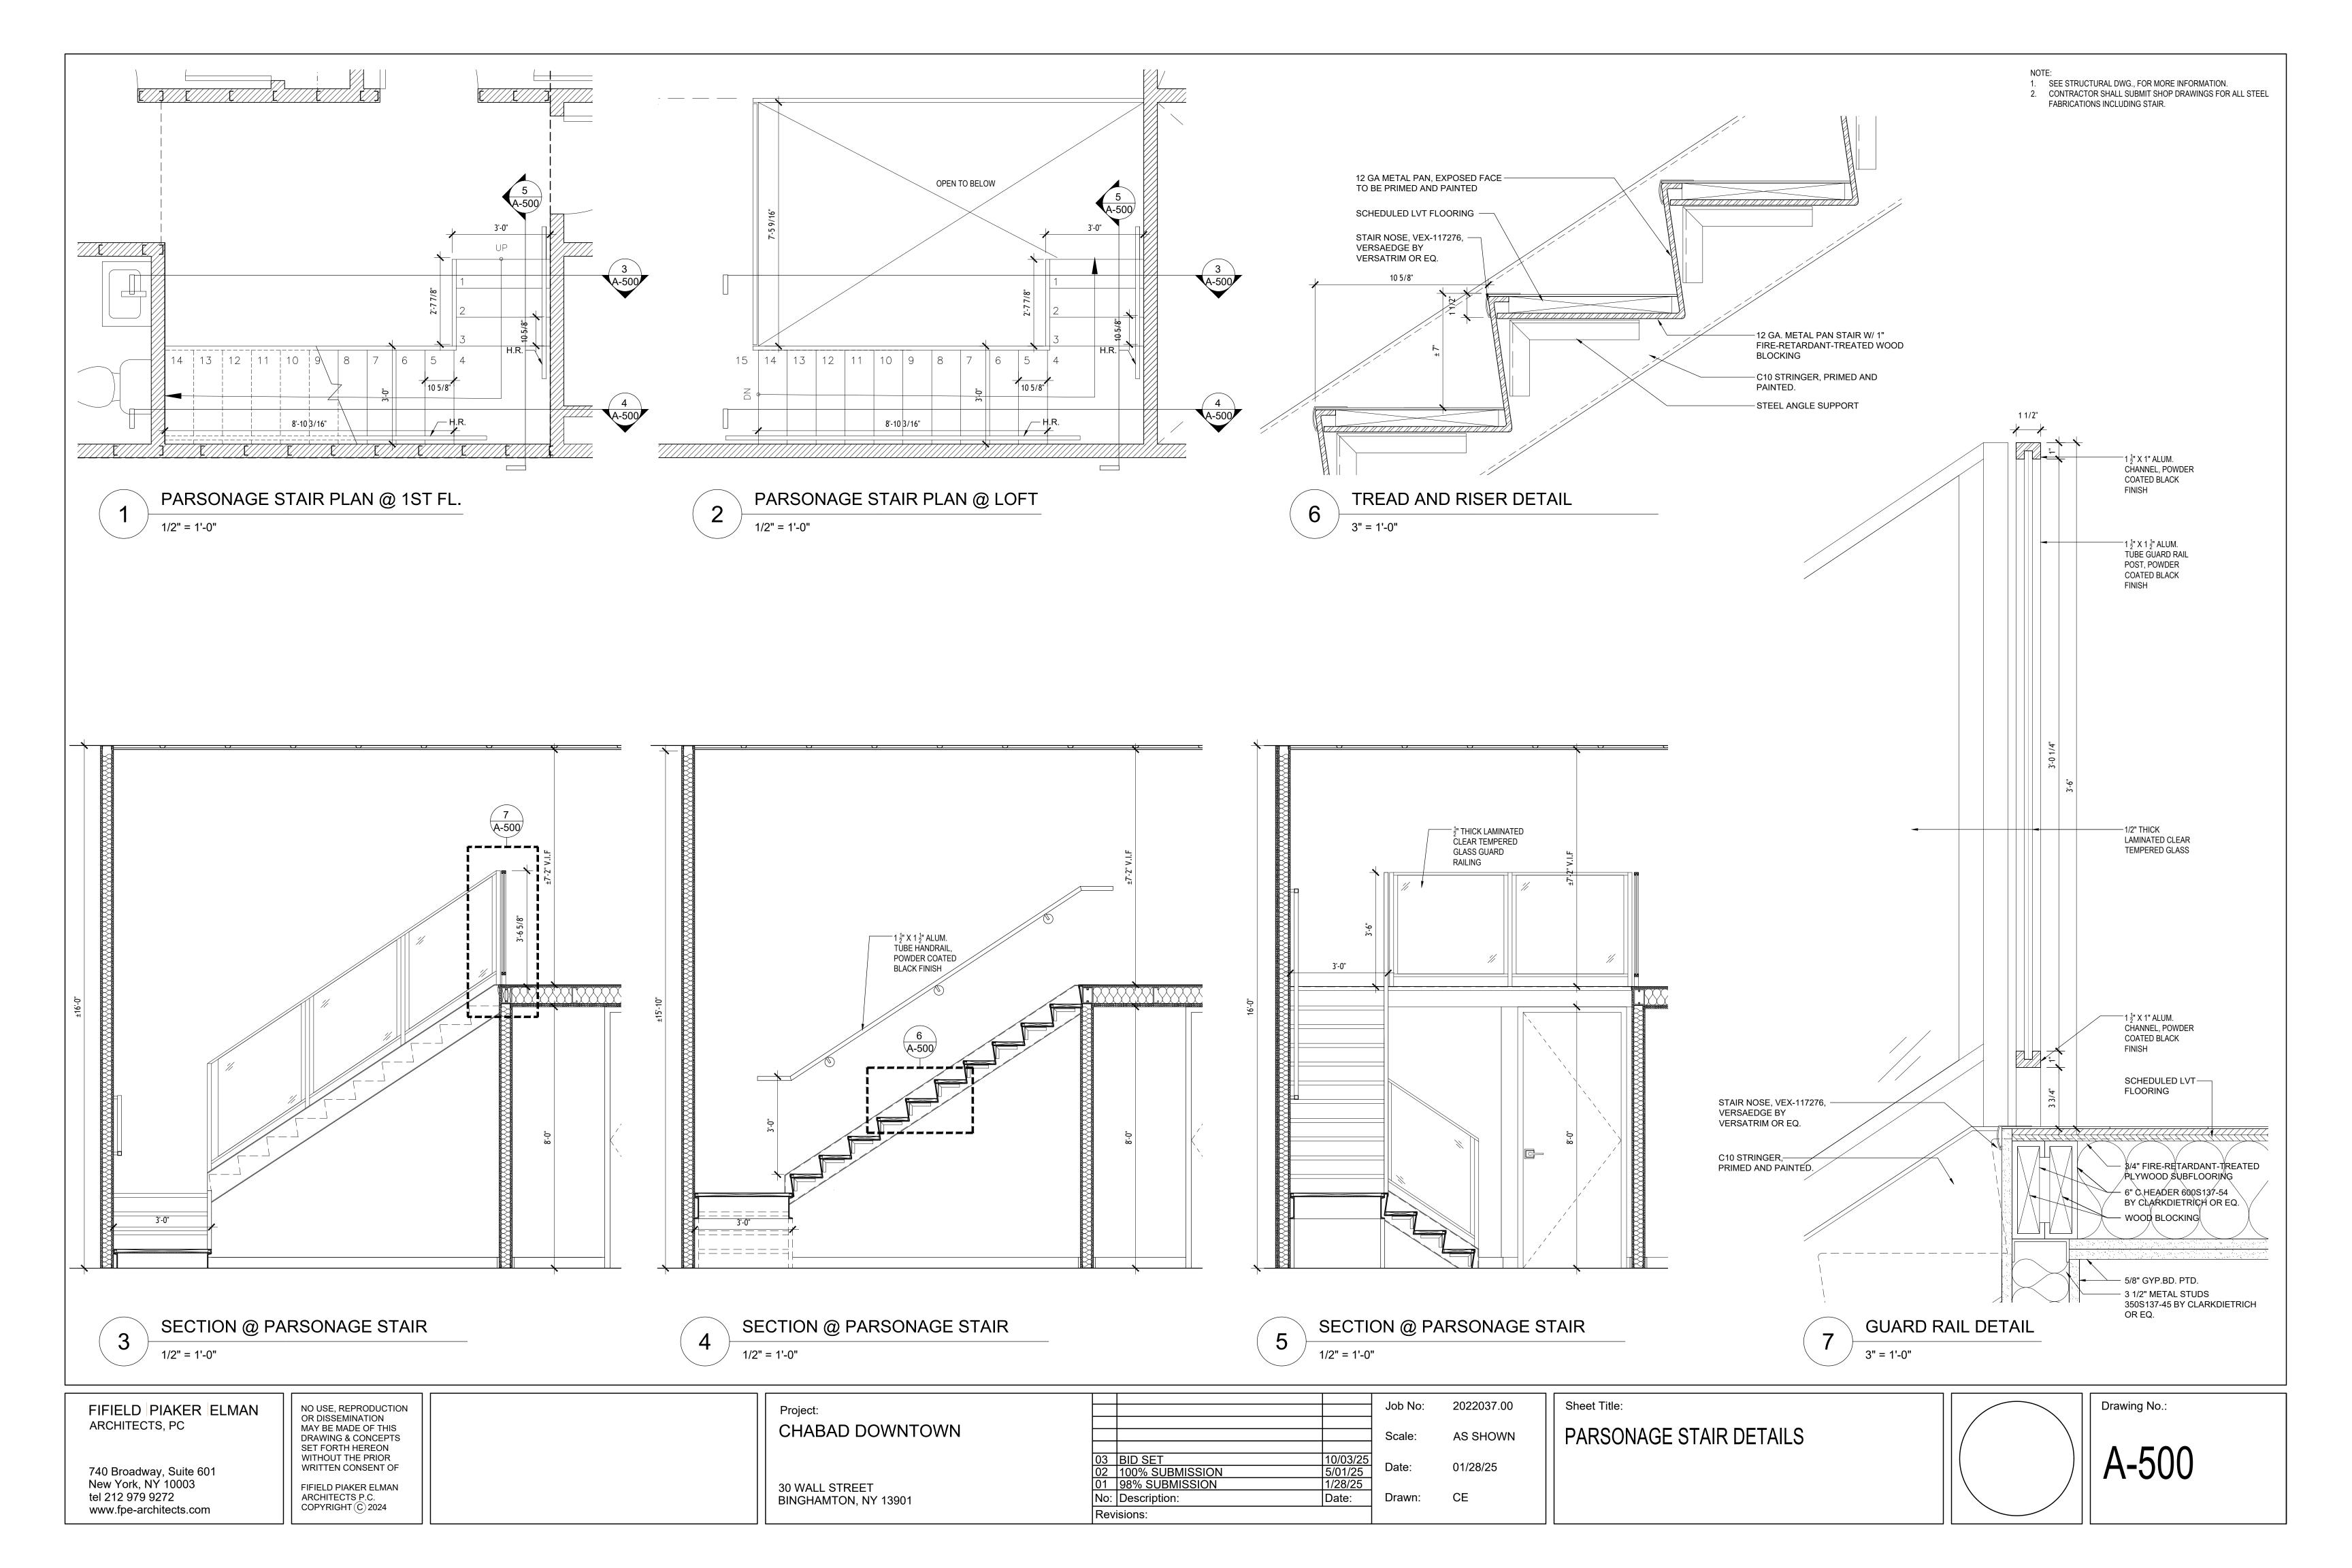


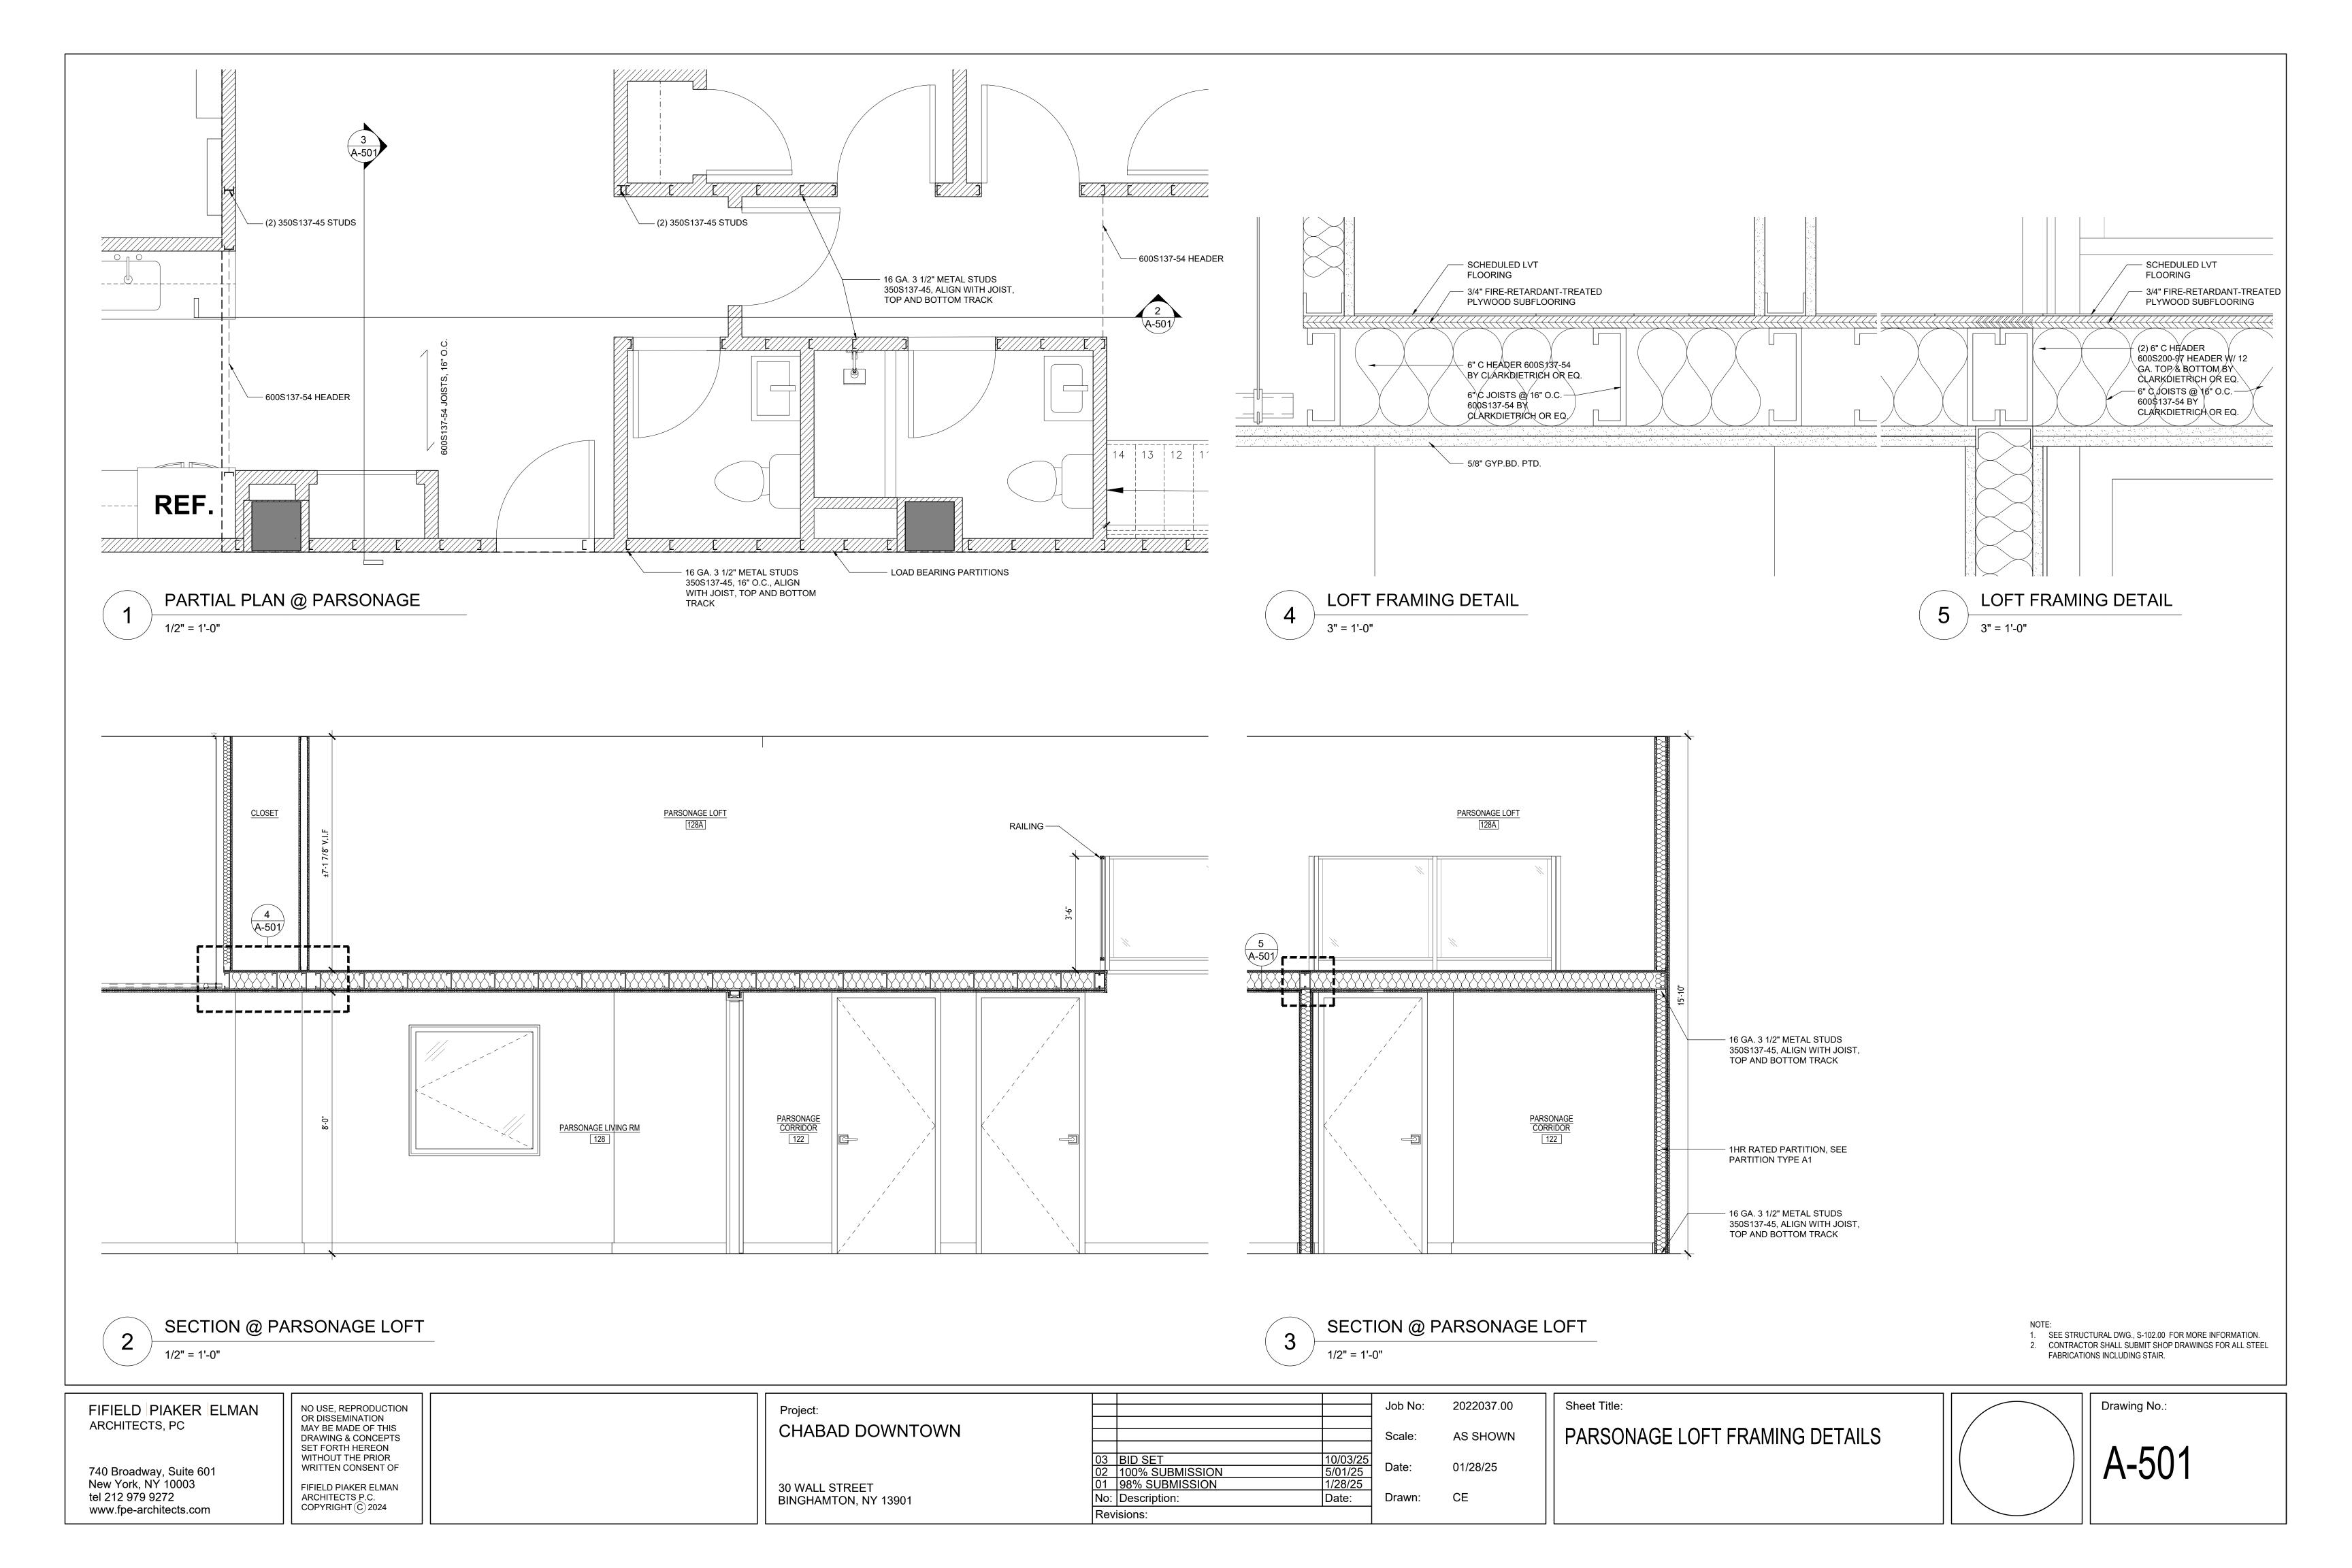


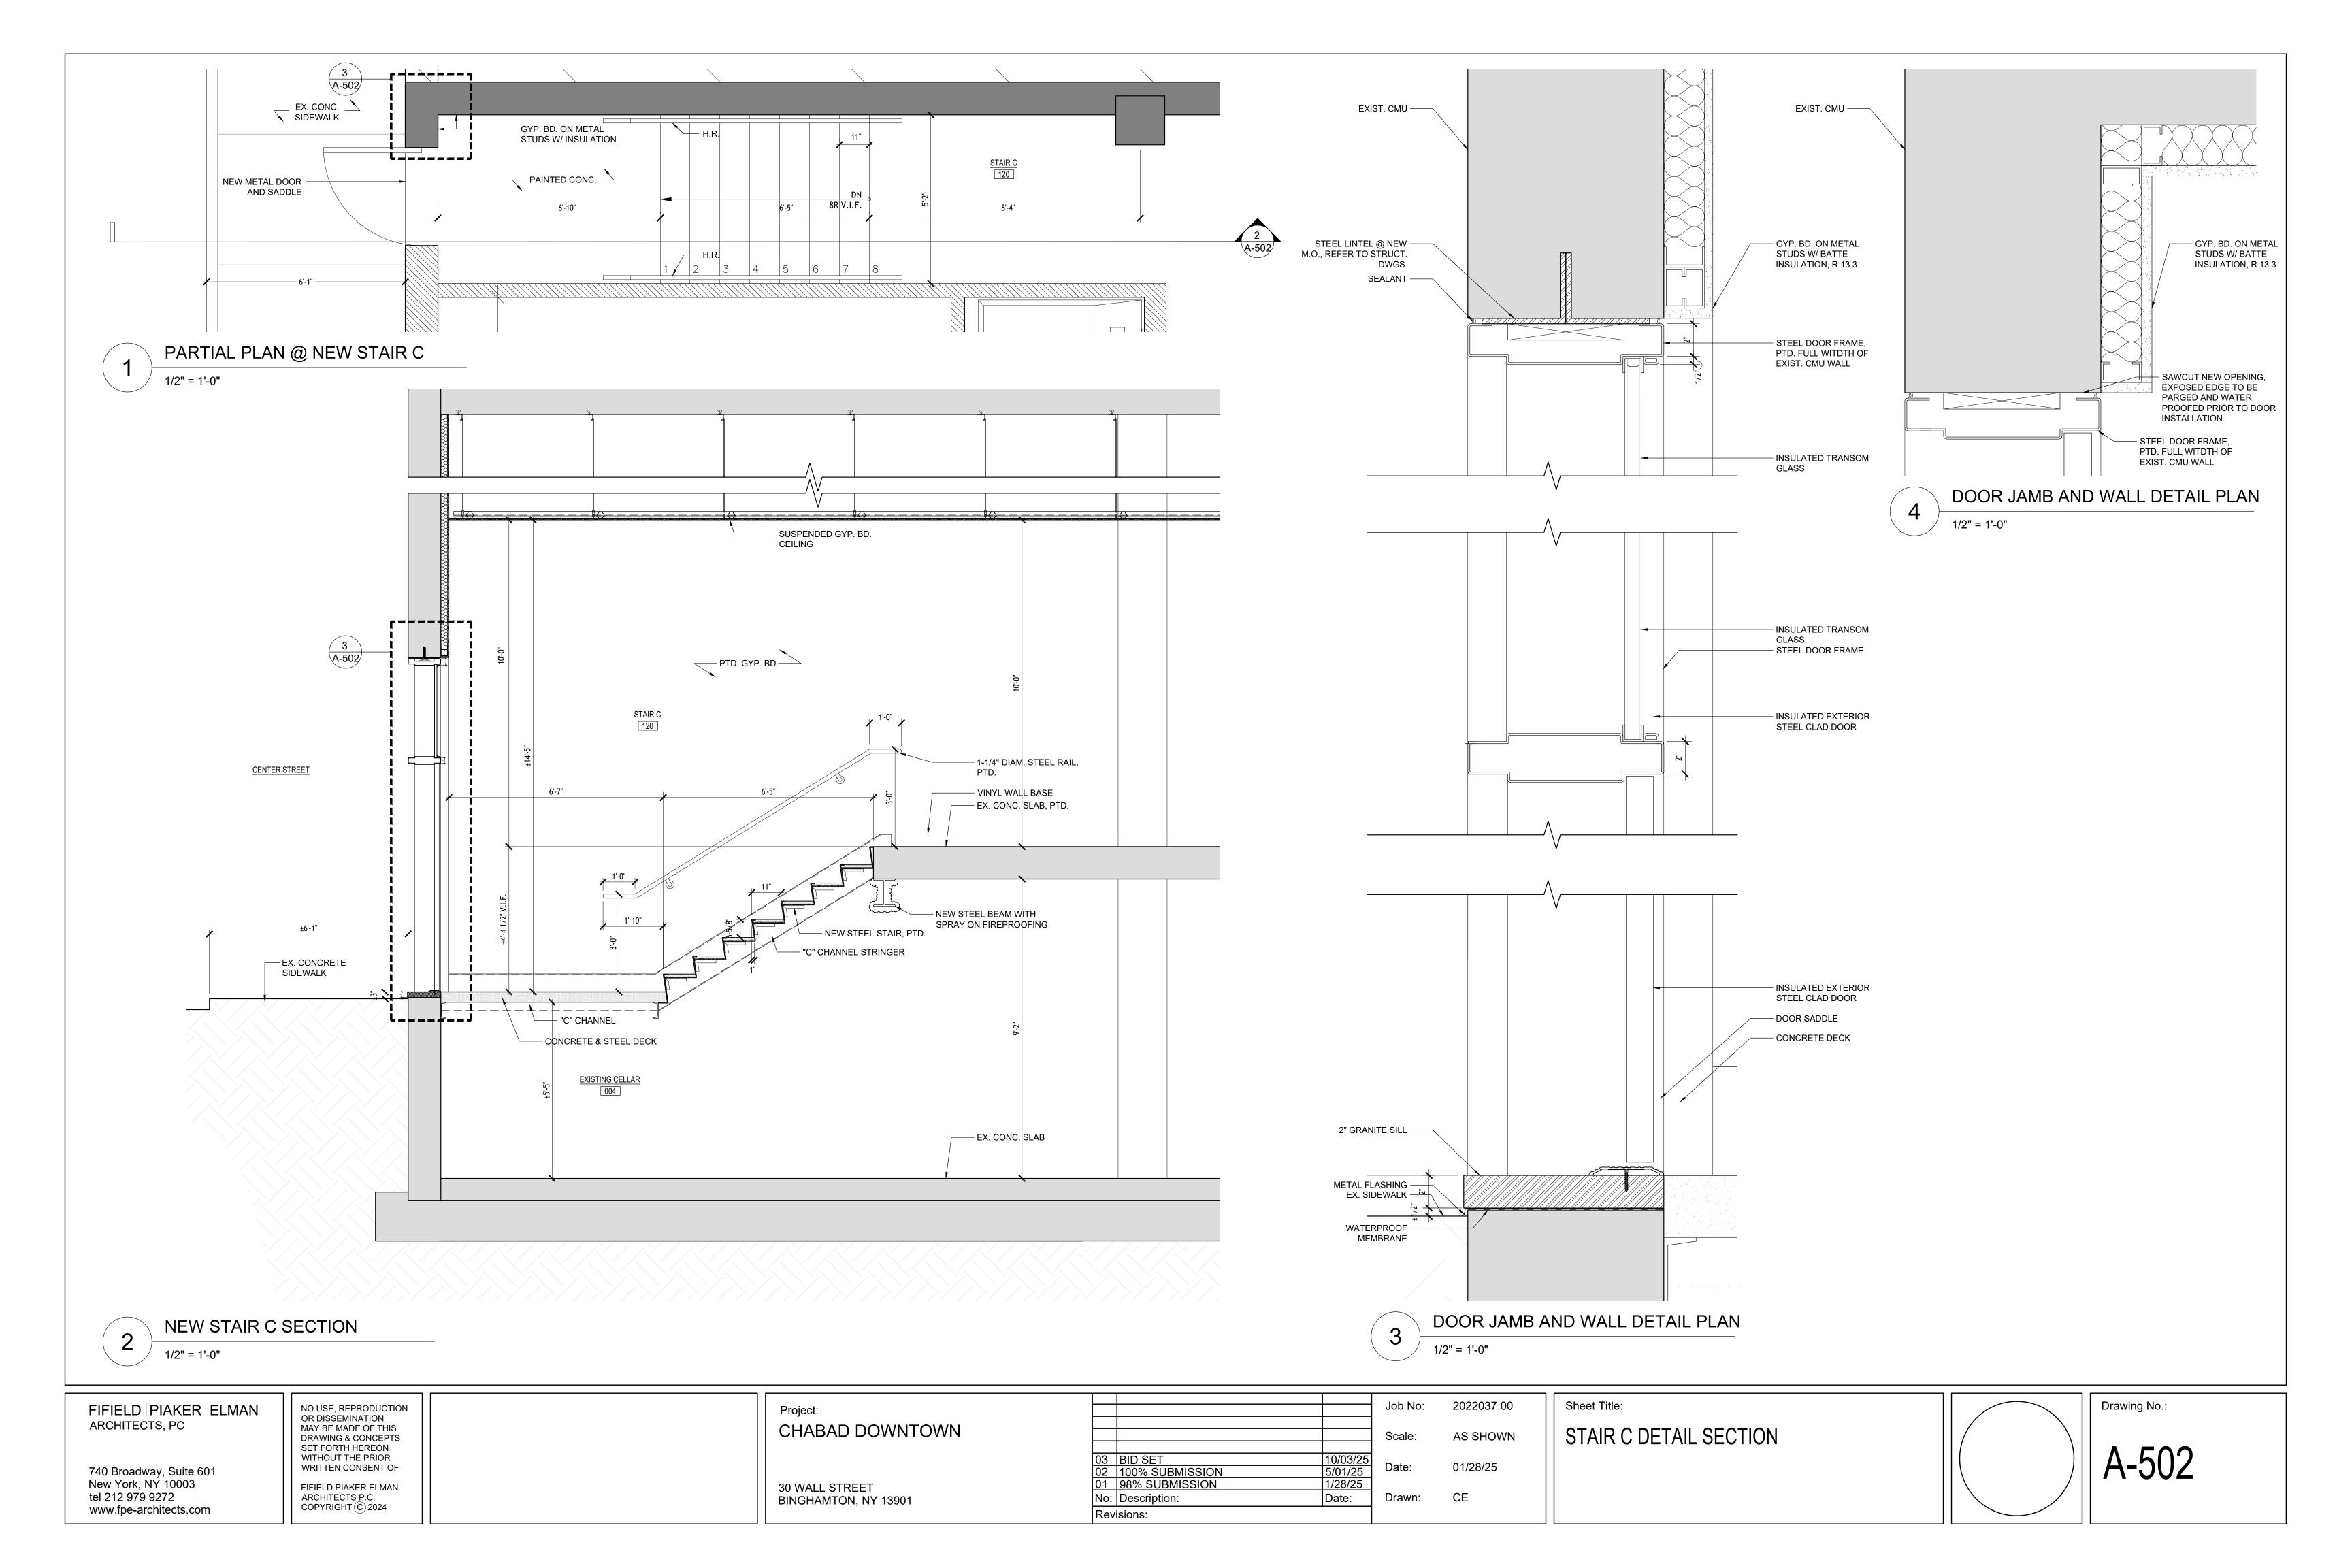


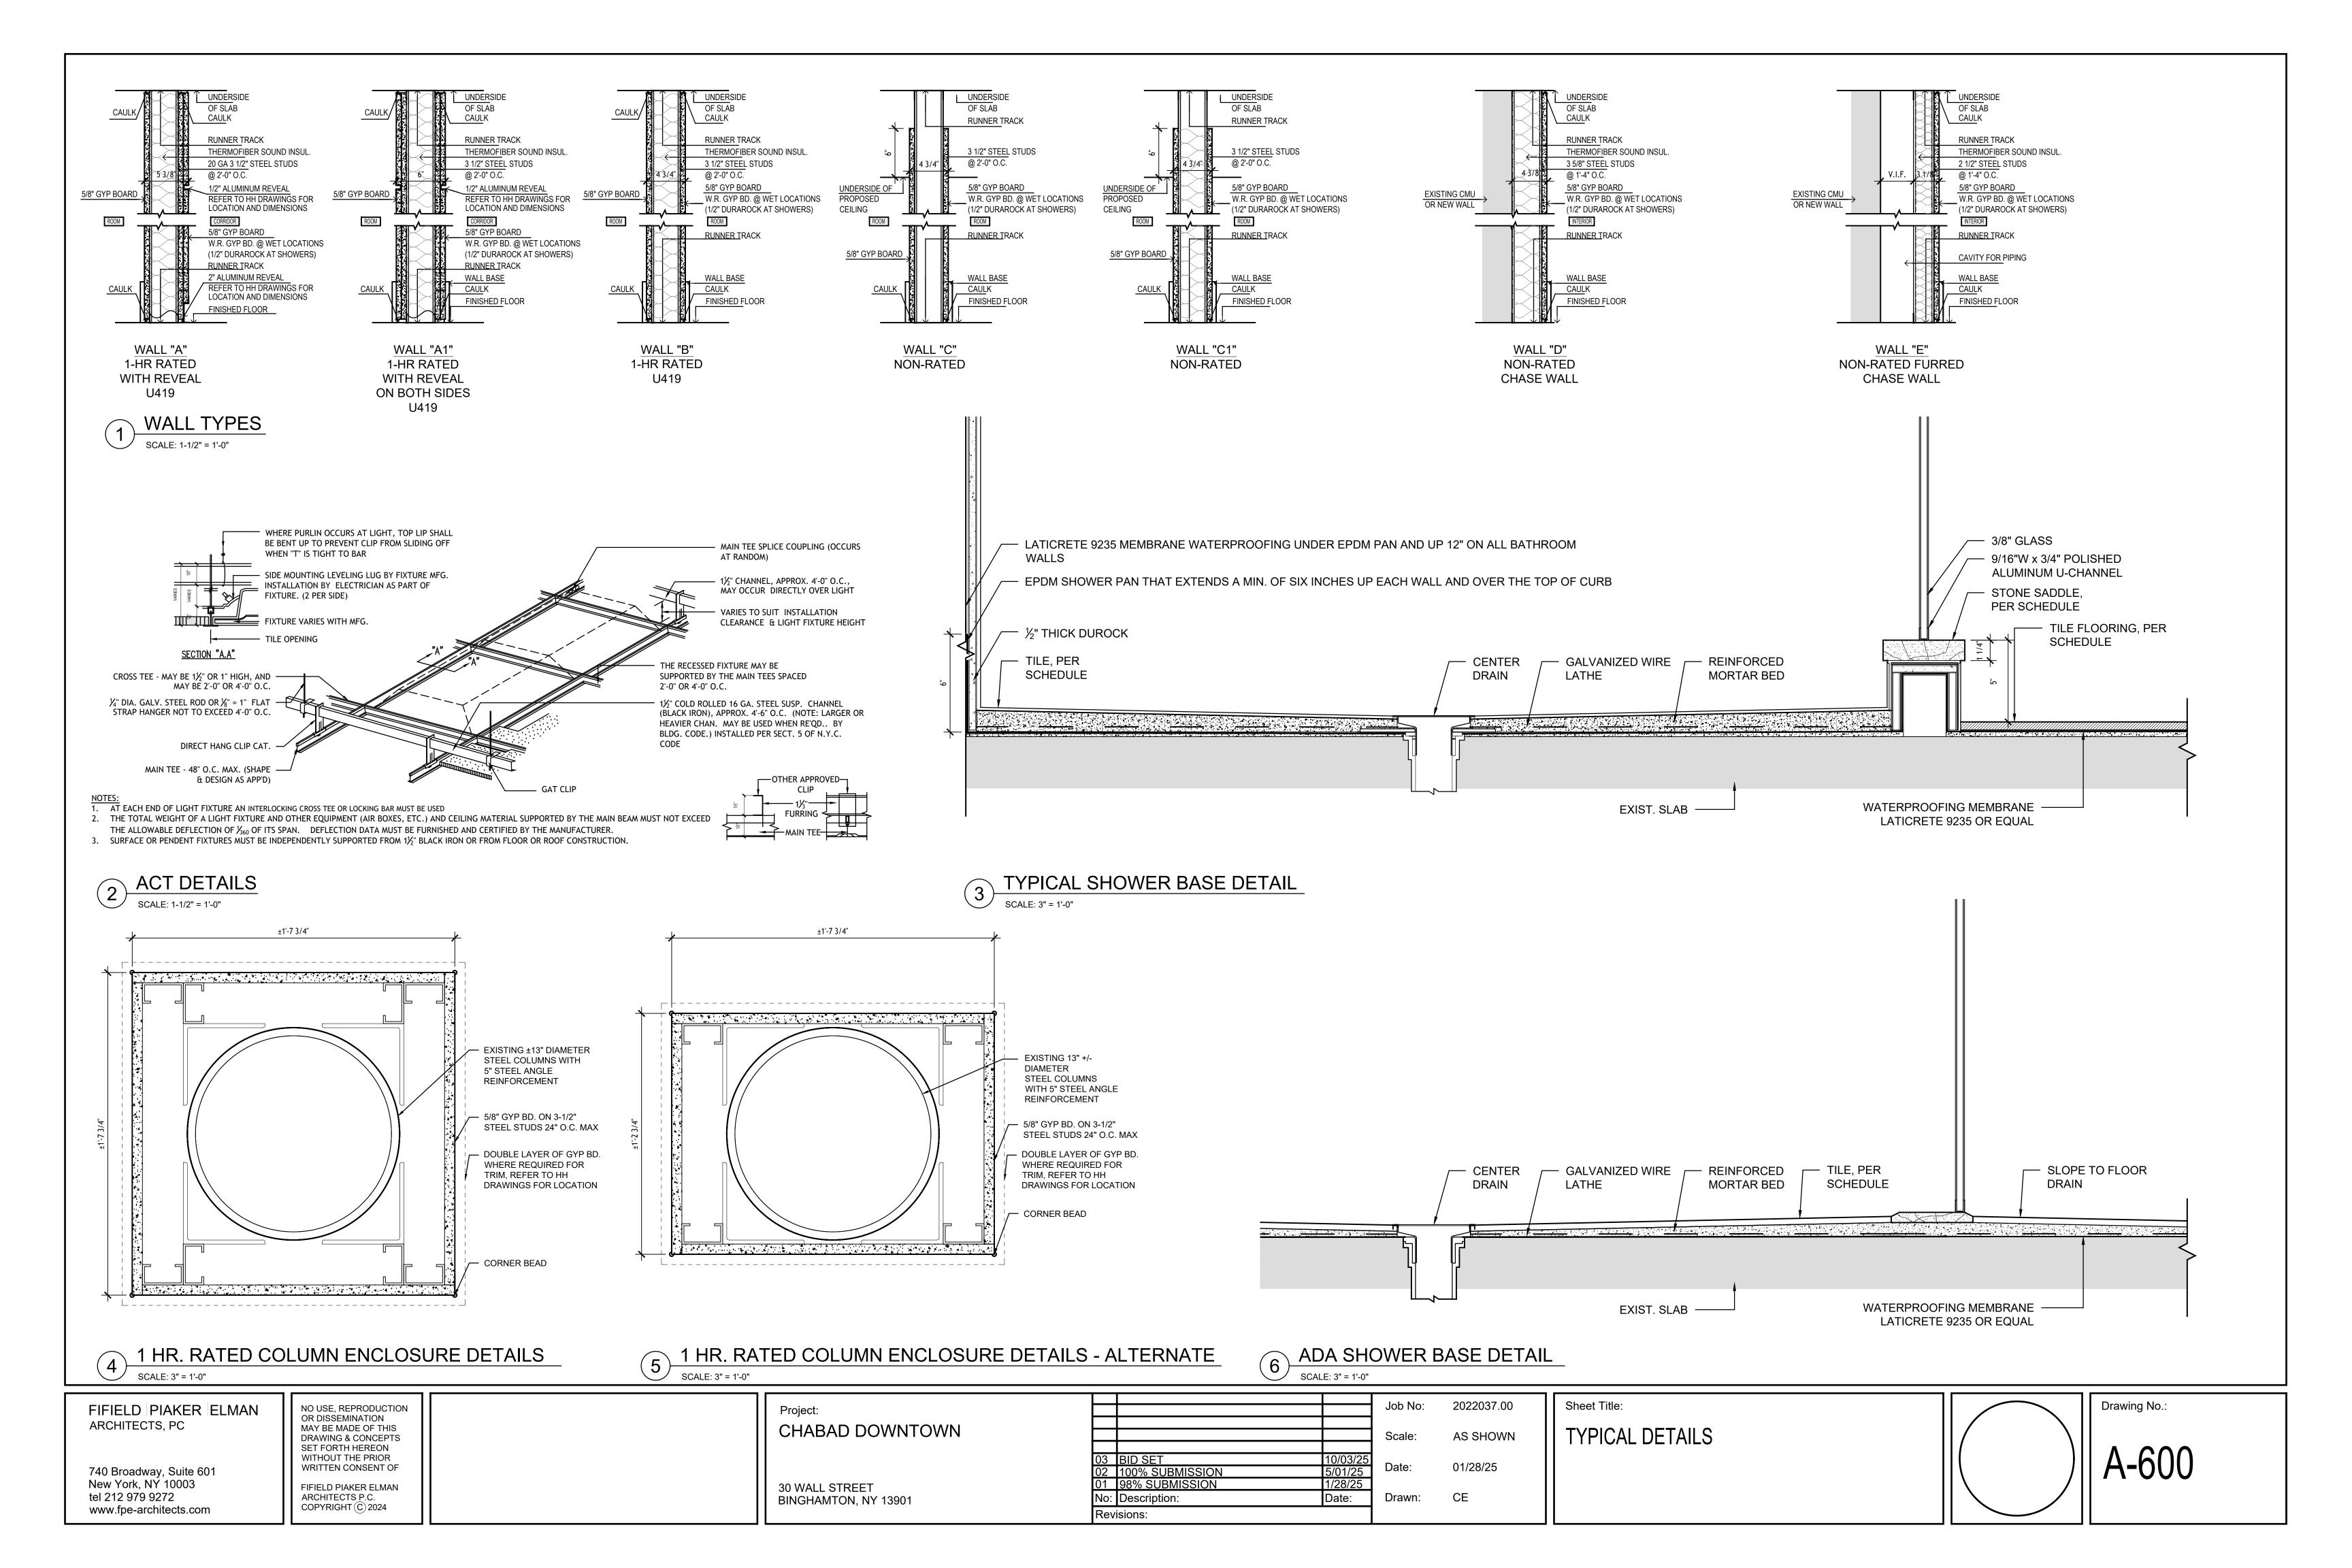


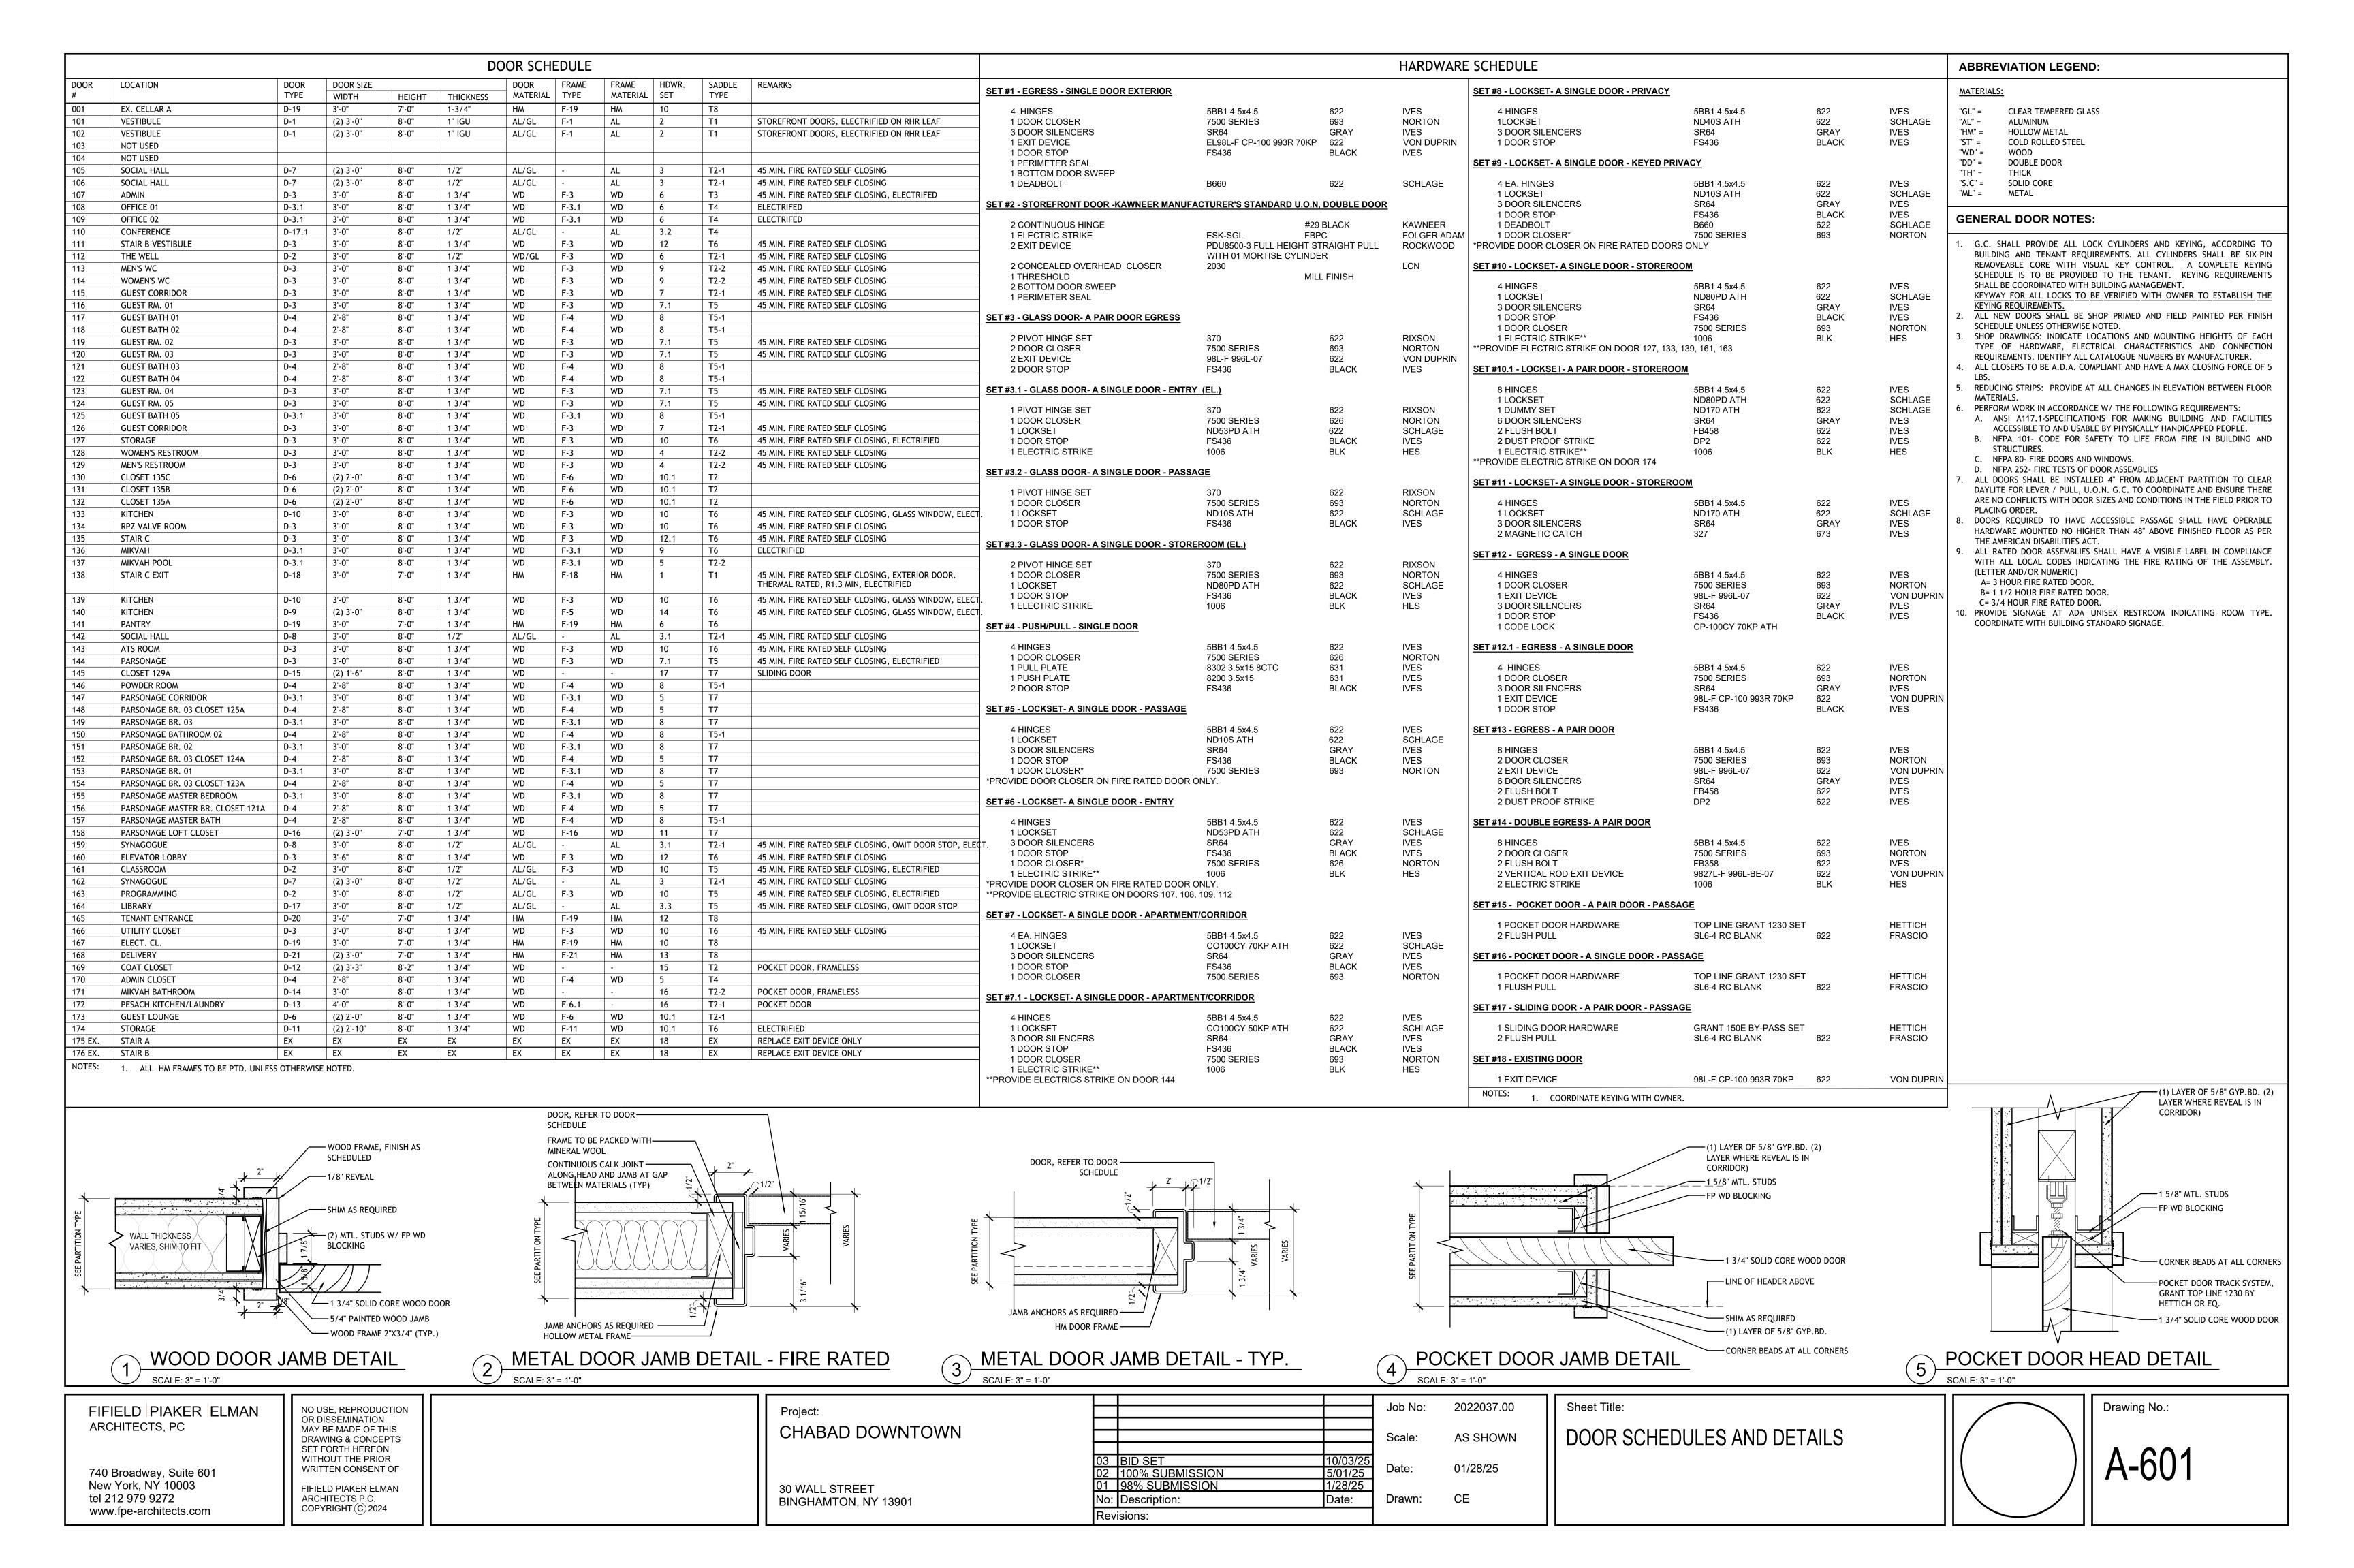

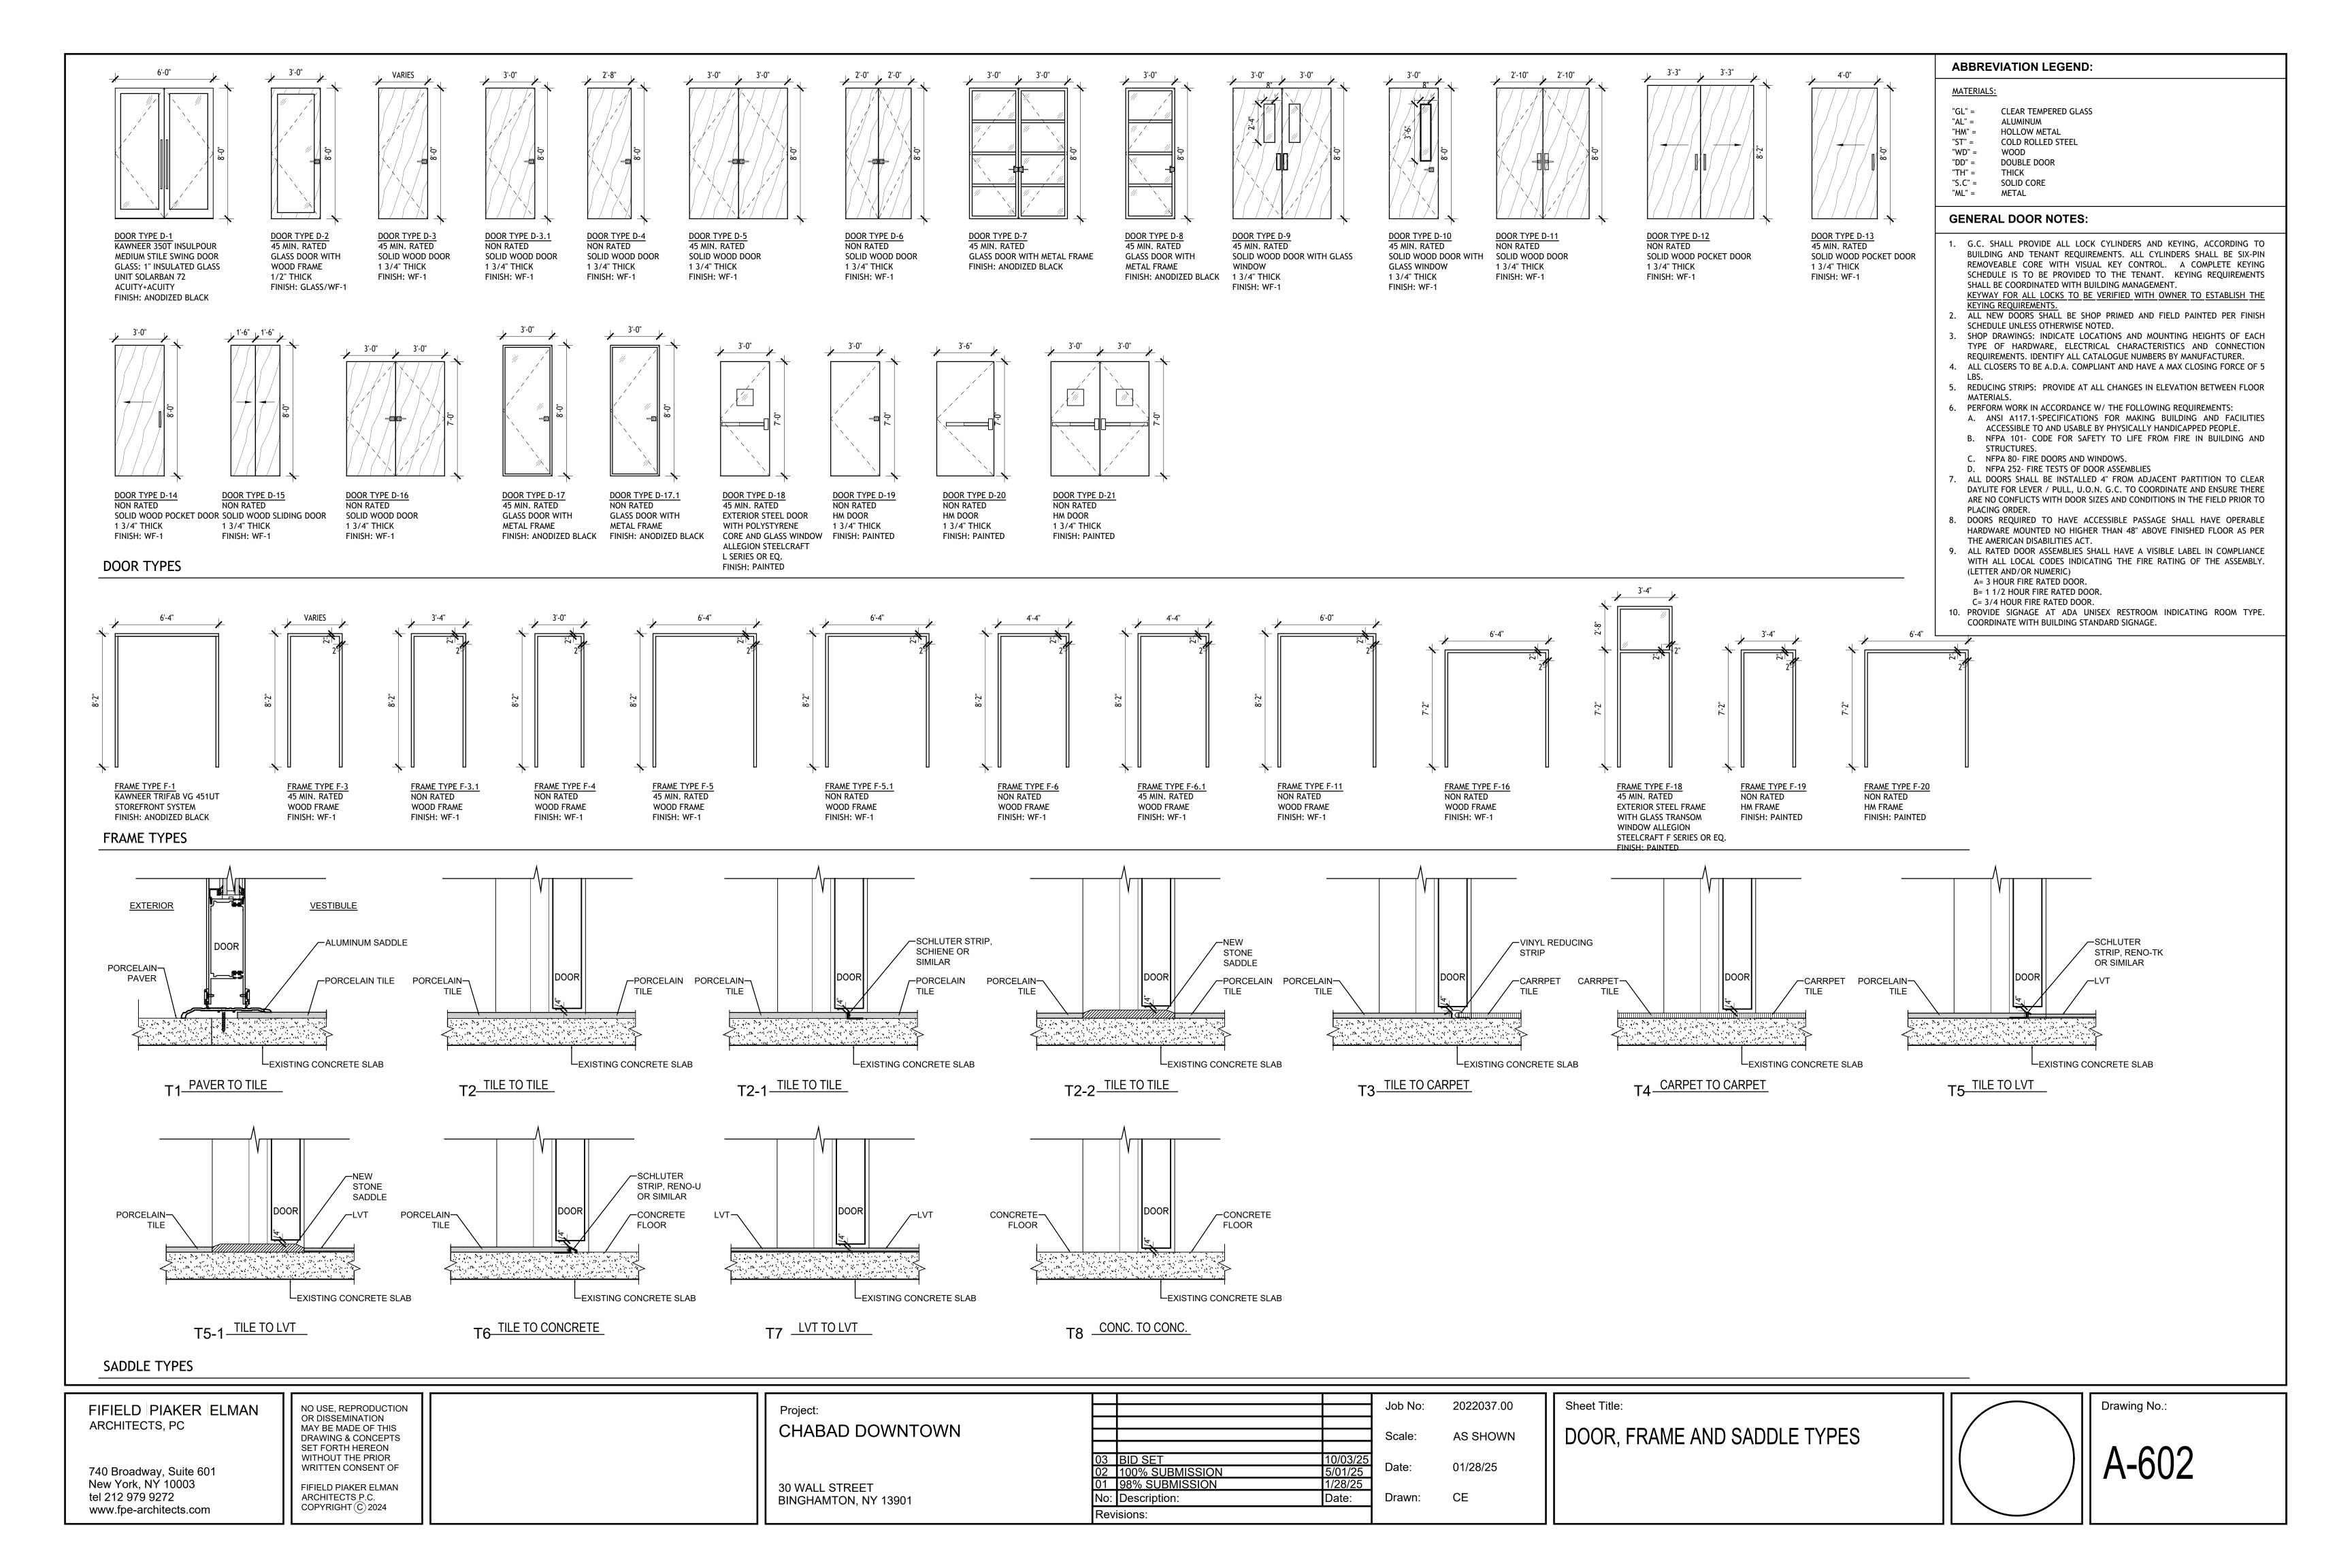

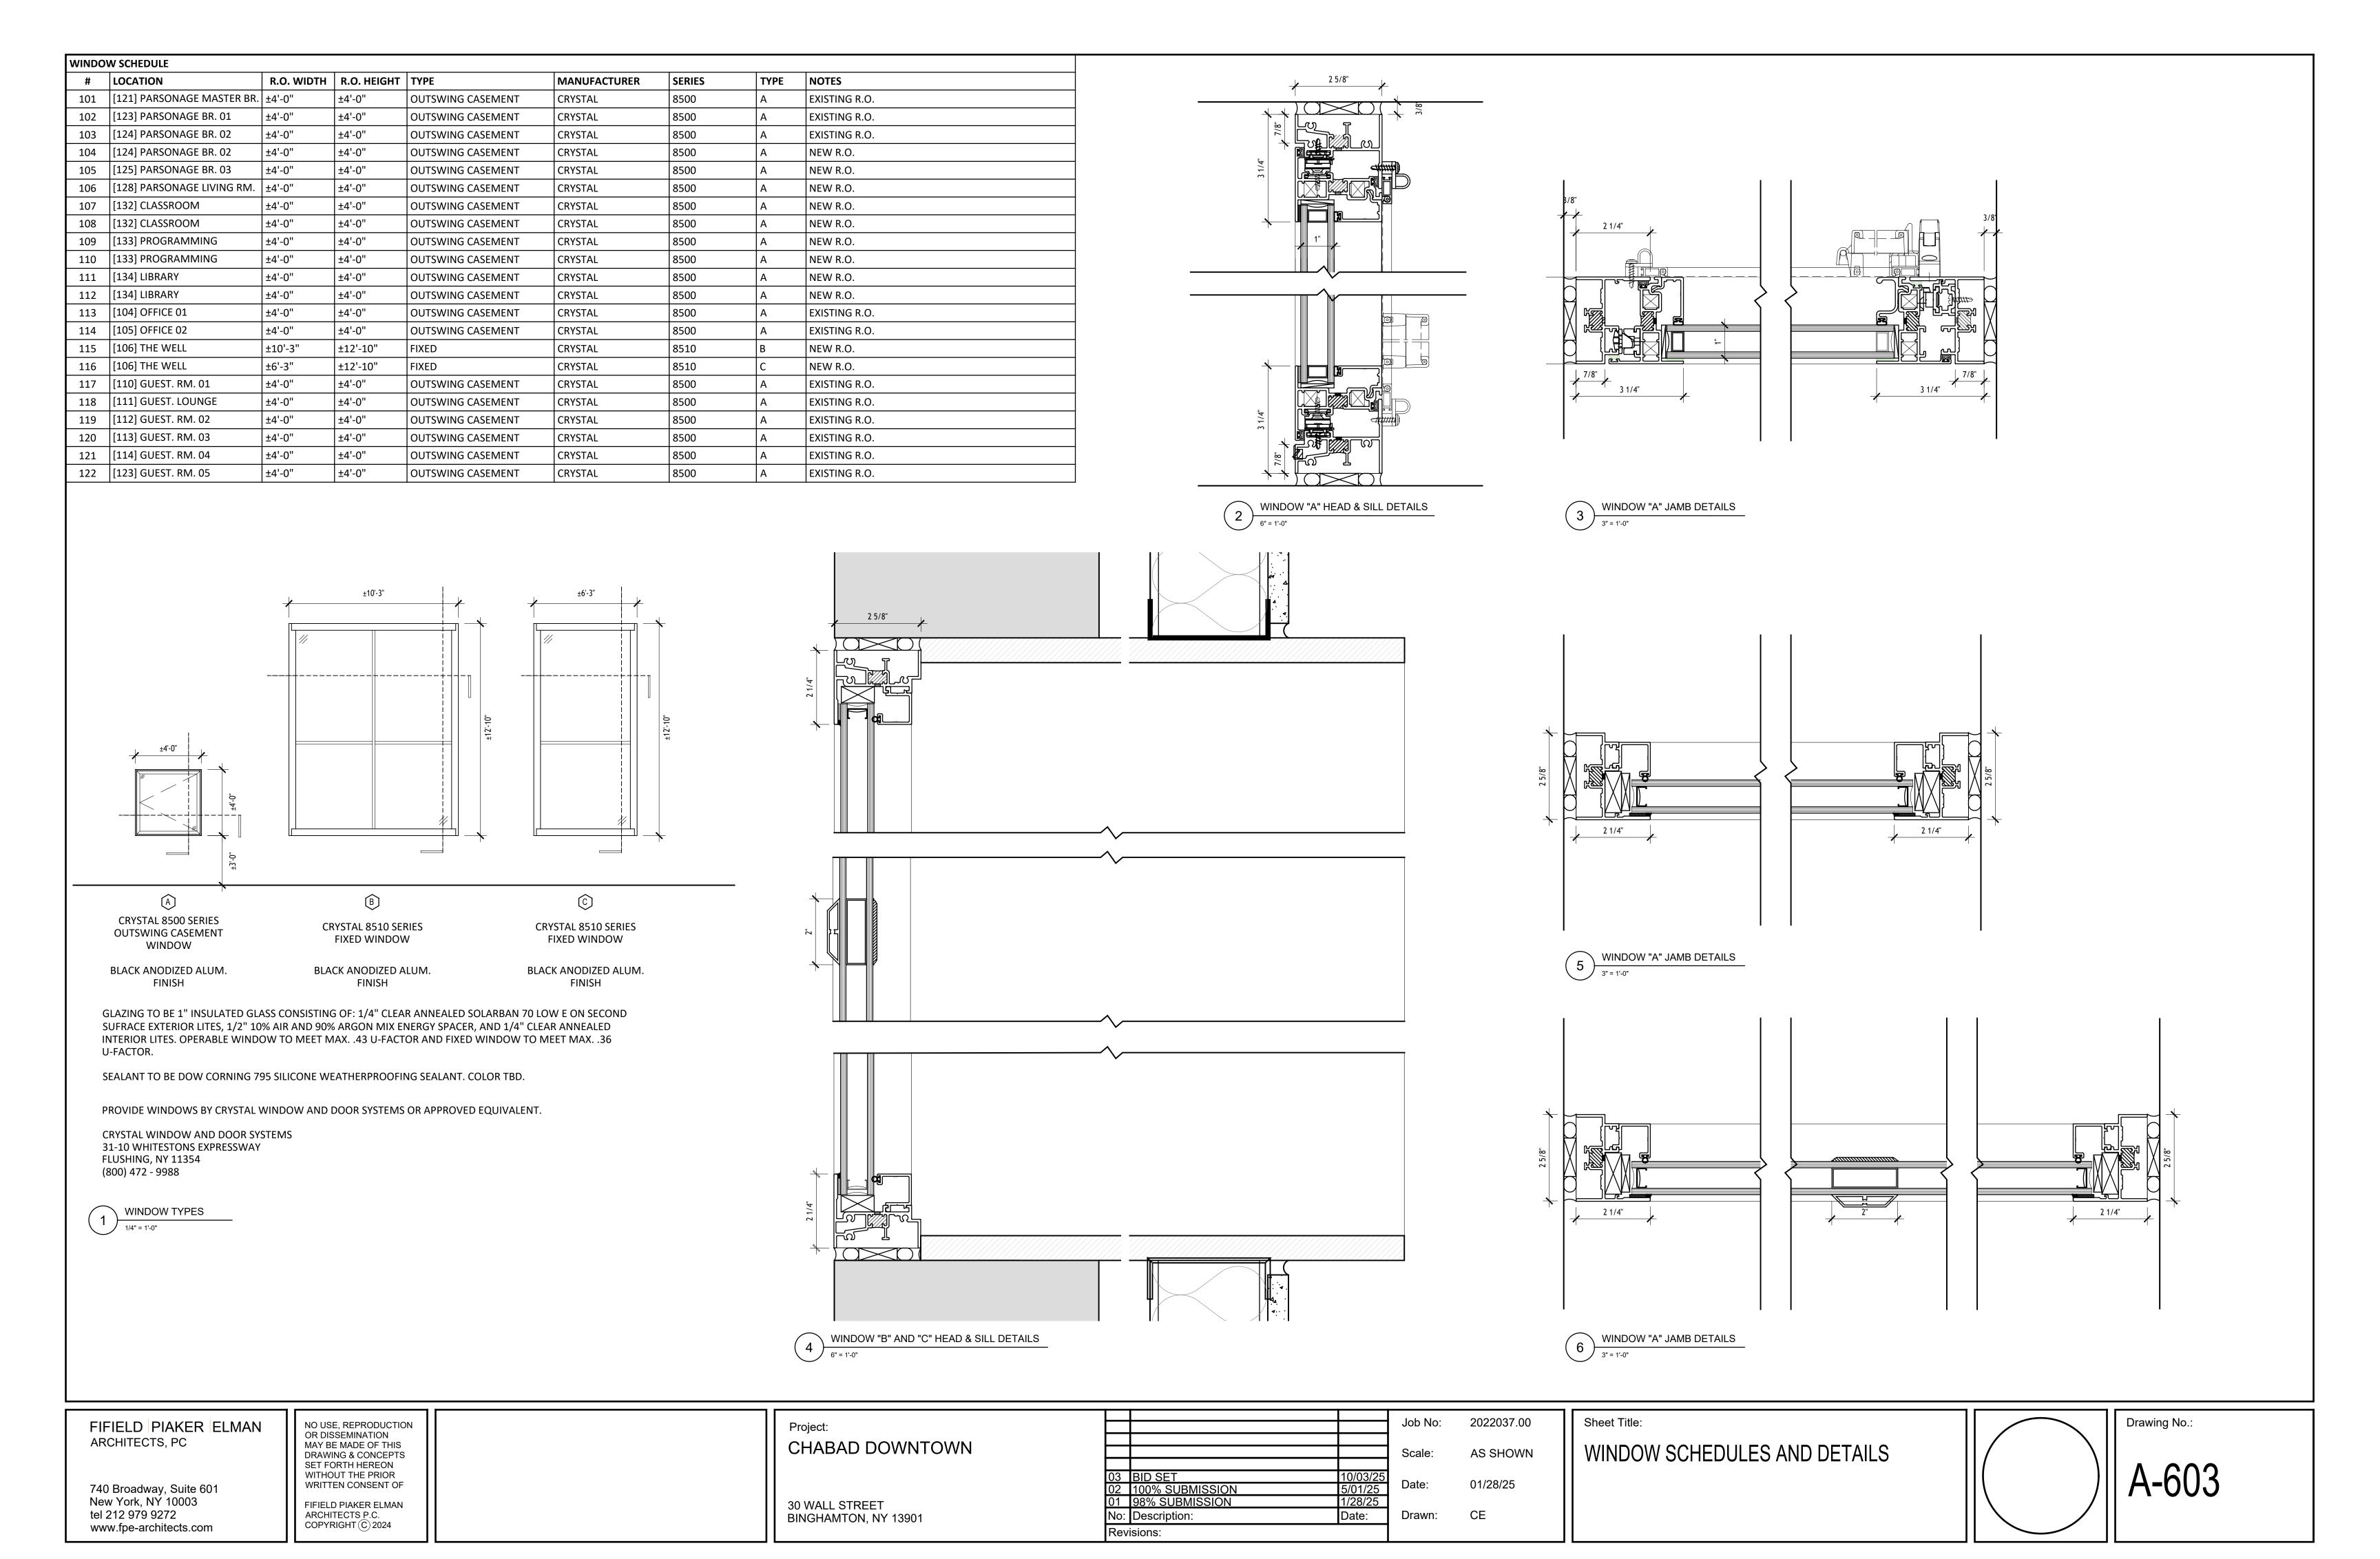

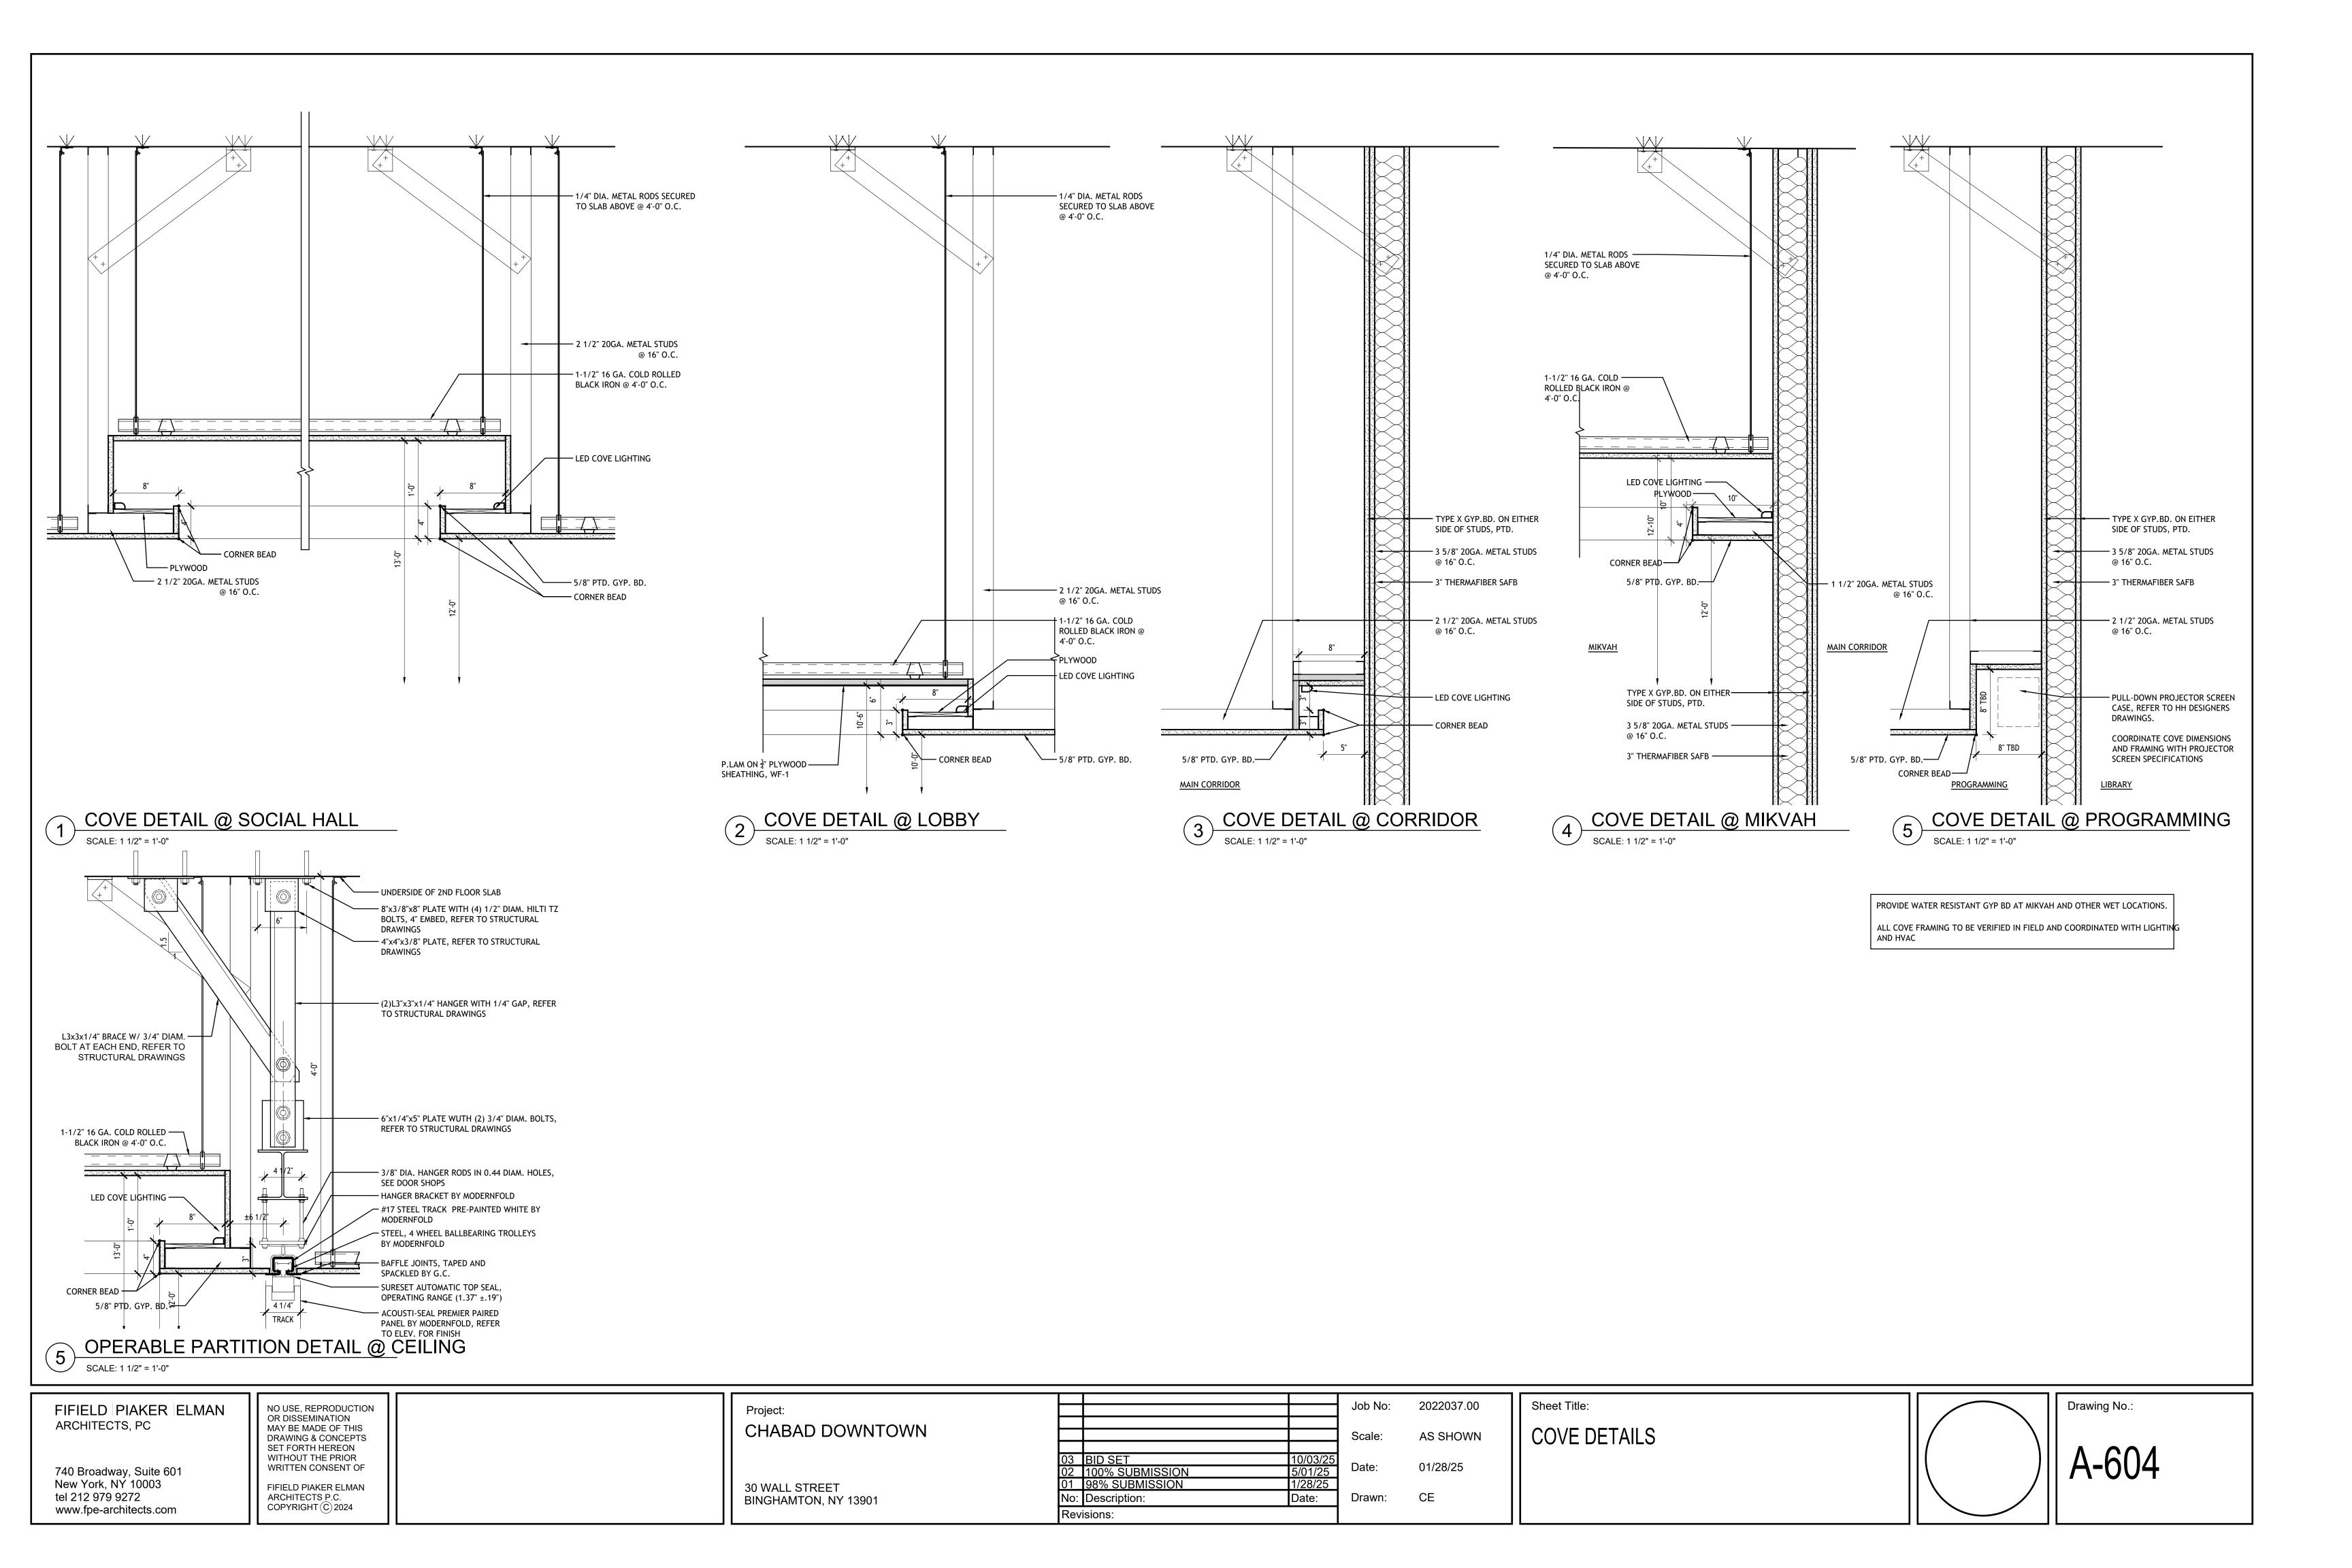


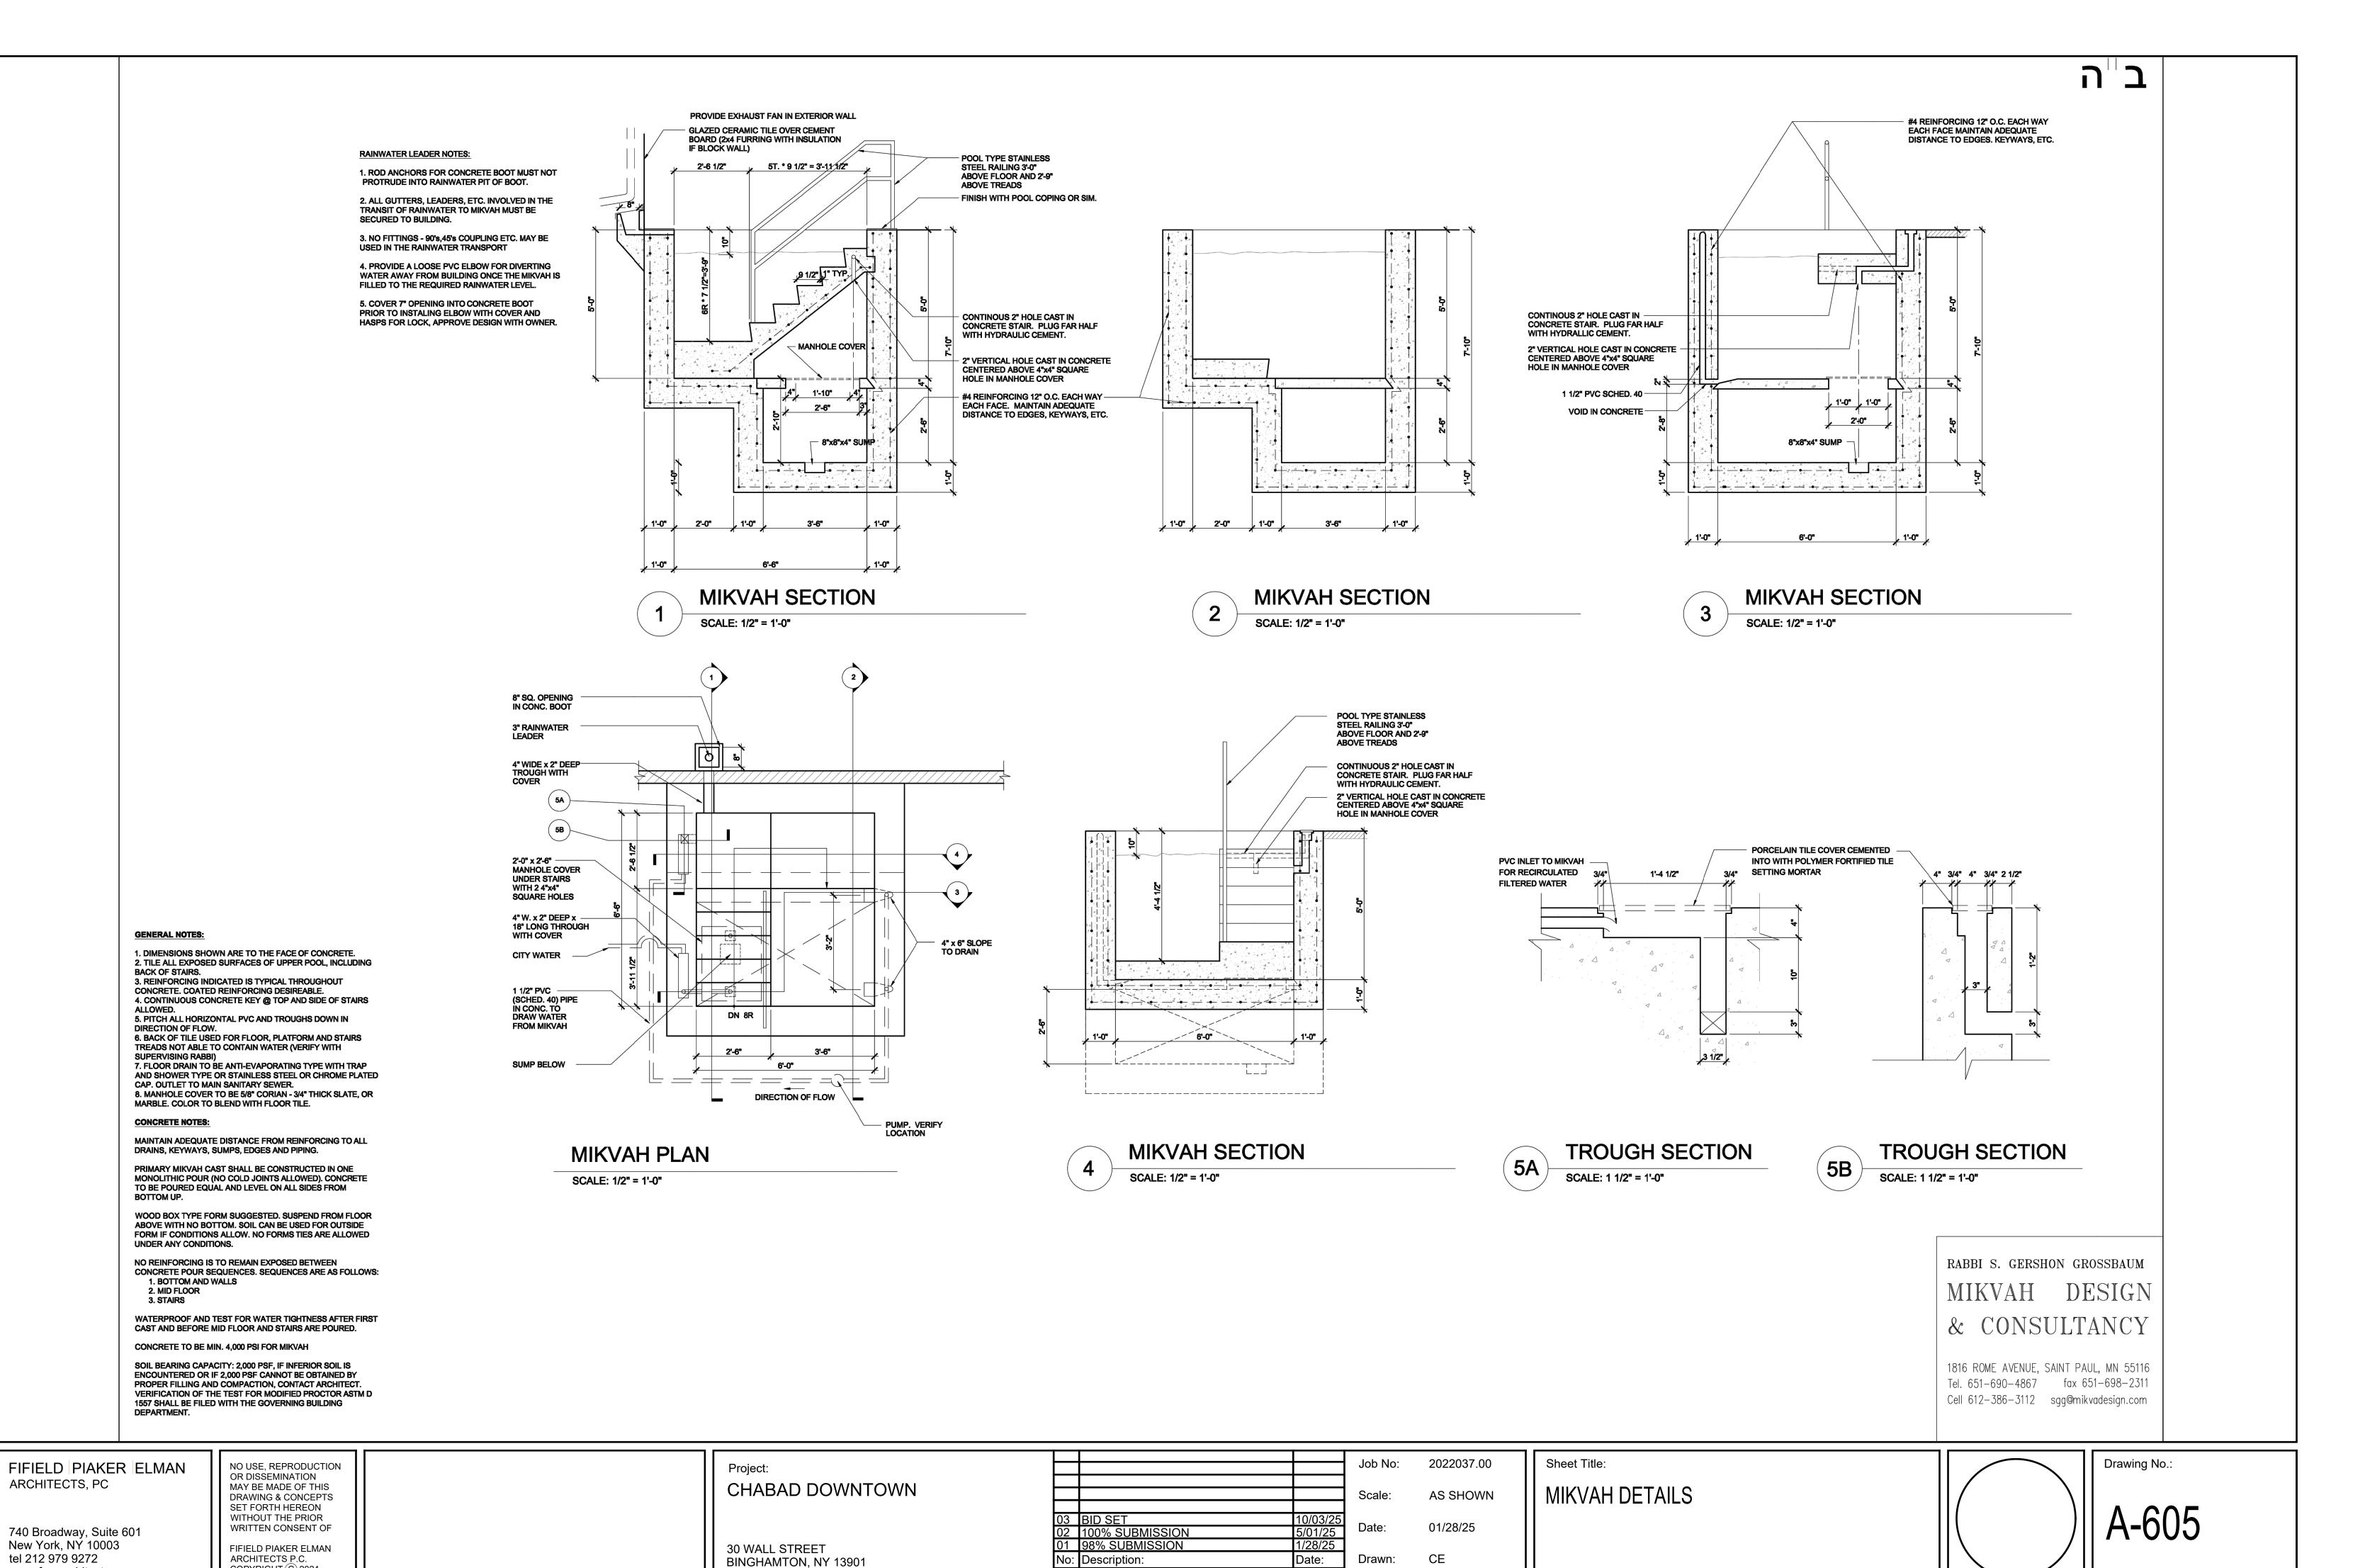



Revisions:

COPYRIGHT © 2024

www.fpe-architects.com

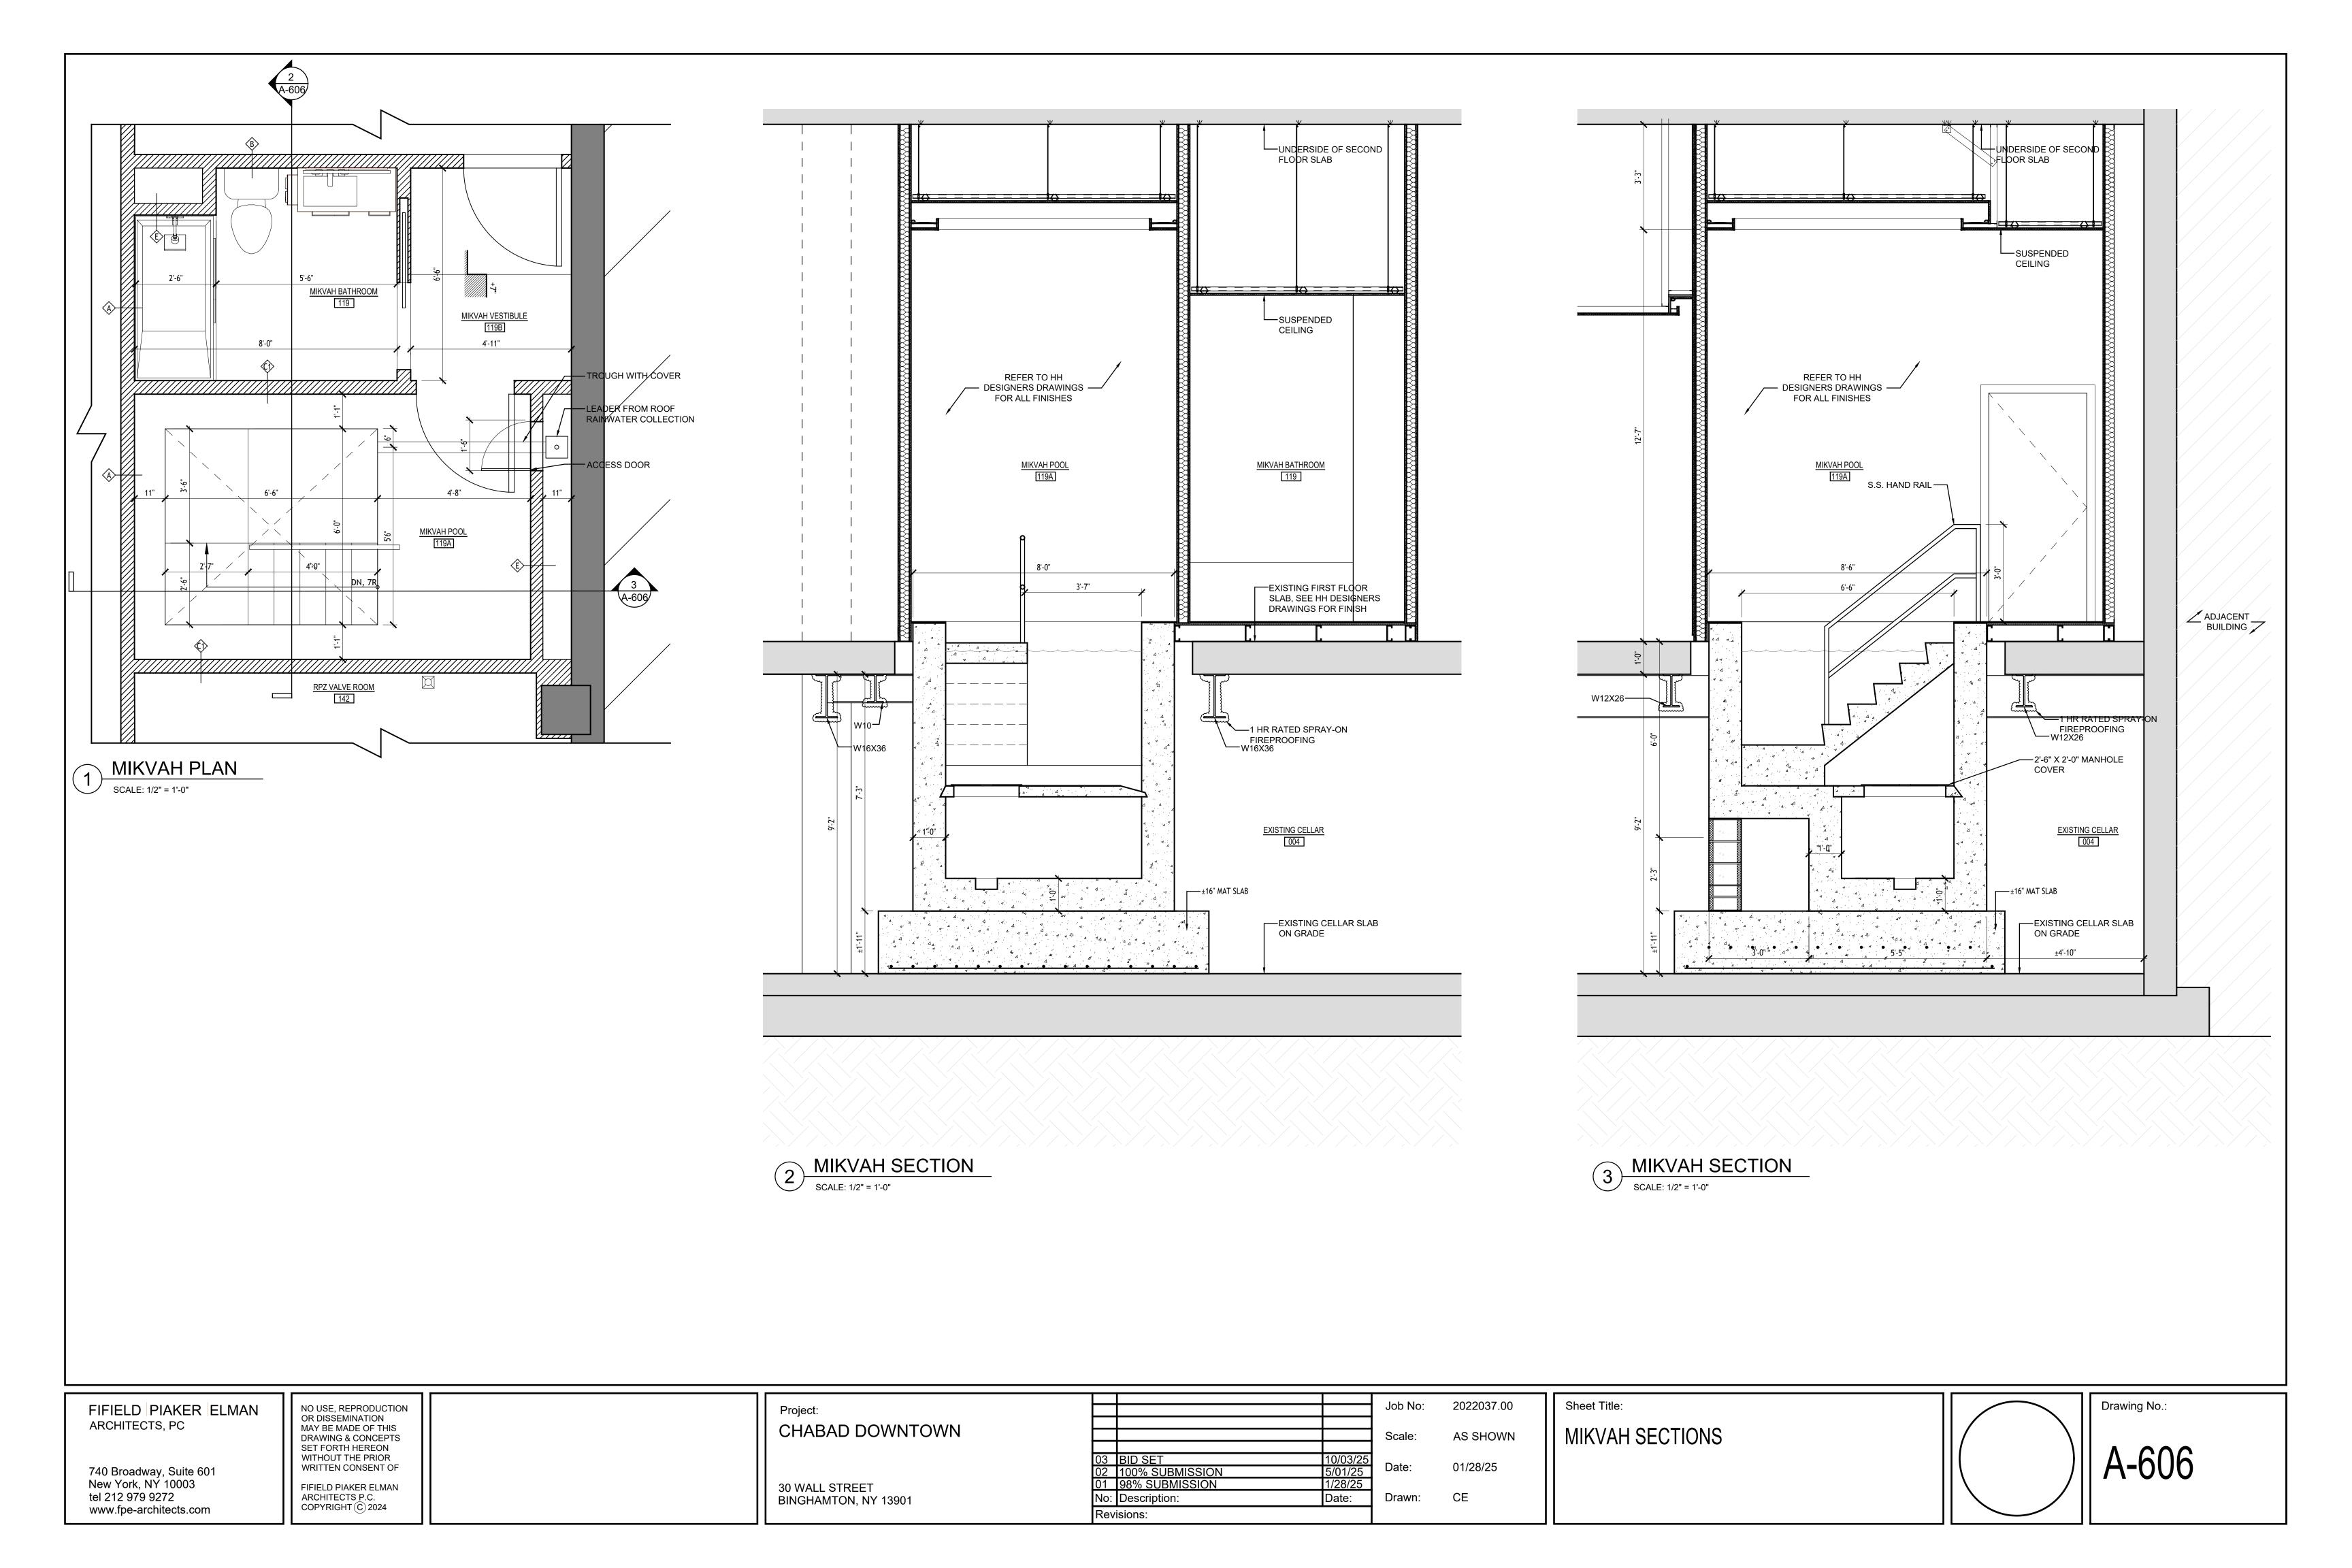

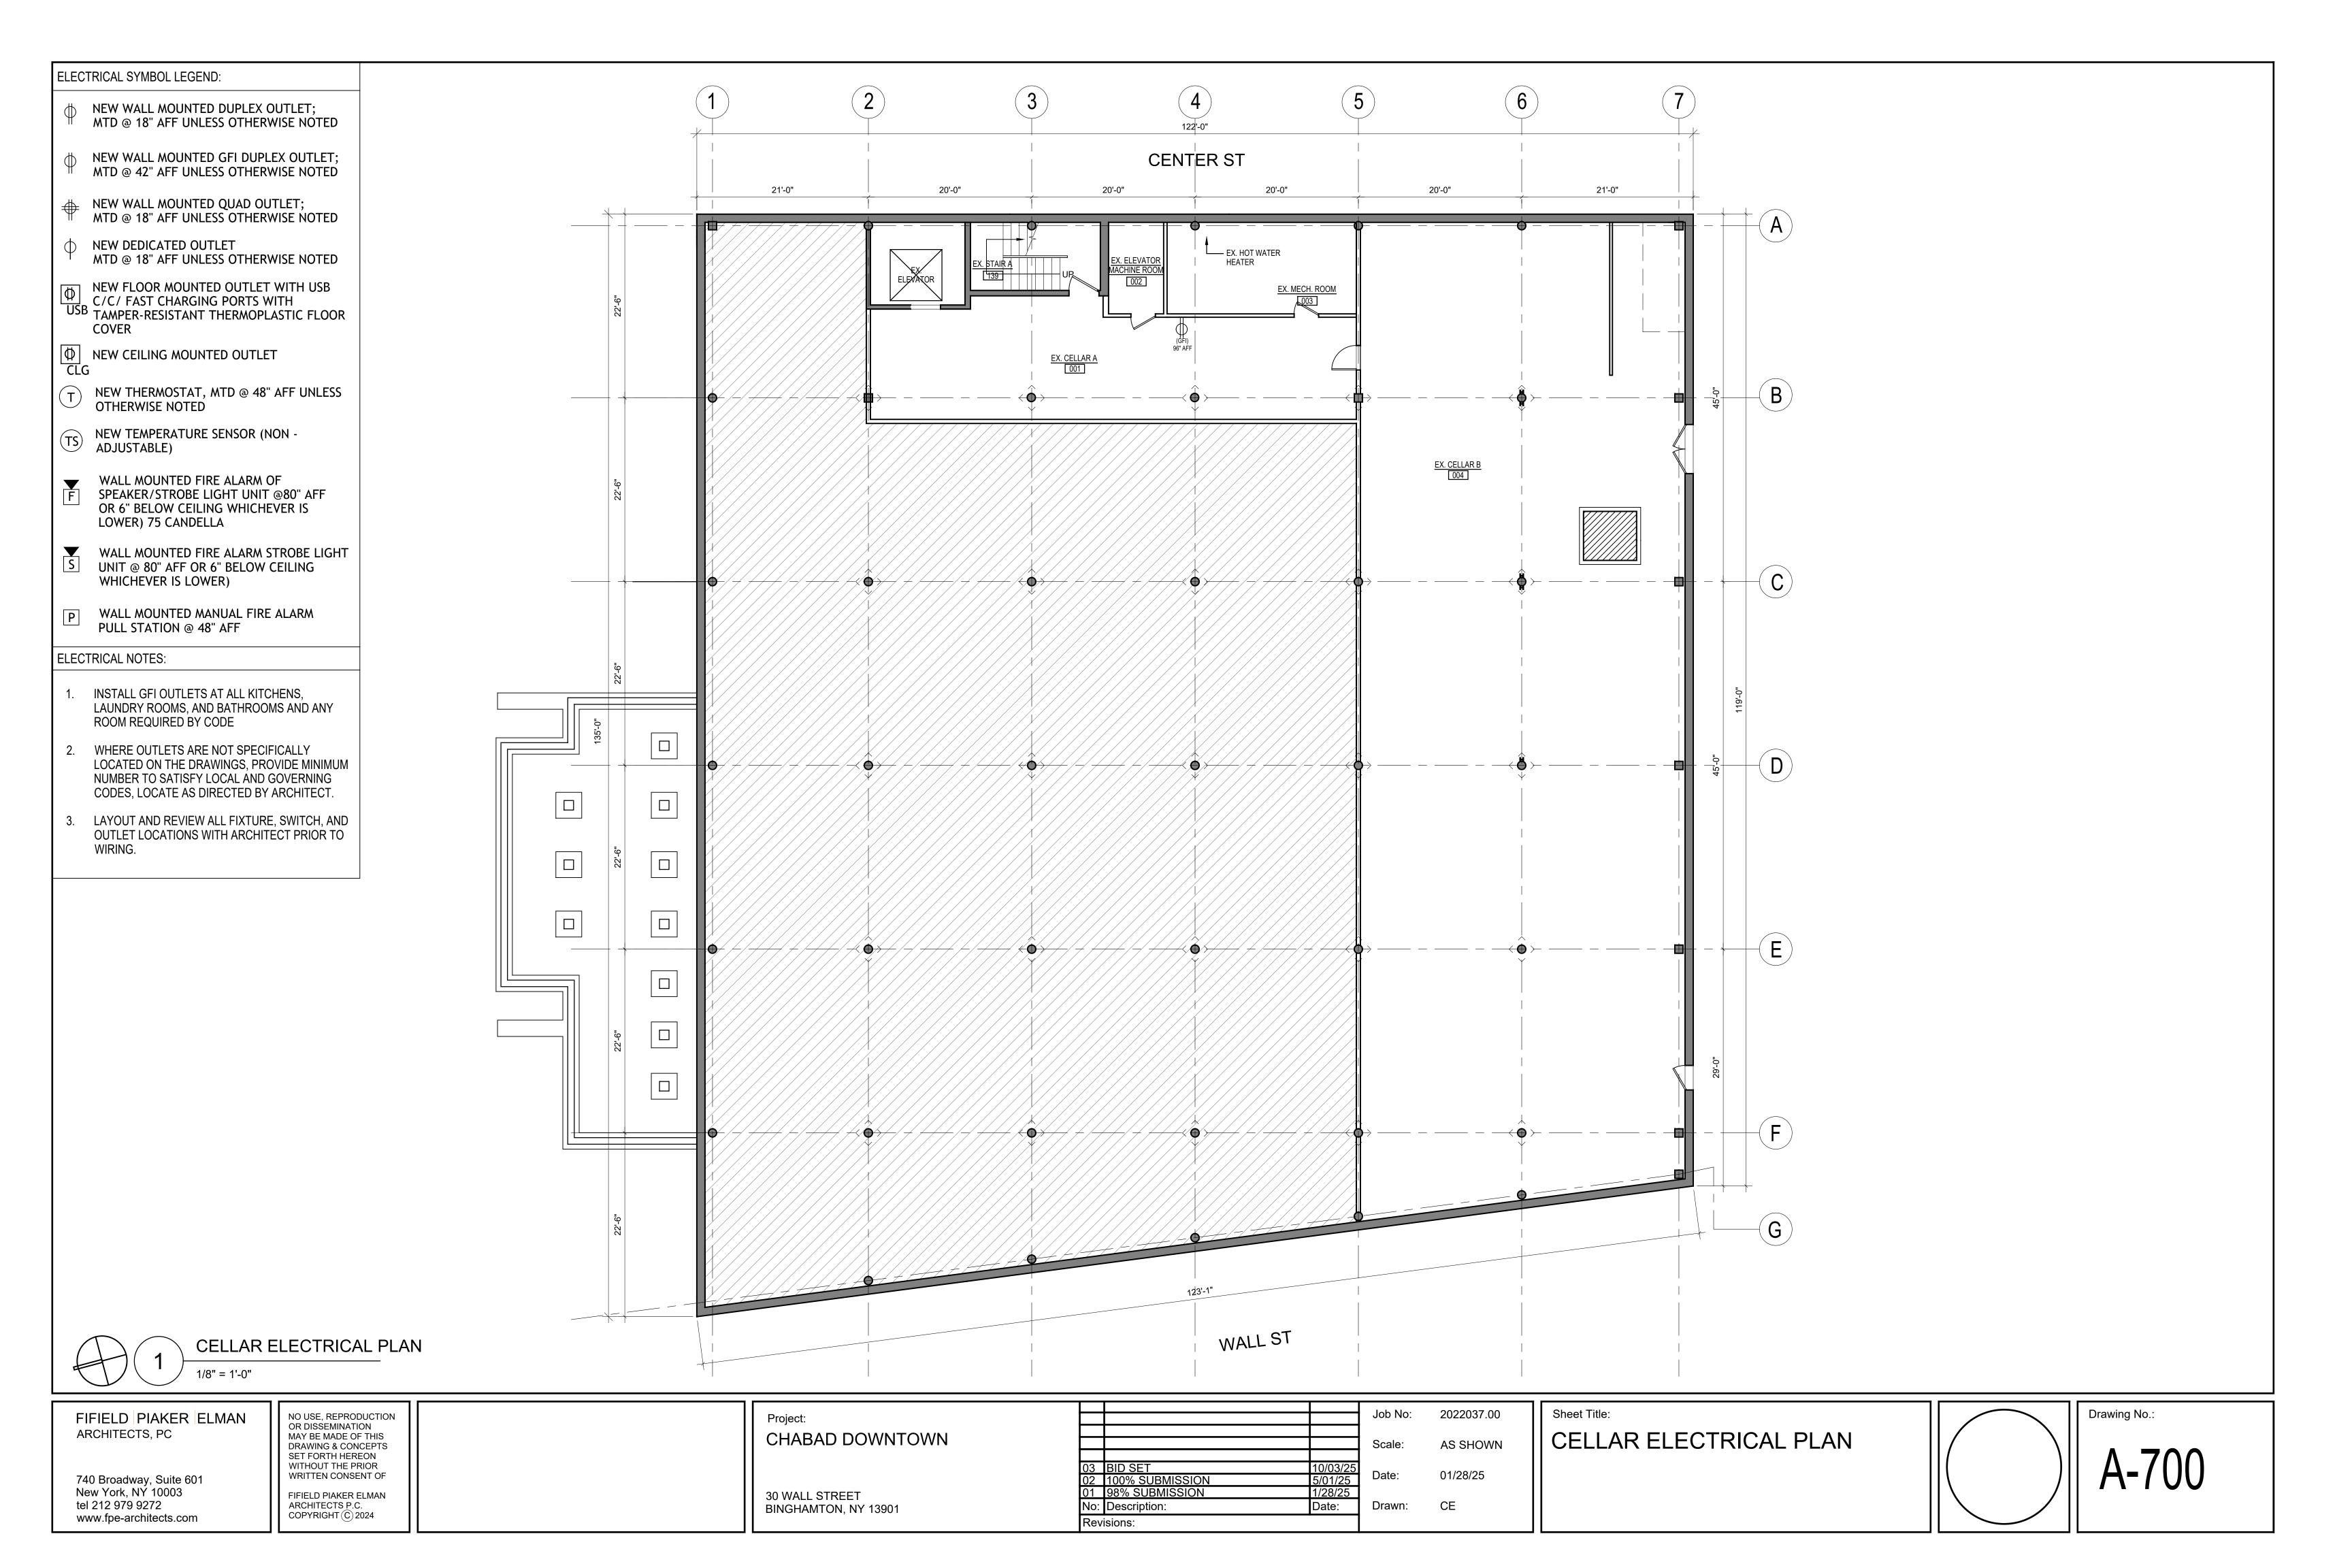

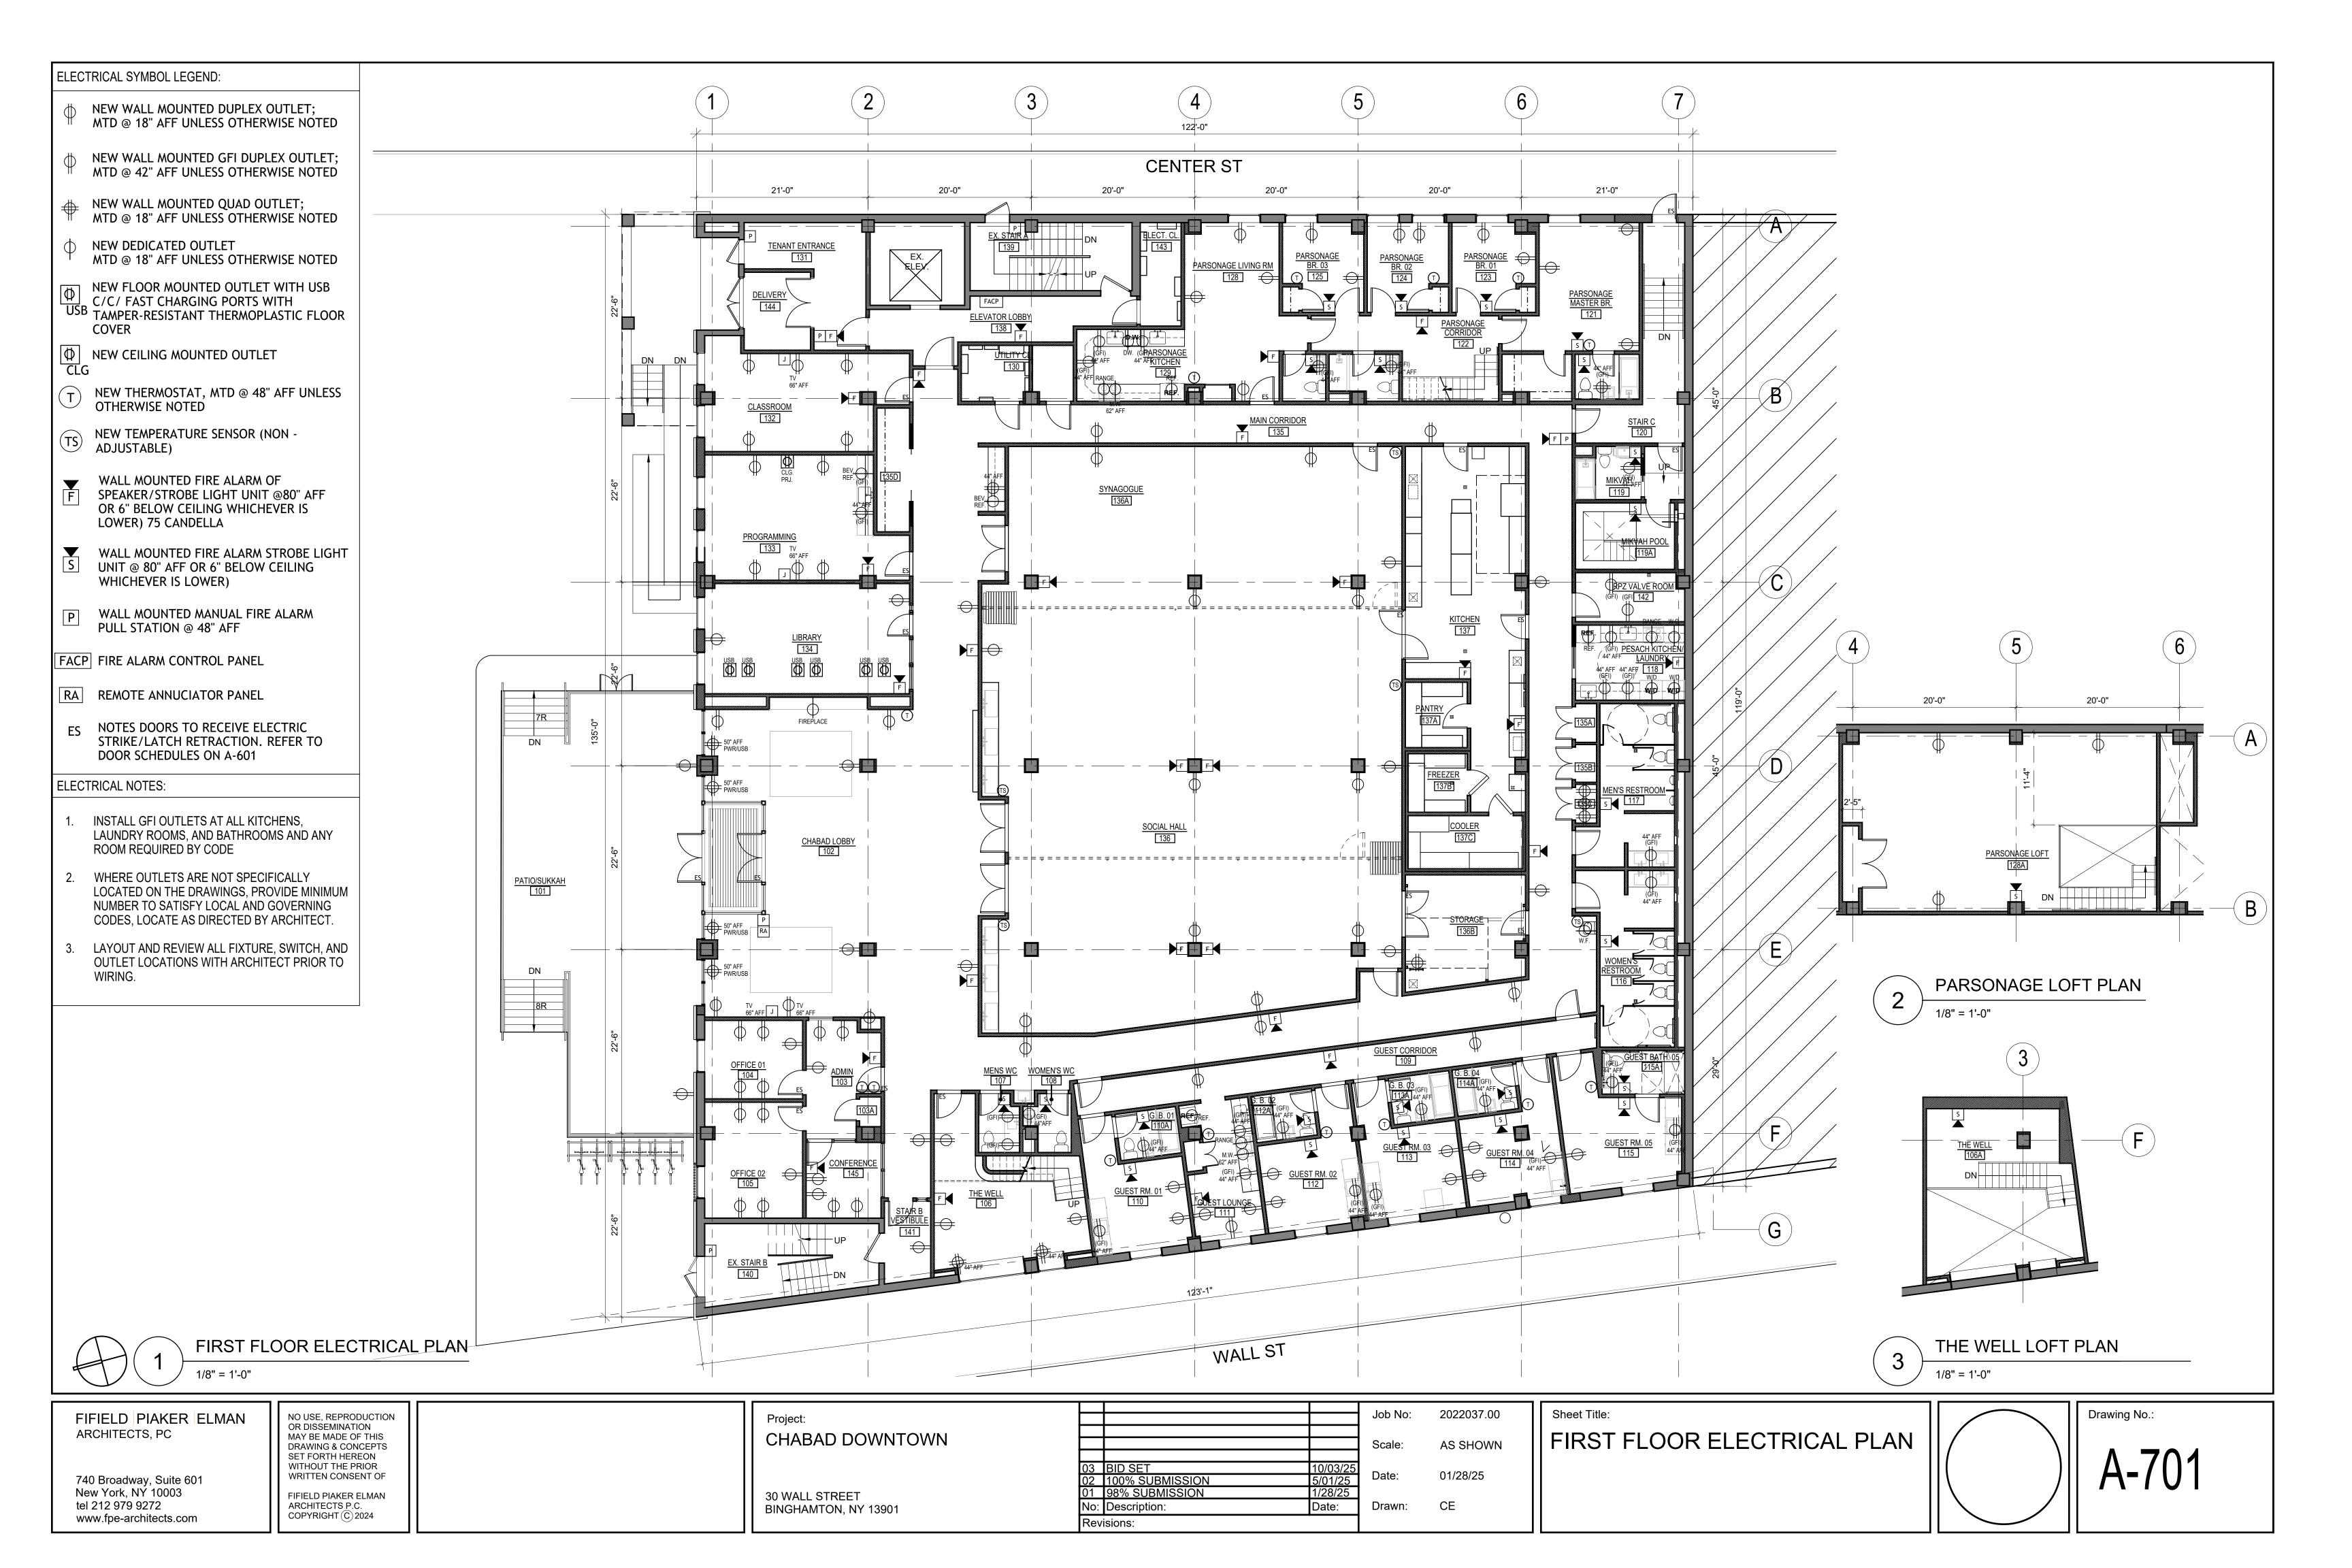

	MATERIAL SCHEDULE				ULE		LIGHT FIXTURE SCHEDULE	LIGHT FIXTURE SCHEDULE			
SYMBOL	MATERIAL	MANUFACTURER	MODEL NO).	COLOR/FINIS	H DIMS. REMARKS	TYPE DESCRIPTION MANUFACTURER LAMP WATTS VOLTS CONTROL	REMARKS LOCATION QTY			
ACT-1 CO-1	ACOUSTIC CEILING TILE PAINTED CONCRETE	ARMSTRONG	BRIGHTEX		WHITE -	2'x2'	FC FC	EFER TO HH AND CL DRAWINGS OR SPECS, LOCATIONS, AND UANTITY			
EP-1 PT-1	EPOXY FLOOR WALL PAINT	- BENJAMIN MOORE	- OC-65		- CHANTILLY LA	CE EGGSHELL		EFER TO HH AND CL DRAWINGS OR SPECS, LOCATIONS, AND			
PT-2 WB-1	CEILING PAINT VINYL WALL BASE	BENJAMIN MOORE ROPPE	OC-65	L BASE	CHANTILLY LA 100 BLACK		2" TRIMLESS SPOTLIGHT RE	EFER TO HH AND CL DRAWINGS			
WB-1 VINYL WALL BASE ROPPE VINYL WALL BASE 100 BLACK 1/8" TH. *ALL MATERIALS PROVIDED BY CONTRACTOR - INSTALLED BY CONTRACTOR								OR SPECS, LOCATIONS, AND JUANTITY			
				FIN	NISH SCHEDULE		TA FC	EFER TO HH AND CL DRAWINGS OR SPECS, LOCATIONS, AND UANTITY			
ROOM NA	ME ROOM N	O. FLOOR CEILING	SURFACE FII G NORTH SOUTH		WEST GEN. MAT.	REMARKS	CLOSET LIGHT RE	EFER TO HH AND CL DRAWINGS OR SPECS, LOCATIONS, AND			
PATIO/SU							QU QU	UANTITY			
CHABAD L ADMIN	103					REFER TO HH DESIGNERS DRAWINGS REFER TO HH DESIGNERS DRAWINGS REFER TO HH DESIGNERS DRAWINGS	T FC	EFER TO HH AND CL DRAWINGS OR SPECS, LOCATIONS, AND UANTITY			
ADMIN CL. OFFICE 01 OFFICE 02	103A 104 105					REFER TO HH DESIGNERS DRAWINGS REFER TO HH DESIGNERS DRAWINGS REFER TO HH DESIGNERS DRAWINGS		EFER TO HH AND CL DRAWINGS OR SPECS, LOCATIONS, AND			
THE WELL	106	TBD. TBD. TBD.	TBD. TBD. TBD.	TBD.	TBD. TBD. TBD. TBD. TBD.		QL QL	UANTITY			
MEN'S WC WOMEN'S	WC 108					REFER TO HH DESIGNERS DRAWINGS REFER TO HH DESIGNERS DRAWINGS	FC	EFER TO HH AND CL DRAWINGS OR SPECS, LOCATIONS, AND WANTITY			
HOSPITAL						REFER TO HH DESIGNERS DRAWINGS REFER TO HH DESIGNERS DRAWINGS		EFER TO HH AND CL DRAWINGS OR SPECS, LOCATIONS, AND			
	TY BATH 01 110A TY LOUNGE 111 TY RM 02 112					REFER TO HH DESIGNERS DRAWINGS REFER TO HH DESIGNERS DRAWINGS REFER TO HH DESIGNERS DRAWINGS	QU QU	EFER TO HH AND CL DRAWINGS			
	TY BATH 02 112A					REFER TO HH DESIGNERS DRAWINGS REFER TO HH DESIGNERS DRAWINGS	LT4	OR SPECS, LOCATIONS, AND JUANTITY			
	TY BATH 03 113A					REFER TO HH DESIGNERS DRAWINGS REFER TO HH DESIGNERS DRAWINGS	LT2	EFER TO HH AND CL DRAWINGS OR SPECS, LOCATIONS, AND			
HOSPITAL						REFER TO HH DESIGNERS DRAWINGS REFER TO HH DESIGNERS DRAWINGS	Qt	EFER TO HH AND CL DRAWINGS			
	TY BATH 05 115A RESTROOM 116					REFER TO HH DESIGNERS DRAWINGS REFER TO HH DESIGNERS DRAWINGS REFER TO HH DESIGNERS DRAWINGS	LT3	OR SPECS, LOCATIONS, AND JUANTITY			
	TCHEN/LAUNDRY 118 119					REFER TO HH DESIGNERS DRAWINGS REFER TO HH DESIGNERS DRAWINGS	FC	EFER TO HH AND CL DRAWINGS OR SPECS, LOCATIONS, AND			
MIKVAH PO STAIR C	120	CO-1 PT-2	PT-1 PT-1	PT-1	PT-1 - WB-1	REFER TO HH DESIGNERS DRAWINGS	LED TAPE RE	EFER TO HH AND CL DRAWINGS			
PARSONA	GE MASTER BR. 121 GE MASTER BATH. 121A					REFER TO HH DESIGNERS DRAWINGS REFER TO HH DESIGNERS DRAWINGS		OR SPECS, LOCATIONS, AND JUANTITY			
PARSONA PARSONA						REFER TO HH DESIGNERS DRAWINGS REFER TO HH DESIGNERS DRAWINGS REFER TO HH DESIGNERS DRAWINGS	LT6	EFER TO HH AND CL DRAWINGS OR SPECS, LOCATIONS, AND WANTITY			
PARSONA PARSONA	GE BR. 03 125					REFER TO HH DESIGNERS DRAWINGS REFER TO HH DESIGNERS DRAWINGS	LED TAPE RE	EFER TO HH AND CL DRAWINGS			
PARSONA	GE POWDER RM. 127 GE LIVING RM. 128					REFER TO HH DESIGNERS DRAWINGS REFER TO HH DESIGNERS DRAWINGS		OR SPECS, LOCATIONS, AND JUANTITY			
	GE KITCHEN 129				DT 4	REFER TO HH DESIGNERS DRAWINGS REFER TO HH DESIGNERS DRAWINGS	I TO FO	EFER TO HH AND CL DRAWINGS OR SPECS, LOCATIONS, AND UANTITY			
TENANT E	NTRANCE 131	CO-1 EX. CO-1 ACT-1	PT-1 PT-1 PT-1	PT-1	PT-1 - WB-1 PT-1 - WB-1	REFER TO HH DESIGNERS DRAWINGS	LED TAPE	EFER TO HH AND CL DRAWINGS OR SPECS, LOCATIONS, AND			
PROGRAM LIBRARY						REFER TO HH DESIGNERS DRAWINGS REFER TO HH DESIGNERS DRAWINGS	CI 9	UANTITY			
MAIN COR SOCIAL HA	LL 136					REFER TO HH DESIGNERS DRAWINGS REFER TO HH DESIGNERS DRAWINGS	LT10	EFER TO HH AND CL DRAWINGS OR SPECS, LOCATIONS, AND UANTITY			
SYNAGOG STORAGE KITCHEN PANTRY		CO-1 ACT-1 EP-1 ACT-1 EP-1 ACT-1	PT-1 PT-1 PT-1 PT-1 PT-1	PT-1 PT-1 PT-1	PT-1 - WB-1 PT-1 - WB-1 PT-1 - WB-1	REFER TO HH DESIGNERS DRAWINGS	LT11	EFER TO HH AND CL DRAWINGS OR SPECS, LOCATIONS, AND OUANTITY			
FREEZER COOLER ELEVATOR	137B 137C	EP-1 - EP-1 - CO-1 ACT-1	PT-1	- PT-1	PT-1 - WB-1		LT12	EFER TO HH AND CL DRAWINGS OR SPECS, LOCATIONS, AND UANTITY			
EXISTING EXISTING STAIR B VI	STAIR A 139 STAIR B 140	EX. EX. EX. CO-1 ACT-1	PT-1 PT-1 PT-1 PT-1 PT-1	PT-1 PT-1 PT-1	PT-1 - EX. PT-1 - EX. PT-1 - WB-1		FC FC	EFER TO HH AND CL DRAWINGS OR SPECS, LOCATIONS, AND OUANTITY			
RPZ VALVI ELECTRIC DELIVERY	RM. 142 AL CL. 143	CO-1 EX. CO-1 EX. CO-1 ACT-1	PT-1 PT-1 PT-1 PT-1 PT-1	PT-1 PT-1 PT-1	PT-1 - WB-1 PT-1 - WB-1 PT-1 - WB-1		LIBRARY FIXTURE RE	EFER TO HH AND CL DRAWINGS OR SPECS, LOCATIONS, AND			
NOTES:							FAMILY WING FIXTURE F3	EFER TO HH AND CL DRAWINGS OR SPECS, LOCATIONS, AND			
							F1 FC	EFER TO HH AND CL DRAWINGS OR SPECS, LOCATIONS, AND			
							FC FC	EFER TO HH AND CL DRAWINGS OR SPECS, LOCATIONS, AND			
							FC FC	EFER TO HH AND CL DRAWINGS OR SPECS, LOCATIONS, AND			
FPE1 EXTERIOR WALL SCONCE TECH LIGHTING CHARA 26 OUTDOOR WALL, BLACK LED 3000K 90+ CRI 1286 LM 11.8 UNV EXTERIOR 1											
	NOTES: - REFER TO HH AND CONSUMER'S LIGHTING DRAWINGS FOR ALL OTHER FIXTURES										
FIFIELD PIAKER ELMAN No USE, REPRODUCTION Project: Project: Project:											
	ITECTS, PC	OR DISSEMINATION MAY BE MADE OF T DRAWING & CONCE SET FORT THE BROWN	THIS EPTS DN			CHABAD DOWNTOWN	Scale: AS SHOWN FINISH SCHEDULES				
740 B New Y	oadway, Suite 601 ork, NY 10003	WITHOUT THE PRIC WRITTEN CONSENT	IT OF			30 WALL STREET	03 BID SET 10/03/25 02 100% SUBMISSION 5/01/25 01 98% SUBMISSION 1/28/25	() A-900			

740 Broadway, Suite 601 New York, NY 10003 tel 212 979 9272 www.fpe-architects.com

WRITTEN CONSENT OF FIFIELD PIAKER ELMAN ARCHITECTS P.C. COPYRIGHT © 2024

30 WALL STREET BINGHAMTON, NY 13901

03 BID SET
02 100% SUBMISSION
01 98% SUBMISSION
No: Description: 10/03/25 5/01/25 Date: Drawn: Drawn: CE Revisions:

