
DISCIPLINE DESIGNATION —
G = GENERAL
S = STRUCTURAL
A = ARCHITECTURAL
M = MECHANICAL
E = ELECTRICAL - SHEET TYPE 0 = GENERAL 1 = PLANS 5 = DETAILS

SHEET NUMBER: G - 0 0 1 NUMBERING CONVENTION

SHEET SEQUENCE NO.

DRAWING INDEX			
NO.	SHEET TITLE		
G-001	COVER SHEET		
G-101	CODE DATA, GENERAL NOTES, AND OVERALL PLAN		
G-102	SITE PLAN AND SAFEGUARD NOTES		
5-101	DESIGN DATA AND GENERAL NOTES - PH1		
5-102	SNOW DRIFT LOADING PLAN - PH1		
A-101	GENERAL ROOFING NOTES AND ABBREVIATIONS		
A-102	ROOF DEMOLITION PLAN		
A-103	ROOF PLAN		
A-104	ROOF TAPERED PLAN		
A-105	ROOF PLANS		
A-106	PHOTOS		
A-501	DETAILS		
A-502	DETAILS		
A-503	DETAILS		
A-504	DETAILS		
A-505	DETAILS		
A-506	DETAILS		
A-507	DETAILS		
A-508	DETAILS		
M-000	GENERAL NOTES & SYMBOLS LIST - MECHANICAL		
M-101	PARTIAL ROOF PLANS - MECHANICAL		
M-501	DETAILS - MECHANICAL		
E-000	GENERAL NOTES AND ABBREVIATIONS - ELECTRICAL		
E-101	PARTIAL ROOF PLANS - ELECTRICAL		
E-501	DETAILS - ELECTRICAL		

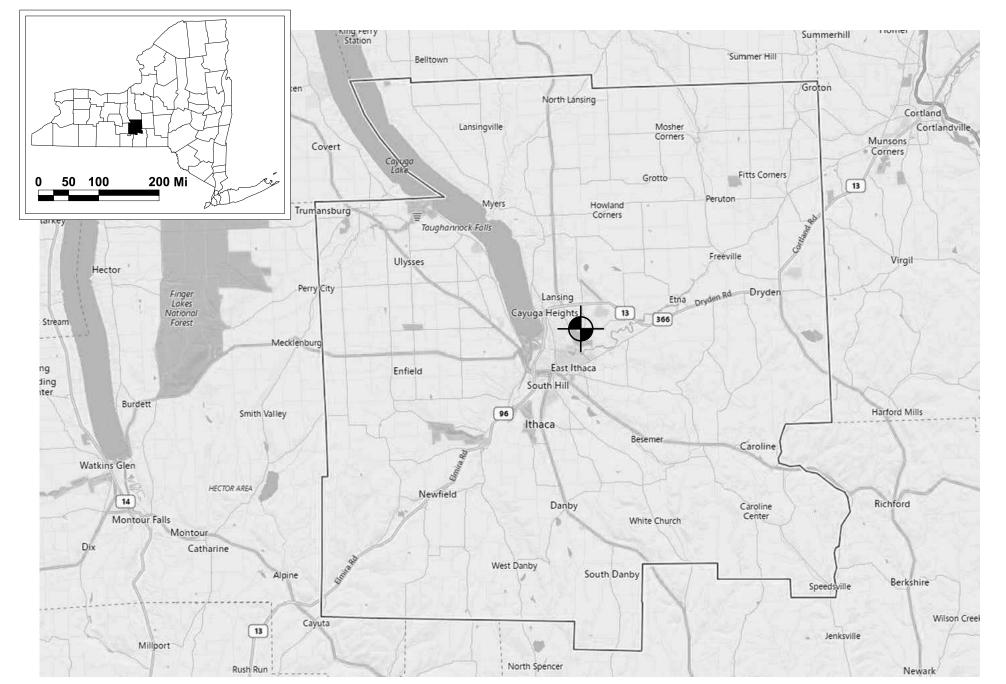

LOCATION MAP



215 Wyoming Street Suite 201 Syracuse, NY 13204 Pittsford, NY 14534
Tel (315) 488 - 0377 Tel (585) 200 - 5038
Fax (315) 487 - 5947 Fax (585) 487 - 9532

info@bellandspina.com www.bellandspina.com

PROJECT#: 319-24-032

10/10/2025

CENTER

9102

~


0


4853


AREA OF WORK CAMPUS ROAD





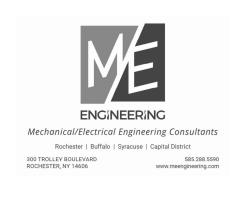


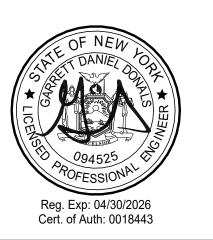

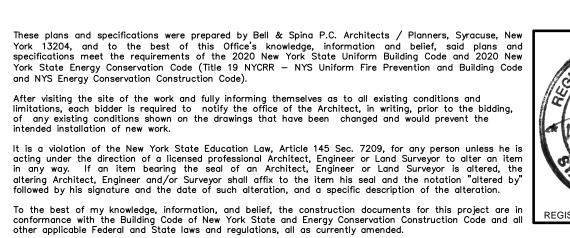



SITE PLAN

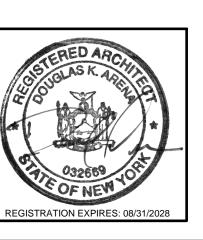

SET NUMBER:

BUILDING NAME AND LOCATION	REPLACE ROOF - VETERINARY MEDICAL CENTER - PHASE 1 930 CAMPUS ROAD ITHACA, NY 14853 COUNTY				
CODE REFERENCE	2020 NYS BUILDING CODE AND / OR 2020 NYS EXISTING BUILDING				
ITEM (SECTION)	EXISTING	REQ.	PROPOSED	REMARKS	
ALTERATION CLASSIFICATION TYPE (EBCNYS CHAPTER 5)			ALTERATIONS LEVEL 1	ROOF REPLACEMENT IN KIND	
USE & OCCUPANCY GROUP (BCNYS CHAPTER 3)	В		N/C		
CONSTRUCTION TYPE (BCNYS CHAPTER 6)	1B		N/C		
BUILDING HEIGHT (BCNYS 504.3)	32'-9"±	N/C	N/C		
BUILDING AREA (BCNYS 506.2)	N/C	N/C	N/C		
BUILDING NO. STORIES (BCNYS TBL 504.4)	3	N/C	N/C		
MIXED USE AND OCCUPANCIES					
SEPARATION OF OCCUPANCIES (BCNYS 508.4)	N/C	N/C	N/C		
INCIDENTAL USES (BCNYS 509)		N/C	N/C		
ACCESSORY USE AREAS (BCNYS 508.2)		N/C	N/C		
SPECIAL USE & OCCUPANCY (BCNYS CHAPTER 4)	N/C	N/C	N/C		
MEANS OF EGRESS (BCNYS CHAPTER 10)	N/C	N/C	N/C		
ACCESSIBILITY (BCNYS CHAPTER 11)	N/C	N/C	N/C		

BUILDING CODE SUMMARY DATA

TO THE BEST OF THE REGISTERED DESIGN PROFESSIONALS KNOWLEDGE, BELIEF AND PROFESSIONAL JUDGEMENT, THESE PLANS AND/OR SPECIFICATIONS ARE IN COMPLIANCE WITH THE 2020 UNIFORM CODE

COUNTY
CLIMATE ZONE
COMMERCIAL / RESIDENTIAL

COMPLIANCE METHOD
(IECC SECTION C401)

TOMPKINS COUNTY
6A
COMMERCIAL

ECCNYS CHAPTER 4

ENVELOPE SCOPE OF WORK REPLACEMENT OF ROOF DOORS AND SKYLIGHTS

REPLACEMENT OF ROOF COVERING/INSULATION, ROOF ACCESS DOORS AND SKYLIGHTS

	DOORS AND SKYLIGHTS				
ITEM (SECTION)	EXISTING	REQ.	PROPOSED	REMARKS	
ROOF INSULATION					
INSULATION ABOVE ROOF DECK	R-20ci	R-30ci	R-30ci		
ATTIC INSULATION	N/C	N/C	N/C		
WALLS ABOVE GRADE	N/C	N/C	N/C		
WALLS BELOW GRADE	N/C	N/C	N/C		
SLAB ON GRADE					
FENESTRATION					
VERTICAL FENESTRATION (MAX30%)	N/C	N/C	N/C		
U-FACTOR (FIXED)	N/C	N/C	N/C		
U-FACTOR (OPERABLE)	N/C	N/C	N/C		
SHGC	N/C	0.40	0.35		
U-VALUE (SKYLIGHTS)	N/C	0.50	0.38		
AIR LEAKAGE	N/C	N/C	N/C		
VAPOR RETARDER	N/C	N/C	N/C		
AIR BARRIER	N/C	N/C	N/C		

N/A - NOT APPLICABLE N/C - NO CHANGE N/R - NOT REQUIRED N/P - NOT PROVIDED

TO THE BEST OF THE REGISTERED DESIGN PROFESSIONALS KNOWLEDGE BELIEF AND PROFESSION

TO THE BEST OF THE REGISTERED DESIGN PROFESSIONALS KNOWLEDGE, BELIEF AND PROFESSIONAL JUDGEMENT, THESE PLANS AND/OR SPECIFICATIONS ARE IN COMPLIANCE WITH THE 2020 ENERGY CONSERVATION CONSTRUCTION CODE OF NEW YORK STATE.

GENERAL DESIGN NOTES:

- THIS PROJECT IS DESIGNED IN ACCORDANCE WITH 2020 BUILDING CODE OF NEW YORK STATE (REFERENCING THE 2018 INTERNATIONAL CODES).
- 2. EXPOSED MATERIALS THAT WERE ANTICIPATED TO BE WITHIN THE SCOPE OF THIS PROJECT AT THE TIME OF DESIGN HAVE BEEN TESTED FOR ASBESTOS AND LEAD PAINT CONTENT. SEE THE HAZARDOUS MATERIAL SURVEY REPORT APPENDED TO THE PROJECT MANUAL FOR A LIST OF TESTED MATERIALS. AND THEIR RESULTS. IN SUMMARY, ACM MATERIALS & LEAD BASED MATERIALS ARE NOT ANTICIPATED TO BE DISTURBED.
- 3. THE SCOPE OF WORK GENERALLY INCLUDES THE FOLLOWING:
 3.1. COMPLETE REMOVAL AND REPLACEMENT OF THE EXISTING ROOF ASSEMBLY DOWN TO THE
- 3.1. COMPLETE REMOVAL AND REPLACEMENT OF THE EXISTING ROOF ASSEMBLY DOWN TO THE STEEL AND CONCRETE ROOF DECKS AND ASSOCIATED ROOF FLASHINGS,
- 3.2. INSTALLATION OF NEW INSULATED ROOF ASSEMBLIES,
- 3.3. INCIDENTAL REPLACEMENTS OF ROOFTOP ELECTRICAL COMPONENTS, 3.4. NEW THROUGH-WALL FLASHINGS,
- 3.5. RELATED BUILDING/ OCCUPANT PROTECTION AND SITE RESTORATION,
- 4. THE ROOFING SYSTEMS AND FLASHINGS SHALL BE MANUFACTURED AND INSTALLED IN ACCORDANCE WITH FM GLOBAL STANDARDS TO ACHIEVE A 1-90 RATING (ZONE 1) UNLESS NOTED OTHERWISE. CUSTOM FABRICATED PERIMETER EDGE METAL FLASHINGS ARE REQUIRED TO TESTED AND APPROVED IN ACCORDANCE WITH ANSI/SPRI/FM-4435/ES-1 UNDER THIS CONTRACT. REFER TO THE PROJECT SPECIFICATIONS.
- 5. PROJECT MOCKUPS: MOCKUP REQUIREMENTS ARE INNUMERATED IN THE PROJECT SPECIFICATIONS.
 THE FOLLOWING IN PLACE OR ON THE BUILDING MOCKUPS ARE REQUIRED. LOCATIONS TO BE
 APPROVED BY THE ARCHITECT
- 6. BID ALTERNATES: THE PROJECT INCLUDES THE FOLLOWING BID ALTERNATES AS INDICATED ON THE DRAWINGS:
- 6.1. ADD ALTERNATE #1: REMOVE AND REPLACE ROOF ASSEMBLY FOR ROOF AREA 1164-001B AND 1164-012.
- 6.2. ADD ALTERNATE #2: REMOVE AND REPLACE ROOF ASSEMBLY FOR ROOF AREA 1164-008
 6.3. ADD ALTERNATE #3: REMOVE AND REPLACE ROOF ASSEMBLY FOR ROOF AREA 1163-001
- 7. ROOF DIAPHRAGM EVALUATION (IN ACCORDANCE WITH THE 2020 IEBC CHPT 106.3.2)
 7.1. PROVIDE THE THE UNIVERSITY DESIGNATED REPRESENTATIVE AND THE DESIGN CONSULTANT/
 STRUCTURAL ENGINEER SAFE ACCESS TO EVALUATE THE CONDITION OF THE STRUCTURAL ROOF
 DECK, DIAPHRAGM, FRAMING AND CONNECTIONS AS REQUIRED BY THE EXISTING BUILDING CODE
 OF NYS.
- 7.2. THE UNIVERSITY DESIGNATED REPESENTATIVE SHALL BE GIVEN A MINIMUM OF TWO (2) WEEKS NOTICE OF REMOVALS.
- 7.3. DURING REMOVALS, EXPOSE REPRESENTATIVE LOCATIONS OR CONDITIONS FOR REVIEW.
 7.4. BE RESPONSIBLE FOR PROVIDING WEATHERTIGHTNESS AT EACH REMOVAL LOCATION.
- 8. CONTRACTOR SHALL INCLUDE 1000 SF OF APPLIED FIRE PROTECTION, PER SPECIFICATION 078100 TO REPAIR ANY AREAS DISTURBED BY THE WORK OF THIS CONTRACT. CONTRACTOR IS RESPONSIBLE FOR REPAIRING AREAS DISTURBED WITH PROVIDED FIRE PROTECTION

DESIGN WIND UPLIFT NOTES

- DESIGN WIND UPLIFT PRESSURES ARE DERIVED IN ACCORDANCE WITH ASCE 7-16 AND/OR THE 2020 NYS UNIFORM FIRE PREVENTION AND BUILDING CODE.
- 2. WIND PRESSURES ARE CONSERVATIVELY BASED ON AN EFFECTIVE COMPONENT & CLADDING AREA OF 10 SQUARE FEET OR LESS. PRESSURES ARE APPLIED NORMAL TO THE SURFACE OF THE COMPONENT OR CLADDING.
- 3. THE ROOFING MANUFACTURER SHALL PROVIDE A TOTAL SYSTEM CAPABLE OF RESISTING THE WIND UPLIFT PRESSURES AT THE DEPICTED LOCATIONS, APPLYING A MINIMUM 2.0X FACTOR OF SAFETY.
- 4. THE MANUFACTURER OF METAL EDGE COMPONENTS FOR THE ROOF PERIMETER SHALL PROVIDE SYSTEMS CAPABLE OF RESISTING THE WIND UPLIFT PRESSURES AT THE DEPICTED LOCATIONS, APPLYING A MINIMUM 1.67x FACTOR OF SAFETY.
- 5. MISCELLANEOUS FASTENERS ANCILLARY TO THE PROPRIETARY SYSTEMS OF THE ROOFING AND METAL EDGE COMPONENT MANUFACTURERS SHALL BE CAPABLE OF RESISTING THE WIND UPLIFT PRESSURES AT THE DEPICTED LOCATIONS, APPLYING A MINIMUM 4.0X FACTOR OF SAFETY.




Syracuse, NY 13204 Pittsford, NY 14534
Tel (315) 488-0377 Tel (585) 200-5038
Fax (315) 487-5947 Fax (585) 487-9532
info@bellandspina.com
www.bellandspina.com



It is a violation of the New York State Education Law, Article 145 Sec. 7209, for any person unless he is acting under the direction of a licensed professional Architect, Engineer or Land Surveyor to alter an item in any way. If an item bearing the seal of an Architect, Engineer or Land Surveyor is altered, the altering Architect, Engineer or Land Surveyor shall affix to the item his seal and the notation "altered by" followed by his signature and the date of such alteration, and a specific description of the alteration.

PROJECT NORTH

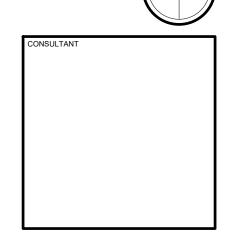

ROOF - VETERINARY MEDICAL CENTER - PHASE 1

KEPLAUE KUUF 930 CAMPUS R ITHACA, NY 148

PROJECT NUMBER

319-24-032

The Contractor shall verify all dimensions an notify the Architect in writing of an discrepancies.

All drawings and specifications are the

All drawings and specifications are the property of the Architect and shall be used only on the job designated.

MARK DATE DESCRIPTION


DRAWN
ZEH
DATE
SCALE

10/10/2025 AS NOTED

HEET TITLE

CODE DATA, GENERAL NOTES, AND OVERALL PLAN

SHEET NUMBER **G-101**SHEET ____2 OF _____25

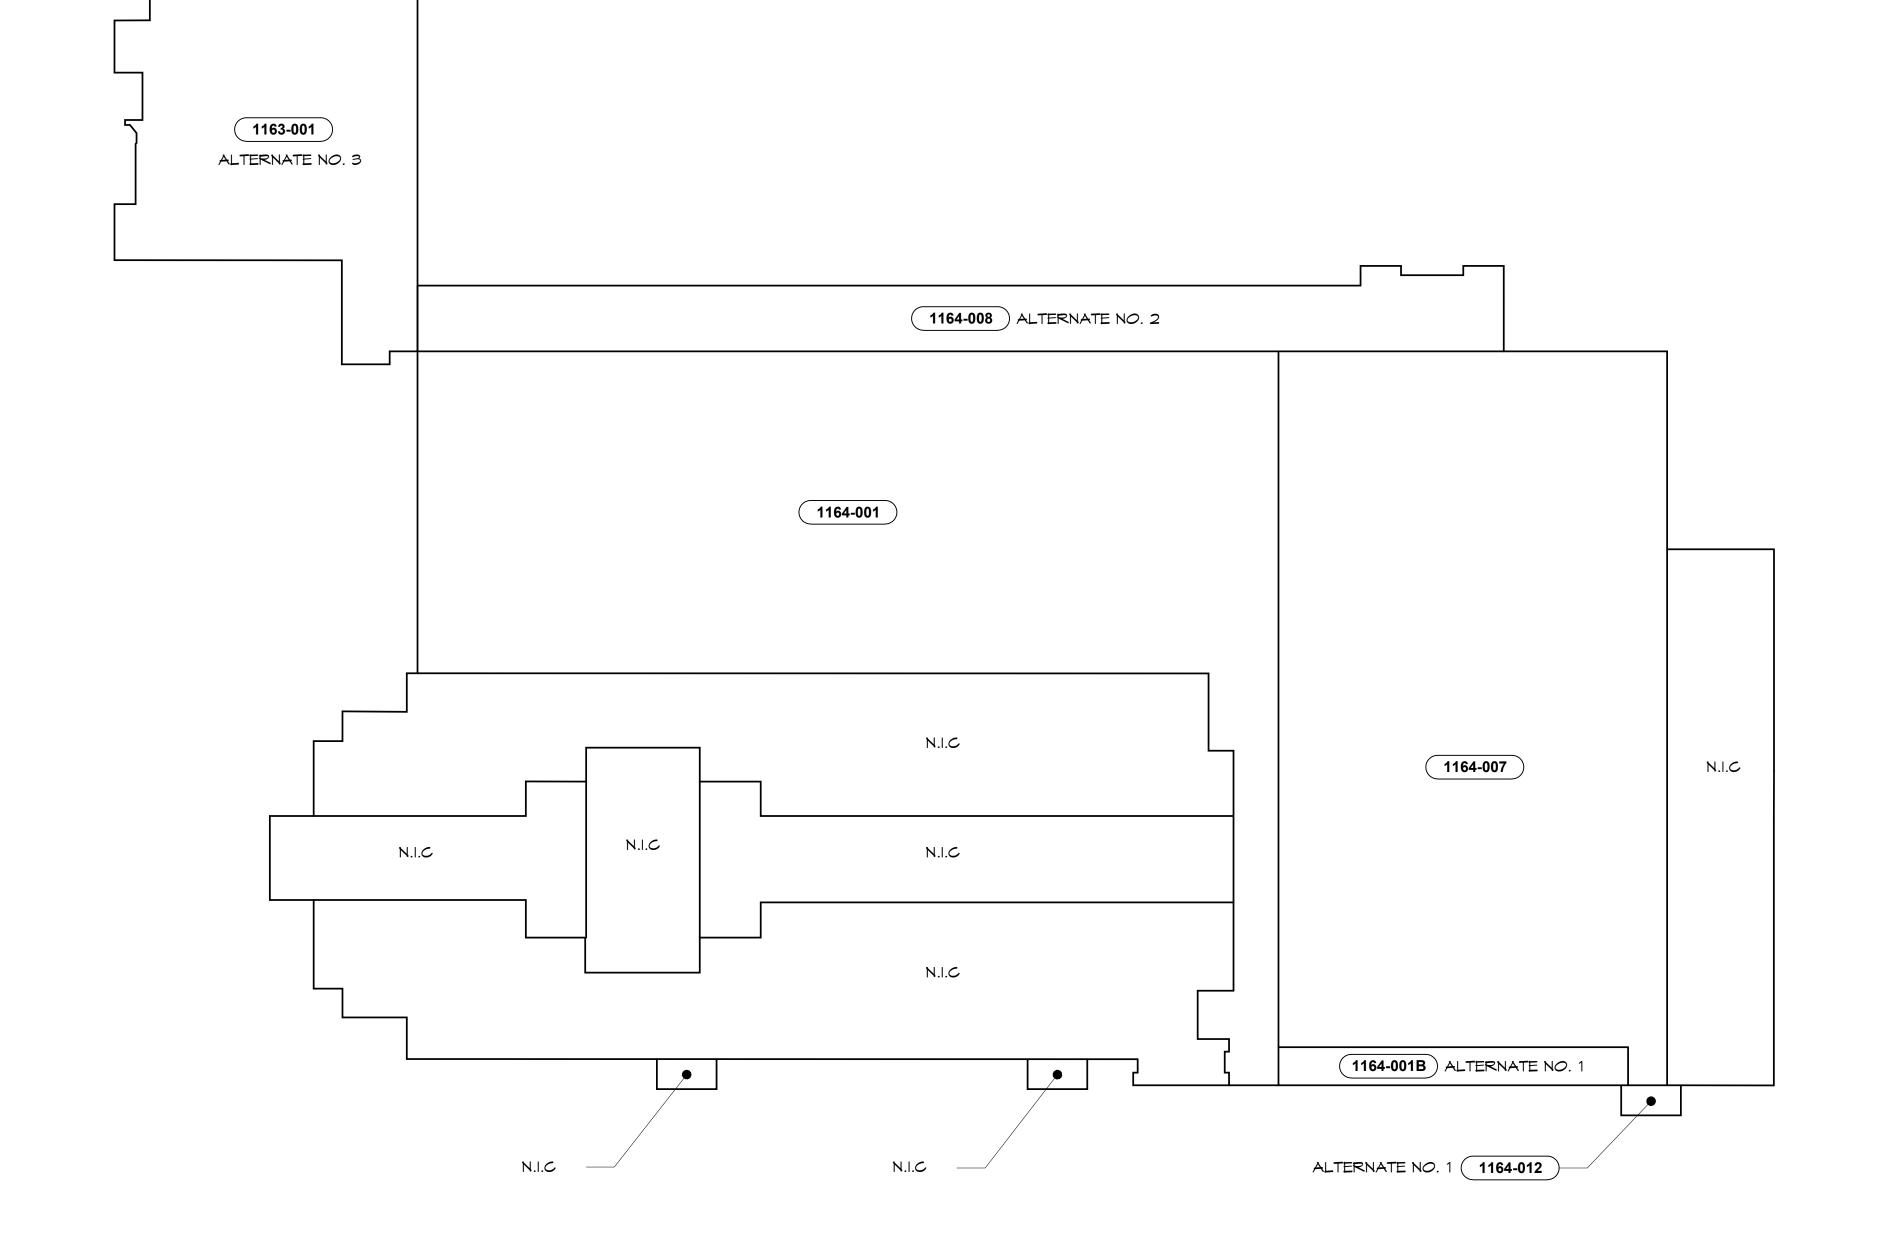

PROTECTION OF PEDESTRIANS HEIGHT OF TYPE OF PROTECTION DISTANCE OF CONSTRUCTION CONSTRUCTION TO LOT LINE OR WALKWAY REQUIRED BARRIER AND OVERHEAD LESS THAN 5 FEET PROTECTION 5 FEET OR MORE BUT NOT MORE THAN BARRIER AND OVERHEAD ONE-FOURTH THE HEIGHT OF CONSTRUCTION PROTECTION MORE THAN 5 FEET OR MORE, BUT BETWEEN ONE-FOURTH 8 FEET BARRIER AND ONE-HALF THE HEIGHT OF CONSTRUCTION 5 FEET OR MORE, BUT EXCEEDING NONE (FENCE)

PROVIDE OVERHEAD PROTECTION AT ENTRANCE/ EXIT COMPLYING WITH BONYS CHAPTER 33 SAFEGUARDS DURING CONSTRUCTION AND EBCNYS CHAPTER 15 CONSTRUCTION SAFEGUARDS.

ONE-HALF THE HEIGHT OF CONSTRUCTION


SCALE: 1/64" = 1'-0"


CONSTRUCTION SAFEGUARDS NOTES:

- 1. PEDESTRIANS AND EGRESS PATHWAYS SHALL REMAIN UNOBSTRUCTED AND PROTECTED DURING THE WORK. COMPLY WITH THE FOLLOWING MINIMUM REQUIREMENTS:
- 1.1. OSHA OCCUPATIONAL SAFETY AND HEALTH ADMINISTRATION.
- 1.2. 2020 BUILDING CODE OF NYS, CHAPTER 33 SAFEGUARDS DURING CONSTRUCTION 1.3. 2020 EXISTING BUILDING CODE OF NYS, CHAPTER 15 CONSTRUCTION SAFEGUARDS.
- 1.4. 2020 FIRE CODE OF NYS, CHAPTER 33 FIRE SAFETY DURING CONSTRUCTION AND DEMOLITION.
- 2. THE BUILDING WILL BE OCCUPIED DURING THE CONSTRUCTION PERIOD. PROVIDE OVERHEAD PROTECTION AT ALL INGRESS/ EGRESS DOORS (ENTRANCES, OVERHEAD DOORS AND EXIT DOORS) IN THE VICINITY OF THE WORK AREA AND MAINTAIN FOR THE DURATION OF THE WORK AS FOLLOWS:
- A. PROVIDE APPROPRIATE OVERHEAD SCAFFOLDING/BRIDGING FOR OCCUPANTS ENTERING AND EXITING THE BUILDING TO PROTECT FROM FALLING DEBRIS DURING THE MORK. SUCH SCAFFOLDING MAY ALSO DOUBLE FOR CONTRACTOR ACCESS TO THE WORK. STORAGE OF MATERIALS ON
- SCAFFOLDING SHALL ONLY BE PERMITTED IF THE SYSTEM IS DESIGNED AND ENGINEERED FOR MATERIAL STORAGE. B. CONSTRUCT SYSTEM IN ACCORDANCE WITH NYS UNIFORM FIRE PREVENTION AND BUILDING CODE
- AND OSHA REGULATIONS. C. WHERE SUBJECT TO IMPACT FROM VEHICLES OR EQUIPMENT, PROVIDE BARRIERS TO PROTECT THE
- SYSTEMS FROM IMPACT. D. POST TEMPORARY SIGNAGE ON THE PROTECTION COMPONENTS INDICATING ROOF CONSTRUCTION
- E. PROVIDE A MINIMUM 1 FOOTCANDLE (Fc) TEMPORARY CONSTRUCTION LIGHTING AT DOOR LOCATIONS BELOW OVERHEAD PROTECTION SCAFFOLDING.
- F. SUCH SYSTEMS SHALL BE PREPARED, DESIGNED AND STAMPED BY A NYS LICENSED PROFESSIONAL ENGINEER AND SUBMITTED FOR REVIEW AND APPROVAL. COORDINATE ALL WORK WITH THE OWNER. INCLUDE THE OVERHEAD PROTECTION SYSTEM AS PART OF THE SUBMITTED SAFETY PLAN. G. REPAIR/ RESTORE SYSTEM ANCHORAGE OR ATTACHMENT POINTS ON THE BUILDING.
- 3. PROVIDE TEMPORARY CONSTRUCTION BARRIERS AT OTHER AREAS AROUND THE WORK AREA TO PROTECT PEDESTRIANS IN ACCORDANCE WITH THE FOLLOWING:

SITE GENERAL NOTES:

- MATERIAL STAGING & LAYDOWN AREAS AND CRANE ACCESS LOCATIONS ARE INDICATED ON THE DRAWINGS. THE CONTRACTOR SHALL COORDINATE FINAL CRANE STAGING CONTRACTOR STAGING AREA, ACCESS, PARKING, DELIVERY & STORAGE WITH THE UNIVERSITY DESIGNATED REPRESENTATIVE PRIOR TO MOBILIZATION.
- PROVIDE A CRANE PICK PLAN SUBMITTAL FOR REVIEW FOR ALL CRANE OPERATIONS. INCLUDE CRANE LOADING INFORMATION, OPERATOR CERTIFICATIONS, LAYDOWN AND PICK SITE PLAN FOR ARCHITECT AND UNIVERSITY DESIGNATED REPRESENTATIVE PRIOR TO WORK. CONTRACTOR TO PROVIDE A FLAGMAN TO DIRECT TRAFFIC WHEN ACCEPTING MATERIAL DELIVERIES OR EQUIPMENT MOVEMENT TO PROVIDE SAFE PASSAGE TO CONSTRUCTION AREAS. TEMPORARY ROAD
- CLOSURES MUST BE COORDINATED IN ADVANCE. MAINTAIN ROAD ACCESS WIDTH IN ACCORDANCE WITH LOCAL AND STATE REGULATIONS BUT NOT LESS THAN 14'-O" WIDE.
- 2. CONTRACTOR SHALL BARRICADE, IN THE FORM OF A 6'-0" HIGH CHAIN LINK FENCE, THE PERIMETER OF ALL STAGING AREAS TO PREVENT PUBLIC ACCESS. THE BARRICADE SHALL HAVE A LOCKABLE 12'-0" WIDE DOUBLE GATE.
- PROVIDE TEMPORARY WAYFINDING AND CONSTRUCTION CAUTION SIGNAGE TO DIRECT PEDESTRIAN TRAFFIC AROUND BUILDING TO AVAILABLE ENTRANCES; SIGNAGE SIZE: 12"X 24", COROPLAST BOARD OR
- OTHER APPROVED MATERIAL, MOUNTED TO TEMPORARY CONSTRUCTION FENCE WITH HEAVY DUTY NYLON CABLE TIES THROUGH (4) EYELETS AT CORNERS PROVIDE INTERIOR SIGNAGE AND THROUGHOUT THE BUILDING DIRECTING PEDESTRIAN TRAFFIC AS NEEDED BASED ON TEMPORARY STAGING TO ALTERNATE EXIT LOCATIONS.
- PROVIDE RUBBER PARKING WHEEL BLOCKS AT ALL ADJACENT PARKING SPACES ABUTTING THE FENCING TO PROTECT FROM IMPACT. PROVIDE FENCE SCREENING MOUNTED ON THE INSIDE OF THE FENCE AROUND THE PERIMETER OF ALL STAGING AREAS AND TEMPORARY CONSTRUCTION FENCES. COLOR BLACK. VISIBILITY PERCENTAGE
- FENCE POSTS LOCATED IN GRASS AREAS MAY BE DRILLED. POSTS AND BASE OF FENCE ON IMPERVIOUS SURFACES TO BE BALLASTED WITH OUTRIGGERS ADEQUATELY DESIGNED TO WITHSTAND WIND LOADS 2.5. FROM OVERTURNING THE FENCE. CALL UFPO DIG SAFELY TO SURVEY AND MARK AREA FOR UTILITIES.
- SITE PLAN INFORMATION IS BASED ON RECORD INFORMATION PROVIDED. NOT ALL EXISTING UTILITIES, TREES, LANDSCAPING, SIDEWALKS, PAVEMENTS, EQUIPMENT, FIXTURES AND TOPOGRAPHIC INFORMATION MAY BE SHOWN. CONTRACTOR SHALL FIELD VERIFY AND FAMILIARIZE THEMSELVES WITH EXISTING CONDITIONS. REPAIR AND RESTORE ANY DAMAGE TO EXISTING CONSTRUCTION AND SITE WORK RESULTING FROM THE WORK OF THIS PROJECT INCLUDING BUT NOT LIMITED TO: GRASSED OR LANDSCAPED AREAS, CURBS, WALKWAYS, CATCH BASINS, PAVEMENT, ETC. CAUSED BY THE WORK OF THIS PROJECT. REPAIRS ARE TO MATCH ORIGINAL/ADJACENT SURFACES UNLESS NOTED OTHERWISE. CONTRACTOR TO TAKE PHOTOGRAPHS OF SITE PRIOR TO START OF WORK AND SUBMIT TO THE UNIVERSITY'S DESIGNATED
- EXTERIOR EGRESS PATHS, WALKWAYS, AND ENTRANCES SHALL REMAIN UNOBSTRUCTED AND PROTECTED. REFER TO CONSTRUCTION SAFEGUARD NOTES ON G-102. PROVIDE ALTERNATE CIRCULATION AS NEEDED TO ACCESS THE WORK.
- FIRE DEPARTMENT ACCESS AND FIRE DEPARTMENT CONNECTIONS TO REMAIN UNOBSTRUCTED DURING DURATION OF WORK.

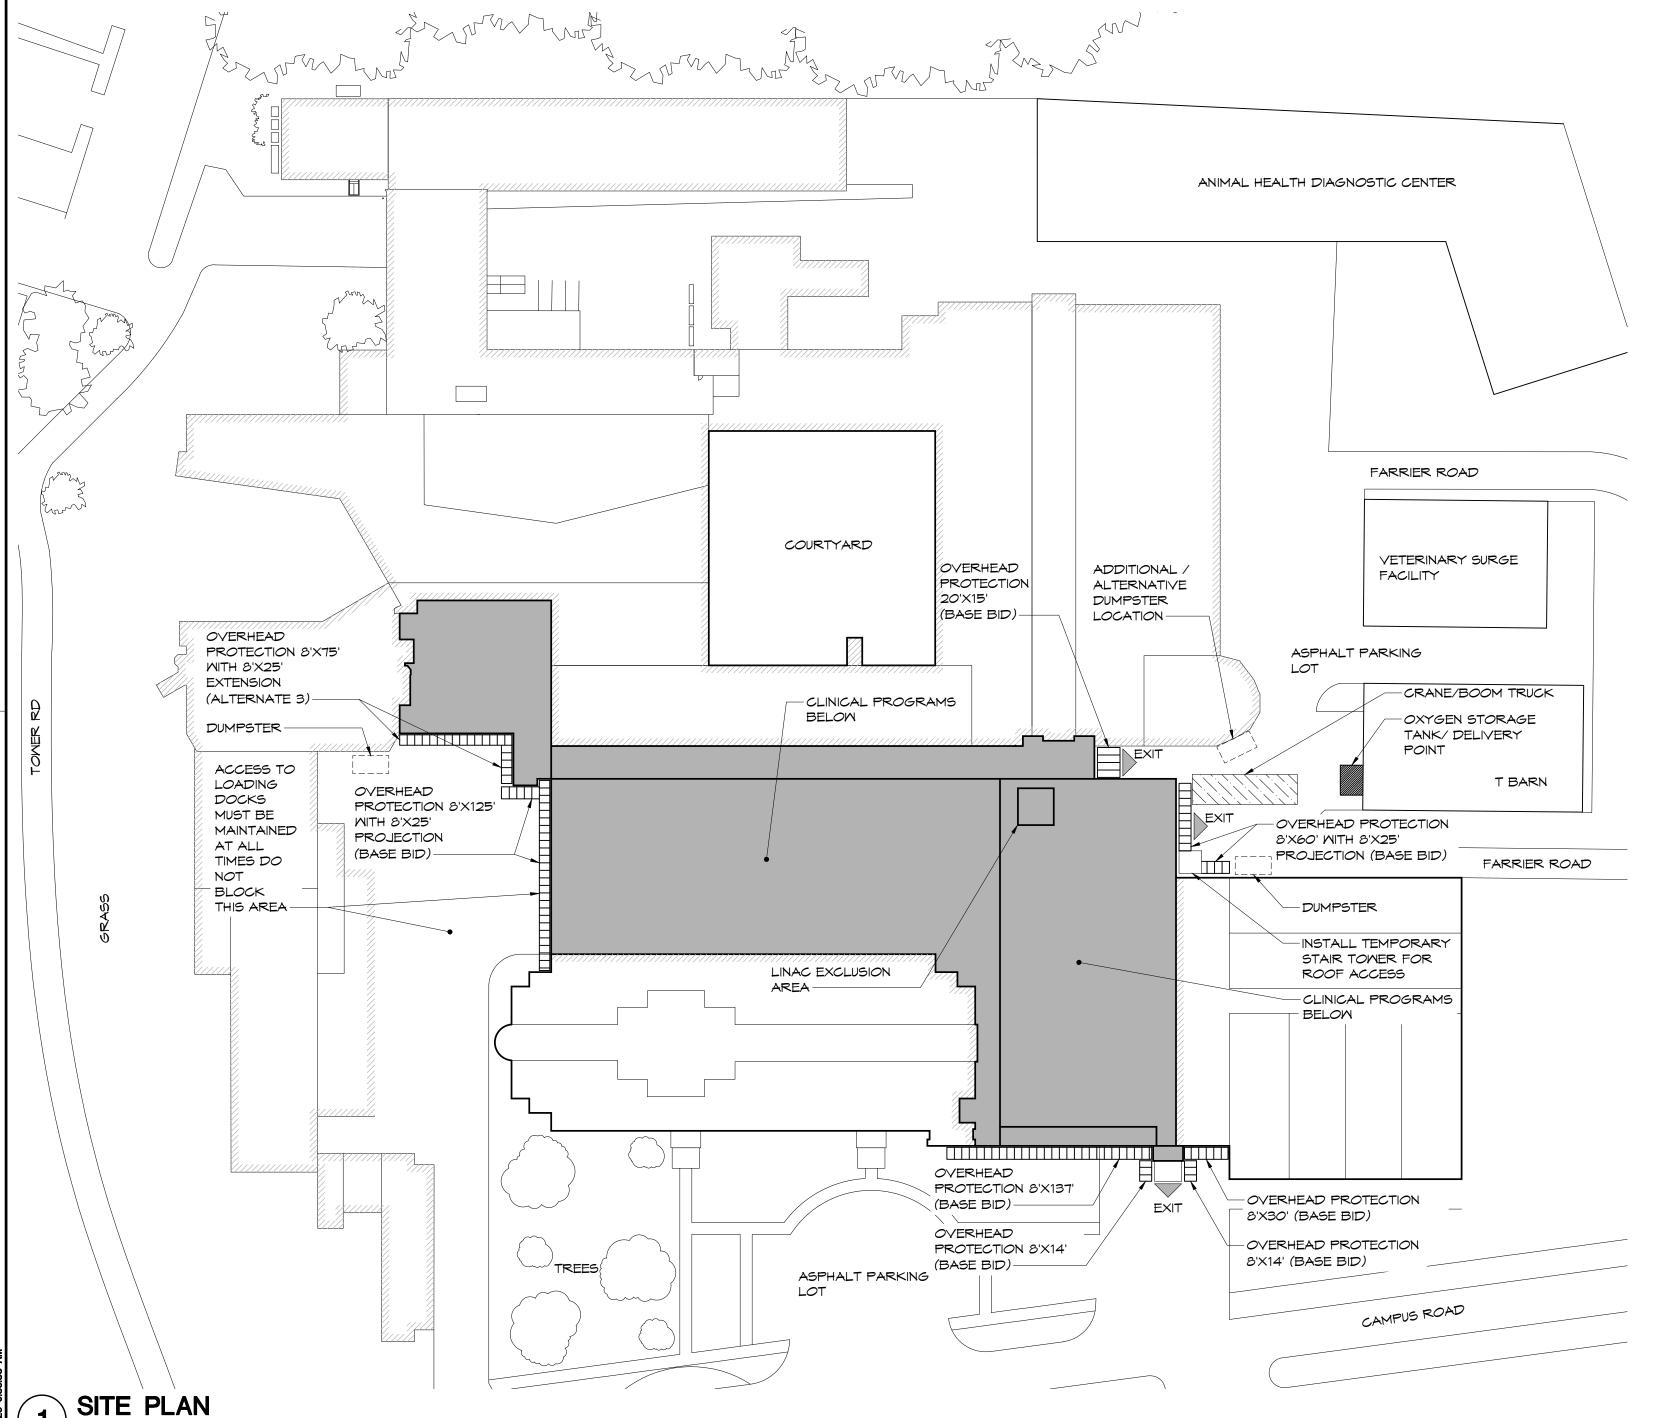

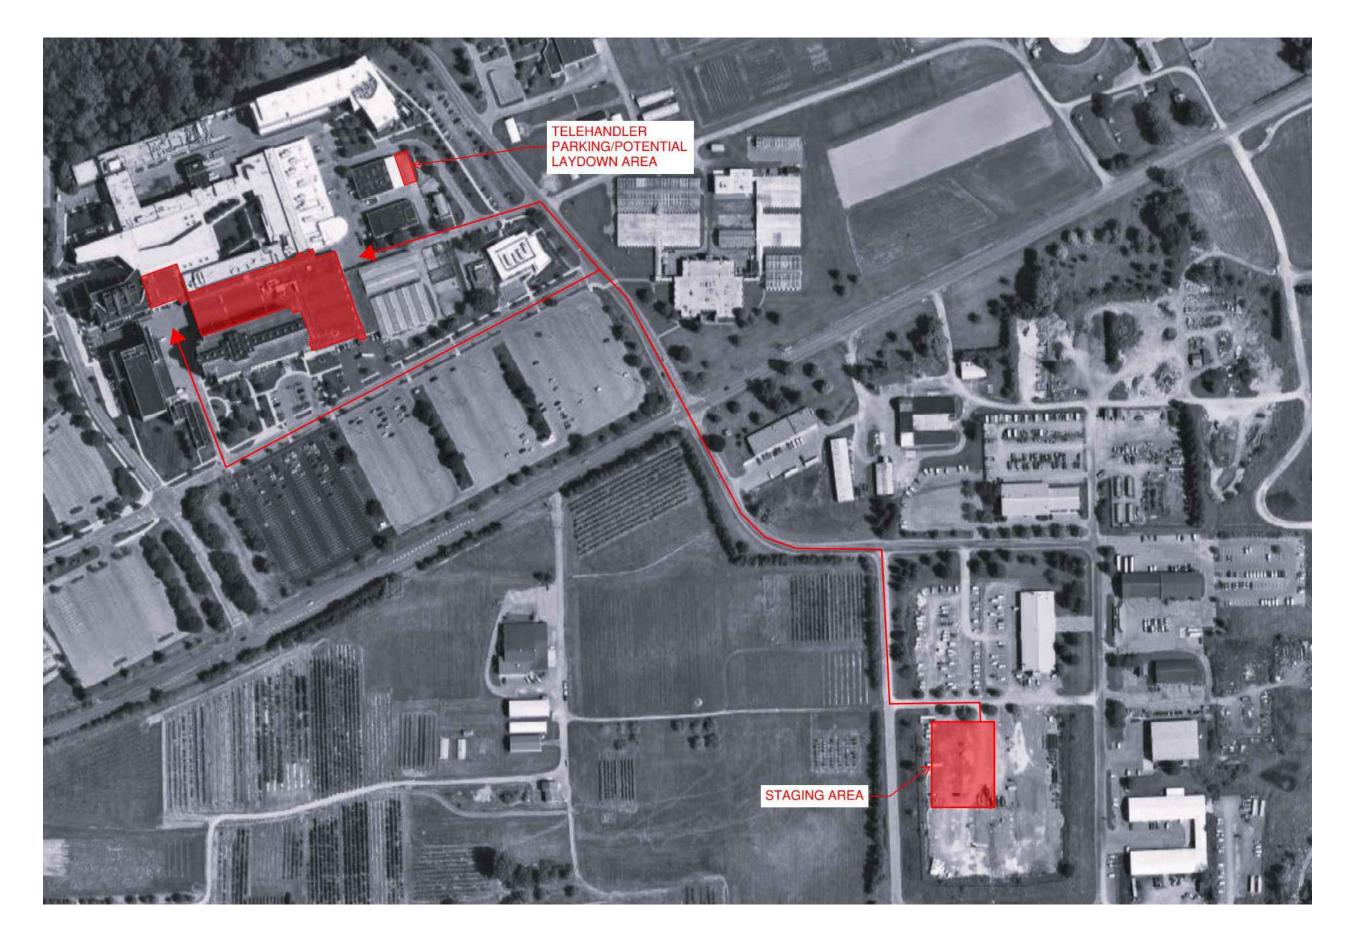

SITE PLAN LEGEND DESIGNATION AREA OF WORK OVERHEAD PROTECTION CONTRACTOR DUMPSTER

CRANE/BOOM TRUCK

LOCATION

GENERAL PHASING NOTES:

- 1. MASONRY WORK SHALL BE SUBSTANTIALLY COMPLETED PRIOR TO ROOFING WORK
- 2. ROOFING AND MASONRY WORK SHALL NOT PROCEED INTO WINTER MONTHS (NOVEMBER APRIL) MITHOUT PRIOR REVIEW AND APPROVAL FROM ARCHITECT, UNIVERSITY, AND ROOFING MANUFACTURER. PROVIDE ALL NIGHT TIME AND SEASONAL ROOF TERMINATIONS
- 3. WORK OVER CLINICAL PROGRAMS (1164-001, 1164-007) MUST BE SUBMITTED AND APPROVED BY THE UNIVERSITY'S DESIGNATED REPRESENTATIVE PRIOR TO COMMENCEMENT OF ANY CONSTRUCTION ACTIVITY OVER SPECIFIED AREAS
- 4. WORK IN LINAC EXCLUSION AREA MUST BE COORDINATED WITH THE UNIVERSITY'S DESIGNATED REPRESENTATVIVE BEFOREHAND FOR CONTRACTOR'S SAFETY/PROTECTION.




Fax (315) 487 - 5947 Fax (585) 487 - 9532 info@bellandspina.com www.bellandspina.com



It is a violation of the New York State any person unless he is acting under the direction of a licensed professional Architect, Engineer or Land Surveyor to alter an Item in any way. If an Item bearing the seal of an Architect, Engineer or Land Surveyor is altered, the alterir Architect, Engineer or Land Surveyor she affix to the item his seal and the notation "altered by" followed by his signature and the date of such alteration, and a specific description of the alteration.

PROJECT NORTH

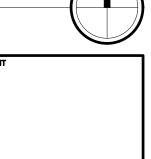

R

 α GENTE MEDICAL ERINARY

PROJECT NUMBER 319-24-032 he Contractor shall verify all dimension All drawings and specifications are the property of the Architect and shall be used only on the job designated.


ZEH DKA SCALE 10/10/2025 AS NOTE

MARK DATE DESCRIPTION

SHEET TITLE

SITE PLAN AND SAFEGUARD NOTES

SHEET NUMBER G-102 SHEET _____3 OF ____ 25

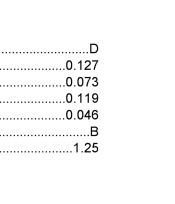



ULTIMATE WIND SPEED (3-SECOND GUST) (Vult):	117 mph
NOMINAL WIND SPEED (3-SECOND GUST) (Vasd):	
DIRECTIONAL FACTOR (kd):	0.85
TOPOGRAPHIC FACTOR (Kzt):	1
GUST EFFECT FACTOR (G):	0.85
HEIGHT OF MAIN ROOF:	

SEE S101 FOR ADDITIONAL WIND LOAD DATA FOR ROOFS, OVERHANGS, CANOPIES, AND


COMPONENTS AND CLADDING.

NET UPLIFT LOAD ON ROOF FRAMING COMPONENTS SHALL BE DETERMINED BY DEDUCTING 15 psf DEAD LOAD FROM THE TABULATED ROOF WIND LOADS FOR COMPONENTS AND CLADDING. NET UPLIFT VALUE SHALL BE A MINIMUM OF 10 psf.

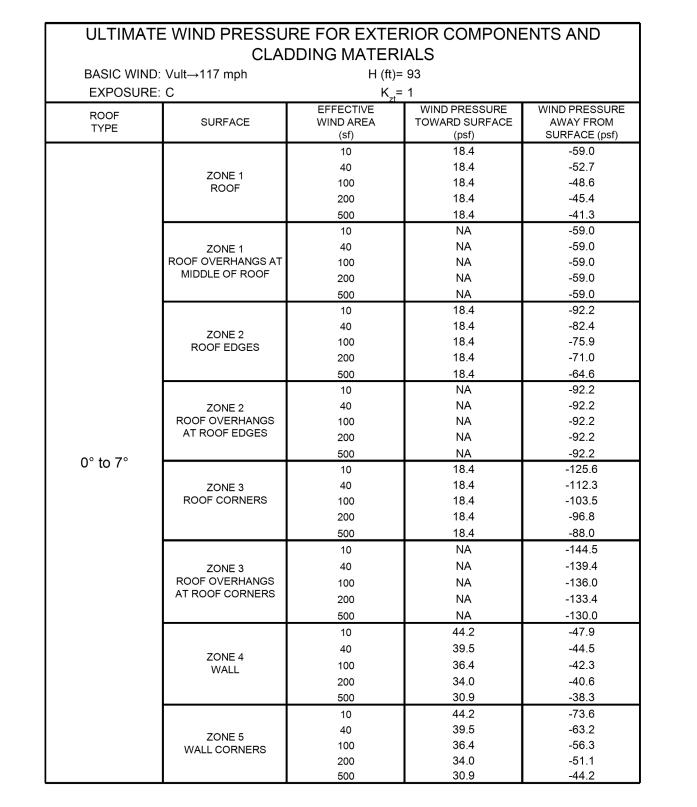

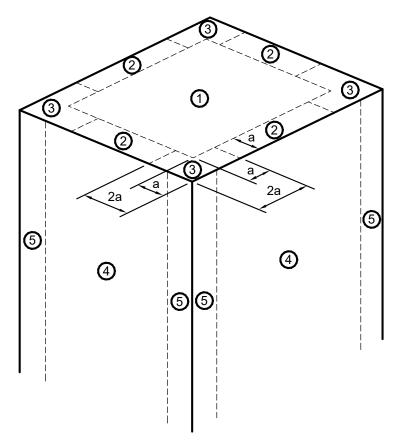


FLAT ROOF ($\Theta \le 7^\circ$; h $\le 60'$ -0")

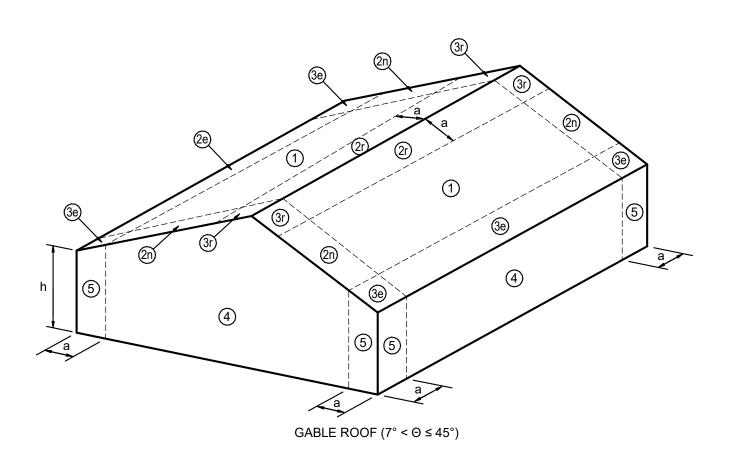

FLAT / HIP / GABLE/MANSARD ROOF ($\Theta \le 7^{\circ}$; h $\le 60'-0"$)

ROOF WIND PRESSURE ZONE DESIGNATIONS

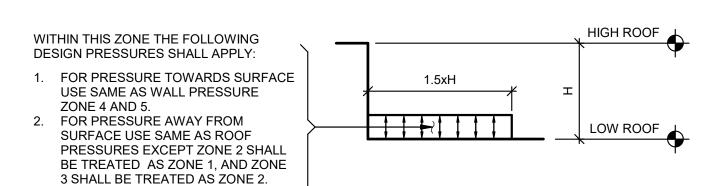

2 COMPONENTS AND CLADDING PRESSURES AT ROOF STEPS S-101 NOT TO SCALE

ULTIMAT	E WIND PRESSU			ENTS AND			
		MATERIALS GA					
BASIC WINE	D: 117 mph	H (ft)= 24					
EXPOSURE	E: C	K _{zt} =	1				
ROOF		EFFECTIVE					
TYPE	SURFACE	WIND AREA	TOWARD SURFACE	AWAY FROM			
111 -		(sf)	(psf)	SURFACE (psf)			
		10	19.9	-60.7			
	ZONE 1	20	17.9	-60.7			
	ROOF MIDDLE	50	16.0	-36.9			
		100	16.0	-18.9			
		10	NA	-69.6			
	ZONE 1	20	NA	-69.6			
	ROOF OVERHANGS AT		NA NA	-60.2			
	ROOF MIDDLE	50					
		100	NA 10.0	-53.0			
		10	19.9	-60.7			
	ZONE 2E	20	17.9	-60.7			
	LOWER ROOF EDGES	50	16.0	-36.9			
		100	16.0	-18.9			
	ZONE 2E	10	NA	-69.6			
	ROOF OVERHANGS	20	NA	-69.6			
	AT LOWER ROOF	50	NA	-60.2			
	EDGES	100	NA NA	-53.0			
		10	19.9	-88.5			
	ZONE ON		17.9	-76.6			
	ZONE 2N ROOF EAVE EDGES	20					
	NOO! LAVE EDGEG	50	16.0	-60.7			
		100	16.0	-48.7			
	ZONE 2N	10	NA	-97.4			
	ROOF OVERHANGS	20	NA	-84.8			
	AT ROOF EAVE EDGES	50	NA	-68.2			
		100	NA	-55.7			
		10	19.9	-88.5			
	ZONE 2R	20	17.9	-76.6			
	ROOF RIDGE	50	16.0	-60.7			
>7° TO 20°		100	16.0	-48.7			
7 10 20			NA	-97.4			
	ZONE 2R	10					
	ROOF OVERHANGS	20	NA	-84.8			
	AT ROOF RIDGE	50	NA	-68.2			
		100	NA	-55.7			
	ZONE 3E	10	19.9	-88.5			
	LOWER ROOF	20	17.9	-76.6			
	CORNERS	50	16.0	-60.7			
	ZONE 3E ROOF OVERHANGS AT LOWER ROOF CORNERS	100	16.0	-48.7			
		100	NA	-114.1			
			NA NA	-114.1 -98.5			
		20					
		50	NA	-78.0			
		100	NA 10.0	-62.4			
	ZONE 3R	10	19.9	-105.3			
	UPPER ROOF	20	17.9	-90.2			
	CORNERS	50	16.0	-70.3			
		100	16.0	-55.2			
	ZONE 3R	10	NA NA	-133.7			
	ROOF OVERHANGS	20	NA NA	-112.7			
	AT UPPER ROOF CORNERS	50	NA NA	-85.0			
	JOINVENO	100	NA 32.8	-64.0			
	70115 4	10	32.8	-35.6			
	ZONE 4 WALL	20	31.3	-34.1			
	VVALL	50	29.4	-32.2 30.7			
		100	27.9	-30.7			
	ZONE 5	10 20	32.8 31.3	-44.0 -41.1			
	WALL CORNERS	20 50	29.4	-41.1 -37.2			
	W. LE COMMENC	100	29.4 27.0	-37.2 24.1			

		ABI	BREVIATIONS LEGEN	D	
ADDL	- ADDITIONAL	EOD	- EDGE OF DECK	PAF	- POWER-ACTUATED
ADJ	- ADJACENT	EOS	- EDGE OF SLAB		FASTENER
L	- ANGLE	FD	- FLOOR DRAIN	PE	- PROFESSIONAL
APPROX	(- APPROXIMATE	FDN	- FOUNDATION		ENGINEER
ARCH	- ARCHITECT/	FTG	- FOOTING	PERP	- PERPENDICULAR
	ARCHITECTURAL	GA	- GAUGE	PLF	- POUNDS PER
B/	- BOTTOM OF	GALV	- GALVANIZED		LINEAL FOOT
BLDG	- BUILDING	HSS	- HOLLOW STEEL	PSF	- POUNDS PER
BRG	- BEARING		SECTION		SQUARE FOOT
BP	- BASE PLATE	HORIZ	- HORIZONTAL	PSI	- POUNDS PER
CANT	- CANTILEVER	Н	- HIGH		SQUARE INCH
CJ	- CONTROL,	HP	- HIGH POINT	PCF	- POUNDS PER
	CONTRACTION,	HVAC	- HEATING/	\dashv	CUBIC FOOT
	CONSTRUCTION		VENTILATING/	PC	- PRECAST
	JOINT		AIR CONDITIONING	PSL	- PARALLEL STRAND
С	- CENTERLINE	INFO	- INFORMATION		LUMBER
CMU	- CONCRETE	INT	- INTERIOR	PT	- PRESSURE TREATED
	MASONRY UNIT(S)	INV	- INVERT	R	- RADIUS
CONC	- CONCRETE	К	- KIPS	RD	- ROOF DRAIN
CONT	- CONTINUOUS	LG	- LONG	RDP	- REGISTERED DESIGN
COL	- COLUMN	LLH	- LONG LEG		PROFESSIONAL
CFMF	- COLD-FORMED	┪	HORIZONTAL	REQD	- REQUIRED
	METAL FRAMING	LLV	- LONG LEG	REINF	- REINFORCING OR
COORD	- COORDINATE	┪	VERTICAL		REINFORCED
Ø	- DIAMETER	LOC	- LOCATION	REV	- REVISION OR REVISED
DIM	- DIMENSION	LW	- LIGHT WEIGHT	RO	- ROUGH OPENING
DN	- DOWN	LVL	- LAMINATED VENEER	SIM	- SIMILAR
do	- DITTO	1	LUMBER	SPA	- SPACE
DWG	- DRAWING	LO	- LOW	STD	- STANDARD
EA	- EACH	MANUF	- MANUFACTURER	SF	- SQUARE FEET
EF	- EACH FACE	MAX	- MAXIMUM	ss	- STAINLESS STEEL
EJ	- EXPANSION JOINT	MECH	- MECHANICAL	SQ	- SQUARE
ELEC	- ELECTRICAL	MIN	- MINIMUM	T/	- TOP OF
EL	- ELEVATION	MISC	- MISCELLANEOUS	TIM	- THERMAL ISOLATION
ELEV	ELEVATOR	МО	- MASONRY OPENING		MATERIAL
ENGR	- ENGINEER	NA	- NOT APPLICABLE	TYP	- TYPICAL
EMBD	- EMBEDDED	NIC	- NOT IN CONTRACT	UNO	- UNLESS NOTED
EQ	- EQUAL	NOM	- NOMINAL	\exists	OTHERWISE
EQUIP	- EQUIPMENT	NW	- NORMAL WEIGHT	VERT	- VERTICAL
ES	- EACH SIDE	ос	- ON CENTER	VIF	- VERIFY IN FIELD
EW	- EACH WAY	OD	- OUTSIDE DIAMETER	W/	- WITH
EXIST	- EXISTING	OPNG	- OPENING	WP	- WORK POINT
EXP	- EXPANSION	OPP	- OPPOSITE	WWR	- WELDED WIRE
EXT	- EXTERIOR	PL	- PLATE	\dashv	REINFORCEMENT
		1		WCJ	- WALL CONTROL OR
		1			CONSTRUCTION JOINT



215 Wyoming Street 1163 Pittsford-Victor Rd Suite 201 Suite 200

Tel (315) 488 - 0377 Tel (585) 200 - 5038 **Fax (315) 487 - 5947** Fax (585) 487 - 9532 info@bellandspina.com www.bellandspina.com

Syracuse, NY 13204 Pittsford, NY 14534



It is a violation of the New York State Education Law, Article 145 Sec. 7209, for any person unless he is acting under the direction of a licensed professional Architection Engineer or Land Surveyor to alter an item in any way. If an item bearing the seal of an Architect, Engineer or Land Surveyor is altered, the altering Architect, Engineer or Land Surveyor shall affix to the item his sea and the notation "altered by" followed by his signature and the date of such alteration, and a specific description of the alteration.

NORTH



CENTE : CORNELL UNIVERSITY
F - VETERINARY MEDICAL (
ROAD 91026


PROJECT NUMBER 319-24-032 The Contractor shall verify all dimensions and notify the Architect in writing of any All drawings and specifications are the

property of the Architect and shall be used only on the job designated. MARK DATE DESCRIPTION

KMR DATE SCALE 10/10/2025 AS NOTED

DESIGN DATA AND GENERAL NOTES - Ph1

SHEET NUMBER S-101

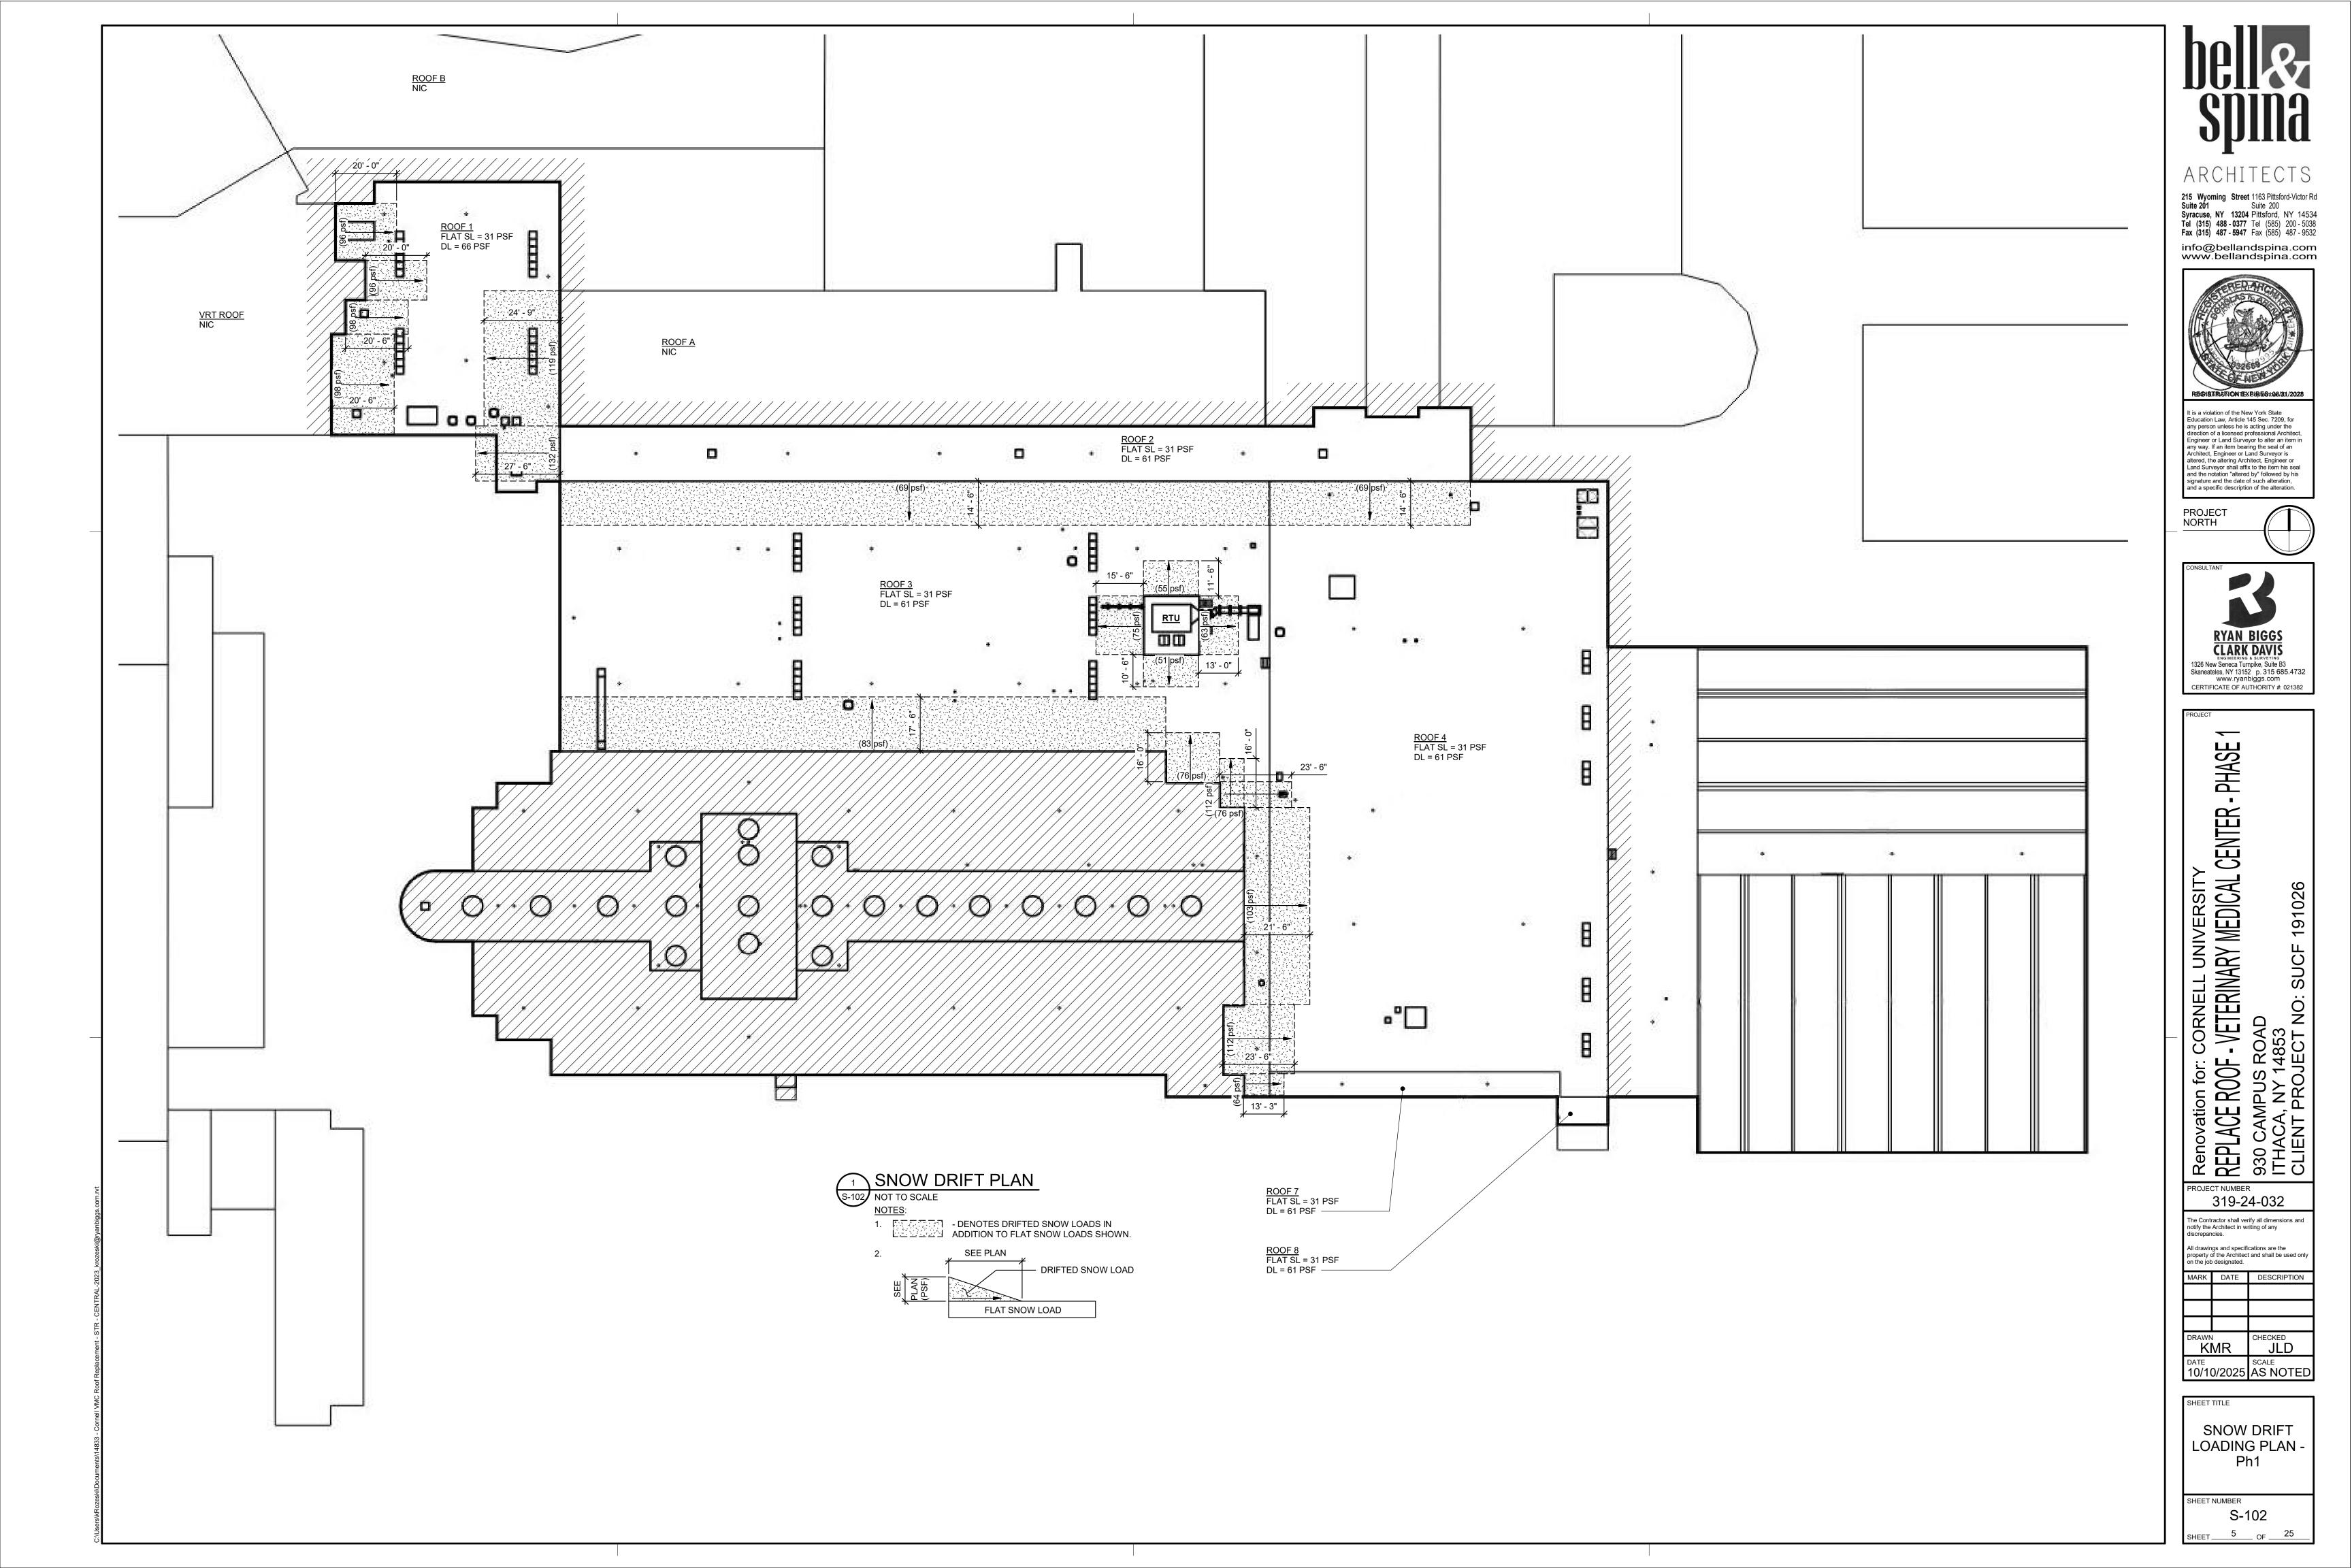

GENERAL ROOF NOTES:

- MORE STRINGENT ARCHITECTURAL DETAILS SHALL GOVERN OVER MANUFACTURER'S DETAILS
- 2. REMOVE EXISTING ROOF SYSTEM, IN ITS ENTIRETY, DOWN TO THE DECK, INCLUDING ALL GRAVEL BALLAST, METAL FLASHINGS, ROOF GRAVEL STOPS & WALL FLASHINGS UNLESS NOTED OTHERWISE. DECK TYPE AS NOTED ON PLANS. (SEE ROOF TEST CUTS FOR EXISTING ROOF SYSTEM INFORMATION.)
 - A. GRAYEL MUST BE REMOYED USING HAND CARTS TO REDUCE NOISE AND DISTURBANCE IN THE BUILDING DURING CONSTRUCTION. VACUUM TRUCKS ARE NOT PERMITTED
- DIMENSIONS GIVEN ARE FOR REFERENCE ONLY. FIELD VERIFYING THE EXISTING BUILDING EXTENT AND MEASUREMENTS IS SOLELY THE CONTRACTOR'S RESPONSIBILITY.
- 4. ALL ROOF PENETRATIONS ARE TO BE FLASHED, WHETHER SHOWN OR NOT; ITEMS ARE SHOWN IN THEIR GENERAL LOCATIONS.
- 5. MINIMUM FINISHED FLASHING HEIGHTS, TOP OF MEMBRANE TO:
 - -TOP OF NON-METALLIC FLASHINGS 8" -TOP OF PLUMBING VENT - 18"
 - -OR AS SHOWN ON DRAWINGS

TYPICAL ABBREVIATIONS:

ABOVE GRADE

ALUMINUM

ASPHALT

BLOCKING **CONTROL JOINT**

CONCRETE

CONSTRUCTION

CONTINUOUS DIAMETER DIMENSION

DIMENSIONS

EXHAUST FAN EXPANSION JOINT

EXPANSION JOINT

ETHYLENE PROPYLENE DIENE MONOMER

HEATING, VENTILATION, AND AIR CONDITIONING

ELECTRICAL

EXISTING

FINISH

FLOOR

GAUGE

GYPSUM **GRAVITY VENT**

HIGH POINT

HOT VENT

INCLUDING

INSULATION

MAXIMUM

MECHANICAL

MEMBRANE

MINIMUM

METAL

MANUFACTURER

MILES PER HOUR

NOT IN CONTRACT

PAINT OR PAINTED

PIPE PENETRATION

PRESSURE TREATED

POLYVINYL CHLORIDE

POWER ROOF EXHAUST

POUNDS PER SQUARE FOOT

POUNDS PER SQUARE INCH

NOT TO SCALE

ON CENTER

PLUMBING

PLYWOOD

ROOF CUT

ROOF DRAIN ROOF HATCH

REINFORCED

SIMILAR

TYPICAL

STEEL

ROOFTOP UNIT SQUARE FOOT SMOKE HATCH

STAINLESS-STEEL

PLUMBING VENT

VERIFY IN FIELD VAPOR RETARDER

STRUCTURE OR STRUCTURAL

KEYTONE ETHYLENE ESTER

LIGHTNING PENETRATION

GALVANIZED

DETAIL

DRAWING EACH

- 6. CONTRACTOR TO FIELD VERIFY ALL EXISTING CONDITIONS AND CONFIRM THAT DETAILS AS SHOWN WILL INTERFACE WITH THOSE
- 7. WATER DAMAGE NOTE:
 - THE CONTRACTOR IS RESPONSIBLE FOR KEEPING THE BUILDING DRY DURING ROOFING OPERATIONS, ANY WATER OR DEBRIS ENTERING THE BUILDING CAUSED BY REROOFING WORK SHALL BE CLEANED UP BY THE CONTRACTOR. ANY DAMAGE TO THE BUILDING OR ITS CONTENTS SHALL BE REPAIRED OR REPLACED BY THE CONTRACTOR AT NO COST TO THE OWNER. IF WORK AFFECTS THE INTERIOR OF THE BUILDING, PRECAUTIONS SHALL BE TAKEN TO PROTECT THE BUILDING AND IT'S CONTENTS. FOR EXAMPLE: PROTECTION OF A GYM FLOOR.
- PROVIDE TRAFFIC / WALKWAY PADS AT ALL ROOF ACCESS POINTS, TOP & BOTTOM OF ALL LADDERS, AROUND ALL POWERED ROOFTOP EQUIPMENT, AT ACCESS POINTS TO LARGE HVAC ROOFTOP UNITS, AT MECHANICAL ROOM DOORS AND WHERE SHOWN.
- ABANDONED PENETRATIONS LESS THAN 12" IN EACH DIMENSION IN METAL ROOF DECKS TO BE COVERED W/ 20 GA. GALV. STEEL SHEET METAL MIN. 4" LARGER THAN OPENING IN ALL DIRECTIONS - FASTEN W/ #14 TEK SCREWS @ 6" O.C. MAX. AROUND PERIMETER OF NEW SHEET METAL. SEE "TYPICAL DECK PATCH DETAIL" FOR LARGER ABANDONED PENETRATIONS.
- 10. AT ALL ROOFTOP EQUIPMENT NEW & EXISTING (A/C UNITS, RTU'S, ETC.) THE WIRES, PIPES AND / OR CONDUIT SHALL BE INSTALLED IN A PRE-FABRICATED PIPE / CONDUIT CURB AS DETAILED / SPECIFIED. WHETHER SHOWN OR NOT. PITCH POCKETS ARE NOT ACCEPTABLE, UNLESS SHOWN OTHERWISE. REFER TO NOTE 11, E.
- 11. MECHANICAL

A.G.

ALUM.

ASPH.

BLKG.

CONC. CONST.

CONT.

DET.

DWG.

ELEC.

EPDM

EXJT.

FIN.

FLR.

GA.

GALV.

GYP.

GV.

HV

HVAC

INC.

KEE

MANUF.

MECH.

MEMB.

MIN

MPH

MTL.

N.I.C.

O.C.

PLUMB.

PLYD.

PNT.

PP

PRE

P.S.F.

P.S.I.

PVC

REINF

RTU

SIM

S.S.

STL.

TYP.

V.I.F.

STRUCT.

PΤ

RC

N.T.S.

MAX.

LP

INSUL

EX. OR EXIST.

EA.

- A. REMOVE AND REINSTALL EXISTING MECHANICAL EQUIPMENT AS REQUIRED FOR INSTALLATION OF NEW ROOF SYSTEM & TO ACHIEVE SPECIFIED CLEARANCES, ie; RAISE AND / OR FLASH PER DETAILS, IF REQUIRED.
- B. DISCONNECT ANY POWER OR PNEUMATIC CONNECTIONS, RECONNECT THE SAME USING ADDITIONAL MATERIAL AS NECESSARY TO REINSTALL. PRIOR TO ROOF REPLACEMENT WORK, THE OWNER'S REPRESENTATIVE SHALL INSPECT ALL UNITS W/ CONTRACTOR AND IDENTIFY ANY NON-OPERATING UNITS.

- C. COORDINATE ALL TEMPORARY ELECTRIC, GAS OR MECHANICAL UNIT ETC. SHUTDOWNS WITH THE UNIVERSITY'S DESIGNATED REPRESENTATIVE.
- D. PAINT NON-ALUMINUM/COPPER UNITS AND STEEL SUPPORT STRUCTURES. PAINT WITH PRIME AND 2 FINISH COATS OF ENAMEL PAINT. IDENTIFY UNITS (STENCIL) PER THE UNIVERSITY'S IDENTIFICATION SCHEDULE.
- E. REPLACE ANY EXTERIOR GAS, REFRIGERANT CONDUIT, CONTROL WIRING, ETC. AS REQUIRED TO ELIMINATE PITCH POCKETS. SERVICES TO BE INSTALLED IN PRE-FABRICATED PIPE/CONDUIT CURBS AS DETAILED / SPECIFIED.

12. ELECTRICAL

- A. REMOVE AND REPLACE EXISTING LIGHTNING PROTECTION SYSTEM, SEE DETAIL 6/A-509 AND E-SERIES DRAWINGS.
- B. MOUNT LIGHTNING PROTECTION CONDUCTORS TO BACK OF PARAPET AND OFF ROOF MEMBRANE. PER DETAIL 5/A-506 -CONTRACTORS TO COORDINATE INSTALLATION.
- C. DISCONNECT ANY POWER CONNECTIONS, RECONNECT THE SAME USING ADDITIONAL MATERIAL AS NECESSARY TO REINSTALL. PRIOR TO ROOF REPLACEMENT WORK.

REPLACED PER SPEC 01 12 00.

- A. PROVIDE CRICKETS AT HIGH SIDE OF ALL ROOFTOP EQUIPMENT LARGER THAN 2'-O" WIDE OR AT ANY DOWNHILL WALL PROJECTION WHICH MAY POCKET WATER.
- B. FILL GAPS BETWEEN CUT INSULATION AND CURBS/WALLS/EDGE BLOCKING GREATER THAN $rac{1}{4}$ " WITH SPRAY FOAM INSULATION. 14. ROOF DRAINS
 - A. UNLESS NOTED ALL ROOF DRAINS TO REMAIN. CLEAN ALL DRAIN BOMLS. THE STRAINERS AND CLAMPING RINGS ARE TO BE
- B. AT COMPLETION OF ROOFING OPERATIONS CLEAN ALL ROOF DRAINS FROM ROOF TO FIRST ELBOW.
- C. CONTRACTOR SHALL AT THEIR OWN COST BE RESPONSIBLE FOR TESTING ROOF DRAINS AT THEIR EXPENSE FOR LEAKS AND FLOW UPON COMPLETION OF CONSTRUCTION. LEAK TEST: PLUG EACH ROOF DRAIN BELOW CONNECTION TO THE ROOF DRAIN LEADER. OBSERVE THE FLOW OF EACH LINE. PROVIDE A WRITTEN REPORT OF THE RESULTS TO THE ONSITE REPRESENTATIVE OR ARCHITECT.

15. MOOD

- A. ALL WOOD OR PLYWOOD INSTALLED IN DIRECT CONTACT WITH MASONRY OR CONCRETE. IS TO BE OF PRESSURE TREATED MATERIALS. ALL OTHER LUMBER TO BE NON-TREATED UNLESS NOTED OTHERWISE.
- B. ALL BLOCKING TO BE SOLID NO VOIDS OR 'SKIP-FRAMING' ARE PERMITTED. IF MOOD DIMENSIONS ARE NOT GIVEN, STACKED WOOD HEIGHT (3 BOARDS OR LESS) SHALL BE 2x6 MINIMUM.
- C. ALL WOOD TO BE ANCHORED AS SPECIFIED, OR SHOWN. GENERALLY, FASTENER SPACING, NAILS OR SCREWS, NOT MORE THAN 12" O.C. AND ANCHOR BOLTS -3/6" O.D. MIN., NOT MORE THAN 36" O.C. AND FROM ENDS OF BOARDS - 9" MAXIMUM. SEE "TYPICAL BLOCKING FASTENING DETAIL" 7/A-506 FOR ADDITIONAL INFORMATION.

D. BLOCKING CONSIDERED FOR REUSE SHALL BE CHECKED FOR ADEQUATE ANCHORAGE VIA PULL TEST AT CONTRACTOR'S EXPENSE. PROVIDE ADDITIONAL FASTENERS, IF REQUIRED TO ASSURE SOLID ANCHORING. INSTALL ADDITIONAL BLOCKING OVER THE EXISTING AS REQUIRED TO BRING HEIGHT INTO THE SAME PLANE WITH INSULATION HEIGHT. REFER TO NOTE 5 IN DESIGN WIND UPLIFT NOTES ON G-101 FOR PERFORMANCE REQUIREMENTS.

16. FASTENERS

- A. ALL FASTENERS TO BE NON-RUSTING TYPE (HOT DIPPED GALVANIZED, STAINLESS STEEL, CADMIUM PLATED) UNLESS NOTED OTHERWISE.
- B. ALL NAILS SHALL BE SPIRAL OR RING-SHANKED
- C. ALL FASTENERS (NAILS, SCREMS, BOLTS, ETC.) FASTENING OR PENETRATING PRESSURE-TREATED MOOD ARE TO BE OF AUSTENITIC STAINLESS STEEL, TYPE A304 OR A316
- D. FASTENERS IN METAL FLASHINGS ALL TO BE COMPATIBLE WITH METAL USED: FASTENERS ALL OF STAINLESS-STEEL UNLESS NOTED OTHERWISE. FASTENER SPACING, SCREMS, NOT MORE THAN 9" O.C., NAILS USED FOR CLEATING - 3" O.C. UNLESS NOTED OTHERWISE FROM ENDS OF UNITS - 3" MAXIMUM.
- E. POP-RIVETS IN METAL FLASHINGS/COPINGS ARE NOT PERMITTED.


17. MISCELLANEOUS;

- A. ANY METAL COPING OR FASCIA OVERLAPS, FOLDS, OR SEAMS ARE TO BE SOLIDLY BEDDED WITH SEALANT BETWEEN PIECES OF METAL.
- B. ALL FLASHINGS, COPINGS OR ROOF EDGES ETC. SHALL HAVE MANUFACTURERS PREFABRICATED CORNERS. NO CAULKED OR RIVITED CORNERS WILL BE ALLOWED.
- C. THE INTENT IS FOR METAL FLASHING HEIGHTS TO ALIGN, UNLESS NOTED OTHERWISE.
- D. PROVIDE MEMBRANE SLIP SHEETS UNDER ALL BALLASTED GUARDRAIL SYSTEM POINTS OF CONTACT AND WALKWAY PADS (NOT MANUFACTURED/PROVIDED BY THE MEMBRANE MANUFACTURER)
- E. TURN OVER TO UNIVERSITY AT COMPLETION OF PROJECT 2 GALLONS OF TOUCH UP PAINT FOR ROOF GUARD RAILS AND MATCHING TRIM/FASCIA METAL
- F. CONTRACTOR SHALL INCLUDE 1000 SF OF APPLIED FIRE PROTECTION, PER SPECIFICATION 078100 TO REPAIR ANY AREAS DISTURBED BY THE WORK OF THIS CONTRACT. CONTRACTOR IS RESPONSIBLE FOR REPAIRING AREAS DISTURBED WITH PROVIDED FIRE PROTECTION

Svracuse. NY 13204 Pittsford, NY 14534


Tel (315) 488 - 0377 Tel (585) 200 - 5038

Fax (315) 487 - 5947 Fax (585) 487 - 9532 info@bellandspina.com www.bellandspina.com

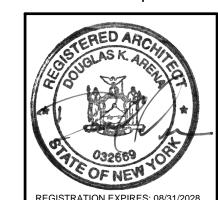

It is a violation of the New York State Educati Law, Article 145 Sec. 7209, for any personal unless he is acting under the direction of icensed professional Architect, Engineer Land Surveyor to alter an item in any way. If em bearing the seal of an Architect, Engine or Land Surveyor is altered, the alter to the item his seal and the notation "altered ollowed by his signature and the date of su alteration, and a specific description of t

PROJECT NORTH

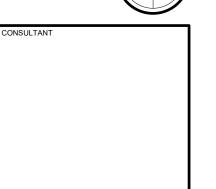

PHA CENTE MEDICAL

-L UNIVERSITY -ROOF - VETERINARY I

CORNELL REPLACE

PROJECT NUMBER 319-24-032 The Contractor shall verify all dimensions and

notify the Architect in writing of ar

property of the Architect and shall be use only on the job designated. MARK DATE DESCRIPTION


ZEH DKA SCALE 10/10/2025 AS NOTED

SHEET TITLE

GENERAL ROOFING NOTES AND ABBREVIATIONS

SHEET NUMBER

A-101 SHEET 6

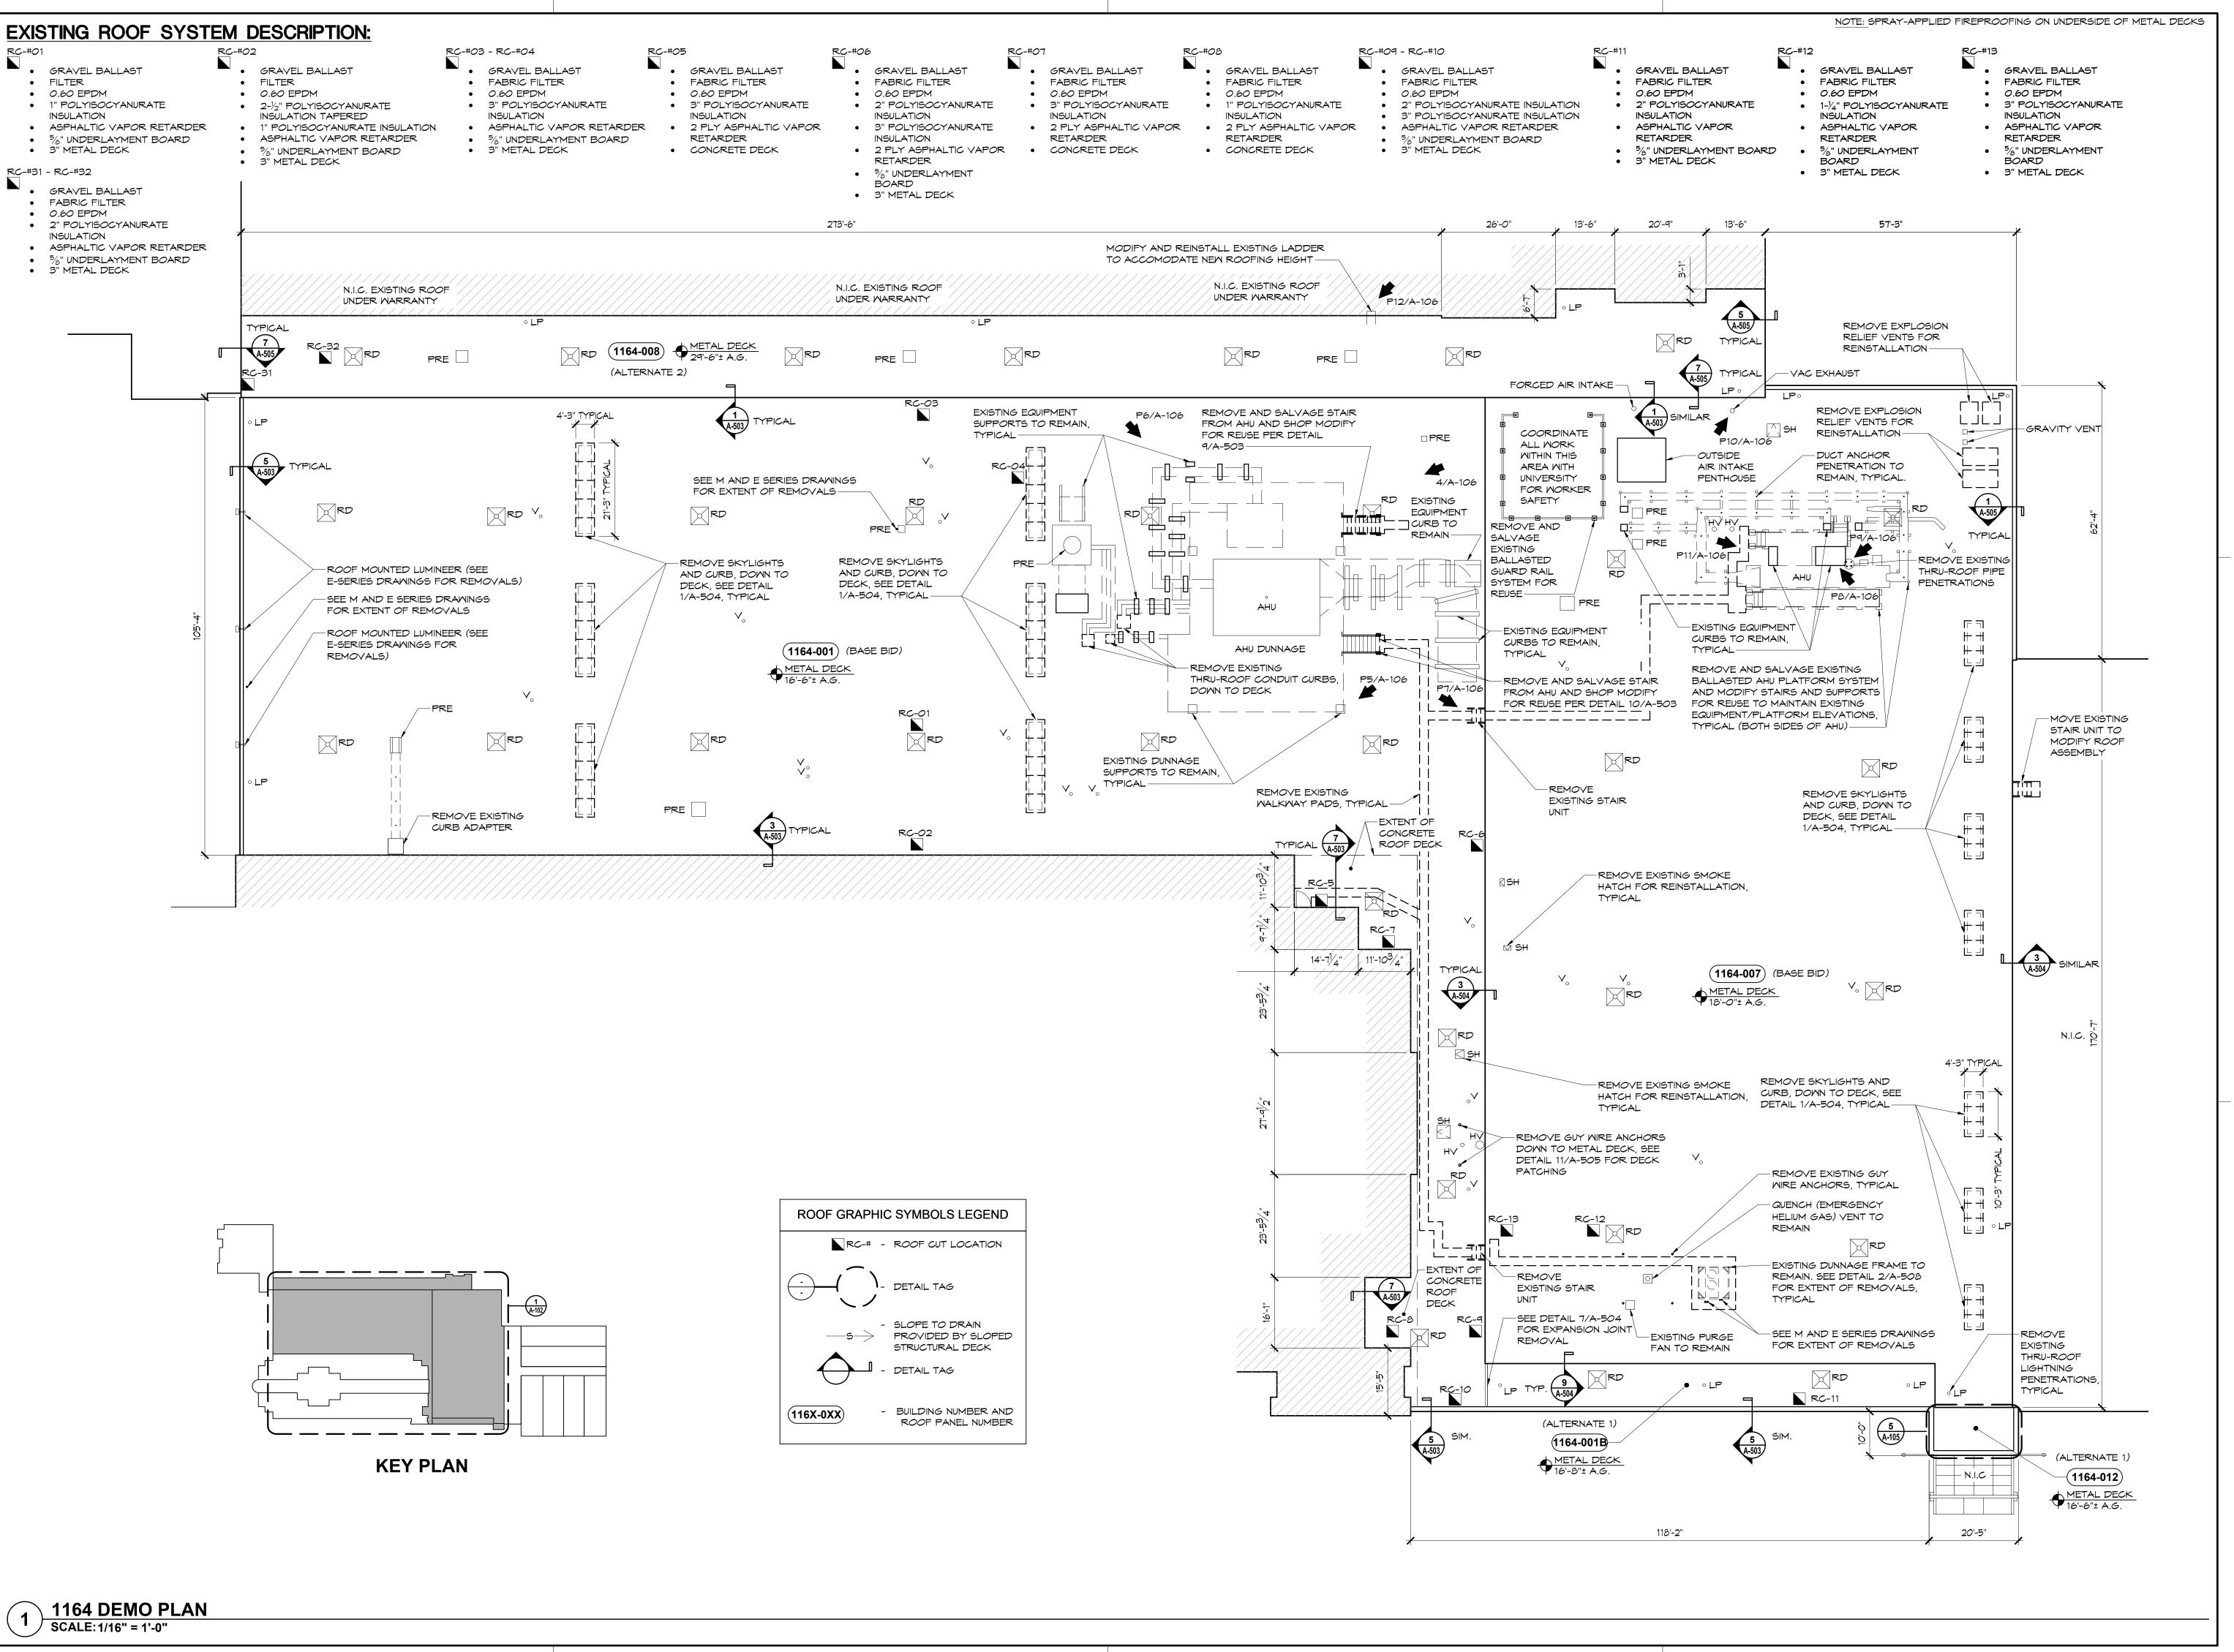


215 Wyoming Street 1163 Pittsford-Victor Rd Svracuse. NY 13204 Pittsford, NY 14534 Tel (315) 488 - 0377 Tel (585) 200 - 5038 Fax (315) 487 - 5947 Fax (585) 487 - 9532 info@bellandspina.com www.bellandspina.com



REGISTRATION EXPIRES: 08/31/2028 It is a violation of the New York State Education Law, Article 145 Sec. 7209, for any person unless he is acting under the direction of a licensed professional Architect, Engineer Land Surveyor to alter an item in any way. If item bearing the seal of an Architect, Engine or Land Surveyor is altered, the alteri Architect, Engineer or Land Surveyor shall aff to the item his seal and the notation "altered by alteration, and a specific description of t

PROJECT NORTH

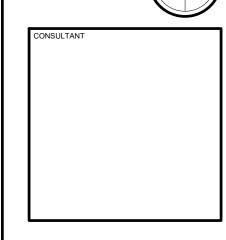

PHASE CENTE IVERSITY F.VETERINARY MEDICAL (

COR RPL


PROJECT NUMBER 319-24-032 The Contractor shall verify all dimensions and notify the Architect in writing of ar All drawings and specifications are t property of the Architect and shall be use only on the job designated. MARK DATE DESCRIPTION

DKA ZEH 10/10/2025 AS NOTED

SHEET TITLE ROOF DEMOLITION **PLAN**

SHEET NUMBER

A-102 SHEET ___

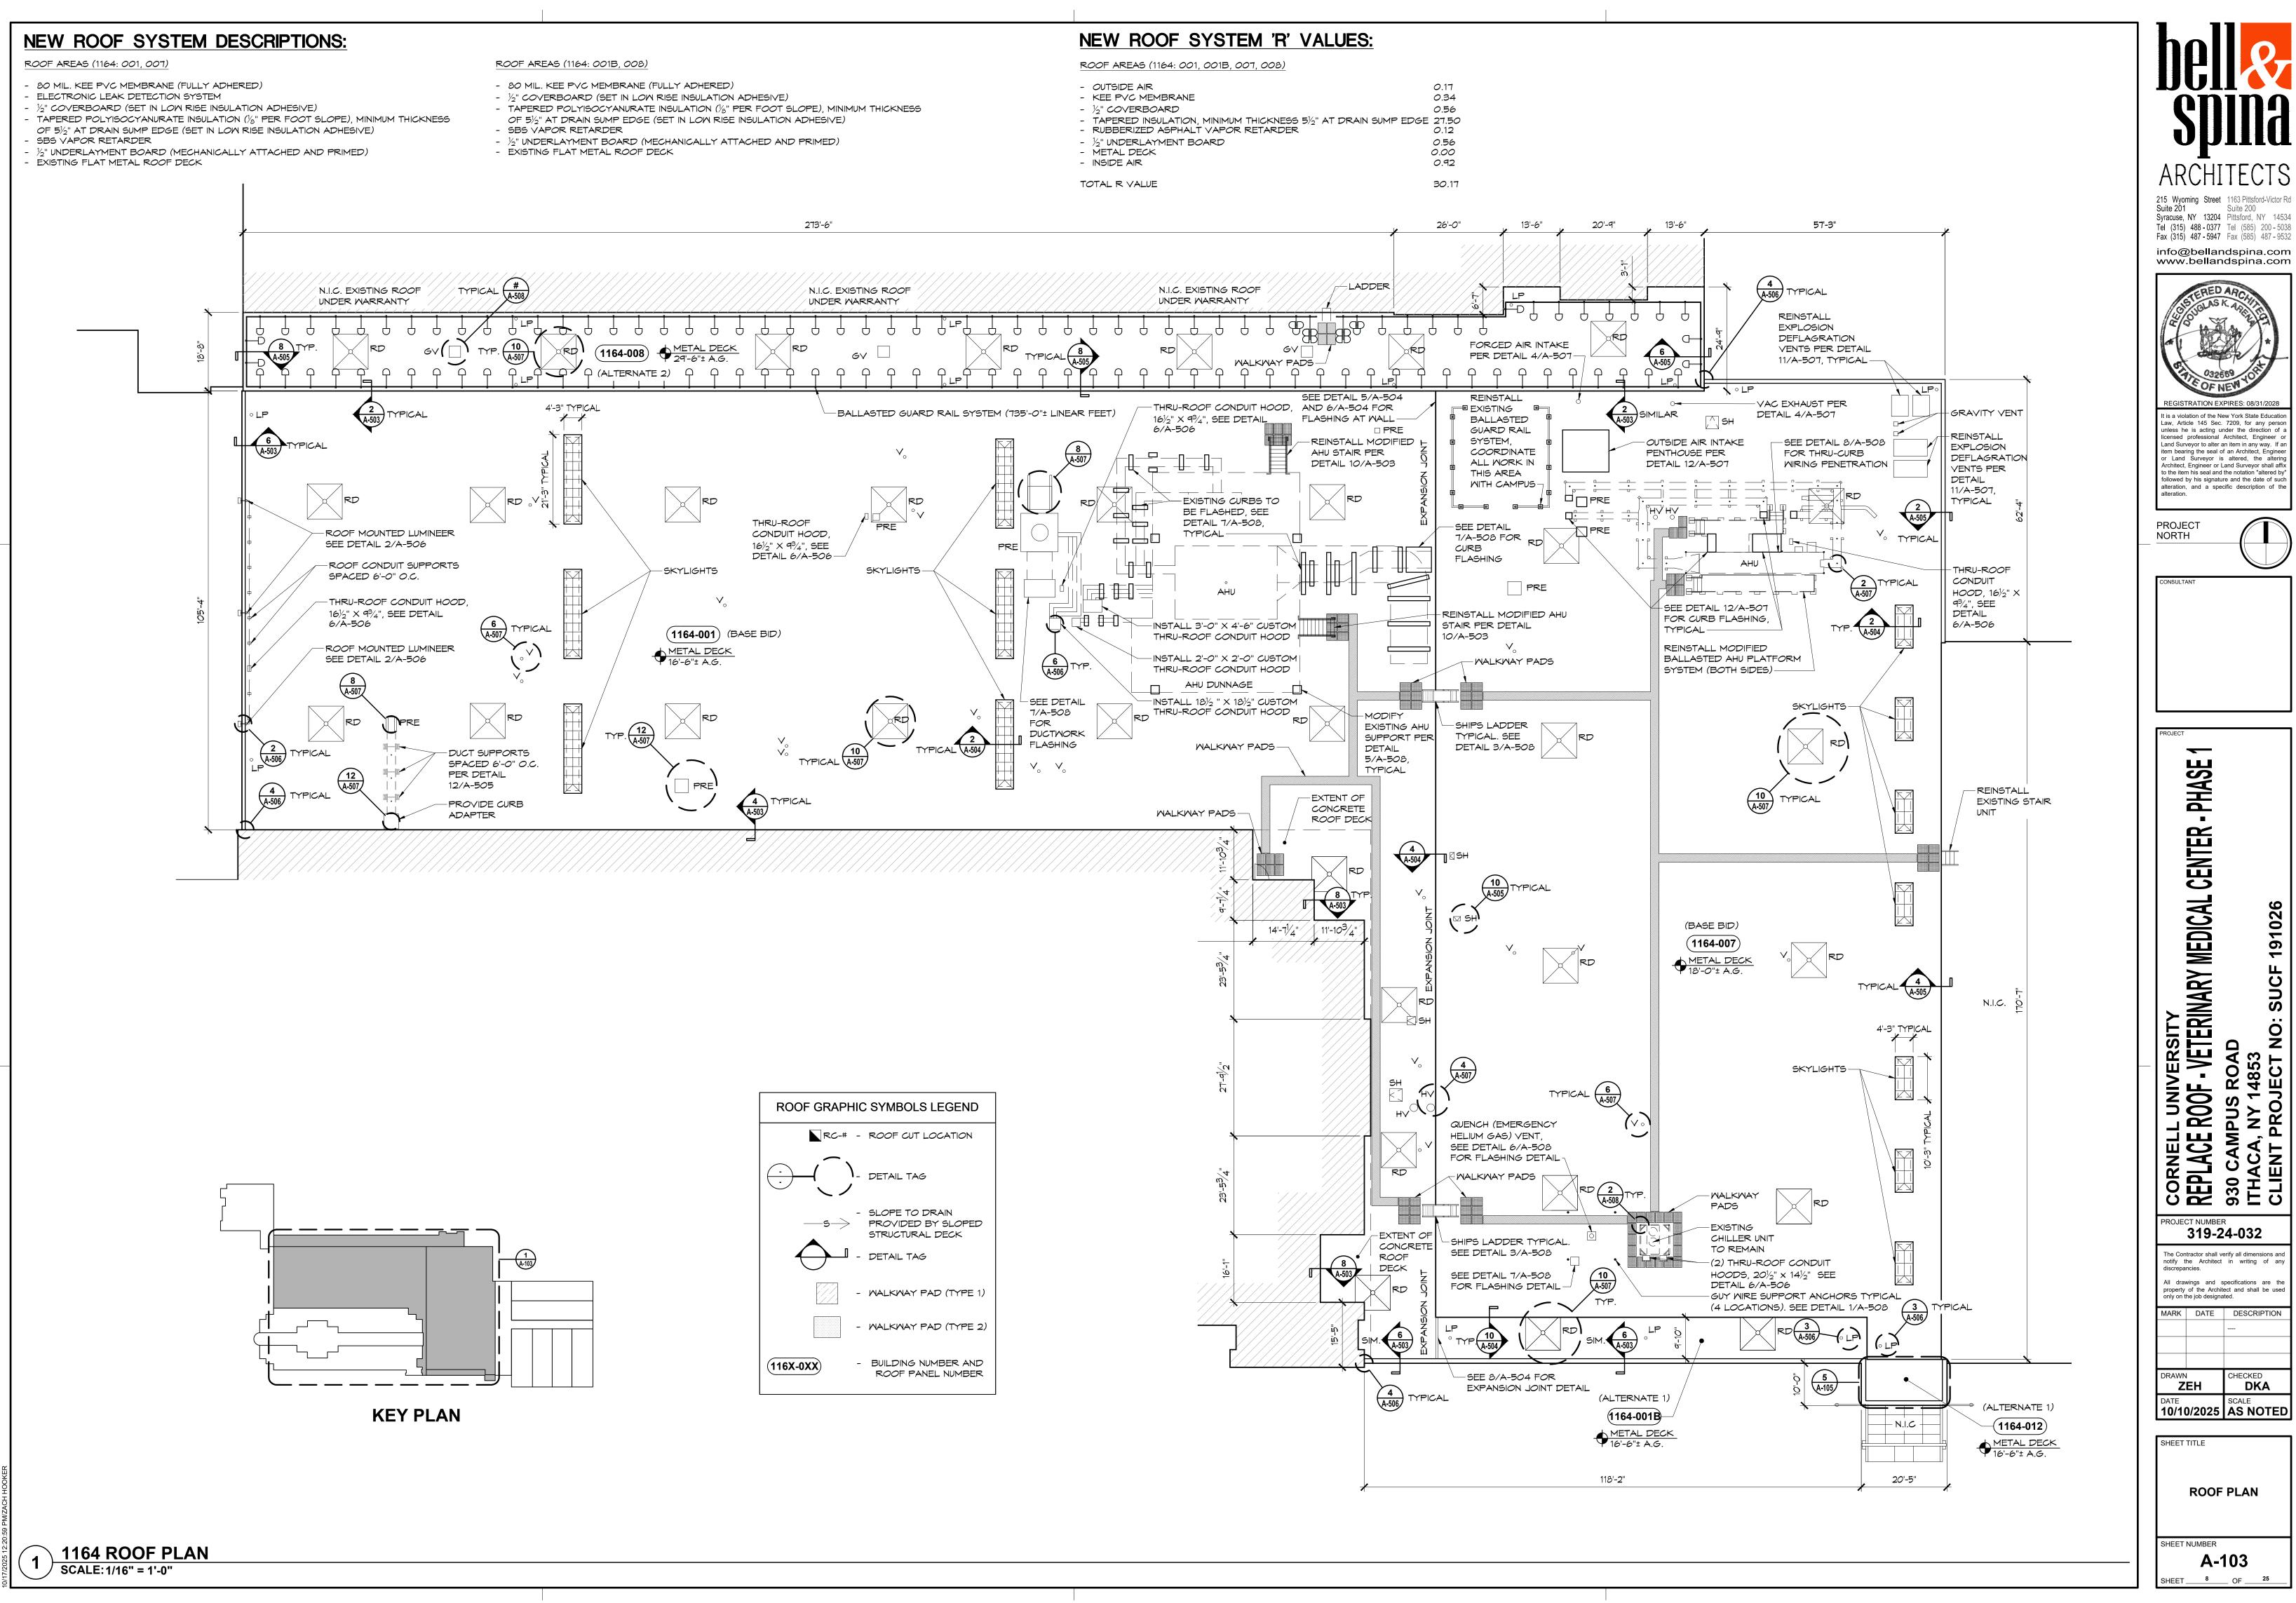

215 Wyoming Street 1163 Pittsford-Victor Rd Syracuse, NY 13204 Pittsford, NY 14534 Tel (315) 488 - 0377 Tel (585) 200 - 5038

info@bellandspina.com www.bellandspina.com

RECISTRATION EXPIRES: 08/31/202 It is a violation of the New York State Education Law, Article 145 Sec. 7209, for any person unless he is acting under the direction of a licensed professional Architect, Engineer of Land Surveyor to alter an item in any way. If a

item bearing the seal of an Architect, Engine or Land Surveyor is altered, the alteri Architect, Engineer or Land Surveyor shall aff to the item his seal and the notation "altered by alteration, and a specific description of t

PHASE CENTE PERSITY -VETERINARY MEDICAL (


PROJECT NUMBER 319-24-032 The Contractor shall verify all dimensions and notify the Architect in writing of ar All drawings and specifications are th property of the Architect and shall be use only on the job designated. MARK DATE DESCRIPTION

CHECKED **DKA**

10/10/2025 AS NOTED

ROOF PLAN

SHEET NUMBER A-103 SHEET 8 OF 25

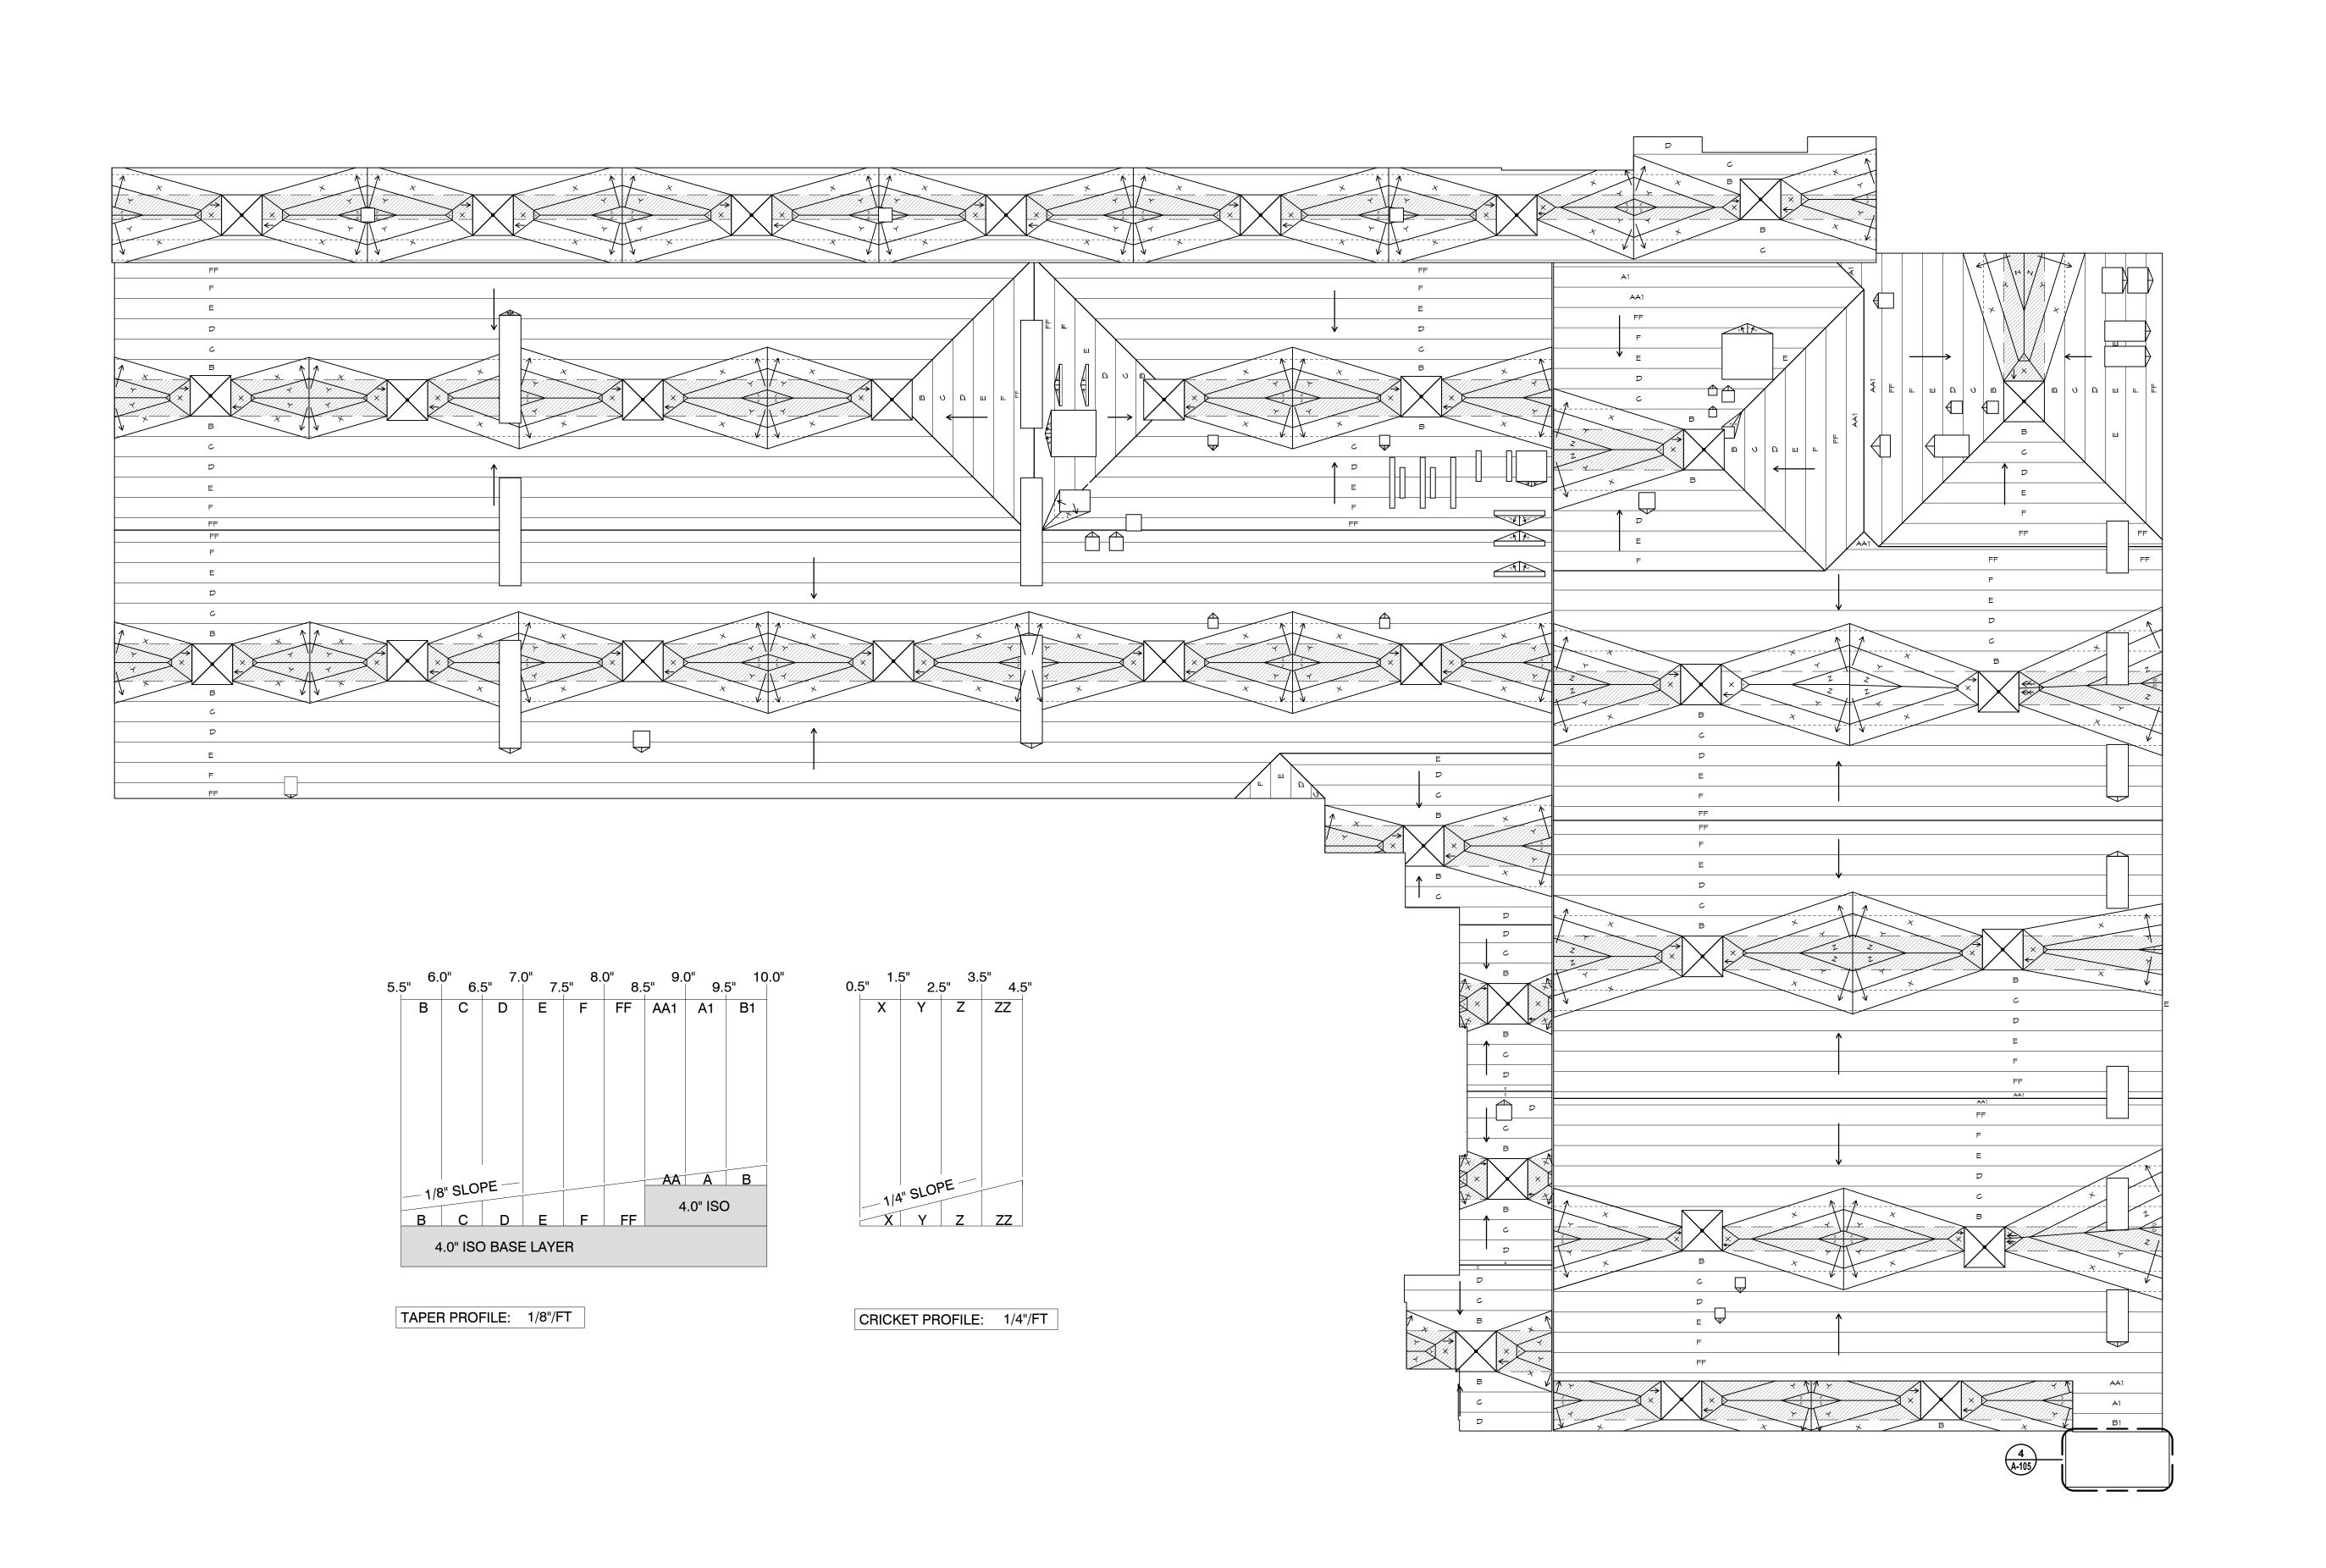






REGISTRATION EXPIRES: 08/31/2028

It is a violation of the New York State Education Law, Article 145 Sec. 7209, for any person unless he is acting under the direction of a licensed professional Architect, Engineer or Land Surveyor to alter an item in any way. If an item bearing the seal of an Architect, Engineer or Land Surveyor is altered, the altering Architect, Engineer or Land Surveyor shall affix to the item his seal and the notation "altered by" followed by his signature and the date of such alteration, and a specific description of the alteration.

PROJECT NORTH

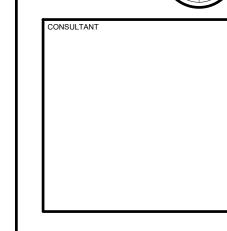

EDICAL CENTER - PHASE 1

CORNELL UNIVERSITY
REPLACE ROOF - VETERINARY MEDICAL CI
120 CAMPUS ROAD
171 THACA, NY 14853
CLIENT PROJECT NO: SUCF 191026

PROJECT NUMBER
319-24-032

The Contractor shall verify all dimensions and notify the Architect in writing of any discrepancies.

All drawings and specifications are the property of the Architect and shall be used only on the job designated.

MARK DATE DESCRIPTION

property of the Architect and shall be used only on the job designated.

MARK DATE DESCRIPTION

ZEH CHECKED DKA


DATE SCALE
10/10/2025 AS NOTED

SHEET TITLE

PLAN
SHEET NUMBER

ROOF TAPERED

A-104SHEET 9 OF 25

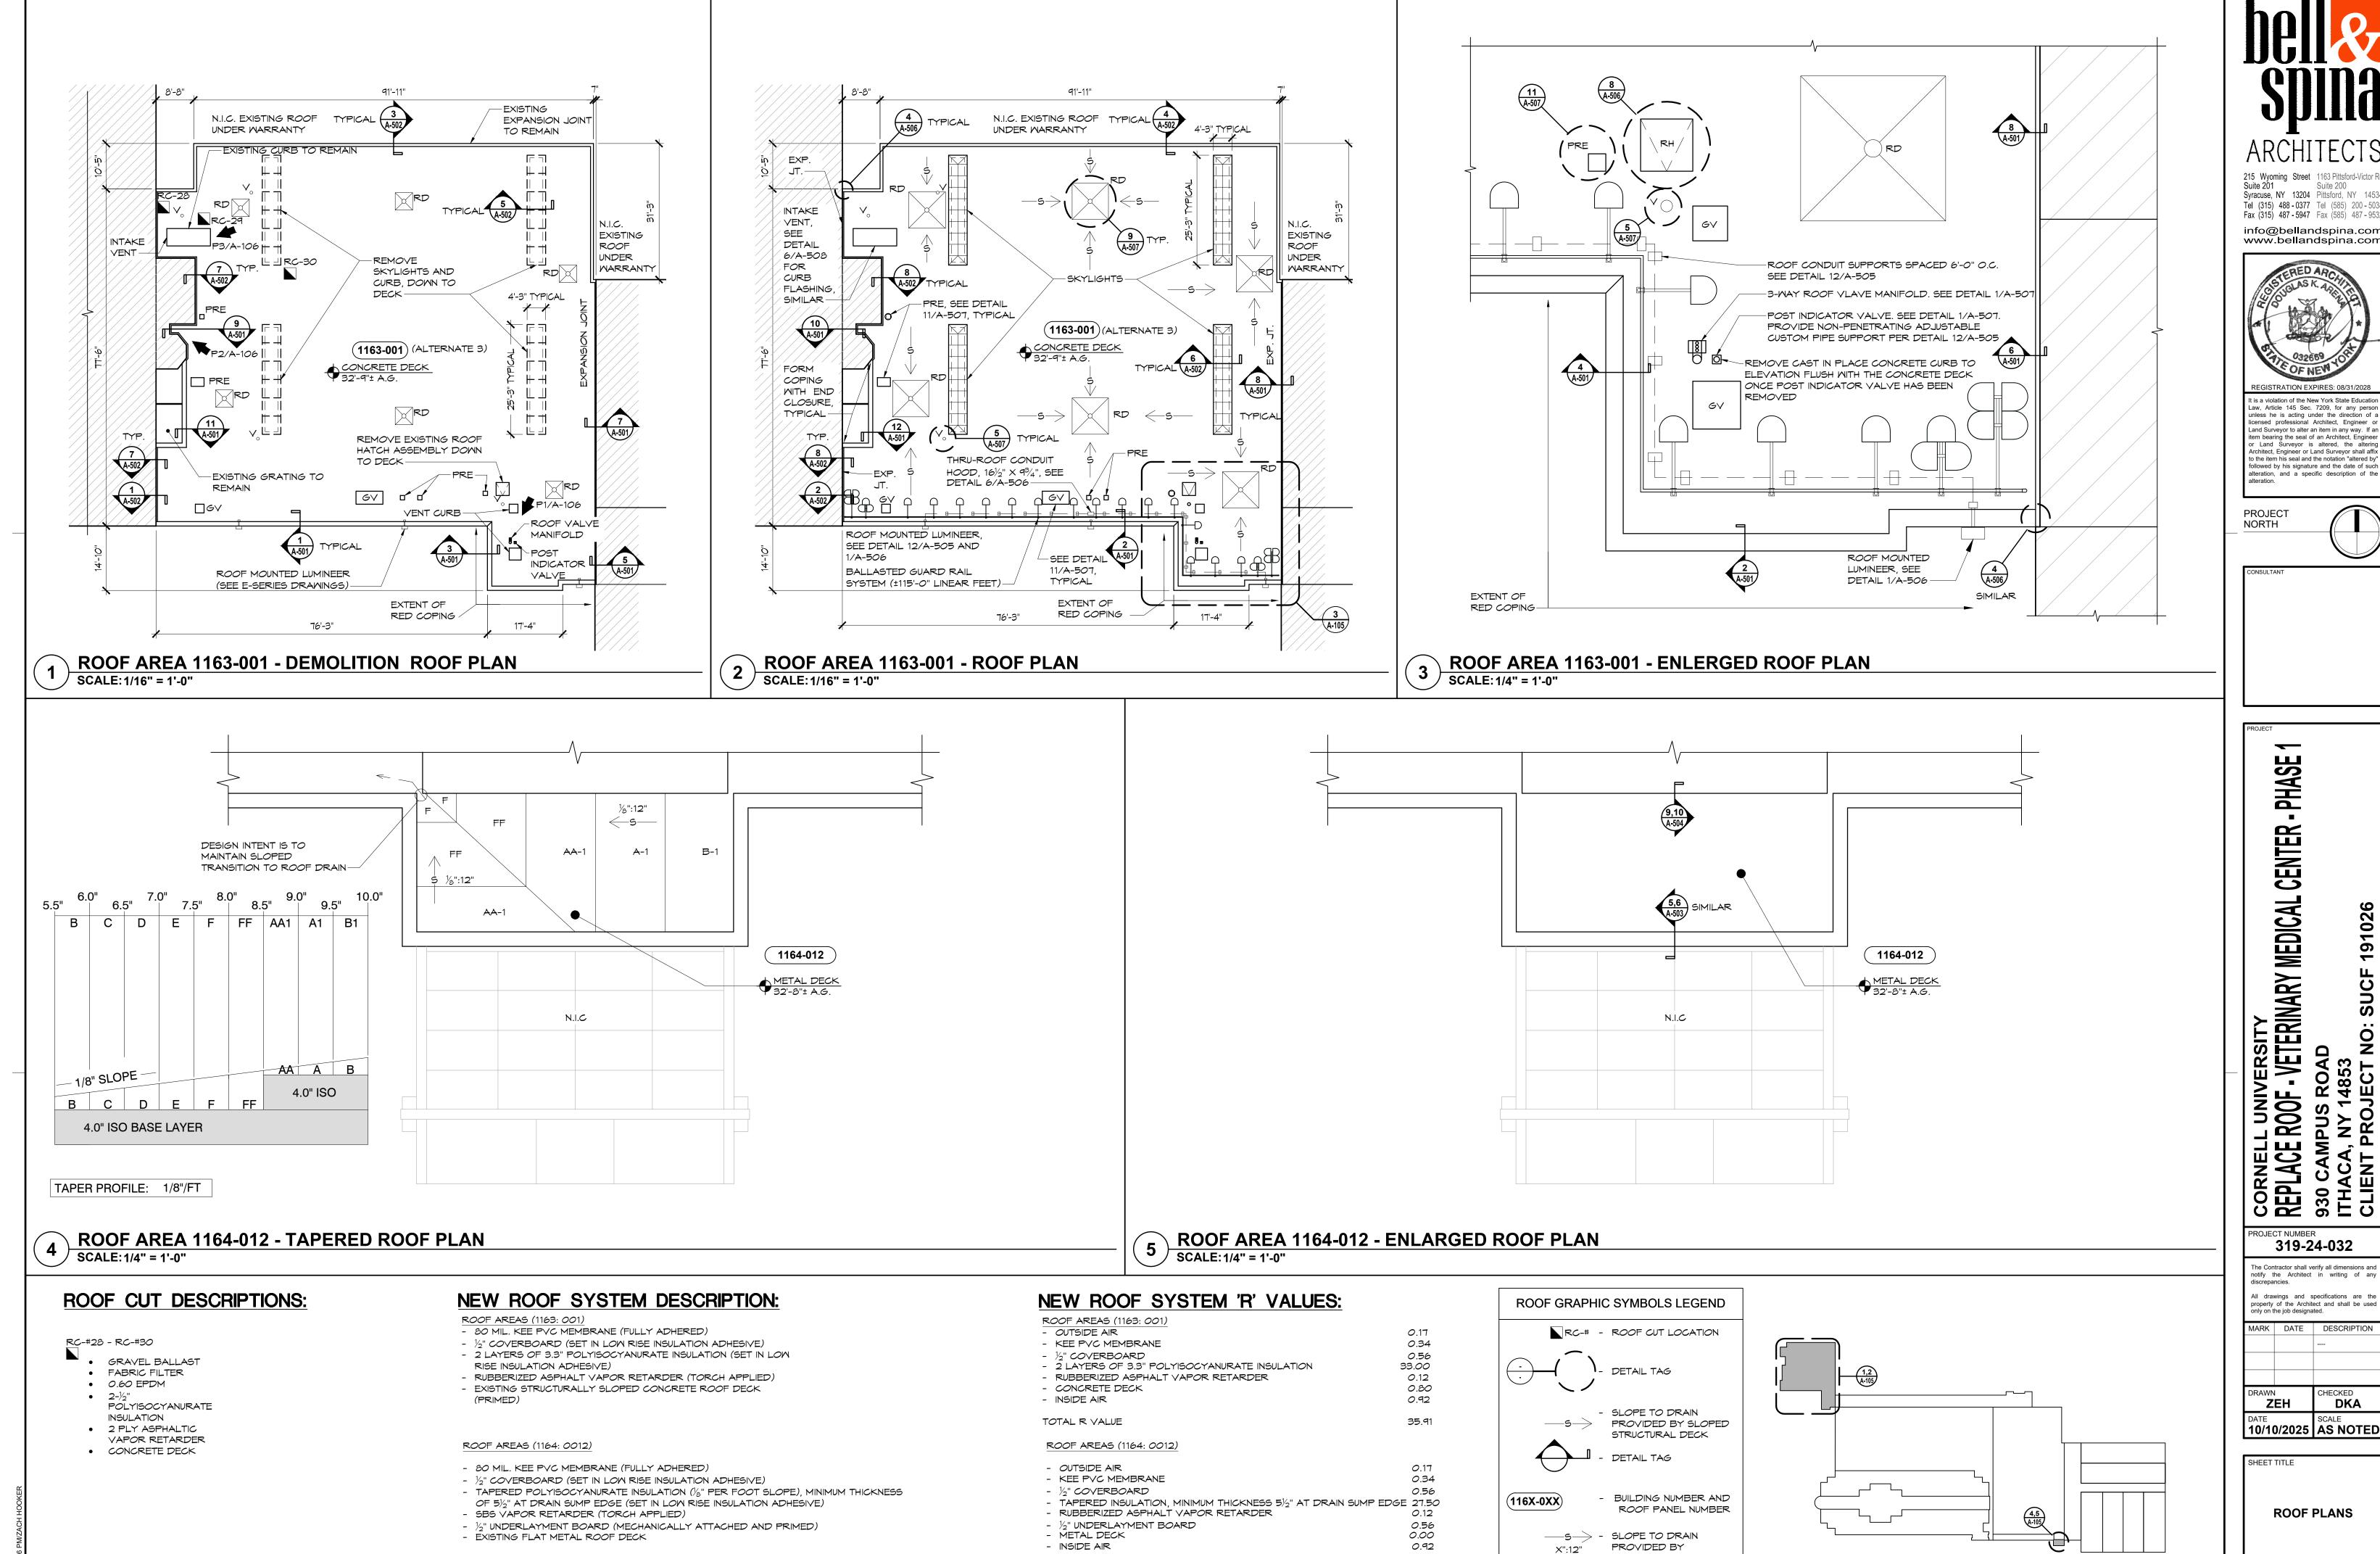

TOTAL R VALUE

INSULATION MEETS OR EXCEEDS REQUIREMENTS IECC

Syracuse, NY 13204 Pittsford, NY 14534 Tel (315) 488 - 0377 Tel (585) 200 - 5038

Fax (315) 487 - 5947 Fax (585) 487 - 9532 info@bellandspina.com www.bellandspina.com



It is a violation of the New York State Education Law, Article 145 Sec. 7209, for any persounless he is acting under the direction of Land Surveyor to alter an item in any way. If to the item his seal and the notation "altered alteration, and a specific description of t

PROJECT

PHASE CENTE

PROJECT NUMBER 319-24-032 The Contractor shall verify all dimensions an notify the Architect in writing of ar All drawings and specifications are th property of the Architect and shall be use only on the job designated. MARK DATE DESCRIPTION

DKA ZEH SCALE 10/10/2025 AS NOTED

ROOF PLANS

SHEET NUMBER A-105 SHEET 10 OF 25

KEY PLAN

TAPERED INSULATION

30.17



P1 - ROOF AREA 1163-001




P2 - ROOF AREA 1163-001



P3 - ROOF AREA 1163-001



P4 - ROOF AREA 1164-001

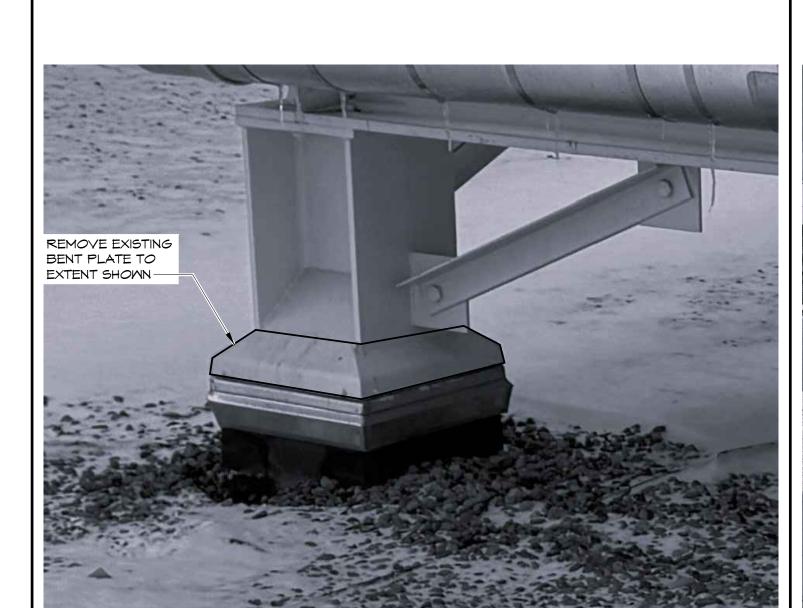

P5 - ROOF AREA 1164-001



P6 - ROOF AREA 1164-001



P7 - ROOF AREA 1164-007




P8 - ROOF AREA 1164-007



P9 - ROOF AREA 1164-007



P10 - ROOF AREA 1164-001

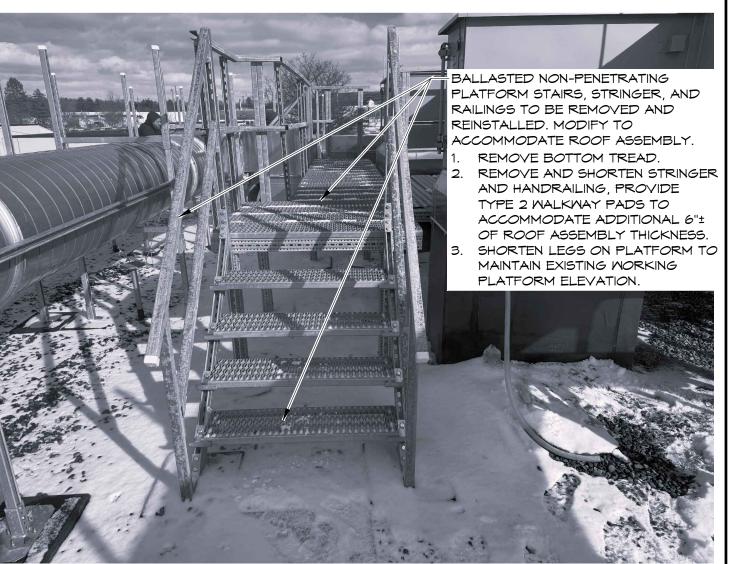

P11 - ROOF AREA 1164-001



P12 - ROOF AREA 1164-001



and Surveyor to alter an item in any way. If a sm bearing the seal of an Architect, Enginee Land Surveyor is altered, the alterin richitect, Engineer or Land Surveyor shall affit the item his seal and the notation "altered by llowed by his signature and the date of sucteration, and a specific description of the teration.

PROJECT NORTH

PROJECT

-VETERINARY MEDICAL CENTER - PHASE 1

NEFLAVE KUUF - VEIENIIVANT 930 CAMPUS ROAD ITHACA, NY 14853

PROJECT NUMBER
319-24-032

The Contractor shall verify all dimensions and notify the Architect in writing of any discrepancies.

All drawings and specifications are the property of the Architect and shall be used only on the job designated.

MARK DATE DESCRIPTION

DRAWN CHECKED DKA


ZEH DKA

DATE SCALE
10/10/2025 AS NOTED

PHOTOS


EET NUMBER
A-106

A-106SHEET 11 OF 25

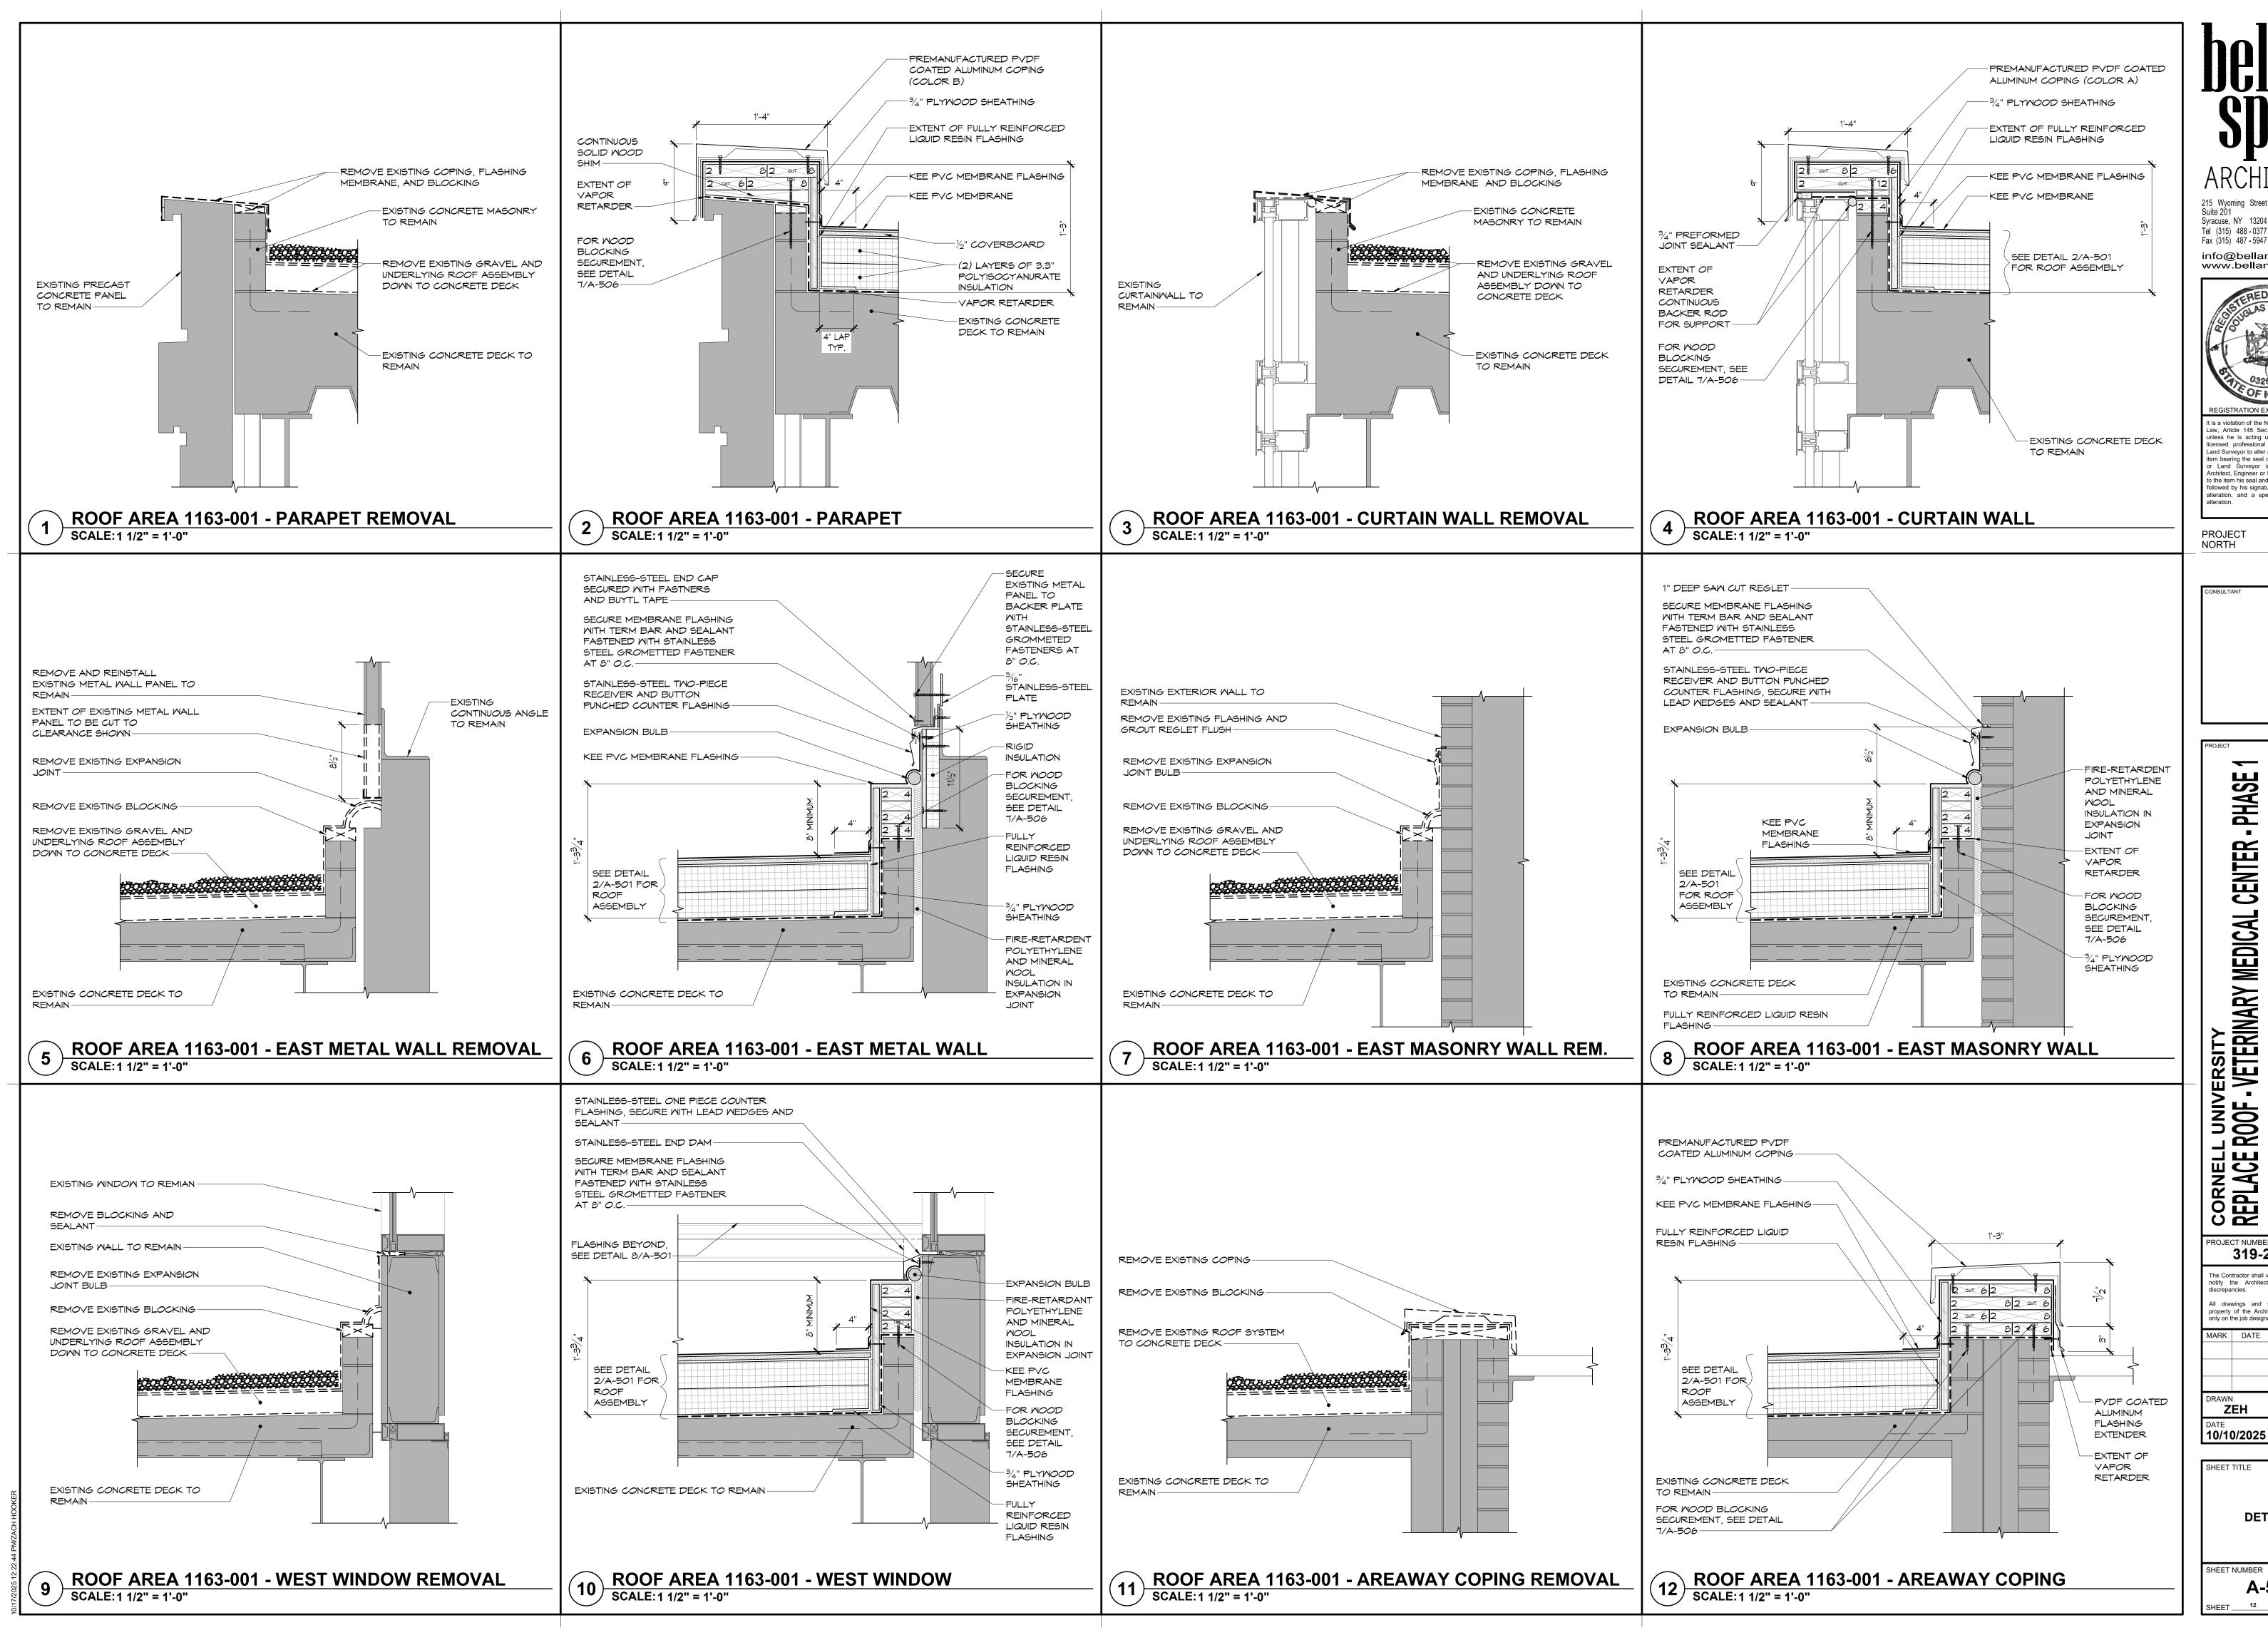


Syracuse, NY 13204 Pittsford, NY 14534 Tel (315) 488 - 0377 Tel (585) 200 - 5038 Fax (315) 487 - 5947 Fax (585) 487 - 9532

info@bellandspina.com www.bellandspina.com

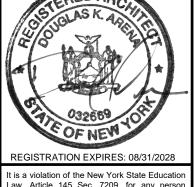

Law, Article 145 Sec. 7209, for any personal unless he is acting under the direction of icensed professional Architect, Engineer and Surveyor to alter an item in any way. If or Land Surveyor is altered, the alter to the item his seal and the notation "altered b alteration, and a specific description of t

PROJECT

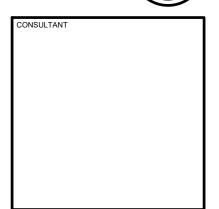

PHASE CENTE MEDICAL

CORNEL
REPLACE
930 CAN
ITHACA
CLIENT


PROJECT NUMBER 319-24-032 he Contractor shall verify all dimensions and All drawings and specifications are th property of the Architect and shall be us only on the job designated. MARK DATE DESCRIPTION

DKA ZEH SCALE 10/10/2025 AS NOTED

SHEET TITLE **DETAILS**

A-501

SHEET NUMBER SHEET 12 OF 25

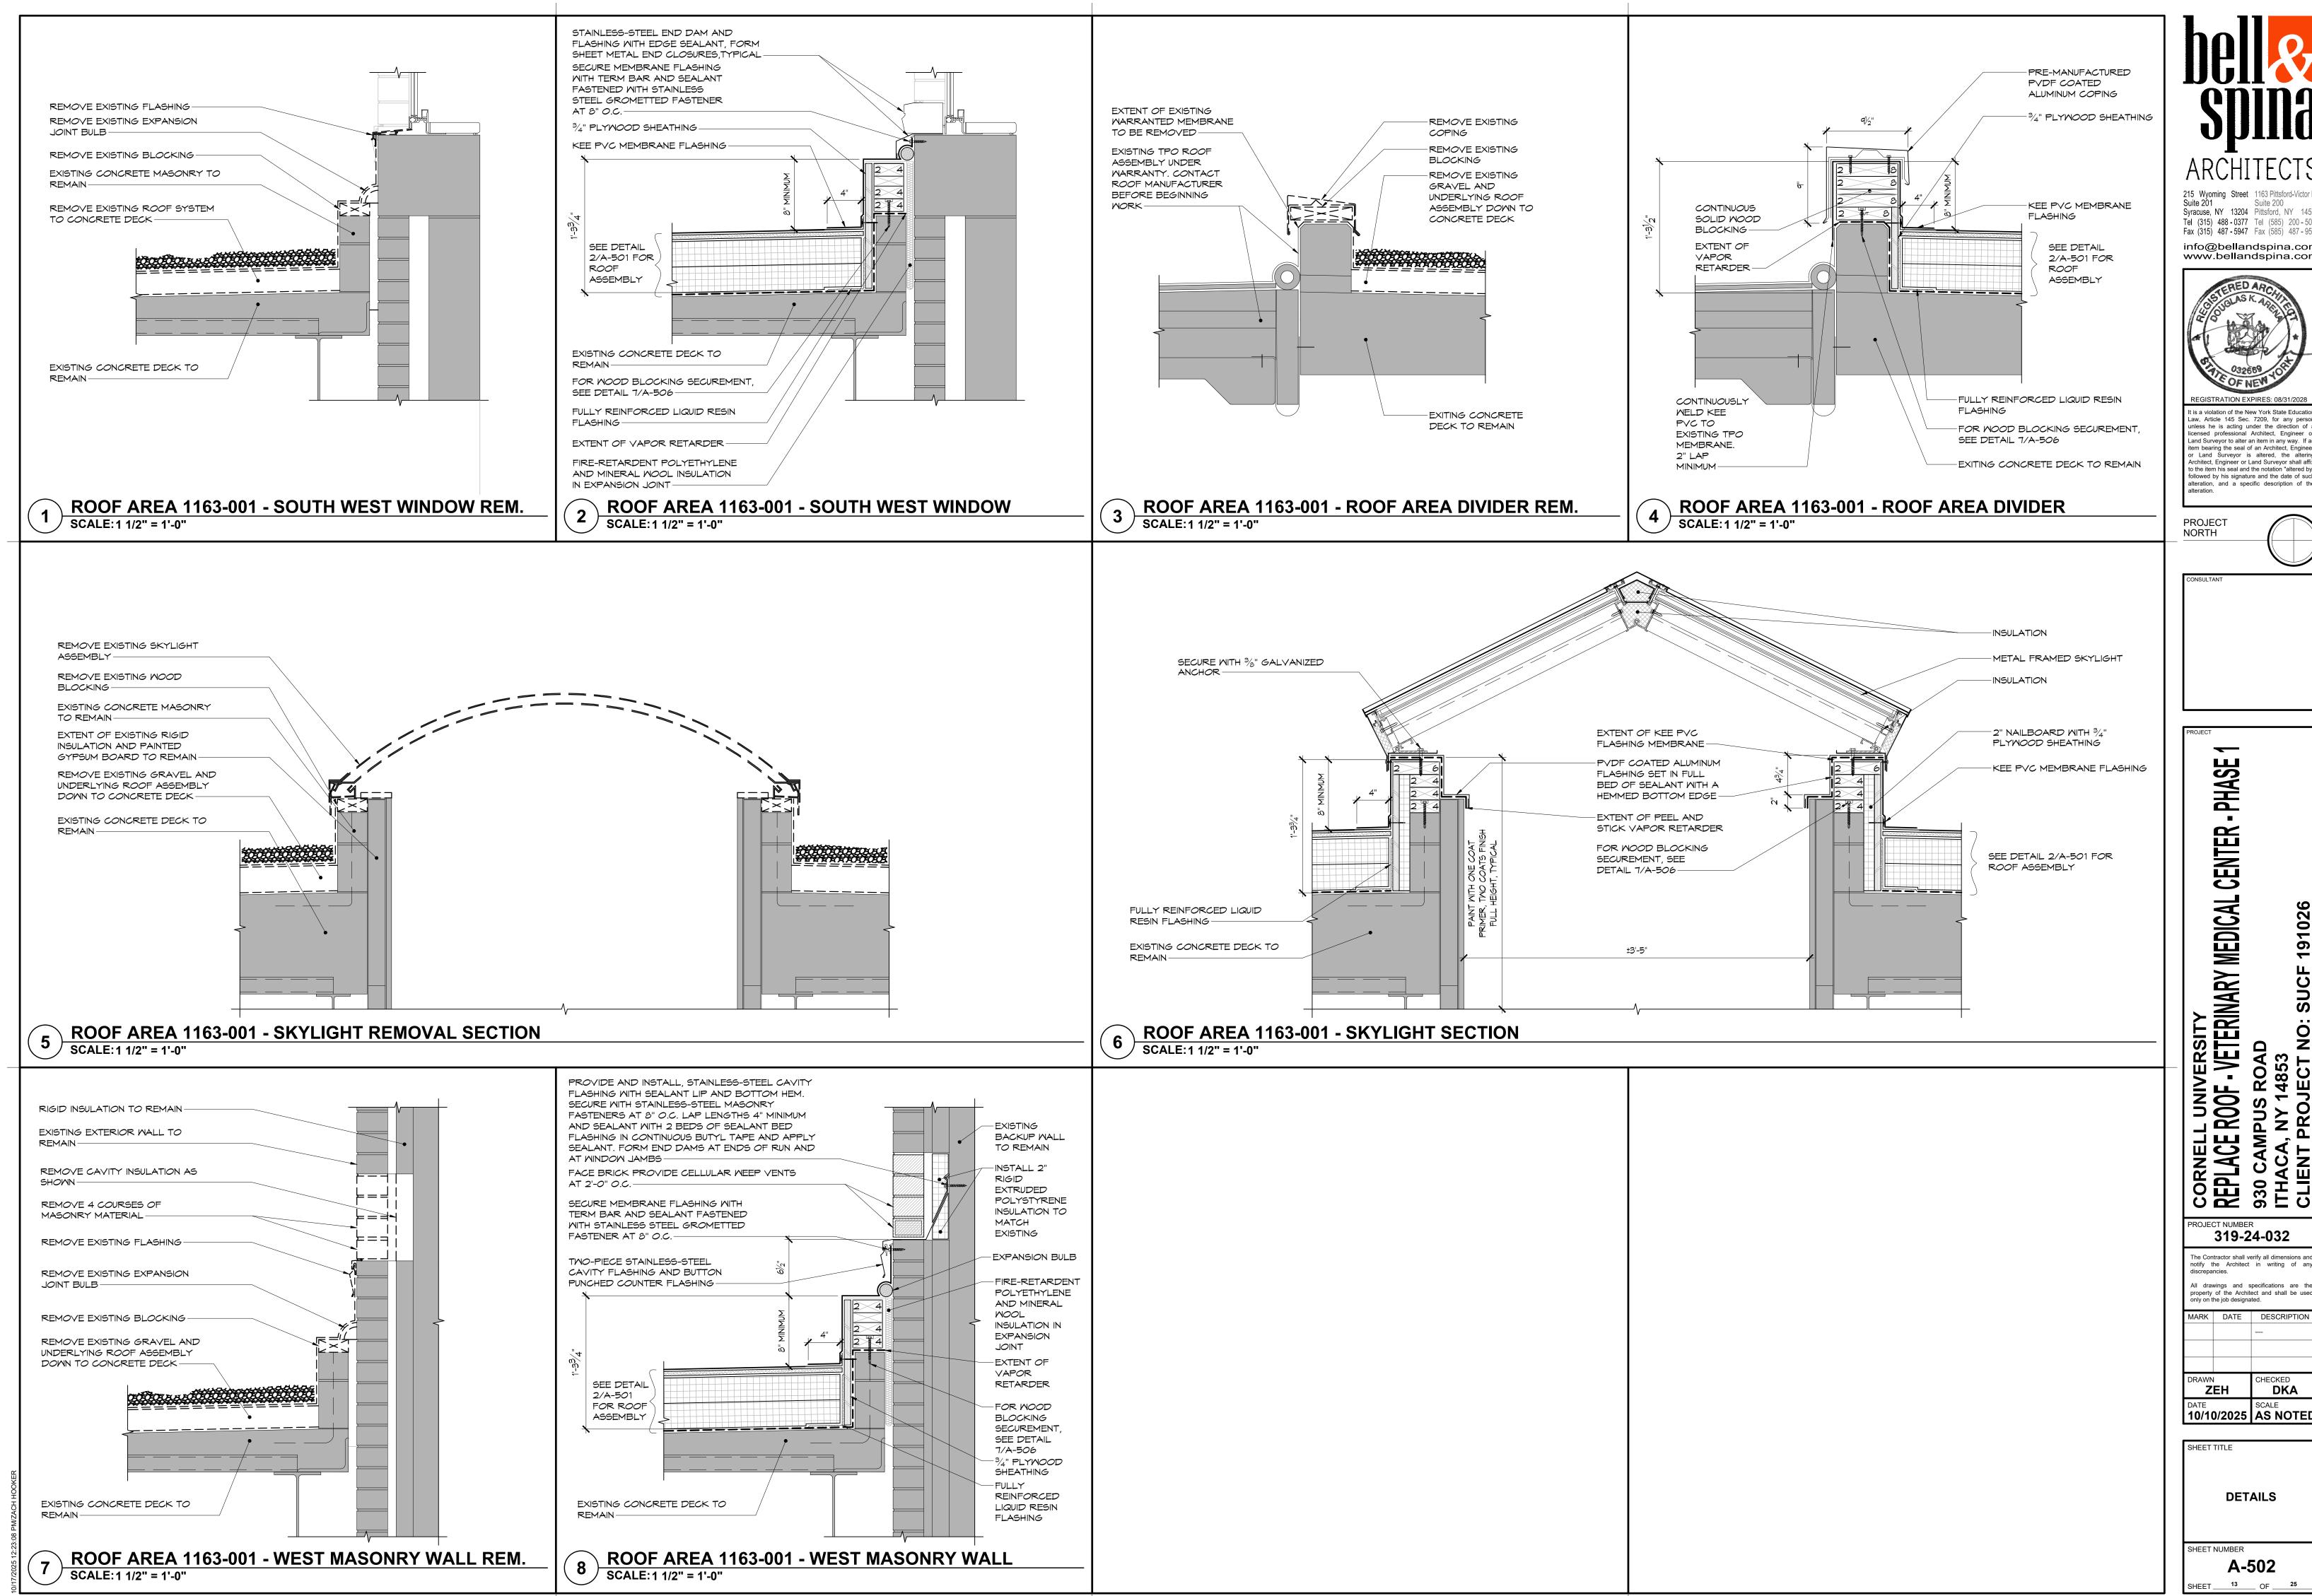




Syracuse, NY 13204 Pittsford, NY 14534 Tel (315) 488 - 0377 Tel (585) 200 - 5038 Fax (315) 487 - 5947 Fax (585) 487 - 9532

info@bellandspina.com www.bellandspina.com



It is a violation of the New York State Education Law, Article 145 Sec. 7209, for any person unless he is acting under the direction of a icensed professional Architect, Engineer and Surveyor to alter an item in any way. If item bearing the seal of an Architect, Engine or Land Surveyor is altered, the alteri o the item his seal and the notation "altered b alteration, and a specific description of t

PROJECT

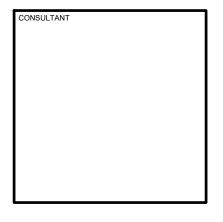

PHASE CENTE MEDICAL


CORNEL
REPLACE
930 CAN
ITHACA,
CLIENT

PROJECT NUMBER 319-24-032 The Contractor shall verify all dimensions and notify the Architect in writing of ar All drawings and specifications are th property of the Architect and shall be use only on the job designated. MARK DATE DESCRIPTION DKA ZEH

SHEET TITLE **DETAILS**

SHEET NUMBER A-502

SHEET 13

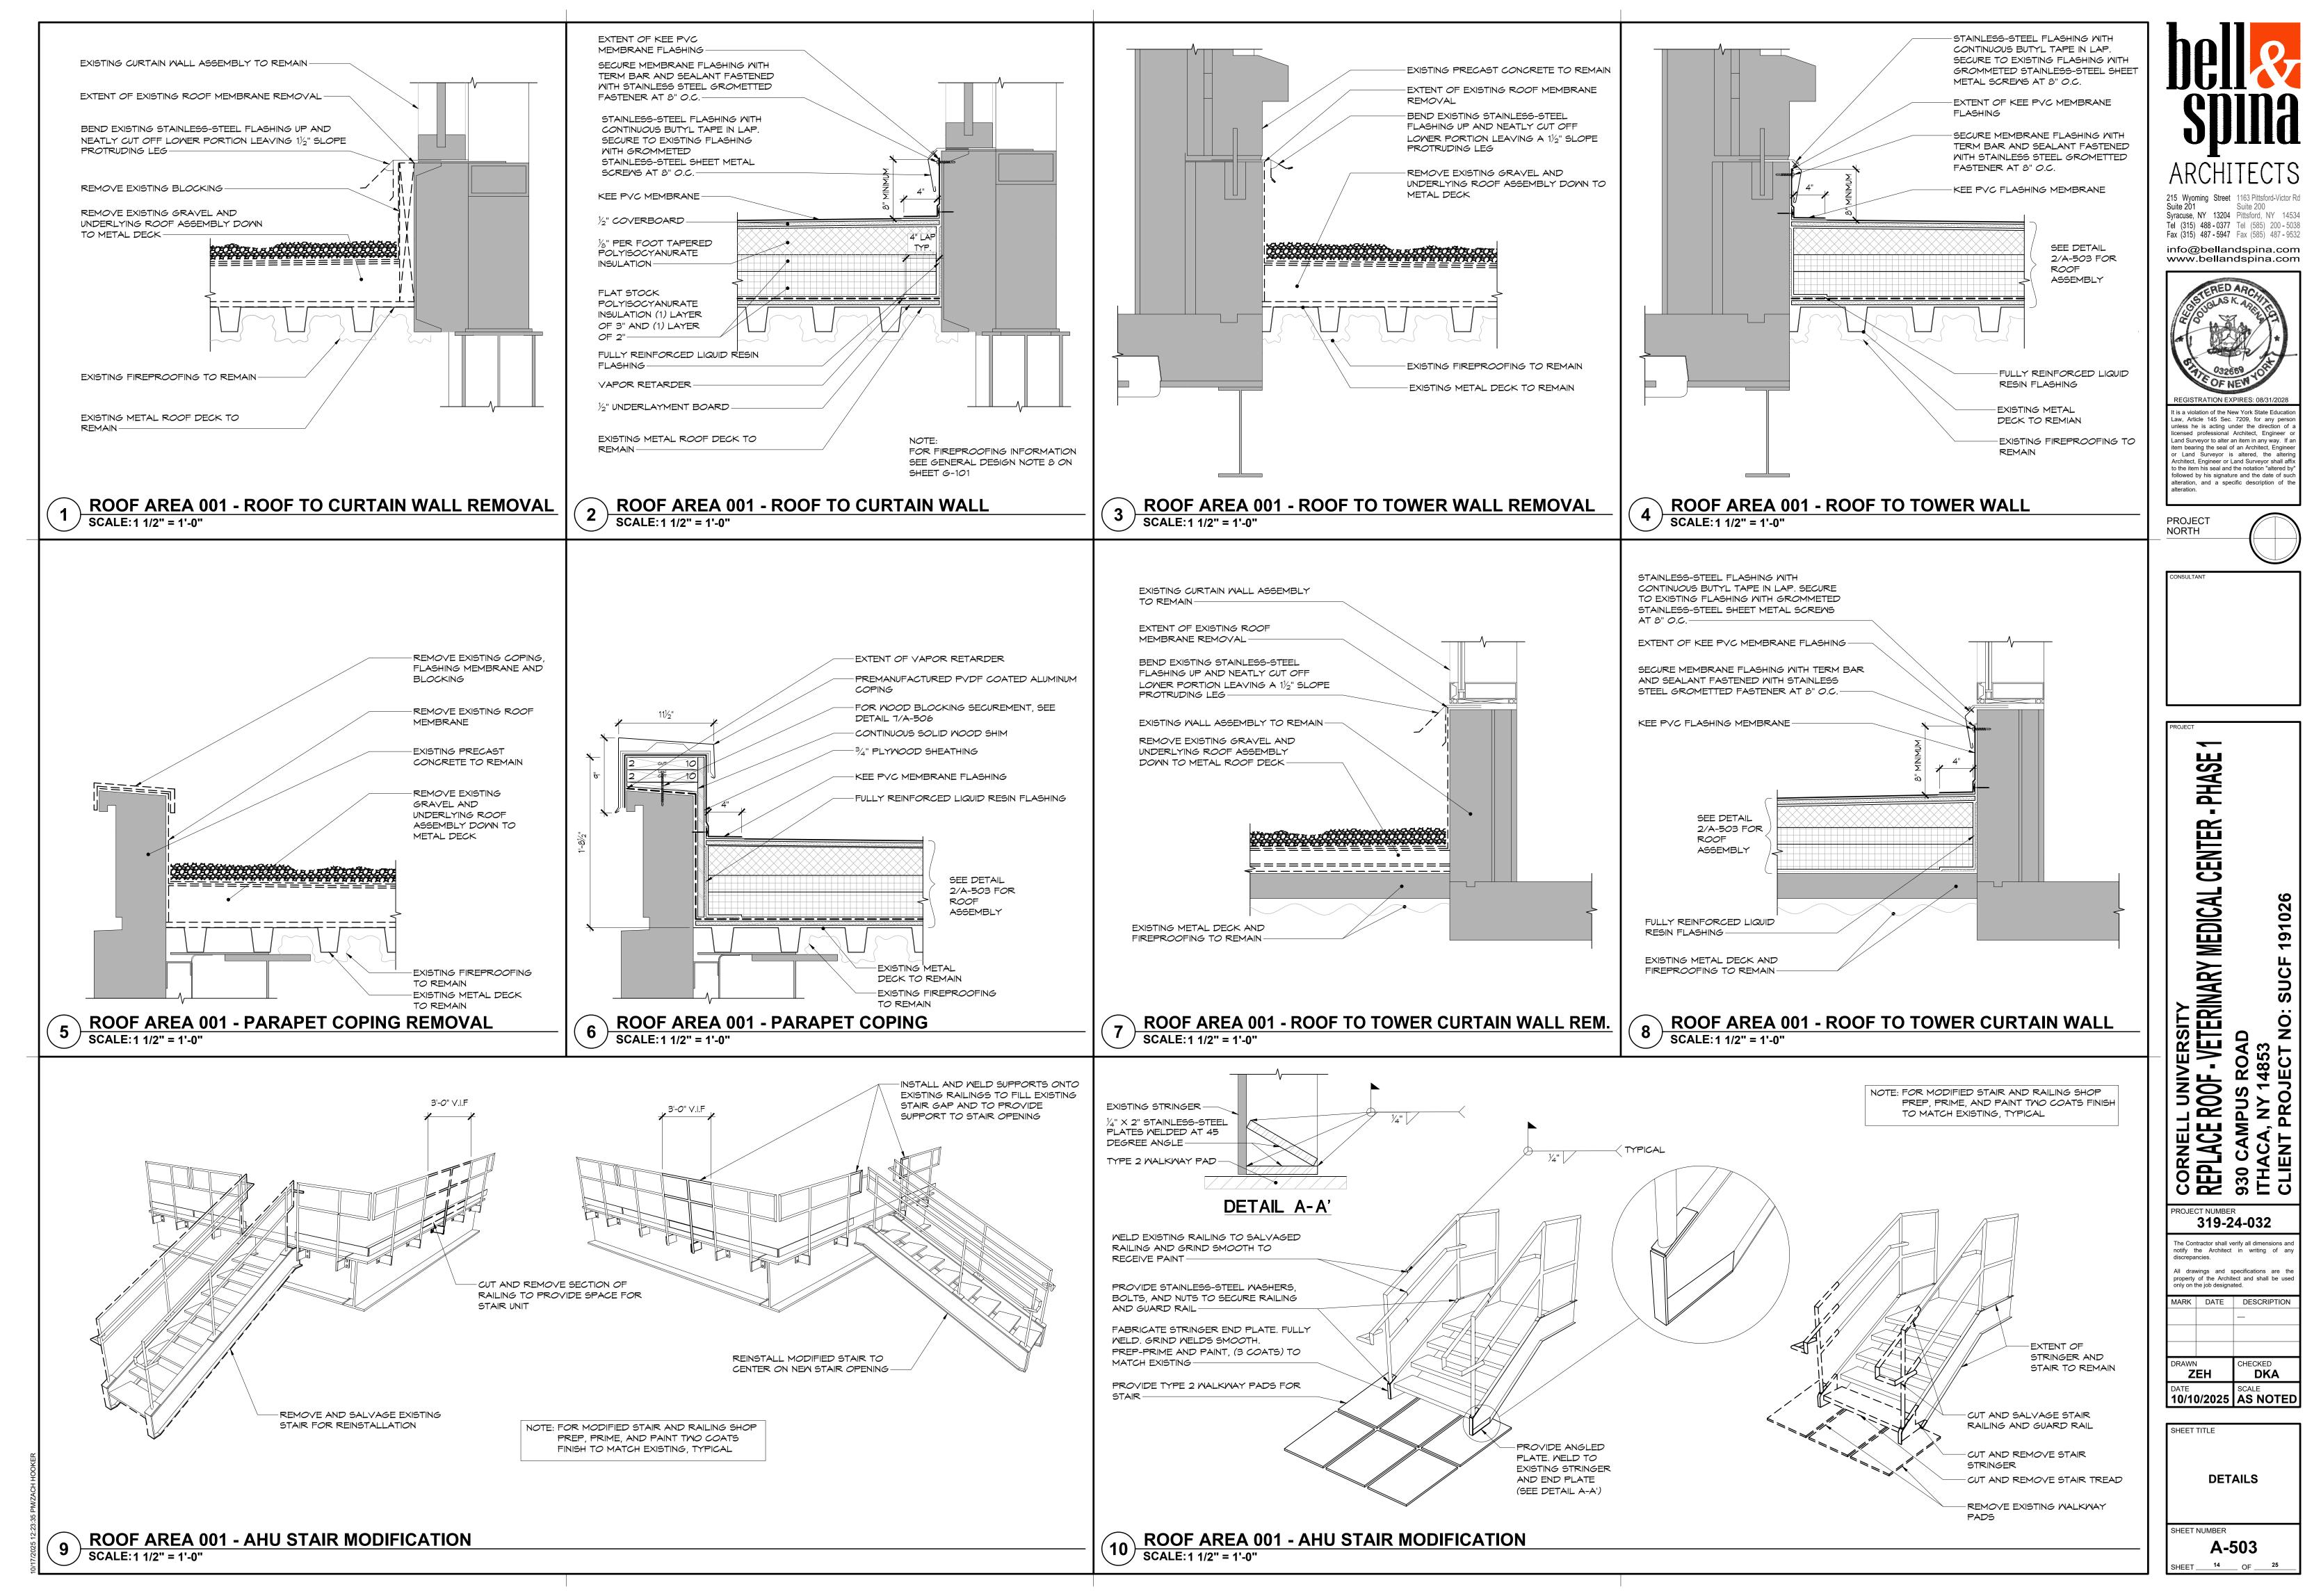

Syracuse, NY 13204 Pittsford, NY 14534 Tel (315) 488 - 0377 Tel (585) 200 - 5038

info@bellandspina.com www.bellandspina.com



It is a violation of the New York State Education Law, Article 145 Sec. 7209, for any persounless he is acting under the direction of icensed professional Architect, Engineer and Surveyor to alter an item in any way. If n bearing the seal of an Architect, Engine or Land Surveyor is altered, the alter to the item his seal and the notation "altered b ollowed by his signature and the date of su alteration, and a specific description of t

PROJECT

PHASE CENTE

CORNEL
REPLACE
930 CAN
ITHACA
CLIENT


PROJECT NUMBER 319-24-032 The Contractor shall verify all dimensions an notify the Architect in writing of a All drawings and specifications are th property of the Architect and shall be us only on the job designated. MARK DATE DESCRIPTION

DKA

10/10/2025 AS NOTED

DETAILS

SHEET NUMBER A-503 SHEET 14 OF 25

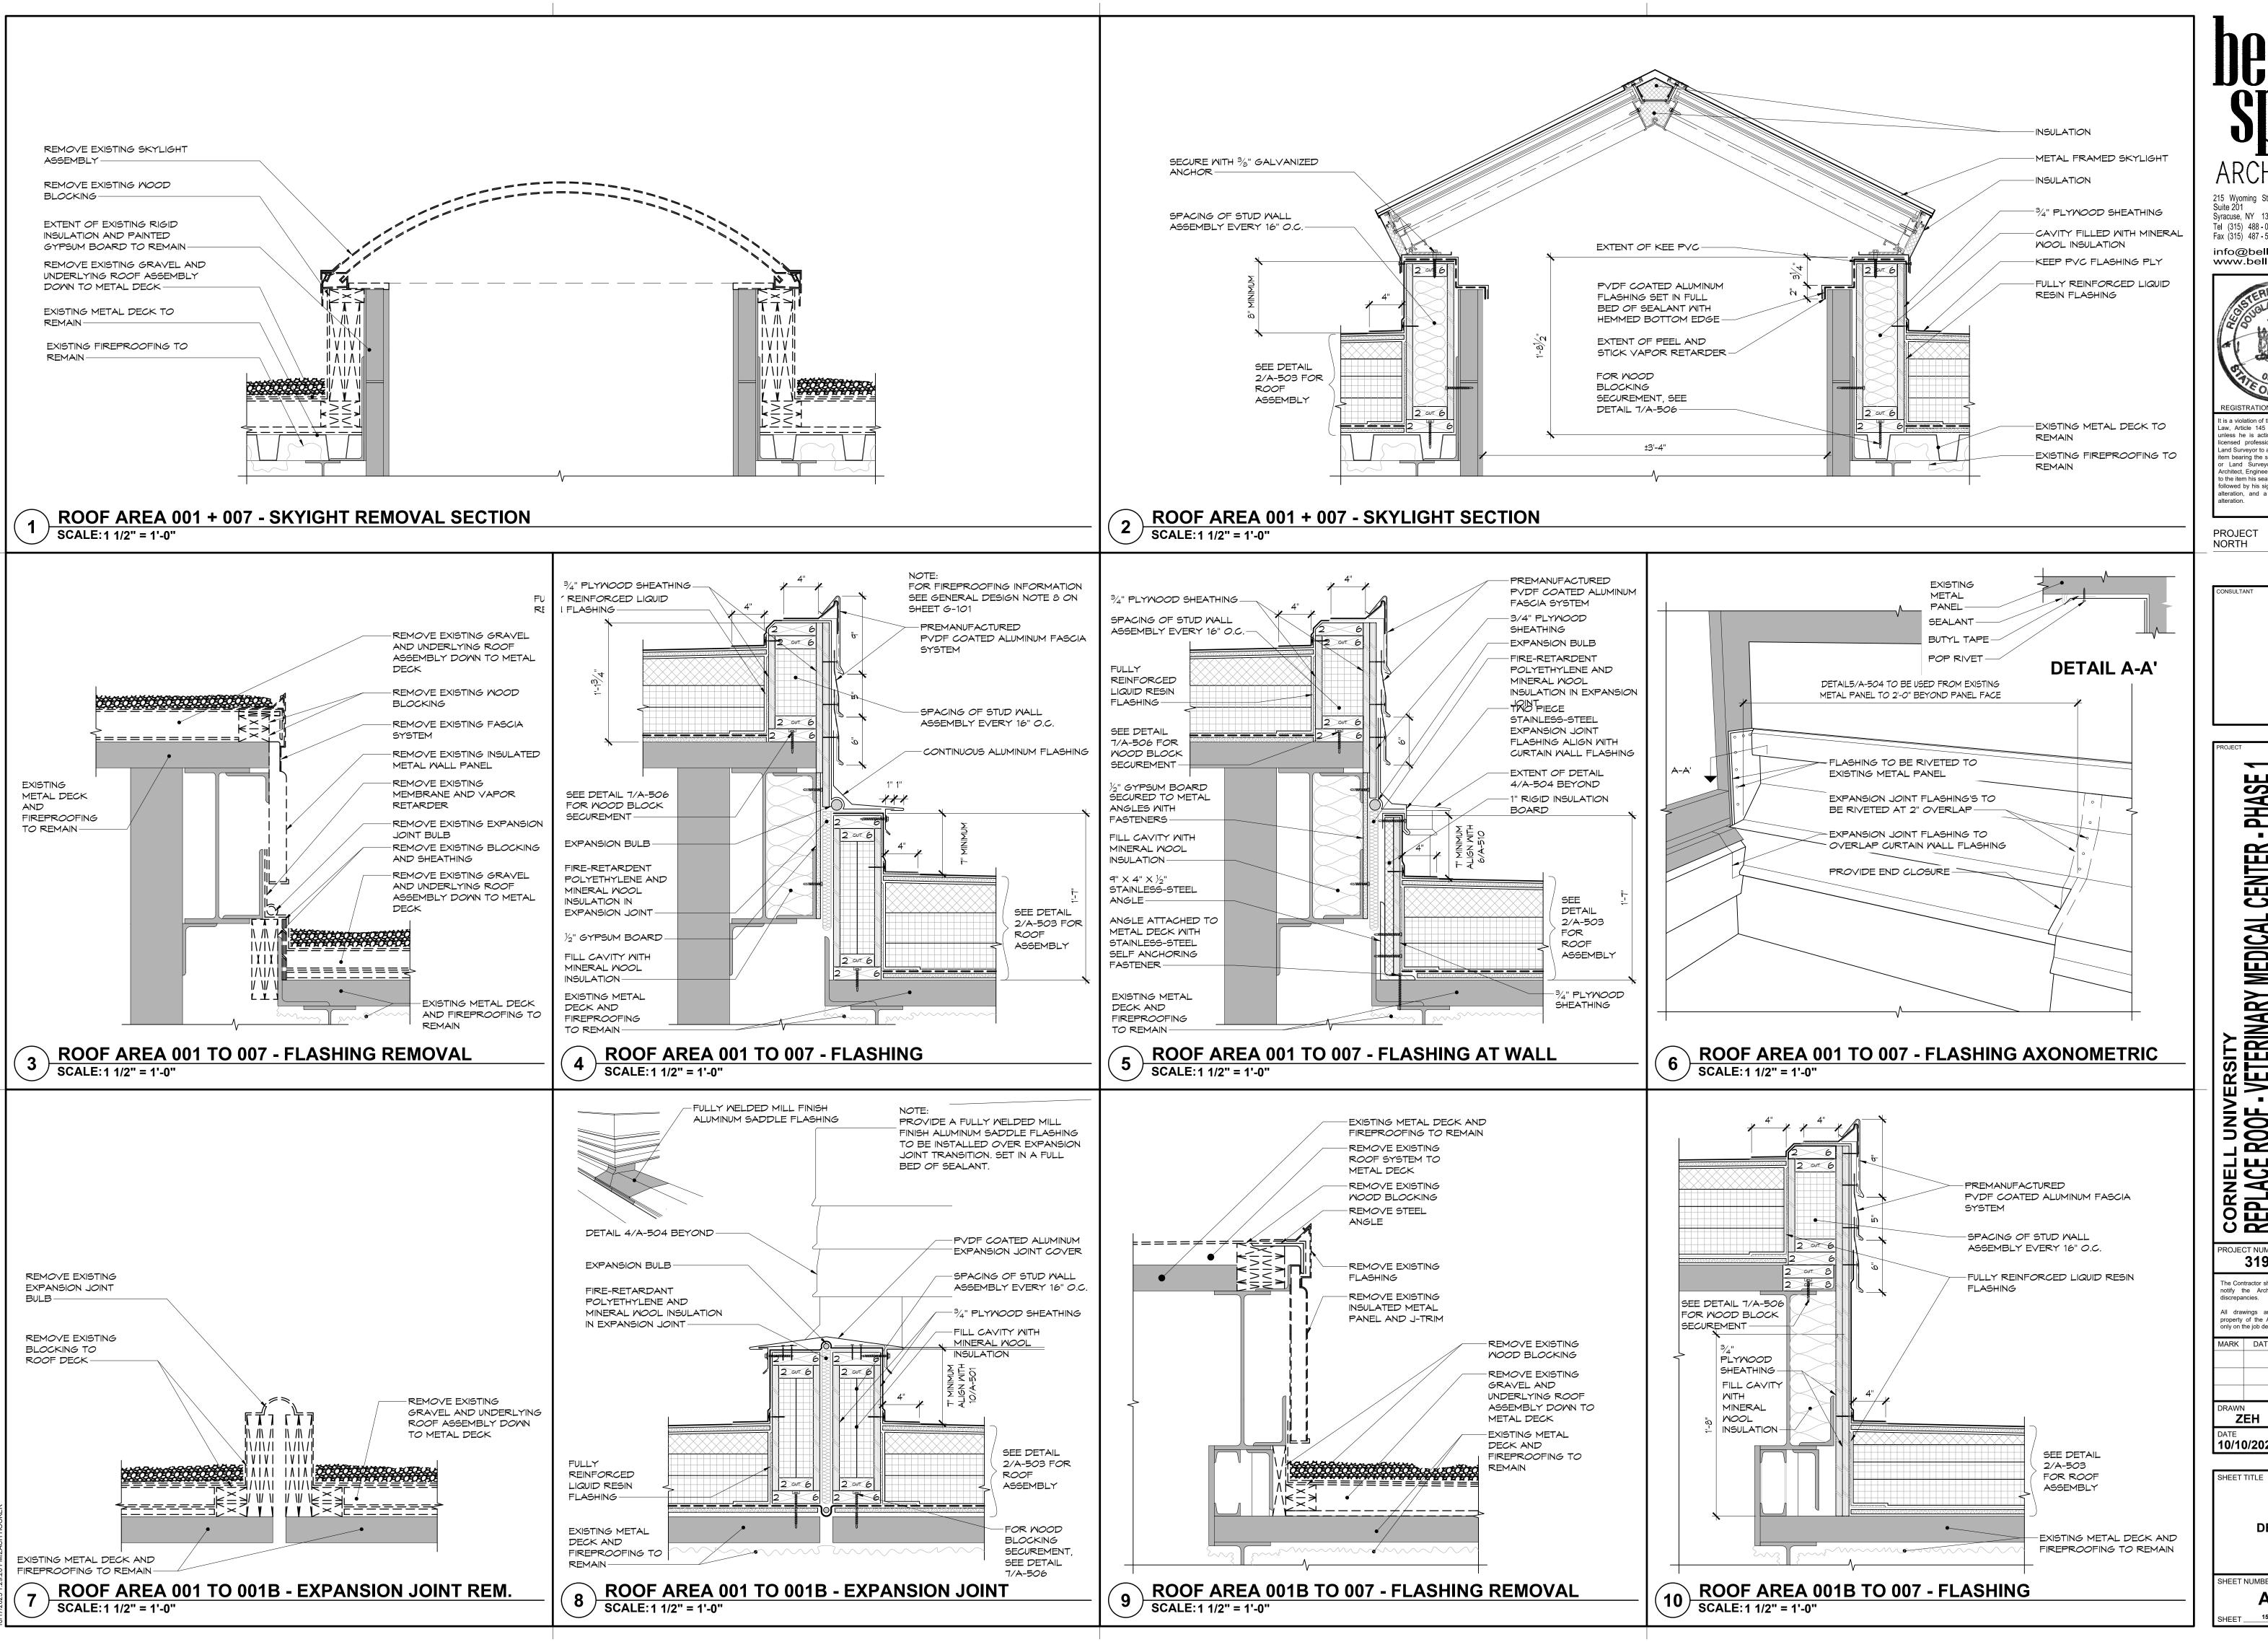


Syracuse, NY 13204 Pittsford, NY 14534 Tel (315) 488 - 0377 Tel (585) 200 - 5038

Fax (315) 487 - 5947 Fax (585) 487 - 9532 info@bellandspina.com www.bellandspina.com



It is a violation of the New York State Education Law, Article 145 Sec. 7209, for any personal unless he is acting under the direction of censed professional Architect, Engineer and Surveyor to alter an item in any way. If or Land Surveyor is altered, the alte to the item his seal and the notation "altered alteration, and a specific description of t

PROJECT NORTH

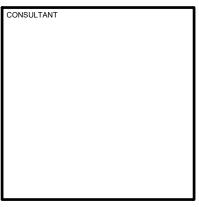

PHASE CENTE 'MEDICAL ROOF - VETERINARY N

CORNELL UNIVERS
REPLACE ROOF - VET
930 CAMPUS ROAD
ITHACA, NY 14853
CLIENT PROJECT N

PROJECT NUMBER 319-24-032 The Contractor shall verify all dimensions an notify the Architect in writing of a All drawings and specifications are th property of the Architect and shall be use only on the job designated. MARK DATE DESCRIPTION


DKA

ZEH SCALE 10/10/2025 AS NOTED

DETAILS


SHEET NUMBER A-504

SHEET 15 OF 25

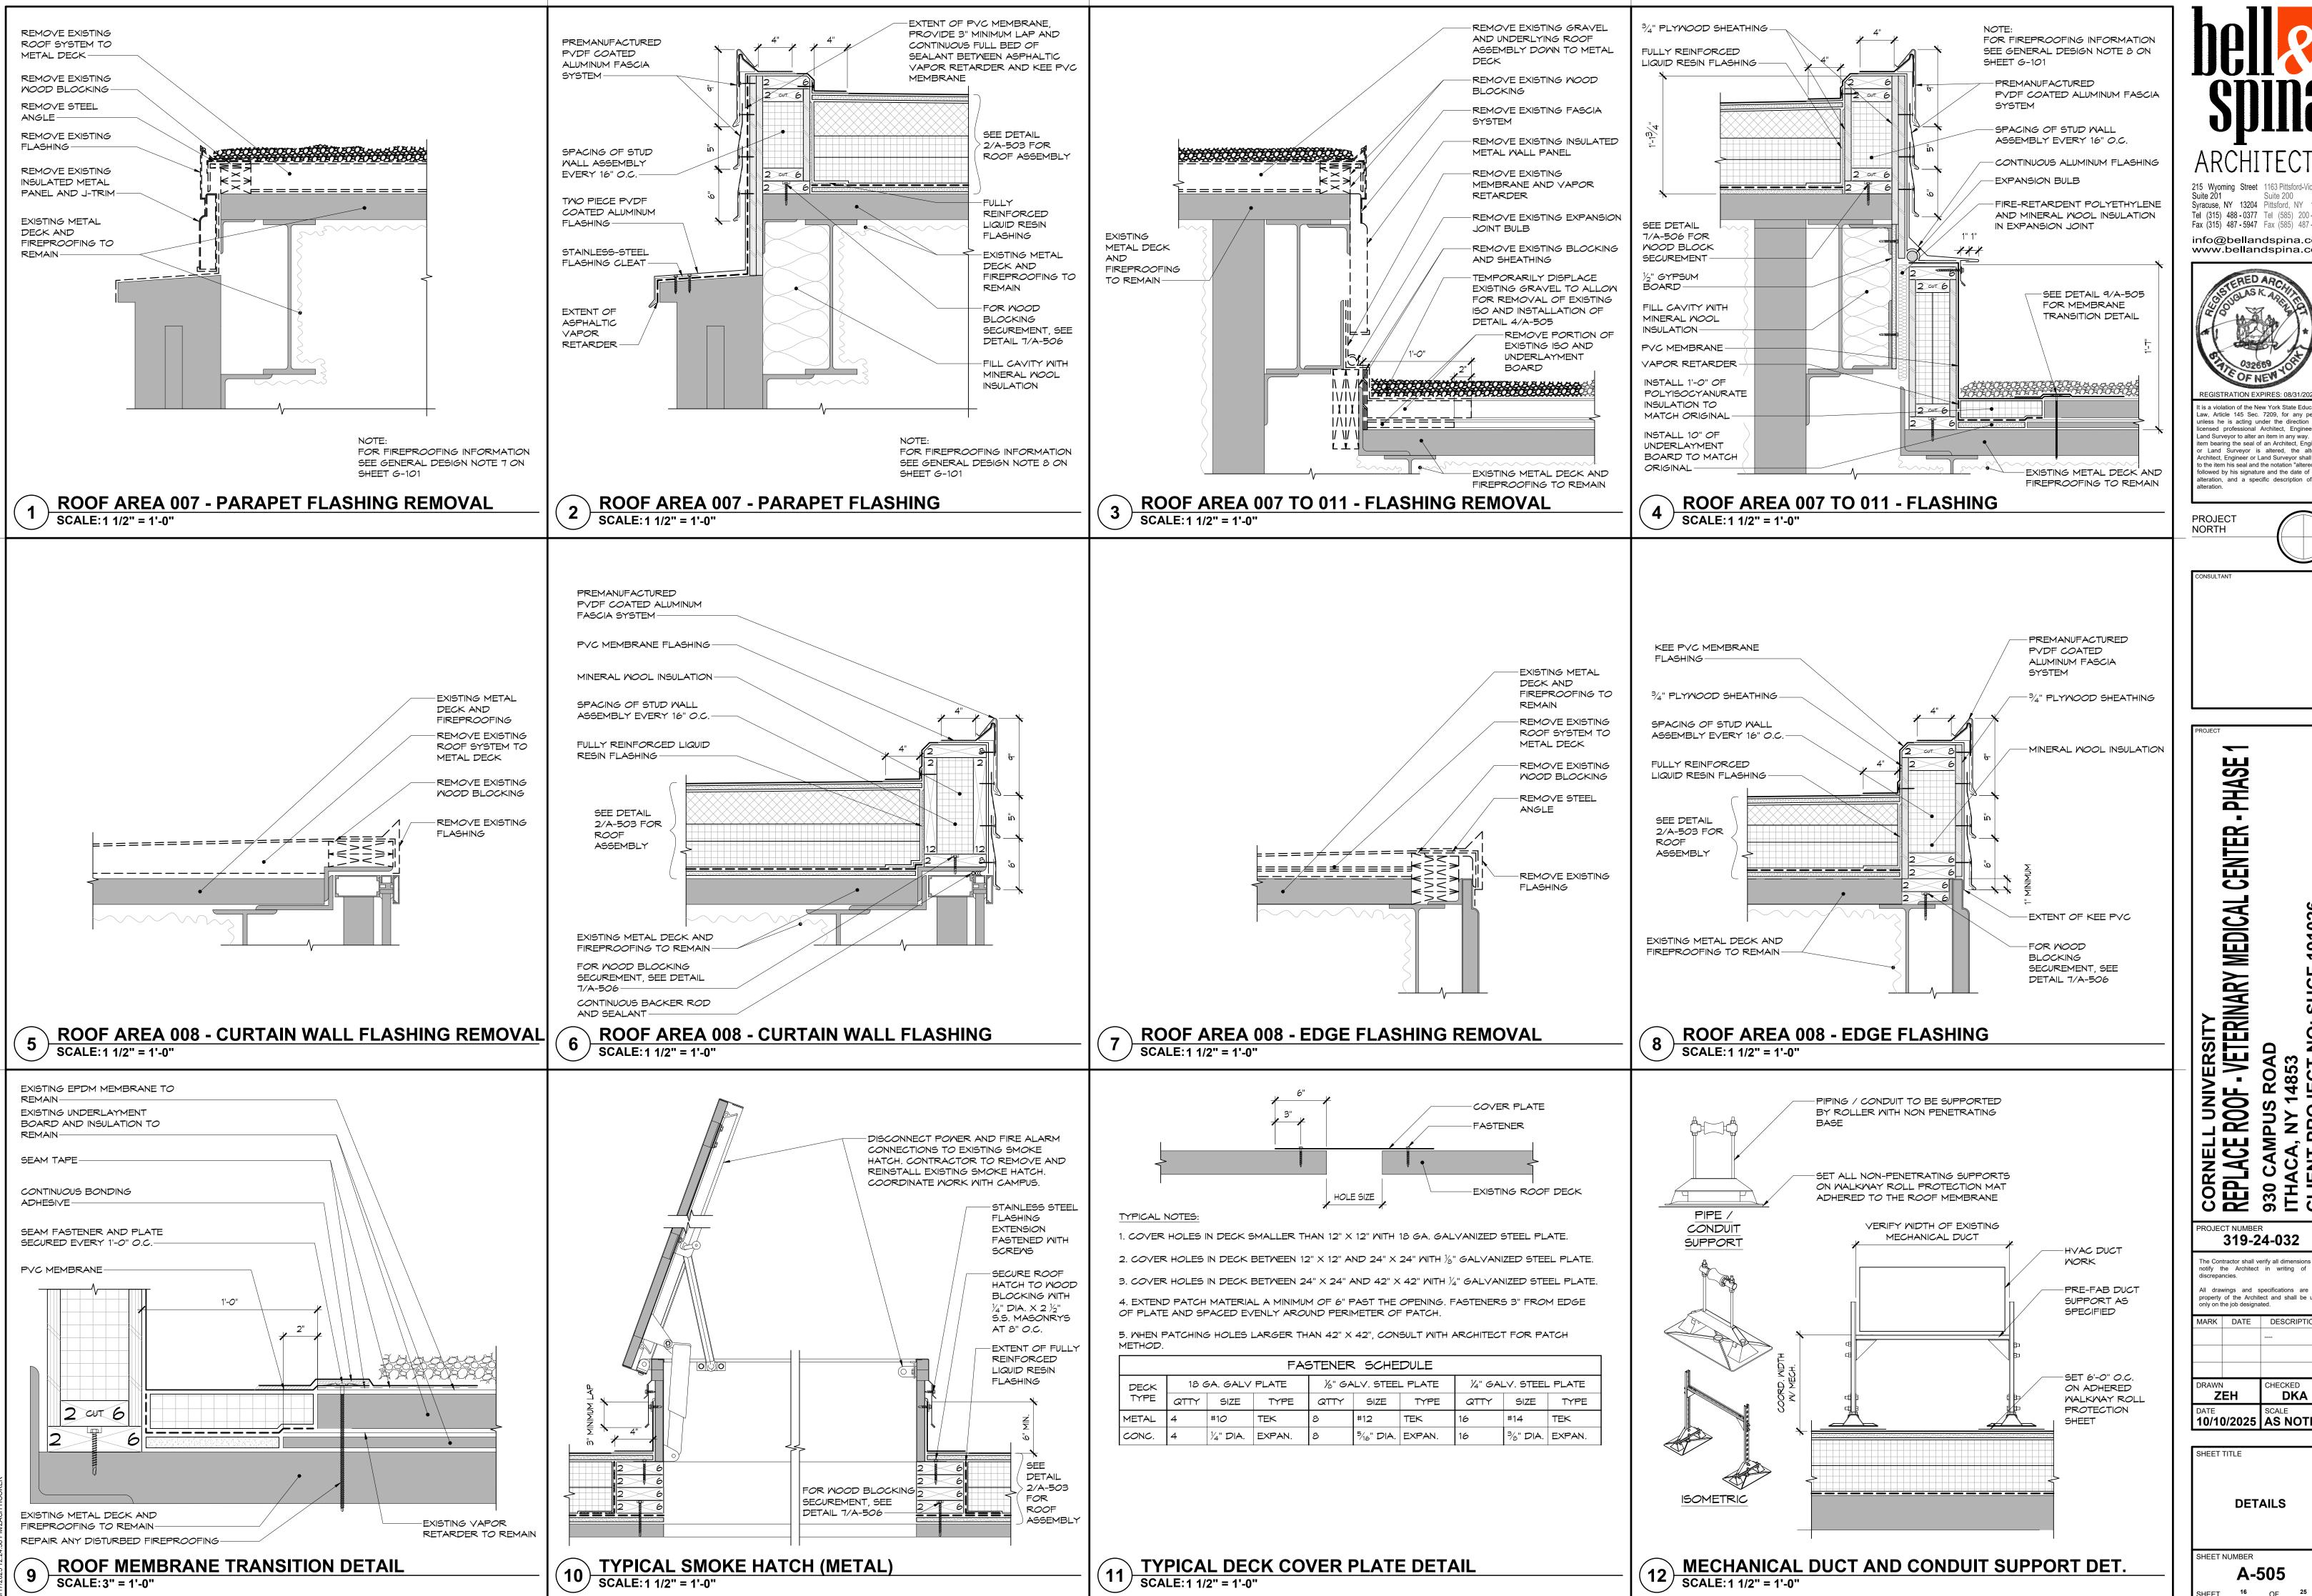

Syracuse, NY 13204 Pittsford, NY 14534 Tel (315) 488 - 0377 Tel (585) 200 - 5038 Fax (315) 487 - 5947 Fax (585) 487 - 9532

info@bellandspina.com www.bellandspina.com

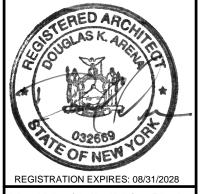

t is a violation of the New York State Education Law, Article 145 Sec. 7209, for any personal content of the New York State Educated Law, Article 145 Sec. 7209, for any personal content of the Mew York State Educated Law, Article 145 Sec. 7209, for any personal content of the New York State Educated Law, Article 145 Sec. 7209, for any personal content of the New York State Educated Law, Article 145 Sec. 7209, for any personal content of the New York State Educated Law, Article 145 Sec. 7209, for any personal content of the New York State Educated Law, Article 145 Sec. 7209, for any personal content of the New York State Educated Law, Article 145 Sec. 7209, for any personal content of the New York State Educated Law, Article 145 Sec. 7209, for any personal content of the New York State Educated Law, Article 145 Sec. 7209, for any personal content of the New York State Educated Law, Article 145 Sec. 7209, for any personal content of the New York State Educated Law, Article 145 Sec. 7209, for any personal content of the New York State Educated Law, and the New York State Educated La censed professional Architect, Engineer and Surveyor to alter an item in any way. If item bearing the seal of an Architect, Engine or Land Surveyor is altered, the alteri o the item his seal and the notation "altered b alteration, and a specific description of t

PROJECT


PHASE CENTE NIVERSITY OF - VETERINARY MEDICAL

PROJECT NUMBER 319-24-032 he Contractor shall verify all dimensions ar notify the Architect in writing of a All drawings and specifications are th property of the Architect and shall be us only on the job designated. MARK DATE DESCRIPTION

DKA 10/10/2025 AS NOTED

DETAILS

SHEET NUMBER A-505

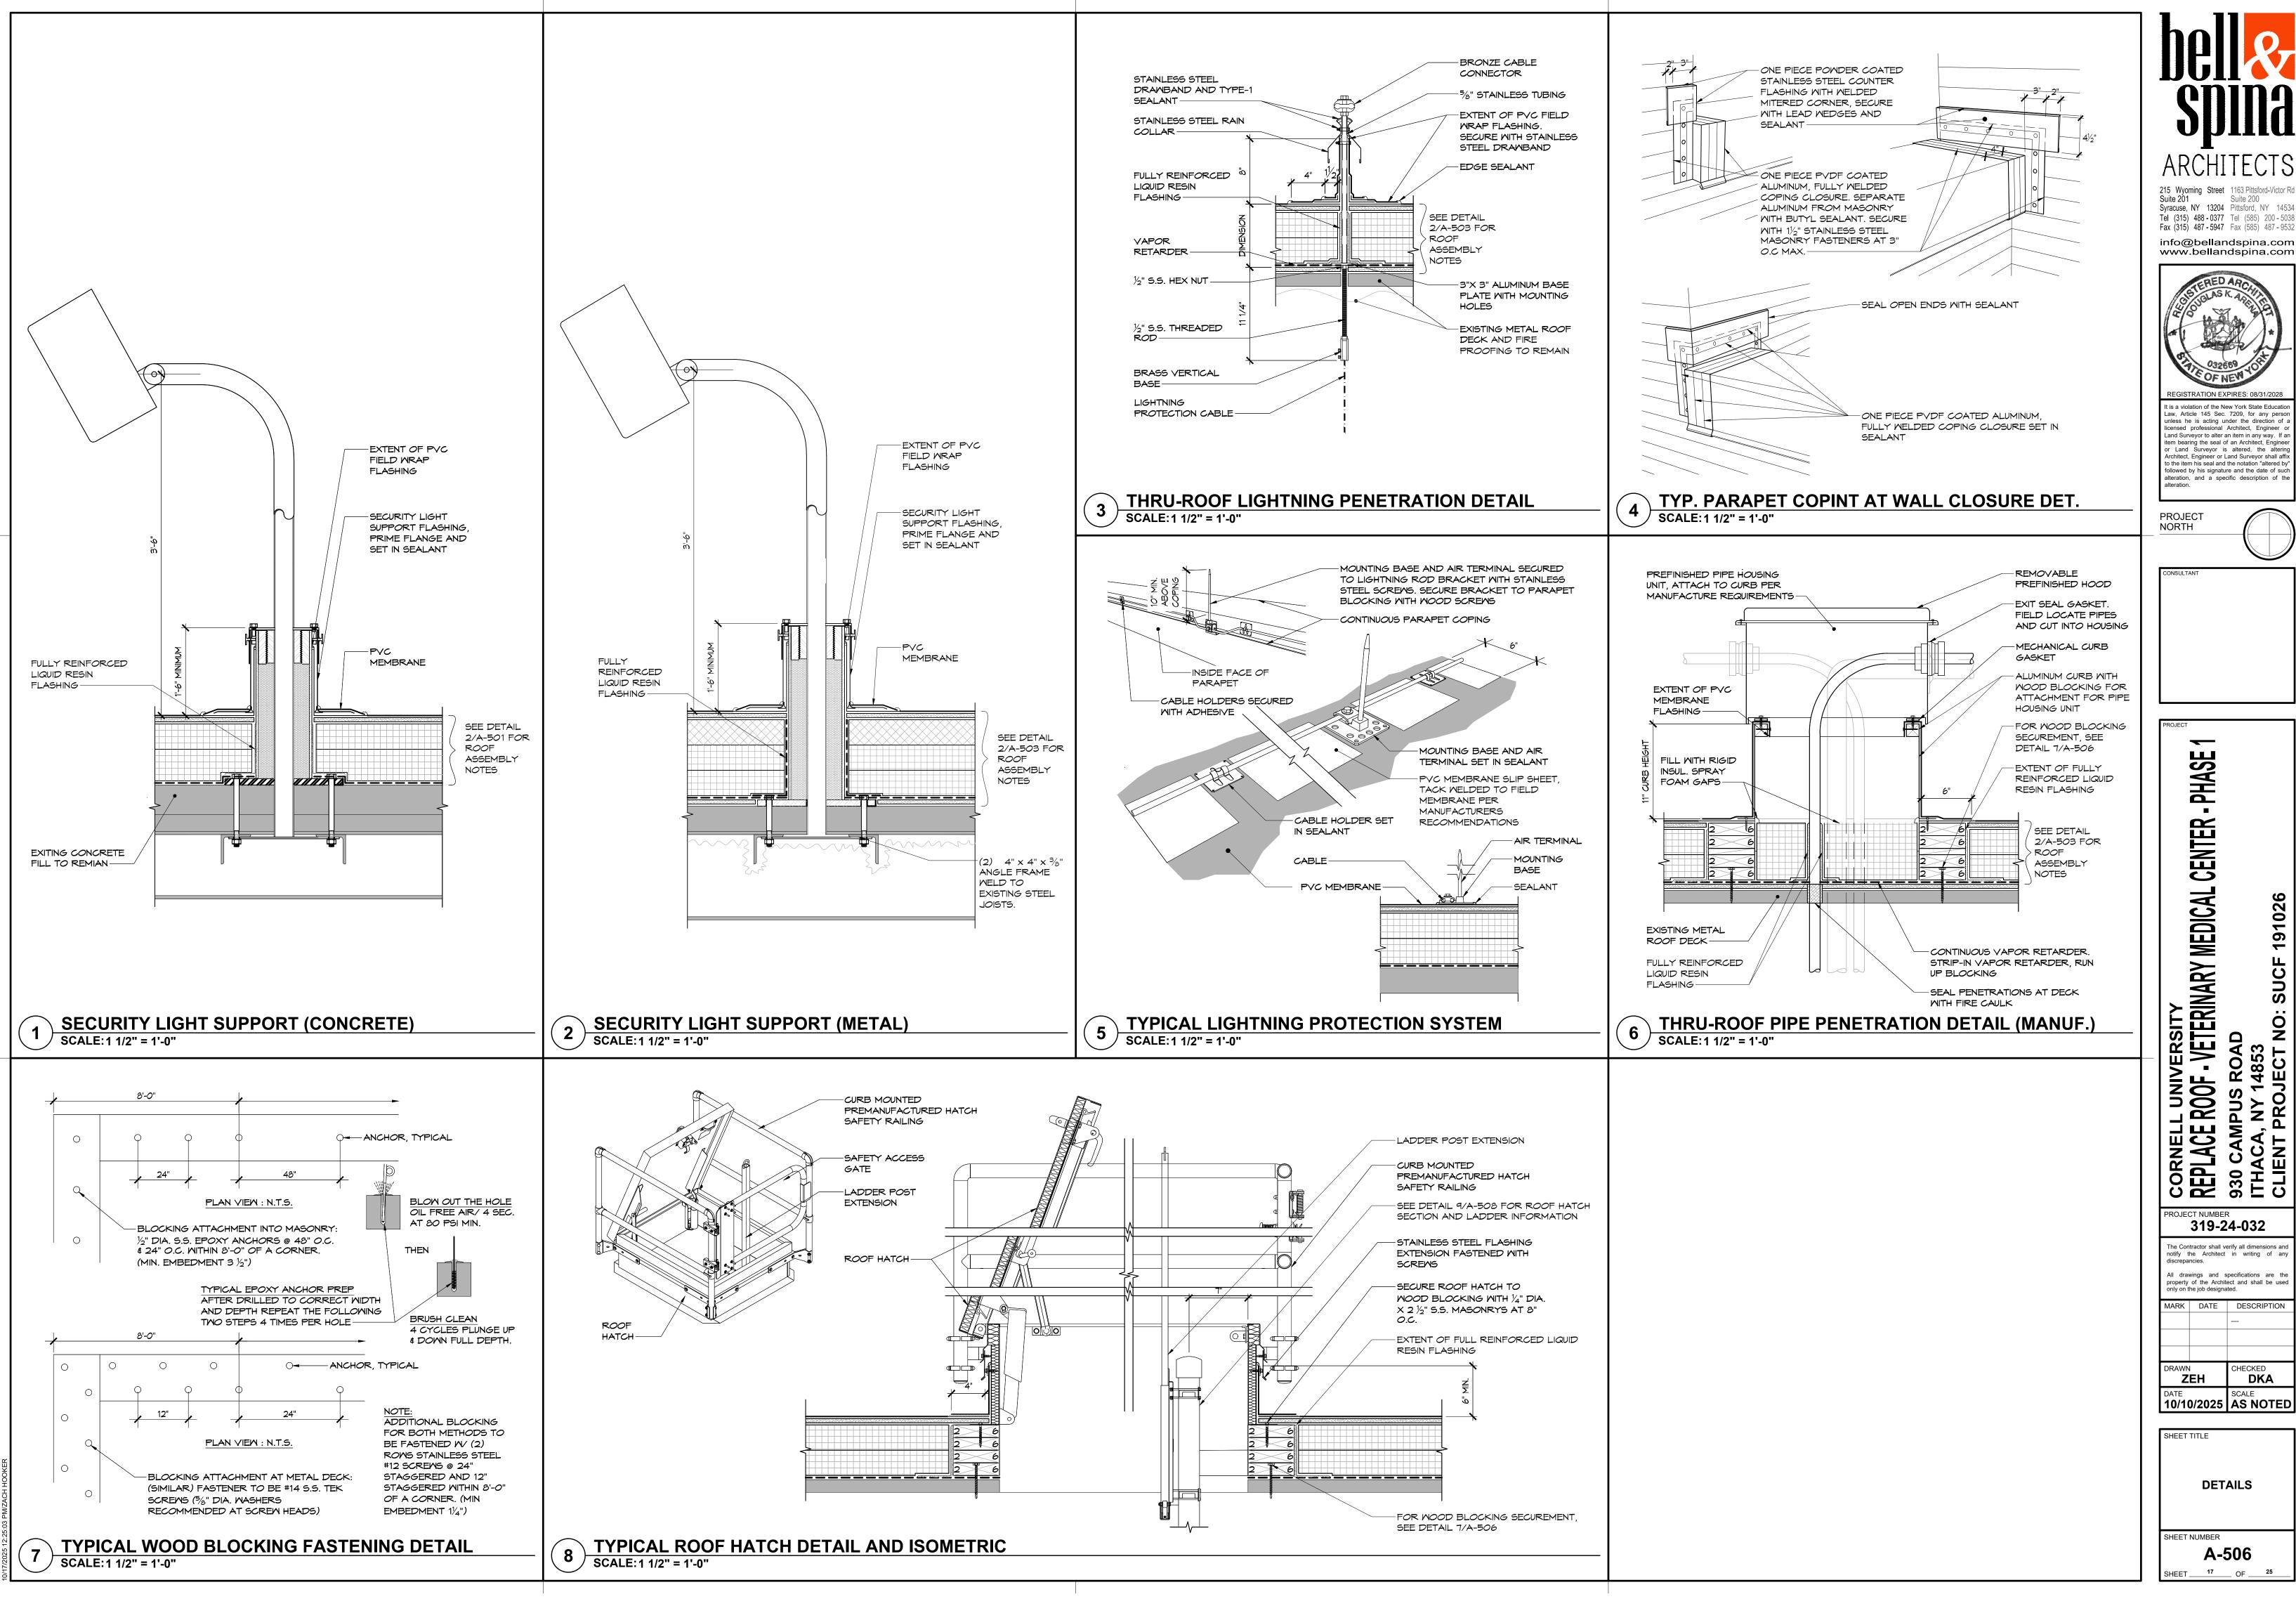

215 Wyoming Street 1163 Pittsford-Victor Rd Syracuse, NY 13204 Pittsford, NY 14534 Tel (315) 488 - 0377 Tel (585) 200 - 5038 Fax (315) 487 - 5947 Fax (585) 487 - 9532



EGISTRATION EXPIRES: 08/31/202 It is a violation of the New York State Education Law, Article 145 Sec. 7209, for any person unless he is acting under the direction of a icensed professional Architect, Engineer Land Surveyor to alter an item in any way. If item bearing the seal of an Architect, Engine or Land Surveyor is altered, the alteri Architect, Engineer or Land Surveyor shall aff to the item his seal and the notation "altered by alteration, and a specific description of the

PROJECT NORTH

PHASE CENTE L UNIVERSITY
ROOF - VETERINARY MEDICAL

CORNEL
REPLACE
930 CAN
ITHACA
CLIENT


PROJECT NUMBER 319-24-032 The Contractor shall verify all dimensions an notify the Architect in writing of a All drawings and specifications are th property of the Architect and shall be us only on the job designated. MARK DATE DESCRIPTION

CHECKED **DKA** ZEH 10/10/2025 AS NOTED SHEET TITLE

DETAILS

SHEET NUMBER A-506

SHEET ___

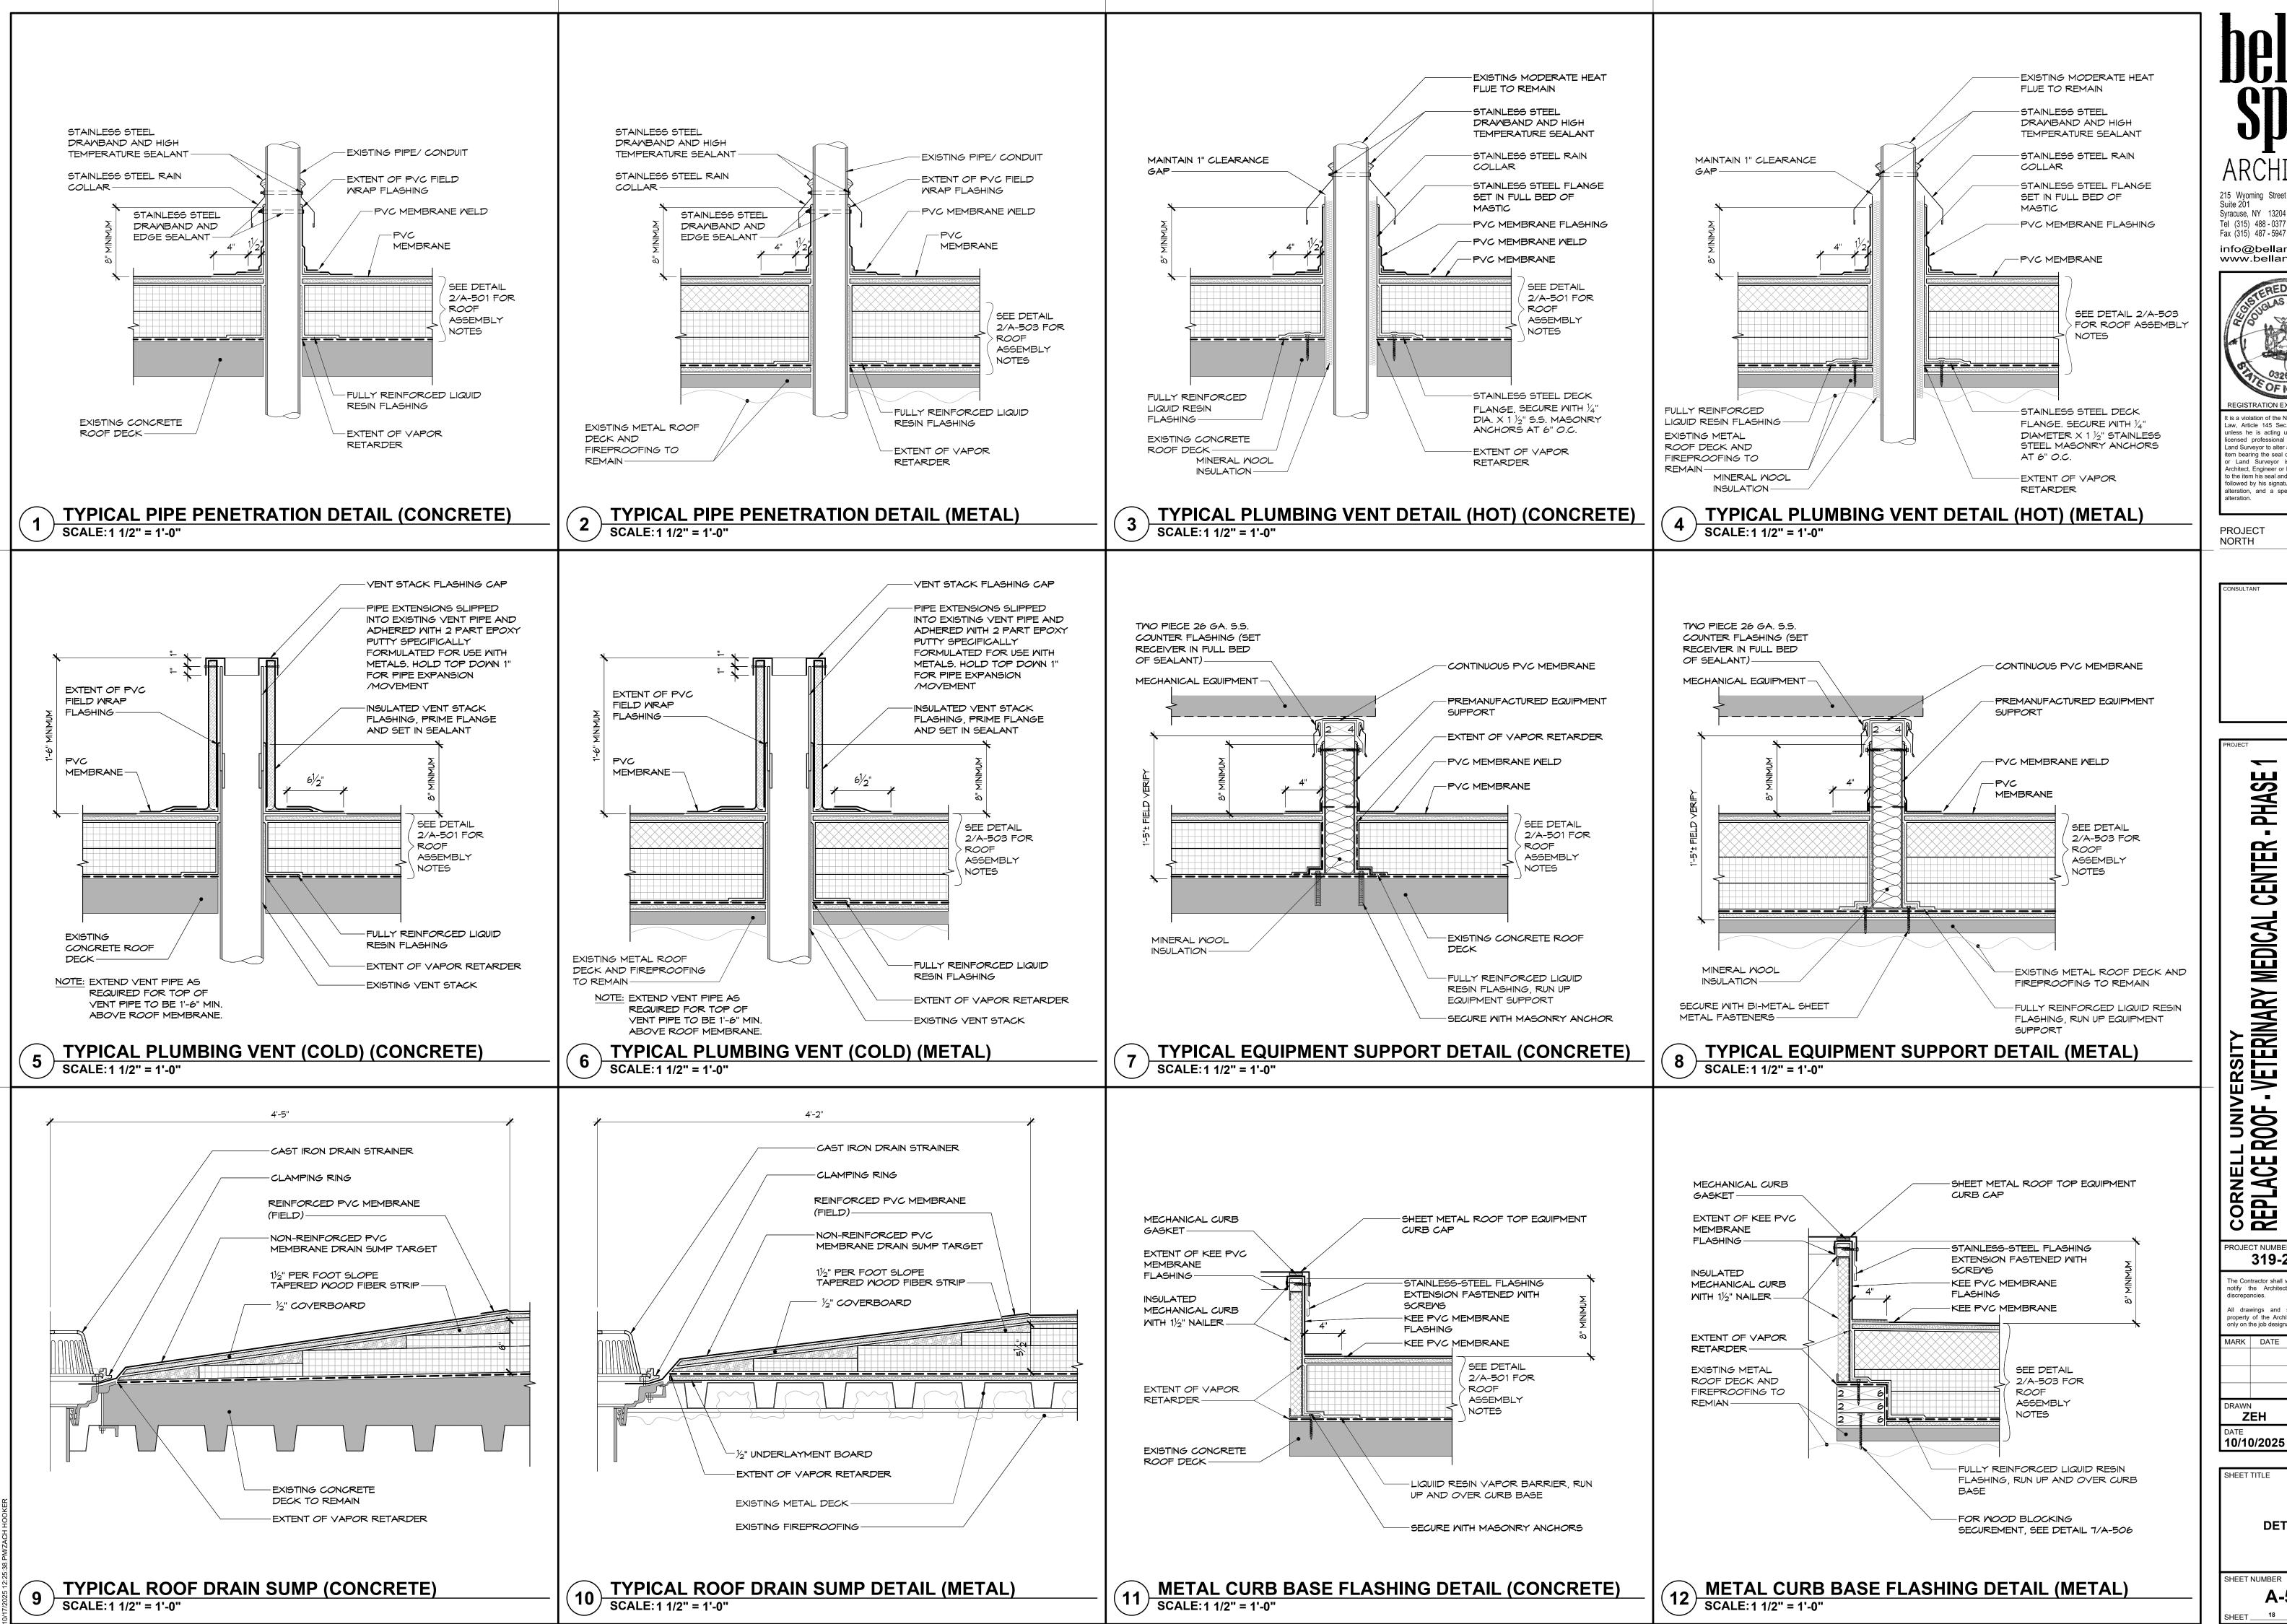

Syracuse, NY 13204 Pittsford, NY 14534 Tel (315) 488 - 0377 Tel (585) 200 - 5038 Fax (315) 487 - 5947 Fax (585) 487 - 9532

info@bellandspina.com www.bellandspina.com



It is a violation of the New York State Education Law, Article 145 Sec. 7209, for any personal unless he is acting under the direction of icensed professional Architect, Engineer Land Surveyor to alter an item in any way. If m bearing the seal of an Architect, Engine or Land Surveyor is altered, the alter to the item his seal and the notation "altered b ollowed by his signature and the date of su alteration, and a specific description of t

PROJECT

PHASE CENTE MEDICAL

CORNEL
REPLACE
930 CAN
ITHACA
CLIENT


PROJECT NUMBER 319-24-032 he Contractor shall verify all dimensions and notify the Architect in writing of a All drawings and specifications are th property of the Architect and shall be us only on the job designated. MARK DATE DESCRIPTION

ZEH DKA SCALE 10/10/2025 AS NOTED

DETAILS

A-507

SHEET NUMBER SHEET 18 OF 25

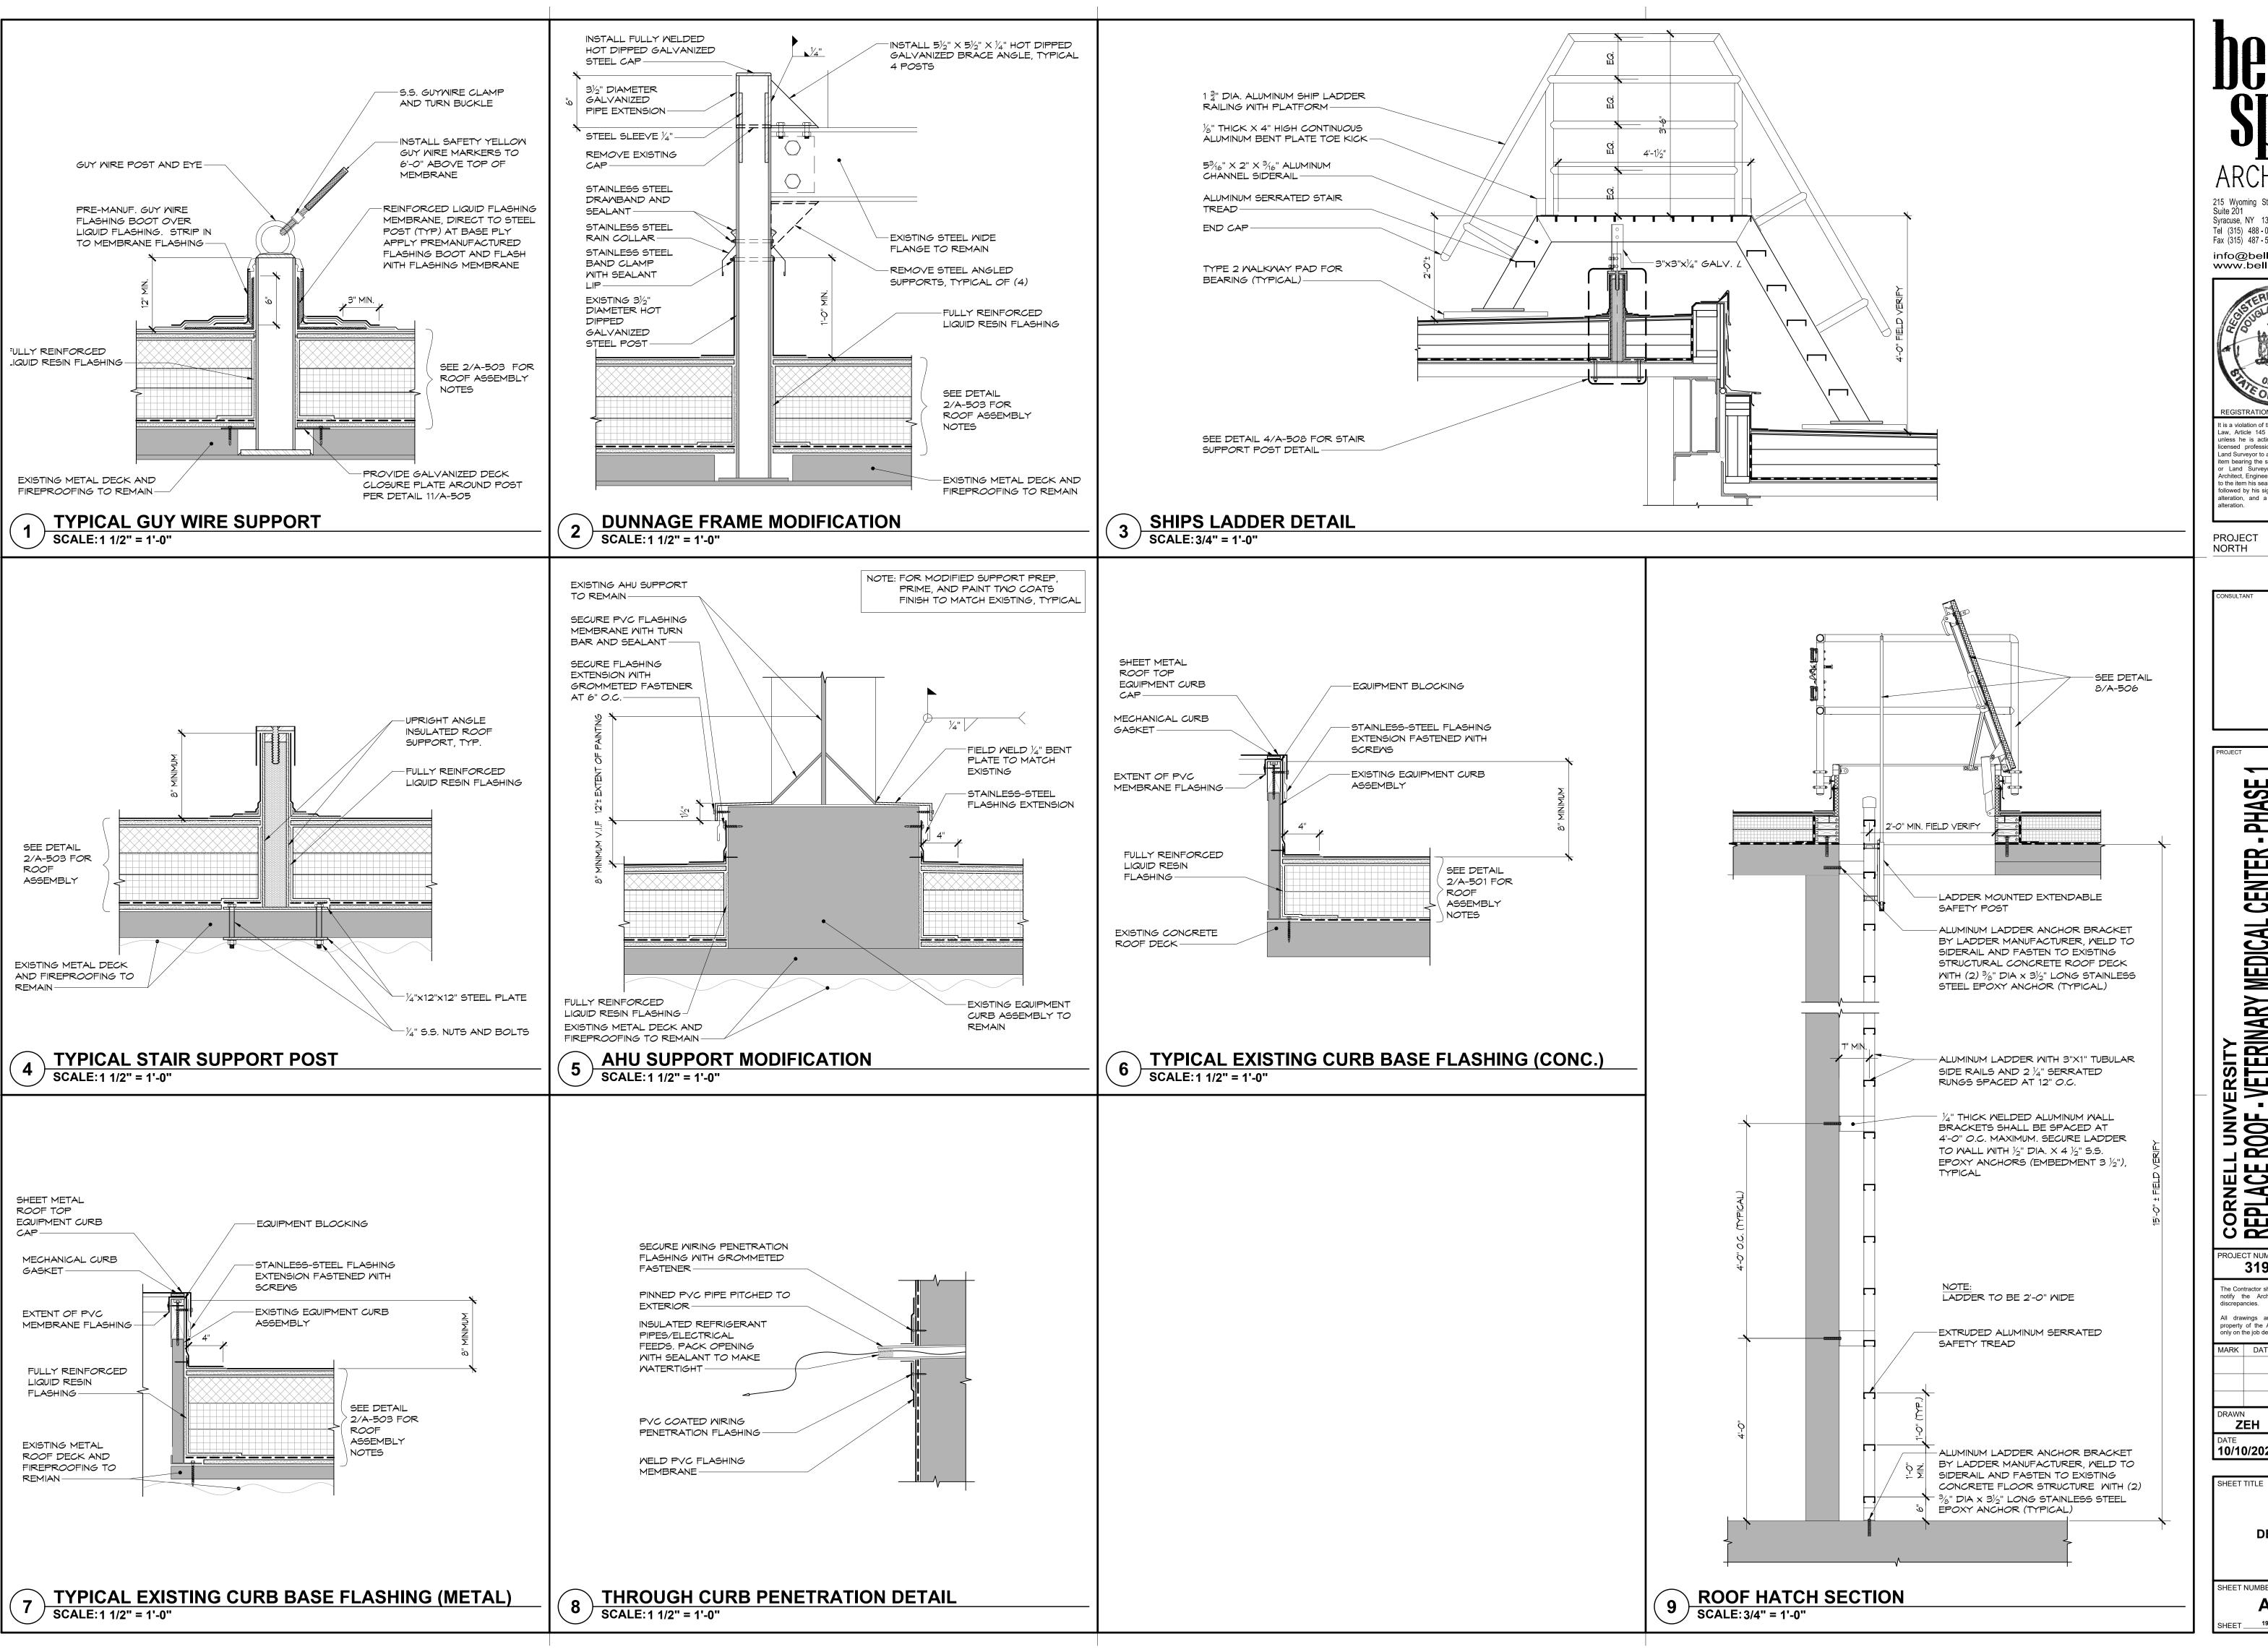


215 Wyoming Street 1163 Pittsford-Victor Rd Syracuse, NY 13204 Pittsford, NY 14534 Tel (315) 488 - 0377 Tel (585) 200 - 5038 Fax (315) 487 - 5947 Fax (585) 487 - 9532

info@bellandspina.com www.bellandspina.com



It is a violation of the New York State Education Law, Article 145 Sec. 7209, for any person unless he is acting under the direction of a licensed professional Architect, Engineer Land Surveyor to alter an item in any way. If item bearing the seal of an Architect, Engineer
or Land Surveyor is altered, the alterin Architect, Engineer or Land Surveyor shall aff to the item his seal and the notation "altered by ollowed by his signature and the date of suc alteration, and a specific description of t

PROJECT NORTH

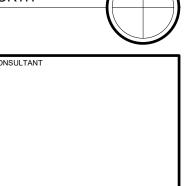

PHASE CENTE L UNIVERSITY ROOF - VETERINARY MEDICAL

CORNELL UNIVERS
REPLACE ROOF - VET
930 CAMPUS ROAD
ITHACA, NY 14853
CLIENT PROJECT N

PROJECT NUMBER 319-24-032 The Contractor shall verify all dimensions an notify the Architect in writing of ar All drawings and specifications are the property of the Architect and shall be use only on the job designated. MARK DATE DESCRIPTION

DKA ZEH SCALE 10/10/2025 AS NOTED

DETAILS

SHEET NUMBER A-508

SHEET 19 OF 25


HVAC SYMBOL LIST				
SYMBOL	DESCRIPTION			
€	POINT OF CONNECTION			
	POINT OF DISCONNECTION			
\mathbf{x}	DRAWING KEYNOTE			
MBH	THOUSAND BTU/HOUR			
NTS	NOT TO SCALE			
(E)	EXISTING			
AB	WIDTH A x DEPTH B			
	TRANSITION SQUARE TO ROUND			
DN 24x12 UP	SUPPLY DUCT TURNING UP OR DOWN			
DN 24x12 UP	RETURN DUCT TURNING UP OR DOWN			
	MITERED ELBOW WITH TURNING VANES			
—— SA ——	SUPPLY AIR			
——RA——	RETURN AIR			
cws	CHILLED WATER SUPPLY			
CWR	CHILLED WATER RETURN			
——GS——	GLYCOL SUPPLY			
——GR——	GLYCOL RETURN			
——HWS ——	HOT WATER SUPPLY			
——HWR——	HOT WATER RETURN			
LPS	LOW PRESSURE STEAM			
—— LPC ——	LOW PRESSURE CONDENSATE			
<u></u> —\►	AIR FLOW			
	ELBOW DOWN			
	ELBOW UP			

MECHANICAL GENERAL NOTES:

- A. IT IS THE RESPONSIBILITY OF THE CONTRACTOR TO DISPOSE OF ALL DEMOLITION DEBRIS AND MATERIALS OFF SITE IN A PROPER LEGAL MANNER.
- B. IT IS THE RESPONSIBILITY OF THE CONTRACTOR TO COORDINATE ALL SHUTDOWNS OF AIR HANDLING, CHILLED WATER, HOT WATER, STEAM, ETC. SYSTEMS WITH CORNELL UNIVERSITY FACILITY PERSONNEL FOR TIE-IN CONNECTIONS. ALL SHUT DOWNS WILL OCCUR DURING NIGHTS OR WEEKENDS. THE CONTRACTOR SHALL ASSIST THE UNIVERSITY PERSONNEL IN SHUTTING DOWN, DRAINING, VENTING, ETC. OF SYSTEM TO FACILITATE THE INTENDED WORK.
- C. DAMAGE TO EXISTING SYSTEMS (EQUIPMENT, PIPING, DUCTWORK, CONTROLS AND ACCESSORIES) SHOWN TO REMAIN AS A RESULT OF THE CONTRACTORS WORK IS THE RESPONSIBILITY OF THE CONTRACTOR TO REPAIR AND/OR REPLACE WITH SIMILAR OR LIKE MATERIALS AT NO ADDITIONAL COST TO THE OWNER.
- D. THE DEMOLITION DRAWINGS SHOW IN GENERAL MAJOR EQUIPMENT, PIPING AND DUCTWORK REMOVALS. THE INTENT IS NOT TO IDENTIFY ALL MISCELLANEOUS PIPING, PIPING ACCESSORIES, DUCTWORK, DUCTWORK ACCESSORIES, SUPPORTS, CONTROLS, CONTROL ACCESSORIES, CONTROL WIRING, CONDUIT, AND CONTROL PNEUMATIC TUBING AND ACCESSORIES TO BE DISCONNECTED AND REMOVED BUT IS THE REQUIREMENTS UNDER THIS CONTRACT. NO EQUIPMENT, PIPING OR DUCTWORK SHALL BE ABANDONED IN PLACE UNLESS OTHERWISE NOTED ON THE DRAWINGS.
- E. IT IS THE RESPONSIBILITY OF THE CONTRACTOR TO PATCH WITH LIKE MATERIAL AND FINISH ALL EXISTING DUCTWORK OR PIPE PENETRATIONS THROUGH THE ROOF AFTER DEMOLITION.
- EXISTING CONDITIONS ARE TAKEN FROM FIELD OBSERVATIONS AND PRIOR CONSTRUCTION DOCUMENTS AND ARE NOT GUARANTEED. THE CONTRACTOR SHALL FIELD VERIFY ALL EXISTING CONDITIONS PRIOR TO BID. NO ALLOWANCE WILL BE MADE FOR ADDITIONAL COSTS DUE TO CONTRACTORS FAILURE TO VERIFY EXISTING CONDITIONS AND DIMENSIONS.
- G. THE OWNER OCCUPIED AREAS INCLUDE SENSITIVE EQUIPMENT AND RESEARCH WHICH MUST NOT BE INTERRUPTED OR OTHERWISE DISTRUPTED WITHOUT PRIOR NOTICE AND APPROPRIATE PLANNING.
- H. ALL WORK SHALL BE COORDINATED WITH ALL TRADES INVOLVED.




215 Wyoming Street 1163 Pittsford-Victor Rd Suite 201 Suite 200
Syracuse, NY 13204 Pittsford, NY 14534 Tel (315) 488 - 0377 Tel (585) 200 - 5038 Fax (315) 487 - 5947 Fax (585) 487 - 9532 info@bellandspina.com www.bellandspina.com

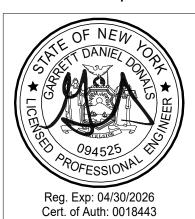

It is a violation of the New York State Education Law, Article 145 Sec. 7209, for any person unless he is acting under the direction of a licensed professional Architect, Engineer or Land Surveyor to alter an item in any way. If an item bearing the seal of an Architect, Engineer or Land Surveyor is altered, the altering Architect, Engineer or Land Surveyor shall affix to the item his seal and the notation "altered by" followed by his signature and the date of such alteration, and a specific description of the alteration.

PROJECT NORTH

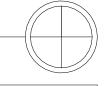



CENTER

VETERINARY MEDICAL (930 CAMPUS ROAD ITHACA, NY 14853 Client Project No: SUCF 19102

PROJECT NUMBER 191026

REPLACE

The Contractor shall verify all dimensions and notify the Architect in writing of any discrepancies.

All drawings and specifications are the property of the Architect and shall be used only on the job designated.

GDD MJW DATE SCALE

10/10/2025 NTS SHEET TITLE

GENERAL NOTES & SYMBOLS LIST -MECHANICAL

SHEET NUMBER

M-000

EXECUTION 2015 MECHANICAL DRAWING NOTES:

- 1 DISCONNECT DUCTWORK FROM EXISTING EXHAUST AIR FAN. TEMPORARILY DISCONNECT FAN FROM EXISTING ROOF
- CURB. REINSTALL EXISTING FAN AND EXISTING DUCTWORK AS REQUIRED TO ACCOMMODATE NEW ROOF.

 2 DISCONNECT DUCTWORK FROM EXISTING EXHAUST AIR FAN. TEMPORARILY DISCONNECT FAN FROM EXISTING EQUIPMENT RAILS. PROVIDE NEW EQUIPMENT RAILS, REINSTALL EXISTING FAN AND RECONNECT EXISTING DUCTWORK AS REQUIRED TO ACCOMMODATE NEW ROOF. RE-SUPPORT AND/OR EXTEND EXISTING EXTERIOR
- DUCTWORK SUPPORTS TO MEET FM GLOBAL AND WIND RESTRAINT REQUIREMENTS.


 3 HIGH PLUME DILUTION LABORATORY EXHAUST AIR FAN WILL REMAIN IN PLACE. DISCONNECT AND RAISE EXISTING GLYCOL HEAT RECOVERY PIPING AS REQUIRED TO ACCOMMODATE NEW ROOF.
- 4 EXTEND EXISTING VENT TO 24" MINIMUM ABOVE NEW ROOF. PROVIDE OMG TUBOS VENT PIPE EXTENSION OR EQUAL FOR EXISTING PVC OR CAST IRON VENTS. ALL OTHER VENT MATERIAL EXTENSIONS SHALL MATCH THE EXISTING
- MATERIAL.

 5 PROVIDE NEW TRANSITION / CURB ADAPTOR. REFER TO ARCH PLANS FOR CURB / DUCTWORK FLASHING
- REQUIREMENTS.

 6 DISCONNECT AND REINSTALL EXISTING OUTSIDE AIR INTAKE / RELIEF AIR PENTHOUSE AS REQUIRED TO
- ACCOMMODATE NEW ROOF.

 7 DISCONNECT AND RAISE EXISTING NATURAL GAS, CHILLED WATER, AND HOT WATER TO ACCOMMODATE NEW ROOF.
- 8 OFFSET EXISTING SS DUCTWORK TO ACCOMMODATE NEW ROOF CURB EXTENSION. MATCH TO EXISTING MATERIAL.
 9 DISCONNECT AND RAISE EXISTING AIR COOLED CHILLER AND ASSOCIATED DUNNAGE AS REQUIRED TO ACCOMMODATE NEW ROOF. DISCONNECT AND REINSTALL EXISTING PIPING TO ACCOMMODATE NEW ROOF CURB.
- REFER TO ARCHITECTURAL PLAN A-508 DETAIL 6 FOR FURTHER REQUIREMENTS.

 10 DISCONNECT AND EXTEND EXISTING FDV TO 36" TO 48" ABOVE NEW ROOF. EXTEND SUPPORT AS REQUIRED.
- 11 DISCONNECT AND REMOVE EXISTING POST INDICATOR VALVE. PROVIDE KENNEDY VALVE MODEL 2945 POST

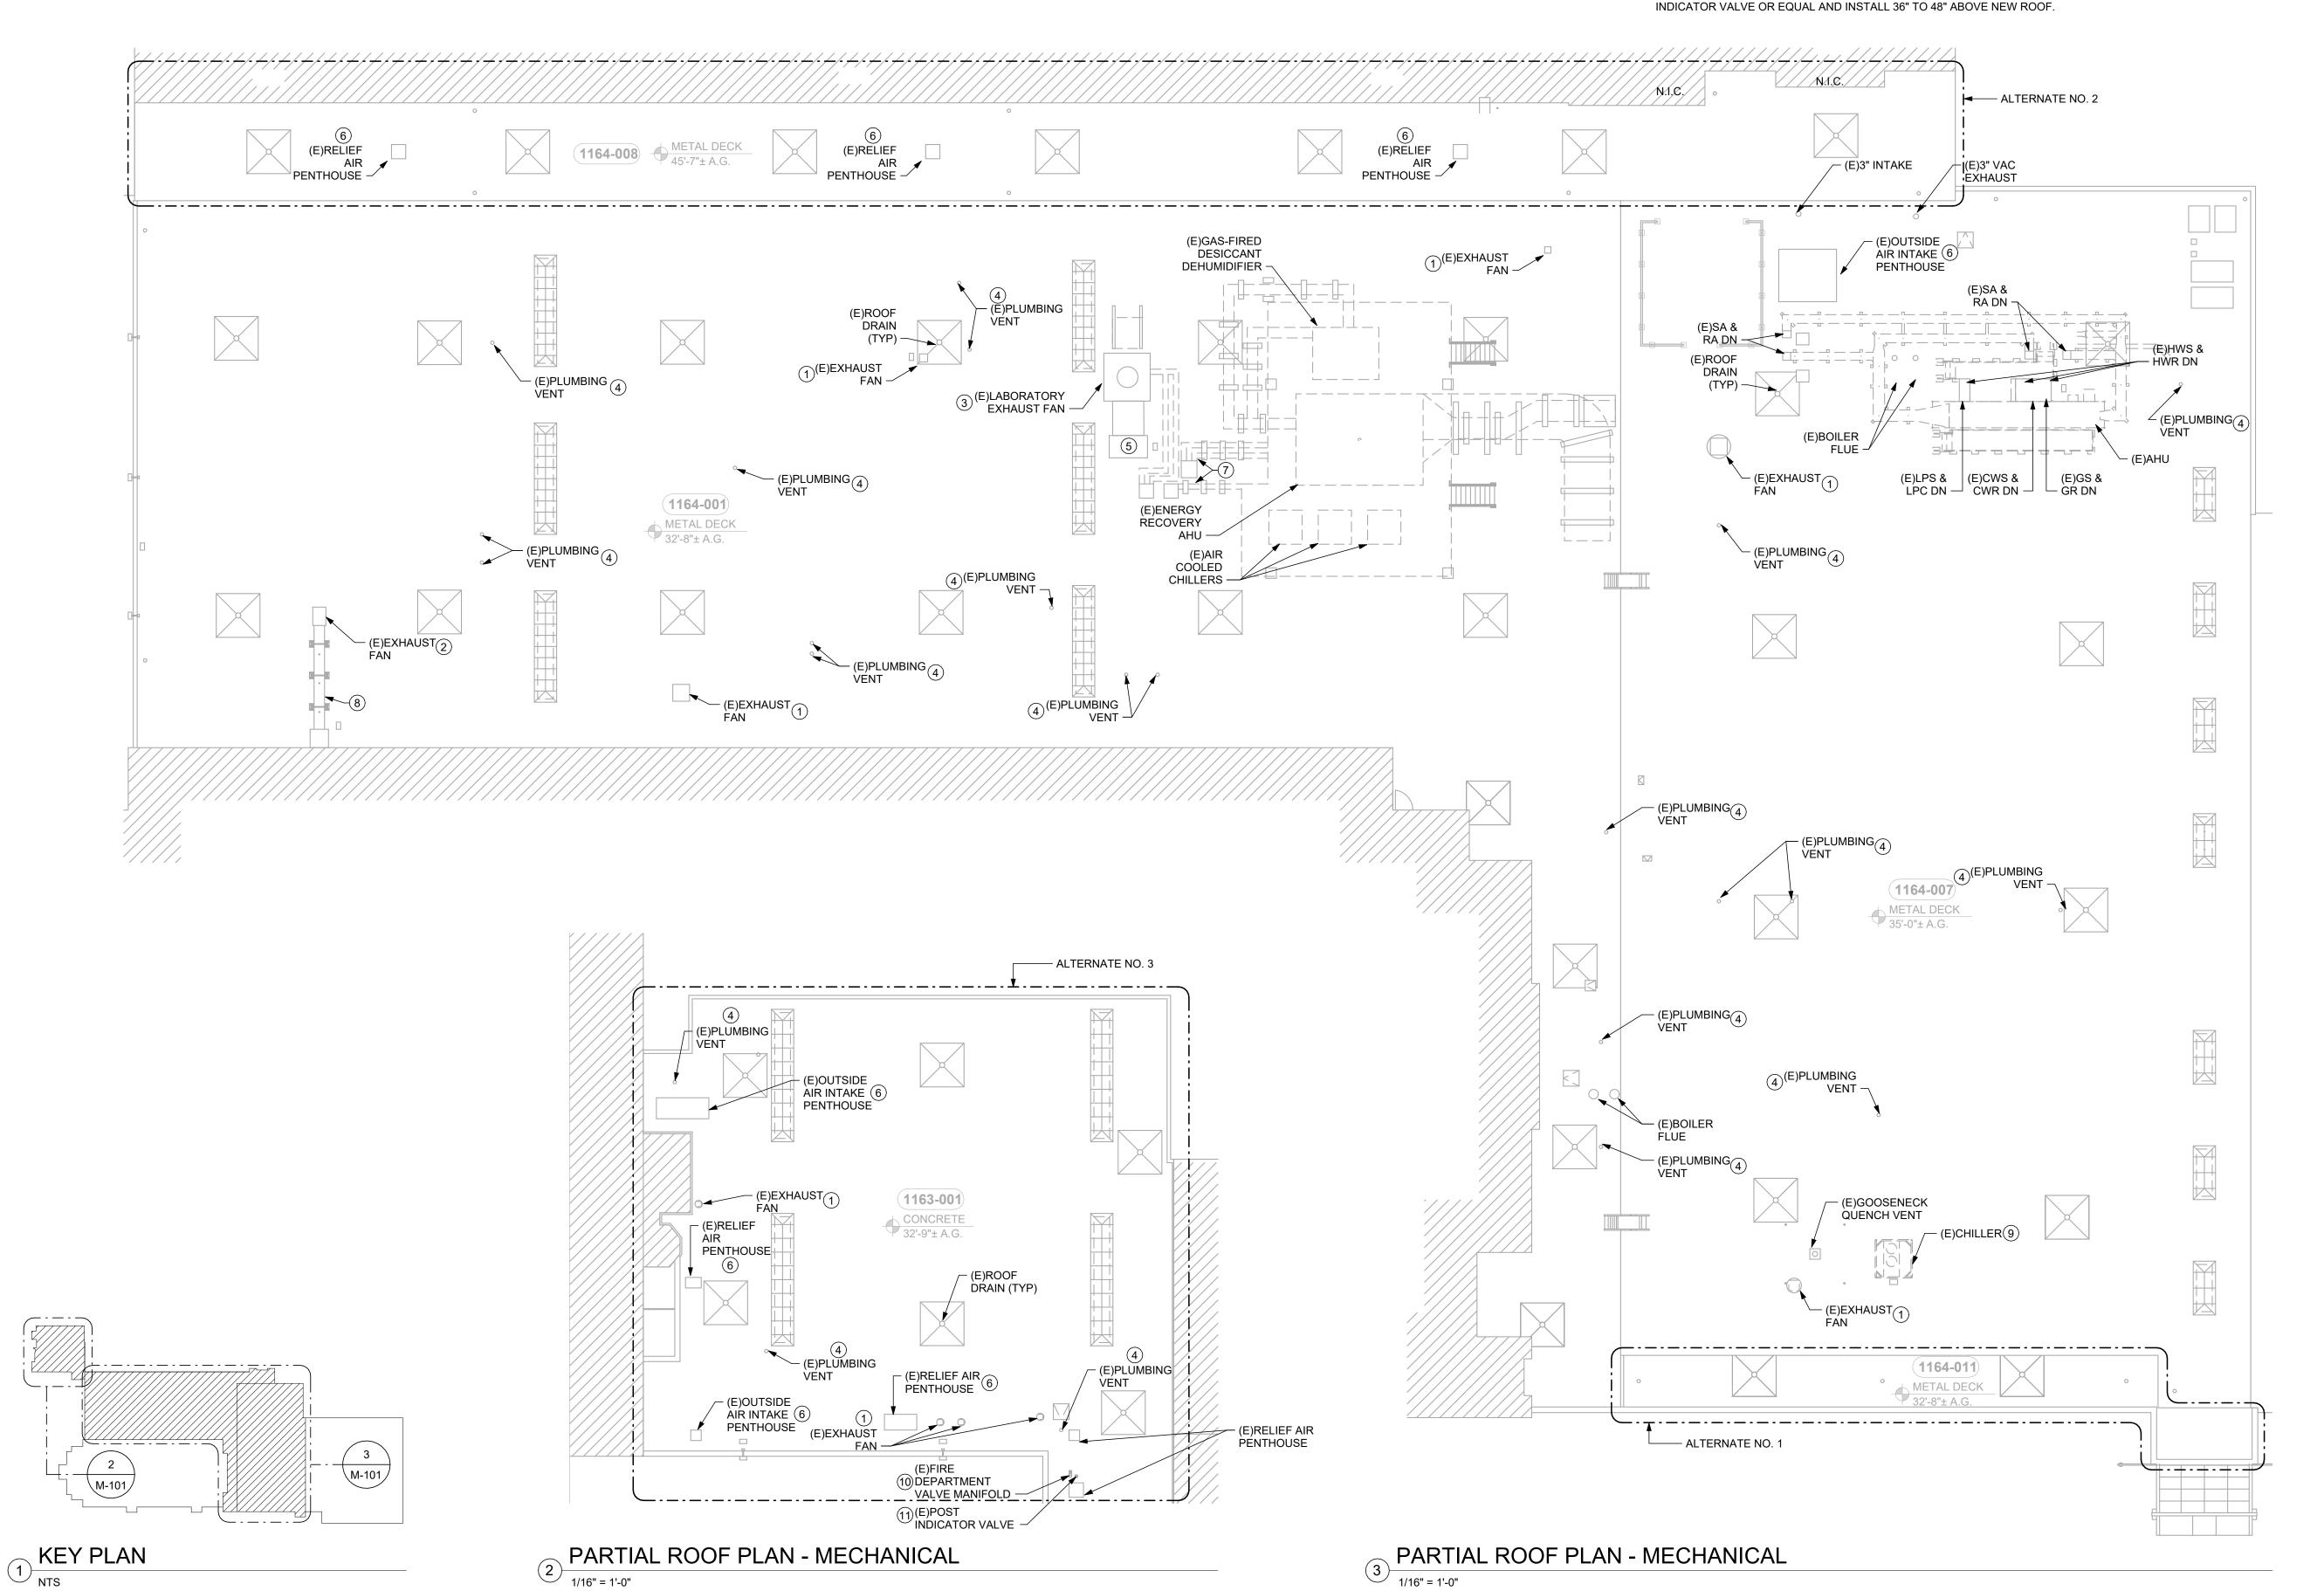



215 Wyoming Street 1163 Pittsford-Victor Rd Suite 201 Suracuse, NY 13204 Pittsford, NY 14534 Tel (315) 488 - 0377 Tel (585) 200 - 5038 Fax (315) 487 - 5947 Fax (585) 487 - 9532



Reg. Exp: 04/30/2026 Cert. of Auth: 0018443

It is a violation of the New York State Education Law, Article 145 Sec. 7209, for any person unless he is acting under the direction of a licensed professional Architect, Engineer or Land Surveyor to alter an item in any way. If an item bearing the seal of an Architect, Engineer or Land Surveyor is altered, the altering Architect, Engineer or Land Surveyor shall affix to the item his seal and the notation "altered by" followed by his signature and the date of such alteration, and a specific description of the alteration.

PROJECT NORTH

CONSULTANT

Mechanical/Electrical Engineering Consultants
Rochester | Buffalo | Syracuse | Capital District
300 TROLLEY BOULEVARD S85.288.5990
WWW.meengineering.com

PROJEC1

) ICE 191026

0 CAMPUS ROAD HACA, NY 14853 ent Project No: SUC

PROJECT NUMBER 191026

The Contractor shall verify all dimensions and notify the Architect in writing of any discrepancies.

All drawings and specifications are the

All drawings and specifications are the property of the Architect and shall be used only on the job designated.

MARK DATE DESCRIPTION

MARK DATE DESCRIPTION


DRAWN CHECKED GDD

DATE SCALE
10/10/2025 As indicated

PARTIAL ROOF
PLANS MECHANICAL

SHEET NUMBER

M-101
EET ______21 OF ___

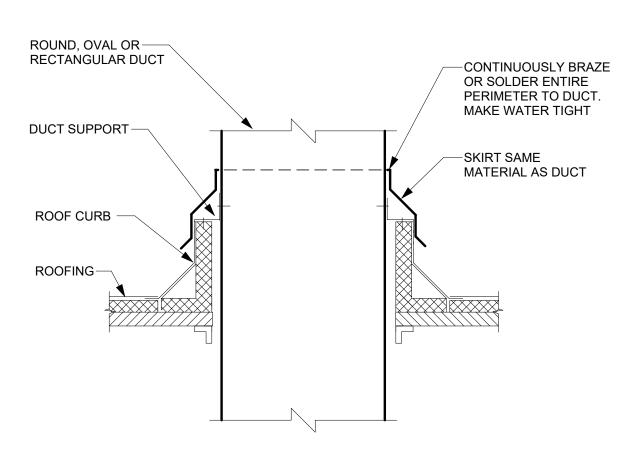

- **DETAIL NOTES:**
- A. CUT BACK INSULATION AND PROVIDE FLASHING.
- B. FURNISH, LOCATE, SET AND SECURE CURB. REFER TO ARCHITECTRUAL PLANS FOR FURTHER
- C. PROVIDE SHIMS WHERE REQUIRED TO LEVEL
- D. LENGTH OF SUPPORTS AS CALLED FOR. PROVIDE BLOCKING BENEATH SUPPORTS IN FLUTES OF METAL DECKS.
- E. PROVIDE WIND RESTRAINT PER SPECIFICATION SECTION 230550-WIND RESTRAINT FOR HVAC

DUCT PENETRATION CURB DETAIL


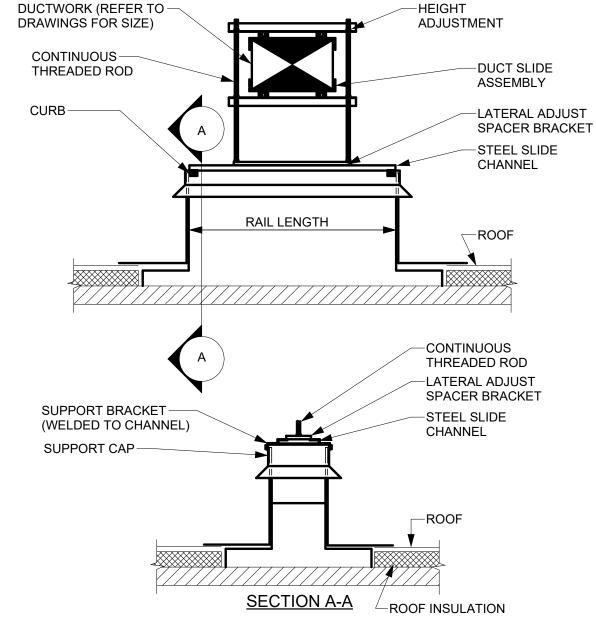


CHART
EQUIPMENT RAIL LENGTH
2'-0"
3'-0"
4'-0"
5'-0"
6'-0"
7'-0"
8'-0"

- DETAIL NOTES:
- A. CUT BACK INSULATION AND PROVIDE FLASHING.
- B. FURNISH, LOCATE, SET AND SECURE CURB. REFER TO ARCHITECTURAL PLANS FOR FURTHER REQUIREMENTS.
- . PROVIDE SHIMS WHERE REQUIRED TO LEVEL
- D. LENGTH OF SUPPORTS AS CALLED FOR. PROVIDE BLOCKING BENEATH SUPPORTS IN FLUTES OF METAL DECKS.
- E. PROVIDE WIND RESTRAINT PER SPECIFICATION SECTION 230550-WIND RESTRAINT FOR HVAC


DUCTWORK SUPPORT DETAIL

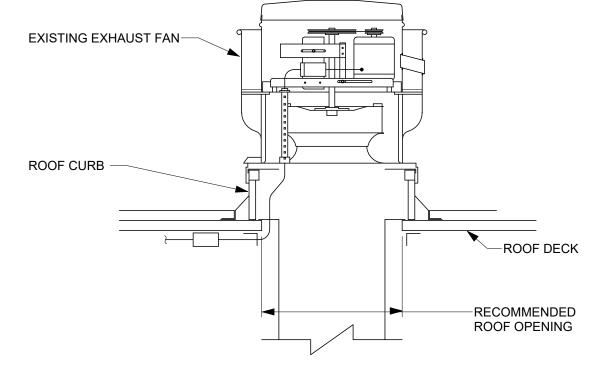

DETAIL NOTES:

- A. REFER TO ARCHITECTURAL PLANS FOR ROOF CURB DETAIL.
- B. NON-GREASE DUCT.
- C. PROVIDE WIND RESTRAINT PER SPECIFICATION SECTION 230550-WIND RESTRAINT FOR HVAC SYSTEMS

UPBLAST EXHAUST FAN DETAIL

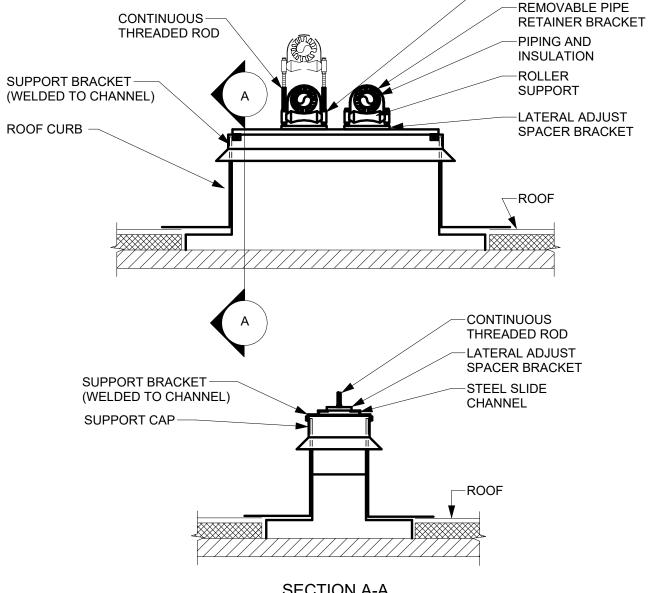

-HEIGHT ADJUSTMENT

SECTION A-A

- **DETAIL NOTES:**
- A. CUT BACK INSULATION AND PROVIDE FLASHING.
- B. FURNISH, LOCATE, SET AND SECURE CURB. REFER TO ARCHITECTURAL PLANS FOR FURTHER REQUIREMENTS.
- C. PROVIDE SHIMS WHERE REQUIRED TO LEVEL SUPPORT.
- D. LENGTH OF SUPPORTS AS CALLED FOR. PROVIDE BLOCKING BENEATH SUPPORTS IN FLUTES OF METAL DECKS.
- E. PROVIDE WIND RESTRAINT PER SPECIFICATION SECTION 230550-WIND RESTRAINT FOR HVAC

PIPE SUPPORT DETAIL


PIPING OR CONDUIT EXIT SIDE OF **CURB ONLY** SEAL WITH EPDM OR -PREMANUFACTURED PIPE CURB ROOF-SLEEVE-FILL WITH INSULATION-AND SEAL WITH WATERPROOF SEALING

DETAIL NOTES:

ELEMENT

- A. CUT BACK INSULATION AND PROVIDE FLASHING.
- B. FURNISH, LOCATE, SET AND SECURE CURB. REFER TO ARCHITECTURAL PLANS FOR FURTHER REQUIREMENTS.
- C. PROVIDE SHIMS WHERE REQUIRED TO LEVEL SUPPORT.
- D. PROVIDE WIND RESTRAINT PER SPECIFICATION SECTION 230550-WIND RESTRAINT FOR HVAC SYSTEMS.

5 PIPE CURB DETAIL - SIDE-ENTRY

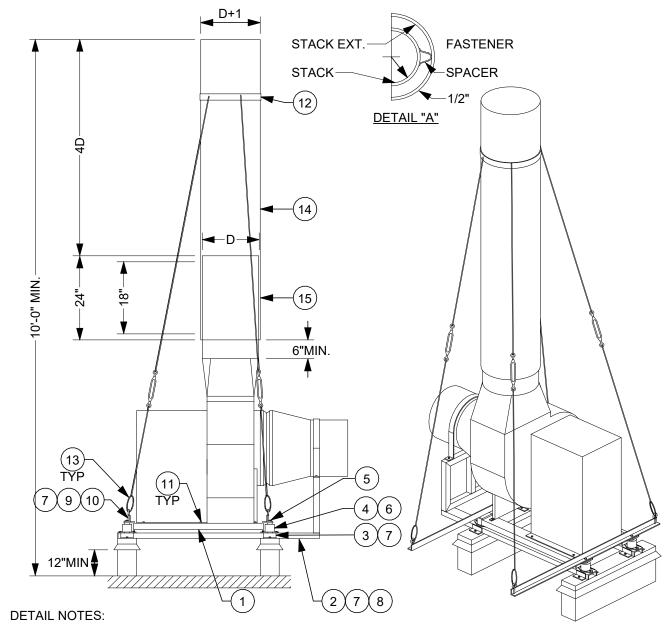

A. PROVIDE RAIL FLASHING.

B. LOCATE, SET AND SECURE CURB.

- C. PROVIDE SHIMS WHERE REQUIRED TO LEVEL SUPPORT.
- D. LENGTH OF SUPPORTS AS CALLED FOR. PROVIDE BLOCKING BENEATH SUPPORTS IN FLUTES OF METAL DECKS.
- E. MEDIUM STRENGTH THREADLOCKER (LOCTITE BRAND 242, OR EQUAL) SHALL BE APPLIED TO ALL BOLTS AND NUTS PRIOR TO FINAL ASSEMBLY.
- F. PROVIDE WIND RESTRAINT PER SPECIFICATION SECTION 230550-WIND RESTRAINT FOR HVAC SYSTEMS.

ROOF MOUNTED FAN SUPPORT DETAIL

KEYED NOTES:

- (1) ISOLATION RAIL FURNISHED WITH THE EXHAUST FAN.
- (2) BASE RAIL. VERIFY ACTUAL BASE RAIL LENGTH. BASE RAIL SHALL BE "C" CHANNEL EQUIVALENT IN STRENGTH TO THE ISOLATION RAIL.
- (3) PROVIDE 4" LONG PIECES OF ANGLE IRON FOR THE MOUNTING BRACKETS TO FASTEN THE BASE RAIL TO THE EQUIPMENT SUPPORT RAILS. THE MOUNTING BRACKETS SHALL BE 4" LONG, 1 1/4"x1 1/4"x3/8" ANGLE IRON. WELD BRACKET TO THE NEW BASE RAIL "C" CHANNEL. FASTEN THE MOUNTING BRACKET TO THE CURB SUPPORT RAIL USING A SAE GRADE 8 BOLT AND (1) SAE GRADE 8 FLAT WASHER BETWEEN THE BOLT HEAD AND THE BRACKET PER BRACKET. THERE ARE A TOTAL OF (4) BRACKETS PER BASE RAIL.
- (4) FAIL-SAFE CAPTIVE DESIGN NEOPRENE-IN-SHEAR VIBRATION ISOLATOR. VERIFY ISOLATOR LOADING REQUIREMENTS. A TOTAL OF (4) ISOLATORS PER FAN ARE REQUIRED.
- (5) FASTEN VIBRATION ISOLATOR TO THE ISOLATION RAIL WITH SAE GRADE 8 BOLTS. BOLT SHALL BE LONG ENOUGH TO PASS THROUGH THE OUTRIGGER ANGLE IRON AND THE ISOLATION RAIL. PROVIDE A SAE GRADE 8 FLAT WASHER BETWEEN THE BOLT HEAD AND THE OUTRIGGER ANGLE
- (6) FASTEN VIBRATION ISOLATOR TO BASE RAIL WITH SAE GRADE 8 BOLTS. PROVIDE (1) SAE GRADE 8 FLAT WASHER BETWEEN THE BOLT HEAD ANF THE ISOLATOR BASE AND (1) SAE GRADE 8 FLAT WASHER BETWEEN THE NUT AND BASE RAIL.
- (7) PAINT ALL RAW EXPOSED METAL ITEMS ASSOCIATED WITH THE NEW EXHAUST FANS WITH TWO PRIMER COATS AND TWO FINAL PAINT COATS OF EXTERIOR RUST RESISTANT PAINT. PAINT SHALL MATCH EXHAUST FAN COLOR.
- (8) NEW BASE RAILS SHALL EXTEND A MINIMUM OF 1'-0" PAST THE CURB SUPPORT RAIL TO PROVIDE A MOUNTING SURFACE FOR THE DUCTWORK SUPPORT AND THE FAN INLET.
- (9) PROVIDE 1 1/4"x1 1/4"x3/8" ANGLE IRON FOR THE OUTRIGGER FRAME. THE OUTRIGGER FRAME MEMBER SHALL BE A MINIMUM OF 6'-0" IN LENGTH. THE OUTRIGGER ANGLE IRON SHALL BE FULLY WELDED TO THE ISOLATION RAILS. PROVIDE A HOLE IN THE ANGLE IRON TO ALLOW THE ISOLATION RAILS TO BE ATTACHED TO THE VIBRATION ISOLATORS. THE HOLES SHALL BE LARGE ENOUGH TO ACCOMMODATE THE VIBRATION ISOLATOR BOLT. THE CENTERLINE OF THE OUTRIGGER FRAME SHALL CORRESPOND TO THE CENTERLINE OF THE EXHAUST STACK. OUTRIGGER FRAME SHALL EXTEND TO MAINTAIN 3" CLEARANCE BETWEEN FAN AND GUY WIRE.
- (10) WELD A 3/8" SAE GRADE 8 EYE BOLT TO THE END OF THE OUTRIGGER FRAME TO ALLOW THE ATTACHMENT OF THE GUY WIRE.
- (11) FASTEN THE EXHAUST FAN TO THE ISOLATION RAIL BY USING SAE GRADE 8 BOLTS. PROVIDE A SAE GRADE 8 FLAT WASHER BETWEEN THE BOLT HEAD AND THE EXHAUST FAN AND A SAE GRADE 8 FLAT WASHER BETWEEN THE NUT AND THE ISOLATION RAIL. ALIGN EXHAUST FAN WITH THE MOUNTING HOLES IN THE ISOLATION RAILS.
- (12) EXHAUST STACK EXTENSION WITH 1 1/4"x1 1/4"x 1/4" ANGLE RING FOR GUY WIRE ATTACHMENT
- (13) LOOP GUY WIRE THROUGH THE EYE BOLT ON THE OUTRIGGER FRAME. PROVIDE A CRIMP CONNECTOR TO ATTACH THE LOOSE END OF THE GUY WIRE TO THE GUY WIRE THAT IS CONNECTED TO THE TURNBUCKLE.
- (14) STACK EXTENSION SHALL BE CONSTRUCTED OF SAME MATERIAL AND TWO (2) GAUGES HEAVIER THAN CALLED FOR IN SPECIFICATIONS.
- (15) PROVIDE A MINIMUM OF THREE (3) SPACERS FOR DUCTS 6" DIA. OR LESS; FIVE (5) SPACERS FOR 8" DIA. AND LARGER. REFER TO DETAIL "A".

Suite 200 Syracuse, NY 13204 Pittsford, NY 14534 Tel (315) 488 - 0377 Tel (585) 200 - 5038 Fax (315) 487 - 5947 Fax (585) 487 - 9532 info@bellandspina.com



Cert. of Auth: 0018443 It is a violation of the New York State Education Law, Article 145 Sec. 7209, for any person unless he is acting under the direction of a licensed professional Architect, Engineer or Land Surveyor to alter an item in any way
If an item bearing the seal of an Architect, Engineer or Land Surveyor is altered, the altering Architect, Engineer or Land Surveyo shall affix to the item his seal and the notation "altered by" followed by his signature and the date of such alteration, and a specific description of the alteration.

PROJECT NORTH

ME ENGINEERING Mechanical/Electrical Engineering Consultants Rochester | Buffalo | Syracuse | Capital District

PROJECT NUMBER 191026

notify the Architect in writing of any All drawings and specifications are the property of the Architect and shall be used

The Contractor shall verify all dimensions and

only on the job designated.

CHECKED MJW GDD SCALE

SHEET TITLE **DETAILS** -

MECHANICAL

10/10/2025 NTS

SHEET NUMBER

SHEET ______ OF ______ 25

	ABBREVIATIONS	ABBREVIATIONS		
ABBREV.	DESCRIPTION	ABBREV.	DESCRIPTION	
A.F.F.	ABOVE FINISHED FLOOR	LTG.	LIGHTING	
A.F.G.	ABOVE FINISHED GRADE	M.C.B.	MAIN CIRCUIT BREAKER	
Α.	AMPERE	M.L.O.	MAIN LUG ONLY	
AUTO.	AUTOMATIC	MICRO	MICROWAVE	
BSMT.	BASEMENT	N.I.C	NOT IN CONTRACT	
BKR.	BREAKER	NL	NIGHT LIGHT	
CLG.	CEILING	PNL.	PANEL	
CONTR.	CONTRACTOR	PH.	PHASE	
CONT.	CONTACTOR	P.C.	PLUMBING CONTRACTOR	
С	CAMERA, CONDUIT	PV	POWER VENTILATOR	
DP	DISTRIBUTION PANEL	P.	POLE	
DN.	DOWN	REFRIG.	REFRIGERATOR	
EA.	EACH	SP.	SPACE	
ELEC.	ELECTRIC	SPEC.	SPECIFICATION	
EMERG.	EMERGENCY	SW.	SWITCH	
EM.	EMERGENCY	TV	TELEVISION	
EWC	ELECTRIC WATER COOLER	T.B.B.	TELEPHONE BACKBOARD	
EXIST.	EXISTING	T.T.C.	TELEPHONE TERMINAL CABINET	
F.A.	FIRE ALARM	TYP.	TYPICAL	
F.A.C.P.	FIRE ALARM CONTROL PANEL	U.L.	UNDERWRITER'S LABORATORY	
F.A.T.C.	FIRE ALARM TERMINAL CABINET	V.	VOLT	
FCU	FAN COIL UNIT	WP	WEATHERPROOF	
FZ (3)	FIRE ZONE (3)	4 W.	WIRE	
GRS.	GALVANIZED RIGID STEEL	3P.15A.	P = POLE A = AMPERE	
GND.	GROUND	ос	MOUNTED OVER COUNTER HEIGHT	
G.C.	GENERAL CONTRACTOR	UC	MOUNTED UNDER COUNTER HEIGHT	
GEN.	GENERATOR	UV	UNIT VENTILATOR	
G.F.C.I.	GROUND FAULT CIRCUIT INTERRUPTER	WG	WIRE GUARD	
H.V.A.C.	HEATING, VENTILATING AND AIR CONDITIONING	EHP	FRACTIONAL HORSEPOWER	
HP.	HORSEPOWER	EF	EXHAUST FAN	
		CUH	CABINET UNIT HEATER	
KW.	KILOWATT	UH	UNIT HEATER	
		WAP	WIRELESS ACCESS POINT	

ELECTRICAL GENERAL NOTES: (APPLY TO ALL DRAWINGS):

- A. SLEEVE AND SEAL ALL ROOF, WALL AND FLOOR PENETRATIONS. PROVIDE FIRESTOPPING FOR ALL FIRE-RATED PENETRATIONS. UTILIZE REMOVABLE FIRESTOPPING MATERIAL AT CABLE TRAY PENETRATIONS. PROVIDE ACOUSTICAL SEALANT FOR ALL NON RATED PENETRATIONS. ALL FIRE RATINGS SHALL BE MAINTAINED.
- B. MAINTAIN SERVICE CLEARANCES OF ALL EQUIPMENT.
- C. COORDINATE EXACT LOCATION OF ALL CONDUIT ROUTES, EQUIPMENT AND DEVICES WITH EXISTING CONDITIONS PRIOR TO CONSTRUCTION.
- D. MINIMUM CONDUIT SIZE SHALL BE 3/4" FOR POWER CIRCUITS UNLESS NOTED OTHERWISE.
- E. PROVIDE NYLON PULL STRING IN ALL EMPTY CONDUITS.
- F. FIRE ALARM SIGNALING APPLIANCES SHALL BE MOUNTED SUCH THAT THE ENTIRE LENS IS NOT LESS THAN 80 INCHES AND NOT GREATER THAN 96 INCHES ABOVE THE FINISHED FLOOR.
- G. CIRCUITING TO DEVICES/EQUIPMENT SHALL BE 2-#12AWG & 1-#12EG (MULTIPLE HOME RUNS IN SAME CONDUIT MAY SHARE SAME EQUIPMENT GROUND) FOR EACH 20 AMPERE CIRCUIT UNLESS OTHERWISE NOTED. ALL CIRCUITS SHALL HAVE SEPARATE NEUTRALS (CIRCUITS SHALL NOT SHARE NEUTRALS).
- H. PROVIDE CONDUIT/WIRING (CIRCUITING) AND REQUIRED EQUIPMENT CONNECTIONS TO ALL DEVICES/EQUIPMENT. CONNECT TO CIRCUIT(S) AS INDICATED.
- I. ALL WORK AND MATERIALS SHALL BE IN ACCORDANCE WITH THE REFERENCE STANDARD EDITION OF NFPA CODES, AS CITED BY THE FIRE CODE OF NEW YORK STATE, BUILDING CODE OF NEW YORK STATE AND CORNELL UNIVERSITY DESIGN STANDARDS.
- J. ALL CONDUITS AND SUPPORTS SHALL BE AS TIGHT TO DECK AS POSSIBLE.
- K. PROVIDE PULLBOX FOR EVERY 180 DEGREE OF BENDS FOR TEL/DATA AND 360 DEGREES OF BENDS FOR POWER CONDUITS.
- L. ALL ELECTRICAL DEVICES (RECEPTACLES, SWITCHES, FIRE ALARM, ETC.) SHALL BE ALIGNED HORIZONTALLY AND VERTICALLY. CONTRACTOR TO SCHEDULE AND COORDINATE PROJECT WALKTHROUGH WITH ARCHITECT AND ENGINEER PRIOR TO COMMENCEMENT OF ANY DEVICE ROUGH-IN FOR FINALIZATION OF ALIGNMENTS.
- M. ALL EXISTING DEVICES CIRCUITED TO PANELS BEING RENAMED SHALL BE PROVIDED WITH UPDATED LABELS.
- N. COORDINATE IT SERVICE CHANGES OR DISRUPTIONS IN SERVICE WITH CIT OPERATIONS AT (607)255-5500.
- O. ALL OUTLETS WITHIN 6' OF SINK EDGE SHALL BE GFCI RATED.
- P. FLEX CONDUIT IS PROHIBITED FOR USE IN DATA APPLICATIONS WITHOUT WRITTEN PERMISSION FROM CORNELL CIT INFRASTRUCTURE ENGINEERS.
- Q. ALL DATA WORK MUST BE COORDINATED WITH CORNELL CIT.


ELECTRICAL GENERAL DEMOLITION NOTES: (APPLY TO ALL DRAWINGS):

- WHEN EXISTING CONSTRUCTION, WHICH IS TO REMAIN, IS DAMAGED DURING THE COURSE OF DEMOLITION AS A RESULT OF THE CONTRACTOR'S WORK, IT SHALL BE REPAIRED AND/OR REPLACED WITH SIMILAR OR LIKE MATERIALS, AS MUCH AS POSSIBLE, SUBJECT TO THE OWNERS APPROVAL.
- B. THE CONTRACTOR IS RESPONSIBLE FOR THE REMOVAL AND REPLACEMENT OF EXISTING CONSTRUCTION IN THE WAY OF NEW WORK. PROTECT BUILDING AND FURNISHINGS FROM DAMAGE.
- COORDINATE PHASING OF WORK WITH OWNER'S REPRESENTATIVE.
- COORDINATE ALL SHUTDOWNS WITH UNIVERSITY PRIOR TO DEMOLITION. ALL FIRE ALARM SHUTDOWNS SHALL BE SCHEDULED THROUGH CUSTOMER SERVICE WITH AT LEAST 24 HOURS NOTICE BEFORE WORK IS TO BE STARTED.
- E. EXISTING CONDITIONS ARE TAKEN FROM FIELD OBSERVATIONS AND PRIOR CONSTRUCTION DOCUMENTS WHEN AVAILABLE AND ARE NOT GUARANTEED. PRIOR TO SUBMITTING BID, VISIT SITE AND IDENTIFY EXISTING CONDITIONS AND DIFFICULTIES THAT WILL AFFECT THE DEMOLITION WORK. NO COMPENSATION WILL BE GRANTED FOR ADDITIONAL WORK CAUSED BY UNFAMILIARITY WITH SITE CONDITIONS THAT ARE VISIBLE OR READILY CONSTRUED BY EXPERIENCED OBSERVERS. THIS CONTRACTOR SHALL PARTICIPATE IN SURVEY OF THE EXISTING ELECTRICAL SYSTEMS. THE CONTRACTOR SHALL DISCONNECT AND CAP ALL SERVICE LINES TO BE DISCONNECTED FOR THOSE SERVICES WHICH NORMALLY ARE INCLUDED IN HIS FIELD OF WORK. PARTICULAR CARE SHALL BE TAKEN TO AVOID CREATING HAZARD OR CAUSING DISRUPTION IN ADJOINING AREAS. NOT ALL DEVICES TERMINATIONS, JUNCTION BOXES AND WIRING HAVE BEEN SHOWN.
- REFER TO PLUMBING CONTRACT DRAWINGS AND SPECIFICATIONS FOR EXACT QUANTITIES AND LOCATIONS OF ALL PLUMBING EQUIPMENT BEING ABANDONED OR REMOVED, WHICH WILL REQUIRE DE-ENERGIZATION, REMOVAL AND BLANK-OFF BY THE CONTRACTOR.
- EXISTING FIRE ALARM SYSTEM SHALL BE KEPT OPERATIONAL DURING THE CONSTRUCTION PERIOD THE BUILDING UNDER RENOVATION MAY BE DISCONNECTED FROM SERVICE DURING THE HOURS THE CONTRACTOR IS WORKING, AT THE DISCRETION OF THE FIRE DEPARTMENT AND THE OWNER'S REPRESENTATIVE, BUT MUST BE PLACED BACK ON LINE DURING OTHER PERIODS. APPROVAL TO BE
- H. THE EXISTING ELECTRICAL EQUIPMENT AND DEVICES WITHIN DEMOLITION AREA SHALL BE DEMOLISHED ALONG WITH ALL FEEDERS AND CONDUITS BACK TO POINT OF SOURCE UNLESS OTHERWISE NOTED. ALL ITEMS SHOWN ON THE DEMOLITION DRAWINGS SHALL BE DISCONNECTED AND REMOVED UNLESS NOTED OTHERWISE. WALLBOXES, BACKBOXES AND CONDUIT SHALL BE REUSED AS DETERMINED BY CONTRACTOR. ALL UNUSED CONDUITS SHALL BE REMOVED. DISCONNECT AND MAKE SAFE ANY EQUIPMENT TO BE REMOVED BY OTHERS. COORDINATE REMOVAL OF EQUIPMENT WITH OTHER TRADES PRIOR TO DEMOLITION.
- MAINTAIN AND RESTORE, IF INTERRUPTED BY REMOVALS OR IN PATH OF NEW CONSTRUCTION, ALL CIRCUITS, CONDUITS AND FEEDERS PASSING THROUGH AND SERVING UNDISTURBED AREAS (SHOWN OR NOT SHOWN).
- ALL EXISTING CONDUITS STUBBED THROUGH FLOOR SERVING ITEMS TO BE REMOVED AND NOT SHOWN OR REQUIRED TO BE REUSED, SHALL BE CUT OFF FLUSH WITH SLAB LEVEL WITH CONCRETE.
- IN ANY AREA REQUIRING THE PERFORMANCE OF ANY TRADE'S WORK, THIS CONTRACTOR SHALL CAREFULLY REMOVE AND STORE ANY OR ALL ELECTRICAL ITEMS IN PATH OF WORK, REINSTALLING AND RECONNECTING SAME AS REQUIRED, IN ACCORDANCE WITH THE PLANS AND/OR AS DIRECTED AFTER COMPLETION OF OTHER TRADE'S WORK IN THAT AREA.
- .. DISCONNECT, MAKE SAFE AND REMOVE ALL TEMPORARY AND ABANDONED WIRE WITHIN THE SPACE.
- BRANCH CIRCUIT WIRING TO DEVICES IN AREAS OF DEMOLITION SHALL BE DISCONNECTED, MADE SAFE AND REMOVED COMPLETELY BACK TO THE PANELBOARD. THE CONTRACTOR SHALL NOT ABANDON BRANCH CIRCUIT WIRING TO ANY AREAS WHICH ARE TO REMAIN BUT ARE AFFECTED BY THE DEMOLITION OR NEW CONSTRUCTION.
- I. DISCONNECT AND REMOVE PANEL, FEEDERS AND BRANCH CIRCUITS BACK TO POINT OF SOURCE PRIOR TO THE START OF DEMOLITION, CONTRACTOR SHALL FIELD VERIFY ALL BRANCH CIRCUITS AND MAINTAIN THOSE CIRCUITS THAT EXTEND OUTSIDE OF THE SCOPE OF WORK.
- AFTER RENOVATING EXISTING ELECTRICAL WORK, THE CONTRACTOR SHALL INSURE THAT ALL REMAINING AND NEW EQUIPMENT WILL OPERATE PROPERLY.
- PROVIDE TEMPORARY HEAT DETECTORS IN AREAS WHERE SPRINKLERS ARE REMOVED FROM SERVICE DURING CONSTRUCTION. COORDINATE WITH FIRE PROTECTION CONTRACTOR.
- Q. REFER TO HVAC CONTRACT DRAWINGS AND SPECIFICATIONS FOR EXACT QUANTITIES AND LOCATIONS OF ALL HVAC EQUIPMENT BEING ABANDONED OR REMOVED, WHICH WILL REQUIRE DE-ENERGIZATION, REMOVAL AND BLANK-OFF BY THE CONTRACTOR.

Della Spina

ARCHITECT

215 Wyoming Street Suite 201 Syracuse, NY 13204 Pittsford, NY 14534
Tel (315) 488 - 0377 Tel (585) 200 - 5038
Fax (315) 487 - 5947 Fax (585) 487 - 9532

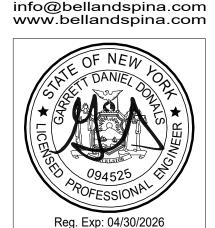

Cert. of Auth: 0018443

It is a violation of the New York State Education Law, Article 145 Sec. 7209, for any person unless he is acting under the direction of a licensed professional Architect, Engineer or Land Surveyor to alter an item in any way. If an item bearing the seal of an Architect, Engineer or Land Surveyor is altered, the altering Architect, Engineer or Land Surveyor shall affix to the item his seal and the notation "altered by" followed by his signature and the date of such alteration, and a specific description of the alteration.

PROJECT NORTH



Mechanical/Electrical Engineering Consultants
Rochester | Buffalo | Syracuse | Capital District
300 TROLLEY BOULEVARD
ROCHESTER, NY 14606
S85.288.5590
www.meengineering.com

ROJECT

dina No. 1

Y MEDICAL CE toad 853

ETERINARY
30 CAMPUS R
HACA, NY 148
ient Project No

PROJECT NUMBER

191026

The Contractor shall verify all dimensions and notify the Architect in writing of any discrepancies.

All drawings and specifications are the property of the Architect and shall be used only on the job designated.

only on the job designated.

MARK DATE DESCRIPTION

DRAWN CHECKED MRG

DATE SCALE NTS

SHEET TITLE

GENERAL NOTES AND ABBREVIATIONS -ELECTRICAL

SHEET NUMBER

E-000

GENERAL NOTES:

- A. REMOVE AND REPLACE ALL EXISTING LIGHTNING PROTECTION SYSTEMS. MOUNT CONDUCTORS TO BACK OF PARAPET AND OFF ROOF MEMBRANE PER DETAIL - CONTRACTOR TO COORDINATE INSTALLATION. PROVIDE A COMPLETE SYSTEM, REFER TO SPECIFICATIONS.
- B. DISCONNECT ANY EQUIPMENT POWER CONNECTIONS, RECONNECT USING ADDITIONAL MATERIAL AS NECESSARY TO REINSTALL PRIOR TO ROOF REPLACEMENT WORK. COORDINATE WITH ROOFTOP EQUIPMENT.

<u>ELECTRICAL DRAWING NOTES:</u>

PARTIAL ROOF PLAN - ELECTRICAL


1 EXTERIOR LUMINAIRE LOCATION. BASE COMPONENT TO BE REPLACED. REMOVE FIXTURE. EXTEND WIRING AND REWORK JUNCTION BOXES AS NEEDED TO ACCOMMODATE NEW BASE AND FIXTURE. ALL ABOVE AND THROUGH-ROOF CIRCUITRY TO BE MINIMUM 3/4" GALVANIZED RIGID CONDUIT. PROVIDE CAST METAL WEATHERPROOF BOXES WITH THREADED HUBS FOR ALL JUNCTION BOXES. PROVIDE BOXES WITH GASKETED WEATHERPROOF COVERS. UTILIZE SINGLE PATH THROUGH ROOF AND THEN RUN HORIZONTALLY ALONG ROOF WITH DURABLOCK CONDUIT SUPPORTS. REFER TO ARCHITECTURAL PLANS FOR DETAILS ON CONDUIT HOOD LOCATIONS AND DURABLOCK LOCATIONS. PROVIDE ADDITIONAL DURABLOCK SUPPORTS AS REQUIRED BASED ON

ELECTRICAL DRAWING NOTES:

- 2 PROVIDE BEACON VIPER FLOODLIGHT CAT#VP-F ST - 2 - 72L-210 - 4K8 - 6X4 - UNV - K - ___ - __ - PC. FINISH BY ARCHITECT. PROVIDE THREADED 2" EXTENSION FROM STANTION TO FIXTURE. COORDINATE WITH ARCHITECT AND OWNER FOR POSITIONING. EXTEND EXISTING CIRCUITRY IN MINIMUM 3/4" RIGID CONDUIT. WIRING TO BE #10AWG MINIMUM. WIRING TO FIXTURE FROM JUNCTION BOX TO BE IN LIQUIDTIGHT FLEXIBLE METAL CONDUIT. 3 PRESSURE RELIEF VENT. EXTEND WIRING AND
- REWORK ELECTRICAL COMPONENTS AS NEEDED. 4 EXISTING ELECTRICAL CONNECTION. DISCONNECT,
- EXTEND, AND RECONNECT ALL ELECTRICAL COMPONENTS AS NEEDED. EXTEND POWER CIRCUITS WITH A MINIMUM OF #12 AWG CONDUCTOR AN CONDUIT SIZE SHALL MATCH FLEXIBLE OR LIQUIDTIGHT FLEXIBLE CONDUIT AS

ELECTRICAL DRAWING NOTES:

- 5 EXISTING SMOKE HATCH. (DISCONNECT, EXTEND, AND RECONNECT ALL ELECTRICAL COMPONENTS AS NEEDED. EXTEND POWER CIRCUITS WITH MINIMUM #12AWG CONDUCTORS IN MINIMUM 3/4"C. PROVIDE FLEXIBLE OR LIQUIDTIGHT FLEXIBLE CONDUIT AS NEEDED FOR MOVING OR VIBRATING COMPONENTS. PROVIDE COPPER, MINIMUM #14 AWG, PLENUM-RATED CABLING FOR FIRE ALARM SIGNAL EXTENSIONS. PROVIDE ALL WIRING BACK TO T-TAP (AND PERFORM T-TAP) OR PREVIOUS AND NEXT DEVICES AS NEEDED. PROVIDE 3/4" EMT PATHWAYS. PROVIDE ALL PROGRAMMING AS REQUIRED, COORDINATE ALL SHUTDOWNS WITH OWNER). REFER TO ARCHITECTURAL DRAWINGS FOR DETAILS.
- 6 EXISTING ELECTRICAL AND BMS CONDUITS. DISCONNECT, EXTEND, RELOCATE AND RECONNECT ALL ELECTRICAL COMPONENTS AS NEEDED TO RAISE TO HEIGHT OF NEW ROOF CURB TO ALLOW FOR ROOF INSTALLATION. REFER TO ARCHITECTURAL DRAWINGS FOR NEW ROOF CURB LOCATION. EXTEND POWER CIRCUITS WITH A MINIMUM OF #10AWG CONDUCTORS AND A MINIMUM 1" CONDUIT. FINAL CONDUCTOR AND CONDUIT SIZE SHALL MATCH EXISTING COMPONENT BEING EXTENDED. PROVIDE FLEXIBLE OR LIQUIDTIGHT FLEXIBLE CONDUIT AS NEEDED FOR MOVING OR VIBRATING COMPONENTS. PROVIDE COPPER, MINIMUM #14 AWG, PLENUM-RATED CABLING FOR FIRE ALARM SIGNAL EXTENSIONS. PROVIDE ALL WIRING BACK TO T-TAP (AND PERFORM T-TAP) OR PREVIOUS AND NEXT DEVICES AS NEEDED. PROVIDE 3/4" EMT PATHWAYS. PROVIDE ALL PROGRAMMING AS REQUIRED, COORDINATE ALL SHUTDOWNS WITH OWNER. BMS WIRING SHALL BE COMPLETELY NEW WIRING FROM POINT TO POINT AND INSTALLED WITHIN CONDUIT FOR ROUTING ON ROOF. REFER TO ARCHITECTURAL
- DRAWINGS FOR DETAILS. 7 EXISTING ELECTRICAL CONNECTION. DISCONNECT, EXTEND AND, RECONNECT ALL ELECTRICAL COMPONENTS AS NEEDED TO REMOVE FROM EXISTING ROOF CURB AND INTO NEW ROOF CURB. REFER TO ARCHITECTURAL DRAWINGS FOR NEW ROOF CURB LOCATION. EXTEND POWER CIRCUITS WITH A MINIMUM OF #12 AWG CONDUCTORS AND A MINIMUM 3/4" CONDUIT. FINAL CONDUCTOR AND CONDUIT SIZE SHALL MATCH EXISTING COMPONENT BEING EXTENDED. PROVIDE FLEXIBLE OR LIQUIDTIGHT FLEXIBLE CONDUIT AS NEEDED FOR MOVING OR VIBRATING COMPONENTS. REFER TO ARCHITECTURAL DRAWINGS FOR DETAILS.
- 8 EXISTING ELECTRICAL AND BMS CONDUITS. DISCONNECT, EXTEND, RELOCATE AND RECONNECT ALL ELECTRICAL COMPONENTS AS NEEDED TO RAISE TO HEIGHT OF NEW ROOF CURB TO ALLOW FOR ROOF INSTALLATION. REFER TO ARCHITECTURAL DRAWINGS FOR NEW ROOF CURB LOCATION. EXTEND POWER CIRCUITS WITH A MINIMUM OF #12AWG CONDUCTORS AND A MINIMUM 3/4" CONDUIT. FINAL CONDUCTOR AND CONDUIT SIZE SHALL MATCH EXISTING COMPONENT BEING EXTENDED. PROVIDE FLEXIBLE OR LIQUIDTIGHT FLEXIBLE CONDUIT AS NEEDED FOR MOVING OR VIBRATING COMPONENTS. PROVIDE COPPER, MINIMUM #14 AWG, PLENUM-RATED CABLING FOR FIRE ALARM SIGNAL EXTENSIONS. PROVIDE ALL WIRING BACK TO T-TAP (AND PERFORM T-TAP) OR PREVIOUS AND NEXT DEVICES AS NEEDED. PROVIDE 3/4" EMT PATHWAYS. PROVIDE ALL PROGRAMMING AS REQUIRED, COORDINATE ALL SHUTDOWNS WITH OWNER. BMS WIRING SHALL BE COMPLETELY NEW WIRING FROM POINT TO POINT AND INSTALLED WITHIN CONDUIT FOR ROUTING ON ROOF. REFER TO ARCHITECTURAL DRAWINGS FOR DETAILS.
- 9 ROOF-MOUNTED POST INDICATOR VALVE (PIV). EXTEND FIRE ALARM CONNECTIONS USING COPPER, MINIMUM #14AWG, PLENUM-RATED CABLING. EXTEND TO T-TAP (AND PROVIDE T-TAP) OR REWORK WIRING TO PREVIOUS AND NEXT DEVICES. PROVIDE PROGRAMMING AS NEEDED; COORDINATE ALL SHUTDOWNS WITH OWNER.
- 10 EXISTING ELECTRICAL CONNECTION TO CONDENSING UNIT. DISCONNECT, EXTEND, AND RECONNECT ALL ELECTRICAL COMPONENTS AS NEEDED TO REMOVE FROM EXISTING ROOF CURB AND INTO NEW ROOF CURB. REFER TO ARCHITECTURAL DRAWINGS FOR NEW ROOF CURB LOCATION, EXTEND POWER CIRCUITS WITH A MINIMUM OF #12 AWG CONDUCTORS AND A MINIMUM 3/4" CONDUIT. FINAL CONDUCTOR AND CONDUIT SIZE SHALL MATCH EXISTING COMPONENTS BEING EXTENDED. PROVIDE FLEXIBLE OR LIQUIDTIGHT FLEXIBLE CONDUIT AS NEEDED FOR MOVING OR VIBRATING COMPONENTS. REFER TO ARCHITECTURAL DRAWINGS FOR DETAILS.
- 11 BOND ALL RAILINGS TO LIGHTNING PROTECTION SYSTEM.
- 12 TEMPORARILY DISCONNECT AND REMOVE EXISTING ELECTRICAL COMPONENTS SUPPORTED FROM AHU METAL PLATFORM TO ALLOW FOR ITS MODIFICATIONS. PROVIDE TEMPORARY SUPPORTS OF REMOVED ELECTRICAL COMPONENTS AND THEN REATTACH TO AHU METAL PLATFORM AFTER MODIFICATIONS HAVE BEEN MADE AND PLATFORM PLACED BACK ADJACENT TO AHU.

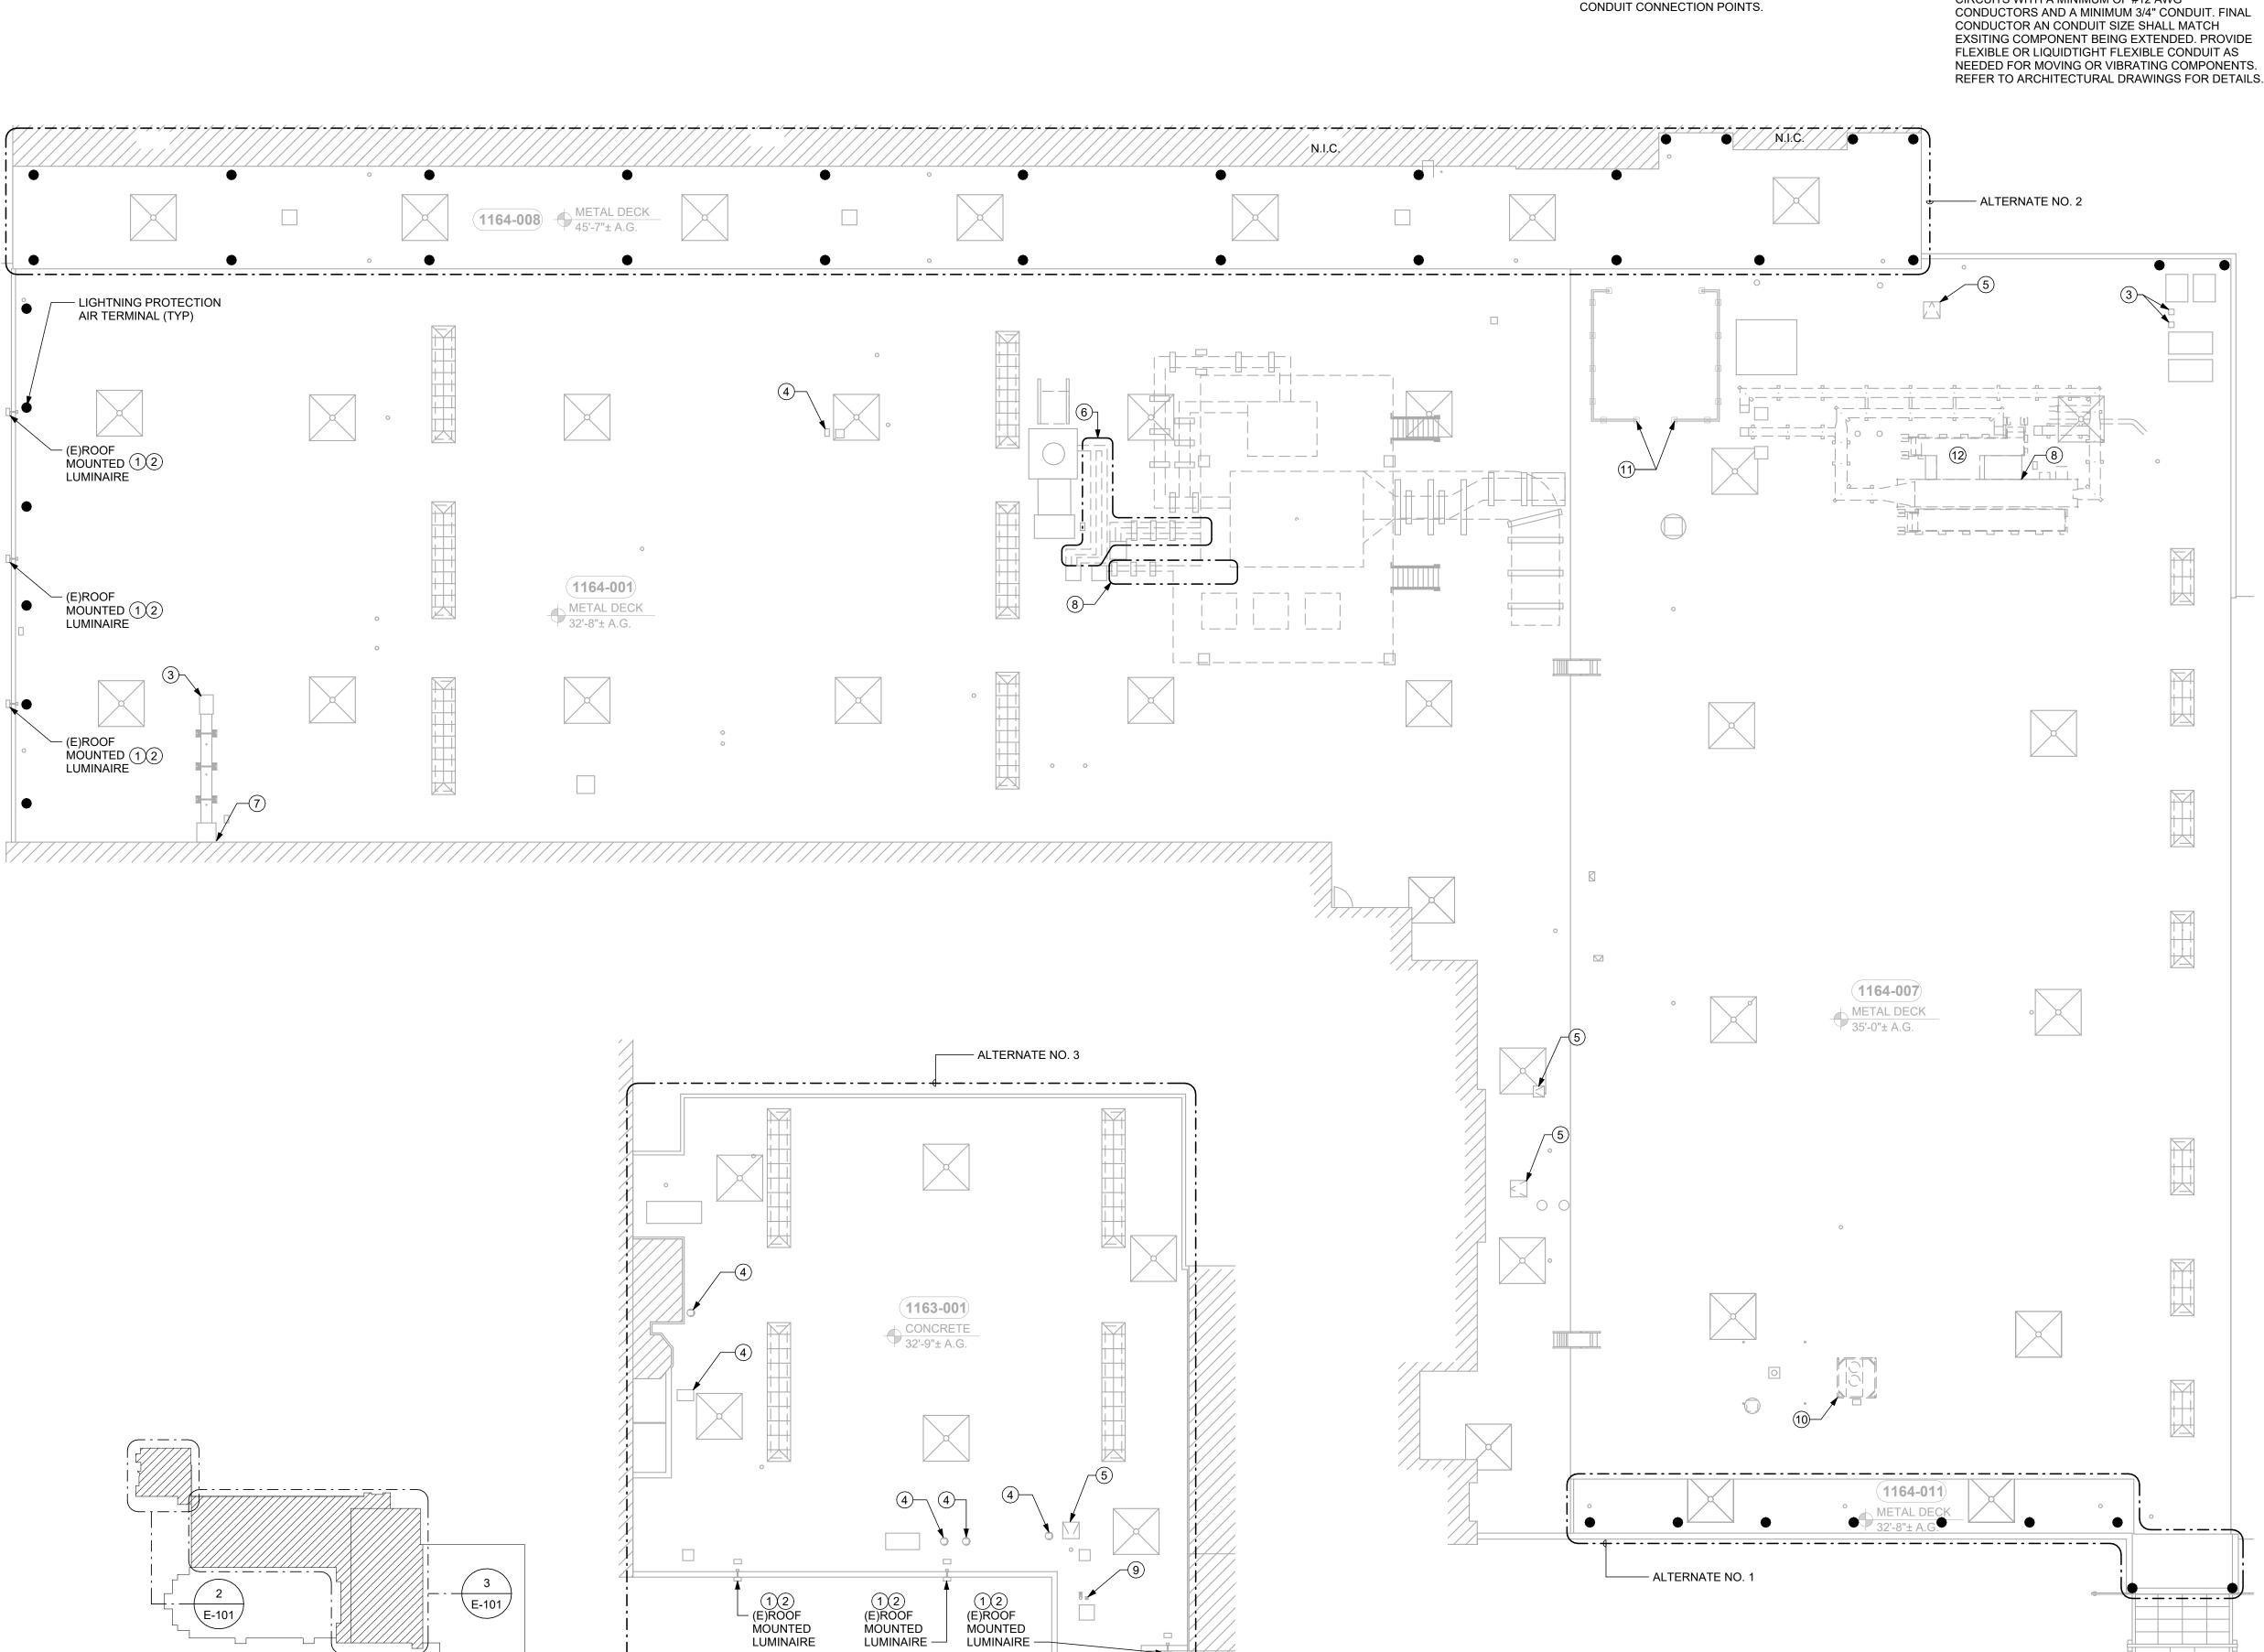


PARTIAL ROOF PLAN - ELECTRICAL

KEY PLAN

215 Wyoming Street 1163 Pittsford-Victor Rd Suite 200

> Tel (315) 488 - 0377 Tel (585) 200 - 5038 Fax (315) 487 - 5947 Fax (585) 487 - 9532 info@bellandspina.com www.bellandspina.com

Syracuse, NY 13204 Pittsford, NY 14534

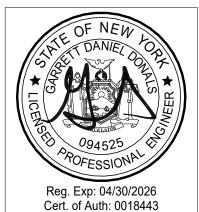

It is a violation of the New York State Education Law, Article 145 Sec. 7209, for any person unless he is acting under the direction of a licensed professional Architect, Engineer or Land Surveyor to alter an item in any way If an item bearing the seal of an Architect, Engineer or Land Surveyor is altered, the altering Architect, Engineer or Land Surveyo shall affix to the item his seal and the notation "altered by" followed by his signature and the date of such alteration, and a specific description of the alteration.

NORTH

PROJECT

ENGINEERING Mechanical/Electrical Engineering Consultants Rochester | Buffalo | Syracuse | Capital District

 $\overline{\mathsf{O}}$

MEDICAL

PROJECT NUMBER 191026

The Contractor shall verify all dimensions and notify the Architect in writing of any discrepancies.

All drawings and specifications are the property of the Architect and shall be used

only on the job designated.


CHECKED IJC MRG

SCALE 10/10/2025 As indicated

SHEET TITLE PARTIAL ROOF PLANS -ELECTRICAL


SHEET NUMBER

E-101 SHEET ______ OF ______ 25

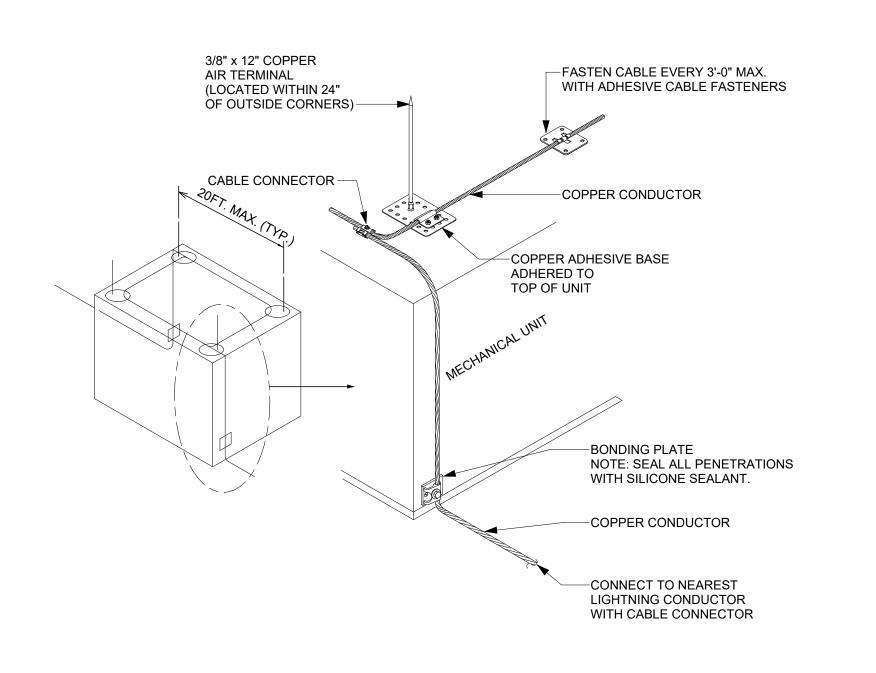

GENERAL NOTES:

A. BOND ALL ROOF DRAINS, PIPING, HVAC UNITS, ETC., AS REQUIRED.

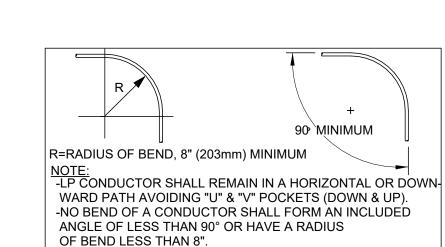


LIGHTNING PROTECTION NOTES:

- A. COORDINATE REMOVAL AND REINSTALLATION OF THE LIGHTNING PROTECTION SYSTEM WITH OTHER TRADES.
- B. CONDUCTORS SHALL MAINTAIN A HORIZONTAL OR DOWNWARD COURSE, FREE FROM "U" OR "V" (DOWN AND UP) POCKETS.
- C. NO BEND OF CONDUCTOR SHALL FORM AN ANGLE OF LESS THAN 90 DEG. NOR SHALL HAVE A RADIUS OF BEND LESS THAN 8".
- D. BARE COPPER MATERIALS SHALL NOT BE INSTALLED ON ALUMINUM SURFACES AND ALUMINUM MATERIALS SHALL NOT BE INSTALLED ON COPPER SURFACES.
- E. ALL LIGHTNING PROTECTION CONDUCTORS SHALL BE FASTENED EVERY 3'-0"
- F. METALLIC BODIES OF INDUCTANCE SITUATED WITHIN 6'-0" OF A LIGHTNING CONDUCTOR OR ANOTHER BONDED METAL BODY SHALL BE INTERCONNECTED TO THE LIGHTNING CONDUCTOR SYSTEM, UNLESS INHERENTLY GROUNDED.
- G. BOND TO ALL METAL BODIES OF CONDUCTANCE WITHIN 6'-0" OF THE MAIN LIGHTNING CONDUCTOR SUCH AS EXHAUST FANS, ROOF VENTS, METAL COOLING TOWERS, H.V.A.C. UNITS, LADDERS, RAILINGS, ANTENNAS, SKYLIGHTS, METAL STACKS AND ANY OTHERS LARGE METAL BODY WHOSE HEIGHT EXCEEDS THAT OF THE AIR TERMINAL IN USE, UNLESS PROTECTED BY HIGHER ROOF ELEVATIONS.
- H. TORQUE ALL CONNECTIONS PER MANUFACTER RECOMMENDATIONS.

LIGHTNING PROTECTION AT ROOFTOP UNIT



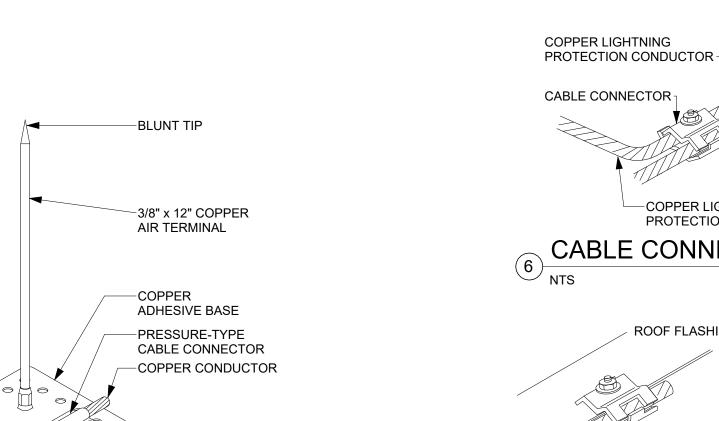


THE ADHESIVE COMPOUND SHALL


WITH ROOF DETAIL.

BE COMPATIBLE WITH THE ROOFING


SYSTEM. COORDINATE INSTALLATION

ADHESIVE AIR TERMINAL BASE

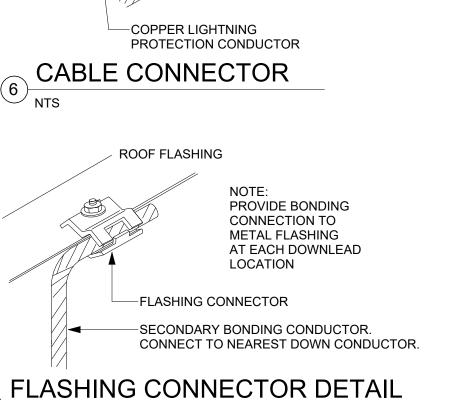


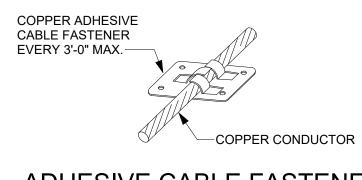


ADHESIVE CABLE FASTENER

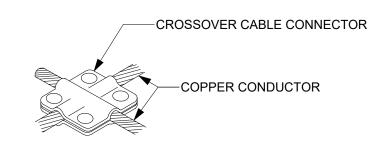

CABLE CROSSOVER DETAIL

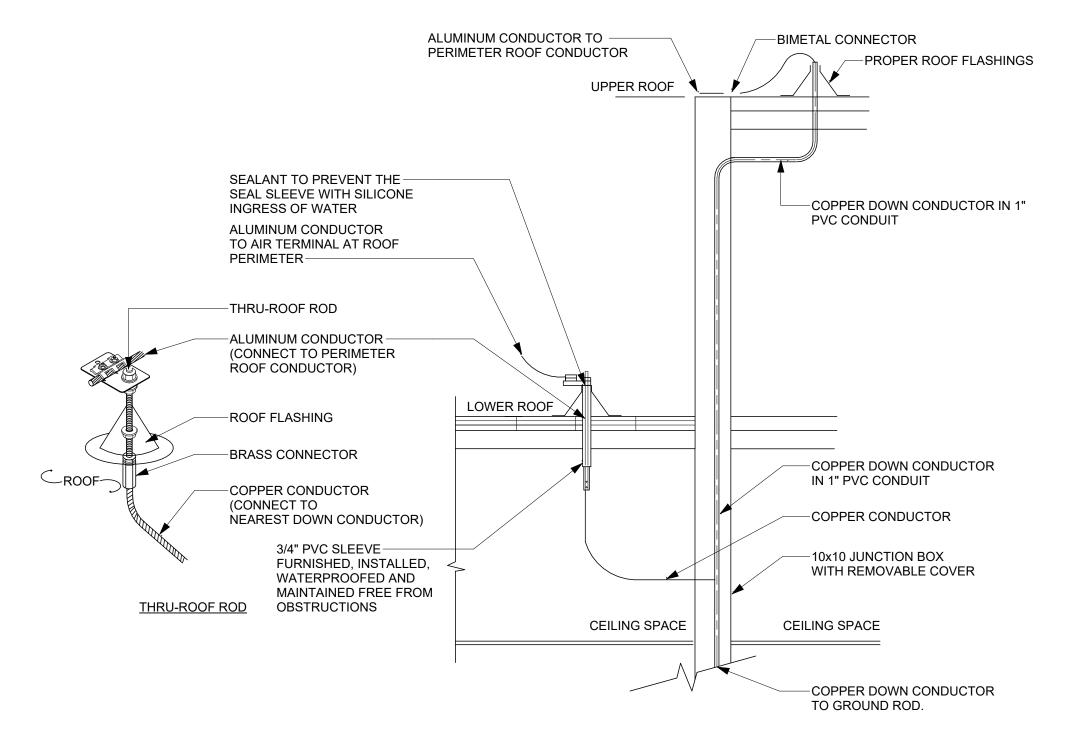

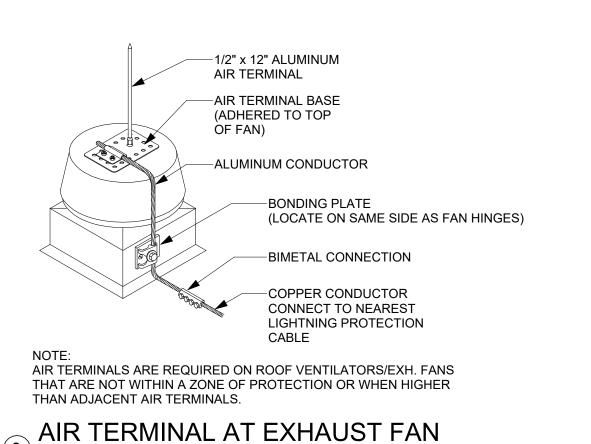

CABLE FASTENER

W/ METAL SCREW

(EVERY 3FT. MAX.)

SEAL PENETRATIONS WITH SILICONE SEALANT

METAL SCREWS (2)

3 OFFSET AIR TERMINAL BASE

CAP

-BLUNT TIP

-3/8" x 12" COPPER

LIGHTNING CONDUCTOR

LIGHTNING PROTECTION COMPONENT

MATERIALS SHALL BE GALVANICALLY

THEY TOUCH. COPPER COMPONENTS

SURFACES. OFFSET BASE SHALL BE

MOUNTED TO WALL BELOW COPING.

SHALL NOT BE INSTALLED ON ALUMINUM

COMPATIBLE WITH METAL COPING IF

AIR TERMINAL


OFFSET BASE

PRESSURE-TYPE

CABLE CONNECTOR

─3/8" x 12" COPPER AIR TERMINAL -COPPER BASE LIGHTNING CONDUCTOR

SADDLE AIR TERMINAL BASE AT RIDGE

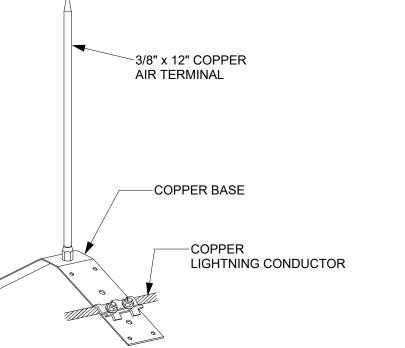

1. PROPER ROOF FLASHINGS SHALL BE FURNISHED, INSTALLED AND

WEATHERPROOFED BY THE CONTRACTOR. 2. JUNCTION BOXES SHALL BE FURNISHED AND INSTALLED BY THE CONTRACTOR.

THRU-ROOF ROD & CABLE TO DOWN CONDUCTOR IN J-BOX



Syracuse, NY 13204 Pittsford, NY 14534 Tel (315) 488 - 0377 Tel (585) 200 - 5038 Fax (315) 487 - 5947 Fax (585) 487 - 9532 info@bellandspina.com



Cert. of Auth: 0018443 It is a violation of the New York State Education Law, Article 145 Sec. 7209, for any person unless he is acting under the direction of a licensed professional Architect, Engineer or Land Surveyor to alter an item in any way If an item bearing the seal of an Architect, Engineer or Land Surveyor is altered, the altering Architect, Engineer or Land Surveyo shall affix to the item his seal and the notation "altered by" followed by his signature and the date of such alteration, and a specific description of the alteration.

PROJECT NORTH

ME ENGINEERING Rochester | Buffalo | Syracuse | Capital District

CE MEDICAL

 $\overline{\mathbf{C}}$ PROJECT NUMBER

191026 The Contractor shall verify all dimensions and notify the Architect in writing of any

All drawings and specifications are the property of the Architect and shall be used

only on the job designated.

CHECKED IJC MRG

DATE SCALE 10/10/2025 NTS

SHEET TITLE

DETAILS -ELECTRICAL

SHEET NUMBER

E-501 SHEET ______ OF ______ 25