ADDENDUM NO. 4

May 6, 2025

This Addendum contains changes to the requirements of the Contract Documents and Specifications. Such changes are to be incorporated into the Construction Documents and shall apply to the work with the same meaning and force as if they had been included in the original document. Wherever this Addendum modifies a portion of a paragraph of the specifications or a portion of any Drawing, the remainder of the Paragraph or Drawing shall remain in force.

NOTE: Provisions of all Contract Documents apply.

Item 1. Drawing A-001

DELETE in its entirety.

REPLACE with revised Drawing A-001R, attached.

Item 2. Drawing A-201

DELETE in its entirety.

REPLACE with revised Drawing A-201R, attached.

Item 3. Drawing A-202

DELETE in its entirety.

REPLACE with revised Drawing A-202R, attached.

Item 4. Drawing A-203

DELETE in its entirety.

REPLACE with revised Drawing A-203R, attached.

Item 5. Drawing A-703

DELETE in its entirety.

REPLACE with revised Drawing A-703R, attached.

Item 6. Drawing A-706

DELETE in its entirety.

REPLACE with revised Drawing A-706R, attached.

Renovate 2nd-5th Floor at King-Shaw Hall Addendum No. 4 May 6, 2025 Page 2

Item 7. Drawing A-708

DELETE in its entirety.

REPLACE with revised Drawing A-708R, attached.

Item 8. Drawing FS-100

DELETE in its entirety.

REPLACE with revised Drawing FS-100R, attached.

Item 9. Pre-bid Sign-in sheet is attached for Contractors' reference only.

Item 10. RFI Questions and Clarifications

See attached RFI Log (items 24 - 31)

Attachments: Drawing A-001R

Drawing A-201R Drawing A-202R Drawing A-203R Drawing A-703R Drawing A-706R Drawing A-708R Drawing FS-100R Pre-bid Sign-in sheet RFI Log (items 1-31)

****END OF ADDENDUM****

CODE COMPLIANCE PLAN - FIFTH FLOOR SCALE: 1/16" = 1'-0"

FIFTH FLOOR

EGRES	SS	CAPA	CITY			
MAX. NO. OF OCCUPANTS		STAIR (1 PER .3	0" WIDTH)		(IT DOOR 20" WIDTH)	
ON FLOOR	NO.	WIDTH	MAX CAP.	WIDTH	MAX CAP.	GOVERNING CAPACITY
	Α	45"	150	36"	180	150
	В	44"	146	36"	180	146
			XIT CAPAC CCUPANC			296 204 (COMPLIES)

PLUMBING FIXTURE COUNT

			CLOSET FEMALE			DRINKING FOUNTAINS	
ROUP 3*	204	1	2	1	1	1	1
TAL OVIDE	D	2	3	1	2	2*	1
	1) (0, 000	0.4.4.51)/7	LIDE OAL	O A T.O.			

*PER BCNYS 2902.1.1 FIXTURE CALCULATIONS

**PLUMBING CODE SECTION 410.4 ALLOWS UP TO 50% OF REQUIRED DRINKING FOUNTAINS TO BE SUBSTITUTED WITH BOTTLED WATER DISPENSERS

FOURTH FLOOR

EGRES	SS	CAPA	CITY			
MAX. NO. OF OCCUPANTS		STAIR (1 PER .3	0" WIDTH)		(IT DOOR 0" WIDTH)	
ON FLOOR	NO.	WIDTH	MAX CAP.	WIDTH	MAX CAP.	GOVERNING CAPACITY
	Α	45"	150	36"	180	150
	В	44"	146	36"	180	146
			XIT CAPAC CCUPANC			296 52 (COMPLIES)

PLUMBING FIXTURE COUNT


	OCC.	WATER	CLOSET	LAVATO	RIES	DRINKING	SERV.
	LOAD	MALE	FEMALE	MALE	FEMALE	FOUNTAINS	SINKS
GROUP B*	52	2	2	1	1	1	1
TOTAL PROVIDE	D	4	3	2	3	2	

**PLUMBING CODE SECTION 410.4 ALLOWS UP TO 50% OF REQUIRED

DRINKING FOUNTAINS TO BE SUBSTITUTED WITH BOTTLED WATER

DISPENSERS

CODE COMPLIANCE PLAN – FOURTH FLOOR SCALE: 1/16" = 1'-0"

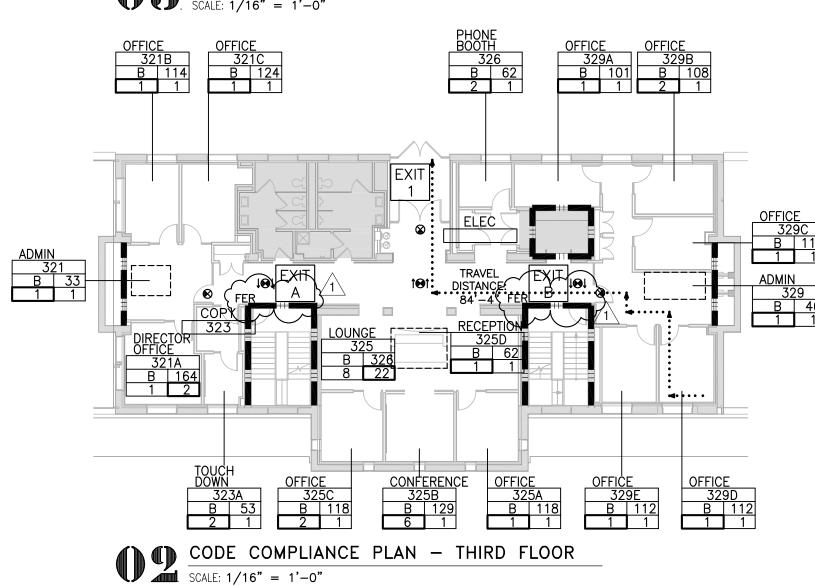

THIRD FLOOR

PREP ROOM 233 B 629 3 3

EXIT 2

CAFE 231 B 725 19 48

EGRES	SS	CAPA	CITY			
MAX. NO. OF OCCUPANTS		STAIR (1 PER .3	0" WIDTH)		(IT DOOR 0" WIDTH)	
ON FLOOR	NO.	WIDTH	MAX CAP.	WIDTH	MAX CAP.	GOVERNING CAPACITY
	Α	45"	150	36"	180	150
	В	44"	146	36"	180	146
	1			72"	360	360
			XIT CAPAC CCUPANC			656 48 (COMPLIES)

PLUMBING FIXTURE COUNT

			.,			-	
	OCC. LOAD		CLOSET FEMALE			DRINKING FOUNTAINS	SERV. SINKS
GROUP B*	48	1	1	1	1	1	1
TOTAL PROVIDE	D	3	3	2	2	2	1
*PER BCN	IYS 290	2.1.1 FIXT	URE CAL	CULATIO	NS		

PER BCNYS 2902.1.1 FIXTURE CALCULATIONS

**PLUMBING CODE SECTION 410.4 ALLOWS UP TO 50% OF REQUIRED DRINKING FOUNTAINS TO BE SUBSTITUTED WITH BOTTLED WATER

SECOND FLOOR

EGRES	SS	CAPA	CITY			
MAX. NO. OF OCCUPANTS		STAIR (1 PER .3	0" WIDTH)		(IT DOOR 0" WIDTH)	
ON FLOOR	NO.	WIDTH	MAX CAP.	WIDTH	MAX CAP.	GOVERNING CAPACITY
	1			72"	360	360
	2			72"	360	360
		. • = = .	XIT CAPAC CCUPANC			720 148 (COMPLIES)

PLUMBING FIXTURE COUNT

	OCC.	WATER	CLOSET	LAVATO	RIES	DRINKING	SER\
	LOAD	MALE	FEMALE	MALE	FEMALE	FOUNTAINS	SINK
GROUP A*	48	1	1	1	1	1	1
GROUP B*	100	2	2	2	2	1	1
TOTAL PROVIDE	D	3	3	2***	2***	2	
*PER BCN	NYS 290	2.1.1 FIXT	URE CAL	CULATIO	NS		
**DLUMBI	NG COI	DE SECTI	ON 410 4		LID TO 50	% OF REQUIF	PED
_	FOUN	_	-	_		TTLED WATE	

***ONE OF THE REQUIRED LAVATORIES LOCATED ON THE THIRD FLOOR

CODE SUMMARY

PROJECT DESCRIPTION:

KING-SHAW HALL IS ONE WING OF A BUILDING WHICH CONSISTS OF THREE WINGS: DOLGEN HALL TO THE NORTH, KING-SHAW HALL IN THE CENTER AND ILR RESEARCH TO THE SOUTH. THIS PROJECT WILL BE A PARTIAL RENOVATION OF FLOORS 2, 3, 4 AND 5 AND PROVIDE NEW OFFICES, WORKSTATIONS, MEETING ROOMS, STUDENT LOUNGES AND A CAFÉ, AS WELL AS RESTORATION OF THE ROOFTOP CUPOLA.

APPLICABLE CODES:

- 2020 NYS UNIFORM FIRE PROTECTION AND BUILDING CODE • ICC/ANSI A117.1-2009 ACCESSIBLE AND USABLE BUILDINGS
- AND FACILITIES 2010 ADA STANDARDS FOR ACCESSIBLE DESIGN

USE AND OCCUPANCY CLASSIFICATION:

THERE WILL BE NO CHANGE IN OCCUPANCY CLASSIFICATION. CURRENT AND NEW USE OF SPACE INCLUDES: BUSINESS GROUP B THE EXISTING LEGAL NONCONFORMING A-3 OCCUPANCY ON THE FIFTH FLOOR IS TO REMAIN; THE NONCONFORMING USE IS NOT BEING

USES IN THE BUILDING INCLUDE:

MADE LESS CONFORMING.

EDUCATION ABOVE 12TH GRADE **ASSEMBLY**

BUSINESS GROUP B ASSEMBLY GROUP A-3 (≥50 PERSONS OR 750SF)

CONSTRUCTION CLASSIFICATION: TYPE VB

TABLE 601:	
BUILDING ELEMENT	RATING (HOURS)
PRIMARY STRUCTURAL FRAME	0
BEARING WALLS	
EXTERIOR	0
INTERIOR	0
FLOOR CONSTRUCTION	0
ROOF CONSTRUCTION	0

INTERIOR FINISHES

BCNYS TABLE 803.13 INTERIOR WALL AND CEILING FINISH

REQUIREMENTS CORRIDORS & **ENCLOSURE** INTERIOR FOR EXIT ROOMS AND EXIT STAIRS, INTERIOR EXIT ACCESS STAIRS ENCLOSED GROUP RAMPS PASSAGEWAYS* AND RAMPS SPACES

*CLASS C SHALL BE PERMITTED FOR WAINSCOTING OR PANELING OF NOT MORE THAN 1,000 SF OF APPLIED SURFACE AREA IN THE GRADE

MEANS OF EGRESS

BCNYS TABLE 1006.2.1 - SPACES WITH ONE EXIT MAX. COMMON PATH OF TRAVEL (SPRINKLERED) MAX. OCCUPANT LOAD

BCNYS TABLE 1006.3.2 - MINIMUM NUMBER OF EXITS PER STORY


OCCUPANT LOAD PER STORY MINIMUM NUMBER OF EXITS
1-500 ? BCNYS 1017 EXIT ACCESS TRAVEL DISTANCE - TABLE 1017.2

USE OF SPACE

	FUNCTION	SF/OCCUPANT
В	BUSINESS	150 GROSS
B(A)	BUSINESS: SMALL ASSEMBLY - UNCONCENTRATED	15 NET
B(S)	ACCESSORY STORAGE, MECH., AND EQUIPMENT	300 GROSS
А3	ASSEMBLY: CONCENTRATED	7 NET

SYMBOLS LEGEND

ROOM NAME	- ROOM NAME - ROOM NUMBER	INTERIOR FIRE F	RESISTANT	
B 1500	SQUARE FOOTAGE NO. OCC. BY CODE	•••••	1 HR	
	- NO. OCC. BY PROGRAM		2 HR	
<u>/</u>	OCCUPANCY GROUP	•••••	2 HR SPECIAL APPLICATION	
•	TRAVEL PATH		SPRINKLER AT GLASS	
X	EXIT DESIGNATION	igotimes	WALL MTD	
FEC	FIRE EXTINGUISHER CABINET	Υ	EXIT SIGN	
FER	FIRE EXTINGUISHER	$\overline{\mathbf{S}}$	CEILING MTD EXIT SIGN	
	RACK	 P	PENDANT MTD EXIT SIGN	

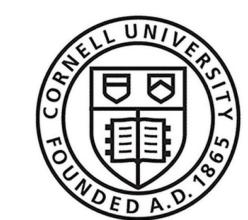

Cornell University Ithaca, NY 14853

ARCHITECT: Mitchell Giurgola

Mitchell Giurgola Architects LLP 630 Ninth Avenue, Suite 711 New York, New York 10036 (212) 663 4000

MEPFP ENGINEER: ME Engineering 300 Trolley Boulevard Rochester, Ny 14606 (585) 288-5590

STRUCTURAL AND EXTERIOR RENOVATION: Simpson Gumpertz & Heger Associates, Inc (SGH) 800 Boylston St, Suite 2320 Boston, MA 02199

LIGHTING DESIGN: Cline Bettridge Bernstein Lighting Design 116 East 27th Street, 4th Floor New York, NY 10016 (212) 741-3280

AUDIOVISUAL, IT, SECURITY: Cerami Associates 1001 Avenue of the Americas, 4th Floor

(212) 370-1776 ACOUSTICS: Longman Lindsey 200 West 41st St, Suite 1100 New York, NY 10036


(212) 370-1776

FOOD SERVICE: Jacobs Doland Beer 192 Lexington Avenue, Suite 804 New York, NY 10016 (212) 937-1097

SEAL:



NO.	DATE	COMMENTS
1	05/06/25	ADDENDUM 04

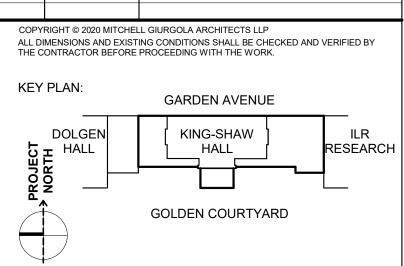

RENOVATE 2ND - 5TH FLOOR AT KING-SHAW HALL

140 Garden Ave, Ithaca, NY 14853

DRAWING TITLE:


CODE COMPLIANCE PLANS - SECOND - FIFTH **FLOORS**


PROJECT NO: 240400 DATE: 01/31/2025 SCALE: PHASE: 100% CD

A-001R



 $\frac{\text{CODE COMPLIANCE PLAN - SECOND FLOOR}}{\text{SCALE: } 1/16" = 1'-0"}$

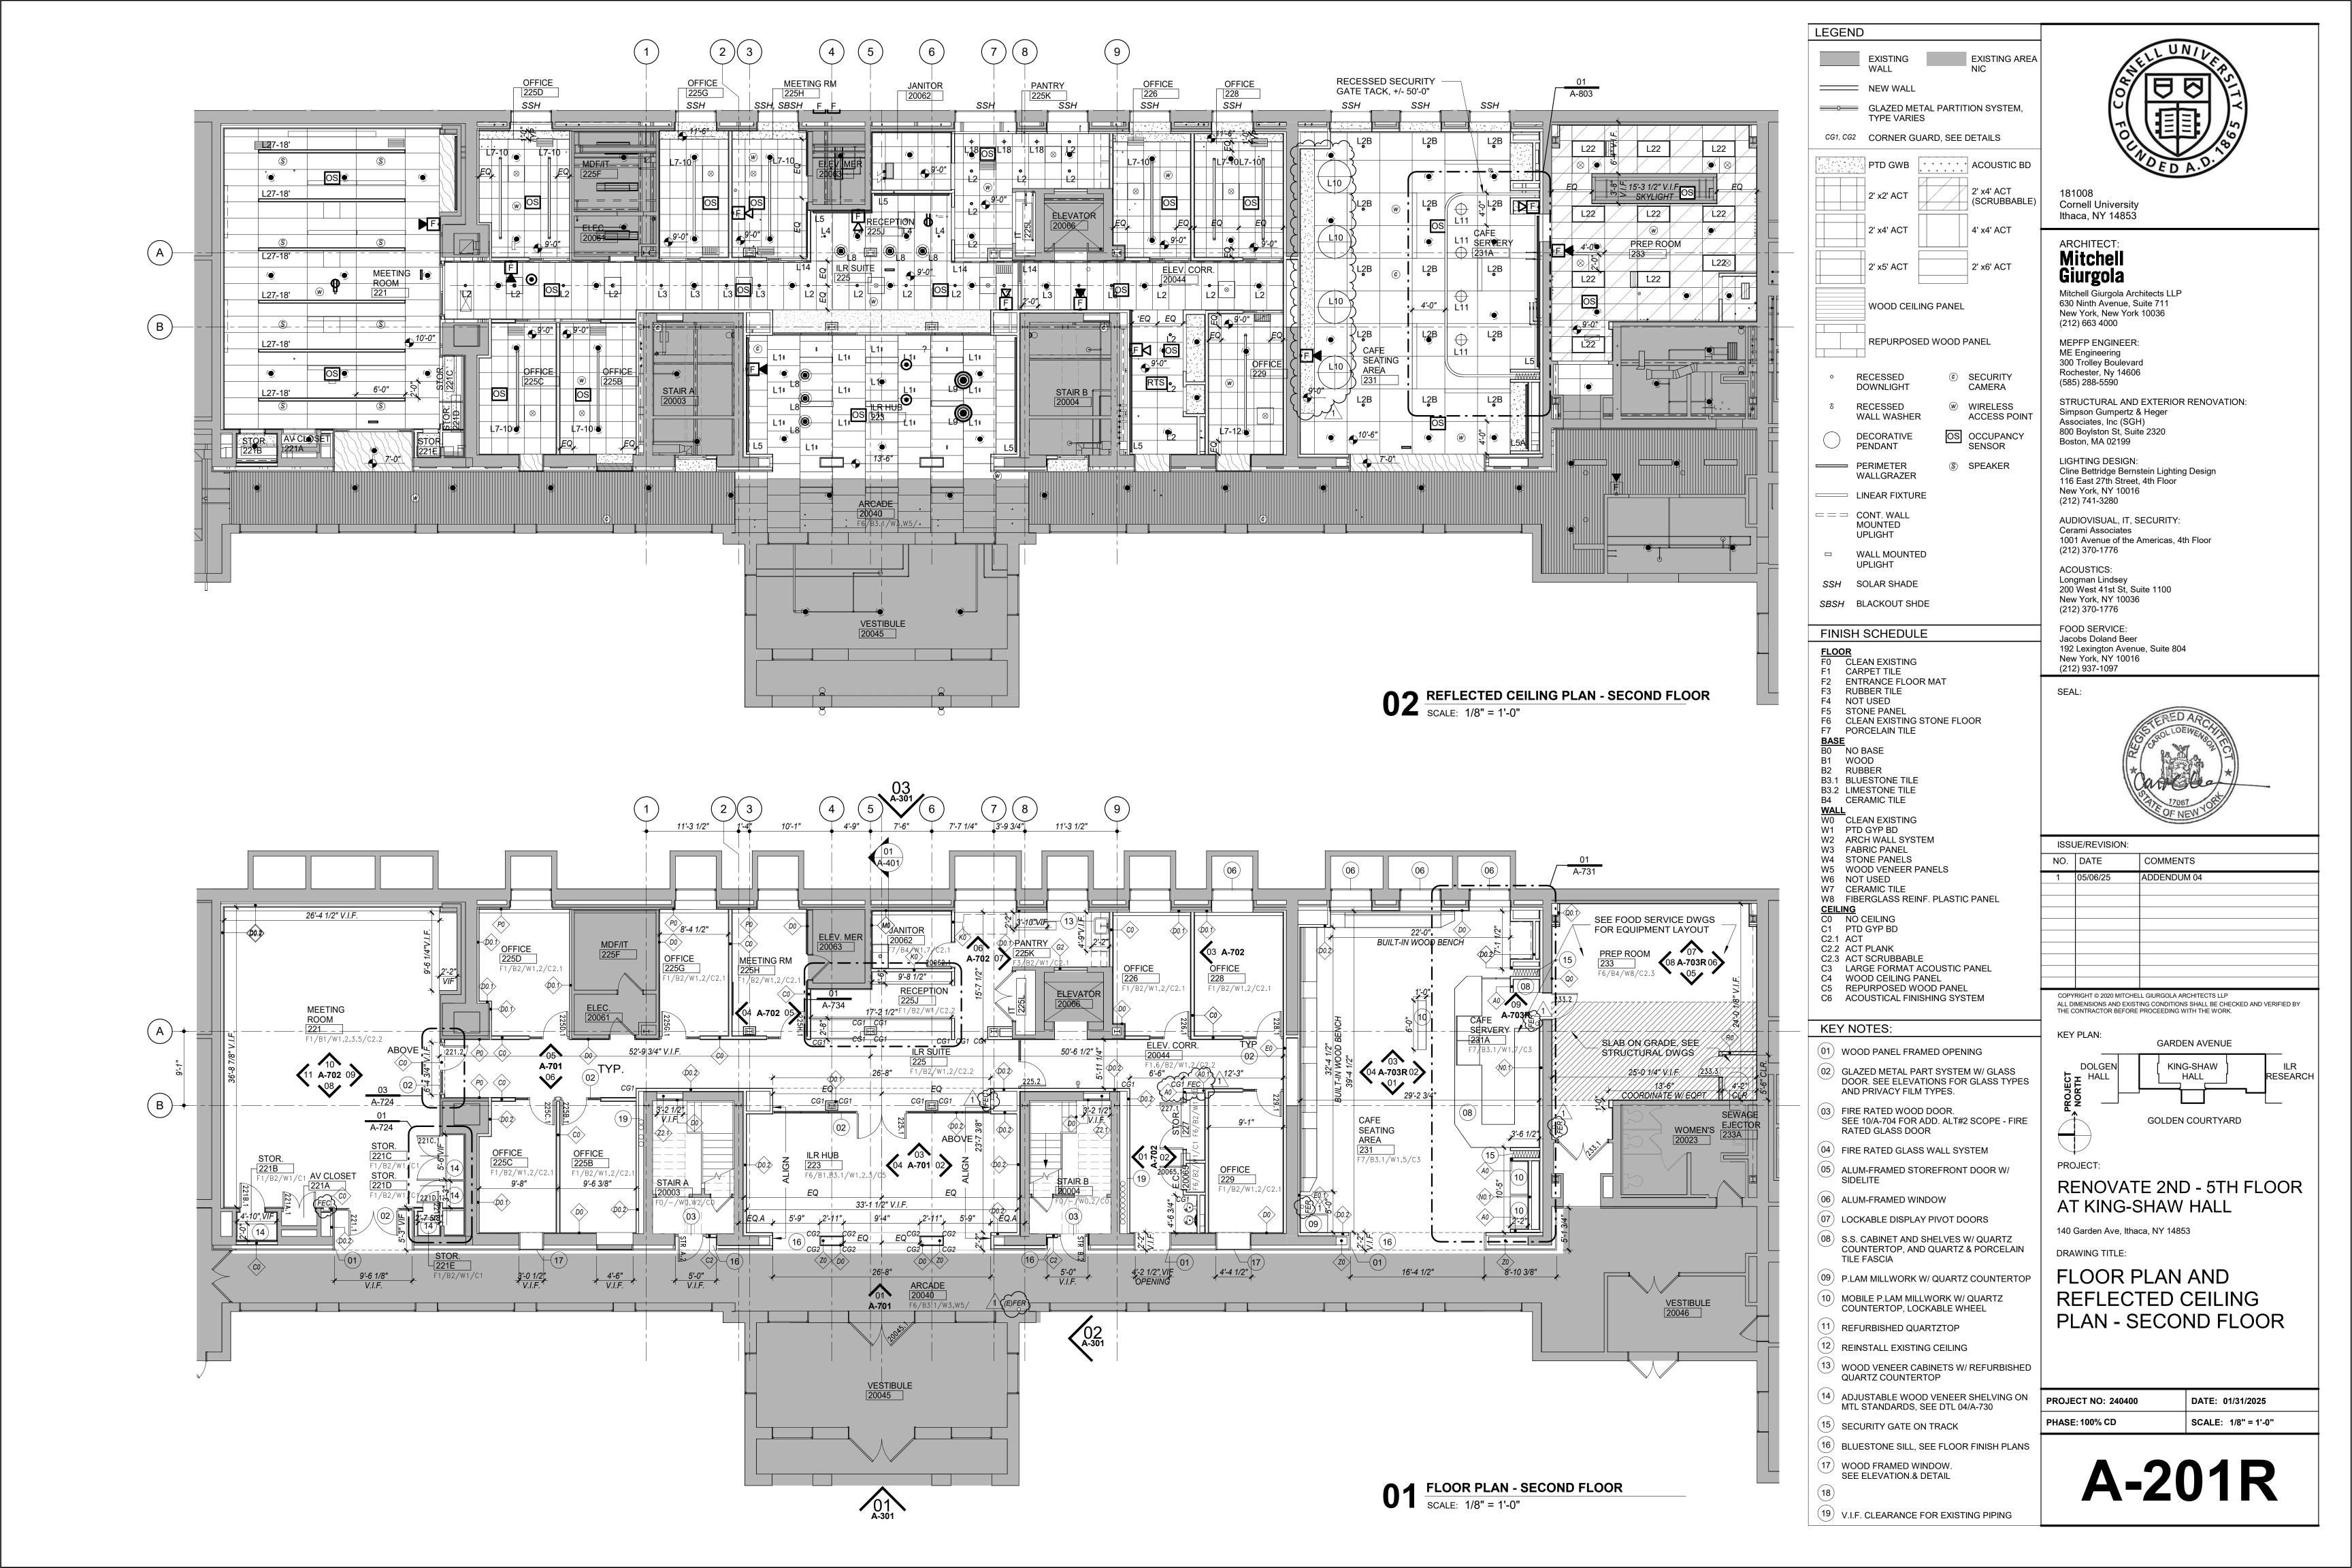

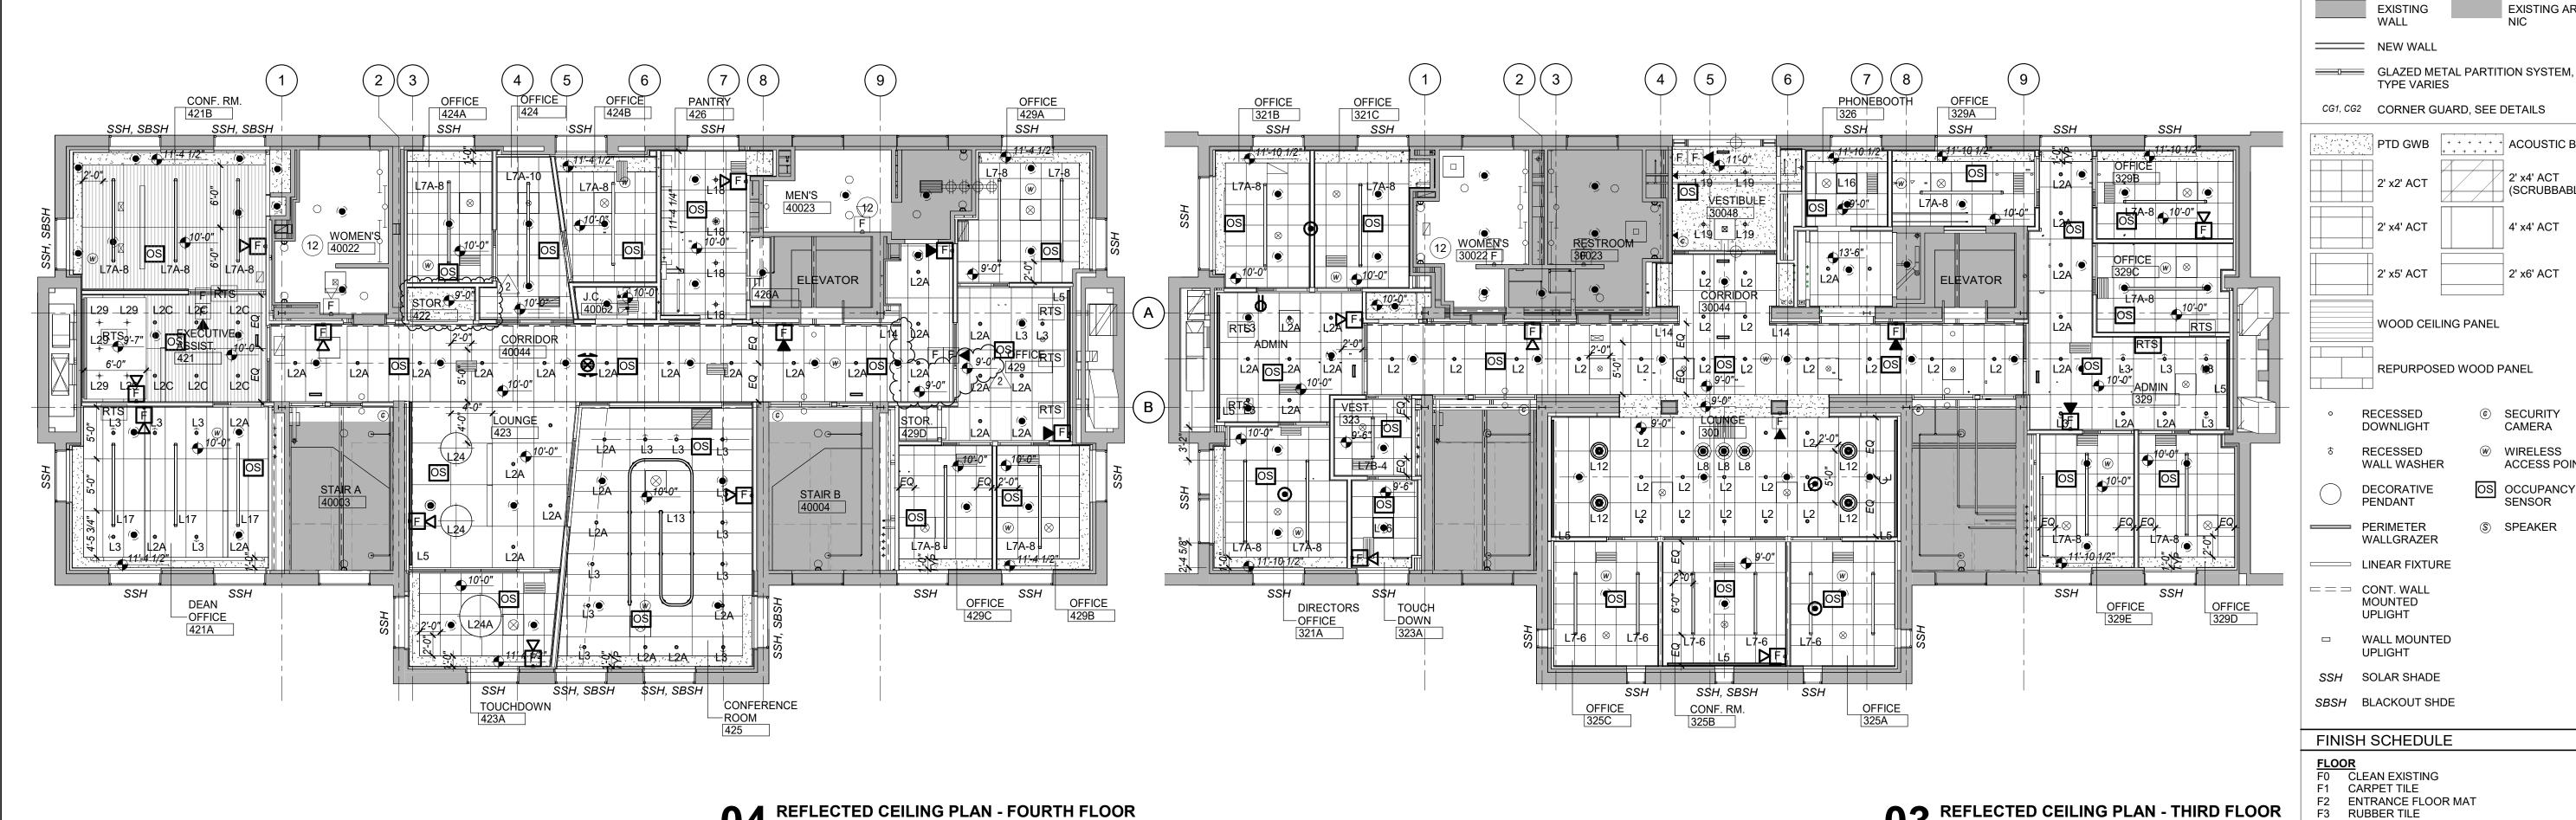


REFLECTED CEILING PLAN - FOURTH FLOOR

SCALE: 1/8" = 1'-0"

02 FLOOR PLAN - FOURTH FLOOR SCALE: 1/8" = 1'-0"

 $03^{\frac{\text{REFLECTED CEILING PLAN - THIRD FLOOR}}{\text{SCALE: } 1/8" = 1'-0"}}$

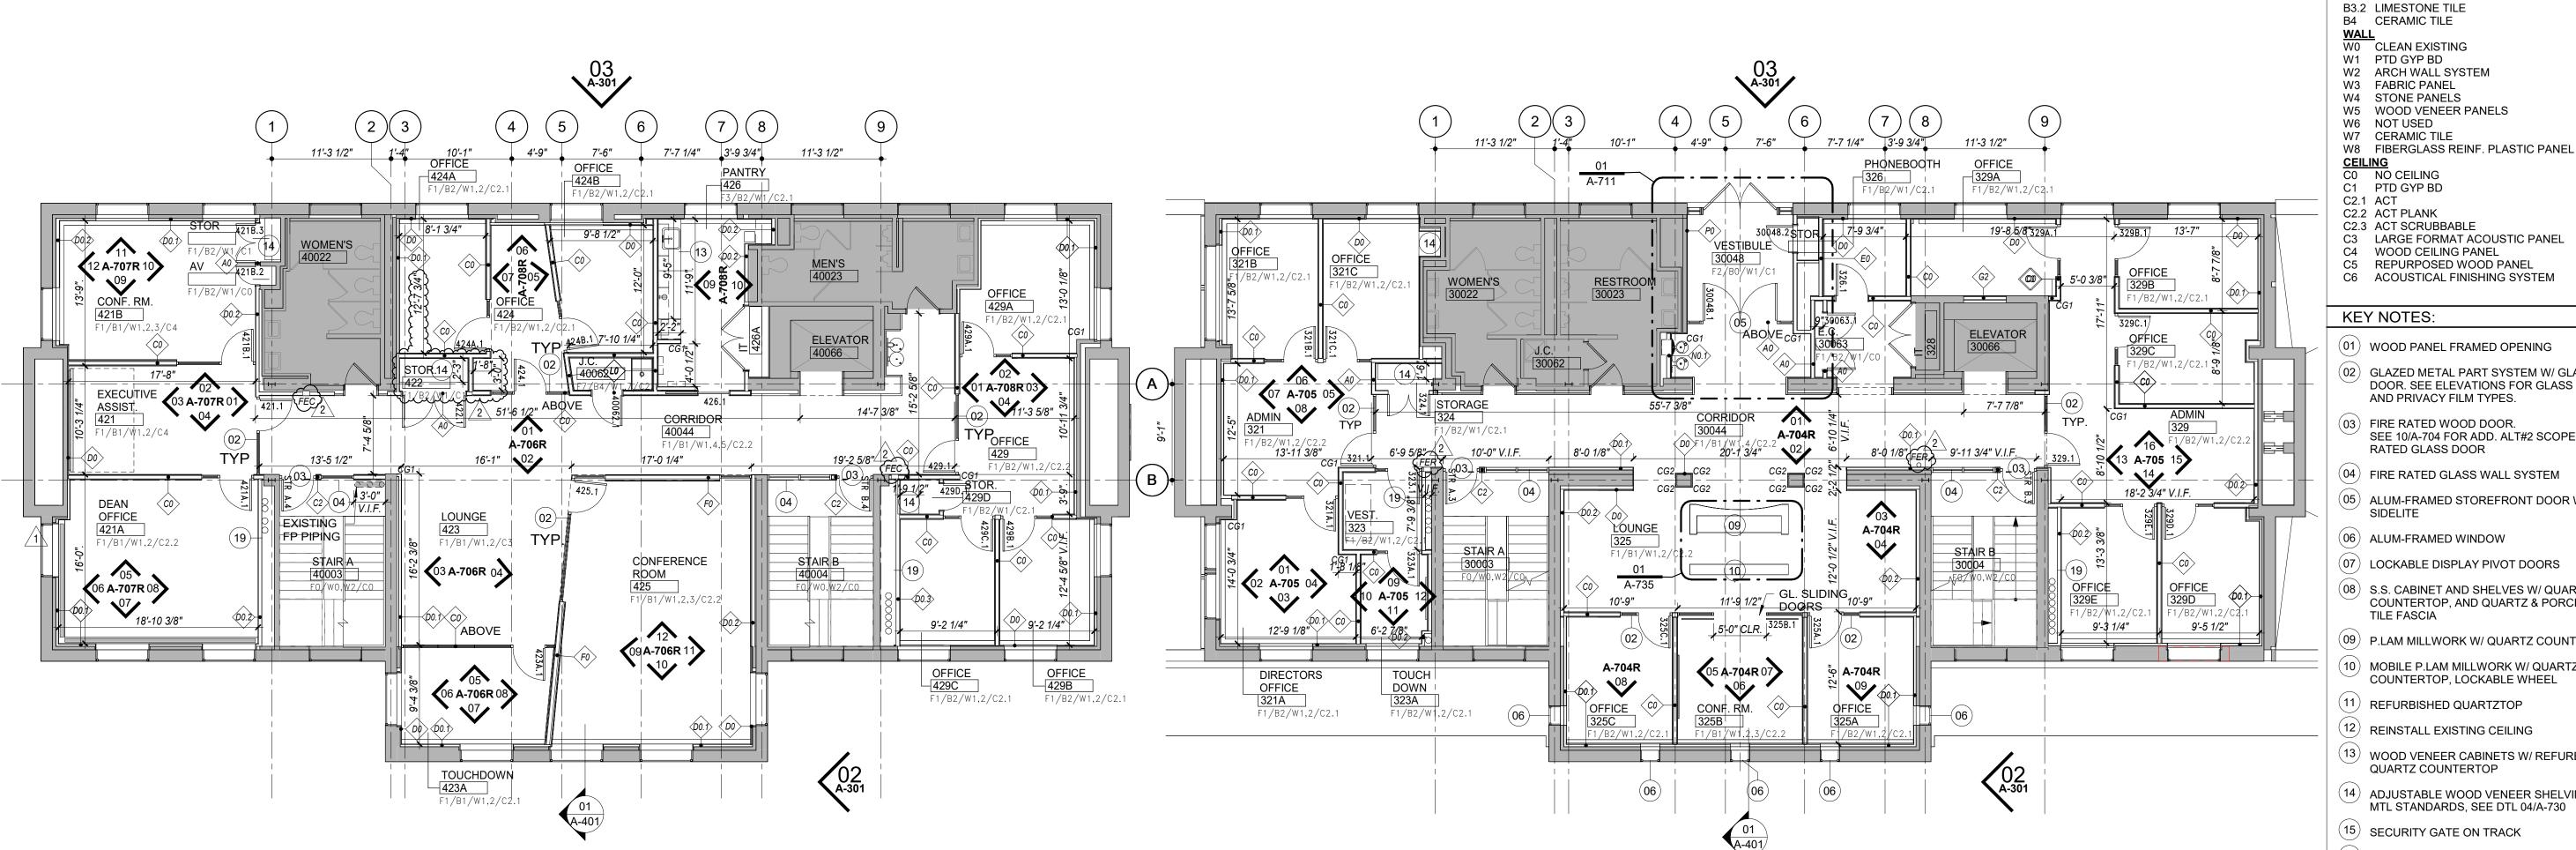

1 FLOOR PLAN - THIRD FLOOR SCALE: 1/8" = 1'-0"

Cornell University Ithaca, NY 14853

EXISTING AREA

+ + + + + ACOUSTIC BD

2' x4' ACT (SCRUBBABLE)

4' x4' ACT

SECURITY

ARCHITECT: **Mitchell** Giurgola

Mitchell Giurgola Architects LLP 630 Ninth Avenue, Suite 711 New York, New York 10036 (212) 663 4000

MEPFP ENGINEER: ME Engineering 300 Trolley Boulevard Rochester, Ny 14606 (585) 288-5590

CAMERA STRUCTURAL AND EXTERIOR RENOVATION: W WIRELESS Simpson Gumpertz & Heger ACCESS POINT Associates, Inc (SGH) 800 Boylston St, Suite 2320 OS OCCUPANCY

Boston, MA 02199 LIGHTING DESIGN: Cline Bettridge Bernstein Lighting Design 116 East 27th Street, 4th Floor New York, NY 10016

> (212) 741-3280 AUDIOVISUAL, IT, SECURITY: Cerami Associates 1001 Avenue of the Americas, 4th Floor

(212) 370-1776 ACOUSTICS: Longman Lindsey 200 West 41st St, Suite 1100

New York, NY 10036

(212) 370-1776 FOOD SERVICE: Jacobs Doland Beer 192 Lexington Avenue, Suite 804 New York, NY 10016

SEAL:

(212) 937-1097



ISSUE/REVISION:				
NO.	DATE	COMMENTS		
1	04/29/25	ADDENDUM 03		
2	05/06/25	ADDENDUM 04		

ALL DIMENSIONS AND EXISTING CONDITIONS SHALL BE CHECKED AND VERIFIED BY THE CONTRACTOR BEFORE PROCEEDING WITH THE WORK.

GARDEN AVENUE

KING-SHAW

HALL

RESEARCH

KEY NOTES:

LEGEND

TYPE VARIES

PTD GWB

2' x4' ACT

RECESSED

RECESSED

WALL WASHER

DECORATIVE

WALLGRAZER

MOUNTED

UPLIGHT

UPLIGHT

F4 NOT USED F5 STONE PANEL

BASE B0 NO BASE B1 WOOD B2 RUBBER

F7 PORCELAIN TILE

B3.1 BLUESTONE TILE

F6 CLEAN EXISTING STONE FLOOR

PENDANT

DOWNLIGHT

WOOD CEILING PANEL

REPURPOSED WOOD PANEL

(01) WOOD PANEL FRAMED OPENING

02 GLAZED METAL PART SYSTEM W/ GLASS DOOR. SEE ELEVATIONS FOR GLASS TYPES AND PRIVACY FILM TYPES.

(03) FIRE RATED WOOD DOOR. SEE 10/A-704 FOR ADD. ALT#2 SCOPE - FIRE RATED GLASS DOOR

(04) FIRE RATED GLASS WALL SYSTEM

(05) ALUM-FRAMED STOREFRONT DOOR W/ SIDELITE

(06) ALUM-FRAMED WINDOW

(07) LOCKABLE DISPLAY PIVOT DOORS (08) S.S. CABINET AND SHELVES W/ QUARTZ COUNTERTOP, AND QUARTZ & PORCELAIN

TILE FASCIA (09) P.LAM MILLWORK W/ QUARTZ COUNTERTO

(10) MOBILE P.LAM MILLWORK W/ QUARTZ COUNTERTOP, LOCKABLE WHEEL

(11) REFURBISHED QUARTZTOP

(12) REINSTALL EXISTING CEILING

(13) WOOD VENEER CABINETS W/ REFURBISHED QUARTZ COUNTERTOP

ADJUSTABLE WOOD VENEER SHELVING ON MTL STANDARDS, SEE DTL 04/A-730

(15) SECURITY GATE ON TRACK

(16) BLUESTONE SILL, SEE FLOOR FINISH PLANS (17) WOOD FRAMED WINDOW. SEE ELEVATION.& DETAIL

(19) V.I.F. CLEARANCE FOR EXISTING PIPING

GOLDEN COURTYARD RENOVATE 2ND - 5TH FLOOR

AT KING-SHAW HALL 140 Garden Ave, Ithaca, NY 14853

DRAWING TITLE:


DOLGEN


₽ + HALL

FLOOR PLANS AND REFLECTED CEILING PLANS - THIRD & FOURTH FLOOR

PROJECT NO: 240400 DATE: 01/31/2025 PHASE: 100% CD SCALE: 1/8" = 1'-0"

A-202R

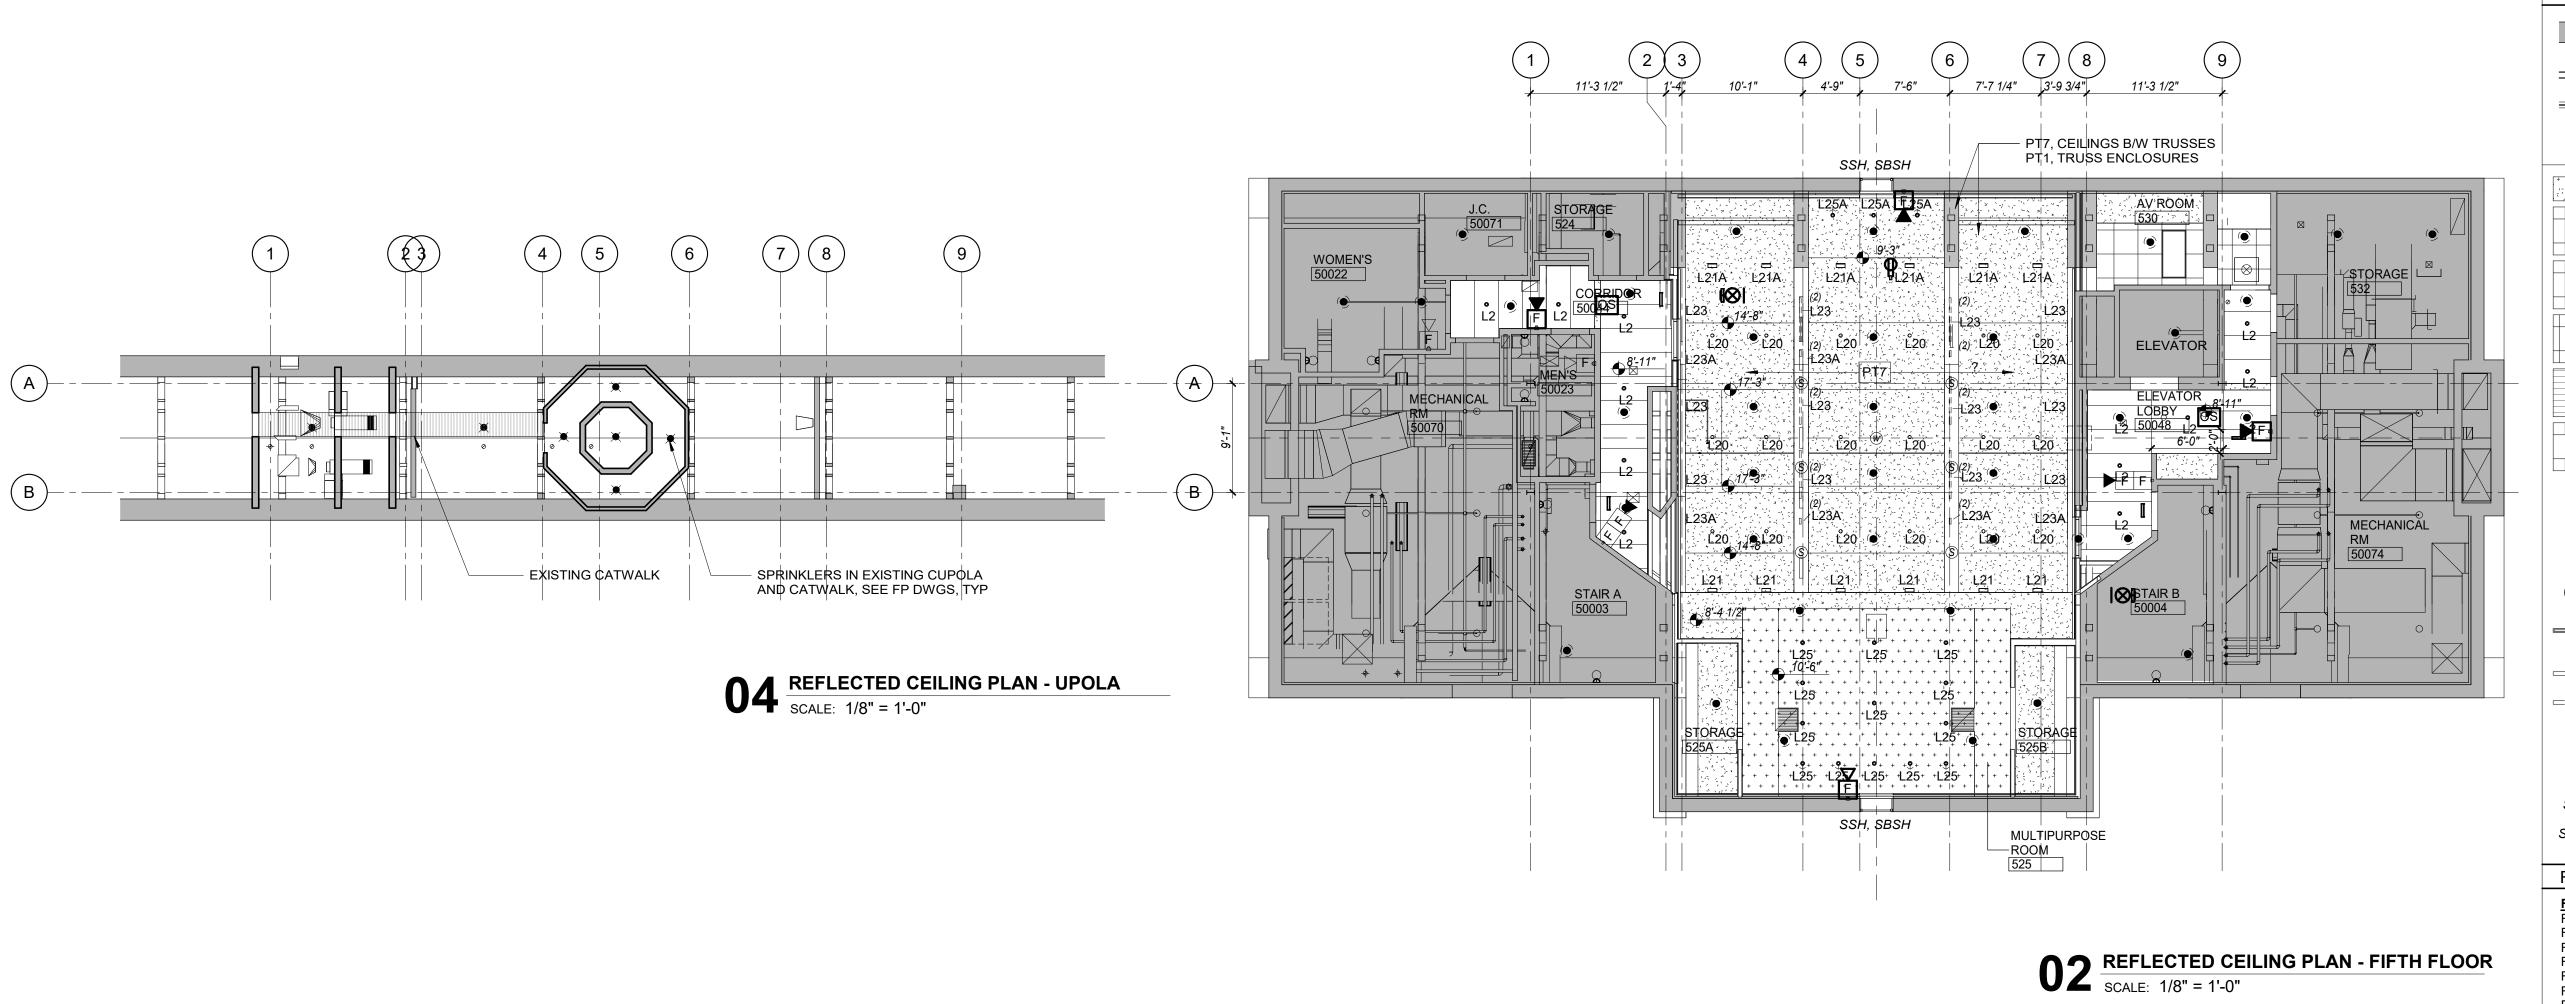

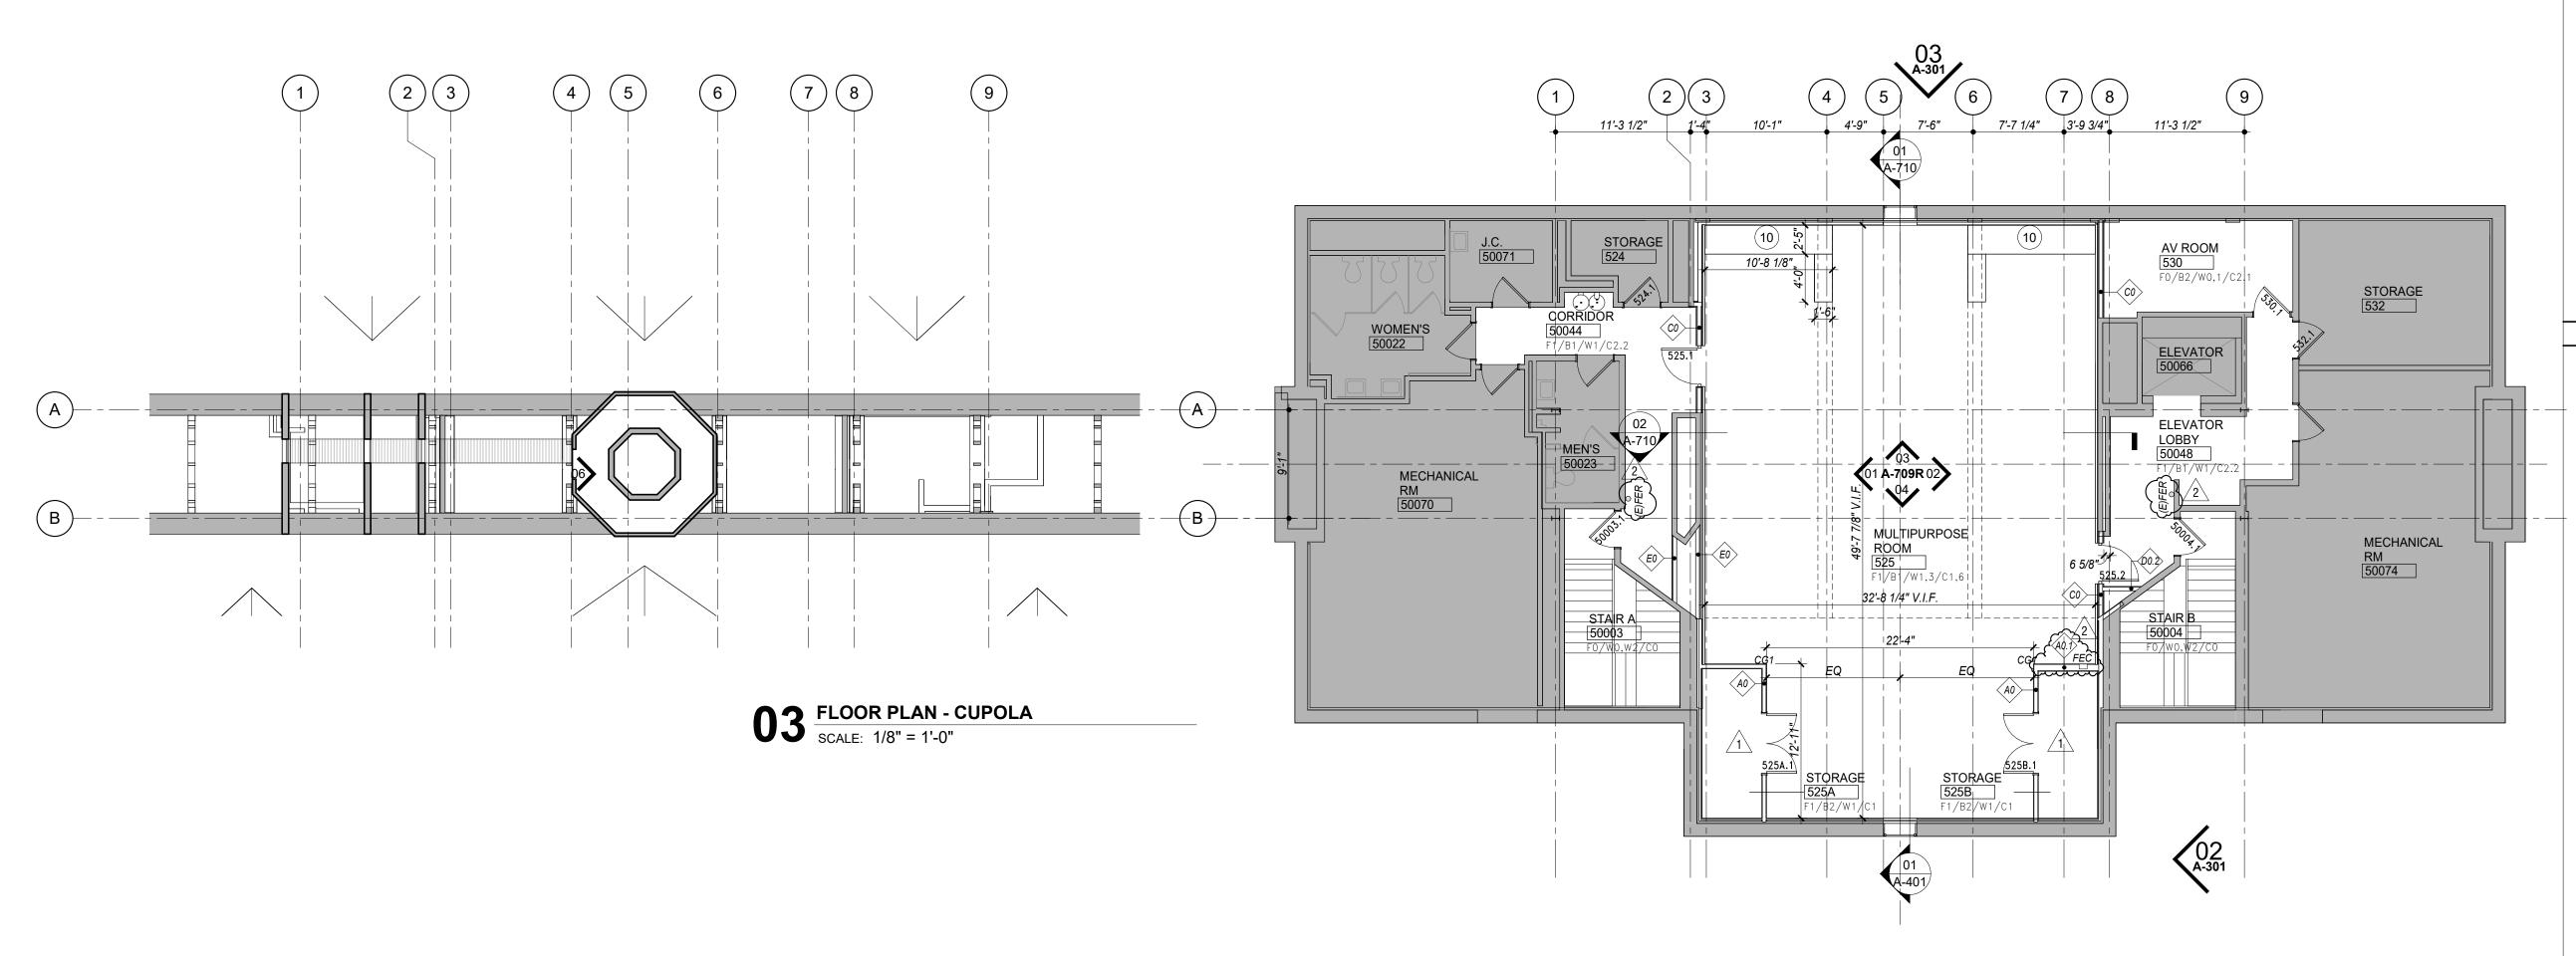

LEGEND EXISTING EXISTING AREA NEW WALL GLAZED METAL PARTITION SYSTEM, TYPE VARIES CG1, CG2 CORNER GUARD, SEE DETAILS PTD GWB + + + + + + ACOUSTIC BD 2' x4' ACT 2' x2' ACT (SCRUBBABLE) Cornell University Ithaca, NY 14853 2' x4' ACT 4' x4' ACT ARCHITECT: **Mitchell** Giurgola Mitchell Giurgola Architects LLP 630 Ninth Avenue, Suite 711 WOOD CEILING PANEL New York, New York 10036 (212) 663 4000 REPURPOSED WOOD PANEL MEPFP ENGINEER: ME Engineering 300 Trolley Boulevard Rochester, Ny 14606 ⑤ SECURITY RECESSED (585) 288-5590 DOWNLIGHT CAMERA STRUCTURAL AND EXTERIOR RENOVATION: RECESSED W WIRELESS Simpson Gumpertz & Heger WALL WASHER ACCESS POINT Associates, Inc (SGH) 800 Boylston St, Suite 2320 OS OCCUPANCY DECORATIVE Boston, MA 02199 SENSOR PENDANT LIGHTING DESIGN: PERIMETER Cline Bettridge Bernstein Lighting Design WALLGRAZER 116 East 27th Street, 4th Floor New York, NY 10016 LINEAR FIXTURE (212) 741-3280 = = = CONT. WALL AUDIOVISUAL, IT, SECURITY: MOUNTED Cerami Associates UPLIGHT 1001 Avenue of the Americas, 4th Floor (212) 370-1776 □ WALL MOUNTED UPLIGHT ACOUSTICS: Longman Lindsey SSH SOLAR SHADE 200 West 41st St, Suite 1100 New York, NY 10036 SBSH BLACKOUT SHDE (212) 370-1776 FOOD SERVICE: FINISH SCHEDULE Jacobs Doland Beer 192 Lexington Avenue, Suite 804 FLOOR F0 CLEAN EXISTING New York, NY 10016 (212) 937-1097 F1 CARPET TILE F2 ENTRANCE FLOOR MAT F3 RUBBER TILE SEAL: F4 NOT USED F5 STONE PANEL F6 CLEAN EXISTING STONE FLOOR F7 PORCELAIN TILE BASE B0 NO BASE B1 WOOD B2 RUBBER B3.1 BLUESTONE TILE **B3.2 LIMESTONE TILE** B4 CERAMIC TILE **WALL** W0 CLEAN EXISTING
W1 PTD GYP BD W2 ARCH WALL SYSTEM ISSUE/REVISION: W3 FABRIC PANEL W4 STONE PANELS NO. DATE COMMENTS W5 WOOD VENEER PANELS ADDENDUM 03 W6 NOT USED W7 CERAMIC TILE 05/06/25 ADDENDUM 04 W8 FIBERGLASS REINF. PLASTIC PANEL CEILING
CO NO CEILING C1 PTD GYP BD C2.1 ACT C2.2 ACT PLANK C2.3 ACT SCRUBBABLE C3 LARGE FORMAT ACOUSTIC PANEL C4 WOOD CEILING PANEL C5 REPURPOSED WOOD PANEL C6 ACOUSTICAL FINISHING SYSTEM ALL DIMENSIONS AND EXISTING CONDITIONS SHALL BE CHECKED AND VERIFIED BY THE CONTRACTOR BEFORE PROCEEDING WITH THE WORK. **KEY NOTES: GARDEN AVENUE** (01) WOOD PANEL FRAMED OPENING DOLGEN KING-SHAW 02 GLAZED METAL PART SYSTEM W/ GLASS DOOR. SEE ELEVATIONS FOR GLASS TYPES AND PRIVACY FILM TYPES. HALL HALL RESEARCH HALL (03) FIRE RATED WOOD DOOR. SEE 10/A-704 FOR ADD. ALT#2 SCOPE - FIRE GOLDEN COURTYARD RATED GLASS DOOR (04) FIRE RATED GLASS WALL SYSTEM (05) ALUM-FRAMED STOREFRONT DOOR W/ SIDELITE RENOVATE 2ND - 5TH FLOOR (06) ALUM-FRAMED WINDOW AT KING-SHAW HALL (07) LOCKABLE DISPLAY PIVOT DOORS 140 Garden Ave, Ithaca, NY 14853 (08) S.S. CABINET AND SHELVES W/ QUARTZ COUNTERTOP, AND QUARTZ & PORCELAIN DRAWING TITLE: TILE FASCIA FLOOR PLAN AND (09) P.LAM MILLWORK W/ QUARTZ COUNTERTOF REFLECTED CEILING (10) MOBILE P.LAM MILLWORK W/ QUARTZ COUNTERTOP, LOCKABLE WHEEL PLAN - FIFTH FLOOR (11) REFURBISHED QUARTZTOP (12) REINSTALL EXISTING CEILING (13) WOOD VENEER CABINETS W/ REFURBISHED QUARTZ COUNTERTOP ADJUSTABLE WOOD VENEER SHELVING ON MTL STANDARDS, SEE DTL 04/A-730 **PROJECT NO: 240400** DATE: 01/31/2025 (15) SECURITY GATE ON TRACK PHASE: 100% CD SCALE: 1/8" = 1'-0" (16) BLUESTONE SILL, SEE FLOOR FINISH PLANS (17) WOOD FRAMED WINDOW. SEE ELEVATION.& DETAIL

1 FLOOR PLAN - FIFTH FLOOR
SCALE: 1/8" = 1'-0"


(18)


wood framed window. SEE ELEVATION.& DETAIL


18

19

V.I.F. CLEARANCE FOR EXISTING PIPING

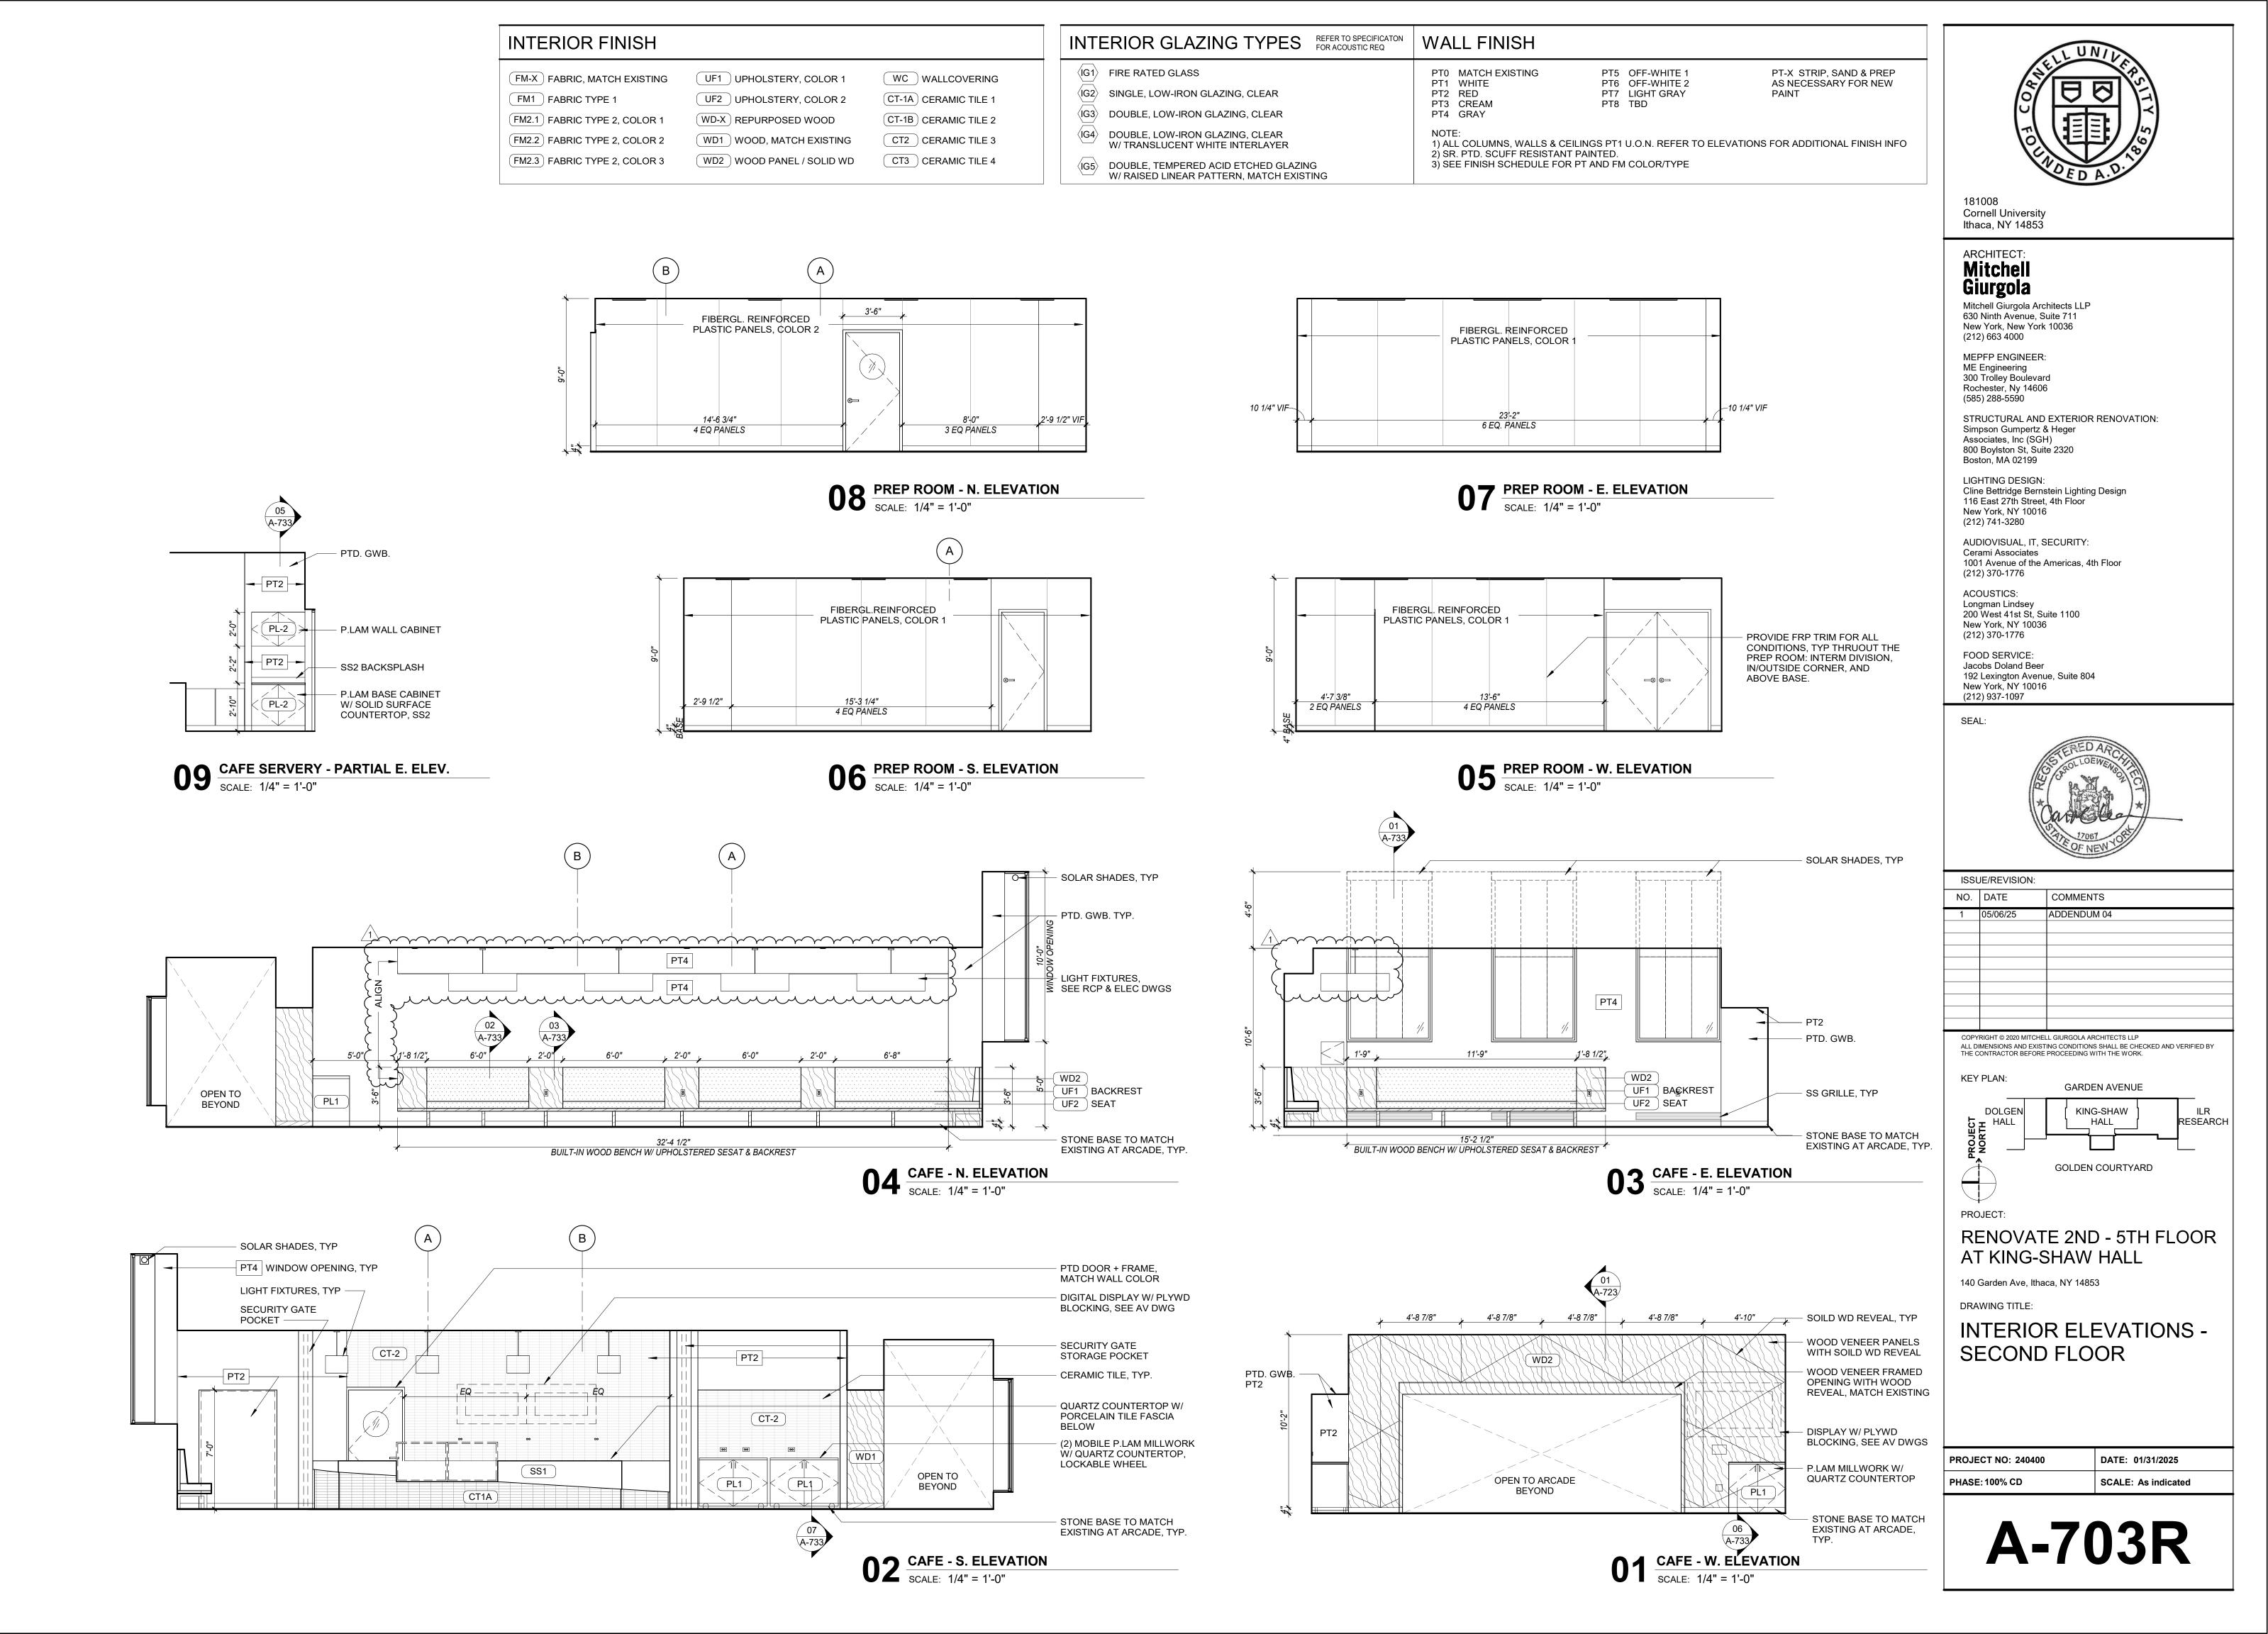

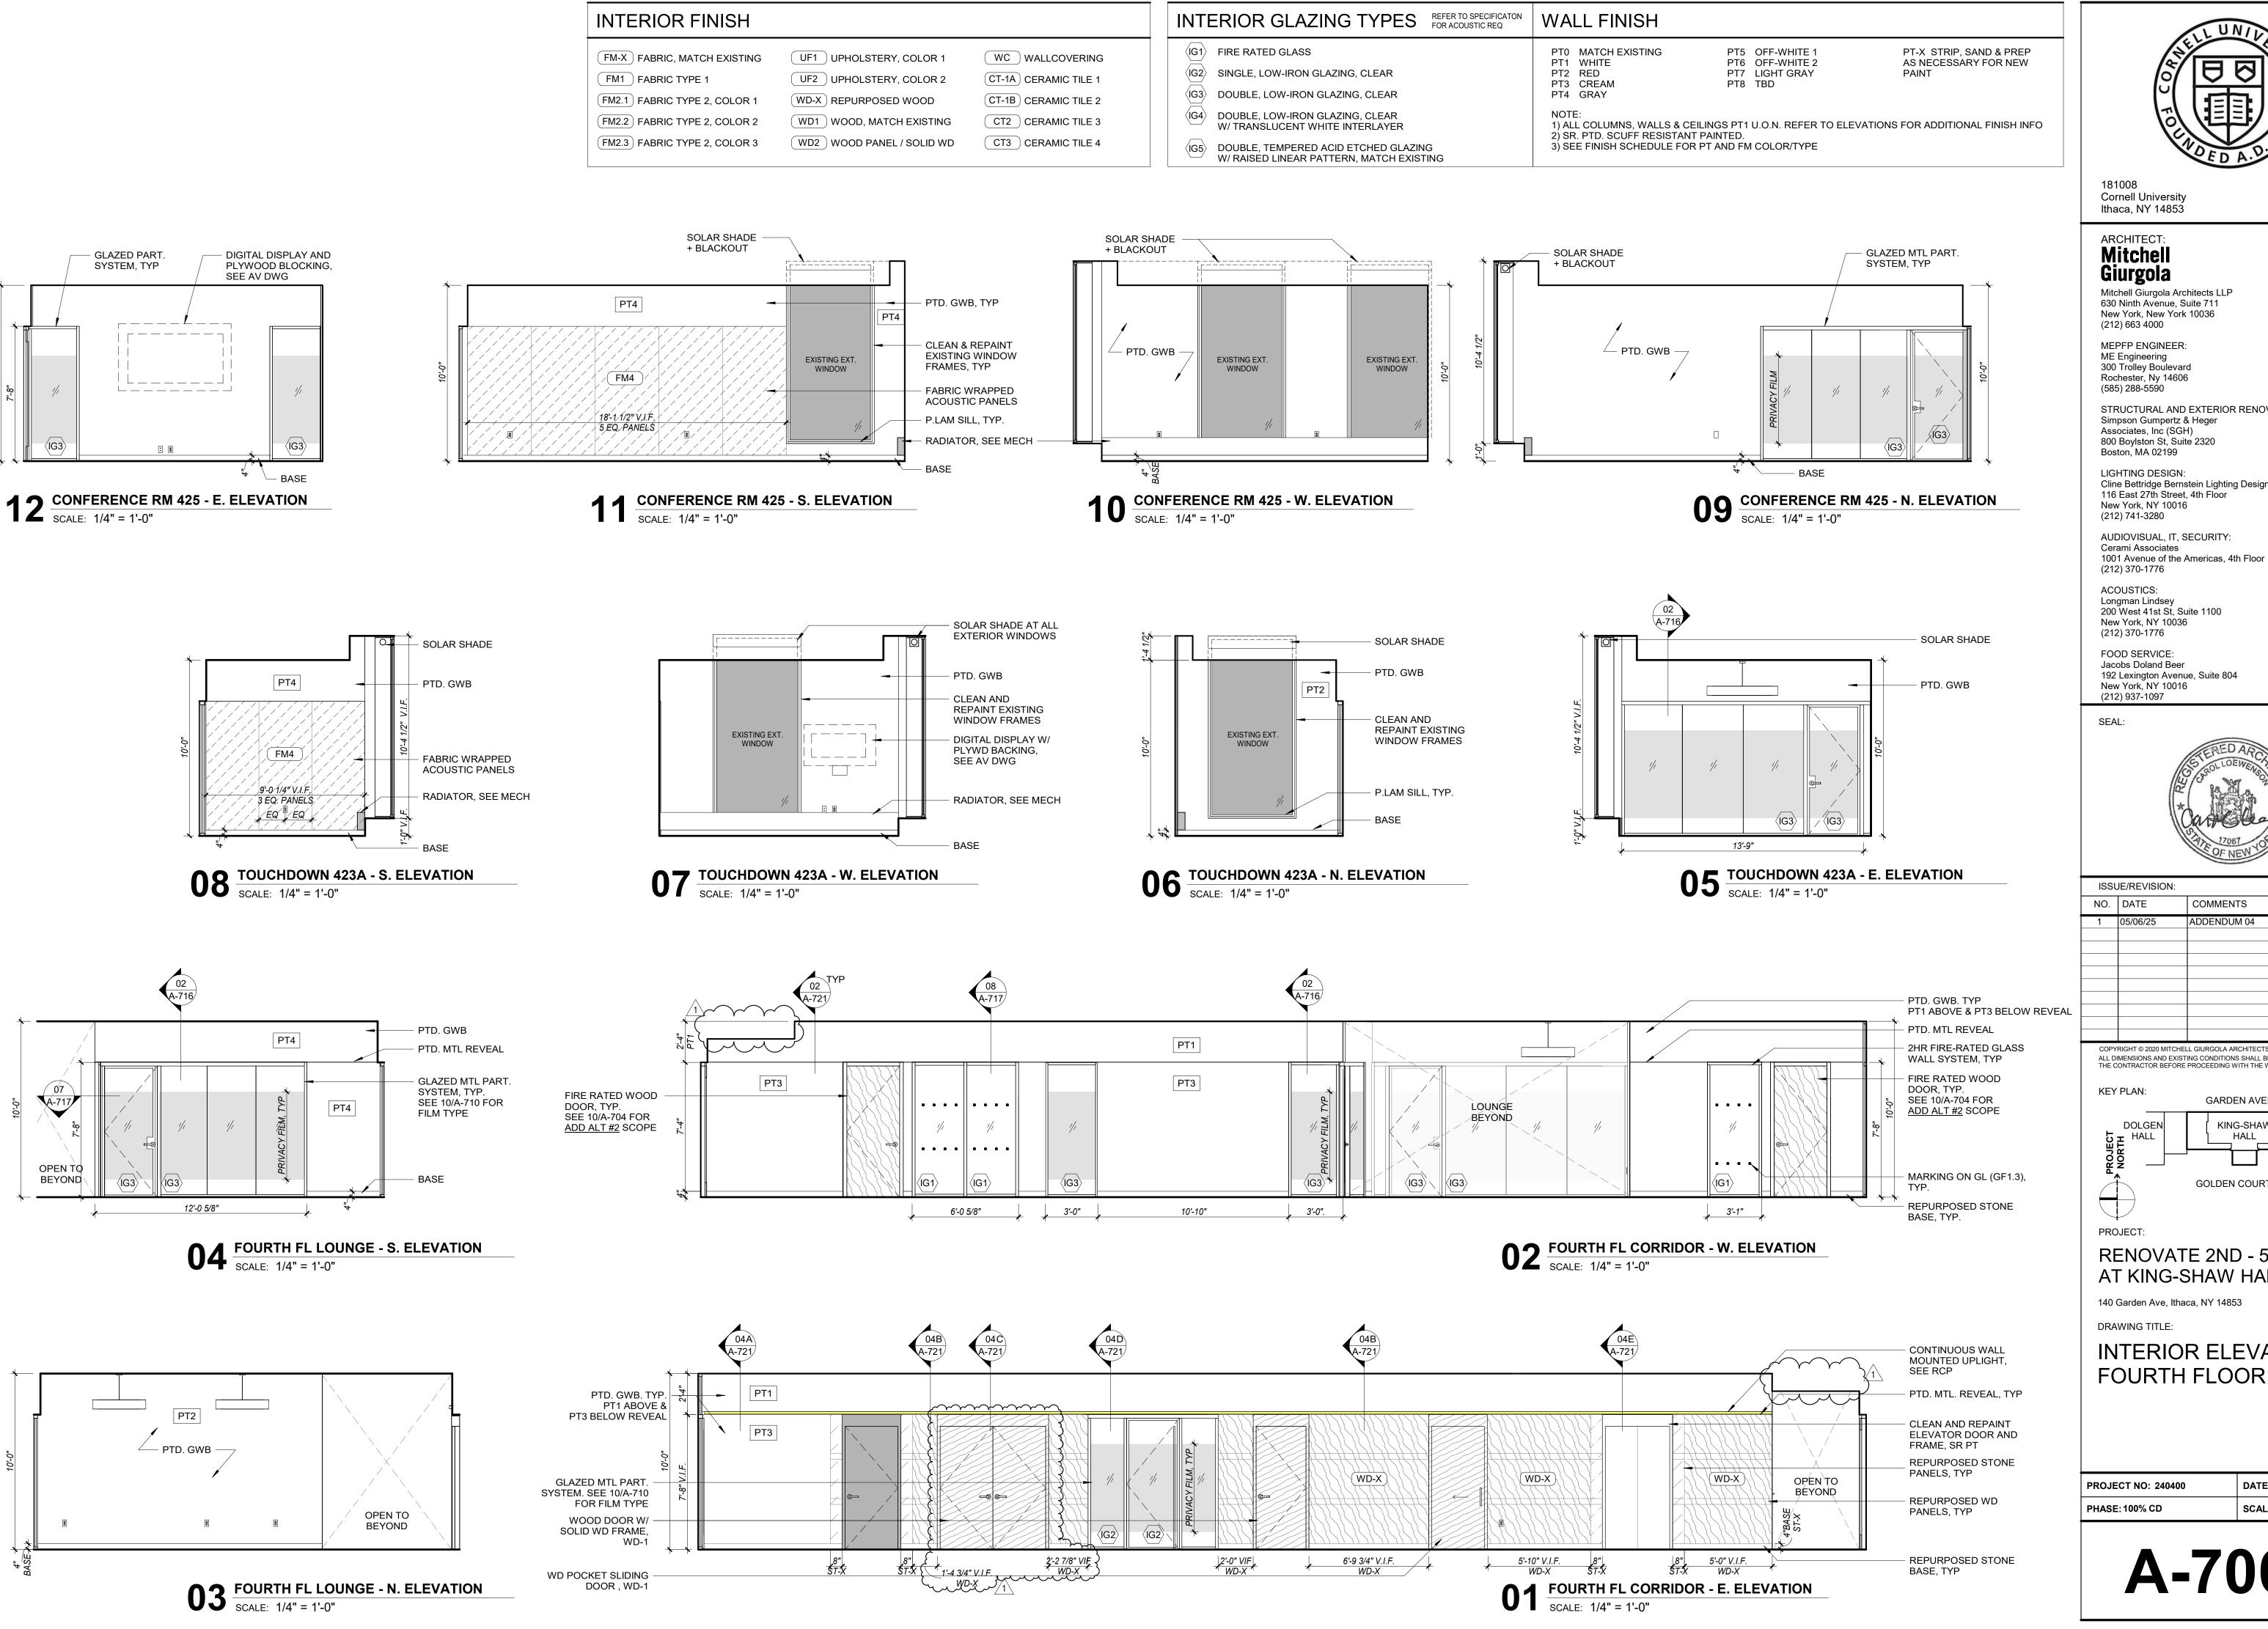

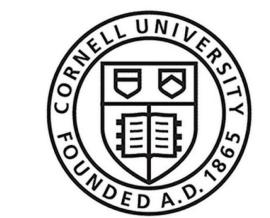

Cornell University Ithaca, NY 14853

ARCHITECT: Mitchell Giurgola

Mitchell Giurgola Architects LLP 630 Ninth Avenue, Suite 711 New York, New York 10036 (212) 663 4000

MEPFP ENGINEER: ME Engineering 300 Trolley Boulevard Rochester, Ny 14606 (585) 288-5590

STRUCTURAL AND EXTERIOR RENOVATION: Simpson Gumpertz & Heger Associates, Inc (SGH)

Boston, MA 02199 LIGHTING DESIGN: Cline Bettridge Bernstein Lighting Design 116 East 27th Street, 4th Floor New York, NY 10016

(212) 741-3280 AUDIOVISUAL, IT, SECURITY: Cerami Associates

1001 Avenue of the Americas, 4th Floor (212) 370-1776

ACOUSTICS: Longman Lindsey 200 West 41st St, Suite 1100 New York, NY 10036 (212) 370-1776


FOOD SERVICE: Jacobs Doland Beer 192 Lexington Avenue, Suite 804 New York, NY 10016 (212) 937-1097

SEAL:



133	UE/REVISION	
NO.	DATE	COMMENTS
1	05/06/25	ADDENDUM 04

THE CONTRACTOR BEFORE PROCEEDING WITH THE WORK.

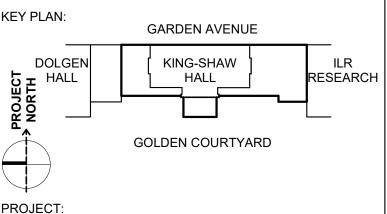

RENOVATE 2ND - 5TH FLOOR AT KING-SHAW HALL


140 Garden Ave, Ithaca, NY 14853

DRAWING TITLE: **INTERIOR ELEVATIONS -**

DATE: 01/31/2025

SCALE: As indicated

A-706R

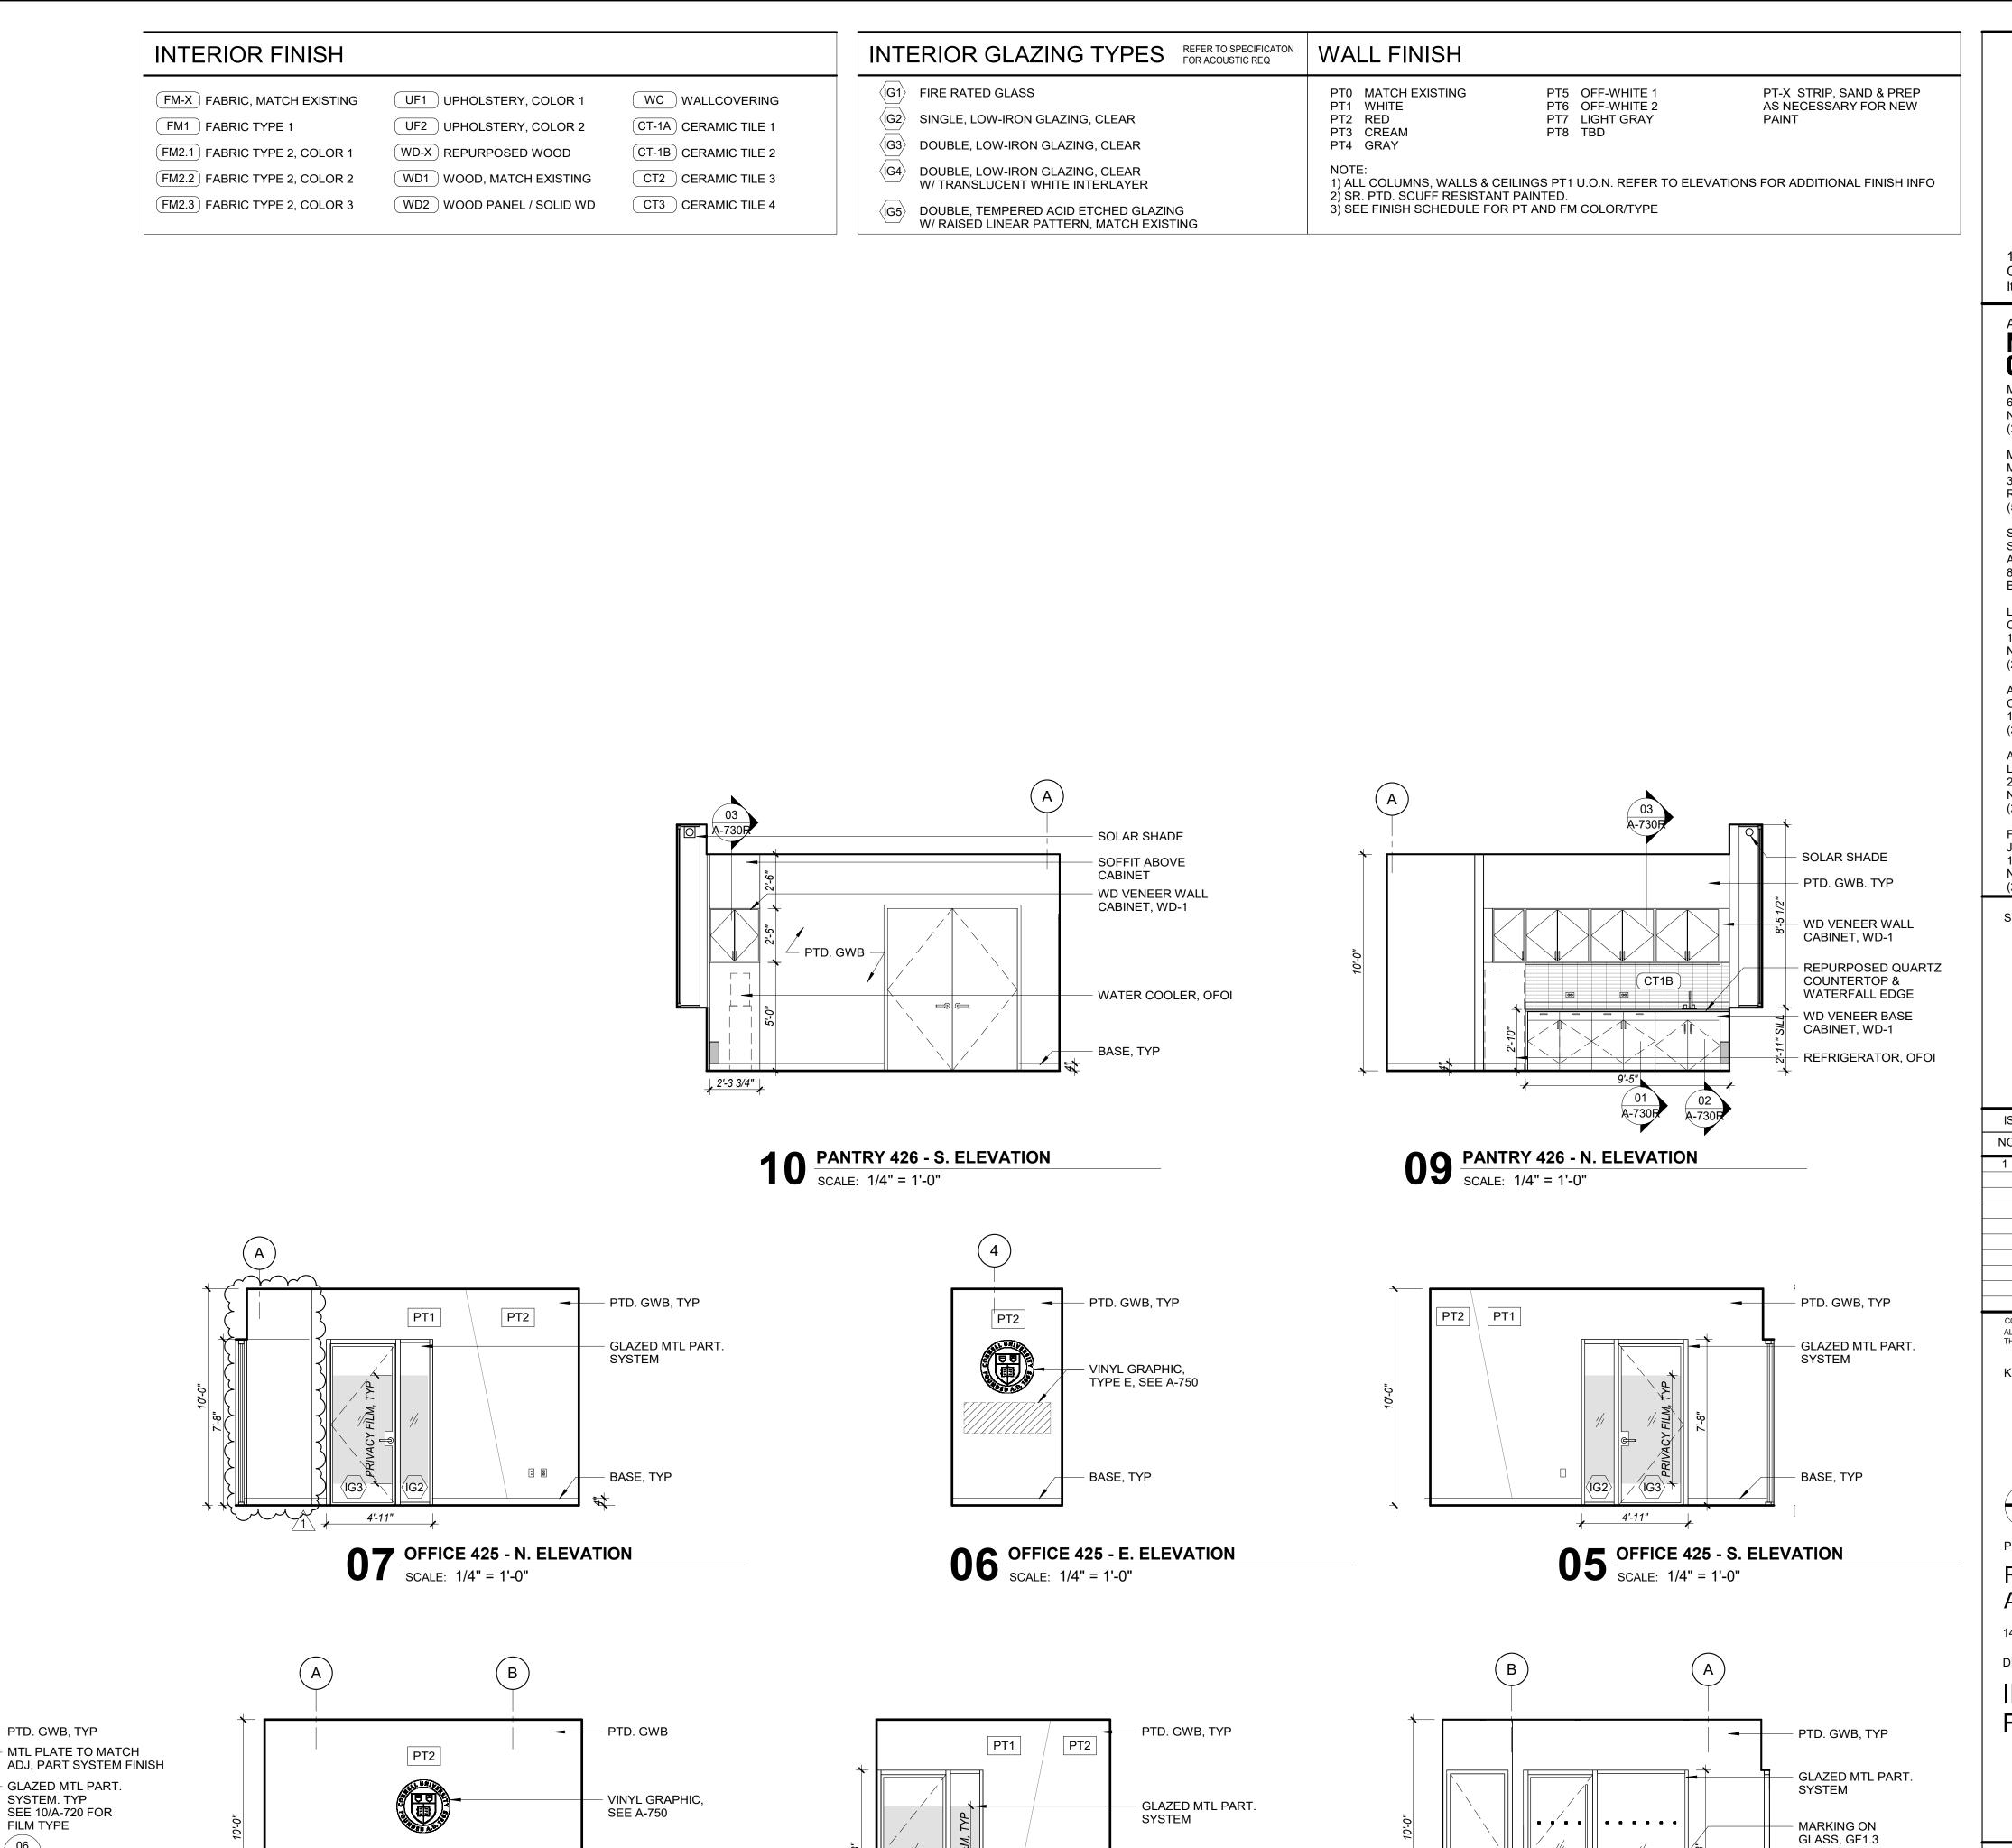

PT2

PT1

4'-11" 4'-10 1/2"

OFFICE 429 - W. ELEVATIONSCALE: 1/4" = 1'-0"

SYSTEM. TYP

9 :


03 OFFICE 429 - S. ELEVATION SCALE: 1/4" = 1'-0"

BASE

4'-11"

07 OFFICE 429 - E. ELEVATION SCALE: 1/4" = 1'-0"

FILM TYPE

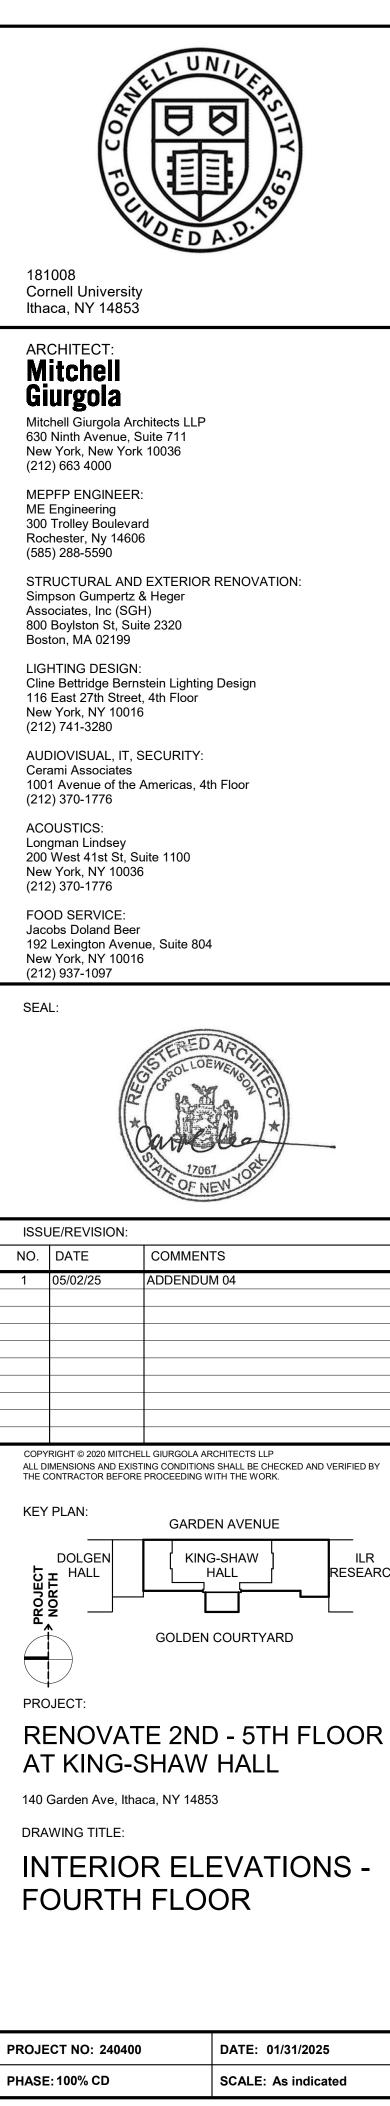

A-708R

- BASE, TYP

(IG2)


|| (IG2)

Office 429 - N. ELEVATION

SCALE: 1/4" = 1'-0"

7'-7 1/4"

RESEARCH

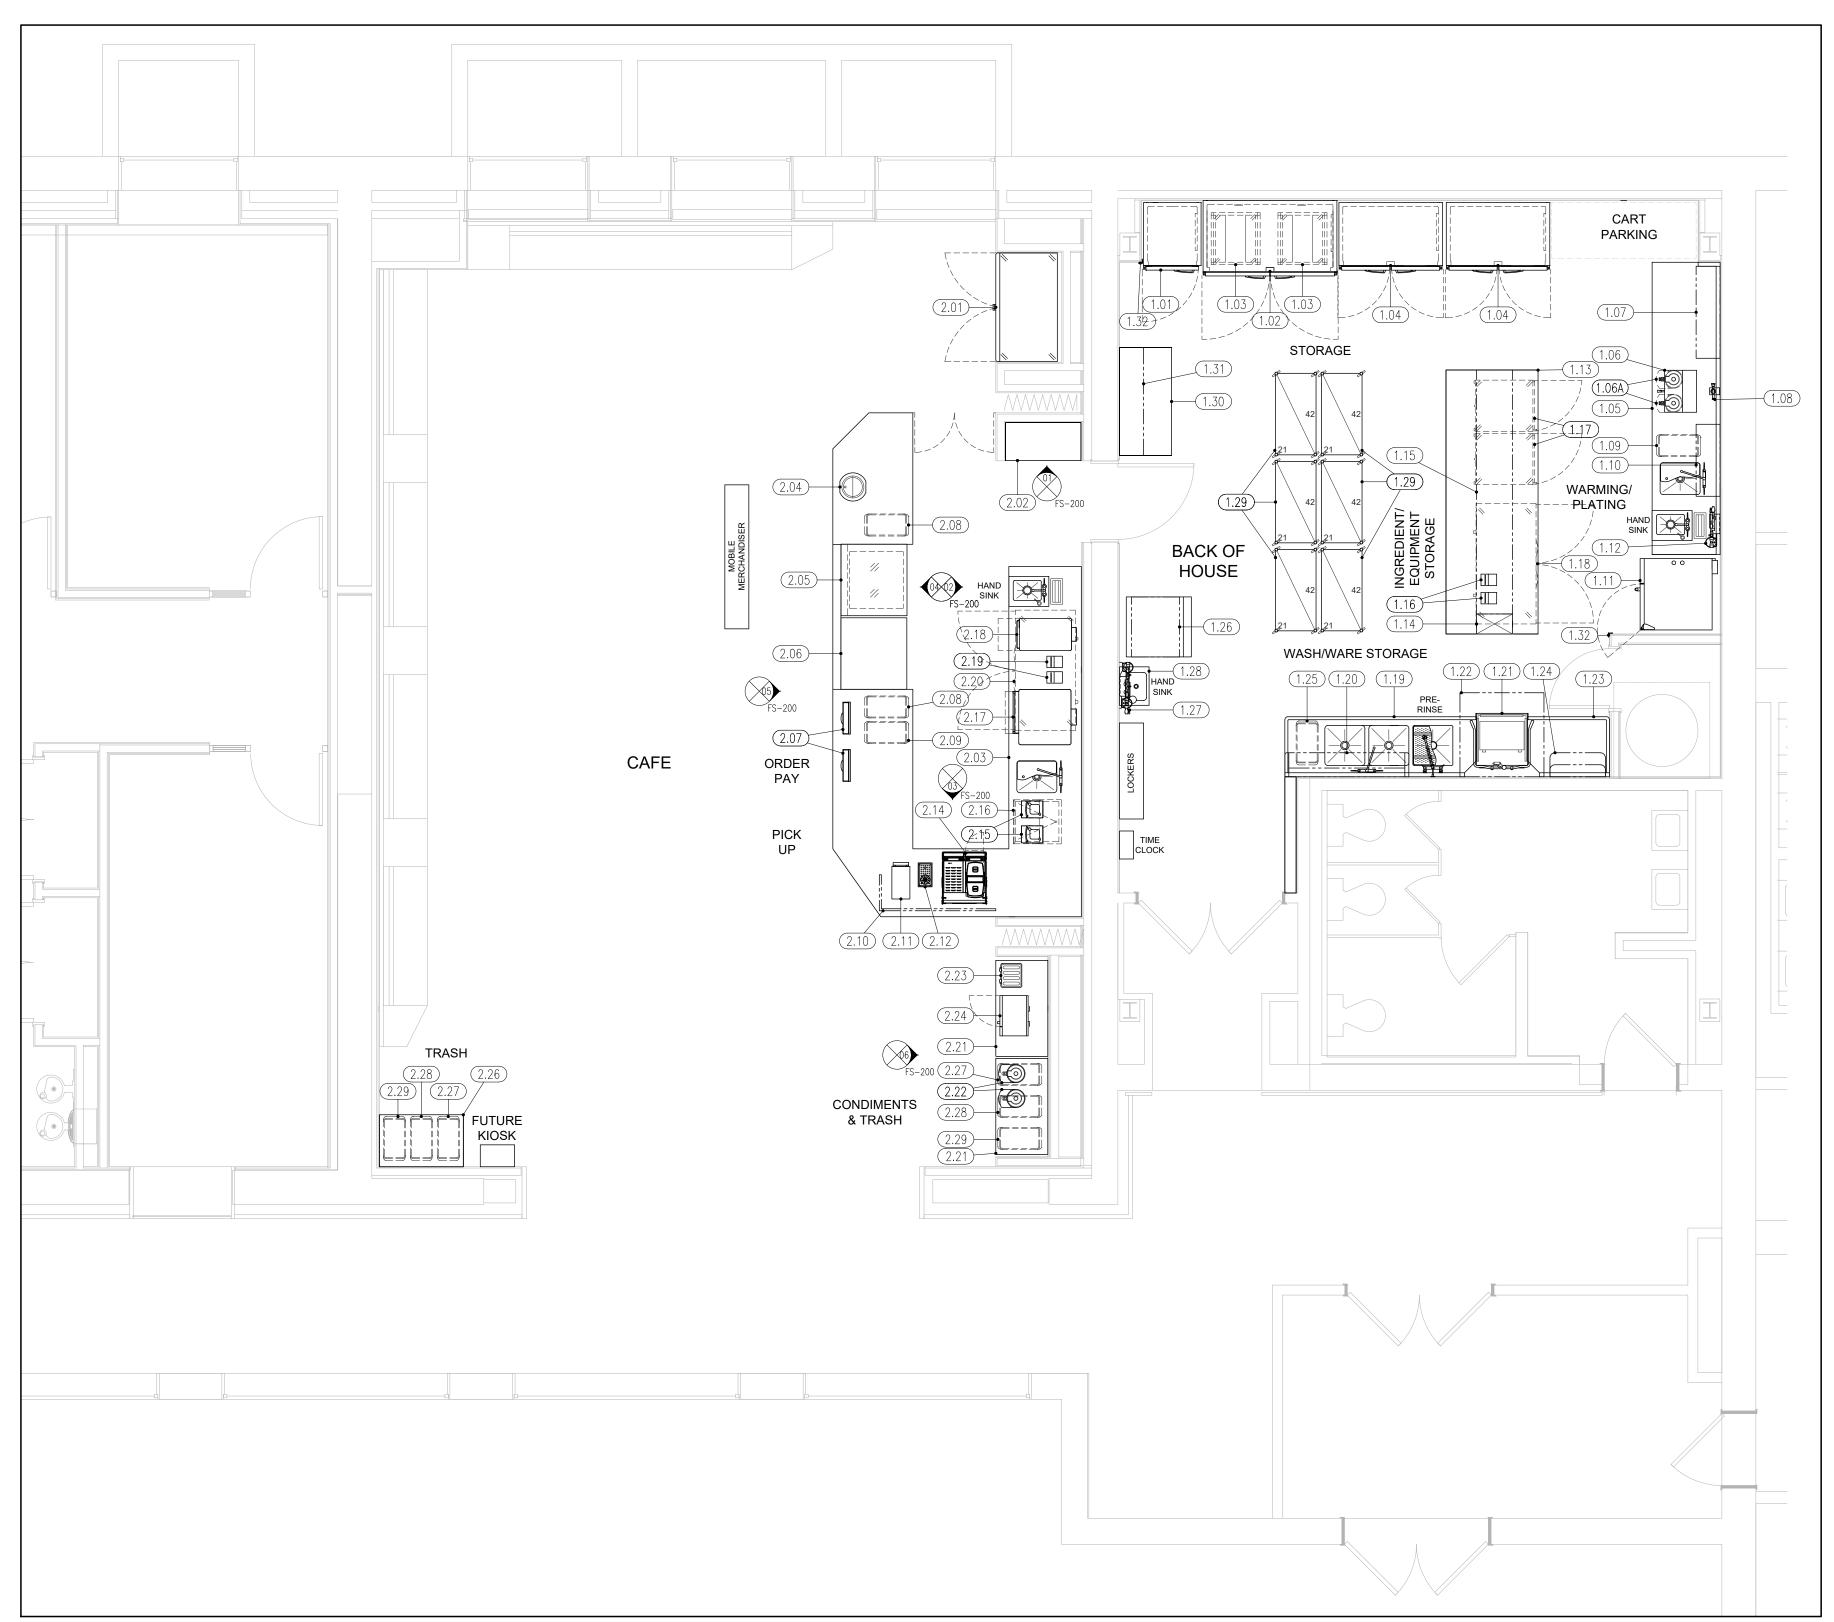


\	2FL FOODSERVICE EQUIPMENT PLAN


ITEM NO	REV	QTY	EQUIPMENT SCHEDULE EQUIPMENT CATEGORY	EQUIPMENT REMARKS
1.00	1 \ \ \ \	ر ا	***BACK OF HOUSE***	EGGI WENT INDIVINIO
1.00		1	FREEZER, REACH-IN	
1.01		1	REFRIGERATOR, ROLL-IN	
			UNIVERSAL PAN RACK	
1.03		2		
1.04		2	REFRIGERATOR, REACH-IN	
1.05		1	WORKTABLE WITH SINKS	
1.06		1	COFFEE BREWER	
1.06A		2	COFFEE DISPENSER	
1.07		1	WALL SHELF	
1.08		1	WATER FILTRATION SYSTEM	
1.09		1	TRASH CONTAINER	
1.10		1	FIRE SUPPRESSION SYSTEM	FOR ITEM 1.11
1.11		1	COMBI OVEN, VENTLESS	
1.12		1	WATER FILTRATION SYSTEM	
1.13		1	WORKTABLE	
1.14		1	UTILITY CHASE	
1.15		1	OVERSHELF, TABLE-MOUNTED	
1.16		2	POS PRINTER	NIC / BY OWNER
1.17		2	HEATED CABINET, MOBILE	
1.18		1	REFRIGERATOR, UNDERCOUNTER	
1.19		1	THREE (3) COMPARTMENT SINK WITH SCRAP BASKET	
1.20		1	POT RACK WALL SHELF	
1.21		1	DISHWASHER, DOOR TYPE	
1.22		1	CONDENSATE HOOD	
1.23		1	CLEAN DISHTABLE	
1.24		1	POT RACK, WALL-MOUNTED	
1.25		1	COMPOST CONTAINER	
1.26		1	ICE MAKER WITH BIN	EXISTING, RELOCATED
1.27		1	WATER FILTRATION SYSTEM	
1.28		1	HAND SINK	
1.29		6	SHELVING, MOBILE	
1.30	1	1	DESK	NIC / BY OWNER
1.31	1	1	WALL SHELVING	NIC / BY OWNER
1.32		2	CORNER GUARD	
2.00			***FRONT OF HOUSE***	
2.01		1	REFRIGERATED MERCHANDISER	
2.02		1	MILLWORK COUNTER	
2.03		1	MILLWORK COUNTER WITH SINKS	
2.04		1	SOUP WELL, DROP-IN	
2.05		1	DISPLAY CASE, NON-REFRIGERATED	
2.06		1	DISPLAY CASE, REFRIGERATED	
2.07		2	KIOSK ORDERING SYSTEM	NIC / BY OWNER
2.08		2	TRASH CONTAINER	
2.09		1	COMPOST CONTAINER	
2.10		1	FOOD GUARD	NIC / BY MILLWORK
2.11		1	COLD BREW COFFEE DISPENSER	
2.12		1	DRIP TROUGH	
2.13			SPARE NUMBER	
2.14		1	ESPRESSO CAPPUCCINO MACHINE	
2.15		2	BLENDER	
2.16		1	ICE CADDY, MOBILE	
2.17		1	CONVECTION OVEN, VENTLESS	
2.17		1	RAPID COOK OVEN	
2.10		2	POS PRINTER	NIC / BY OWNER
2.19		1	REFRIGERATOR, UNDERCOUNTER	EXISTING, RELOCATED
2.21		2	MOBILE COUNTER	NIC / BY MILLWORK
2.22		2	COFFEE DISPENSER	
2.23		1	POP-UP TOASTER	
		1	MICROWAVE OVEN	
2.24			00.000.0000	
2.25			SPARE NUMBER	
2.25 2.26		1	TRASH COUNTER	NIC / BY MILLWORK
2.25		1 2		NIC / BY MILLWORK
2.25 2.26			TRASH COUNTER	NIC / BY MILLWORK

2 TRASH CONTAINER

GENERAL NOTE:

1. KITCHEN EQUIPMENT OFCI, UON.

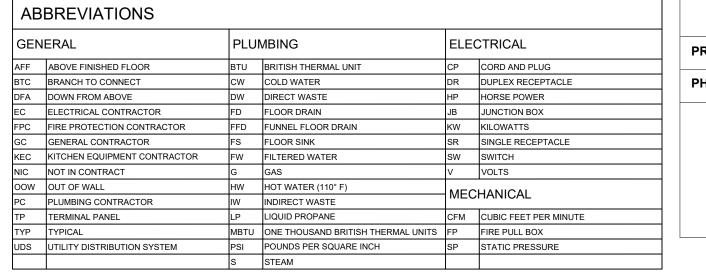

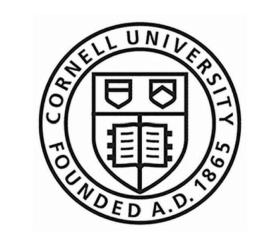

OWNER Cornell University Ithaca, NY 14853

ARCHITECT: Mitchell Giurgola

Mitchell Giurgola Architects LLP 630 Ninth Avenue, Suite 711 New York, New York 10036 (212) 663 4000

MEPFP ENGINEER: ME Engineering 300 Trolley Boulevard Rochester, Ny 14606 (585) 288-5590

STRUCTURAL AND EXTERIOR RENOVATION: Simpson Gumpertz & Heger Associates, Inc (SGH) 800 Boylston St, Suite 2320 Boston, MA 02199

LIGHTING DESIGN: Cline Bettridge Bernstein Lighting Design 116 East 27th Street, 4th Floor New York, NY 10016 (212) 741-3280

AUDIOVISUAL, IT, SECURITY: Cerami Associates 1001 Avenue of the Americas, 4th Floor (212) 370-1776


ACOUSTICS: Longman Lindsey 200 West 41st St, Suite 1100 New York, NY 10036 (212) 370-1776

FOOD SERVICE: Jacobs Doland Beer 192 Lexington Avenue, Suite 804 New York, NY 10016 (212) 937-1097

SEAL:

ISSU	E/REVISION:	
NO.	DATE	COMMENTS
1	05/06/2025	ADDENDUM 04

COPYRIGHT © 2020 MITCHELL GIURGOLA ARCHITECTS LLP

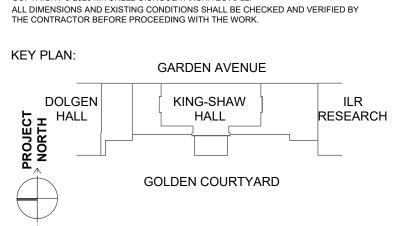

RENOVATE 2ND - 5TH FLOOR AT KING-SHAW HALL

140 Garden Ave, Ithaca, NY 14853 DRAWING TITLE:

2FL FOODSERVICE **EQUIPMENT PLAN**

-	PROJECT NO: 240400	DATE: 01/31/2025
	PHASE: 100% CD	SCALE: AS NOTED

FS-100R

RFI Form

			Rri Form	
RFI/ Response Index	Page/ Dwg./Spec./Rep. Number	Section/ Paragraph/Topic	RFI	Design Team Response
1			Due to local bid market feedback and upcoming holiday, we respectfully request a two-week bid extension.	The bid deadline will not be extended as discussed during the Pre-bid Meeting.
2			Is it possible to either schedule a tour of the building or to receive pictures of the existing interior conditions?	See Addendum No. 1, Item 1.
3	TA-000	AV Scope	Audiovisual Cover Sheet TA-000 has a responsibility matrix which identifies the front projection screens are supplied by the AV Division. Installed by the GC including the necessary blocking. Could not find where it is identified the AV Division is NOT part of this contract. Please clarify.	Where noted 'AV DIVISION', all equipment, materials, and labor shall be outside of the General Contrator's contract.
4	A-200, A-201, A-203	Corner Guards	Corner Guards, CG1 & GC 2, are shown on A-200, A-201 & A-203. They are not described on the finish schedule on A-740. Please supply a specification for them.	See Drawing A-720, details 07 and 08.
5	102219		There is a specification for Demountable Partitions (102219). Could not find them on the drawings. Please clarify.	Demountable Partitions are identified as Glazed Metal Partitions on Floor Plans (Key note #2) and Elevations.
6	S-004	•	Drawing S-004, Detail 5 & 6 identifies some concrete slab on grade replacement. There is no specification on S-001 for Concrete. Please clarify.	See Addendum 3, Items 22 and 23 for concrete specifications and testing.
7	General Conditions	Builder's Risk	It was mentioned in the pre bid meeting that builder's risk is required. Could not find it in Section 10.06 of the general conditions. Please clarify.	See General Conditions, Section 10.08 - Owner's and Contractor's Responsibilities for Fire and Extended Coverage Insurance Hazards
8		Data Infrastructure	During the walkthrough, it was mentioned that some of the data infrastructure for the ILR complex originates in King Shaw Hall, but this is not indicated on the drawings. Please clarify what, if any, teledata infrastructure there may be in King Shaw that feeds other buildings.	We are not aware of any existing backbone. Contractor will need to confirm with Cornell IT, then trace and tag, if required.
9		Security	Please clarify if there are any existing access control provisions in King Shaw that may feed/connect to other buildings in the ILR complex.	The security system will be connected to the main security which will communicate to the main security command center.
10		Cupola Electrical	Please confirm that there is no existing electrical in the cupola.	Electrical not currently included in cupola per existing documentation.
11		Fire Alarm Infrastructure	Please provide a labor allowance for investigating/tracing existing feeders, fire alarm infrastructure, etc. that is to be protected during demolition.	See General Requirements Section 01 21 00 - Allowance No. 2 on page 01 21 00-4. Also, see Addendum No. 3, Item 1.
12	068300	Composite Paneling	Composite Paneling 068300 is supplied by the Owner. Please identify where it is installed on the project. It does not show up on the Finish Schedule on A-201, A-202 & A-203.	Composite Paneling is identified as 3 Dimensional Texture Panel; see elevations details 02, 03, 04 on Drawing A-707.
13	A-704	Wood Wall Paneling	Elevations 01/A-704 & 01?A704 show wood wall paneling "WD-X". This type is not identified on A-740. Please clarify.	See Drawing A-704, Interior Finish legend.
14		Stone Base	Rooms 223, 231 & 20040 identify stone base to match existing. There is no specification for the stone base. Should we assume there will be enough from the select demo to complete the new work.	Yes, see details 02 and 03 on Drawing DA-201 and note stone base to be salvaged for reuse.

RFI/	Page/			
Response Index	Dwg./Spec./Rep. Number	Section/ Paragraph/Topic	RFI	Design Team Response
15	A-702, A-724, A-719	Door 221B.1	Please reference detail 8/A-702. Door 221B.1 is noted as a repurposed door. Detail 5/A-724 notes the door as refurbished. The door schedule on A-719 lists this opening as having door type A. It is not noted as repurposed or refurbished. Please clarify whether or not a new door is desired here. There are also no specifications for any restoration work outside of the cupola alternate. Please provide.	Door is modified and repurposed existing door. See details 01 and 05 on Drawing A-724, demo drawings, and wood doors and hardware to be reused (key note #17).
16		Corner Guards	The floor plans call for corner guards CG1 & CG2. Please provide a specification for these items.	See response to RFI #4 above.
17	A-705	Plastic Laminate Sills	Detail 13/A-705 notes PLAM Sill Typical. This is an existing window. Please confirm that there are no new sills required at existing windows.	Sills required at all existing windows. See Addendum No. 3, details 07 and 08.
18	A-202, A-704		Please reference detail 1/A-202, Rooms 325A and 325C both call for new windows and shades. However the elevations that are called out in those rooms (8 & 9/A-704) show fabric wrapped panels covering the windows. Please advise.	See Addendum No. 3, Item 17. Elevations details 08 and 09 have been revised to include new windows and revised panel layouts.
19	A-706, A-719	Door 426.1	Door 426.1 is noted as a Wood Pocket Door on 1/A-706. The door schedule on A-719 notes this as a hollow metal door in a hollow metal frame. Please advise.	
20	A-717	Wood Blocking	Detail 7/A-717 tells us to provide wood blocking. Please detail the layout and sizing of the desired wood blocking.	=
21	A-203	Section Tags	Detail 1/A-203 has section cuts for 1/A-710 and 2/A-710. Drawing A-710 was not included in the drawing set.	Disregard section references.
22	102219			See response to RFI #5 above. See Addendum No. 3, Item 3 and 4. Both Sections to be reference for demountable partition door hardware. Aluminum Storefront indentified on plans (key note #5) and Drawing A-711 elevations.
23		Bid Extension	We are requesting a bid date extension of a least one week.	See Addendum No. 2, Item 1. The Bid date was extended to May 13.
24	FS-100	Equipment Schedule	2FL Foodservice Equipment Plan FS-100, has the equipment schedule with an Equipment Remarks column. This remarks column identifies items to be supplied by the GC.	See Addendum No. 4, Item 8 for revised drawing.
25	Appendix E	Owner- Furnished Items	Appendix E - Identifies Owner Furnished Interior finishes materials including certain upholstery fabrics, textured wall paneling, ceramic tile & carpet. Also identifies certain light fixtures the owner will supply.	Items are Owner-Furnished, Contractor-Installed.

RFI/	Page/			
Response	Dwg./Spec./Rep.	Section/		Design Team
Index	Number	Paragraph/Topic	RFI	Response
26	104416	Fire Extinguisher Cabinets	Could not find any FEC shown on the drawings. There is a specification. Please clarify.	See Addendum No. 4 and revised Floor Plans locating FECs.
27	A-750	Signage	Drawing A-750 calls for vinyl signage at details 2, 3 and 5. Please update specification 101400 Signage with information regarding the vinyl signage. Also, these are called out at various interior elevations but the notes tell us to reference A-750. Sometimes it is quite clear what sign is desired but other times it is not. Can the interior elevation notes be updated to add which specific detail on A-750? This will help our signage vendors to provide the most accurate pricing possible.	Signage scope to be confirmed with Owner. See notes at detail 05 on Drawing A-750 for current scope information.
28	A-740	OFCI Items	Please reference A-740. The finish schedule calls for the Composite Paneling that is specified in section 068300 as OFCI. The specification does not indicate that this product is OFCI. Please clarify who is to be providing this product. Same question for items UF1 & UF2. All of the fabric items within specification 098413 Acoustic Panel Fabric are listed as OFCI as well. Please confirm who is to be providing these products.	Composite Paneling, UF1, UF2, and acoustic panel fabrics are Owner-Furnished, Contractor-Installed.
29	A-751	Signage	Please reference A-751, sign types G & Occupancy Load are noted to provide one sign per door and a total of 10 respectively. Type H does not have any indication as to how many to provide. Please clarify.	All doors within project scope to have either Type G or Type H sign (exceptions include storage closets within rooms on 2nd-4th Floors, exterior doors, and vestibule doors). Private Offices to receive Type G signs, other rooms to receive Type H signs.
30	FS-100	Foodservice	Please reference drawing FS-100. Items 1.30 & 1.31 are listed as NIC / By GC, item 2.10 is listed as NIC / By Millwork. These items are not show on the architectural drawings. Please provide further information.	Disregard item 2.10. See Addendum No. 4, Item 8 for revised drawing.
31	101100, 101200, 104416		The following specifications were issued in the project manual but no work was shown for them on the drawings, please advise: 1.I01100 Visual Display Surface 2.I01200 Display Cases 3.I04416 Fire Extinguishers And Cabinets	1. 101100 - no scope currently. 2. 101200 - no scope currently. 3. 104416 - see Addendum No. 4 revised Floor Plans locating FECs.