

CORNING-PAINTED POST ASD

2025 MIDDLE SCHOOL PHASE III ALTERATIONS PROJECT

35 VICTORY HIGHWAY, PAINTED POST, NY 14870

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35 VICTORY HIGHWAY, PAINTED POST, NY 14870

PROJECT BID DATE: 10/20/2025  
PROJECT ISSUE DATE: 05/09/2025  
HUNT PROJECT NO.: 2649-153  
S.E.D. # 57-10-00-01-0-024-044 - MIDDLE SCHOOL


THIS IS TO CERTIFY THAT TO THE BEST OF OUR KNOWLEDGE, INFORMATION AND BELIEF - THE DESIGN OF THIS PROJECT CONFORMS TO ALL APPLICABLE PROVISIONS AND BUILDING CODE, THE NEW YORK STATE UNIFORM FIRE PREVENTION AND BUILDING CODE, THE NEW YORK STATE ENERGY CONSERVATION CODE, AND THE BUILDING STANDARDS OF THE NEW YORK STATE EDUCATION DEPARTMENT.

# DATE: DESCRIPTION OF REVISION: 1 10/29/2025 ISSUED FOR BID	DRAWN BY:	PSP
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	DATE:	05/09/2025
	PHASE:	Copyright ©
IT IS A VIOLATION OF THE LAW FOR ANY PERSON TO MAKE UNAUTHORIZED ALTERATIONS OR ADDITIONS TO A PLAN BEARING A LICENSED ENGINEER, ARCHITECT'S OR SURVEYOR'S SEAL.		

HUN  
HORSEHEADS





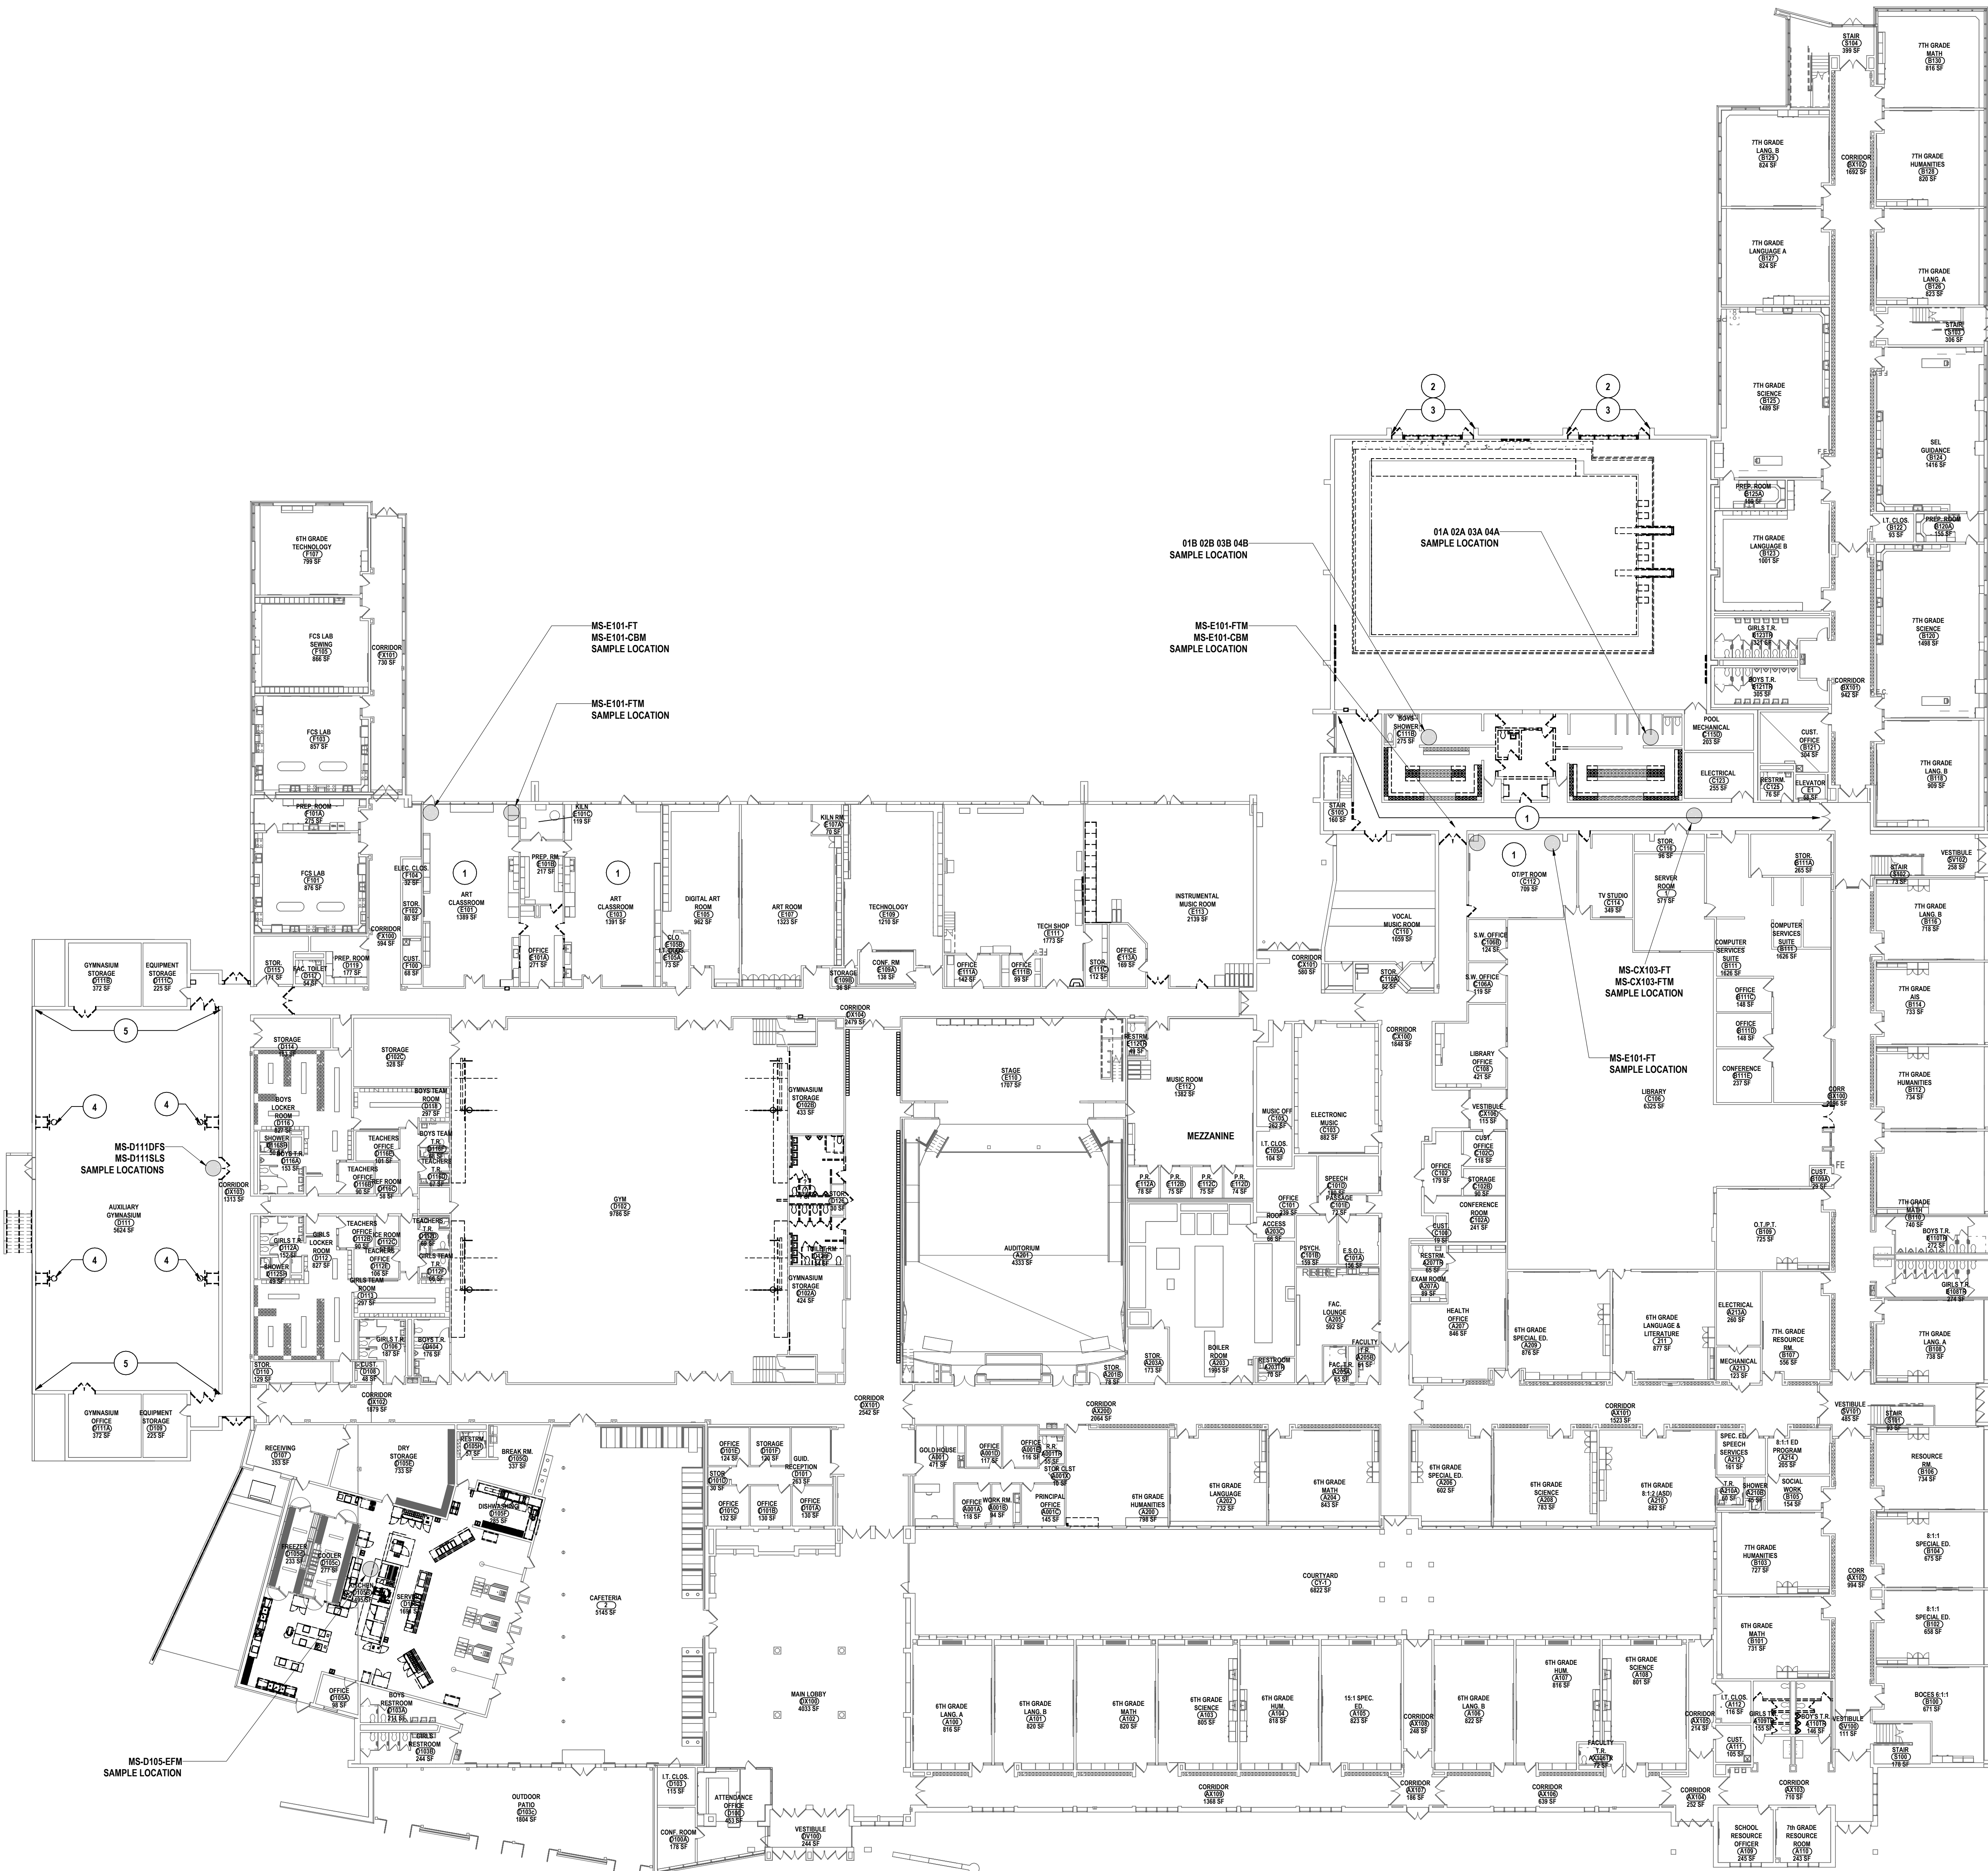

1 FIRST FLOOR ASBESTOS ABATEMENT PLAN  
3/64" = 1'-0"



GENERAL NOTES:

- REFER TO SPECIFICATION 02 21 10 ASBESTOS ABATEMENT FOR ADDITIONAL INFORMATION.
- ALL WORK IS TO COMPLY WITH NYS CODE RULE 56 REQUIREMENTS OR HIGHER. SITE SPECIFIC VARIANCES MAY BE IMPLEMENTED IF APPROVED BY THE ARCHITECT.
- ASBESTOS SURVEY WAS CONDUCTED AND THE REPORT IS ON FILE WITH THE ARCHITECT.
- THE REGULATED ABATEMENT WORK AREA SHALL BE VACATED BY THE OCCUPANTS AND NON-CERTIFIED PERSONNEL, PRIOR TO WORK AREA PREPARATION, AND SHALL REMAIN VACATED UNTIL THE ASBESTOS PROJECT IS COMPLETE.
- THE PERSONAL AND WASTE DECONTAMINATION SYSTEM ENCLOSURE(S) SHALL BE PROVIDED OUTSIDE THE REGULATED ABATEMENT WORK AREA AND ATTACHED TO THE BUILDING AT ENTRY/EXIT LOCATION AS PER SECTION 56.7.3. THESE LOCATIONS SHALL BE REVIEWED AND APPROVED BY THE OWNER/OWNER'S REPRESENTATIVE PRIOR TO COMMENCEMENT OF WORK. THE DECONTAMINATION UNIT(S) SHALL BE CORDONED OFF AT A DISTANCE OF TWENTY-FIVE (25) FEET IN ALL DIRECTIONS TO SEPARATE IT FROM PUBLIC AREAS. THE CONTRACTOR SHALL ESTABLISH, MARK AND MAINTAIN PROPER EXITS WITHIN EACH WORK AREA FOR NORMAL AND EMERGENCY USE AND MAINTAIN A CLEAR EGRESS PATH.
- ALL TOOLS AND EQUIPMENT SHALL BE REMOVED FROM SITE AFTER DECONTAMINATION.
- AFTER ALL REGULATED ABATEMENT WORK AREAS HAVE BEEN DISMANTLED ANY REMAINING REMOTE DECONTAMINATION ENCLOSURES MUST BE DISMANTLED AND REMOVED FROM SITE. ALL PLASTIC SHEETING SHALL BE REMOVED AND DISPOSED OF ASBESTOS WASTE.
- ALL WASTE GENERATED AS PART OF ASBESTOS PROJECT SHALL BE REMOVED FROM THE SITE WITHIN TEN (10) CALENDAR DAYS AFTER SUCCESSFUL COMPLETION OF PHASE 11 C FOR ALL REGULATED WORK AREAS.
- ALL WASTE GENERATED AS PART OF THE ASBESTOS PROJECT SHALL BE LEGALLY DISPOSED OF AT ANY APPROVED LANDFILL FACILITY. ALL GENERATED WASTE REMOVED SHALL BE DOCUMENTED, ACCOUNTED FOR AND DISPOSED OF IN COMPLIANCE WITH REQUIREMENTS OF EPA NESHAP.

PLAN DRAWING NOTES:

- REMOVE ACM FLOOR TILE, MASTIC, AND VINYL BASE. ABATE ACM FLOOR TILE AND MASTIC PRESENT UNDER CASEWORK WHERE CASEWORK IS SCHEDULED TO BE REMOVED.
- REMOVE ACM DOOR AND LIGHT FIXTURE SEALANTS.
- REMOVE STOREFRONT SYSTEM AT EXTERIOR WALL WITH VERMICULITE ACM INSULATION.
- REMOVE BACKSTOPS AT MASONRY WALLS WITH ACM VERMICULITE INSULATION. PATCH WALL AND REFINISH TO MATCH EXISTING.
- INSTALL WALL PADS AT VERMICULITE ACM MASONRY WALLS. PATCH AND REFINISH ANY SURFACES DISTURBED.

SAMPLING FIGURES  
LEGEND:

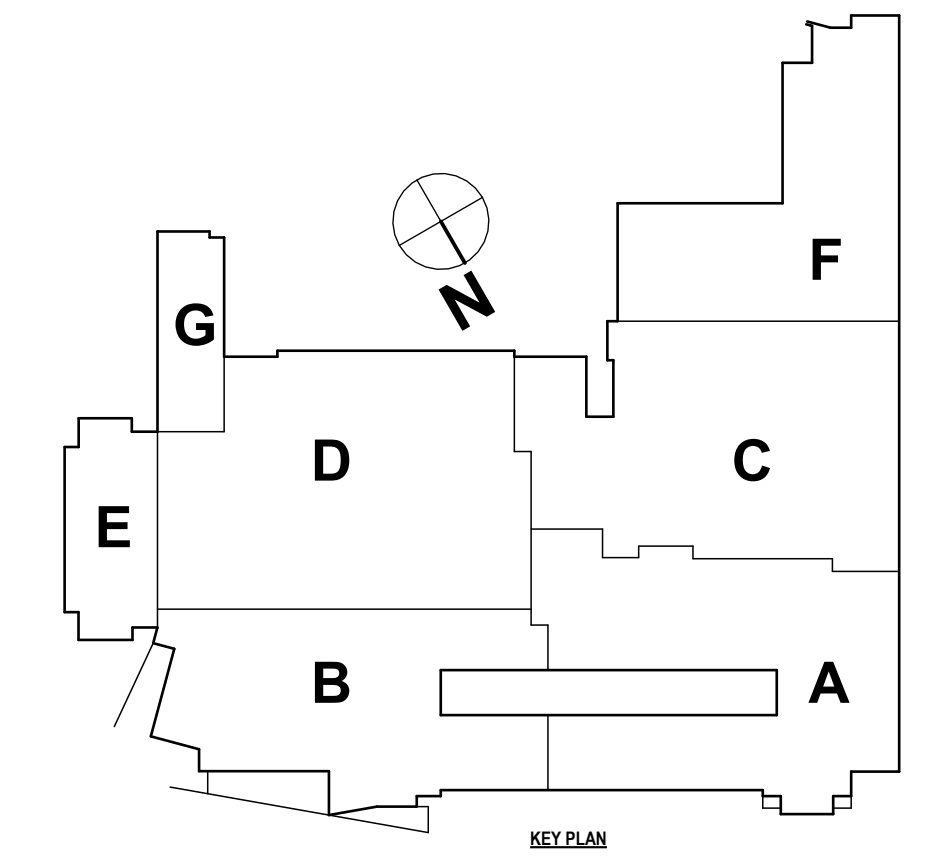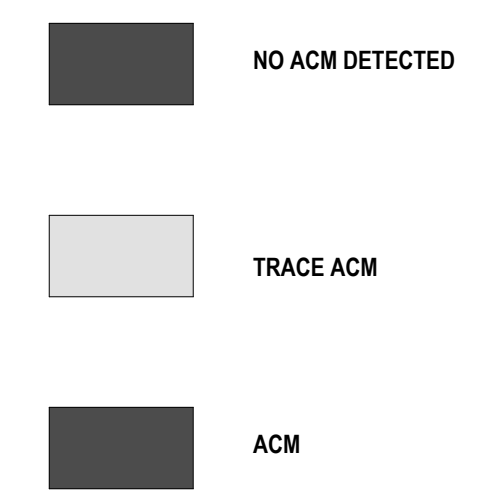

57-10-00-01-002-0444 - MIDDLE SCHOOL

ASBESTOS ABATEMENT PLAN  
2025 MIDDLE SCHOOL PHASE III ALTERATIONS PROJECT  
CORNING-PAINTED POST ASD  
35 VICTORY HIGHWAY, PAINTED POST, NY 14570

MS-AB1.1  
PROJECT NO: 2649-133


HUNT ENGINEERS | ARCHITECTS | SURVEYORS  
HORSEHEADS, NY 607-263-1000 ROCHESTER, NY 585-237-7849 TOWNANDA, PA 470-265-4606  
BINGHAMTON, NY 607-738-8881 ALBANY, NY 607-738-8801  
WWW.HUNTEAS.COM  
NY CERTIFICATE NO. 0016220 PA CERTIFICATE NO. TSC2202013464-1

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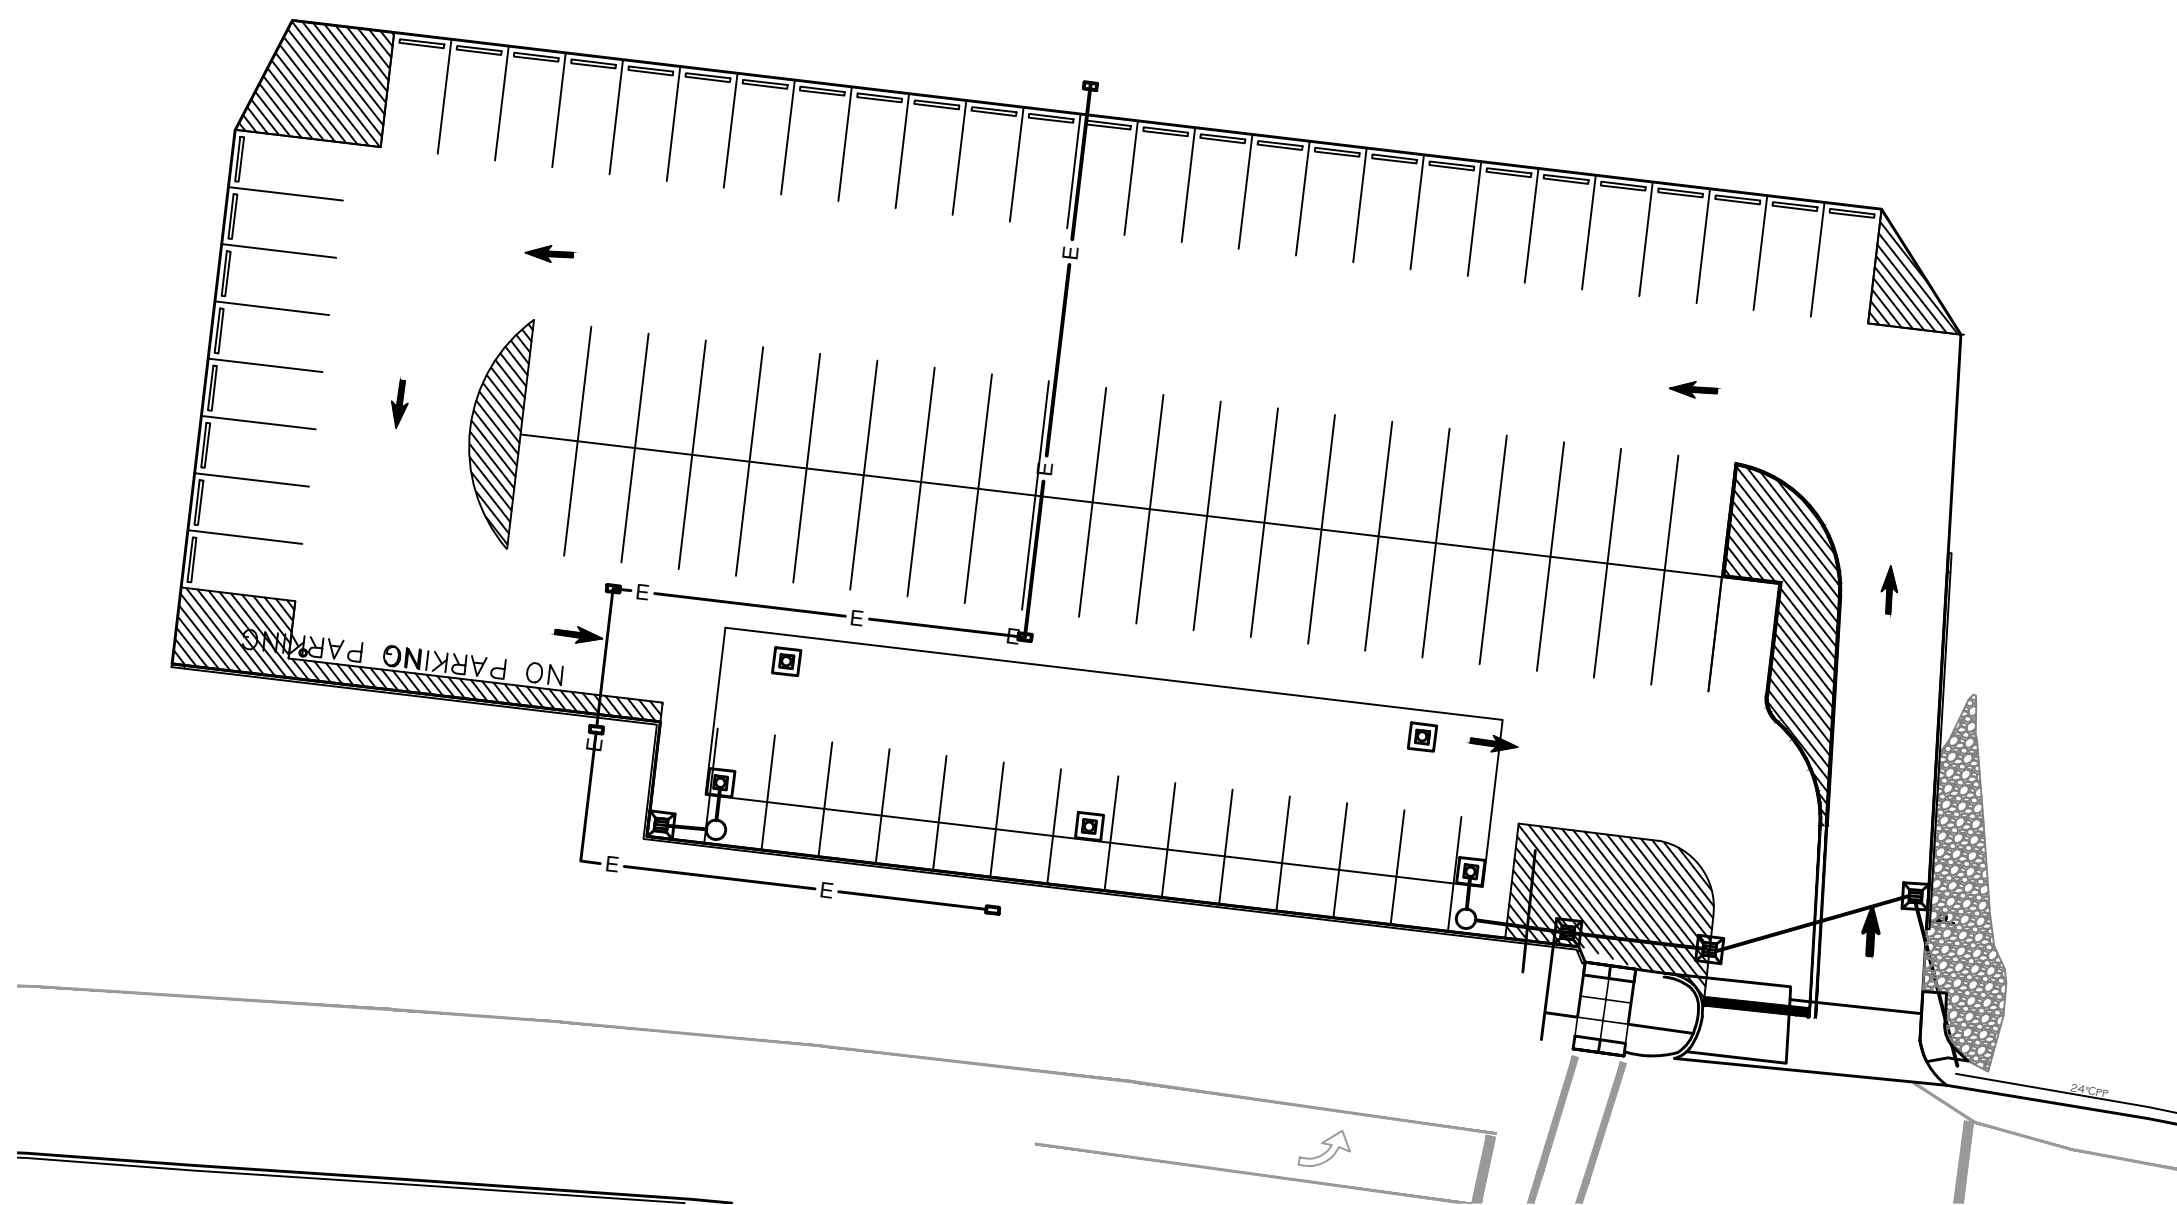
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SURVEY CONTROL POINT TABLE			
POINT NO.	NORTHING	EASTING	ELEVATION DESCRIPTION
1	780033.5270	680081.3310	957.01 CRTH-R
2	780378.5100	680428.0860	967.13 CRTH-R
50	789748.1933	680104.5091	950.59 CP-PK
51	789676.5783	680276.8215	947.90 CP-R
52	789881.6444	680521.4567	951.08 CP-PK
53	789487.3863	680466.5910	948.78 CP-EXPK-35
54	789629.2739	680622.6743	949.20 CP-R
55	789303.1112	681078.1400	942.01 CP-EXPK
56	789845.3014	680800.2879	945.35 CP-EXPK
57	789937.5171	680325.1362	951.31 CP-PK
791	789714.9584	680706.2447	945.45 CP-EXPK
1714	790012.6189	680757.0317	952.16 CP-PK



SED # 57-040-01-0204-044-MIDDLE SCHOOL

SITE EXISTING CONDITIONS PLAN  
2025 MIDDLE SCHOOL PHASE III ALTERATIONS PROJECT  
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35 VICTORY HIGHWAY, PAINTED POST, NY 14870

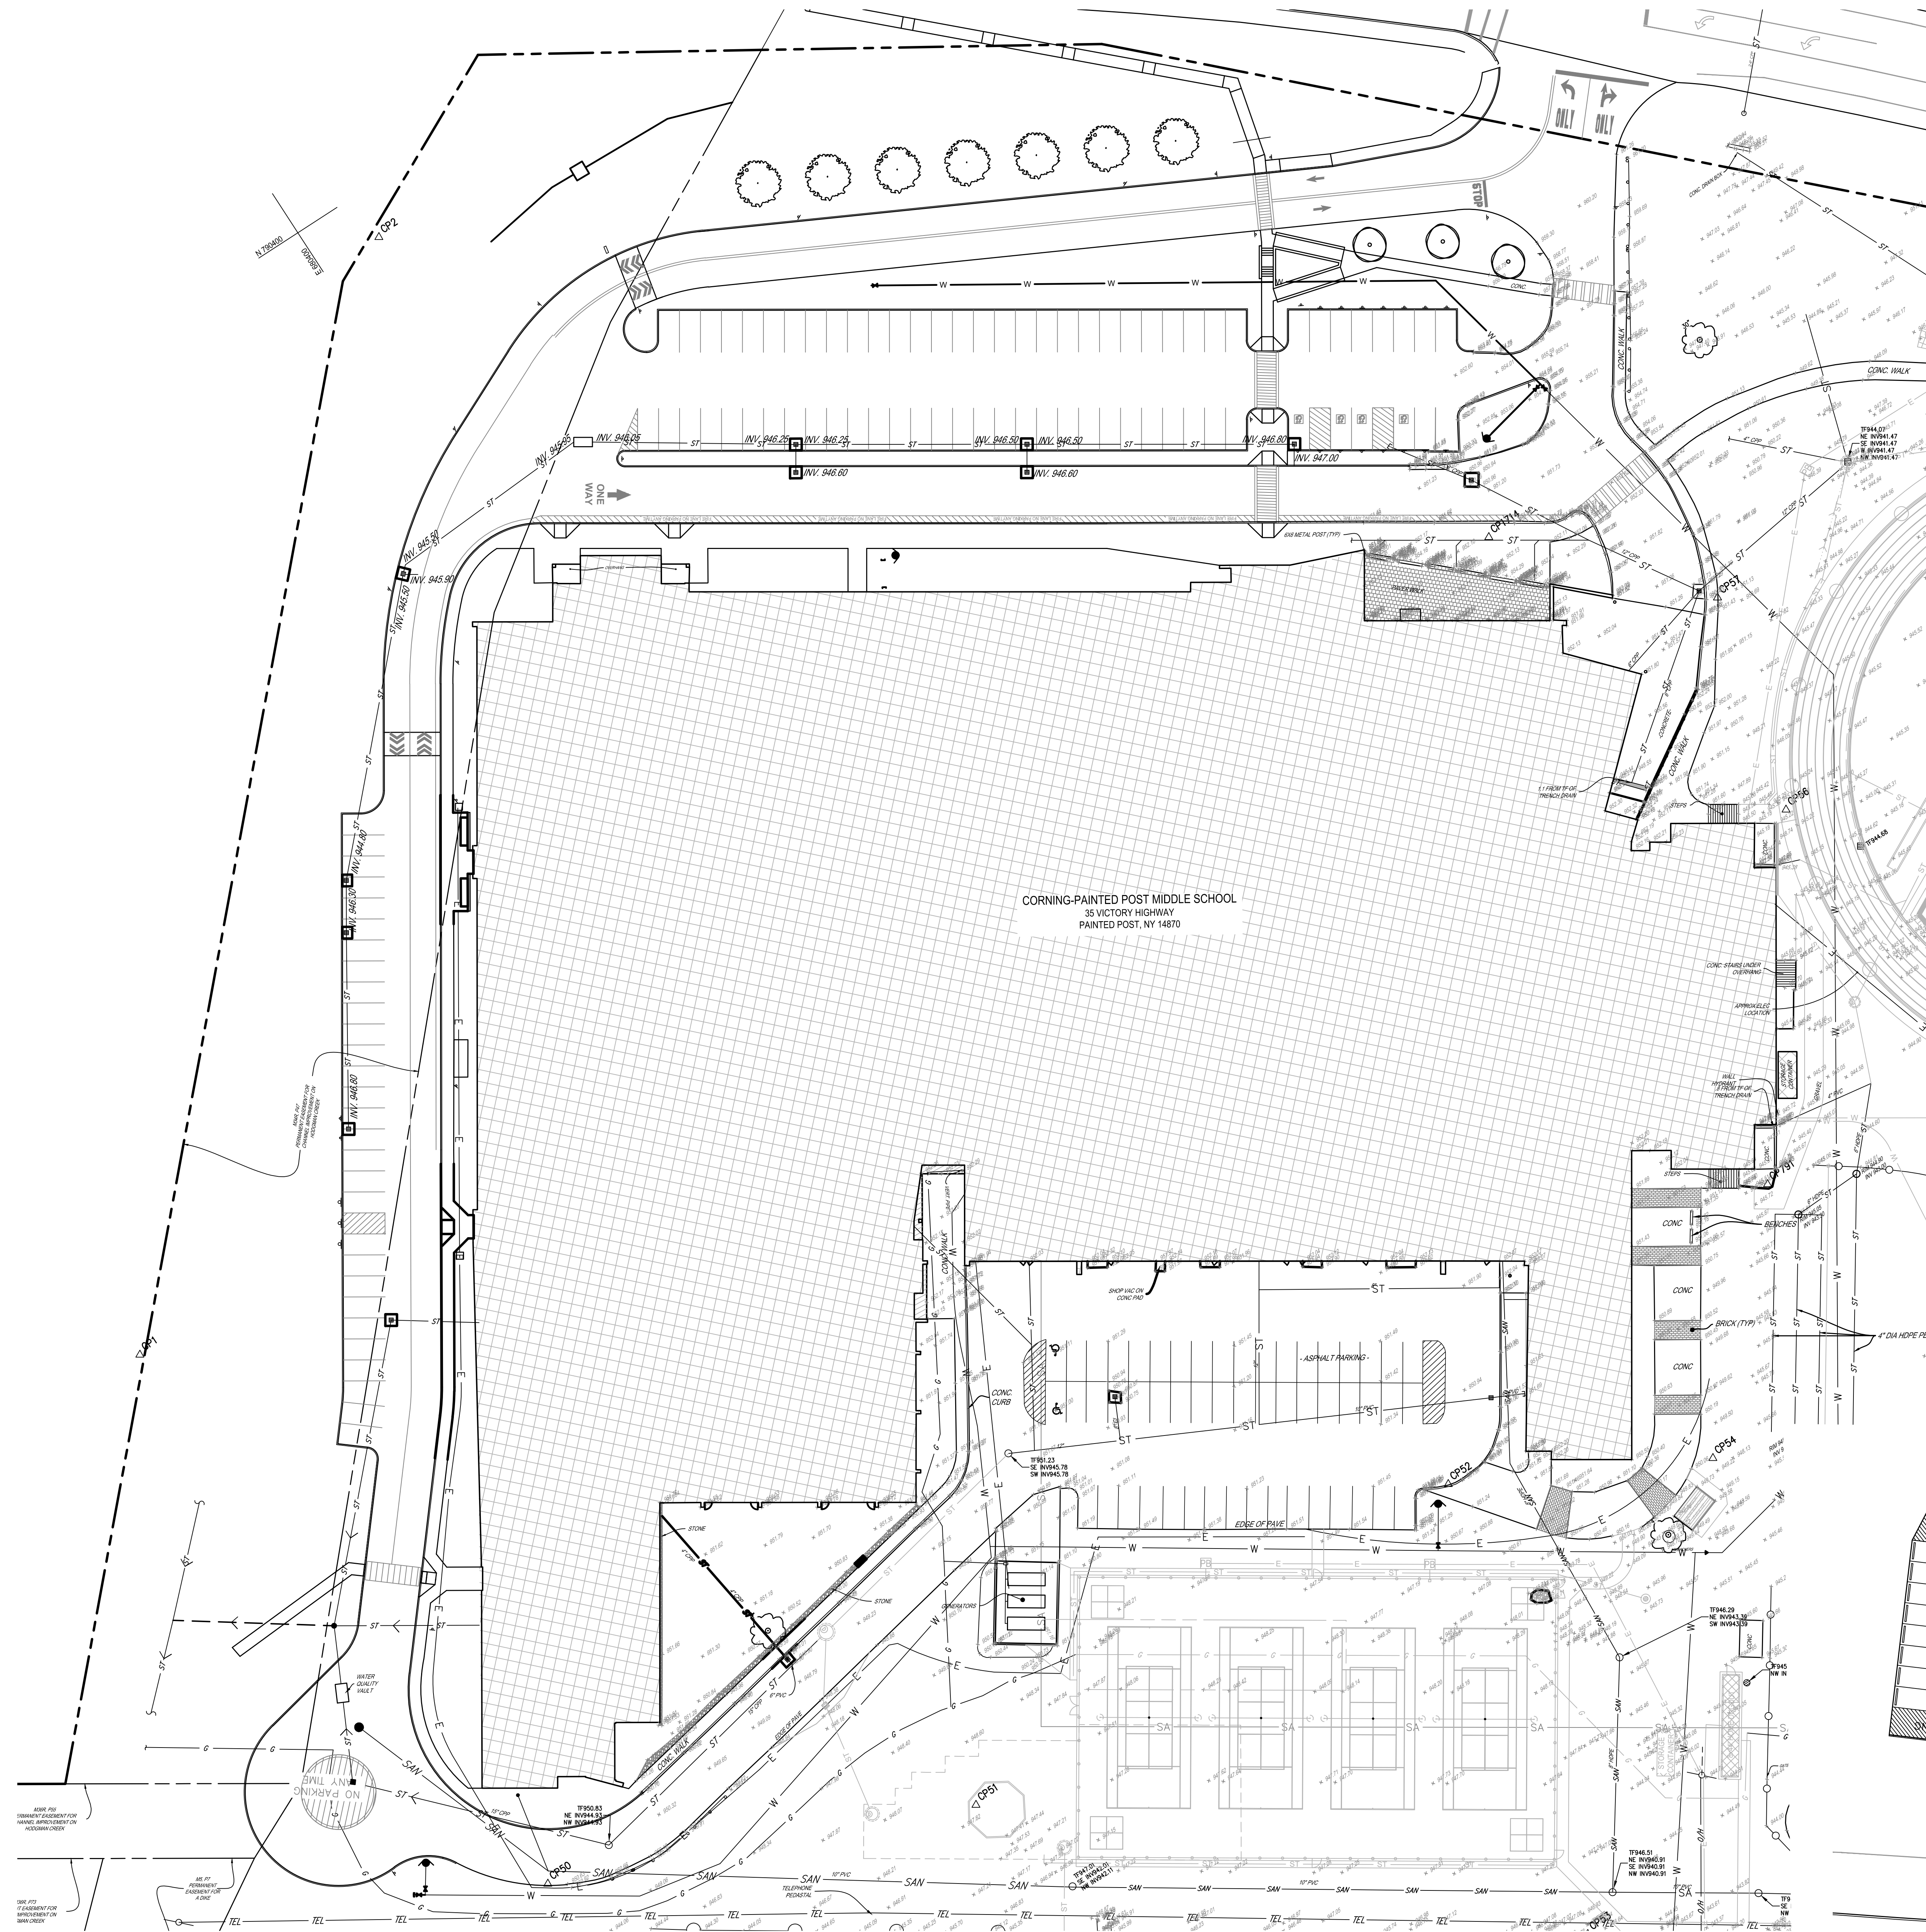**HUNT** ENGINEERS | ARCHITECTS | SURVEYORS  
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BINGHAMTON, NY 807-788-1881 ALBANY, NY 807-798-8081  
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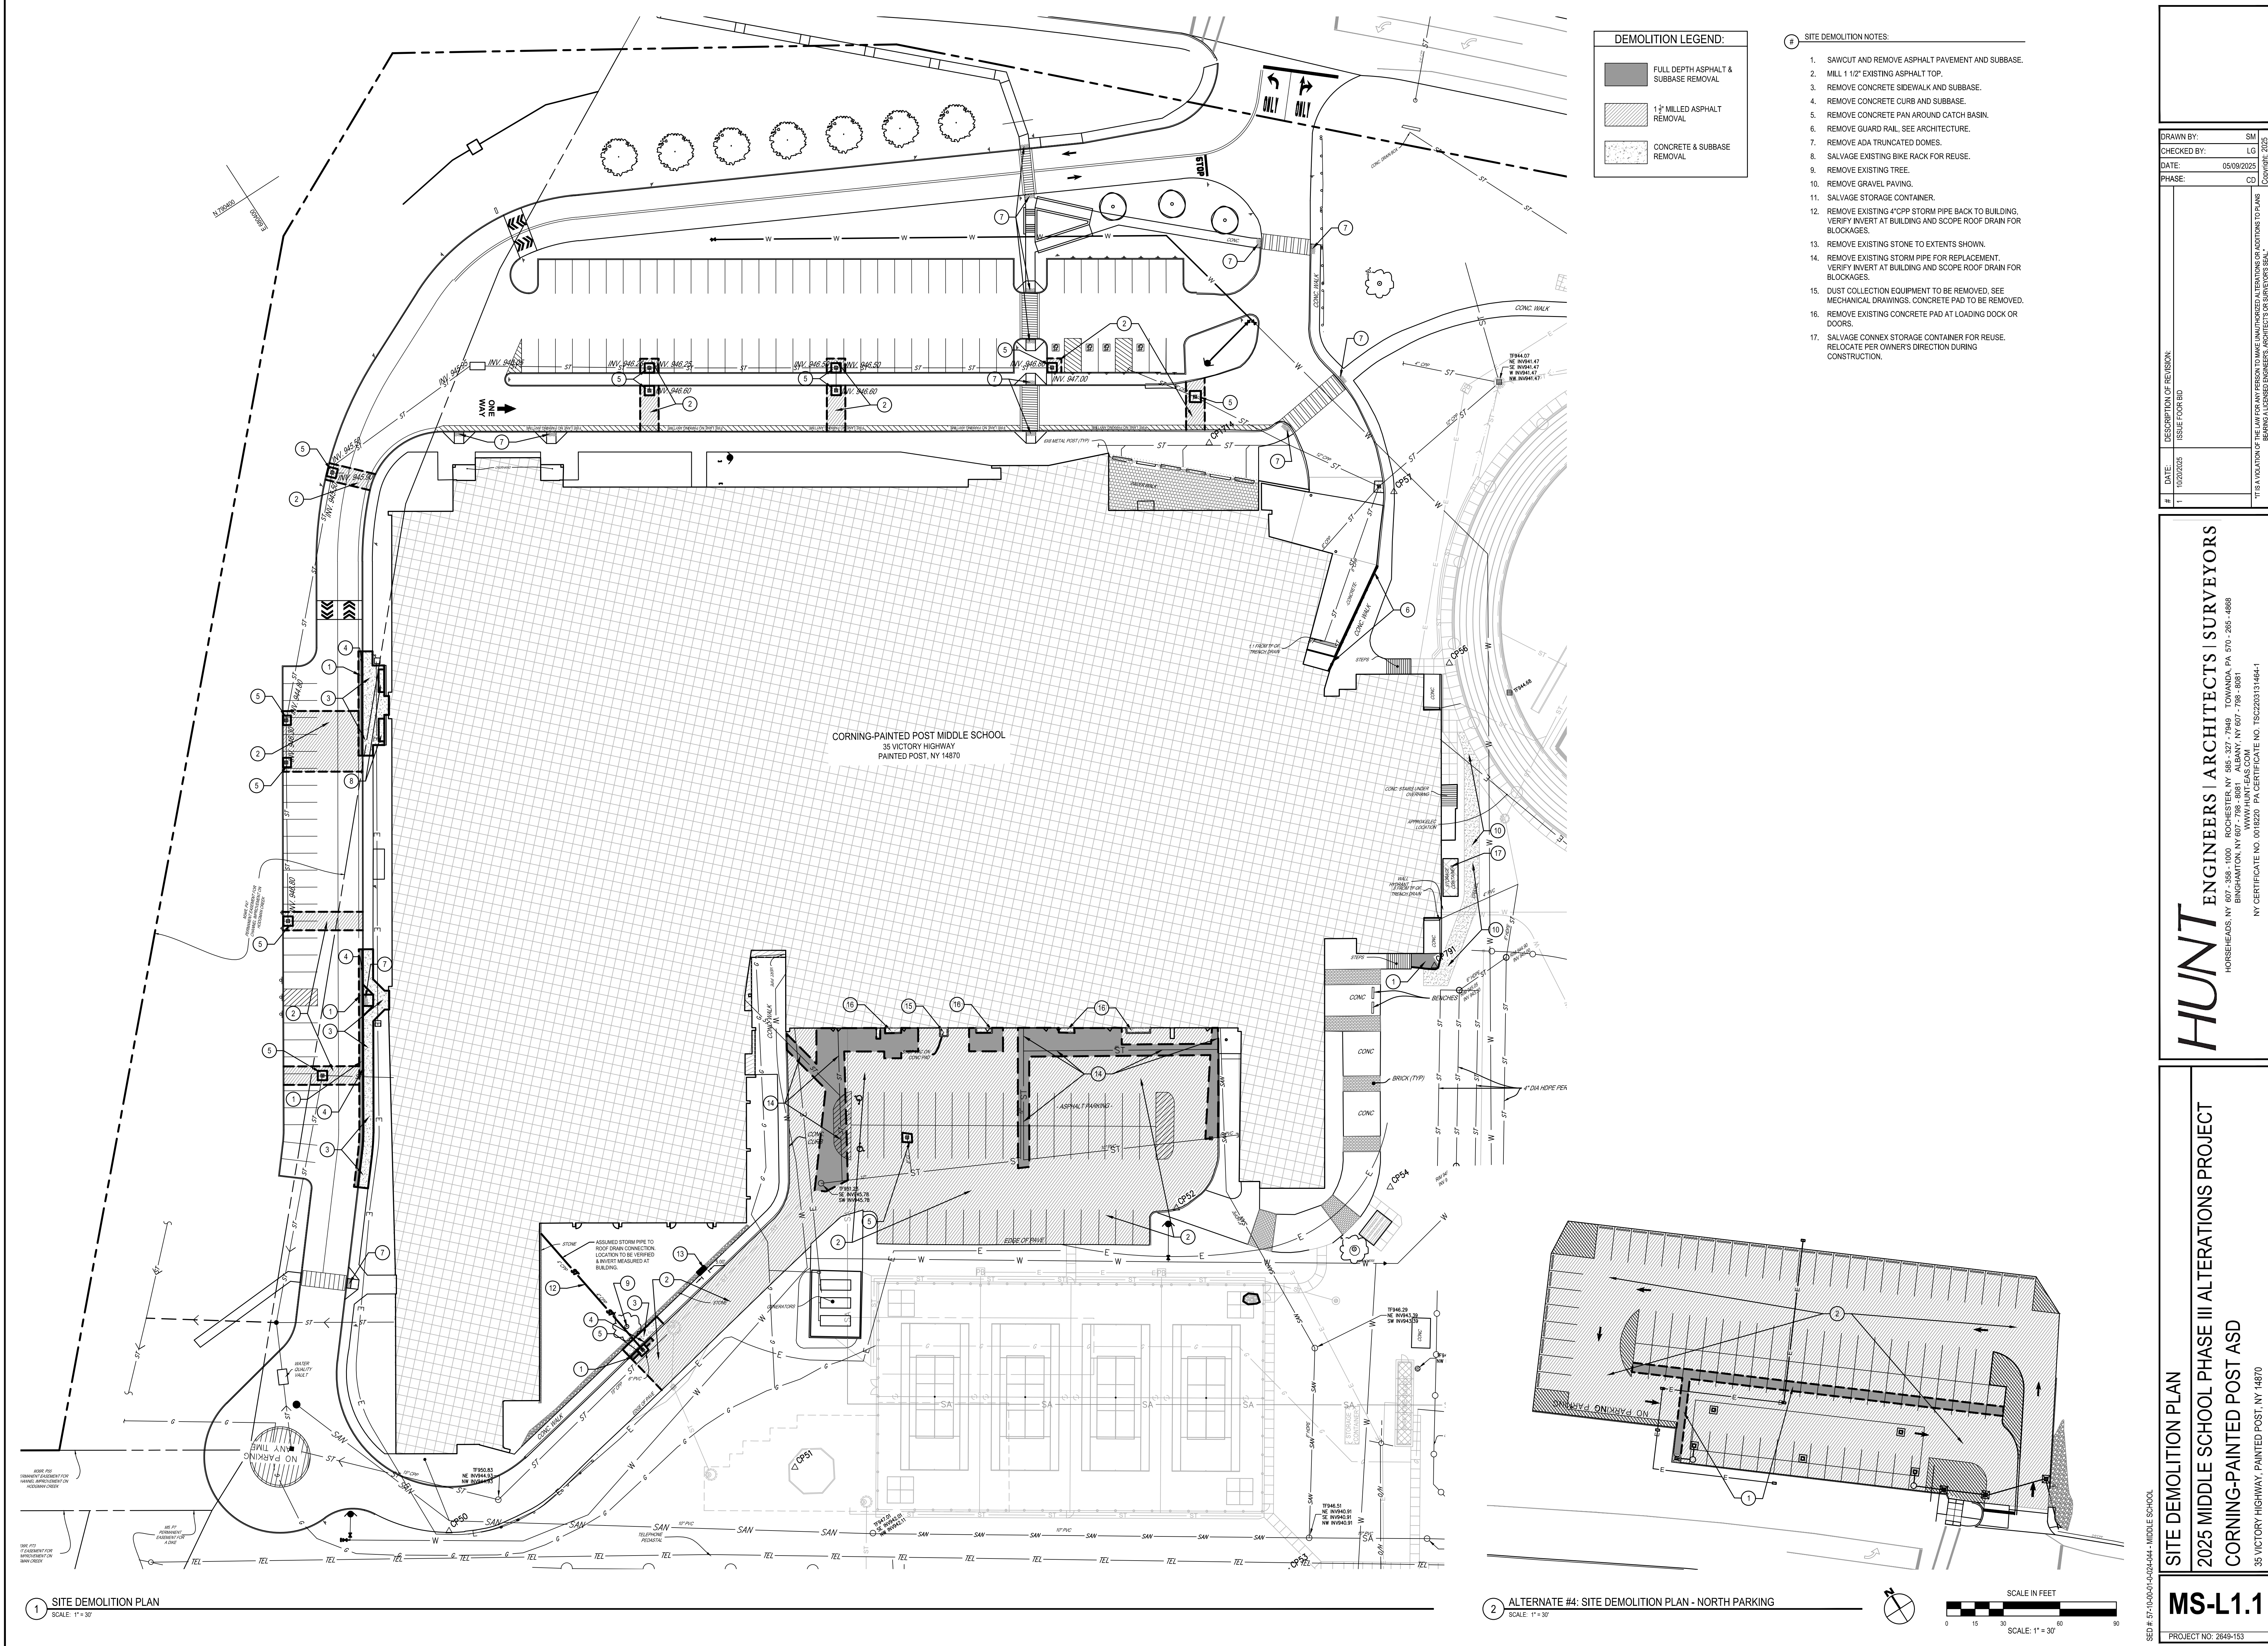
DRAWN BY: SM  
CHECKED BY: LC  
DATE: 05/09/2025  
PHASE: CD  
DESCRIPTION OF REVISION:  
ISSUE FOR BID  
DATE: 10/20/2025  
# 1

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MS-L0.1  
PROJECT NO: 2649-153





DEMOLITION LEGEND:	
	FULL DEPTH ASPHALT & SUBBASE REMOVAL
	1 1/2\"/>

1. SAWCUT AND REMOVE ASPHALT PAVEMENT AND SUBBASE.
2. MILL 1 1/2\"/>
3. REMOVE CONCRETE SIDEWALK AND SUBBASE.
4. REMOVE CONCRETE CURB AND SUBBASE.
5. REMOVE CONCRETE PAN AROUND CATCH BASIN.
6. REMOVE GUARD RAIL. SEE ARCHITECTURE.
7. REMOVE ADA TRUNCATED DOMES.
8. SALVAGE EXISTING BIKE RACK FOR REUSE.
9. REMOVE EXISTING TREE.
10. REMOVE GRAVEL PAVING.
11. SALVAGE STORAGE CONTAINER.
12. REMOVE EXISTING 4\"/>
13. REMOVE EXISTING STONE TO EXTENTS SHOWN.
14. REMOVE EXISTING STORM PIPE FOR REPLACEMENT. VERIFY INVERT AT BUILDING AND SCOPE ROOF DRAIN FOR BLOCKAGES.
15. DUST COLLECTION EQUIPMENT TO BE REMOVED. SEE MECHANICAL DRAWINGS. CONCRETE PAD TO BE REMOVED.
16. REMOVE EXISTING CONCRETE PAD AT LOADING DOCK OR DOORS.
17. SALVAGE CONNEX STORAGE CONTAINER FOR REUSE. RELOCATE PER OWNER'S DIRECTION DURING CONSTRUCTION.

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DATE: 05/09/2025	
PHASE: CD	
ISSUE FOR BID	
DATE: 10/02/2025	
DESCRIPTION OF REVISION:	
1	
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**HUNT** ENGINEERS | ARCHITECTS | SURVEYORS

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NY CERTIFICATE NO. 0016220 PA CERTIFICATE NO. TSC20231464-1

**SITE DEMOLITION PLAN**

**2025 MIDDLE SCHOOL PHASE III ALTERATIONS PROJECT**

**CORNING-PAINTED POST ASD**

35 VICTORY HIGHWAY, PAINTED POST, NY 14870

**MS-L1.1**

PROJECT NO: 2649-153

1 SITE DEMOLITION PLAN  
SCALE: 1" = 30'

2 ALTERNATE #4: SITE DEMOLITION PLAN - NORTH PARKING  
SCALE: 1" = 30'






SITE IMPROVEMENT PLAN  
2025 MIDDLE SCHOOL PHASE III ALTERATIONS PROJECT  
CORNING-PAINTED POST ASD

MS-L2

PROJECT NO: 2649-153

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CHECKED BY:		LG
DATE:		05/09/2025
PHASE:		CD
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1	10/20/2025	ISSUE FOR BID
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1 SITE LAYOUT PLAN  
SCALE: 1" = 30'

2 ALTERNATE #4: SITE LAYOUT PLAN - NORTH PARKING  
SCALE: 1" = 30'

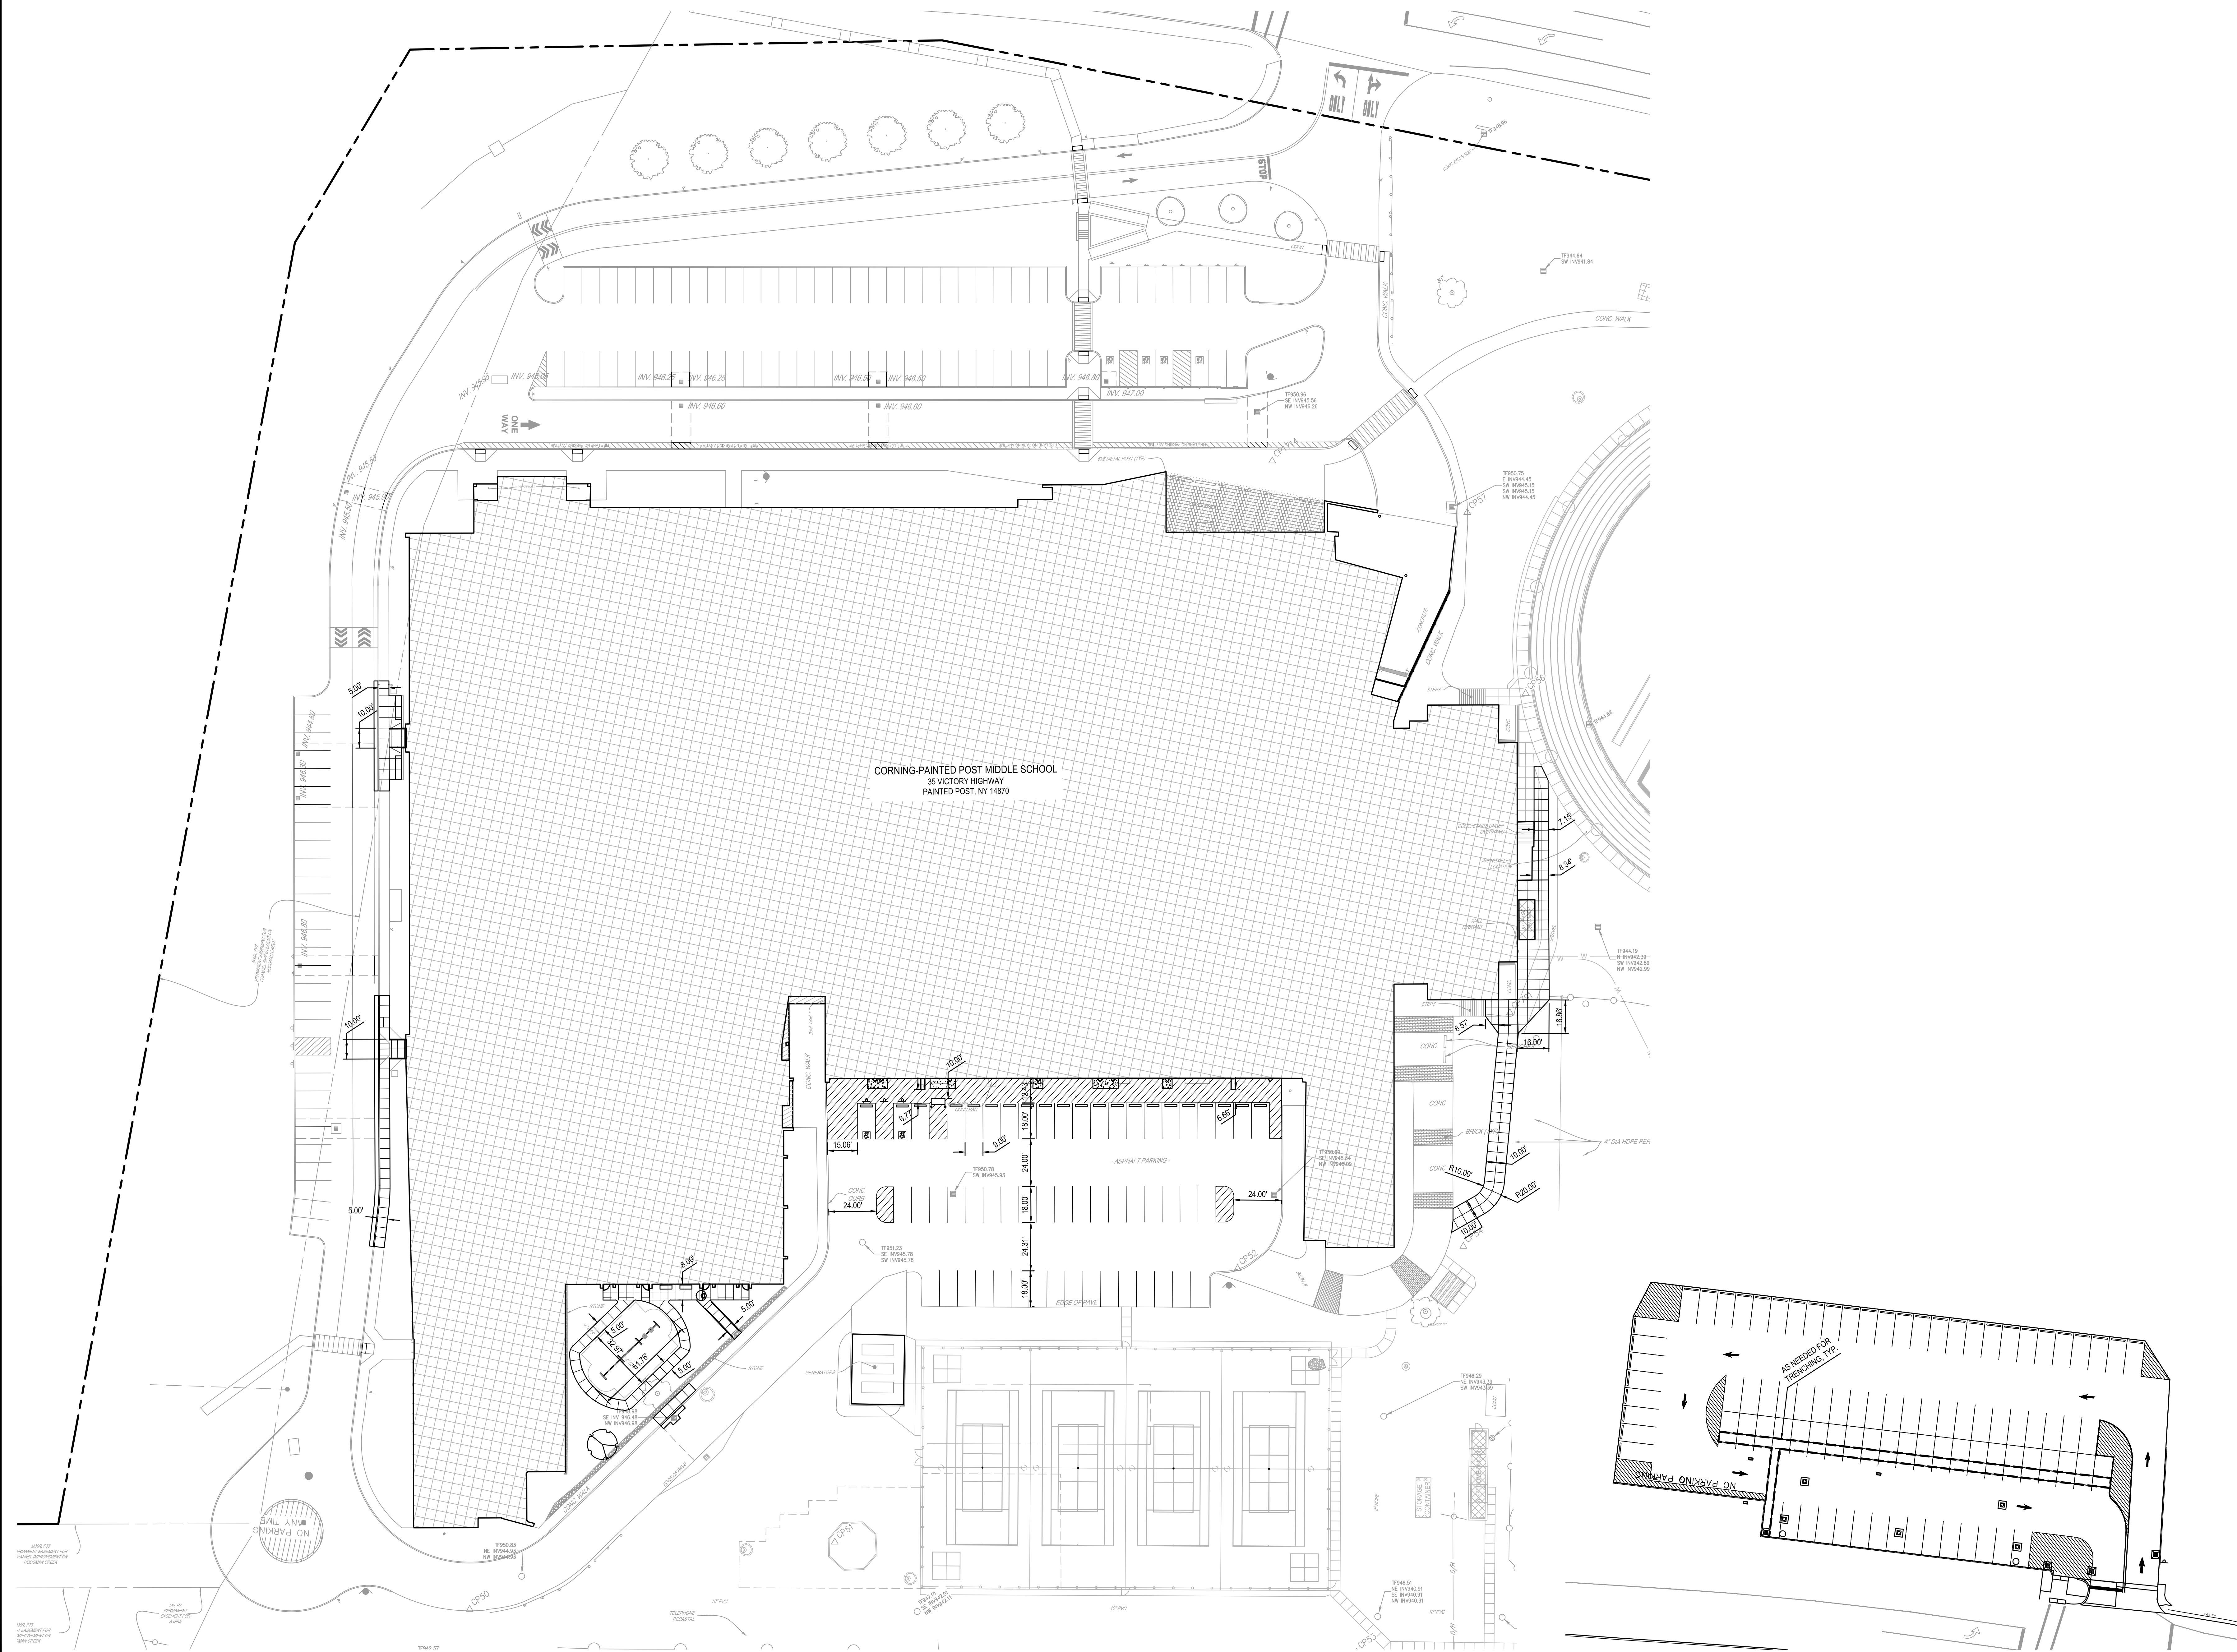SED #: 57-19-00-01-02-04-044 - MIDDLE SCHOOL

SITE LAYOUT PLAN  
2025 MIDDLE SCHOOL PHASE III ALTERATIONS PROJECT  
CORNING-PAINTED POST ASD  
35 VICTORY HIGHWAY, PAINTED POST, NY 14870

MS-L3.1

PROJECT NO: 2649-153

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# DATE

1 10/20/2025

PHASE:

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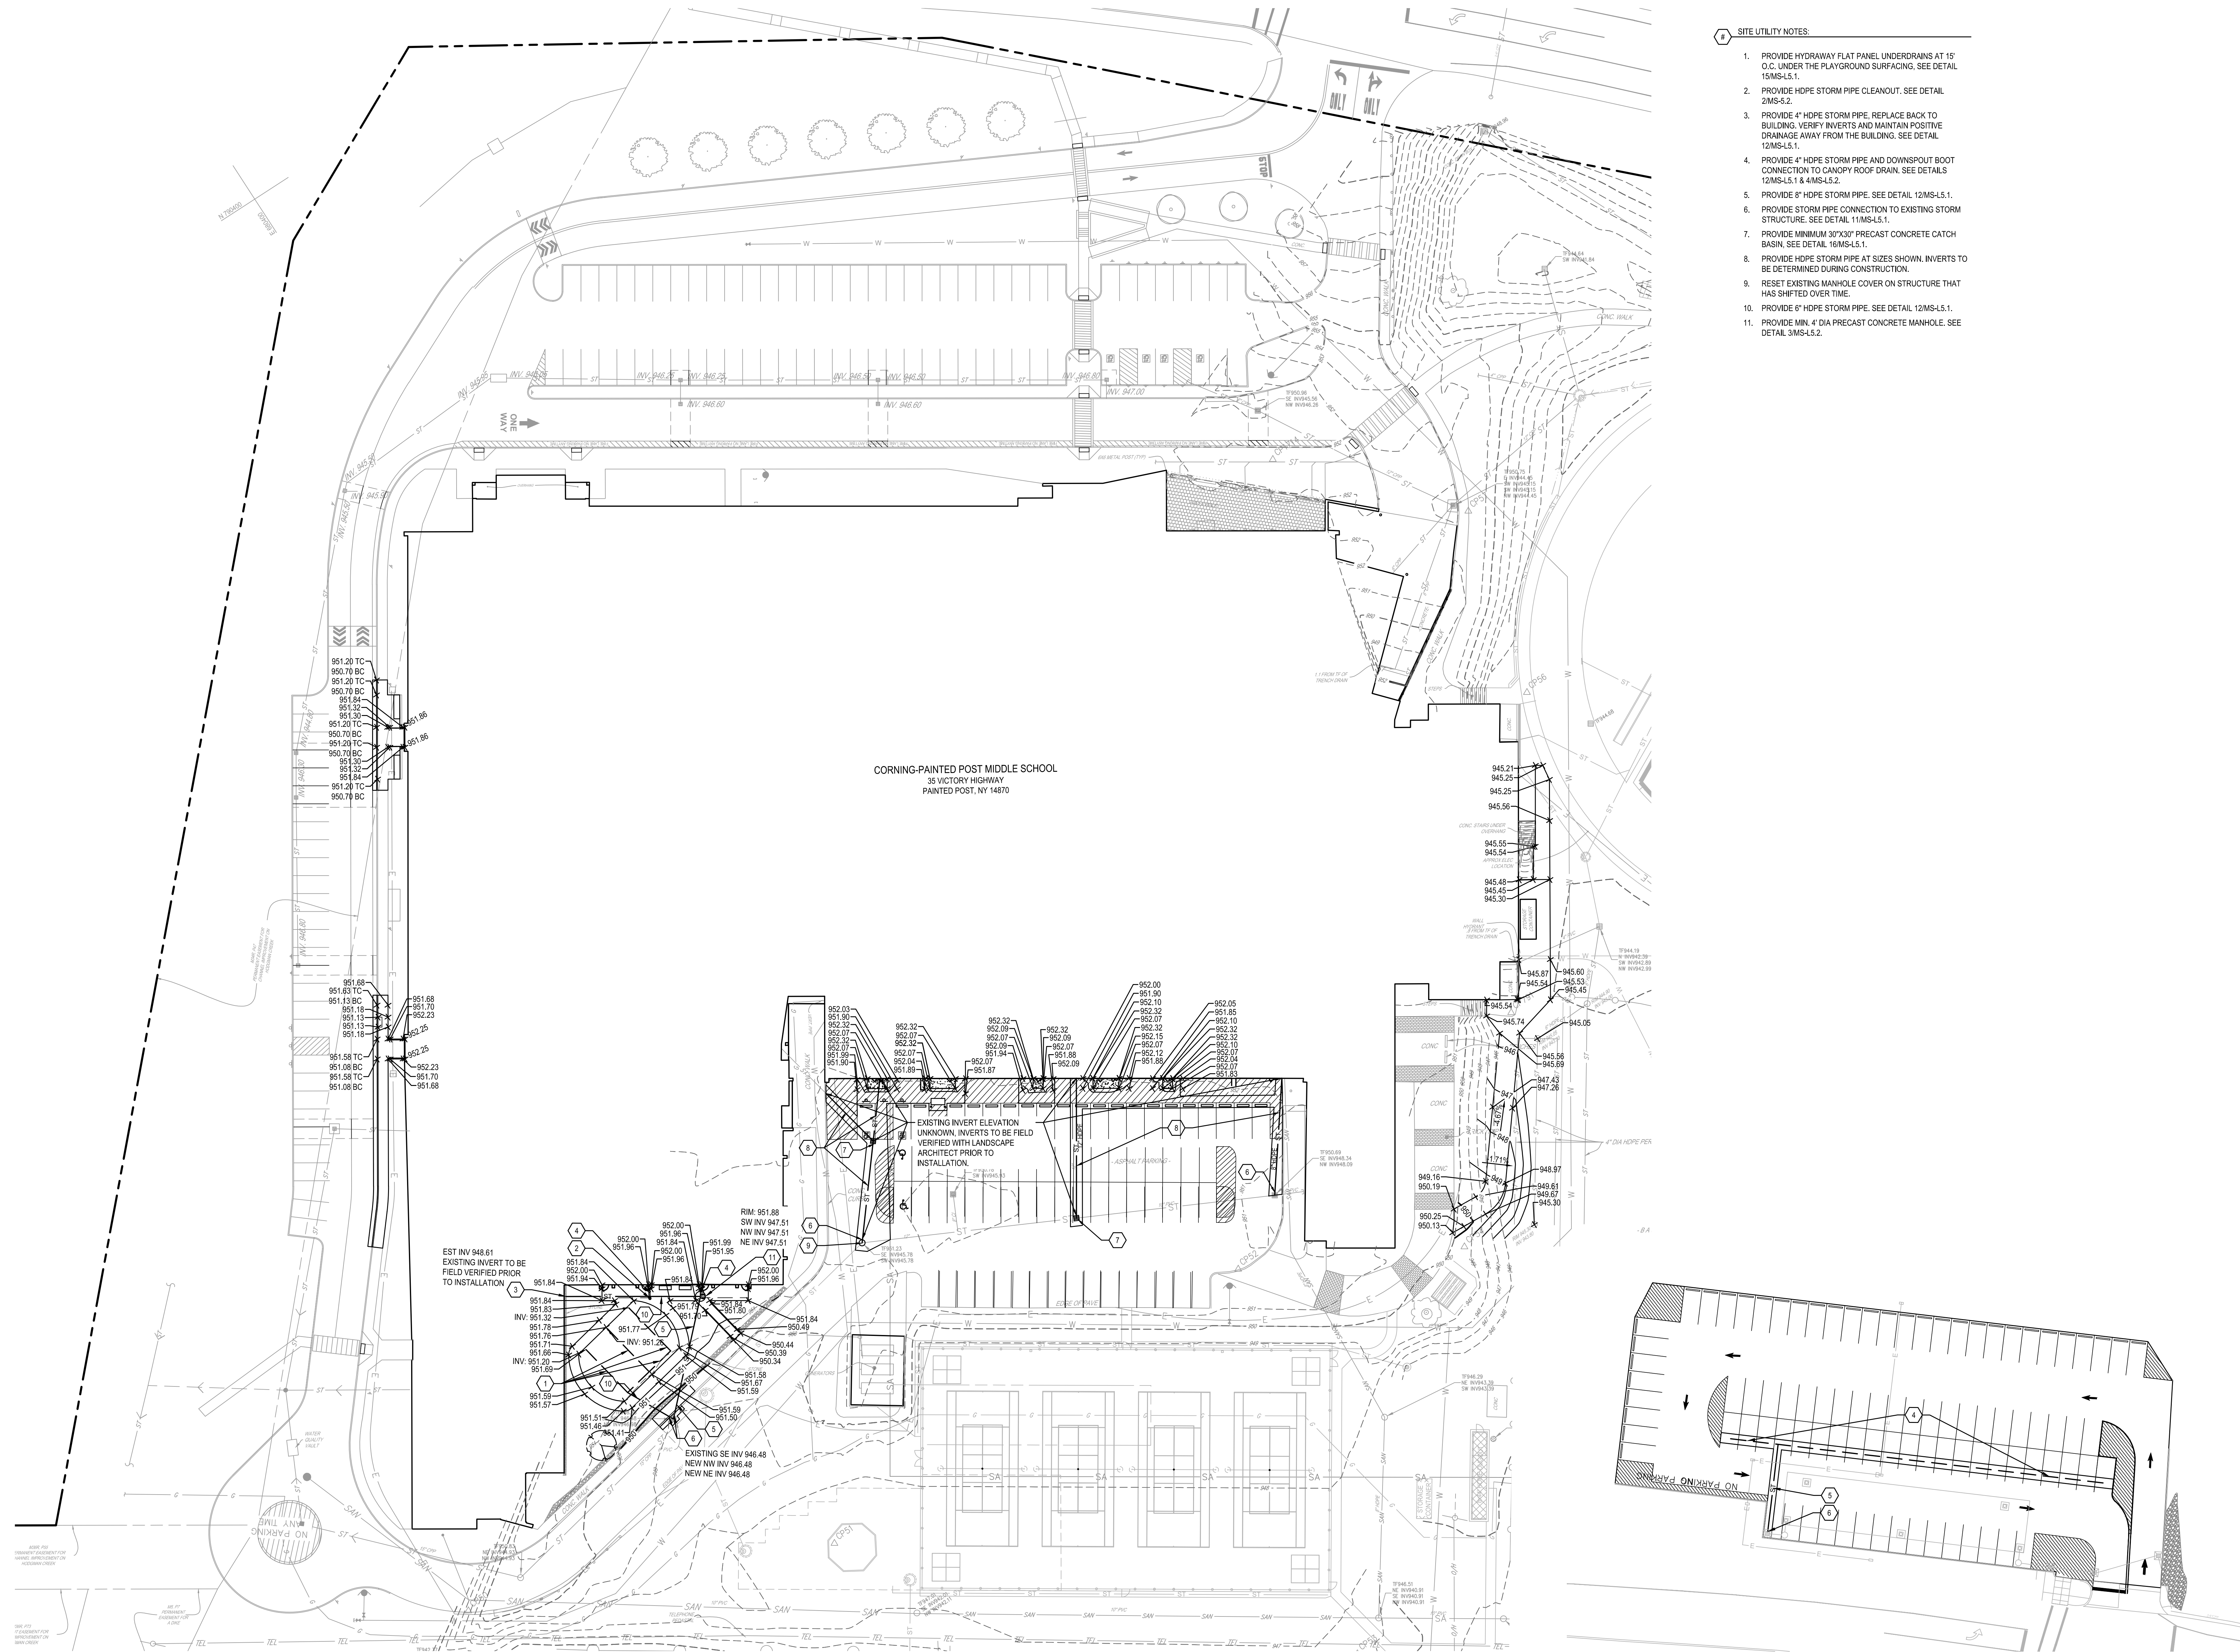
05/09/2025

DRAWN BY:

SM

10/20/2025





8 SITE UTILITY NOTES:

1. PROVIDE HYDRAWAY FLAT PANEL UNDERDRAINS AT 15' O.C. UNDER THE PLAYGROUND SURFACING. SEE DETAIL 15/MS-L5.1.
2. PROVIDE HDPE STORM PIPE CLEANOUT. SEE DETAIL 2/MS-S.2.
3. PROVIDE 4" HDPE STORM PIPE. REPLACE BACK TO BUILDING. VERIFY INVERTS AND MAINTAIN POSITIVE DRAINAGE AWAY FROM THE BUILDING. SEE DETAIL 12/MS-L5.1.
4. PROVIDE 4" HDPE STORM PIPE AND DOWNSPOUT BOOT CONNECTION TO CANOPY ROOF DRAIN. SEE DETAILS 12/MS-L5.1 & 4/MS-L5.2.
5. PROVIDE 8" HDPE STORM PIPE. SEE DETAIL 12/MS-L5.1.
6. PROVIDE STORM PIPE CONNECTION TO EXISTING STORM STRUCTURE. SEE DETAIL 11/MS-L5.1.
7. PROVIDE MINIMUM 30"x30" PRECAST CONCRETE CATCH BASIN. SEE DETAIL 16/MS-L5.1.
8. PROVIDE HDPE STORM PIPE AT SIZES SHOWN. INVERTS TO BE DETERMINED DURING CONSTRUCTION.
9. RESET EXISTING MANHOLE COVER ON STRUCTURE THAT HAS SHIFTED OVER TIME.
10. PROVIDE 6" HDPE STORM PIPE. SEE DETAIL 12/MS-L5.1.
11. PROVIDE MIN. 4" DIA PRECAST CONCRETE MANHOLE. SEE DETAIL 3/MS-L5.2.






**NOTES:**


1. MINIMUM CONCRETE RATING: 3000 PSI






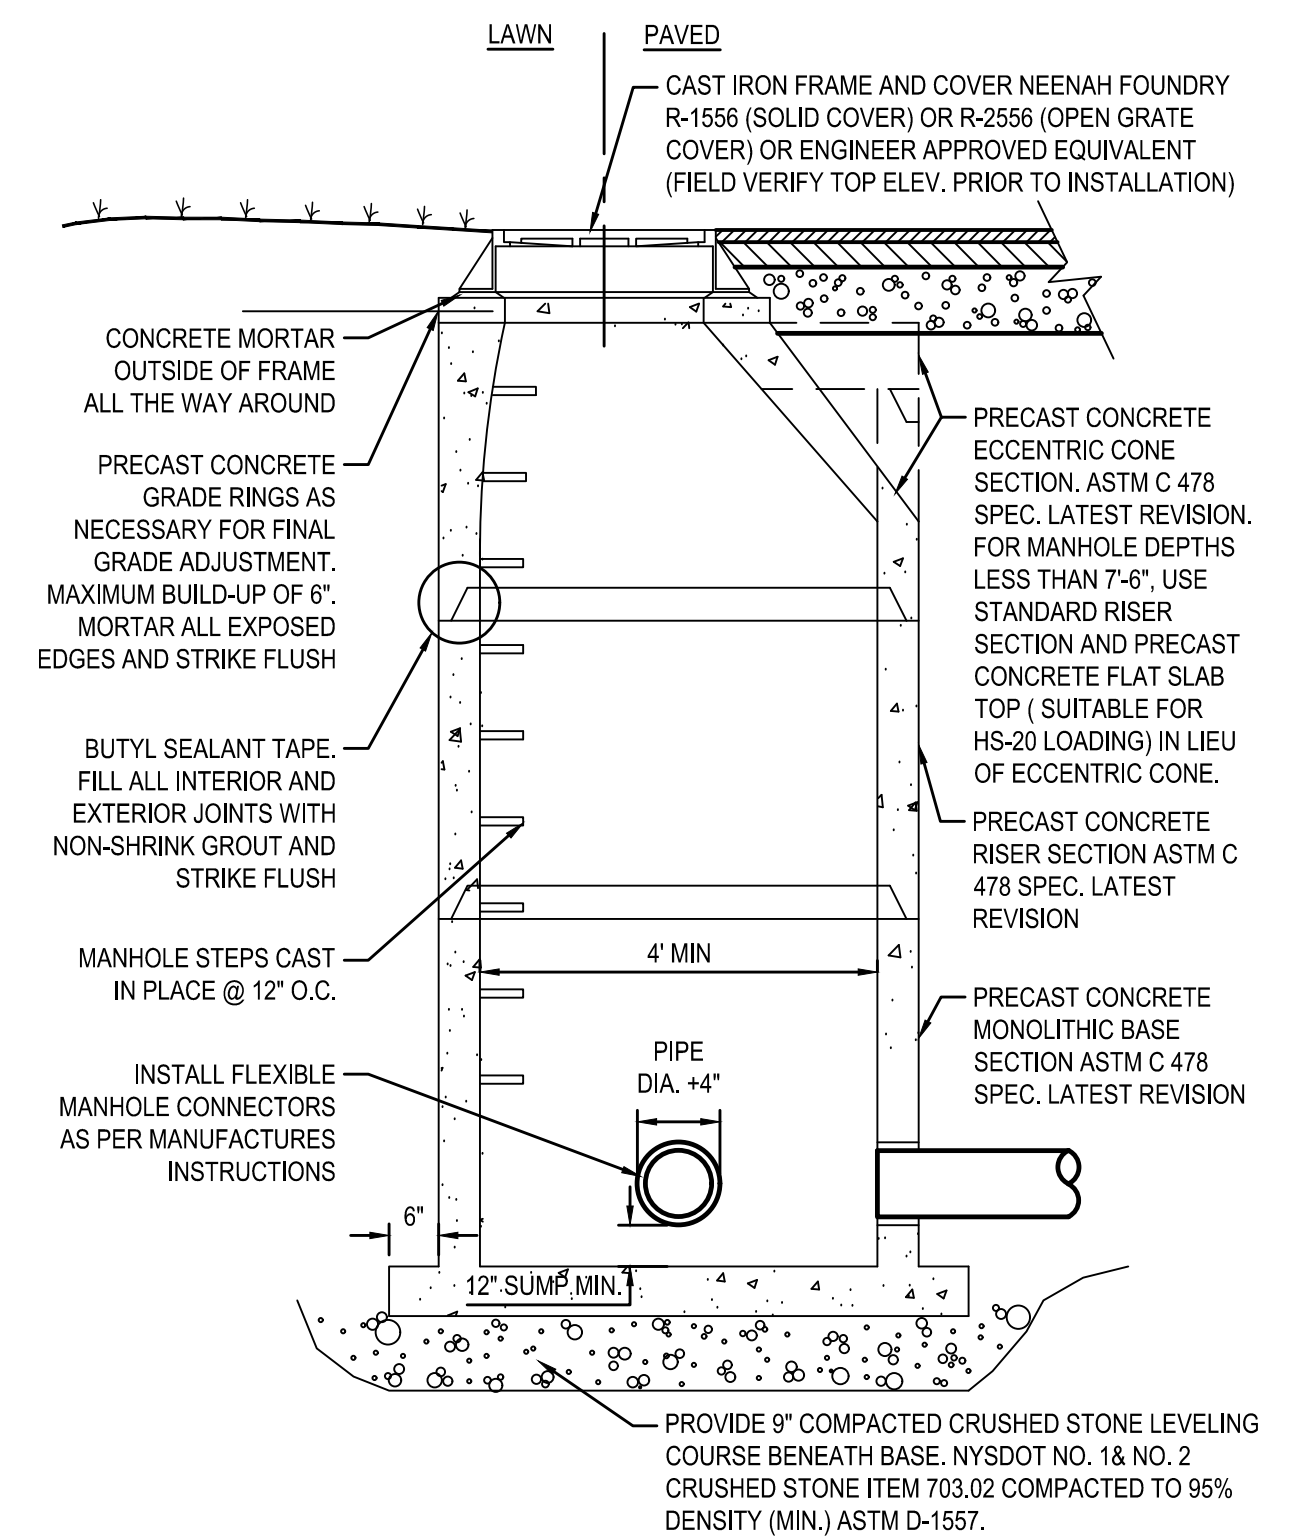

3 PRECAST CONCRETE STORM MANHOLE  
SCALE: N.T.S.

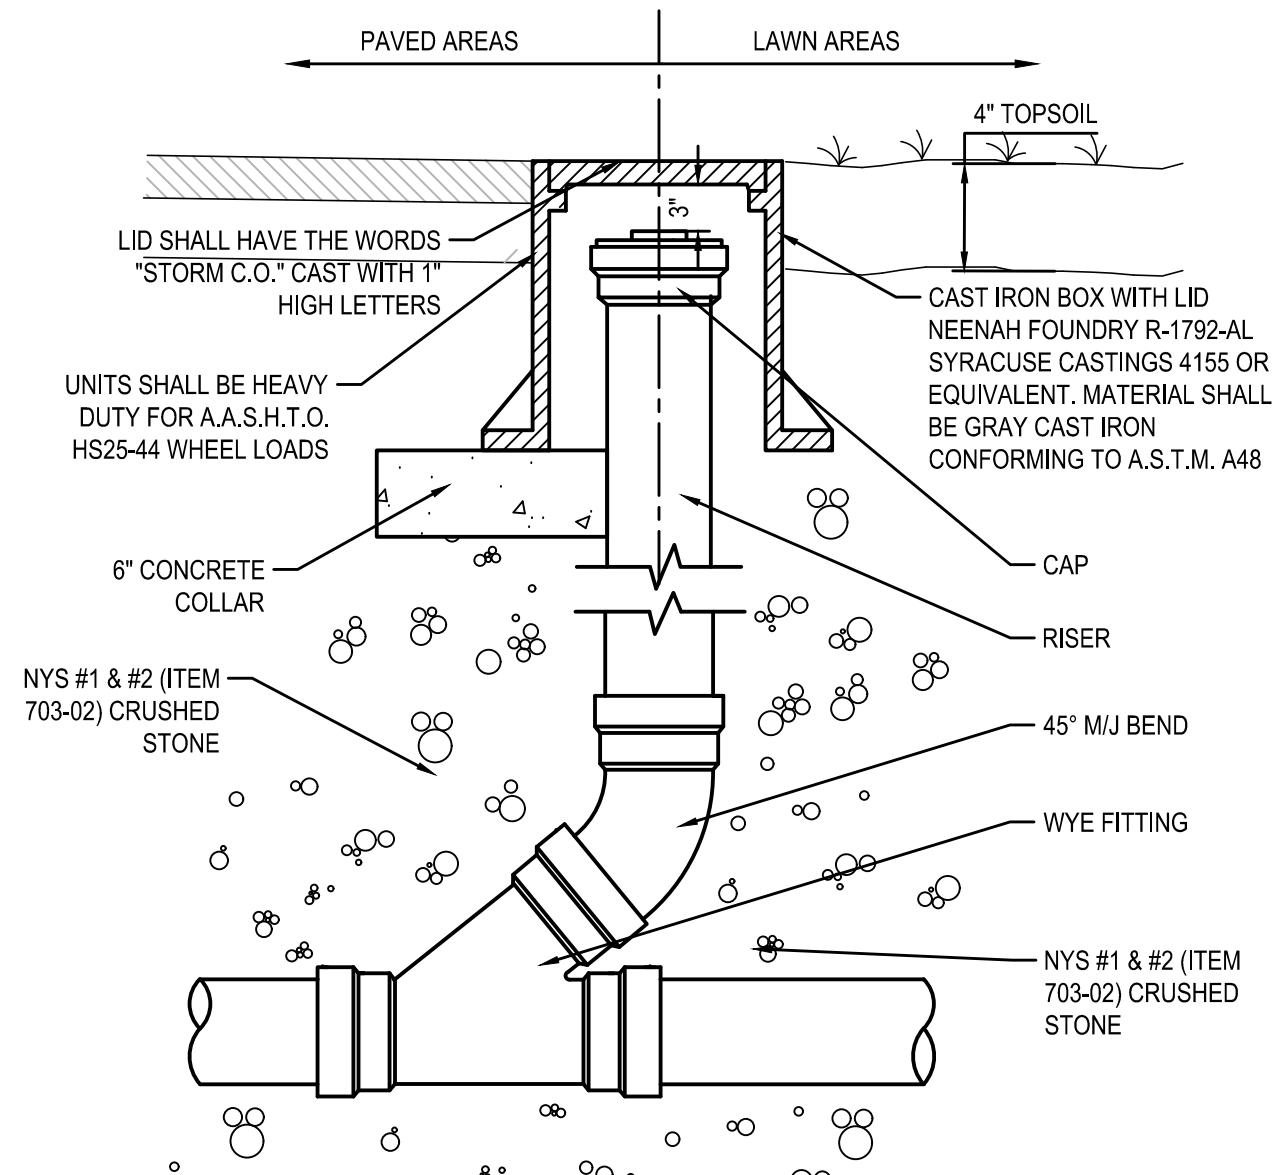


2 STORM CLEANOUT DETAIL  
SCALE: N.T.S.

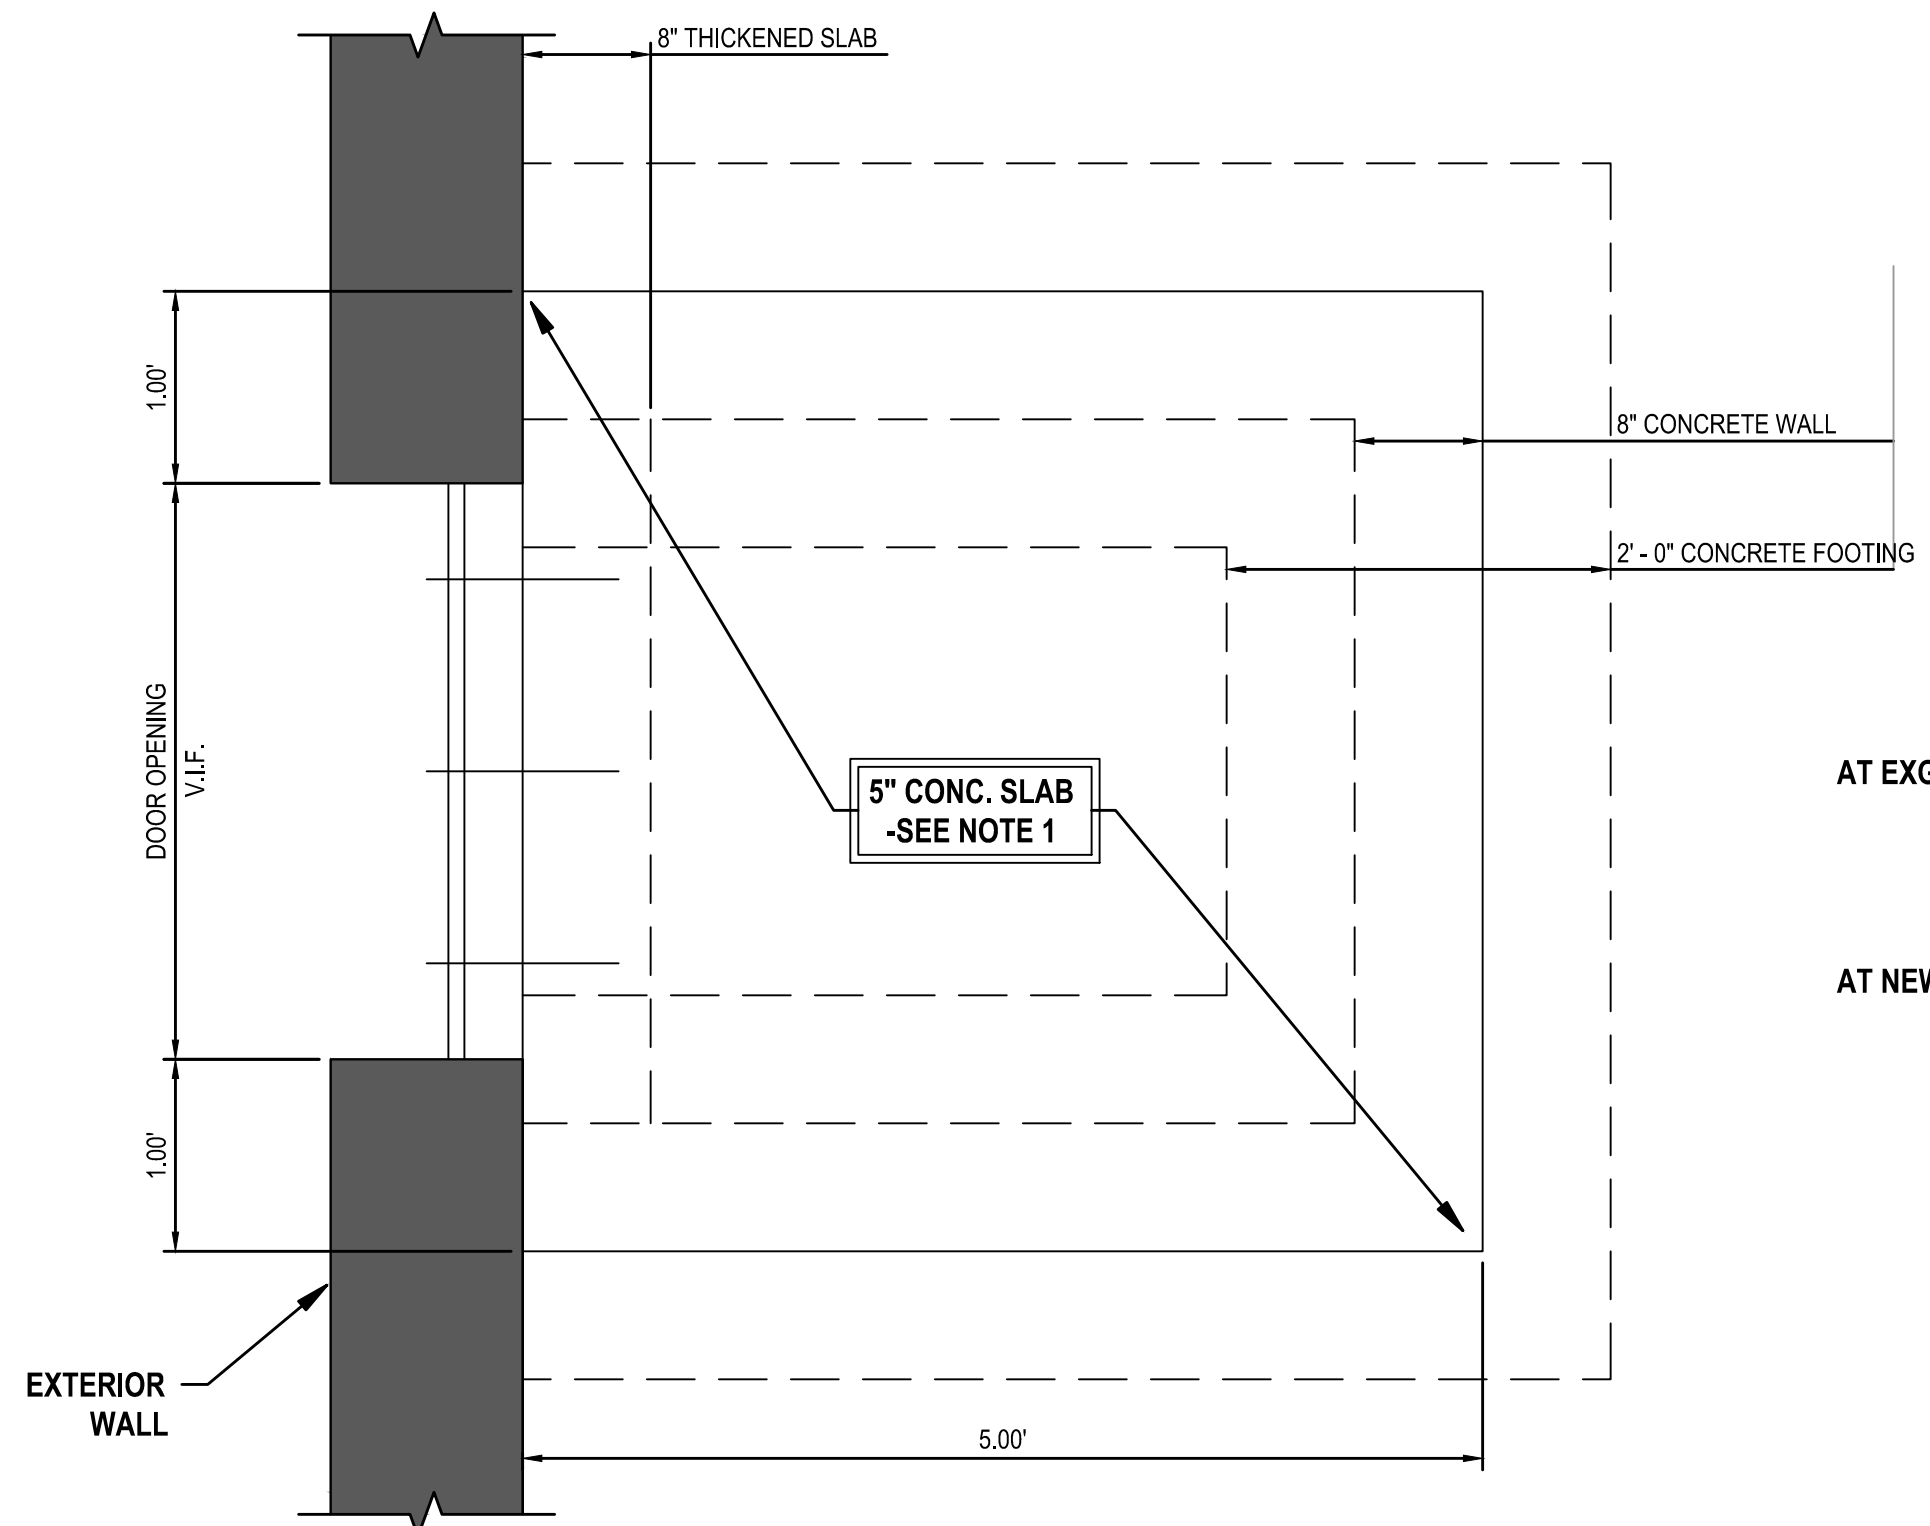


NOTES:  
1. 5" FIBER REINFORCED SLAB ON GRADE ADDITIONALLY REINFORCED WITH 6x6-W2.0xW2.0 WWF.  
PROVIDE SUPPORT CHAIRS TO HOLD WWF IN POSITION DURING CONCRETE PLACEMENT.  
PROVIDE AIR ENTRAINMENT.

1 CONCRETE PAD FOUNDATION  
SCALE: N.T.S.

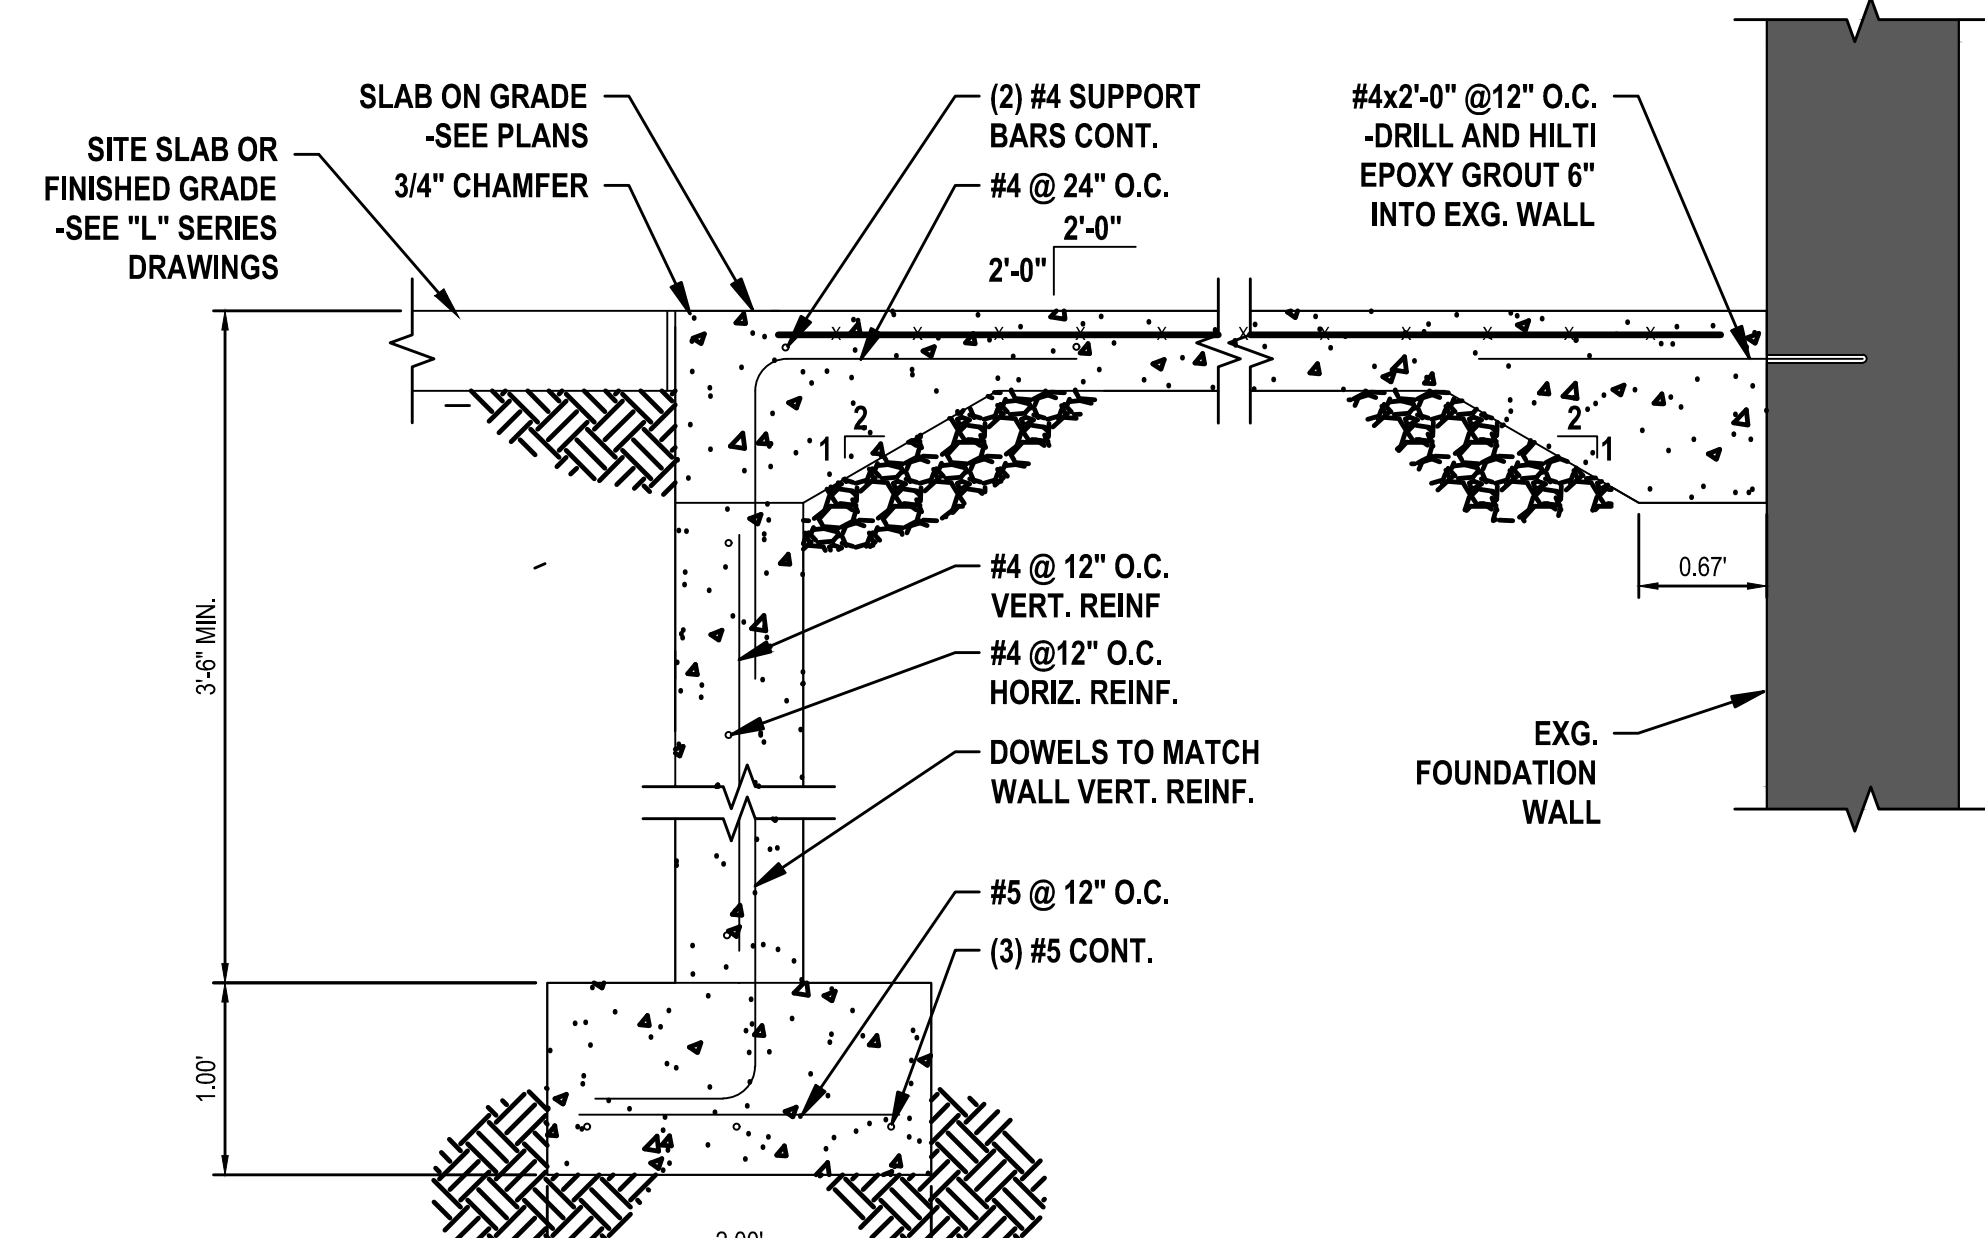
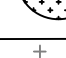

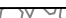

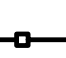
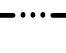



4 ROOF DRAIN ADAPTER DETAIL  
SCALE: N.T.S.



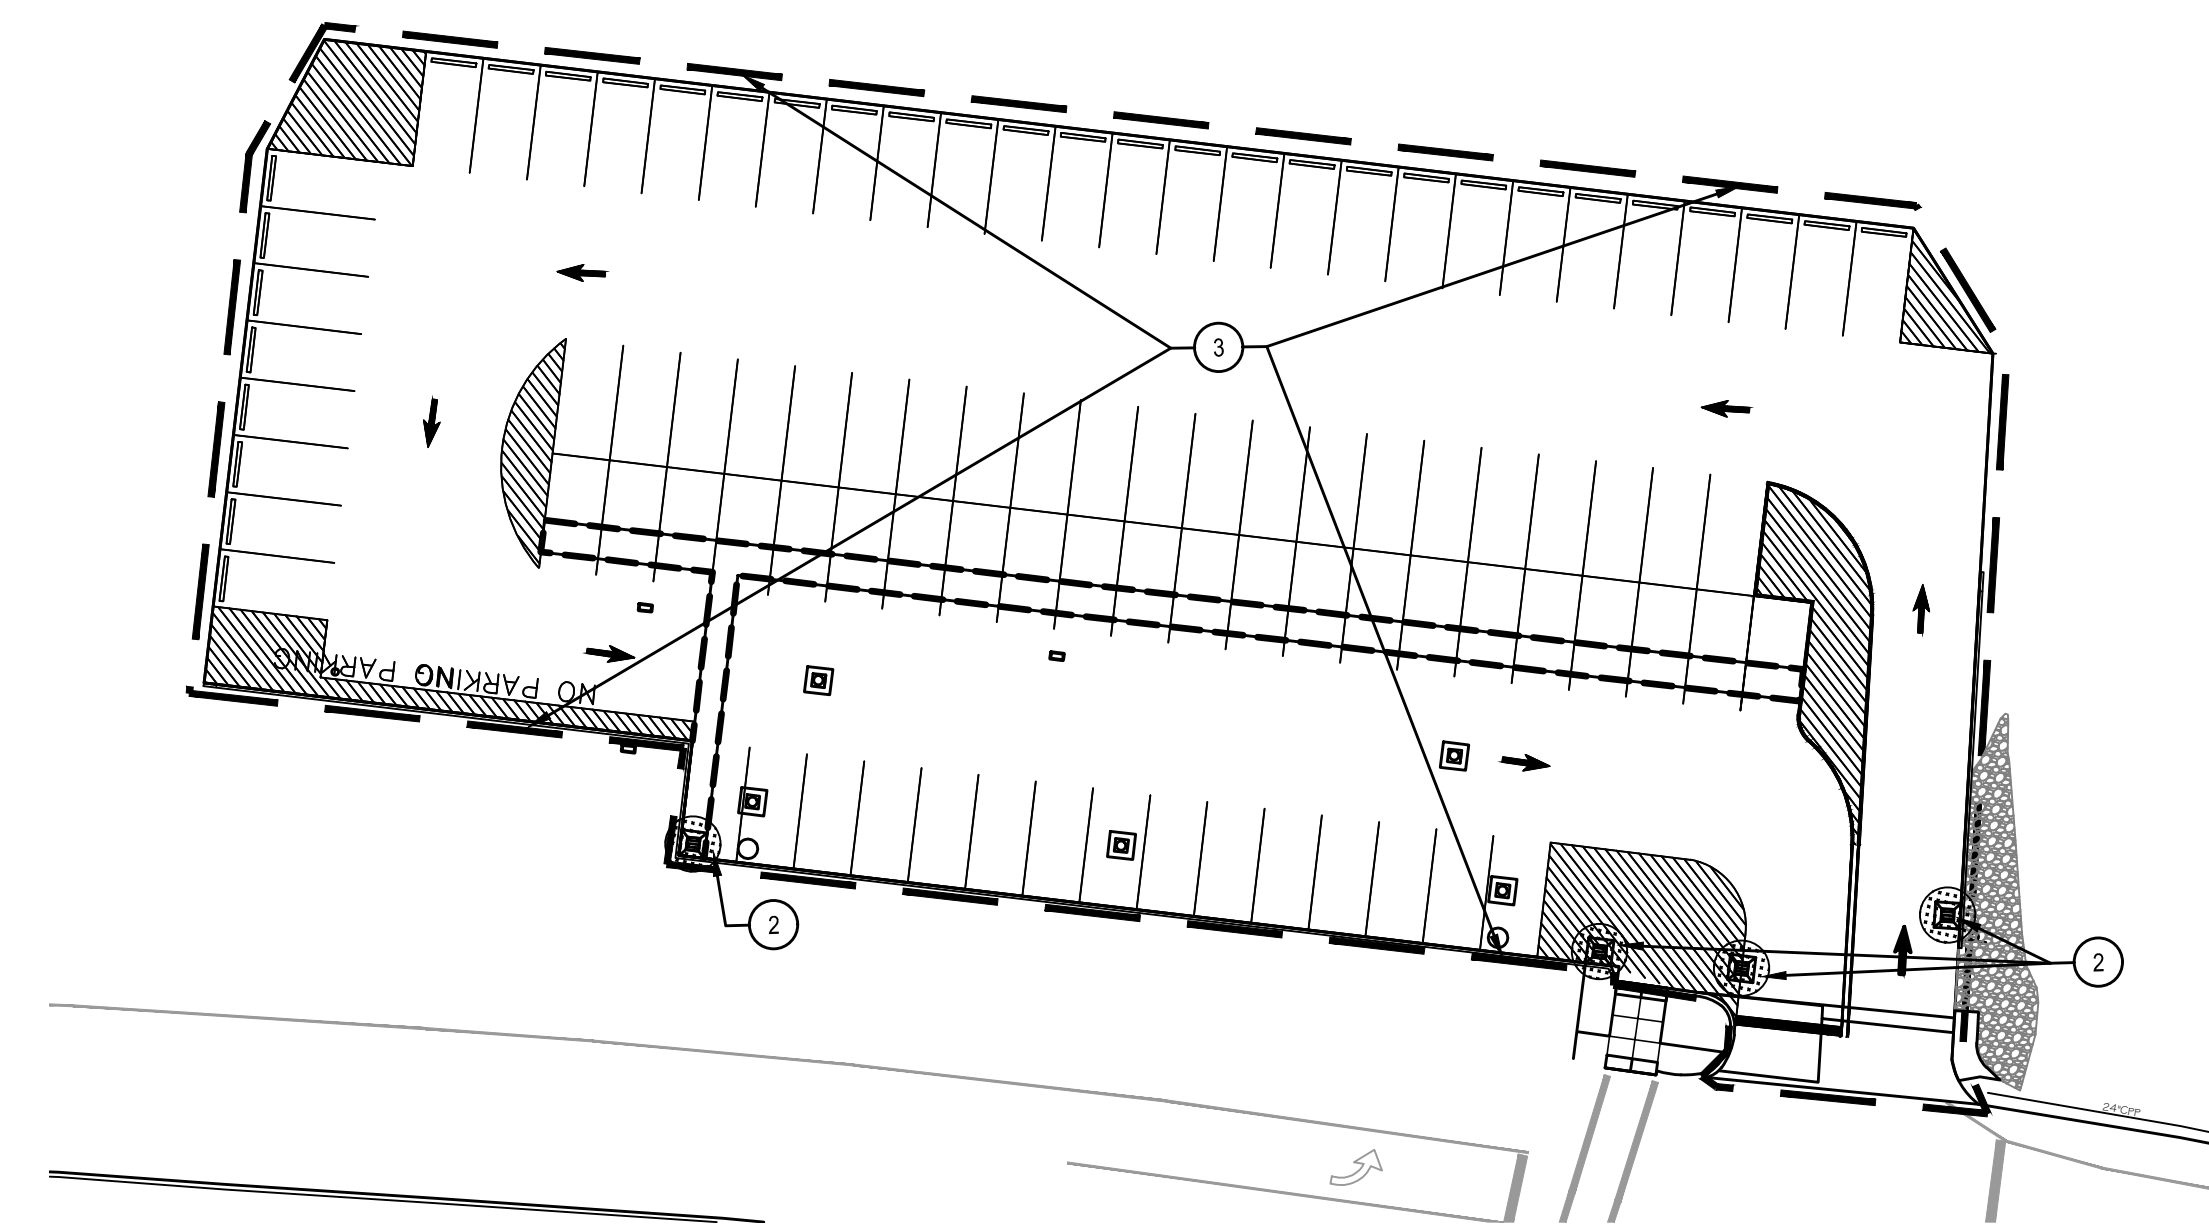

- LEGEND**

  -  INLET PROTECTION
  -  EROSION CONTROL BLANKET
  -  CONSTRUCTION ENTRANCE
  -  SILT SOCK
  -  STAGING AREA
  -  CONCRETE WASHOUT
  -  TOPSOIL STOCKPILE
  -  LIMIT OF DISTURBANCE

<b>MS-L6.1</b>	<b>SITE EROSION &amp; SEDIMENT CONTROL PLAN</b>
	<b>2025 MIDDLE SCHOOL PHASE III ALTERATIONS PROJECT</b> <b>CORNING-PAINTED POST ASD</b>
35 VICTORY HIGHWAY, PAINTED POST, NY 4870	



EROSION & SEDIMENT POLLUTION CONTROL GUIDELINES:


1. THE CONTRACTOR SHALL BE RESPONSIBLE FOR IMPLEMENTING EROSION AND SEDIMENT CONTROL TO PROTECT DOWNSTREAM WATER BODIES.
2. THE CONTRACTOR SHALL BE RESPONSIBLE FOR CONSTRUCTION CONTROL AND MAINTENANCE OF SOIL EROSION AND SEDIMENT CONTROL FACILITIES TO ENSURE PROPER FUNCTIONING OF SAID FACILITIES (DURING CONSTRUCTION).
3. AFTER THE PROJECT HAS BEEN COMPLETED, THE CONTRACTOR SHALL HAVE THE RESPONSIBILITY FOR ENSURING THAT ALL TEMPORARY SOIL EROSION AND SEDIMENT CONTROL MEASURES HAVE BEEN REMOVED OR REPLACED BY PERMANENT CONTROLS.
4. ANY DISTURBED AREAS THAT WILL BE LEFT EXPOSED FOR MORE THAN FIVE (5) DAYS, AND NOT SUBJECT TO CONSTRUCTION TRAFFIC, WILL IMMEDIATELY RECEIVE A TEMPORARY SEEDING. IF THE SEASON PREVENTS THE ESTABLISHMENT OF A TEMPORARY COVER, THE DISTURBED AREAS WILL BE MULCHED WITH STRAW OR EQUIVALENT MATERIAL, AT A RATE OF 2.5 - 3.0 TONS PER ACRE, ACCORDING TO STATE STANDARDS.
5. PERMANENT VEGETATION TO BE SEED OR SODDED ON ALL EXPOSED AREAS WITHIN FIVE (5) DAYS AFTER FINAL GRADING. MULCH IS NECESSARY FOR SEED PROTECTION AND ESTABLISHMENT. LIME AND FERTILIZE SEED BED PRIOR TO PERMANENT SEEDING.
6. EROSION AND SEDIMENT POLLUTION CONTROL FACILITIES AND PRACTICES, UTILIZED IN THE CONSTRUCTION OF THE PROJECT, SHALL BE CONSISTENT WITH THE LATEST VERSIONS OF THE NEW YORK STATE STANDARDS AND SPECIFICATIONS FOR EROSION AND SEDIMENT CONTROL, NEW YORK STATE STORMWATER MANAGEMENT DESIGN MANUAL AND THE NEW YORK STATE SPDES GENERAL PERMIT FOR STORMWATER DISCHARGES.
7. NATURAL VEGETATION SHALL BE RETAINED, PROTECTED, AND SUPPLEMENTED, AS FEASIBLE PRIOR TO AND DURING CONSTRUCTION.
8. CUT AND FILL SLOPES SHALL BE BROUGHT TO FINAL PROPOSED GRADES AS SOON AS POSSIBLE IN THE CONSTRUCTION SEQUENCES, AND SEEDED AND MULCHED IMMEDIATELY.
9. EROSION AND SEDIMENT POLLUTION CONTROL FACILITIES (SILT SOCK, INLET PROTECTION, STABILIZED CONSTRUCTION ENTRANCES AND ALL OTHER ACCEPTABLE FACILITIES) SHALL BE MAINTAINED THROUGHOUT CONSTRUCTION UNTIL COMPLETE SITE STABILIZATION.
10. HEAVY CONSTRUCTION EQUIPMENT SHALL BE KEPT AS CLOSE TO THE WORK AREA AS PRACTICAL TO MINIMIZE DISTURBANCE OF SOIL ALREADY STABILIZED OR UNDISTURBED. ANY HAZARDOUS MATERIALS THAT LEAK ONTO THE GROUND SHALL BE PROPERLY CLEANED AND DISPOSED PER NYSDEC AND EPA STANDARDS.
11. THE CONTRACTOR IS IN CHARGE OF IMPLEMENTING POLLUTION PREVENTION OF WASTE AND HAZARDOUS MATERIALS. THE CONTRACTOR SHALL HAVE A DESIGNATED REPRESENTATIVE ASSIGNED TO IMPLEMENTING THE SPILL PREVENTION AVOIDANCE AND RESPONSE PLAN. THE CONTRACTOR SHALL MAINTAIN A SPILL PREVENTION CONTROL AND COUNTER MEASURES PROGRAM AND HAVE APPROPRIATE MATERIALS TO CONTROL THE SPILLS ON SITE AT ALL TIMES.
12. TOPSOIL AND OTHER SOIL REMOVED DURING CONSTRUCTION SHALL BE STOCKPILED IN A SUITABLE LOCATION CLEAR FROM ANY STORMWATER DRAINAGE COURSES. STOCKPILES SHALL HAVE EITHER A SILT SOCK OR SILT FENCE AROUND THE PERIMETER AT ALL TIMES. STOCKPILES WHICH ARE INACTIVE FOR MORE THAN 5 DAYS SHALL BE SEED.
13. VEGETATIVE STABILIZATION SHALL BE PERIODICALLY INSPECTED FOR SUFFICIENT GROWTH AND PROGRESS. AREAS NOT RESPONDING SHALL BE PROMPTLY RESEEDED AND REMULCHED AS SOON AS POSSIBLE. AREAS SHOWING SIGNS OF EROSION PRIOR TO STABILIZATION SHALL BE GRADED, RESEEDED, AND REMULCHED AS SOON AS POSSIBLE. SOD OR EROSION CONTROL FABRIC SHALL BE UTILIZED WHERE ADEQUATE STABILIZATION IS NOT OCCURRING.
14. ALL PERIMETER SOIL EROSION AND SEDIMENT CONTROL MEASURES SHALL BE INSTALLED BEFORE BEGINNING EARTH MOVING ACTIVITIES, OR IN THEIR PROPER SEQUENCE, AND MAINTAINED UNTIL PERMANENT PROTECTION IS ESTABLISHED.
15. A STABILIZED CONSTRUCTION ENTRANCE PAD OF 1.5' TO 2' CLEAN STONE WILL BE PLACED AT ALL CONSTRUCTION DRIVEWAYS BEFORE INITIAL SITE DISTURBANCE. CONSTRUCTION ENTRANCES SHALL BE MAINTAINED AND CLEANED AS NEEDED OR AS SPECIFIED BY THE INSPECTOR.
16. THE APPLICATION OF TOPSOIL, LIMING, FERTILIZING, SEEDING, AND MULCHING FOR DISTURBED AREAS SHALL BE CONSISTENT WITH THE STANDARD GENERAL PRACTICES FOR CONSTRUCTION.
17. IMMEDIATELY FOLLOWING INITIAL DISTURBANCES OF ROUGH GRADING, ALL CRITICAL AREAS SUBJECT TO EROSION (I.E., STEEP SLOPES AND ROADWAY EMBANKMENTS, ETC.) WILL RECEIVE A TEMPORARY SEEDING IN COMBINATION WITH STRAW MULCH OR A SUITABLE EQUIVALENT, AT A RATE OF 2.5 - 3.0 TONS PER ACRE.
18. AT THE TIME WHEN SITE PREPARATION FOR PERMANENT VEGETATIVE STABILIZATION IS TO BE ESTABLISHED, ANY SOIL THAT WILL NOT PROVIDE A SUITABLE ENVIRONMENT TO SUPPORT ADEQUATE VEGETATIVE GROUND COVER SHALL BE REMOVED OR TREATED IN SUCH A WAY THAT WILL PERMANENTLY ADJUST THE SOIL CONDITIONS AND RENDER IT SUITABLE FOR VEGETATIVE GROUND COVER.
19. IF THE REMOVAL OR TREATMENT OF THE SOIL WILL NOT PROVIDE SUITABLE CONDITIONS, NON-VEGETATIVE MEANS OF PERMANENT GROUND STABILIZATION WILL HAVE TO BE EMPLOYED.
20. IT SHALL BE THE CONTRACTOR'S RESPONSIBILITY TO MAINTAIN EROSION AND SEDIMENT CONTROL MEASURES UNTIL ALL CONTRIBUTING AREAS HAVE BEEN PERMANENTLY STABILIZED.

MAINTENANCE & REPAIR OF EROSION & SEDIMENT FACILITIES

1. PROPER MAINTENANCE AND REPAIR OF EROSION AND SEDIMENT CONTROL FACILITIES ARE NECESSARY TO THE EFFECTIVENESS OF THE EROSION AND SEDIMENT POLLUTION CONTROL FACILITIES.
2. DISTURBED GROUND SURFACES SHALL BE SPRINKLED WITH WATER AND/OR CARBON CHLORIDE, AS NEEDED, TO LIMIT THE FORMATION AND MIGRATION OF AIRBORNE DUST.
3. OPERATIONAL MEASURES SHALL BE EMPLOYED DURING CONSTRUCTION TO PREVENT THE SPILLS OF FUELS, LUBRICANTS OR OTHER HAZARDOUS MATERIALS. IF A SPILL OCCURS, IT SHALL BE CONTROLLED IMMEDIATELY TO PREVENT ITS ENTRY INTO OFF-SITE AREAS INCLUDING ADJACENT STORM SEWERS.
4. ANY TEMPORARY EROSION CONTROL FACILITY SHALL REMAIN FUNCTIONAL UNTIL VEGETATIVE COVER IS SUFFICIENTLY ESTABLISHED WITHIN THE RESPECTIVE TRIBUTARY DRAINAGE AREA.
5. ANY DEBRIS ACCUMULATED IN EROSION AND SEDIMENT CONTROL FACILITIES SHALL BE REMOVED AND PROPERLY DISPOSED OF. THESE FACILITIES SHALL BE CHECKED DAILY AND AFTER RAINFALL EVENTS, AND READJUSTED AS NEEDED. SEDIMENT SHALL BE REMOVED WHEN IT REACHES THE FOLLOWING DEPTHS:
  - SILT SOCK - 1/2 HEIGHT
  - CHECK DAM - 1/2 HEIGHTNOTE: DISTURBED AREAS SHALL BE CONSIDERED AS PERMANENTLY STABILIZED WHEN A MINIMUM COVER OF 80% HAS BEEN ESTABLISHED.
6. ANY EROSION AND SEDIMENT CONTROL DEVICES THAT ARE NOTED AS DEFICIENT BY A SWPPP INSPECTOR, DESIGN ENGINEER, OR NYSDEC STAFF SHALL BE REPAIRED OR REPLACED WITHIN 24 HOURS OF RECEIVING NOTICE.

SOIL RESTORATION REQUIREMENTS


1. AERATION AND THE APPLICATION OF 6 INCHES OF TOPSOIL IS REQUIRED IN ANY PROPOSED LAWN AREA WHERE TOPSOIL HAS BEEN DISTURBED.
2. FULL SOIL RESTORATION IS REQUIRED IN HEAVY TRAFFIC AREAS ON SITE, ESPECIALLY BETWEEN 5 AND 25 FEET AROUND THE PROPOSED BUILDING, BUT NOT WITHIN A 5 FOOT PERIMETER AROUND FOUNDATION WALLS. RESTORATION IS ALSO REQUIRED ON REDEVELOPMENT PROJECTS IN AREAS WHERE EXISTING IMPERVIOUS AREA WILL BE CONVERTED TO PERVIOUS AREA.
3. FULL SOIL RESTORATION REQUIREMENTS ARE AS FOLLOWS:
  - SOIL RESTORATION IS TO TAKE PLACE DURING PERIODS OF RELATIVELY LOW TO MODERATE SUBSOIL MOISTURE, FOLLOWING ROUGH GRADING OF THE DISTURBED SUBSOILS
  - APPLY 3 INCHES OF COMPOST OVER SUBSOIL
  - TILL COMPOST INTO SUBSOIL TO A DEPTH OF AT LEAST 12 INCHES USING A CAT-MOUNTED RIPPER, TRACTOR-MOUNTED DISC, OR TILLER, MIXING, AND CIRCULATING AIR AND COMPOST INTO SUBSOILS
  - ROCK-PICK UNTIL UPLIFTED STONE/ROCK MATERIALS OF FOUR INCHES AND LARGER SIZE ARE CLEANED OFF THE SITE
  - APPLY TOPSOIL TO A DEPTH OF 6 INCHES
  - VEGETATE AS SPECIFIED ON PLANS
4. AT THE END OF THE PROJECT AN INSPECTOR SHOULD BE ABLE TO PUSH A 3/8 INCH METAL BAR 12 INCHES INTO THE SOIL JUST WITH BODY WEIGHT.
5. TILLING SHOULD NOT BE PERFORMED WITHIN THE DRIP LINE OF ANY EXISTING TREES OR OVER UTILITY INSTALLATIONS THAT ARE WITHIN 24 INCHES OF THE SURFACE.
6. ADDITIONAL INFORMATION AND GUIDANCE MAY BE FOUND IN "DEEP-RIPPING AND DECOMPACTION" PUBLISHED BY NYSDEC DIVISION OF WATER 2008.

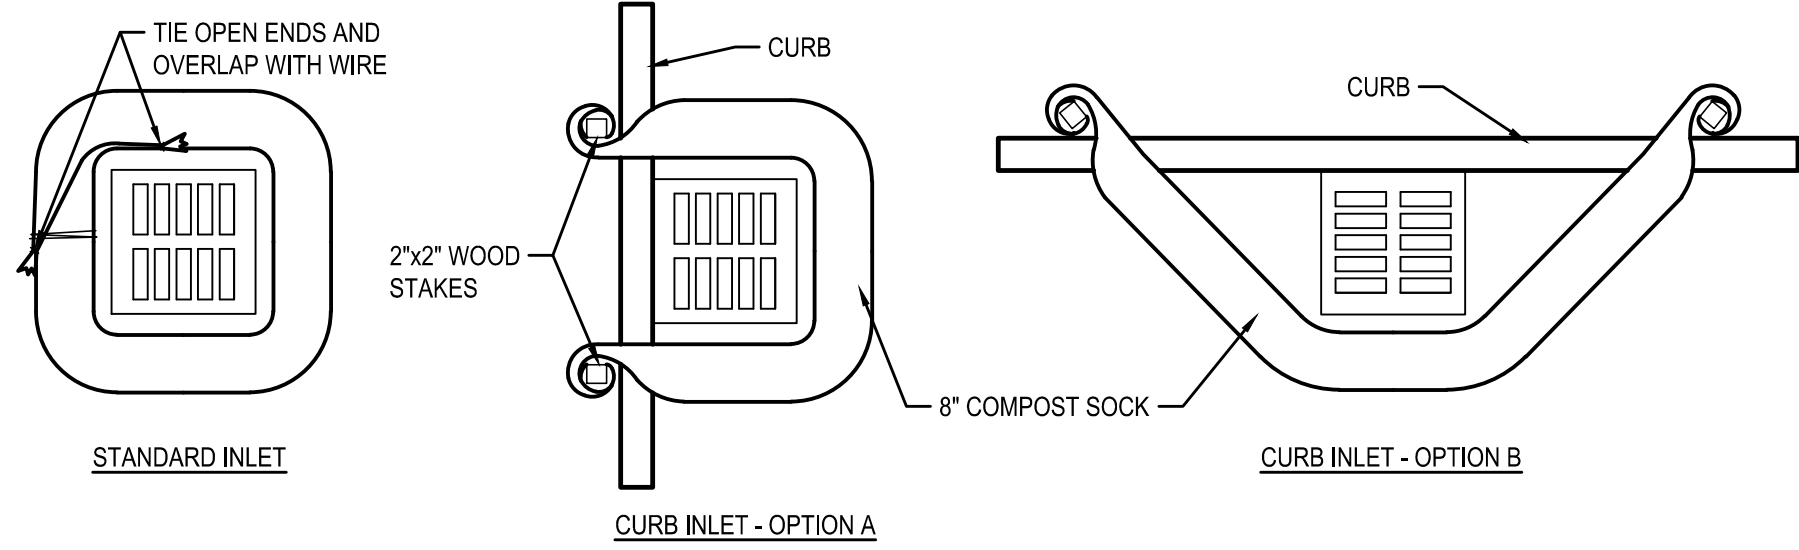

INSTALLATION NOTES:

1. COMPOST SOCKS SHALL BE INSTALLED PRIOR TO ANY LAND-DISTURBING ACTIVITIES.
2. COMPOST SOCKS SHALL BE "SILT SOCK", "FILTEREX" OR OTHER APPROVED FILTER FABRIC SOCK
3. COMPOST SOCKS SHALL BE FILLED WITH WOOD CHIPS OR COMPOST. SEE SPECIFICATIONS FOR APPROVED COMPOSITION OF WOOD CHIPS OR COMPOST
4. COMPOST SOCKS SHALL BE INSTALLED PER MANUFACTURERS SPECIFICATIONS.
5. COMPOST SOCK SHALL BE IN CONSTANT CONTACT WITH THE GROUND SURFACE.
6. WOOD STAKES SHALL BE USED TO SECURE THE WATTLES. 1/2" TO 5/8" REBAR IS ALSO ACCEPTABLE. BE SURE TO USE A STAKE THAT IS LONG ENOUGH TO PROTRUDE SEVERAL INCHES ABOVE THE WATTLE.
7. EXCESS FABRIC SHALL BE WRAPPED AROUND THE STAKES.
8. FOR INLETS NOT ON A CURB THE COMPOST SOCK SHALL BE TIED OFF AT BOTH ENDS WITH TIE WIRE AND OVERLAPPED TO PROVIDE SUITABLE PROTECTION.

2 COMPOST/SILT SOCK INLET PROTECTION DETAIL  
SCALE: N.T.S.

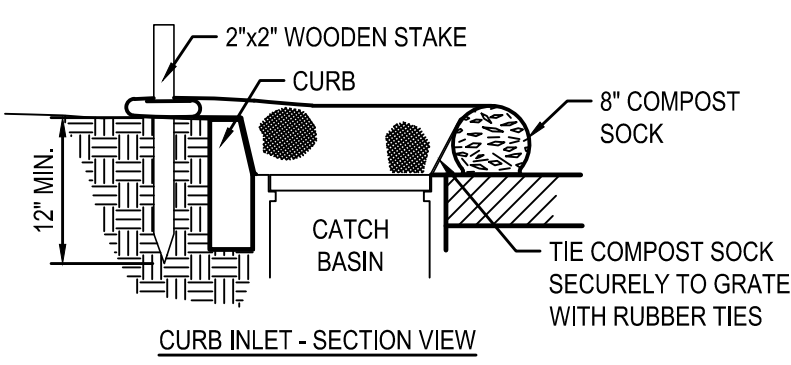

MAINTENANCE:  
SEDIMENT ACCUMULATED BEHIND WATTLE SHALL BE REMOVED WHEN SEDIMENT HAS ACCUMULATED TO ONE-HALF THE DIAMETER OF THE SILT/COMPOST SOCK.

NOTES:

INSTALLATION:  
WHEN INSTALLING RUNNING LENGTHS OF COMPOST SOCKS, BUTT THE SECOND SOCK TIGHTLY AGAINST THE FIRST. DO NOT OVERLAP THE ENDS. STAKE THE SOCKS AT EACH END AND FIVE FOOT ON CENTER.

STAKES SHOULD BE DRIVEN THROUGH THE MIDDLE OF THE SOCK, LEAVING 2 - 3 INCHES OF THE STAKE PROTRUDING ABOVE THE SOCK AND AT LEAST 12" IN THE GROUND. WHEN COMPOST SOCKS ARE USED FOR FLAT GROUND APPLICATIONS, DRIVE THE STAKES STRAIGHT DOWN; WHEN INSTALLING WATTLES ON SLOPES, DRIVE THE STAKES PERPENDICULAR TO THE SLOPE.


DRIVE THE FIRST END STAKE OF THE SECOND SOCK AT AN ANGLE TOWARD THE FIRST SOCK IN ORDER TO HELP ABUT THEM TIGHTLY TOGETHER.

INSTALLATION NOTES:

1. COMPOST SOCKS SHALL BE INSTALLED PRIOR TO ANY LAND-DISTURBING ACTIVITIES.
2. COMPOST SOCKS SHALL BE FILLED WITH WOOD CHIPS OR COMPOST. SEE SPECIFICATIONS FOR APPROVED COMPOSITION OF WOOD CHIPS OR COMPOST
3. NOT FOR USE IN CONCENTRATED FLOW AREAS.
4. COMPOST SOCKS SHALL BE INSTALLED PER MANUFACTURERS SPECIFICATIONS.
5. ON SLOPES, COMPOST SOCKS SHOULD BE INSTALLED ON CONTOUR WITH A SLIGHT DOWNWARD ANGLE AT THE END OF THE ROW IN ORDER TO PREVENT PONDING AT THE MID SECTION.
6. RUNNING LENGTHS OF SOCKS SHOULD BE ABUTTED FIRMLY TO ENSURE NO LEAKAGE AT THE ABUTMENTS.
7. COMPOST SOCK SHALL BE IN CONSTANT CONTACT WITH THE GROUND SURFACE.
8. WOOD STAKES SHALL BE USED TO SECURE THE WATTLES. 1/2" TO 5/8" REBAR IS ALSO ACCEPTABLE. BE SURE TO USE A STAKE THAT IS LONG ENOUGH TO PROTRUDE SEVERAL INCHES ABOVE THE WATTLE.

MAINTENANCE:  
SEDIMENT ACCUMULATED BEHIND WATTLE SHALL BE REMOVED WHEN SEDIMENT HAS ACCUMULATED TO ONE-HALF THE DIAMETER OF THE WATTLE.


1 COMPOST OR SILT SOCK INSTALLATION DETAIL  
SCALE: N.T.S.

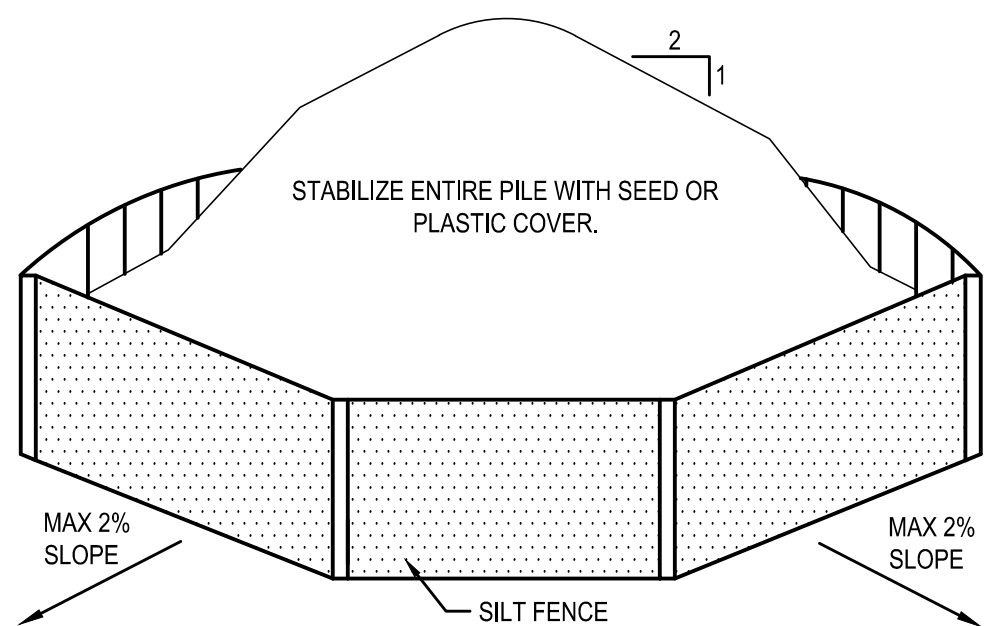

SOIL STOCKPILING NOTES:

1. AREA CHOSEN FOR STOCKPILING OPERATIONS SHALL BE DRY AND STABLE.
2. MAXIMUM SLOPE OF STOCKPILE SHALL BE 1:2.
3. UPON COMPLETION OF SOIL STOCKPILING, EACH PILE SHALL BE SURROUNDED WITH SILT FENCING AND THEN STABILIZED WITH SEED OR SECURED IMPERVIOUS COVER.
4. SEE SILT FENCE INSTALLATION DETAIL.


4 SOIL STOCKPILE AREA DETAIL  
SCALE: N.T.S.

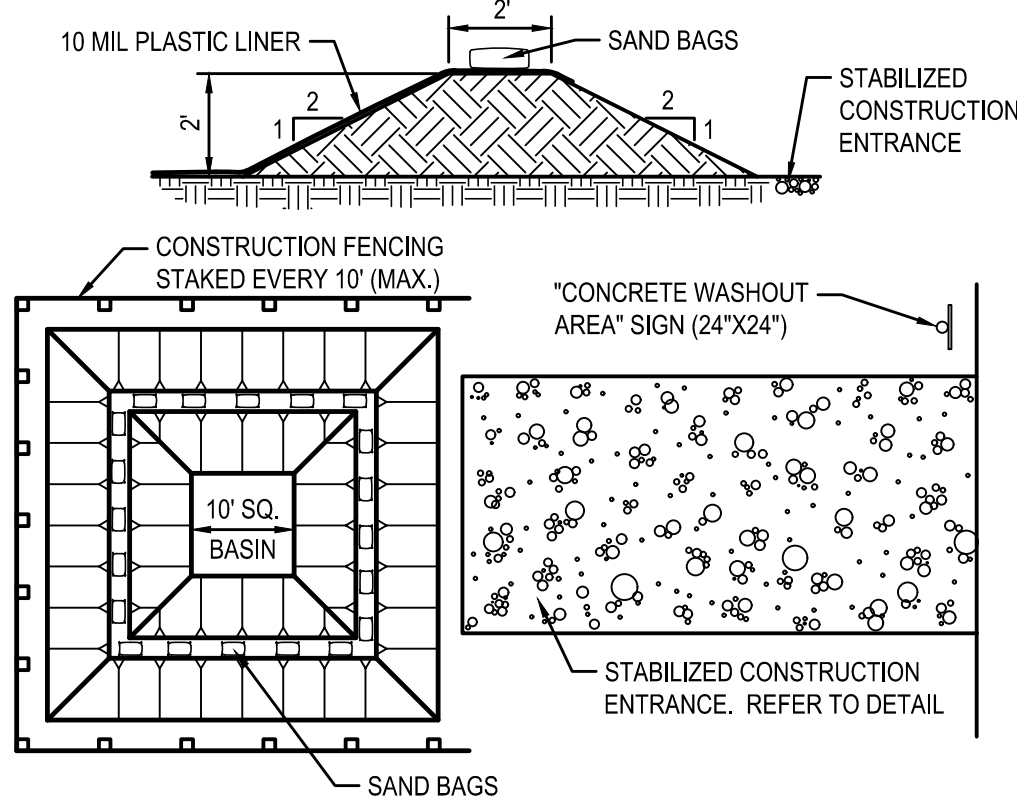

NOTES:

1. ALL TOOLS AND EQUIPMENT UTILIZED DURING ANY CONCRETE CONSTRUCTION, INCLUDING HAND TOOLS, WHEELBARROWS, TRUCKS, CHUTES SHALL UTILIZE THE CONCRETE WASHOUT AREA.
2. WASHOUT AREA TO BE MAINTAINED AND CLEANED OUT PERIODICALLY TO PREVENT WASHWATER AND/OR SOLIDS FROM EXITING THE WASHOUT TRAP.

3 CONCRETE WASH OUT DETAIL  
SCALE: N.T.S.

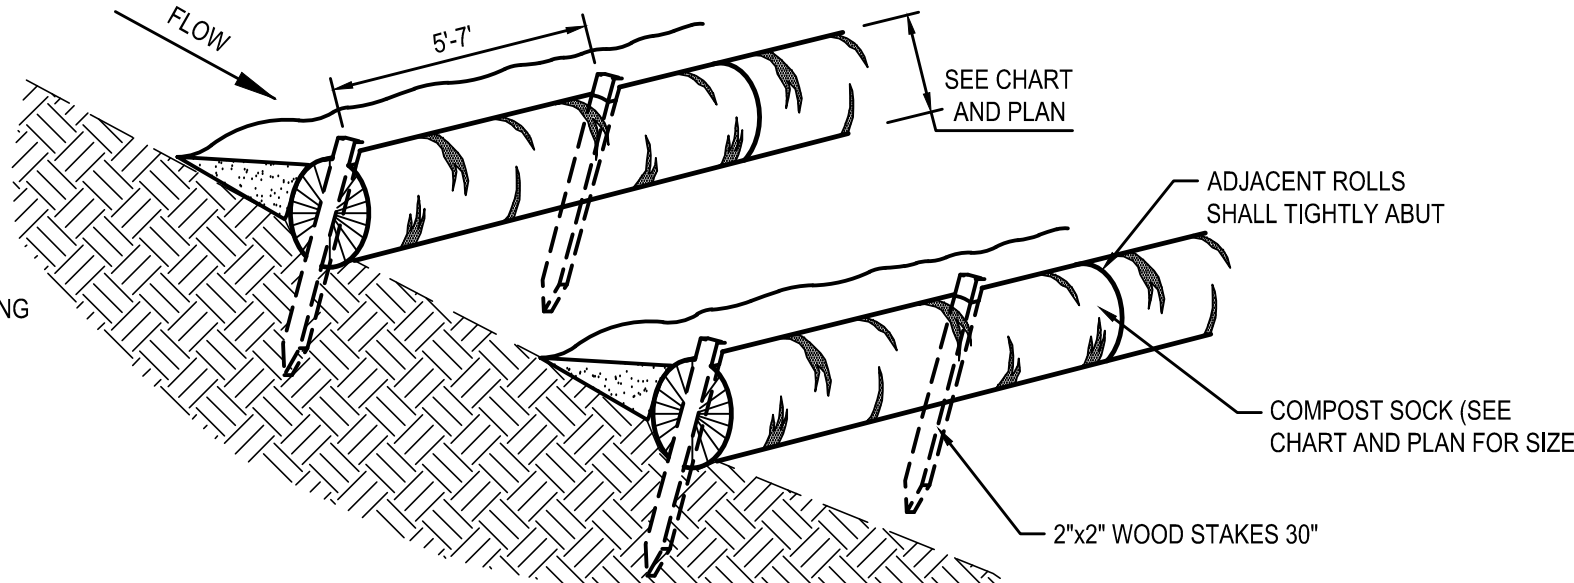

COMPOST SOCK DIAMETER CHART									
DIA. (IN)	SLOPE %								
	2	5	10	20	25	33	50		
8	225	200	100	50	20	-	-		
12	250	225	125	65	50	40	25		
16	275	250	150	70	55	45	30		
24	350	275	200	130	100	60	35		
32	450	325	275	150	120	75	50		

\*LENGTH IN FEET



GENERAL STRUCTURAL NOTES														
A. BUILDING CODES AND STANDARDS			C. FOUNDATION/EARTHWORK/GEOTECHNICAL REPORT			D. CONSTRUCTION			E. CONCRETE			F. STRUCTURAL STEEL		
1. THE FOLLOWING CODES AND STANDARDS, INCLUDING ALL SPECIFICATION REFERENCED WITHIN, SHALL APPLY TO THE DESIGN, CONSTRUCTION, QUALITY CONTROL AND SAFETY OF ALL WORK PERFORMED ON THE PROJECT.  a. "2020 BUILDING CODE OF NEW YORK STATE"  b. "MINIMUM DESIGN LOADS FOR BUILDING AND OTHER STRUCTURES", (ANSI/ASCE 7) AMERICAN SOCIETY OF CIVIL ENGINEERS			1. DESIGN DATA:  a. NO GEOTECHNICAL INFORMATION HAS BEEN PROVIDED BY THE OWNER AT THIS TIME. FOUNDATIONS ARE DESIGNED BASED ON ASSUMED BEARING PRESSURES AND SHALL BE CONFIRMED BY A GEOTECHNICAL ENGINEER BEFORE PLACEMENT OF FOUNDATIONS.  b. ALL EXTERIOR FOUNDATIONS SHALL BEAR A MINIMUM OF 4'-0" BELOW GRADE AND 1'-0" BELOW INTERIOR FINISHED FLOOR GRADE. IN CASE OF CONFLICT, NOTIFY THE ARCHITECT AND STRUCTURAL ENGINEER IN ADVANCE OF ANY CONSTRUCTION TO ALLOW FOR ADJUSTMENT.			1. GENERAL  a. UNAUTHORIZED REPRODUCTION OF ANY PORTION OF THE STRUCTURAL CONTRACT DRAWINGS FOR RESUBMITTAL AS SHOP DRAWINGS IS PROHIBITED. SHOP DRAWINGS PRODUCED IN SUCH A MANNER WILL BE REJECTED AND RETURNED.  b. THESE DRAWINGS REPRESENT THE COMPLETED PROJECT WHICH HAS BEEN DESIGNED FOR THE WEIGHTS OF MATERIALS INDICATED ON THE DRAWINGS AND FOR THE SUPERIMPOSED LOADS INDICATED ON THE DRAWINGS AND FOR THE SUPERIMPOSED LOADS INDICATED IN THE DESIGN LOADS. IT IS THE CONTRACTOR'S RESPONSIBILITY TO DETERMINE ALLOWABLE CONSTRUCTION LOADS AND TO PROVIDE PROPER DESIGN AND CONSTRUCTION OF FALSE WORK, STAGINGS, BRACING, SHEETING AND SHORING, ETC.. ALL SHORING CALCULATIONS AND DRAWINGS SHALL BE SIGNED AND SEALED BY AN ENGINEER REGISTERED IN THE STATE OF NEW YORK.  c. IN CASE OF CONFLICT BETWEEN THE GENERAL NOTES, DETAILS AND SPECIFICATIONS, THE MOST RIGID REQUIREMENTS SHALL GOVERN.  d. IMPLEMENTING JOB SITE SAFETY AND CONSTRUCTION PROCEDURES ARE THE SOLE RESPONSIBILITY OF THE CONTRACTOR.  e. ALL COSTS OF INVESTIGATION AND/OR REDESIGN, DUE TO THE CONTRACTOR MIS LOCATION OF STRUCTURAL ELEMENTS OR OTHER LACK OF CONFORMANCE WITH THE PROJECT DOCUMENTS, SHALL BE AT THE CONTRACTOR'S EXPENSE.  f. CONTRACTOR SHALL REFER TO ARCHITECTURAL, MECHANICAL, PLUMBING, ELECTRICAL AND OTHER APPLICABLE DRAWINGS FOR SIZE AND LOCATIONS OF OPENINGS, SLEEVES, CONCRETE HOUSEKEEPING PADS, INSERTS, AND DEPRESSIONS.  g. SEE ARCHITECTURAL DRAWINGS AND SPECIFICATIONS FOR DETAILED INFORMATION REGARDING FINISHES, FIREPROOFING, WATERPROOFING, ETC.  h. CONTRACTOR SHALL FURNISH DIMENSIONED SHOP DRAWINGS AT ALL LEVELS LOCATING FLOOR AND ROOF EDGES FOR REVIEW BY THE ARCHITECT AND STRUCTURAL ENGINEER.  i. CONTRACTOR SHALL FURNISH DIMENSIONED SHOP DRAWINGS AT ALL LEVELS SHOWING THE LOCATIONS OF ALL SLEEVES AND OPENINGS REQUIRED BY ALL TRADES.  j. THE CONTRACTOR SHALL SUBMIT, FOR REVIEW, DRAWINGS AND CALCULATIONS SIGNED AND SEALED BY A STRUCTURAL ENGINEER REGISTERED IN THE PROJECT'S JURISDICTION FOR THE FOLLOWING ASSEMBLIES. THIS REVIEW SHALL BE FOR GENERAL CONFORMANCE WITH THE PROJECT PARAMETERS AS INDICATED ON THE DRAWINGS AND IN THE GENERAL NOTES. THE DESIGN OF THESE ASSEMBLIES IS THE RESPONSIBILITY OF THE ENGINEER WHO HAS SIGNED AND SEALED THESE DRAWINGS AND CALCULATIONS. THE DESIGN OF THESE ASSEMBLIES SHALL TAKE INTO ACCOUNT ALL VERTICAL AND LATERAL LOADS REQUIRED BY APPLICABLE BUILDING CODES.  (1) METAL STAIRS AND METAL RAILINGS: WHERE HEADERS OR OTHER TYPES OF STRUCTURAL MEMBERS HAVE BEEN DESIGNATED BY THE STRUCTURAL ENGINEER OF RECORD TO SUPPORT THE STAIRS, THE CONNECTION FROM THE STAIR SHALL BE DESIGNED SO THAT NO ECCENTRIC OR TORSIONAL FORCES ARE INDUCED IN THESE STRUCTURAL MEMBERS. THE CONTRACTOR SHALL BE RESPONSIBLE FOR FURNISHING AND INSTALLING EMBEDS AND HARDWARE AS REQUIRED BY THE STAIR MANUFACTURER.  k. WORK NOT INCLUDED ON THE DRAWINGS BUT IMPLIED TO BE SIMILAR TO THAT SHOWN AT CORRESPONDING PLACES ELSEWHERE ON THE DRAWINGS SHALL BE REPEATED.  l. EXISTING BUILDING INFORMATION SHOWN IS BASED ON EXISTING BUILDING DRAWINGS, FIELD OBSERVATIONS, AND/OR ARCHITECTURAL DRAWINGS. THE CONTRACTOR SHALL VERIFY ALL EXISTING BUILDING INFORMATION SHOWN (DIMENSIONS, ELEVATIONS, ETC.) AND NOTIFY THE ARCHITECT AND STRUCTURAL ENGINEER OF ANY DISCREPANCIES. NEW SLABS ARE TO BE AT THE SAME ELEVATIONS AS ADJACENT EXISTING SLABS, UNLESS INDICATED OTHERWISE. FOUNDATION ELEVATIONS OR COLUMN LENGTHS SHALL BE ADJUSTED WITH THE APPROVAL OF THE STRUCTURAL ENGINEER TO ACHIEVE MATCHING SLAB ELEVATIONS.  m. SEE ARCHITECTURAL DRAWINGS FOR LOCATIONS OF MASONRY AND DRYWALL, NON-LOADBEARING PARTITIONS. PROVIDE SLIP CONNECTIONS THAT ALLOW VERTICAL MOVEMENT AT THE HEADS OF ALL SUCH PARTITIONS. UNLESS SHOWN ON THE DRAWINGS, THE CONNECTIONS SHALL BE DESIGNED TO SUPPORT THE TOP OF THE WALLS LaterALLY FOR THE CODE REQUIRED LATERAL LOAD. PROVIDE COMPRESSIBLE FIRE SAFING AT THE TOP OF WALL AS REQUIRED BY ARCHITECTURAL DRAWINGS.			1. CODES  a. "BUILDING CODE REQUIREMENTS FOR STRUCTURAL CONCRETE, ACI 318", AMERICAN CONCRETE INSTITUTE.  b. "ACI MANUAL OF CONCRETE PRACTICE - PARTS 1 THROUGH 5".  c. "MANUAL OF STANDARD PRACTICE", CONCRETE REINFORCING STEEL INSTITUTE.			1. CODES  a. "AISC STEEL CONSTRUCTION MANUAL", FOURTEENTH EDITION, 2011. AMERICAN INSTITUTE OF STEEL CONSTRUCTION INCLUDING SPECIFICATIONS FOR STRUCTURAL STEEL BUILDINGS, SPECIFICATION FOR STRUCTURAL JOINTS USING HIGH-STRENGTH BOLTS, AND AISC CODE OF STANDARD PRACTICE FOR STEEL BUILDINGS AND BRIDGES; WITH EXCEPTION, IF ANY, AS INDICATED IN THE SPECIFICATIONS).  b. "MANUAL OF STEEL CONSTRUCTION, VOLUME II CONNECTIONS", ASD NINTH EDITION/LRFD SECOND EDITION, AMERICAN INSTITUTE OF STEEL CONSTRUCTION.  c. "DETAILING FOR STEEL CONSTRUCTION", AMERICAN INSTITUTE OF STEEL CONSTRUCTION.  d. "STRUCTURAL WELDING CODE ANSIAWS D1.1", AMERICAN WELDING SOCIETY.		
2. ADDITIONAL CODES FOR MATERIALS SHALL BE FOUND IN THE APPROPRIATE SECTIONS THAT FOLLOW. SEE THOSE SECTIONS FOR THE APPLICABLE CODES.			2. FOUNDATION SYSTEM			2. MATERIALS			2. MATERIALS			2. MATERIALS		
B. DESIGN LOADS			a. SPREAD FOOTINGS			APPLICATION			APPLICATION			a. ROLLED SHAPES		
1. GRAVITY - DEAD LOADS			(1) BUILDING SPREAD AND STRIP FOOTINGS SHALL BEAR ON UNDISTURBED NATURAL SOILS OR PROPERLY PLACED AND COMPACTED ENGINEERED FILL WITH A MINIMUM ALLOWABLE BEARING PRESSURE OF 2000 PSF. BEARING PRESSURES SHALL BE VERIFIED BY AN EXPERIENCED QUALIFIED GEOTECHNICAL ENGINEER PRIOR TO PLACEMENT OF FOUNDATIONS.			SLABS ON-GRADE (INTERIOR)			SLABS ON-GRADE (INTERIOR)			ASTM A992, Fy = 50ksi		
a. AREA EXISTING ROOF			(2) NEW FOOTING BEARING ELEVATIONS ARE TO MATCH ADJACENT EXISTING FOOTING BEARING WHERE APPLICABLE UNLESS INDICATED OTHERWISE ON PLANS.			SLABS ON-GRADE (EXTERIOR)			SLABS ON-GRADE (EXTERIOR)			ASTM A36		
b. GRAVITY - LIVE LOADS			3. GENERAL			FOOTINGS			FOOTINGS			ASTM A500, GRADE C, Fy = 50 ksi		
a. ROOF LIVE LOAD 20 PSF MIN. (SNOW LOAD USED WHEN GREATER)			a. SEE THE SPECIFICATIONS AND GEOTECHNICAL REPORT FOR EXCAVATION, DEWATERING AND PREPARATION OF THE FOUNDATION AND SLAB-ON-GRADE SUBGRADE, INCLUDING COMPACTION PROCEDURES. REQUIREMENTS CONTAINED IN THE GEOTECHNICAL REPORTS ARE PART OF THIS WORK.			COLUMNS			COLUMNS			ASTM A500, GRADE C, Fy = 50 ksi		
b. ROOF SNOW LOAD 31 PSF+ DRIFTING (WHERE APPLICABLE)			b. CONTRACTOR SHALL VERIFY ALL EXISTING FIELD CONDITIONS THAT MAY AFFECT THE INSTALLATION OF THE FOUNDATION SYSTEM AS SHOWN PRIOR TO STARTING WORK.			FILL ON METAL DECK			FILL ON METAL DECK			ASTM A53, GRADE B, Fy = 35 ksi		
(1) GROUND SNOW LOAD			c. THE CONTRACTOR SHALL BE RESPONSIBLE FOR LOCATION AND PROTECTING ALL EXISTING UTILITIES, EXISTING STRUCTURES, ETC.. WHETHER INDICATED OR NOT, WHICH MAY BE AFFECTED BY THE CONSTRUCTION PROCESS.			*PUMP MIXES: MAXIMUM WATER/CEMENT RATIO MUST BE MAINTAINED. IF ADDITIONAL WORKABILITY IS REQUIRED FOR PUMPED PLACEMENT, THE HIGH OR MID-RANGE WATER REDUCERS SHALL BE USED IN LIEU OF ADDITIONAL WATER.			*PUMP MIXES: MAXIMUM WATER/CEMENT RATIO MUST BE MAINTAINED. IF ADDITIONAL WORKABILITY IS REQUIRED FOR PUMPED PLACEMENT, THE HIGH OR MID-RANGE WATER REDUCERS SHALL BE USED IN LIEU OF ADDITIONAL WATER.			ASTM A570, OR APPROVED EQUAL		
(2) EXPOSURE FACTOR			d. UTILITY LINES SHALL NOT BE PLACED THROUGH OR BELOW FOUNDATIONS WITHOUT THE STRUCTURAL ENGINEER'S APPROVAL.			ASTM C150, TYPE I OR III			ASTM C150, TYPE I OR III			ASTM A570, OR APPROVED EQUAL		
(3) IMPORTANCE FACTOR			e. BEARING ELEVATIONS INDICATED ON THE DRAWINGS ARE ESTIMATED FROM SOIL BEARING AND EXISTING FOUNDATION ELEVATION DATA. PRIOR TO PLACING FOUNDATIONS, AN EXPERIENCED QUALIFIED GEOTECHNICAL ENGINEER SHALL MAKE DETERMINATION OF FINAL BEARING ELEVATIONS AND VERIFICATION OF ALLOWABLE BEARING PRESSURE.			ASTM C150, TYPE II FOR CONCRETE IN CONTACT WITH EARTH.			ASTM C150, TYPE II FOR CONCRETE IN CONTACT WITH EARTH.			ASTM A570, OR APPROVED EQUAL		
(4) THERMAL FACTOR			f. CONCRETE FOR FOUNDATIONS SHALL BE POURED ON THE SAME DAY SUBGRADE APPROVAL IS GIVEN BY THE GEOTECHNICAL ENGINEER.			ASTM C280			ASTM C280			ASTM A570, OR APPROVED EQUAL		
(5) SLOPE FACTOR			g. THE SLOPE BETWEEN THE LOWER EDGES OF ADJACENT FOUNDATIONS SHALL NOT EXCEED 45 DEGREES WITH THE HORIZONTAL, UNLESS INDICATED OTHERWISE ON PLANS. MAINTAIN A 1:1 SLOPE FROM BOTTOM EDGE OF ANY EXCAVATION.			CONCRETE EXPOSED TO WEATHER SHALL BE AIR-ENTRAINED (5%+) (1-1/2%) BY VOLUME.			CONCRETE EXPOSED TO WEATHER SHALL BE AIR-ENTRAINED (5%+) (1-1/2%) BY VOLUME.			ASTM A570, OR APPROVED EQUAL		
c. FLOOR LIVE LOADS			h. FOLLOWING REQUIRED STRIPPING OPERATIONS, ANY PROOFROLLING SHALL BE AS DIRECTED BY AN EXPERIENCED, QUALIFIED GEOTECHNICAL ENGINEER. THE PURPOSE OF THE PROOFROLLING WILL BE TO LOCATE ANY ISOLATED AREAS OF SOFT OR LOOSE SOILS REQUIRING IMPROVEMENT OR REPLACEMENT. SOFT AREAS SHALL BE UNDERCUT AND REPLACED BY PROPERLY COMPACTED MATERIALS.			ASTM C308, TYPE IS (LIMIT TO 50% MAX OF CEMENTITIOUS CONTENT BY WEIGHT)			ASTM C308, TYPE IS (LIMIT TO 50% MAX OF CEMENTITIOUS CONTENT BY WEIGHT)			ASTM A570, OR APPROVED EQUAL		
a. AREA SLAB-ON-GRADE, TYPICAL U.N.O. CLASSROOMS			i. ALL SHORING, SHEETING, AND DEWATERING SHALL BE THE TOTAL RESPONSIBILITY OF THE CONTRACTOR. THE CONTRACTOR'S ENGINEER REGISTERED IN THE PROJECT'S JURISDICTION SHALL DESIGN SHEETING AND SHORING. ALL SUBMITTALS SHALL BEAR THE ENGINEER'S SEAL AND SIGNATURE.			ASTM C330 (STRUCTURAL LIGHTWEIGHT)			ASTM C330 (STRUCTURAL LIGHTWEIGHT)			ASTM A570, OR APPROVED EQUAL		
b. CORRIDOR			j. WHERE THE FINAL GRADE ELEVATIONS ARE APPROXIMATELY EQUAL ON BOTH SIDES OF A WALL, BACKFILL IN LIFTS TO MAINTAIN LEVEL ELEVATIONS WITHIN 10" ON BOTH SIDES AT ANY TIME.			ASTM C330 (STRUCTURAL LIGHTWEIGHT)			ASTM C330 (STRUCTURAL LIGHTWEIGHT)			ASTM A570, OR APPROVED EQUAL		
c. STAIRS AND EXITS			k. ALL BACKFILL SHALL BE COMPLETED USING MATERIAL APPROVED BY THE GEOTECHNICAL ENGINEER, WITH OPTIMUM MOISTURE CONTENT FOR COMPACTING AND SHALL BE FREE OF DEBRIS.			ASTM C330 (STRUCTURAL LIGHTWEIGHT)			ASTM C330 (STRUCTURAL LIGHTWEIGHT)			ASTM A570, OR APPROVED EQUAL		
3. WIND LOADS			l. APPROVED MATERIAL SHOULD BE PLACED IN 8" MINIMUM INDIVIDUAL MOISTURE CONDITIONED AS REQUIRED TO ACHIEVE COMPACTION TO A MINIMUM IN PLACE DENSITY OF 95% MAX. IN ACCORDANCE WITH ASTM SPECIFICATION D-1557 (MODIFIED PROCTOR) FOR FILL BELOW FOOTINGS AND SLABS-ON-GRADE.			ASTM C330 (STRUCTURAL LIGHTWEIGHT)			ASTM C330 (STRUCTURAL LIGHTWEIGHT)			ASTM A570, OR APPROVED EQUAL		
a. BASIC WIND SPEED			5. STRUCTURAL FILL			ASTM C330 (STRUCTURAL LIGHTWEIGHT)			ASTM C330 (STRUCTURAL LIGHTWEIGHT)			ASTM A570, OR APPROVED EQUAL		
b. ALLOWABLE DESIGN WIND SPEED			a. REFER TO SPECIFICATIONS AND GEOTECHNICAL REPORT FOR EXCAVATION, DEWATERING AND PREPARATION OF THE FOUNDATION AND SLAB-ON-GRADE SUBGRADE, INCLUDING COMPACTION PROCEDURES. REQUIREMENTS CONTAINED IN THE GEOTECHNICAL REPORTS ARE PART OF THIS WORK.			ASTM C330 (STRUCTURAL LIGHTWEIGHT)			ASTM C330 (STRUCTURAL LIGHTWEIGHT)			ASTM A570, OR APPROVED EQUAL		
c. OCCUPANCY RISK CATEGORY			b. CONTRACTOR SHALL FURNISH DIMENSIONED SHOP DRAWINGS AT ALL LEVELS LOCATING FLOOR AND ROOF EDGES FOR REVIEW BY THE ARCHITECT AND STRUCTURAL ENGINEER.			ASTM C330 (STRUCTURAL LIGHTWEIGHT)			ASTM C330 (STRUCTURAL LIGHTWEIGHT)			ASTM A570, OR APPROVED EQUAL		
d. WIND EXPOSURE CATEGORY			c. THE CONTRACTOR SHALL NOT BE PLACED THROUGH OR BELOW FOUNDATIONS WITHOUT THE STRUCTURAL ENGINEER'S APPROVAL.			ASTM C330 (STRUCTURAL LIGHTWEIGHT)			ASTM C330 (STRUCTURAL LIGHTWEIGHT)			ASTM A570, OR APPROVED EQUAL		
e. ENCLOSED BUILDING			d. FOLLOWING REQUIRED STRIPPING OPERATIONS, ANY PROOFROLLING SHALL BE AS DIRECTED BY AN EXPERIENCED, QUALIFIED GEOTECHNICAL ENGINEER. THE PURPOSE OF THE PROOFROLLING WILL BE TO LOCATE ANY ISOLATED AREAS OF SOFT OR LOOSE SOILS REQUIRING IMPROVEMENT OR REPLACEMENT. SOFT AREAS SHALL BE UNDERCUT AND REPLACED BY PROPERLY COMPACTED MATERIALS.			ASTM C330 (STRUCTURAL LIGHTWEIGHT)			ASTM C330 (STRUCTURAL LIGHTWEIGHT)			ASTM A570, OR APPROVED EQUAL		
f. MODIFICATION FACTORS			e. BEARING ELEVATIONS INDICATED ON THE DRAWINGS ARE ESTIMATED FROM SOIL BEARING AND EXISTING FOUNDATION ELEVATION DATA. PRIOR TO PLACING FOUNDATIONS, AN EXPERIENCED QUALIFIED GEOTECHNICAL ENGINEER SHALL MAKE DETERMINATION OF FINAL BEARING ELEVATIONS AND VERIFICATION OF ALLOWABLE BEARING PRESSURE.			ASTM C330 (STRUCTURAL LIGHTWEIGHT)			ASTM C330 (STRUCTURAL LIGHTWEIGHT)			ASTM A570, OR APPROVED EQUAL		
g. MAIN WIND FORCE RESISTING SYSTEM LOADS (PSF)			f. CONCRETE FOR FOUNDATIONS SHALL BE POURED ON THE SAME DAY SUBGRADE APPROVAL IS GIVEN BY THE GEOTECHNICAL ENGINEER.			ASTM C330 (STRUCTURAL LIGHTWEIGHT)			ASTM C330 (STRUCTURAL LIGHTWEIGHT)			ASTM A570, OR APPROVED EQUAL		
WINDOW (PER ZONE)			g. THE SLOPE BETWEEN THE LOWER EDGES OF ADJACENT FOUNDATIONS SHALL NOT EXCEED 45 DEGREES WITH THE HORIZONTAL, UNLESS INDICATED OTHERWISE ON PLANS. MAINTAIN A 1:1 SLOPE FROM BOTTOM EDGE OF ANY EXCAVATION.			ASTM C330 (STRUCTURAL LIGHTWEIGHT)			ASTM C330 (STRUCTURAL LIGHTWEIGHT)			ASTM A570, OR APPROVED EQUAL		
INTERIOR			h. FOLLOWING REQUIRED STRIPPING OPERATIONS, ANY PROOFROLLING SHALL BE AS DIRECTED BY AN EXPERIENCED, QUALIFIED GEOTECHNICAL ENGINEER. THE PURPOSE OF THE PROOFROLLING WILL BE TO LOCATE ANY ISOLATED AREAS OF SOFT OR LOOSE SOILS REQUIRING IMPROVEMENT OR REPLACEMENT. SOFT AREAS SHALL BE UNDERCUT AND REPLACED BY PROPERLY COMPACTED MATERIALS.			ASTM C330 (STRUCTURAL LIGHTWEIGHT)			ASTM C330 (STRUCTURAL LIGHTWEIGHT)			ASTM A570, OR APPROVED EQUAL		
EFFECTIVE AREA			i. ALL SHORING, SHEETING, AND DEWATERING SHALL BE THE TOTAL RESPONSIBILITY OF THE CONTRACTOR. THE CONTRACTOR'S ENGINEER REGISTERED IN THE PROJECT'S JURISDICTION SHALL DESIGN SHEETING AND SHORING. ALL SUBMITTALS SHALL BEAR THE ENGINEER'S SEAL AND SIGNATURE.			ASTM C330 (STRUCTURAL LIGHTWEIGHT)			ASTM C330 (STRUCTURAL LIGHTWEIGHT)			ASTM A570, OR APPROVED EQUAL		
10 SF			j. WHERE THE FINAL GRADE ELEVATIONS ARE APPROXIMATELY EQUAL ON BOTH SIDES OF A WALL, BACKFILL IN LIFTS TO MAINTAIN LEVEL ELEVATIONS WITHIN 10" ON BOTH SIDES AT ANY TIME.			ASTM C330 (STRUCTURAL LIGHTWEIGHT)			ASTM C330 (STRUCTURAL LIGHTWEIGHT)			ASTM A570, OR APPROVED EQUAL		
500SF			k. ALL BACKFILL SHALL BE COMPLETED USING MATERIAL APPROVED BY THE GEOTECHNICAL ENGINEER, WITH OPTIMUM MOISTURE CONTENT FOR COMPACTING AND SHALL BE FREE OF DEBRIS.			ASTM C330 (STRUCTURAL LIGHTWEIGHT)			ASTM C330 (STRUCTURAL LIGHTWEIGHT)			ASTM A570, OR APPROVED EQUAL		
INTERIOR			l. APPROVED MATERIAL SHOULD BE PLACED IN 8" MINIMUM INDIVIDUAL MOISTURE CONDITIONED AS REQUIRED TO ACHIEVE COMPACTION TO A MINIMUM IN PLACE DENSITY OF 95% MAX. IN ACCORDANCE WITH ASTM SPECIFICATION D-1557 (MODIFIED PROCTOR) FOR FILL BELOW FOOTINGS AND SLABS-ON-GRADE.			ASTM C330 (STRUCTURAL LIGHTWEIGHT)			ASTM C330 (STRUCTURAL LIGHTWEIGHT)			ASTM A570, OR APPROVED EQUAL		
EFFECTIVE AREA			5. STRUCTURAL FILL			ASTM C330 (STRUCTURAL LIGHTWEIGHT)			ASTM C330 (STRUCTURAL LIGHTWEIGHT)			ASTM A570, OR APPROVED EQUAL		
10 SF			a. REFER TO SPECIFICATIONS AND GEOTECHNICAL REPORT FOR EXCAVATION, DEWATERING AND PREPARATION OF THE FOUNDATION AND SLAB-ON-GRADE SUBGRADE, INCLUDING COMPACTION PROCEDURES. REQUIREMENTS CONTAINED IN THE GEOTECHNICAL REPORTS ARE PART OF THIS WORK.			ASTM C330 (STRUCTURAL LIGHTWEIGHT)			ASTM C330 (STRUCTURAL LIGHTWEIGHT)			ASTM A570, OR APPROVED EQUAL		
100SF			b. CONTRACTOR SHALL FURNISH DIMENSIONED SHOP DRAWINGS AT ALL LEVELS LOCATING FLOOR AND ROOF EDGES FOR REVIEW BY THE ARCHITECT AND STRUCTURAL ENGINEER.			ASTM C330 (STRUCTURAL LIGHTWEIGHT)			ASTM C330 (STRUCTURAL LIGHTWEIGHT)			ASTM A570, OR APPROVED EQUAL		
INTERIOR			c. THE CONTRACTOR SHALL NOT BE PLACED THROUGH OR BELOW FOUNDATIONS WITHOUT THE STRUCTURAL ENGINEER'S APPROVAL.			ASTM C330 (STRUCTURAL LIGHTWEIGHT)			ASTM C330 (STRUCTURAL LIGHTWEIGHT)			ASTM A570, OR APPROVED EQUAL		
EFFECTIVE AREA			d. FOLLOWING REQUIRED STRIPPING OPERATIONS, ANY PROOFROLLING SHALL BE AS DIRECTED BY AN EXPERIENCED, QUALIFIED GEOTECHNICAL ENGINEER. THE PURPOSE OF THE PROOFROLLING WILL BE TO LOCATE ANY ISOLATED AREAS OF SOFT OR LOOSE SOILS REQUIRING IMPROVEMENT OR REPLACEMENT. SOFT AREAS SHALL BE UNDERCUT AND REPLACED BY PROPERLY COMPACTED MATERIALS.			ASTM C330 (STRUCTURAL LIGHTWEIGHT)			ASTM C330 (STRUCTURAL LIGHTWEIGHT)			ASTM A570, OR APPROVED EQUAL		
10 SF			e. BEARING ELEVATIONS INDICATED ON THE DRAWINGS ARE ESTIMATED FROM SOIL BEARING AND EXISTING FOUNDATION ELEVATION DATA. PRIOR TO PLACING FOUNDATIONS, AN EXPERIENCED QUALIFIED GEOTECHNICAL ENGINEER SHALL MAKE DETERMINATION OF FINAL BEARING ELEVATIONS AND VERIFICATION OF ALLOWABLE BEARING PRESSURE.			ASTM C330 (STRUCTURAL LIGHTWEIGHT)			ASTM C330 (STRUCTURAL LIGHTWEIGHT)			ASTM A570, OR APPROVED EQUAL		
100SF			f. CONCRETE FOR FOUNDATIONS SHALL BE POURED ON THE SAME DAY SUBGRADE APPROVAL IS GIVEN BY THE GEOTECHNICAL ENGINEER.			ASTM C330 (STRUCTURAL LIGHTWEIGHT)			ASTM C330 (STRUCTURAL LIGHTWEIGHT)			ASTM A570, OR APPROVED EQUAL		
INTERIOR			g. THE SLOPE BETWEEN THE LOWER EDGES OF ADJACENT FOUNDATIONS SHALL NOT EXCEED 45 DEGREES WITH THE HORIZONTAL, UNLESS INDICATED OTHERWISE ON PLANS. MAINTAIN A 1:1 SLOPE FROM BOTTOM EDGE OF ANY EXCAVATION.			ASTM C330 (STRUCTURAL LIGHTWEIGHT)			ASTM C330 (STRUCTURAL LIGHTWEIGHT)			ASTM A570, OR APPROVED EQUAL		
EFFECTIVE AREA			h. FOLLOWING REQUIRED STRIPPING OPERATIONS, ANY PROOFROLLING SHALL BE AS DIRECTED BY AN EXPERIENCED, QUALIFIED GEOTECHNICAL ENGINEER. THE PURPOSE OF THE PROOFROLLING WILL BE TO LOCATE ANY ISOLATED AREAS OF SOFT OR LOOSE SOILS REQUIRING IMPROVEMENT OR REPLACEMENT. SOFT AREAS SHALL BE UNDERCUT AND REPLACED BY PROPERLY COMPACTED MATERIALS.			ASTM C330 (STRUCTURAL LIGHTWEIGHT)			ASTM C330 (STRUCTURAL LIGHTWEIGHT)			ASTM A570, OR APPROVED EQUAL		
10 SF			i. ALL SHORING, SHEETING, AND DEWATERING SHALL BE THE TOTAL RESPONSIBILITY OF THE CONTRACTOR. THE CONTRACTOR'S ENGINEER REGISTERED IN THE PROJECT'S JURISDICTION SHALL DESIGN SHEETING AND SHORING. ALL SUBMITTALS SHALL BEAR THE ENGINEER'S SEAL AND SIGNATURE.			ASTM C330 (STRUCTURAL LIGHTWEIGHT)			ASTM C330 (STRUCTURAL LIGHTWEIGHT)			ASTM A570, OR APPROVED EQUAL		
100SF			j. WHERE THE FINAL GRADE ELEVATIONS ARE APPROXIMATELY EQUAL ON BOTH SIDES OF A WALL, BACKFILL IN LIFTS TO MAINTAIN LEVEL ELEVATIONS WITHIN 10" ON BOTH SIDES AT ANY TIME.			ASTM C330 (STRUCTURAL LIGHTWEIGHT)			ASTM C330 (STRUCTURAL LIGHTWEIGHT)			ASTM A570, OR APPROVED EQUAL		
INTERIOR			k. ALL BACKFILL SHALL BE COMPLETED USING MATERIAL APPROVED BY THE GEOTECHNICAL ENGINEER, WITH OPTIMUM MOISTURE CONTENT FOR COMPACTING AND SHALL BE FREE OF DEBRIS.			ASTM C330 (STRUCTURAL LIGHTWEIGHT)			ASTM C330 (STRUCTURAL LIGHTWEIGHT)			ASTM A570, OR APPROVED EQUAL		
EFFECTIVE AREA			l. APPROVED MATERIAL SHOULD BE PLACED IN 8" MINIMUM INDIVIDUAL MOISTURE CONDITIONED AS REQUIRED TO ACHIEVE COMPACTION TO A MINIMUM IN PLACE DENSITY OF 95% MAX. IN ACCORDANCE WITH ASTM SPECIFICATION D-1557 (MODIFIED PROCTOR) FOR FILL BELOW FOOTINGS AND SLABS-ON-GRADE.			ASTM C330 (STRUCTURAL LIGHTWEIGHT)			ASTM C330 (STRUCTURAL LIGHTWEIGHT)			ASTM A570, OR APPROVED EQUAL		
10 SF			5. STRUCTURAL FILL			ASTM C330 (STRUCTURAL LIGHTWEIGHT)			ASTM C330 (STRUCTURAL LIGHTWEIGHT)			ASTM A570, OR APPROVED EQUAL		
100SF			a. REFER TO SPECIFICATIONS AND GEOTECHNICAL REPORT FOR EXCAVATION, DEWATERING AND PREPARATION OF THE FOUNDATION AND SLAB-ON-GRADE SUBGRADE, INCLUDING COMPACTION PROCEDURES. REQUIREMENTS CONTAINED IN THE GEOTECHNICAL REPORTS ARE PART OF THIS WORK.			ASTM C330 (STRUCTURAL LIGHTWEIGHT)			ASTM C330 (STRUCTURAL LIGHTWEIGHT)			ASTM A570, OR APPROVED EQUAL		
INTERIOR			b. CONTRACTOR SHALL FURNISH DIMENSIONED SHOP DRAWINGS AT ALL LEVELS LOCATING FLOOR AND ROOF EDGES FOR REVIEW BY THE ARCHITECT AND STRUCTURAL ENGINEER.			ASTM C330 (STRUCTURAL LIGHTWEIGHT)			ASTM C330 (STRUCTURAL LIGHTWEIGHT)			ASTM A570, OR APPROVED EQUAL		
EFFECTIVE AREA			c. THE CONTRACTOR SHALL NOT BE PLACED THROUGH OR BELOW FOUNDATIONS WITHOUT THE STRUCTURAL ENGINEER'S APPROVAL.			ASTM C330 (STRUCTURAL LIGHTWEIGHT)			ASTM C330 (STRUCTURAL LIGHTWEIGHT)			ASTM A570, OR APPROVED EQUAL		
10 SF			d. FOLLOWING REQUIRED STRIPPING OPERATIONS, ANY PROOFROLLING SHALL BE AS DIRECTED BY AN EXPERIENCED, QUALIFIED GEOTECHNICAL ENGINEER. THE PURPOSE OF THE PROOFROLLING WILL BE TO LOCATE ANY ISOLATED AREAS OF SOFT OR LOOSE SOILS REQUIRING IMPROVEMENT OR REPLACEMENT. SOFT AREAS SHALL BE UNDERCUT AND REPLACED BY PROPERLY COMPACTED MATERIALS.			ASTM C330 (STRUCTURAL LIGHTWEIGHT)			ASTM C330 (STRUCTURAL LIGHTWEIGHT)			ASTM A570, OR APPROVED EQUAL		
100SF			e. BEARING ELEVATIONS INDICATED ON THE DRAWINGS ARE ESTIMATED FROM SOIL BEARING AND EXISTING FOUNDATION ELEVATION DATA. PRIOR TO PLACING FOUNDATIONS, AN EXPERIENCED QUALIFIED GEOTECHNICAL ENGINEER SHALL MAKE DETERMINATION OF FINAL BEARING ELEVATIONS AND VERIFICATION OF ALLOWABLE BEARING PRESSURE.			ASTM C330 (STRUCTURAL LIGHTWEIGHT)			ASTM C330 (STRUCTURAL LIGHTWEIGHT)			ASTM A570, OR APPROVED EQUAL		
INTERIOR			f. CONCRETE FOR FOUNDATIONS SHALL BE POURED ON THE SAME DAY SUBGRADE APPROVAL IS GIVEN BY THE GEOTECHNICAL ENGINEER.			ASTM C330 (STRUCTURAL LIGHTWEIGHT)			ASTM C330 (STRUCTURAL LIGHTWEIGHT)			ASTM A570, OR APPROVED EQUAL		
EFFECTIVE AREA			g. THE SLOPE BETWEEN THE LOWER EDGES OF ADJACENT FOUNDATIONS SHALL NOT EXCEED 45 DEGREES WITH THE HORIZONTAL, UNLESS INDICATED OTHERWISE ON PLANS. MAINTAIN A 1:1 SLOPE FROM BOTTOM EDGE OF ANY EXCAVATION.			ASTM C330 (STRUCTURAL LIGHTWEIGHT)			ASTM C330 (STRUCTURAL LIGHTWEIGHT)			ASTM A570, OR APPROVED EQUAL		
10 SF			h. FOLLOWING REQUIRED STRIPPING OPERATIONS, ANY PROOFROLLING SHALL BE AS DIRECTED BY AN EXPERIENCED, QUALIFIED GEOTECHNICAL ENGINEER. THE PURPOSE OF THE PROOFROLLING WILL BE TO LOCATE ANY ISOLATED AREAS OF SOFT OR LOOSE SOILS REQUIRING IMPROVEMENT OR REPLACEMENT. SOFT AREAS SHALL BE UNDERCUT AND REPLACED BY PROPERLY COMPACTED MATERIALS.			ASTM C330 (STRUCTURAL LIGHTWEIGHT)			ASTM C330 (STRUCTURAL LIGHTWEIGHT)			ASTM A570, OR APPROVED EQUAL		
100SF			i. ALL SHORING, SHEETING, AND DEWATERING SHALL BE THE TOTAL RESPONSIBILITY OF THE CONTRACTOR. THE CONTRACTOR'S ENGINEER REGISTERED IN THE PROJECT'S JURISDICTION SHALL DESIGN SHEETING AND SHORING. ALL SUBMITTALS SHALL BEAR THE ENGINEER'S SEAL AND SIGNATURE.			ASTM C330 (STRUCTURAL LIGHTWEIGHT)			ASTM C330 (STRUCTURAL LIGHTWEIGHT)			ASTM A570, OR APPROVED EQUAL		
INTERIOR			j. WHERE THE FINAL GRADE ELEVATIONS ARE APPROXIMATELY EQUAL ON BOTH SIDES OF A WALL, BACKFILL IN LIFTS TO MAINTAIN LEVEL ELEVATIONS WITHIN 10" ON BOTH SIDES AT ANY TIME.			ASTM C330 (STRUCTURAL LIGHTWEIGHT)			ASTM C330 (STRUCTURAL LIGHTWEIGHT)			ASTM A570, OR APPROVED EQUAL		
EFFECTIVE AREA			k. ALL BACKFILL SHALL BE COMPLETED USING MATERIAL APPROVED BY THE GEOTECHNICAL ENGINEER, WITH OPTIMUM MOISTURE CONTENT FOR COMPACTING AND SHALL BE FREE OF DEBRIS.			ASTM C330 (STRUCTURAL LIGHTWEIGHT)			ASTM C330 (STRUCTURAL LIGHTWEIGHT)			ASTM A570, OR APPROVED EQUAL		
10 SF			l. APPROVED MATERIAL SHOULD BE PLACED IN 8" MINIMUM INDIVIDUAL MOISTURE CONDITIONED AS REQUIRED TO ACHIEVE COMPACTION TO A MINIMUM IN PLACE DENSITY OF 95% MAX. IN ACCORDANCE WITH ASTM SPECIFICATION D-1557 (MODIFIED PROCTOR) FOR FILL BELOW FOOTINGS AND SLABS-ON-GRADE.			ASTM C330 (STRUCTURAL LIGHTWEIGHT)			ASTM C330 (STRUCTURAL LIGHTWEIGHT)			ASTM A570, OR APPROVED EQUAL		
100SF			5. STRUCTURAL FILL			ASTM C330 (STRUCTURAL LIGHTWEIGHT)			ASTM C330 (STRUCTURAL LIGHTWEIGHT)			ASTM A570, OR APPROVED EQUAL		
INTERIOR			a. REFER TO SPECIFICATIONS AND GEOTECHNICAL REPORT FOR EXCAVATION, DEWATERING AND PREPARATION OF THE FOUNDATION AND SLAB-ON-GRADE SUBGRADE, INCLUDING COMPACTION PROCEDURES. REQUIREMENTS CONTAINED IN THE GEOTECHNICAL REPORTS ARE PART OF THIS WORK.			ASTM C330 (STRUCTURAL LIGHTWEIGHT)			ASTM C330 (STRUCTURAL LIGHTWEIGHT)			ASTM A570, OR APPROVED EQUAL		
EFFECTIVE AREA			b. CONTRACTOR SHALL FURNISH DIMENSIONED SHOP DRAWINGS AT ALL LEVELS LOCATING FLOOR AND ROOF EDGES FOR REVIEW BY THE ARCHITECT AND STRUCTURAL ENGINEER.			ASTM C330 (STRUCTURAL LIGHTWEIGHT)			ASTM C330 (STRUCTURAL LIGHTWEIGHT)			ASTM A570, OR APPROVED EQUAL		
10 SF			c. THE CONTRACTOR SHALL NOT BE PLACED THROUGH OR BELOW FOUNDATIONS WITHOUT THE STRUCTURAL ENGINEER'S APPROVAL.			ASTM C330 (STRUCTURAL LIGHTWEIGHT)			ASTM C330 (STRUCTURAL LIGHTWEIGHT)			ASTM A570, OR APPROVED EQUAL		
100SF			d. FOLLOWING REQUIRED STRIPPING OPERATIONS, ANY PROOFROLLING SHALL BE AS DIRECTED BY AN EXPERIENCED, QUALIFIED GEOTECHNICAL ENGINEER. THE PURPOSE OF THE PROOFROLLING WILL BE TO LOCATE ANY ISOLATED AREAS OF SOFT OR LOOSE SOILS REQUIRING IMPROVEMENT OR REPLACEMENT. SOFT AREAS SHALL BE UNDERCUT AND REPLACED BY PROPERLY COMPACTED MATERIALS.			ASTM C330 (STRUCTURAL LIGHTWEIGHT)			ASTM C330 (STRUCTURAL LIGHTWEIGHT)			ASTM A570, OR APPROVED EQUAL		
INTERIOR			e. BEARING ELEVATIONS INDICATED ON THE DRAWINGS ARE ESTIMATED FROM SOIL BEARING AND EXISTING FOUNDATION ELEVATION DATA. PRIOR TO PLACING FOUNDATIONS, AN EXPERIENCED QUALIFIED GEOTECHNICAL ENGINEER SHALL MAKE DETERMINATION OF FINAL BEARING ELEVATIONS AND VERIFICATION OF ALLOWABLE BEARING PRESSURE.			ASTM C330 (STRUCTURAL LIGHTWEIGHT)			ASTM C330 (STRUCTURAL LIGHTWEIGHT)			ASTM A570, OR APPROVED EQUAL		
EFFECTIVE AREA			f. CONCRETE FOR FOUNDATIONS SHALL BE POURED ON THE SAME DAY SUBGRADE APPROVAL IS GIVEN BY THE GEOTECHNICAL ENGINEER.			ASTM C330 (STRUCTURAL LIGHTWEIGHT)			ASTM C330 (STRUCTURAL LIGHTWEIGHT)			ASTM A570, OR APPROVED EQUAL		
10 SF			g. THE SLOPE BETWEEN THE LOWER EDGES OF ADJACENT FOUNDATIONS SHALL NOT EXCEED 45 DEGREES WITH THE HORIZONTAL, UNLESS INDICATED OTHERWISE ON PLANS. MAINTAIN A 1:1 SLOPE FROM BOTTOM EDGE OF ANY EXCAVATION.			ASTM C330 (STRUCTURAL LIGHTWEIGHT)			ASTM C330 (STRUCTURAL LIGHTWEIGHT)			ASTM A570, OR APPROVED EQUAL		
100SF			h. FOLLOWING REQUIRED STRIPPING OPERATIONS, ANY PROOFROLLING SHALL BE AS DIRECTED BY AN EXPERIENCED, QUALIFIED GEOTECHNICAL ENGINEER. THE PURPOSE OF THE PROOFROLLING WILL BE TO LOCATE ANY ISOLATED AREAS OF SOFT OR LOOSE SOILS REQUIRING IMPROVEMENT OR REPLACEMENT. SOFT AREAS SHALL BE UNDERCUT AND REPLACED BY PROPERLY COMPACTED MATERIALS.			ASTM C330 (STRUCTURAL LIGHTWEIGHT)			ASTM C330 (STRUCTURAL LIGHTWEIGHT)			ASTM A570, OR APPROVED EQUAL		
INTERIOR			i. ALL SHORING, SHEETING, AND DEWATERING SHALL BE THE TOTAL RESPONSIBILITY OF THE CONTRACTOR. THE CONTRACTOR'S ENGINEER REGISTERED IN THE PROJECT'S JURISDICTION SHALL DESIGN SHEETING AND SHORING. ALL SUBMITTALS SHALL BEAR THE ENGINEER'S SEAL AND SIGNATURE.			ASTM C330 (STRUCTURAL LIGHTWEIGHT)			ASTM C330 (STRUCTURAL LIGHTWEIGHT)			ASTM A570, OR APPROVED EQUAL		
EFFECTIVE AREA			j. WHERE THE FINAL GRADE ELEVATIONS ARE APPROXIMATELY EQUAL ON BOTH SIDES OF A WALL, BACKFILL IN LIFTS TO MAINTAIN LEVEL ELEVATIONS WITHIN 10" ON BOTH SIDES AT ANY TIME.			ASTM C330 (STRUCTURAL LIGHTWEIGHT)			ASTM C330 (STRUCTURAL LIGHTWEIGHT)			ASTM A570, OR APPROVED EQUAL		
10 SF			k. ALL BACKFILL SHALL BE COMPLETED USING MATERIAL APPROVED BY THE GEOTECHNICAL ENGINEER, WITH OPTIMUM MOISTURE CONTENT FOR COMPACTING AND SHALL BE FREE OF DEBRIS.			ASTM C330 (STRUCTURAL LIGHTWEIGHT)			ASTM C330 (STRUCTURAL LIGHTWEIGHT)			ASTM A570, OR APPROVED EQUAL		
100SF			l. APPROVED MATERIAL SHOULD BE PLACED IN 8" MINIMUM INDIVIDUAL MOISTURE CONDITIONED AS REQUIRED TO ACHIEVE COMPACTION TO A MINIMUM IN PLACE DENSITY OF 95% MAX. IN ACCORDANCE WITH ASTM SPECIFICATION D-1557 (MODIFIED PROCTOR) FOR FILL BELOW FOOTINGS AND SLABS-ON-GRADE.			ASTM C330 (STRUCTURAL LIGHTWEIGHT)			ASTM C330 (STRUCTURAL LIGHTWEIGHT)			ASTM A570, OR APPROVED EQUAL		
INTERIOR			5. STRUCTURAL FILL			ASTM C330 (STRUCTURAL LIGHTWEIGHT)			ASTM C330 (STRUCTURAL LIGHTWEIGHT)			ASTM A570, OR APPROVED EQUAL		
EFFECTIVE AREA			a. REFER TO SPECIFICATIONS AND GEOTECHNICAL REPORT FOR EXCAVATION, DEWATERING AND PREPARATION OF THE FOUNDATION AND SLAB-ON-GRADE SUBGRADE, INCLUDING COMPACTION PROCEDURES. REQUIREMENTS CONTAINED IN THE GEOTECHNICAL REPORTS ARE PART OF THIS WORK.			ASTM C330 (STRUCTURAL LIGHTWEIGHT)			ASTM C330 (STRUCTURAL LIGHTWEIGHT)			ASTM A570, OR APPROVED EQUAL		
10 SF			b. CONTRACTOR SHALL FURNISH DIMENSIONED SHOP DRAWINGS AT ALL LEVELS LOCATING FLOOR AND ROOF EDGES											





A MAINTAIN EXISTING STRUCTURAL SYSTEMS AT ALL TIMES, EXCEPT IN AREAS NOTED FOR DEMOLITION IN ITS ENTIRETY. PROVIDE TEMPORARY SHORING AND BRACING AT LOCATIONS WHERE THE EXISTING STRUCTURE IS BEING MODIFIED. MASONRY WALLS ARE BEING REMOVED OR OPENINGS ARE BEING PROVIDED IN MASONRY WALLS. PROTECT THE EXISTING STRUCTURE SCHEDULED TO REMAIN, FROM DAMAGE DURING DEMOLITION. MAINTAIN SHORING AND BRACING UNTIL THE NEW STRUCTURE IS COMPLETED AND READY TO ACCEPT LOADS.


B DIMENSIONS SHOWN FOR ALL NEW OPENINGS IN EXISTING CONSTRUCTION SHOULD BE COORDINATED WITH THE NEW PLANS AND EXISTING CONDITIONS IN THE FILED

C ITEMS SHOWN ARE INTENDED TO GIVE GENERAL DESCRIPTION. CONTRACTOR IS RESPONSIBLE FOR VERIFYING ACTUAL QUANTITIES LOCATION AND TYPE FOR THE EXISTING FIELD CONDITIONS, IN ORDER TO COMPLETE NEW WORK.


D1 DEMO EXISTING POOL GUTTER.  
D2 DEMO EXISTING POOL WALL DOWN 4'-0".  
D3 DEMO EXISTING SLAB BACK 7'-6" FROM POOL GUTTER.

#	DATE:	DESCRIPTION OF REVISION:	DRAWN BY:	MKB
1	10/20/2025	ISSUED FOR BID	CHECKED BY:	ESS
			DATE:	05/09/2025
			PHASE:	CD
<p>"IT IS A VIOLATION OF THE LAW FOR ANY PERSON TO MAKE UNAUTHORIZED ALTERATIONS OF ADDITIONS TO PLANS BEARING A LICENSED ENGINEER, ARCHITECT'S OR SURVEYOR'S SEAL."</p>			Copyright: 2025	



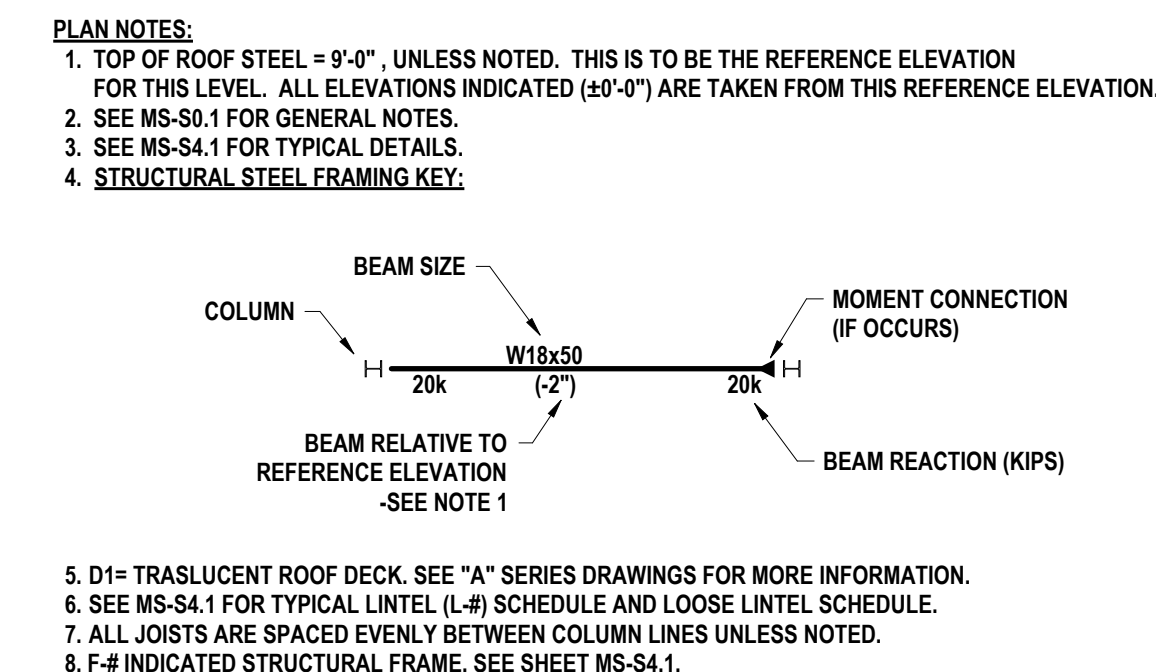

5. D1= TRANSLUCENT ROOF DECK. SEE "A" SERIES DRAWINGS FOR MORE INFORMATION.
6. SEE MS-S4.1 FOR TYPICAL LINTEL (L-#) SCHEDULE AND LOOSE LINTEL SCHEDULE.
7. ALL JOISTS ARE SPACED EVENLY BETWEEN COLUMN LINES UNLESS NOTED.
8. F-# INDICATED STRUCTURAL FRAME. SEE SHEET MS-S4.1.

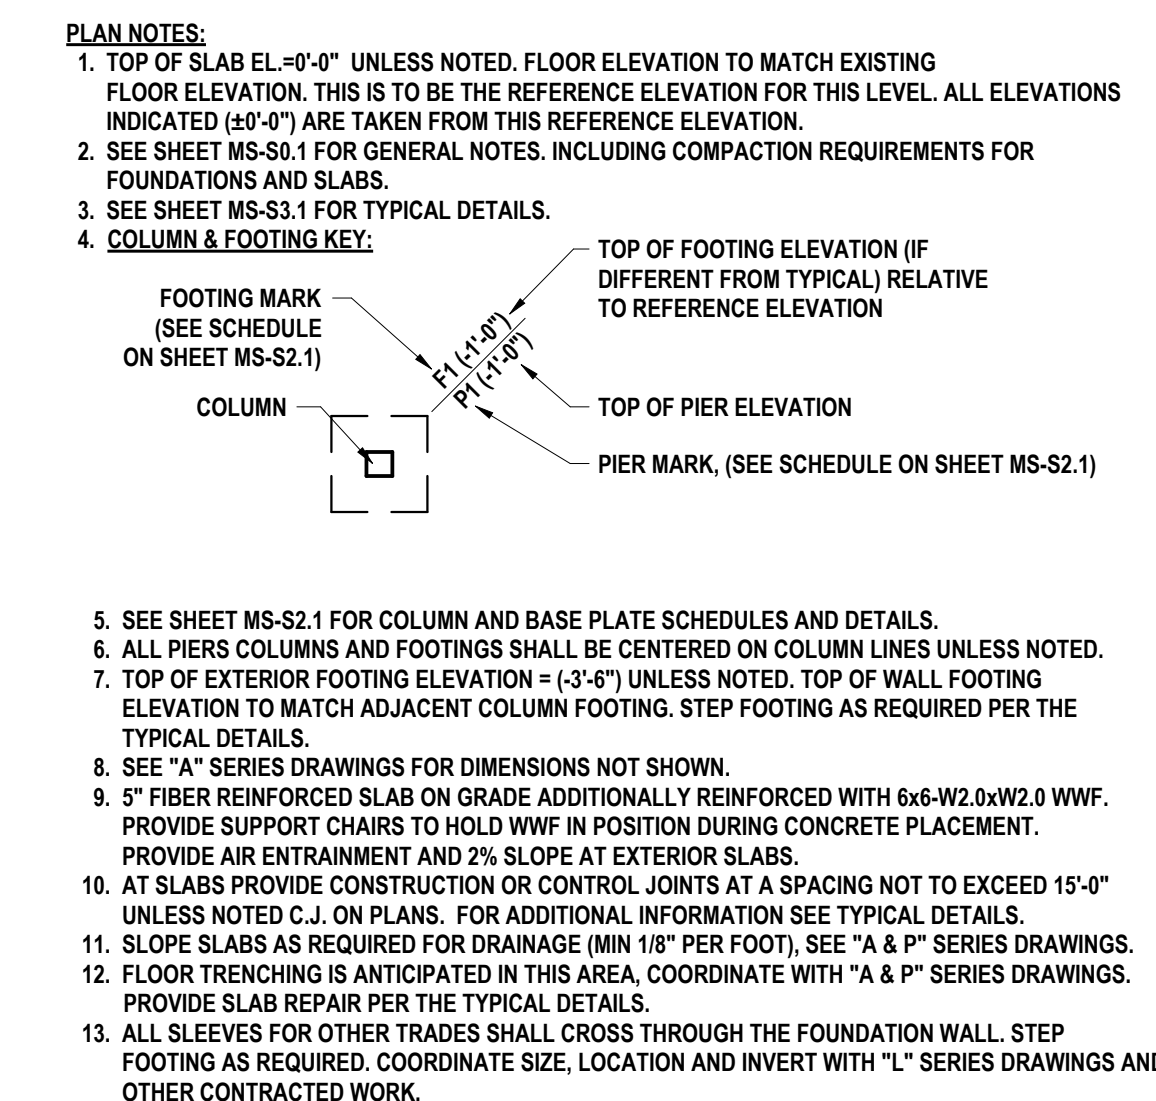




COLUMN SCHEDULE							
COLUMN LOCATION	SIZE	BASE REFERENCE	BASE OFFSET	TOP REFERENCE	TOP OFFSET	BASE PLATE MARK	NOTES
F1-FA	HSS12X6X3/8	0'-0"	-1'-0"	9'-0"	-SEE ELEVATION	BP-1	
F2-FA	HSS12X6X3/8	0'-0"	-1'-0"	9'-0"	-SEE ELEVATION	BP-1	
F3-FA	HSS12X6X3/8	0'-0"	-1'-0"	9'-0"	-SEE ELEVATION	BP-1	
F4-FA	HSS12X6X3/8	0'-0"	-1'-0"	9'-0"	-SEE ELEVATION	BP-1	

FOOTING SCHEDULE			
MARK	SIZE	REINFORCING	NOTES
F1	6'-0"x6'-0"x1'-0"	(7) #5 BARS E.W.	

BASE PLATE SCHEDULE				
MARK	SIZE	ANCHOR BOLT SIZE	EMBEDMENT	NOTES
BP-1	14"x16"x1"	(4) 1" Ø BOLTS	12"	

PIER REINFORCING SCHEDULE				
MARK	PIER SIZE	VERTICAL REINFORCING	TIES	NOTES
P1	20x22	(8) #7 BARS	(4) #4 @3", R@12"	

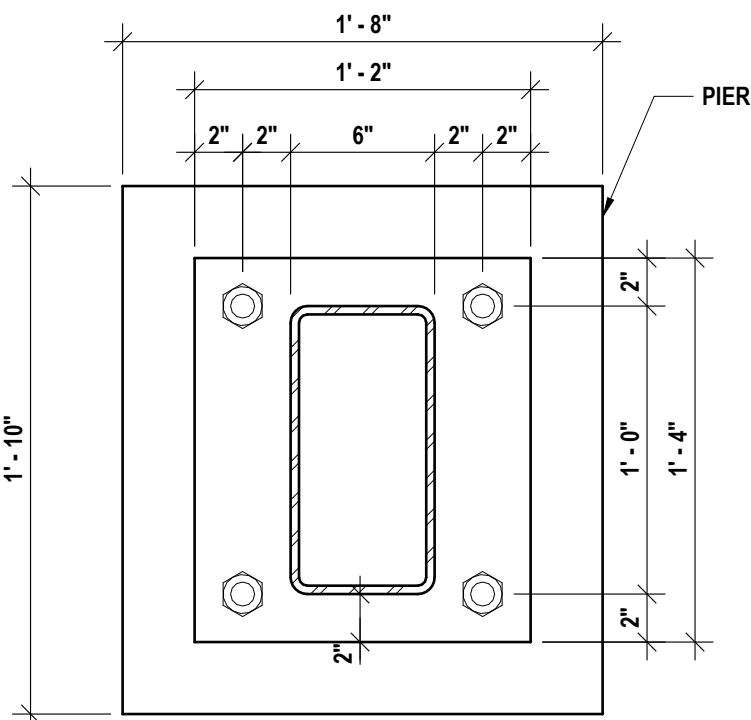

SEE MS-27-00-01-0-014/44

SCHEDULES

2025 MIDDLE SCHOOL PHASE III ALTERATIONS PROJECT  
CORNING-PAINTED POST ASD

35 VICTORY HIGHWAY, PAINTED POST, NY 14870

MS-S2.1

PROJECT NO: 2649-133

**HUNT** ENGINEERS | ARCHITECTS | SURVEYORS

HORSEHEADS, NY 607-263-1000 ROCHESTER, NY 565-537-7549 TOWNANDA, PA 570-265-4606  
BINGHAMTON, NY 607-798-8881 ALBANY, NY 607-798-8801

WWW.HUNTEAS.COM

NY CERTIFICATE NO. 001620 PA CERTIFICATE NO. TSC22013464-1

# DATE: 1 10/03/2025


DESCRIPTION OF REVISION:  
ISSUED FOR BID

PHASE:


IT IS A VIOLATION OF THE LAW FOR ANY PERSON TO MAKE UNAUTHORIZED ALTERATIONS OR ADDITIONS TO PLANS  
DRAWN BY: MKB  
CHECKED BY: BSB  
DATE: 05/09/2025  
CITY: CD

05/09/2025




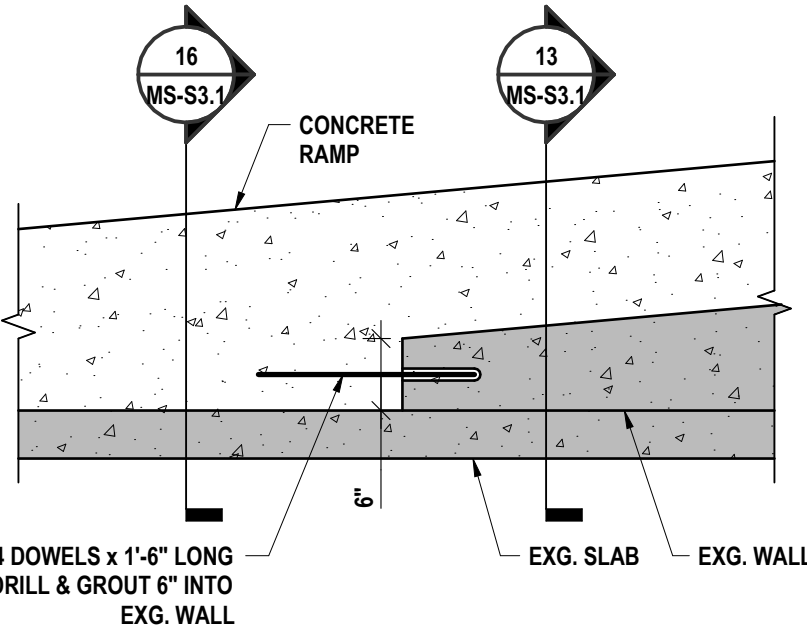


17 WALL TRANSITION AT RAMP  
3/4" = 1'-0"

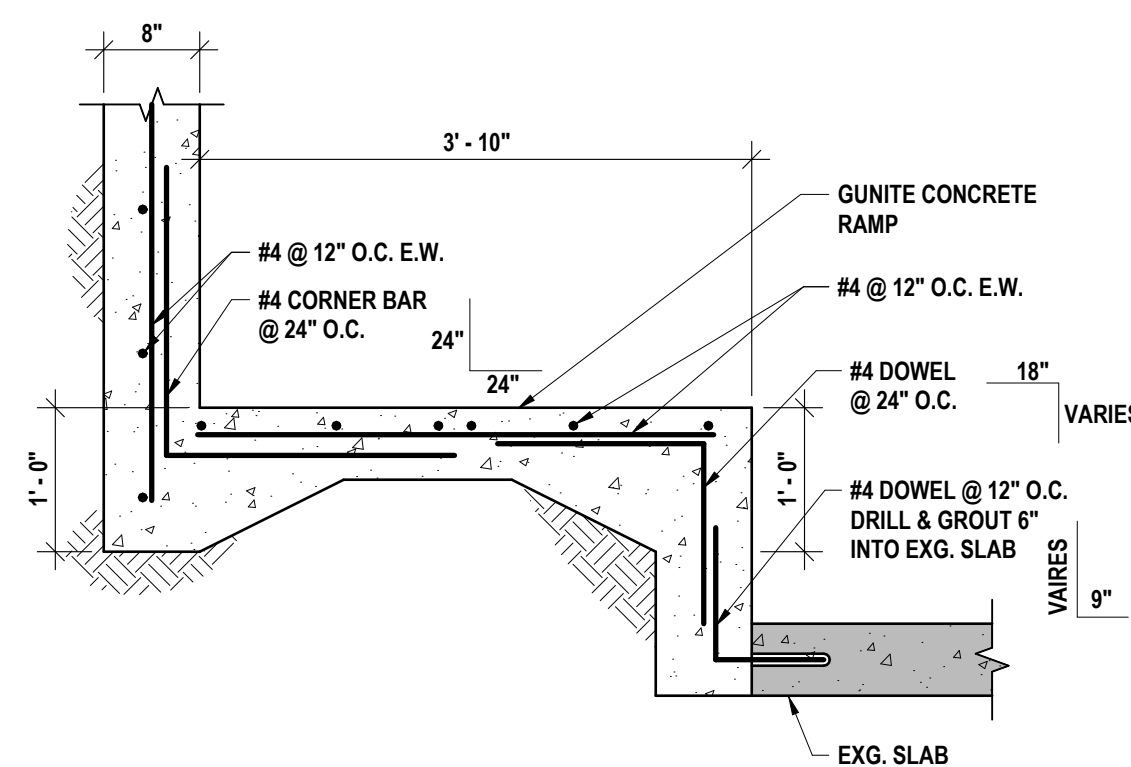


16 POOL RAMP SECTION AT EXISTING  
3/4" = 1'-0"

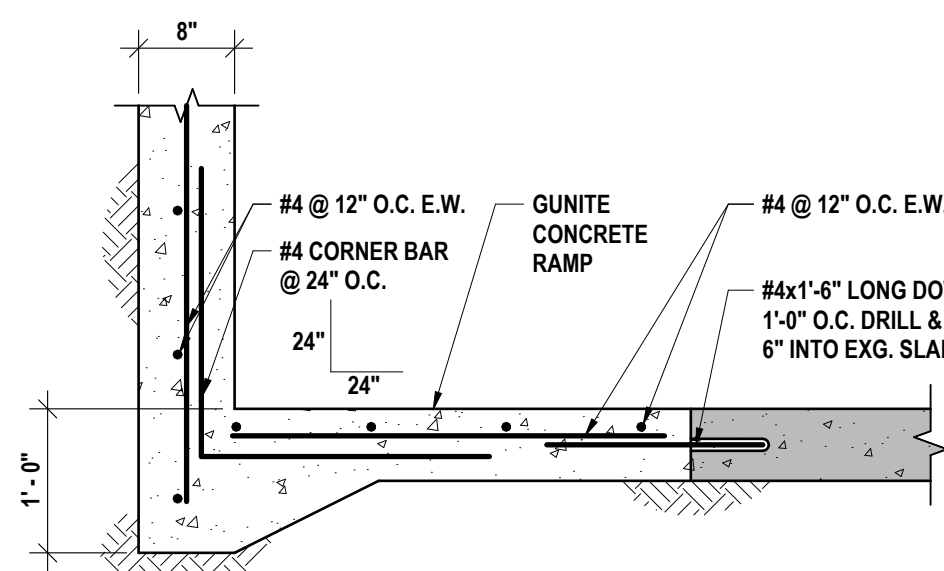


15 POOL RAMP SECTION  
3/4" = 1'-0"

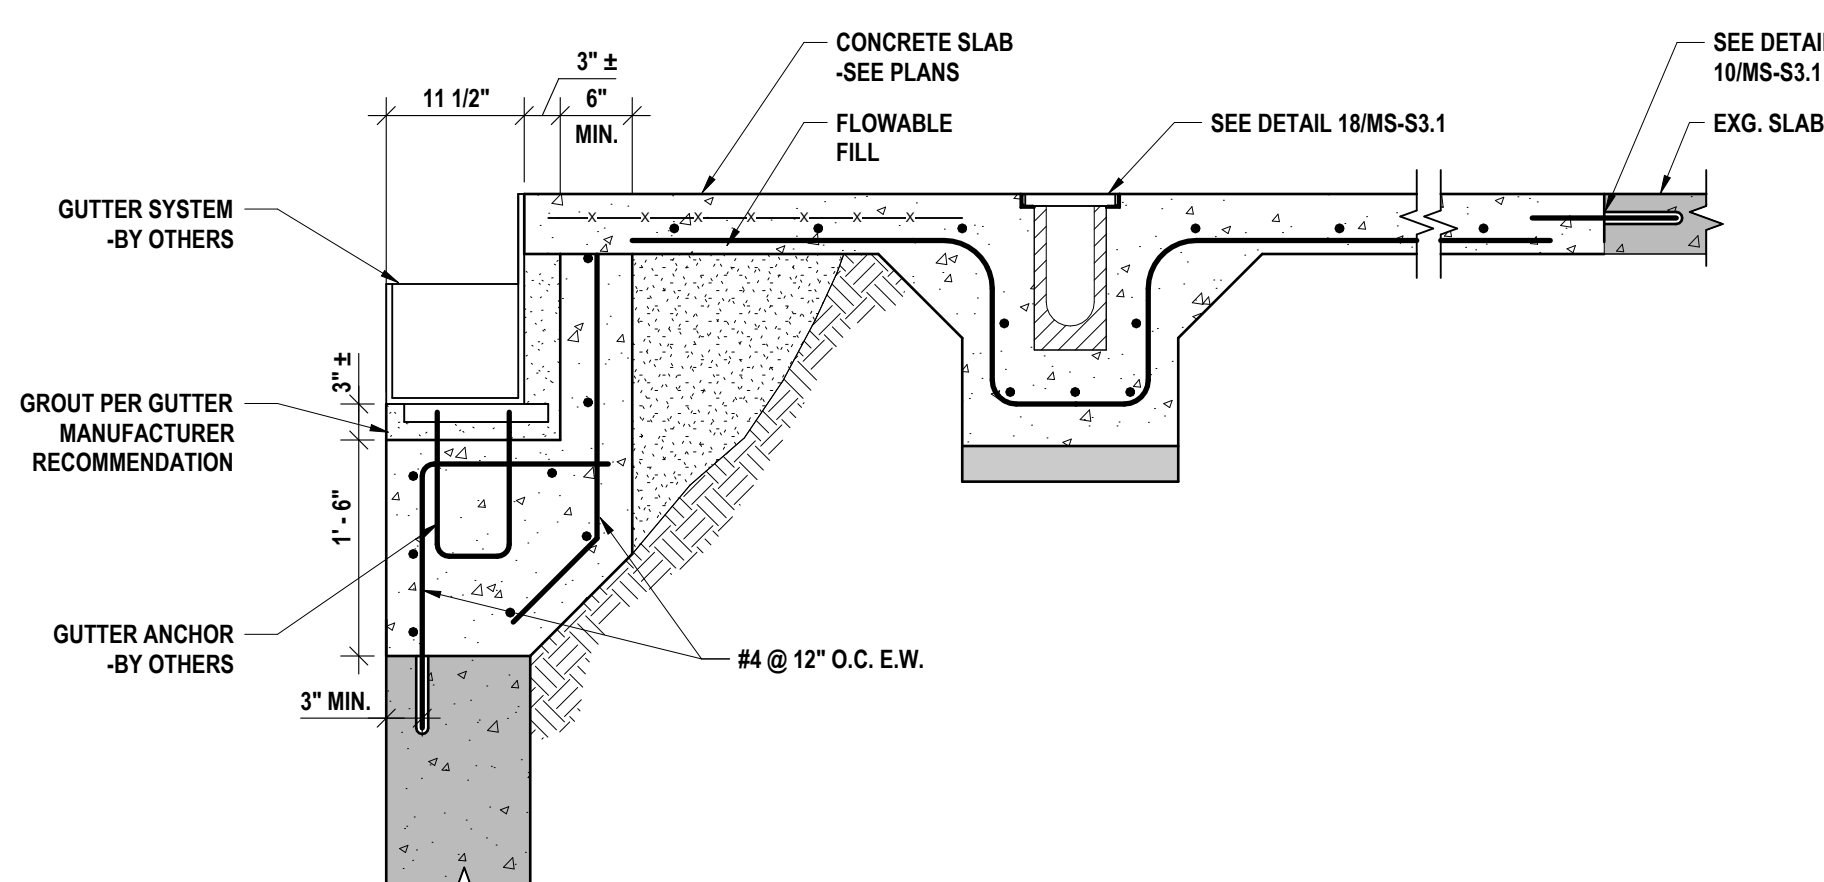


14 POOL GUTTER DETAIL  
3/4" = 1'-0"

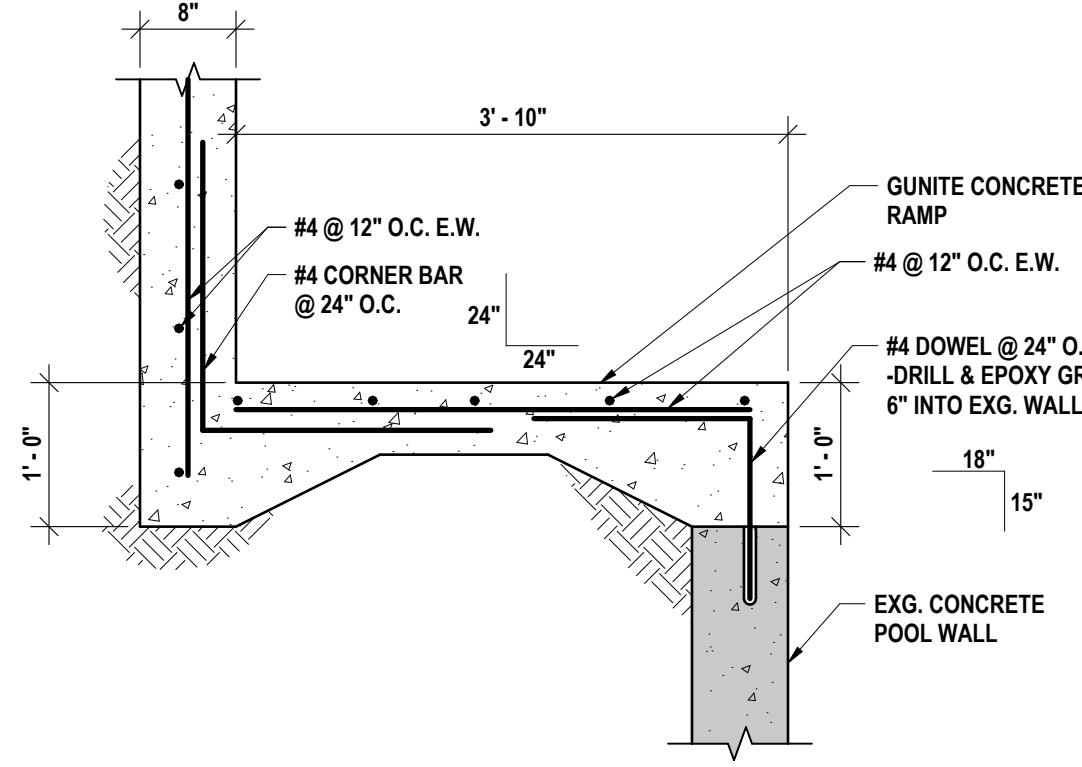


13 POOL RAMP SECTION  
3/4" = 1'-0"

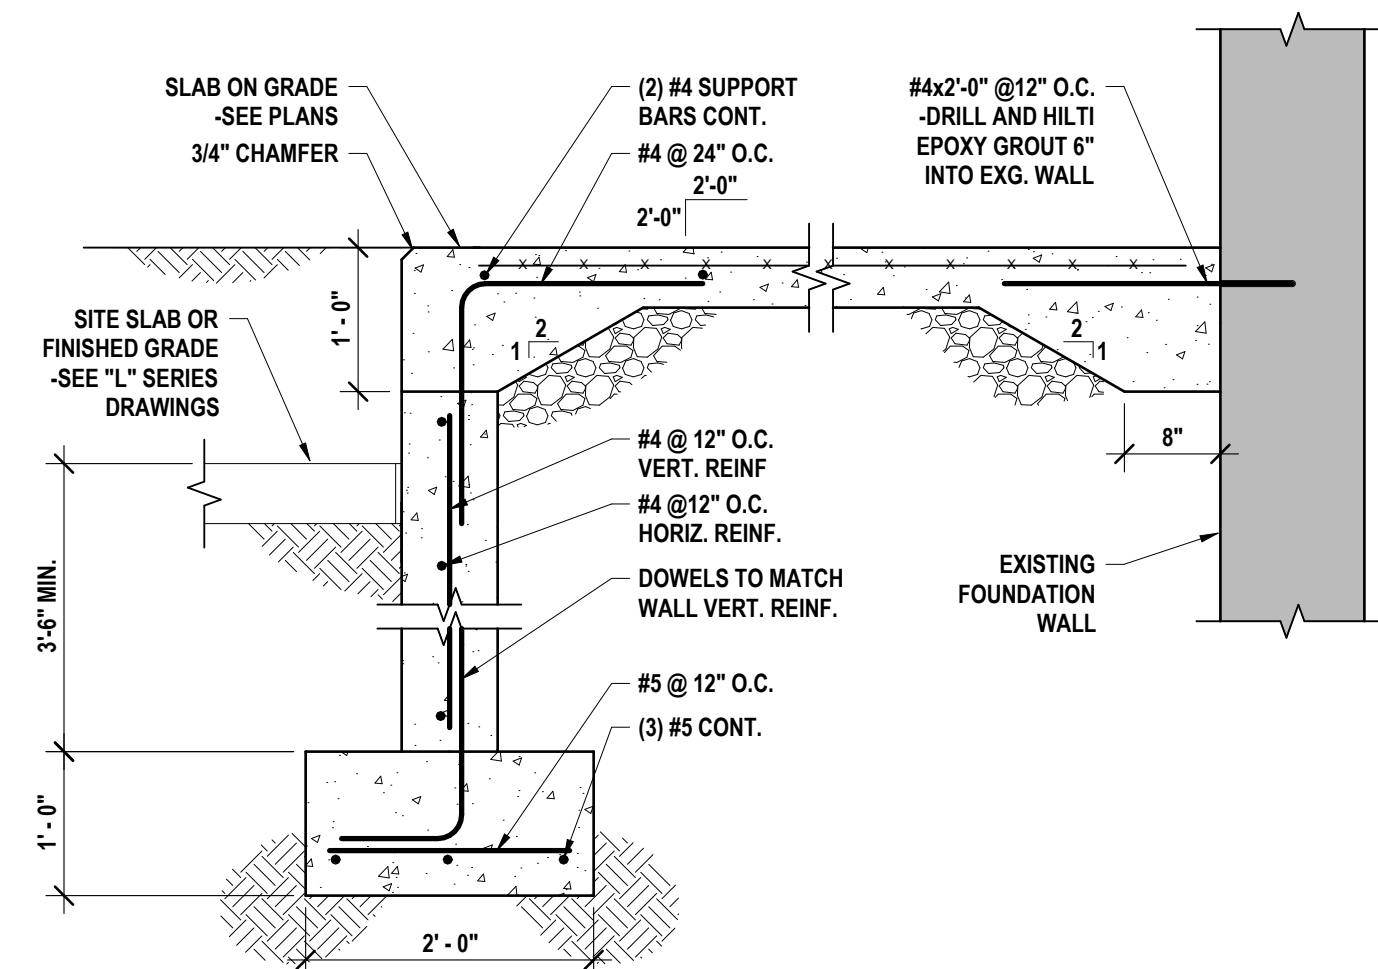


12 FROST SLAB AT CANOPY  
3/4" = 1'-0"

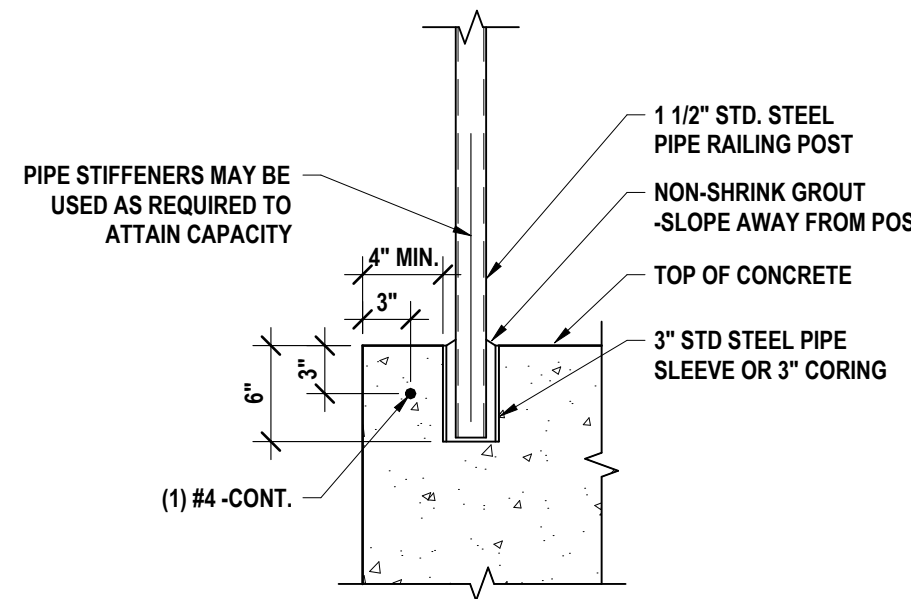


11 TYPICAL SLEEVED RAILING POST  
1" = 1'-0"

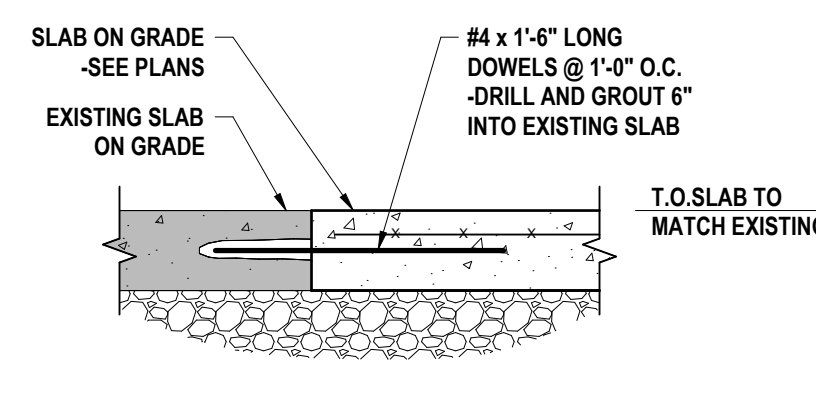


10 DOWEL AT EXISTING SLAB  
1" = 1'-0"

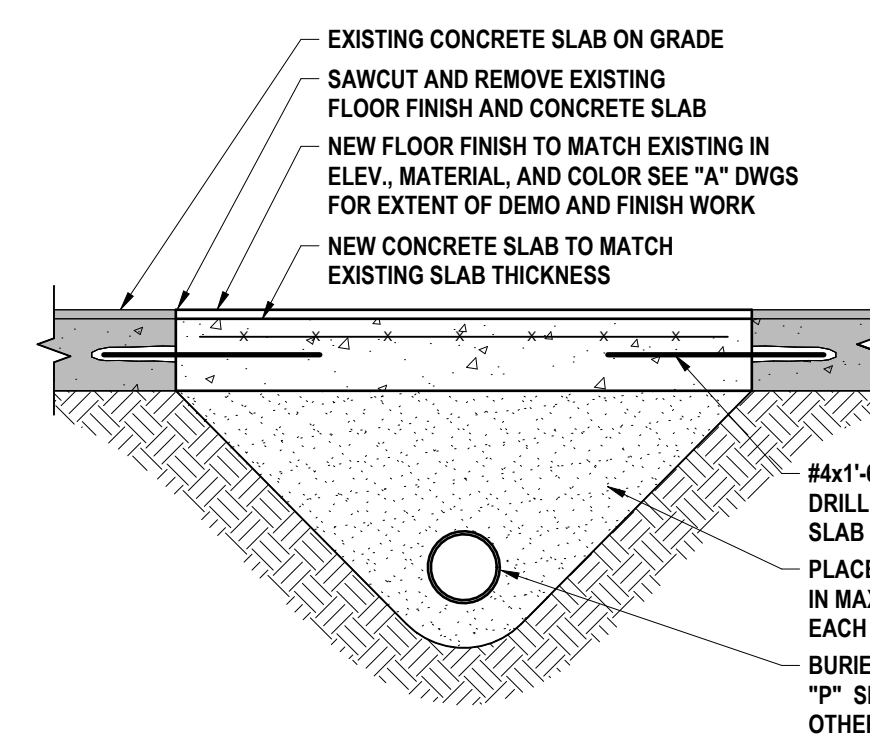


9 TRENCHING BELOW EXISTING SLAB  
3/4" = 1'-0"

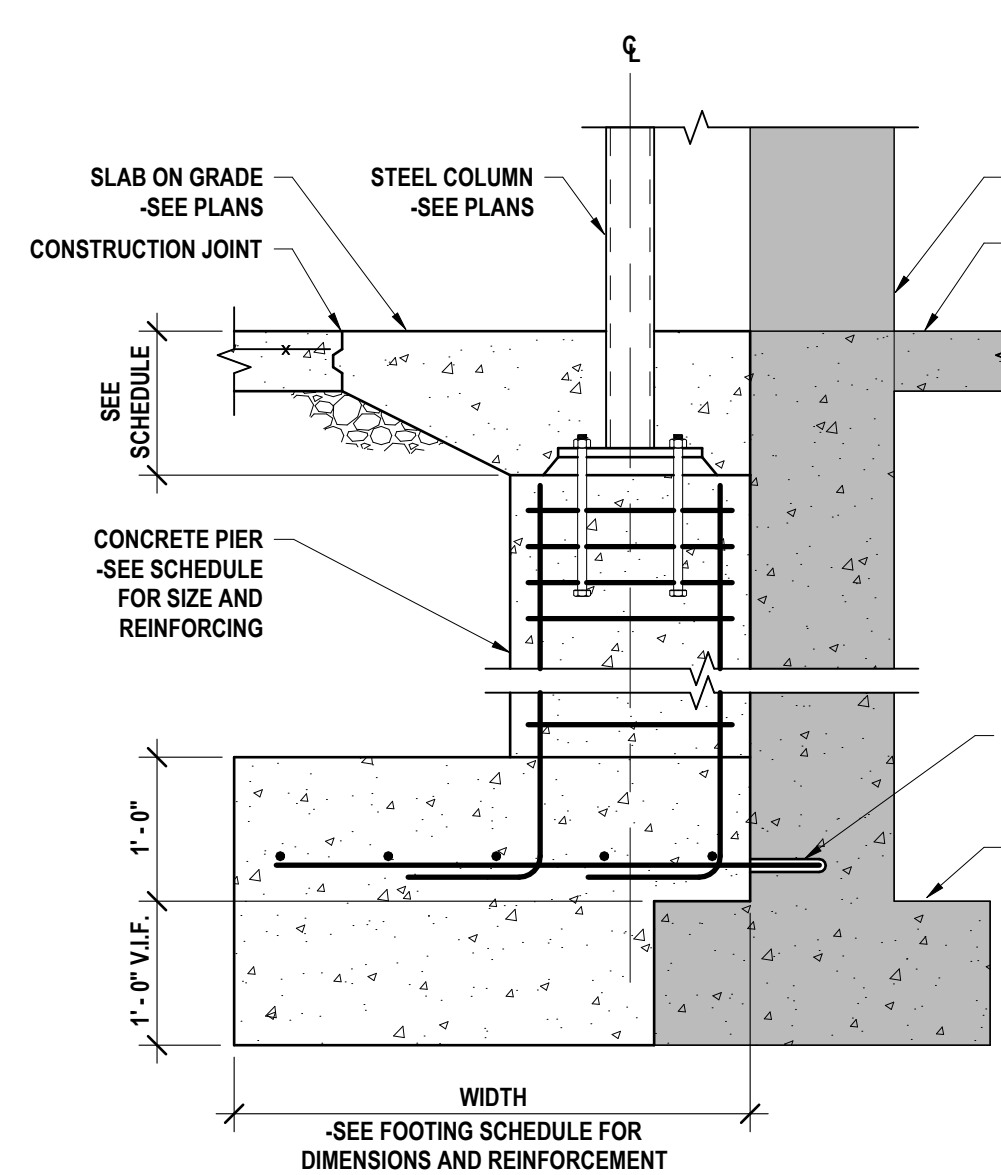


8 PIER AT EXISTING WALL  
3/4" = 1'-0"

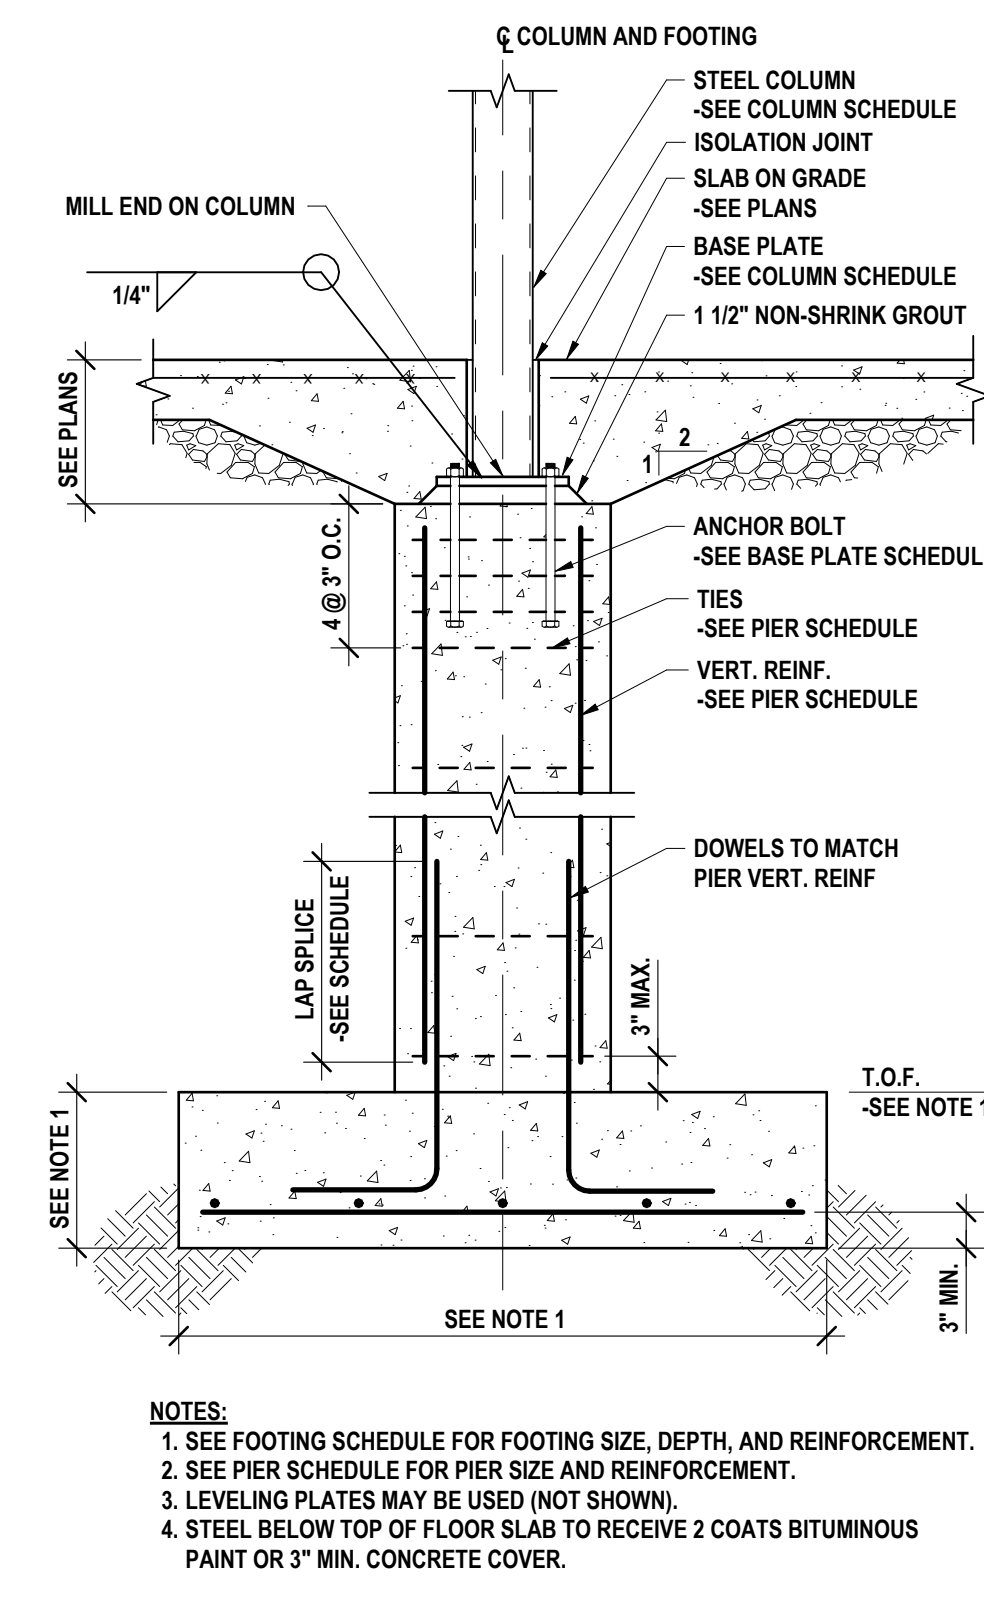


7 TYPICAL COLUMN FOUNDATION  
3/4" = 1'-0"

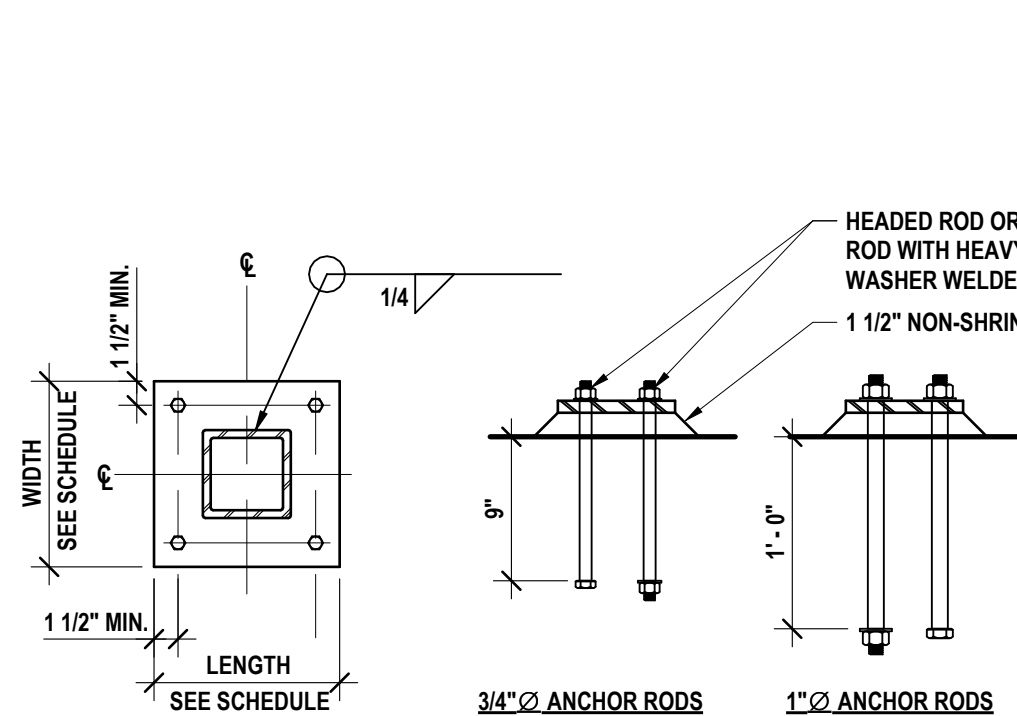


6 BASE PLATE PLAN ANCHOR ROD DETAILS  
1" = 1'-0"

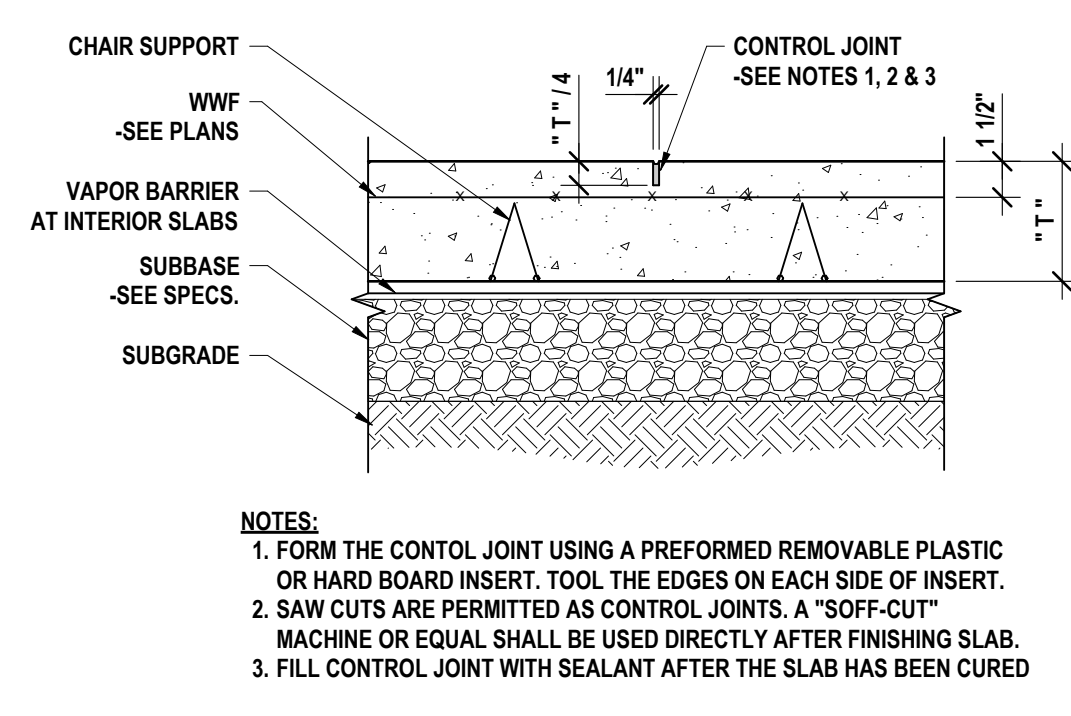


5 TYPICAL SLAB ON GRADE AND CONTROL JOINT  
1 1/2" = 1'-0"

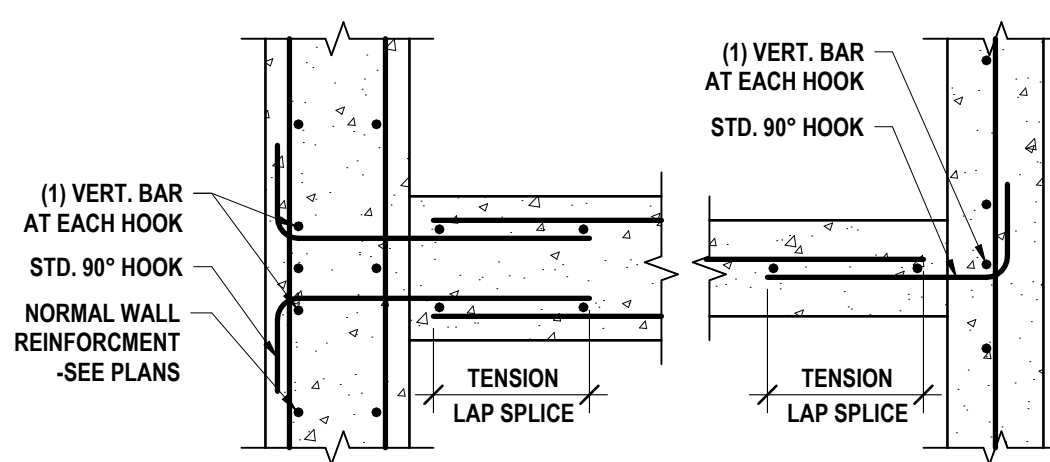


4 CONCRETE WALL PLAN AT TEE  
3/4" = 1'-0"

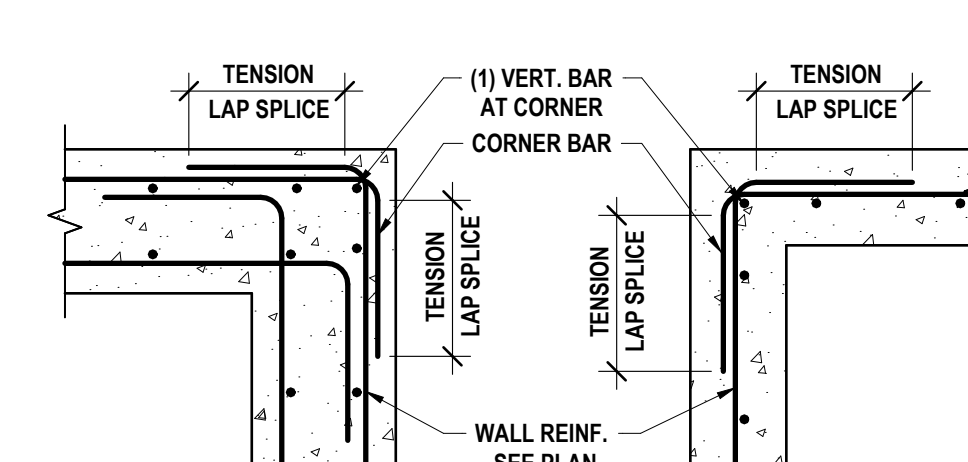

3 CONCRETE WALL PLAN AT CORNER  
3/4" = 1'-0"

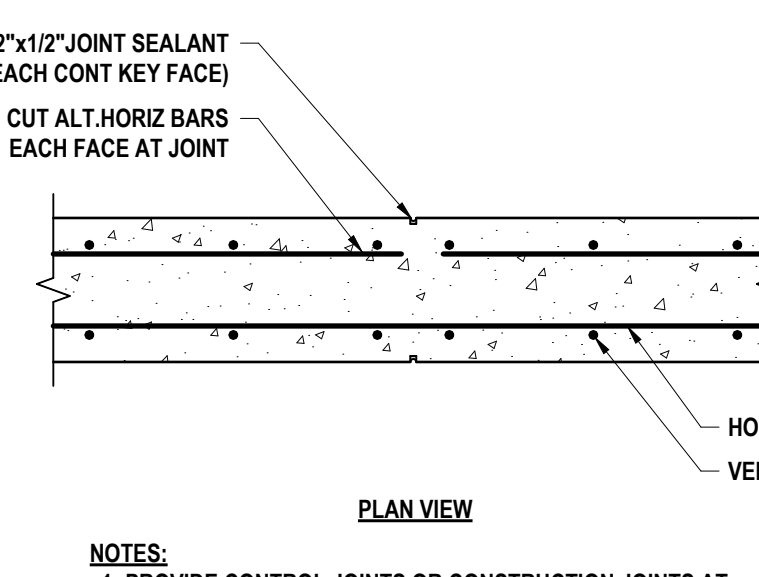

2 CONCRETE WALL CONTROL JOINT  
3/4" = 1'-0"

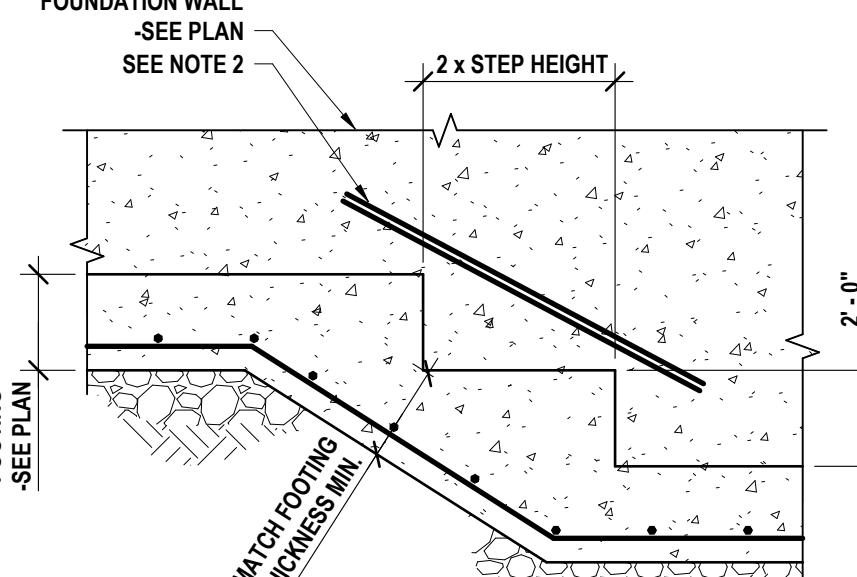

1 TYPICAL STEPPED FOOTING  
1/2" = 1'-0"

TENSION LAP SPICE LENGTHS FOR WALLS AND SLABS (INCH)							
BAR SIZE	CONCRETE COVER 3/4"		CONCRETE COVER 1 1/2"		CONCRETE COVER 2"		CONCRETE COVER 3"
	TOP	OTHER	TOP	OTHER	TOP	OTHER	TOP OTHER
#3	15	12	15	12	15	12	15 12
#4	24	19	20	15	20	15	20 15
#5	36	28	24	19	24	19	24 19
#6	48	37	29	22	29	22	29 22
#7	-	-	48	37	42	33	42 33
#8	-	-	60	47	48	37	48 37


NOTES:  
1. TABULATED VALUES ARE BASED ON UNCOATED 60,000PSI REINFORCEMENT AND NORMAL WEIGHT 4,000PSI CONCRETE.  
2. TENSION LAP SPICE LENGTHS ARE CALCULATED PER ACI 318-14, SECTIONS 25.4.2 AND 25.5.  
3. CENTER-CENTER SPACING OF SHALL AT MINIMUM BE ONE BAR DIAMETER PLUS TWICE THE COVER TO USE THIS TABLE.  
4. TYPICAL CENTER-CENTER SPACING AT LAPPED BARS IS 2".  
5. TOP BARS ARE HORIZONTAL WITH MORE THAN 12" OF CONCRETE CAST BELOW.  
6. FOR LIGHTWEIGHT CONCRETE MULTIPLY ALL LENGTHS IN THE TABLE BY 1.33

TENSION LAP SPICE LENGTHS FOR WALLS AND SLABS (INCH)							
BAR SIZE	CONCRETE COVER 3/4"		CONCRETE COVER 1 1/2"		CONCRETE COVER 2"		CONCRETE COVER 3"
	TOP	OTHER	TOP	OTHER	TOP	OTHER	TOP OTHER
#3	12	12	12	12	12	12	12 12
#4	20	16	16	13	16	13	16 13
#5	30	24	20	16	20	16	20 16
#6	40	31	24	19	24	19	24 19
#7	-	-	40	31	35	27	35 27
#8	-	-	50	38	40	31	40 31


NOTES:  
1. TABULATED VALUES ARE BASED ON UNCOATED 60,000PSI REINFORCEMENT AND NORMAL WEIGHT 3,500PSI CONCRETE.  
2. TENSION LAP SPICE LENGTHS ARE CALCULATED PER ACI 318-14, SECTIONS 25.4.2 AND 25.5.  
3. CENTER-CENTER SPACING OF SHALL AT MINIMUM BE ONE BAR DIAMETER PLUS TWICE THE COVER TO USE THIS TABLE.  
4. TYPICAL CENTER-CENTER SPACING AT LAPPED BARS IS 2".  
5. TOP BARS ARE HORIZONTAL WITH MORE THAN 12" OF CONCRETE CAST BELOW.  
6. FOR LIGHTWEIGHT CONCRETE MULTIPLY ALL LENGTHS IN THE TABLE BY 1.33

DRAWN BY:		MKB
CHECKED BY:		BSS
DATE:		05/09/2025
PHASE:		CD
DESCRIPTION OF REVISION:		
#	DATE:	1 10/02/2025
ISSUED FOR BID		



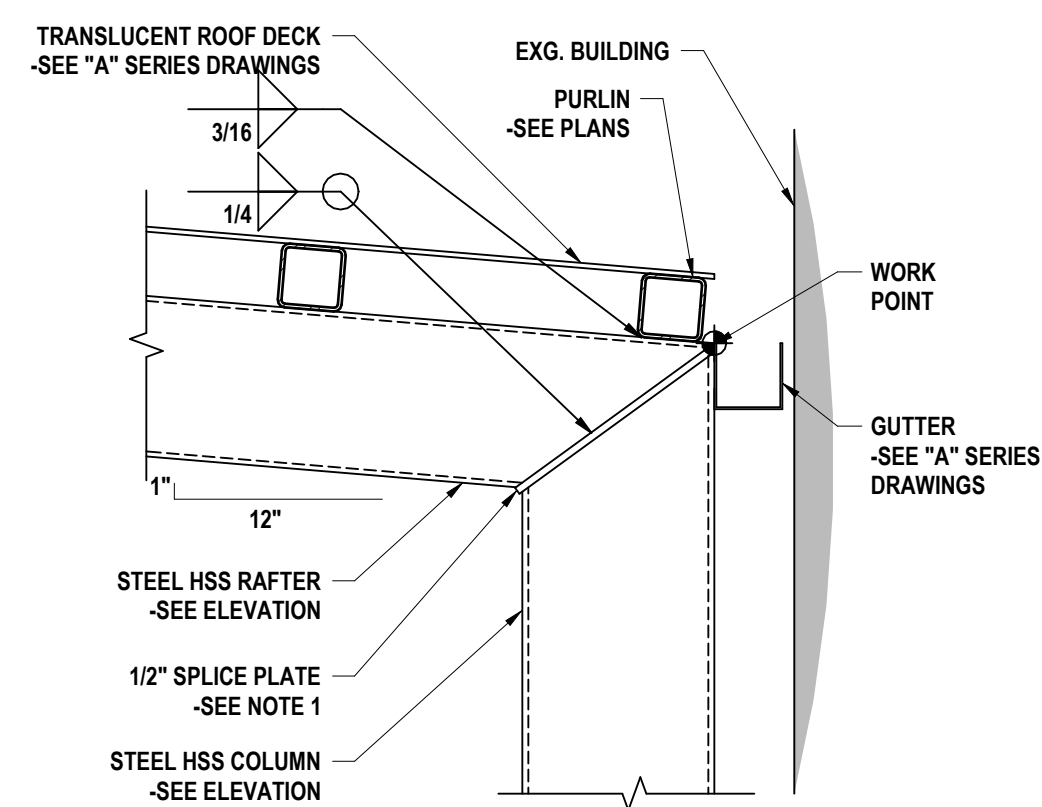

**3 CANOPY FRAME (F-1) CONNECTION**  
1" = 1'-0"

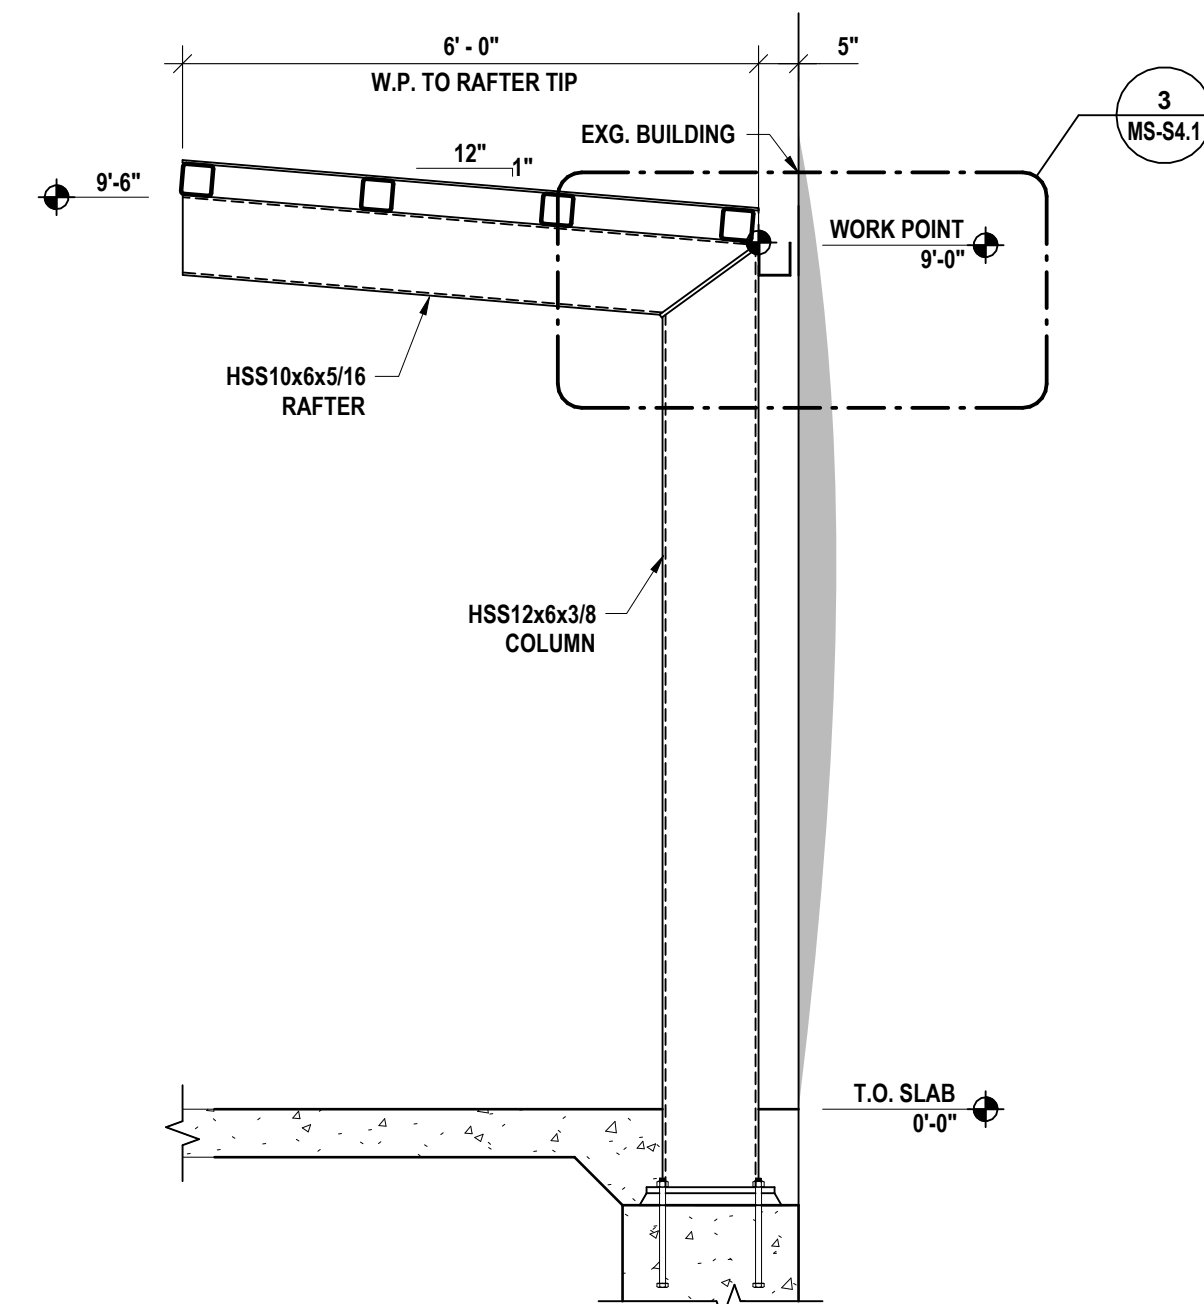


2 CANOPY FRAME ELEVATION (F-1)  
1/2" = 1'-0"

SINGLE PLATE CONNECTION SCHEDULE										
MINIMUM CONNECTION ON BEAM	MAXIMUM CONNECTION ON BEAM	NO. OF BOLTS (TOTAL)	3/4" Ø BOLTS CAPACITY (kips)		E70XX WELD CAPACITY (kips)					
			A325-N	A325-X	3/16" WELD	1/4" WELD	5/16" WELD			
					PLATE (in)	PLATE (in)	PLATE (in)	PLATE (in)		
W8, W10, W12	W8, W10	2	—	11.7	14.2	3/8"	18.9	3/8"	23.6	3/8"
W14, W16, W18	W12, W14	3	16.4	23.4	29.0	3/8"	38.6	3/8"	48.3	7/16"
W21, W24	W16	4	26.2	37.5	45.4	3/8"	60.5	7/16"	75.6	1/2"
W27, W30	W18	5	36.3	51.8	62.6	3/8"	83.4	7/16"	104.6	9/16"
W33, W36	W21	6	46.3	66.1	78.8	3/8"	105.1	1/2"	131.4	5/8"


**NOTES:**

1. WHEN BEAM WEB THICKNESS IS LESS THAN PLATE THICKNESS SHOWN, MULTIPLY LISTED CAPACITY BY RATIO OF ACTUAL THICKNESS TO LISTED MINIMUM THICKNESS
2. MINIMUM WEB THICKNESS (A36) TO DEVELOP BEARING =  $0.204"$

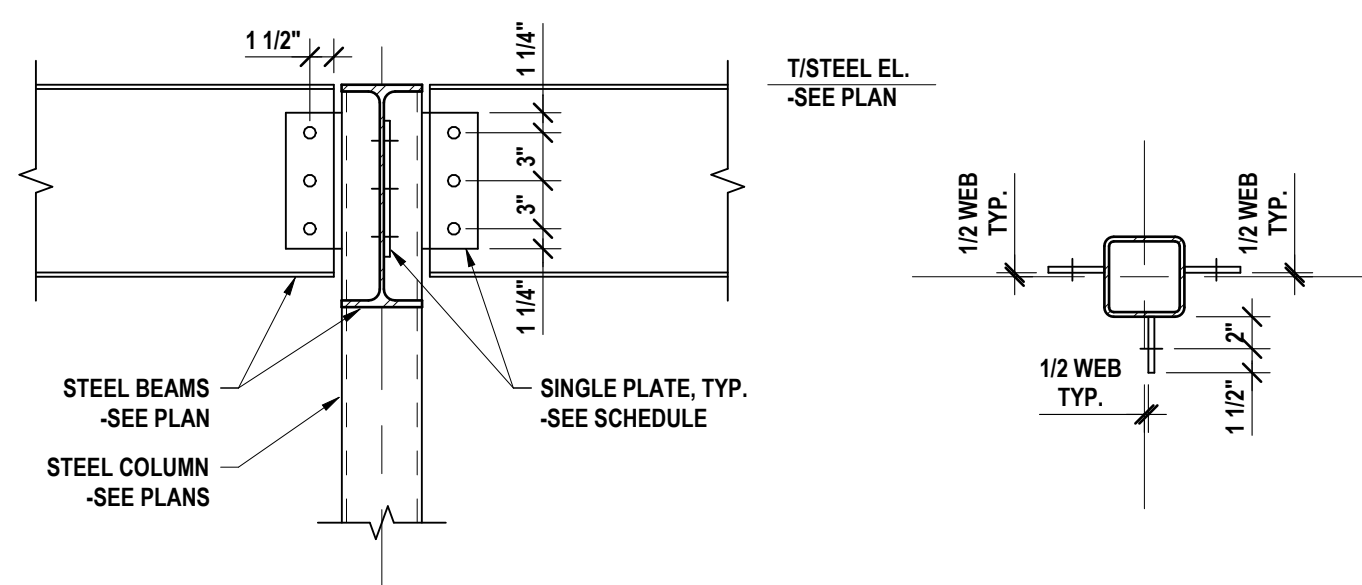


**1 TYPICAL SINGLE PLATE CONNECTION AT COLUMN**  
1" = 1'-0"



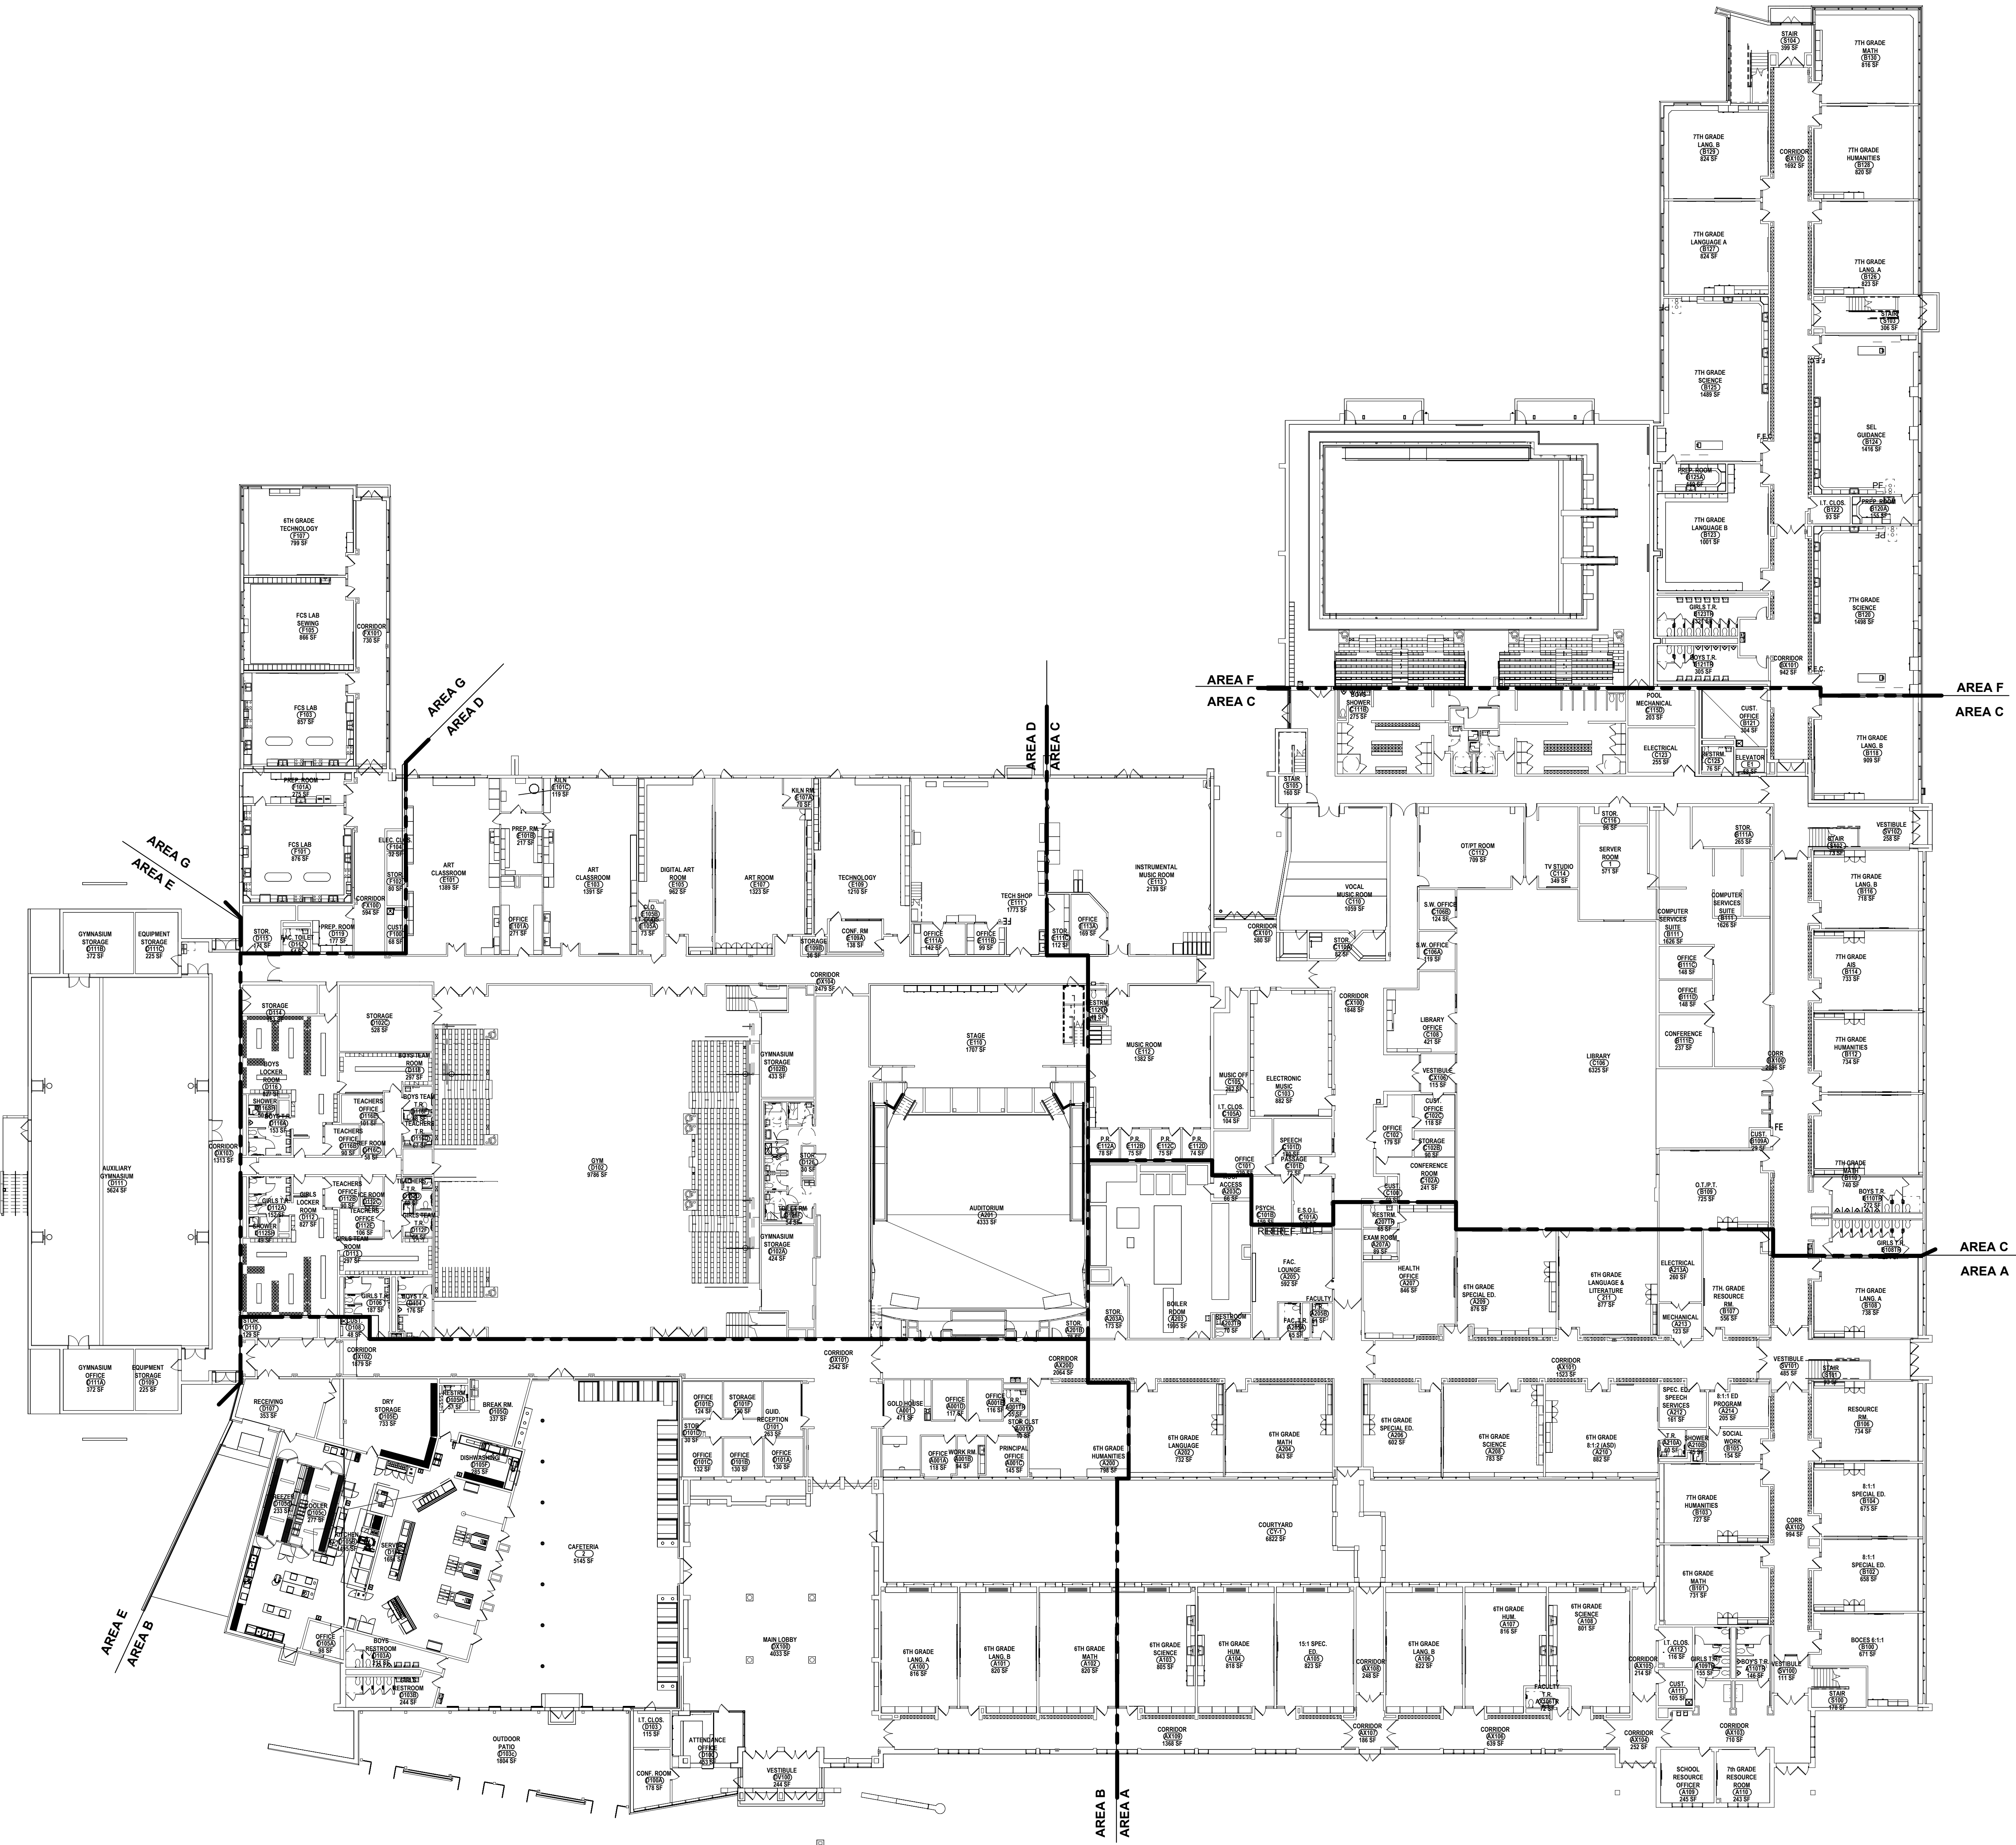

1 KEY PLAN  
3/64" = 1'-0"

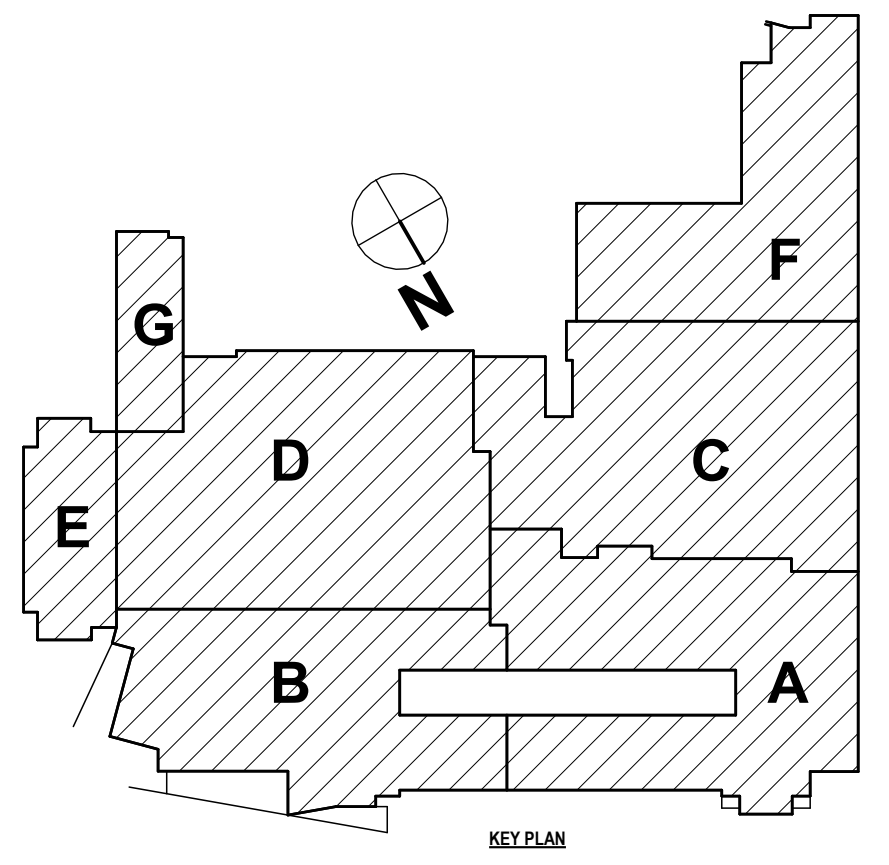

57-16-00-01-002-044 - MIDDLE SCHOOL

KEY PLAN

2025 MIDDLE SCHOOL PHASE III ALTERATIONS PROJECT  
CORNING-PAINTED POST ASD  
35 VICTORY HIGHWAY, PAINTED POST, NY 14870

MS-A0.0  
PROJECT NO: 2649-133

DRAWN BY: PSP	
CHECKED BY: MS	
DATE: 05/09/2025	
PHASE: CD	
#	DATE
	1 11/03/2025
DESCRIPTION OF REVISION: ISSUED FOR BID	
IT IS A VIOLATION OF THE LAW FOR ANY PERSON TO MAKE UNAUTHORIZED ALTERATIONS OR ADJUSTMENTS TO PLANS DRAWN BY: LICENSED ARCHITECTS   SURVEYORS	

HUNT ENGINEERS | ARCHITECTS | SURVEYORS  
HORSEHEADS, NY 807-263-1000 ROCHESTER, NY 585-237-7649 TOWNANDA, PA 470-265-4668  
BINGHAMTON, NY 807-798-8881 ALBANY, NY 807-798-8801  
WWW.HUNTEAS.COM  
NY CERTIFICATE NO. 001620 PA CERTIFICATE NO. TSC220013464-1



**A. ASBESTOS ABATEMENT IS BEING PERFORMED. SPECIFICATIONS CONTAINING MATERIALS ARE PRESENT IN THE EXISTING BUILDING. REFER TO ASB DRAWINGS & ASBESTOS CERTIFICATIONS FOR LOCATIONS AND SCHEDULE. THE CONTRACTOR SHALL BE RESPONSIBLE FOR OBTAINING ALL NECESSARY PERMITS AND APPROVALS FROM ALL AFFECTED AGENCIES AND AGENCIES' CONTRACTORS. IF SUSPECT MATERIAL NOT SCHEDULED IS ENCOUNTERED, STOP WORK IMMEDIATELY, DO NOT DISTURB THE MATERIAL AND NOTIFY THE OWNER'S REPRESENTATIVE AND THE AGENCY.**

**B. MAINTAIN EXISTING STRUCTURAL SYSTEMS AT ALL TIMES. PROVIDE TEMPORARY SHORING AND BRACING AT LOCATIONS WHERE THE EXISTING STRUCTURE IS BEING MODIFIED. PROTECT THE EXISTING STRUCTURE FROM DAMAGE. PROVIDE PROPER BRACING AND SHORING TO MAINTAIN THE EXISTING STRUCTURE. BRACING UNTIL THE NEW STRUCTURE IS INSTALLED AND READY TO ACCEPT LOADS. PROVIDE PROTECTION TO PROVIDE PROTECTION TO EXISTING AREAS OF DECOMPOSITION. KEEP AREAS CLEAR AND CLEAR AT ALL TIMES DURING SCHOOL OPERATIONS.**

**THE OWNER RESERVES THE RIGHT TO RETAIN ANY REMOVED ITEMS AFTER CONTRACTOR REMOVAL. CONTRACTOR SHALL REMOVE FROM THE SITE AND DISPOSE OF ALL REMOVED ITEMS THE OWNER DOES NOT WANT TO RETAIN.**



E FLOOR CONCRETE AND GRINDING OF SUBSTRATES OF DIFFERENT HEIGHTS IN THE SAME AREA IS REQUIRED AT FLOOR REMOVALS AND NEW DOORS EXPOSE WALLS TO ALLOW THE NEW FINISHES TO ALIGN

F PROTECT EXISTING FINISHES ADJACENT TO AREAS OF DEMOLITION FROM DUST AND DAMAGE.

G CONTRACTOR TO COORDINATE THE WORK OF THIS CONTRACT WITH THE WORK OF OTHER TRADES.

H DIMENSIONS SHOWN FOR ALL NEW OPENINGS IN EXISTING CONSTRUCTION SHOULD BE COORDINATED

I ROOM NUMBERS INDICATED ARE EXISTING BUILDING NUMBERS. REFER TO NEW FLOOR PLANS (A-1 DRAWING SERIES FOR NEW ROOM NUMBERING).

J REMOVE EXISTING WOOD BLOCKING FOR EXISTING PENCILS, SHIMMERS, BULLETIN BOARDS ETC. THAT INTERFERE WITH NEW LOCATIONS OR NEW ROOM FINISHES AND WALL TREATMENTS. CONTRACTOR FOR ALL AREAS.

K ITEMS SHOWN ARE INTENDED TO GIVE APPROXIMATE QUANTITY, LOCATION AND TYPE. CONTRACTOR IS RESPONSIBLE FOR VERIFYING ACTUAL QUANTITIES AND EXISTING FIELD CONDITIONS, IN ORDER TO COMPLETE NEW WORK.

M CORONATE ANY WALL PATCHING INFILL THAT IS CAUSED BY THE REMOVAL OF EQUIPMENT IN THE "H", "I", "E", AND "D" TAGS. AND PREPARE SURFACE TO RECEIVE NEW FINISHES.

N PREPARE FLOOR SLAB AT THE INTERFERENCE, SUCH AS "C" TAGS, PATCH TO MATCH EXISTING OR PREPARE TO RECEIVE NEW FINISHES.



D1 REMOVE LOOSE CONC. PAVING AT TRENCH DRAIN AND PATCH SPALLING AREA W/ CONC. REPAIR PRODUCT.  
D2 REMOVE EXISTING DOOR, FRAME AND HARDWARE IN THEIR ENTIRETY TO EXTENDS SHOWN ON PLAN. PATCH  
D3 DAMAGED SURFACES SCHEDULED TO REMAIN IN PLACE TO MATCH EXISTING CONSTRUCTION AND PREPARE  
D4 SURFACES TO RECEIVE NEW FINISHES AND DOOR.  
D5 PATCH DAMAGED SURFACES SCHEDULED TO REMAIN IN PLACE AT DRINKING FOUNTAIN REMOVAL. TO MATCH  
D6 EXISTING CONSTRUCTION. PREPARE FOR NEW INSTALLATION.  
D7 REPLACE EARTH BENCH. PREPARE FOR NEW INSTALLATION.  
D8 BY ALTERNATE #2, REMOVE EXISTING BLEACHER SYSTEM IN ITS ENTIRETY. PATCH DAMAGED SURFACES SCHEDULED  
D9 TO REMAIN IN PLACE. PREPARE SURFACES FOR NEW INSTALLATION.  
D10 REMOVE EXISTING BASKETBALL BACKBOARD. PATCH DAMAGED SURFACES SCHEDULED TO REMAIN IN PLACE.  
D11 REMOVE EXISTING SCORE BOARD. PATCH DAMAGED SURFACES TO REMAIN. PREPARE SURFACES FOR NEW SCORE  
D12 BOARD INSTALLATION.  
D13 REMOVE FLOORING. PATCH ADJACENT SURFACES DISTURBED BY DEMOLITION. PREPARE CONCRETE SLAB  
D14 FOR INSTALLATION OF NEW FINISHES.  
D15 REMOVE CEILING AT EXISTING CONC. SLAB AS INDICATED BY HATCH. COORD. WITH "P" & "PP" DWGS.  
D16 PROVIDE EXISTING TRUSS SYSTEM AND ANY SUPPORTING STRUCTURE, ADJOINT VENTS, AND SOFFITS IN THEIR  
D17 ENTIRETY TO EXTENTS SHOWN ON PLAN. REPAIR ALL DAMAGED SURFACES SCHEDULED TO REMAIN. PREPARE  
D18 FOR NEW CEILING INSTALLATION.  
D19 REMOVE EXISTING STOREFRONT SIGNAGE IN ITS ENTIRETY TO EXTENTS SHOWN ON PLAN. CLEAN, RUST SCRAP STEEL  
D20 LIFTS TO REMOVE WHITE PAINT AND ALL RUST. PREPARE SURFACES TO RECEIVE NEW FINISHES.  
D21 REMOVE EXISTING WHITEBOARD IN ITS ENTIRETY. PATCH DAMAGED SURFACES SCHEDULED TO REMAIN. PREPARE  
D22 FOR NEW WHITEBOARD IN NEW WHITEBOARD IN PLACE.  
D23 REMOVE DOOR HARDWARE. PREPARE DOOR FOR NEW HARDWARE, DOOR AND FRAME TO REMAIN.  
D24 BY ALTERNATE #2, REMOVE EXISTING WALL FILLS IN THEIR ENTIRETY. PATCH DAMAGED SURFACES SCHEDULED TO  
D25 REMAIN IN PLACE.  
D26 REMOVE ALL LOOSE CONCRETE AND OLD PATCHING MATERIAL. CLEAN REPAIR REINFORCING TO REMOVE RUST  
D27 AND PATCH WITH A VERTICAL OR OVERHEAD CONCRETE PATCH B.O.D. SIKKA REPAIR 223 TO PREVENT ADDITIONAL  
D28 CORROSION/DAMAGE.

- D16 REMOVE EXISTING FACADE AT VERTICAL FACE OF CANOPY, PATCH DAMAGED SURFACES SCHEDULED TO REMAIN IN PLACE. PREPARE SURFACES FOR NEW FINISH INSTALLATION.
- D17 REMOVE EXISTING SLAB AT VERTICAL FACE OF CANOPY, PATCH DAMAGED SURFACES DISTURBED BY DEMOLITION. PREPARE CONCRETE SLAB FOR INSTALLATION OF NEW FINISHES.
- D18 REMOVE EXISTING STORORAGE SYSTEM IN ITS ENTIRETY. PREPARE SURFACES FOR NEW FLOOR FINISHES.
- D19 REMOVE EXISTING STAIRS, STAIRCASE, AND STAIRCASE HANDRAILS. PREPARE SURFACES FOR NEW FLOOR FINISHES.
- D20 REMOVE PORTION OF EXISTING FLOOR SLAB AS NEEDED FOR POOL, GUTTER SYSTEM INSTALLATION. COORDINATE WITH NEW CONSTRUCTION.
- D21 REMOVE EXISTING SHUTTER ASSEMBLY IN ITS ENTIRETY. PREPARE FOR WALL, INFILL, AND NEW FINISHES.
- D22 REMOVE EXISTING GUM TOILET PARTITIONS IN THEIR ENTIRETY. PREPARE FOR NEW CONSTRUCTION.
- D23 REMOVE EXISTING HANDRAIL AND PREPARE FOR NEW.
- D24 REMOVE EXISTING GUM PARTITION TO DEC. PREPARE FOR NEW CONSTRUCTION.
- D25 PROTECT IN PLACE AERILIZED CONCRETE STATION.
- D26 REMOVE SOFFIT PLASTER AND LIGHT.
- D27 REMOVE 2 LAYERS OF EXISTING WALL TILE AT CORRIDOR WALL AND PREPARE FOR NEW FLOOR FINISHES. PROTECT ALL ADJACENT FINISHES TO REMAIN.
- D28 REMOVE EXPOSED FLOORING AND WALL BASE IN ITS ENTIRETY AND PREPARE FOR NEW FLOOR FINISH.
- D29 REMOVE TYPICAL WALL PANELS AND PREPARE FOR NEW FINISHES.
- D30 REMOVE DIVING BOARDS AND STARTER BLOCKS AND PREPARE FOR NEW IN SAME LOCATION.
- D31 REMOVE EXISTING WALLS AND FLOORING IN GYMNASIUM CASE AND STORE FOR REINSTATEMENT, INCLUDING BUT NOT LIMITED TO SERVING LINES, METAL TABLES, OVENS, MIXERS, REFRIGERATORS, ETC.
- D32 REMOVE SALVAGE STORE AND PROTECT EXISTING BUILT-IN CASEWORKS/FRUITING UNITS AND ASSOCIATED WORK.
- D33 REMOVE EXISTING WALLS AND FLOORING IN KITCHEN AND RESTROOM CASEWORK AND ACCESSORIES TO BE REINSTALLED IN SAME LOCATION. REFRESH DAMAGED WALLS AND FLOORING SCHEDULED TO REMAIN IN PLACE TO MATCH EXISTING CONSTRUCTION AND PREPARE SURFACES FOR NEW FINISHES.
- D34 REMOVE EXISTING CEMENT FLOOR TO ACCOMMODATE NEW T2 INFILL.
- D35 REMOVE WINDOW, FRAME, HARDWARE, AND WINDOW TREATMENT SYSTEMS IN THEIR ENTIRETY. REPAIR DAMAGED SURFACES SCHEDULED TO REMAIN IN PLACE TO MATCH EXISTING CONSTRUCTION AND PREPARE SURFACES TO RECEIVE NEW FINISHES.

D035 REMOVE POOL FLOOR SLAB AND FOUNDATION AT THE SHALLOW END AS SHOWN AND PREPARE FOR NEW FLOOR  
D036 SLAB AND FOUNDATION AT A NEW DEPTH. COORDINATE WITH PROPOSED FLOOR PLAN AND DETAILS.  
D037 REMOVE BALCONY RAMP AND FOUNDATION AS SHOWN AND PREPARE FOR NEW CONSTRUCTION PLANS.  
D038 REMOVE PORTION OF EXG. CEILING AS REQUIRED FOR DEMOLITION OF ADJACENT COMPONENTS.  
D039 REMOVE POOL WALL IN ITS ENTIRETY TO PREPARE FOR NEW POOL FLOOR OR NEW POOL RAMP. REFER TO NEW  
D040 CONSTRUCTION PLANS FOR ADDITIONAL INFORMATION.  
D041 REMOVE POOL FLOOR IN ITS ENTIRETY TO ACCOMMODATE NEW RAMP. REFER TO NEW CONSTRUCTION  
D042 PLAN FOR ADDITIONAL INFORMATION.  
D043 TRENCH PORTION OF FLOOR AS SHOWN FOR NEW TRENCH DRAIN. COORDINATE WITH PLUMBING DRAWINGS  
D044 AND DETAILS.  
D045 REMOVE EXISTING FLOOR WALL DOWN FROM FINISHED FLOOR SURFACE TO REBUILD. COORDINATE WAIRBACH  
D046 DRAWINGS AND DETAILS.  
D047 REMOVE WITH CARE AND SALVAGE CEILING LIGHTS AND SECONDARY RUINS IN SAFE LOCATION FOR LATER  
D048 REMOVAL AND REUSE.  
D049 REMOVE EXISTING LOCKERS IN THEIR ENTIRETY. CLEAN AND REPAIR TERRAZZO FLOOR IMPACTED BY LOCKER  
D050 REMOVAL AS NEEEDED.  
D051 REMOVE EXISTING LOCKERS, ACCESSORIES, AND BENCH SEATING IN THEIR ENTIRETY. PATCH FLOOR AS REQUIRED  
D052 FOR SMOOTH FINISH. PREPARE FLOOR FINISH PATCHES.  
D053 REMOVE/TRENCH CONCRETE SLAB AS REQUIRED (ASSUME FULL EXTENTS) FOR NEW PLUMBING.  
D054 REMOVE COUNTERTOP HEIGHT OVER HEAD DOOR, COUNTER, AND ALL ASSOCIATED ACCESSORIES.  
D055 REMOVE EXISTING FINISHES INCLUDING TILE, MARBLE, GRANITE, STONE, MASONRY, AND BOARDS. MARKING  
D056 AND BOARDS OF MARCITE WITHIN THE SWIMMING POOL IN ITS ENTIRETY. PREPARE SURFACES TO RECEIVE NEW  
D057 FINISHES.  
D058 REMOVE PORTION OF CMU WALL TO ACCOMMODATE NEW PLUMBING LAYOUT.  
D059 REMOVE EXISTING TOTILE PARTITIONS, ASSOCIATED BRACING, ACCESSORIES AND ALL WALL MOUNTED ITEMS  
D060 INCLUDING, BUT NOT LIMITED TO MIRRORS, SOAP DISPENSERS, GRAB BARS, ETC. PREPARE FLOOR AND WALL  
D061 SURFACES FOR NEW FINISHES.  
D062 REMOVE, SALVAGE AND PROTECT CEILING GRID AS REQUIRED FOR WALL FINISH SCOPE.  
D063 REMOVE CASEWORK AND ASSOCIATED ACCESSORIES IN ITS ENTIRETY. REPAIR DAMAGE SURFACES SCHEDULED TO  
D064 REMAIN.  
D065 REMOVE BACKSPLASH, BACKBOARD AND ASSOCIATED HARDWARE. EXISTING BACKSTOP FRAME TO REMAIN.  
D066 REMOVE COUNTERTOP, SALVAGE AND SAFETY STORE CASEWORK BENEATH FOR LATER REINSTALLATION.

FIRST FLOOR DEMOLITION PLAN - AREA A &amp; E

2025 MIDDLE SCHOOL PHASE III ALTERATIONS PROJECT

# CORNING-PAINTED POST ASD

335 VICTORY HIGHWAY, PAINTED POST, NY 14870

# HUNT<sup>®</sup>

ENGINEERS | ARCHITECTS | SURVEYORS

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NY CERTIFICATE NO. 0018220 PA CERTIFICATE NO. TSC2203131464-1

#	DATE:	DESCRIPTION OF REVISION:
1	10/20/2025	ISSUED FOR BID

"IT IS A VIOLATION OF THE LAW FOR ANY PERSON TO MAKE UNAUTHORIZED ALTERATIONS OR ADDITIONS TO PLANS"

SP
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GENERAL DEMOLITION NOTES:

- A ASBESTOS ABATEMENT IS BEING PERFORMED. ASBESTOS CONTAINING MATERIALS ARE PRESENT IN THE EXISTING BUILDING. REFER TO AS DRAWINGS & SPECIFICATIONS FOR LOCATIONS AND SCHEDULE. THE OWNER HAS REPORTS IDENTIFYING ACM MATERIALS AND WILL HAVE THESE AVAILABLE FOR CONTRACTORS REFERENCE. IF SUSPECT MATERIAL NOT SCHEDULED IS ENCOUNTERED, STOP WORK IMMEDIATELY, DO NOT DISTURB THE MATERIAL AND NOTIFY THE OWNER'S REPRESENTATIVE AND THE ARCHITECT.
- B MAINTAIN EXISTING STRUCTURAL SYSTEMS AT ALL TIMES. PROVIDE TEMPORARY SHORING AND BRACING AT LOCATIONS WHERE THE EXISTING STRUCTURE IS BEING MODIFIED. PROTECT THE EXISTING STRUCTURE SCHEDULED TO REMAIN, FROM DAMAGE DURING DEMOLITION. MAINTAIN SHORING AND BRACING UNTIL THE NEW STRUCTURE IS INSTALLED AND READY TO ACCEPT LOADS.
- C CONTRACTOR TO PROVIDE PROTECTIVE BARRIER AT ALL AREAS OF DEMOLITION. KEEP ALL EXITS FREE AND CLEAR AT ALL TIMES DURING SCHOOL OPERATIONS.
- D THE OWNER RESERVES THE RIGHT TO RETAIN ANY REMOVED ITEMS AFTER CONTRACTOR REMOVAL. THE CONTRACTOR SHALL REMOVE FROM THE SITE AND DISPOSE OF ALL REMOVED ITEMS THE OWNER DOES NOT WISH TO RETAIN.

GENERAL DEMOLITION NOTES:

- E FLOOR CONC. AND GRINDING OF SUBSTRATES OF DIFFERENT HEIGHTS IN THE SAME AREA IS REQUIRED AT WALL REMOVALS AND NEW DOORS IN EXG. WALLS TO ALLOW THE NEW FINISHES TO ALIGN BETWEEN ADJACENT ROOMS AND ADJACENT ROOMS THAT BECOME ONE ROOM.
- F PROTECT EXISTING FINISHES ADJACENT TO AREAS OF DEMOLITION FROM DUST AND DAMAGE.
- G CONTRACTOR TO COORDINATE THE WORK OF THIS CONTRACT WITH THE WORK OF OTHER TRADES.
- H DIMENSIONS SHOWN FOR ALL NEW OPENINGS IN EXISTING CONSTRUCTION SHOULD BE COORDINATED WITH THE NEW PLANS AND EXISTING CONDITIONS IN THE FIELD.
- I ROOM NUMBERS INDICATED ARE EXISTING BUILDING NUMBERS. REFER TO NEW FLOOR PLANS (A-1 DRAWING SERIES FOR NEW ROOM NUMBERING).
- J REMOVE EXISTING WOOD BLOCKING FOR EXISTING PENCIL, SHARPENERS, BULLETIN BOARDS ETC. THAT INTERFERE WITH NEW LOCATIONS OR NEW ROOM FINISHES AND WALL TREATMENTS. TYPICAL FOR ALL AREAS.
- K ITEMS SHOWN ARE INTENDED TO GIVE APPROXIMATE QUANTITY, LOCATION AND TYPE. CONTRACTOR IS RESPONSIBLE FOR VERIFYING ACTUAL QUANTITIES AND EXISTING FIELD CONDITIONS, IN ORDER TO COMPLETE NEW WORK.
- M COORDINATE ANY WALL PATCHING INFILL THAT IS CAUSED BY THE REMOVAL OF EQUIPMENT IN THE "H", "P", "E" AND "T" DWGS. AND PREPARE SURFACE TO RECEIVE NEW FINISHES.
- N INFILL FLOOR SLAB AT LOCATIONS OF TRENCHING, SEE "S" DWGS. PATCH TO MATCH EXISTING OR PREPARE TO RECEIVE NEW FINISHES.

D# DEMOLITION KEY NOTES:


- D1 REMOVE LOOSE CONC. PAVING AT TRENCH DRAIN AND PATCH SPALLING AREA W/ CONC. REPAIR PRODUCT.
- D2 REMOVE EXISTING DOOR, FRAME, AND HARDWARE IN THEIR ENTIRETY TO EXTENTS SHOWN ON PLAN. PATCH DAMAGED SURFACES SCHEDULED TO REMAIN IN PLACE TO MATCH EXISTING CONSTRUCTION AND PREPARE SURFACES TO RECEIVE NEW FINISHES AND DOOR.
- D3 PATCH DAMAGED SURFACES SCHEDULED TO REMAIN IN PLACE AT DRINKING FOUNTAIN REMOVAL TO MATCH EXISTING CONSTRUCTION. PREPARE SURFACES FOR NEW INSTALLATION.
- D4 REPLACE ENTIRE FENCE. PREPARE FOR NEW INSTALLATION.
- D5 BY ALTERNATE #, REMOVE EXISTING BLEACHER SYSTEM IN ITS ENTIRETY. PATCH DAMAGED SURFACES SCHEDULED TO REMAIN IN PLACE. PREPARE SURFACES FOR NEW INSTALLATION.
- D6 REMOVE EXISTING BASKETBALL BACKSTOPS. PREPARE FOR NEW INSTALLATION.
- D7 REMOVE EXISTING SCORE BOARD. PATCH DAMAGED SURFACES TO REMAIN. PREPARE SURFACES FOR NEW SCORE BOARD INSTALLATION.
- D8 REMOVE LVTI VCT FLOORING. PATCH ADJACENT SURFACES DISTURBED BY DEMOLITION. PREPARE CONCRETE SLAB FOR INSTALLATION OF NEW FINISHES.
- D9 PROVIDE TRENCHING AT EXISTING CONC. SLAB AS INDICATED BY HATCH. COORD. WITH "P" & "PP" DWGS.
- D10 REMOVE EXISTING CEILING SYSTEM AND ANY SUPPORTING STRUCTURE. ADJACENT AXIUM, AND SOFFITS IN THEIR ENTIRETY TO EXTENTS SHOWN ON PLAN. REPAIR ALL DAMAGED SURFACES SCHEDULED TO REMAIN. PREPARE FOR NEW CEILING INSTALLATION.
- D11 REMOVE EXISTING STOREFRONT SYSTEM IN THEIR ENTIRETY TO EXTENTS SHOWN ON PLAN. PATCH DAMAGED SURFACES SCHEDULED TO REMAIN IN PLACE TO MATCH EXISTING CONSTRUCTION. CLEAN AND SCRAPE STEEL UNITS. S TO REMOVE LOOSE PAINT AND ALL RUST. PREPARE SURFACES TO RECEIVE NEW FINISHES.
- D12 REMOVE EXISTING WHITEBOARD IN ITS ENTIRETY. PATCH DAMAGED SURFACES SCHEDULED TO REMAIN. PREPARE SURFACES FOR NEW WHITEBOARD INSTALLATION.
- D13 REMOVE DOOR HARDWARE. PREPARE DOOR FOR NEW HARDWARE. DOOR AND FRAME TO REMAIN.
- D14 BY ALTERNATE #, REMOVE EXISTING WALL TILES IN THEIR ENTIRETY. PATCH DAMAGED SURFACES SCHEDULED TO REMAIN IN PLACE. PREPARE SURFACES FOR NEW FINISHES.
- D15 REMOVE ALL LOOSE CONCRETE AND OLD PATCHING MATERIAL. CLEAN EXPOSED REINFORCING TO REMOVE RUST AND PATCH WITH A VERTICAL OR OVERHEAD CONCRETE PATCH B.O.D. SIKA REPAIR 223 TO PREVENT ADDITIONAL SPALLING. APPROXIMATELY 90 SF.

D# DEMOLITION KEY NOTES:

- D16 REMOVE EXISTING FACADE AT VERTICAL FACE OF CANOPY. PATCH DAMAGED SURFACES SCHEDULED TO REMAIN IN PLACE. PREPARE SURFACES FOR NEW FINISH INSTALLATION.
- D17 REMOVE CERAMIC TILE FLOORING. PATCH ADJACENT SURFACES DISTURBED BY DEMOLITION. PREPARE CONCRETE SLAB FOR INSTALLATION OF NEW FINISHES.
- D18 REMOVE EXISTING STOREFRONT SYSTEM IN ITS ENTIRETY. PREPARE SURFACES FOR NEW STOREFRONT SYSTEM. REFER TO ASBESTOS ABATEMENT PLAN FOR BACKSTOP REMOVAL.
- D19 REMOVE PORTION OF EXISTING FLOOR SLAB AS NEEDED FOR POOL. GUTTER SYSTEM INSTALLATION. COORDINATE WITH NEW CONSTRUCTION.
- D21 REMOVE EXISTING FIRE SHUTTER ASSEMBLY IN ITS ENTIRETY. PREPARE FOR WALL INFILL AND NEW FINISHES.
- D22 REMOVE EXISTING CMU TOILET PARTITIONS IN THEIR ENTIRETY. PREPARE FOR NEW CONSTRUCTION.
- D23 REMOVE EXISTING HANDRAIL AND PREPARE FOR NEW.
- D24 REMOVE EXISTING CMU PARTITION TO DECK. PREPARE FOR NEW CONSTRUCTION.
- D25 PROTECT IN PLACE AED/BLEED CONTROL STATION.
- D26 REMOVE SOFFIT PLASTER AND LIGHT.
- D27 REMOVE (2) LAYERS OF EXISTING WALL TILE AT CORRIDOR WALL AND PREPARE FOR NEW FINISHES. PROTECT ALL ADJACENT FINISHES TO REMAIN.
- D28 REMOVE EPOXY FLOORING AND WALL BASE IN ITS ENTIRETY AND PREPARE FOR NEW FLOOR FINISH.
- D29 REMOVE TECTUM WALL PANELS AND PREPARE FOR NEW FINISHES.
- D30 REMOVE DIVING BOARDS AND STARTER BLOCKS AND PREPARE FOR NEW IN SAME LOCATION.
- D31 DISCONNECT AND REMOVE ALL KITCHEN EQUIPMENT WITH CARE AND STORE FOR REINSTALLATION. INCLUDING BUT NOT LIMITED TO, SERVING LINES, METAL TABLES, OVENS, MIXERS, REFS, FREEZERS, ECT.
- D32 REMOVE, SALVAGE STORE AND PROTECT EXISTING BUILT-IN CASEWORK/SHELVING UNITS AND ASSOCIATED WORK SURFACES AS REQUIRED FOR FLOORING REPLACEMENT. CASEWORK AND ACCESSORIES TO BE REINSTALLED IN SAME LOCATION. REFINISH DAMAGED WALLS AND FLOORING SCHEDULED TO REMAIN IN PLACE TO MATCH EXISTING CONSTRUCTION AND PREPARE SURFACES TO RECEIVE NEW FINISHES.
- D33 REMOVE EXISTING CONCRETE FLOOR TO ACCOMMODATE NEW T2 INFILL.
- D34 REMOVE WINDOW, FRAME, HARDWARE, AND WINDOW TREATMENT SYSTEMS IN THEIR ENTIRETY. REPAIR DAMAGED SURFACES SCHEDULED TO REMAIN IN PLACE TO MATCH EXISTING CONSTRUCTION AND PREPARE SURFACES TO RECEIVE NEW FINISHES.

D# DEMOLITION KEY NOTES:

- D35 REMOVE POOL FLOOR SLAB AND FOUNDATION AT THE SHALLOW END AS SHOWN AND PREPARE FOR NEW FLOOR SLAB AND FOUNDATION AT A NEW DEPTH. COORDINATE WITH PROPOSED FLOOR PLAN AND DETAILS.
- D36 BY ALTERNATE #, REMOVE BALCONY RAILINGS AND PREPARE TO RECEIVE NEW RAILINGS.
- D37 REMOVE PORTION OF EXG. CEILING AS REQUIRED FOR DEMOLITION OF ADJACENT COMPONENTS.
- D38 REMOVE POOL WALL IN ITS ENTIRETY TO PREPARE FOR NEW POOL FLOOR OR NEW POOL RAMP. REFER TO NEW CONSTRUCTION PLANS FOR ADDITIONAL INFORMATION.
- D39 REMOVE POOL FLOOR IN ITS ENTIRETY TO EXTENTS SHOWN IN PLAN TO ACCOMMODATE NEW RAMP. REFER TO NEW CONSTRUCTION PLAN FOR ADDITIONAL INFORMATION.
- D40 TRENCH PORTION OF FLOOR AS SHOWN FOR NEW TRENCH DRAIN. COORDINATE WITH PLUMBING DRAWINGS.
- D41 REMOVE +3'-3" OF POOL WALL DOWN FROM FINISHED FLOOR AND PREPARE TO REBUILD. COORDINATE W/ ARCH DRAWINGS AND DETAILS.
- D42 REMOVE WITH CARE AND SALVAGE CEILING TILES AND SECONDARY RUNNERS IN SAFE LOCATION FOR LATER REINSTALLATION AS REQUIRED FOR HVAC SCOPE. SEE "H" DWGS.
- D43 REMOVE EXISTING LOCKERS IN THEIR ENTIRETY. CLEAN AND REPAIR TERRAZZO FLOOR IMPACTED BY LOCKER REMOVAL, AS NEEDED.
- D44 REMOVE EXISTING LOCKERS, ACCESSORIES, AND BENCH SEATING IN THEIR ENTIRETY. PATCH FLOOR AS REQUIRED FOR SMOOTH FINISH. PREPARE FOR FLOOR FINISH PATCHING.
- D45 REMOVE/TRENCH CONCRETE SLAB AS REQUIRED (ASSUME FULL EXTENTS) FOR NEW PLUMBING.
- D46 REMOVE COUNTERTOP HEIGHT OVER HEAD DOOR, COUNTER, AND ALL ASSOCIATED ACCESSORIES.
- D48 REMOVE EXISTING POOL FINISHES INCLUDING BUT NOT LIMITED TO TILE RACING LANES, TILE MARKINGS, AND BOTH LAYERS OF MARCITE WITHIN THE SWIMMING POOL. IN ITS ENTIRETY. PREPARE SURFACES TO RECEIVE NEW FINISHES.
- D49 REMOVE PORTION OF CMU WALL TO ACCOMMODATE NEW PLUMBING LAYOUT.
- D50 REMOVE EXISTING TOILET PARTITIONS, ASSOCIATED BRACING, ACCESSORIES AND ALL WALL MOUNTED ITEMS INCLUDING, BUT NOT LIMITED TO MIRRORS, SOAP DISPENSERS, GRAB BARS, ETC. PREPARE FLOOR AND WALL SURFACES FOR NEW FINISHES.
- D52 REMOVE, SALVAGE AND PROTECT CEILING AND GRID AS REQUIRED FOR WALL FINISH SCOPE.
- D53 REMOVE CASEWORK AND ASSOCIATED ACCESSORIES IN ITS ENTIRETY. REPAIR DAMAGED SURFACES SCHEDULED TO REMAIN.
- D54 REMOVE BASKETBALL BACKBOARD AND ASSOCIATED HARDWARE. EXISTING BACKSTOP FRAMING TO REMAIN.
- D55 REMOVE COUNTERTOP. SALVAGE AND SAFETY STORE CASEWORK BENEATH FOR LATER REINSTALLATION.

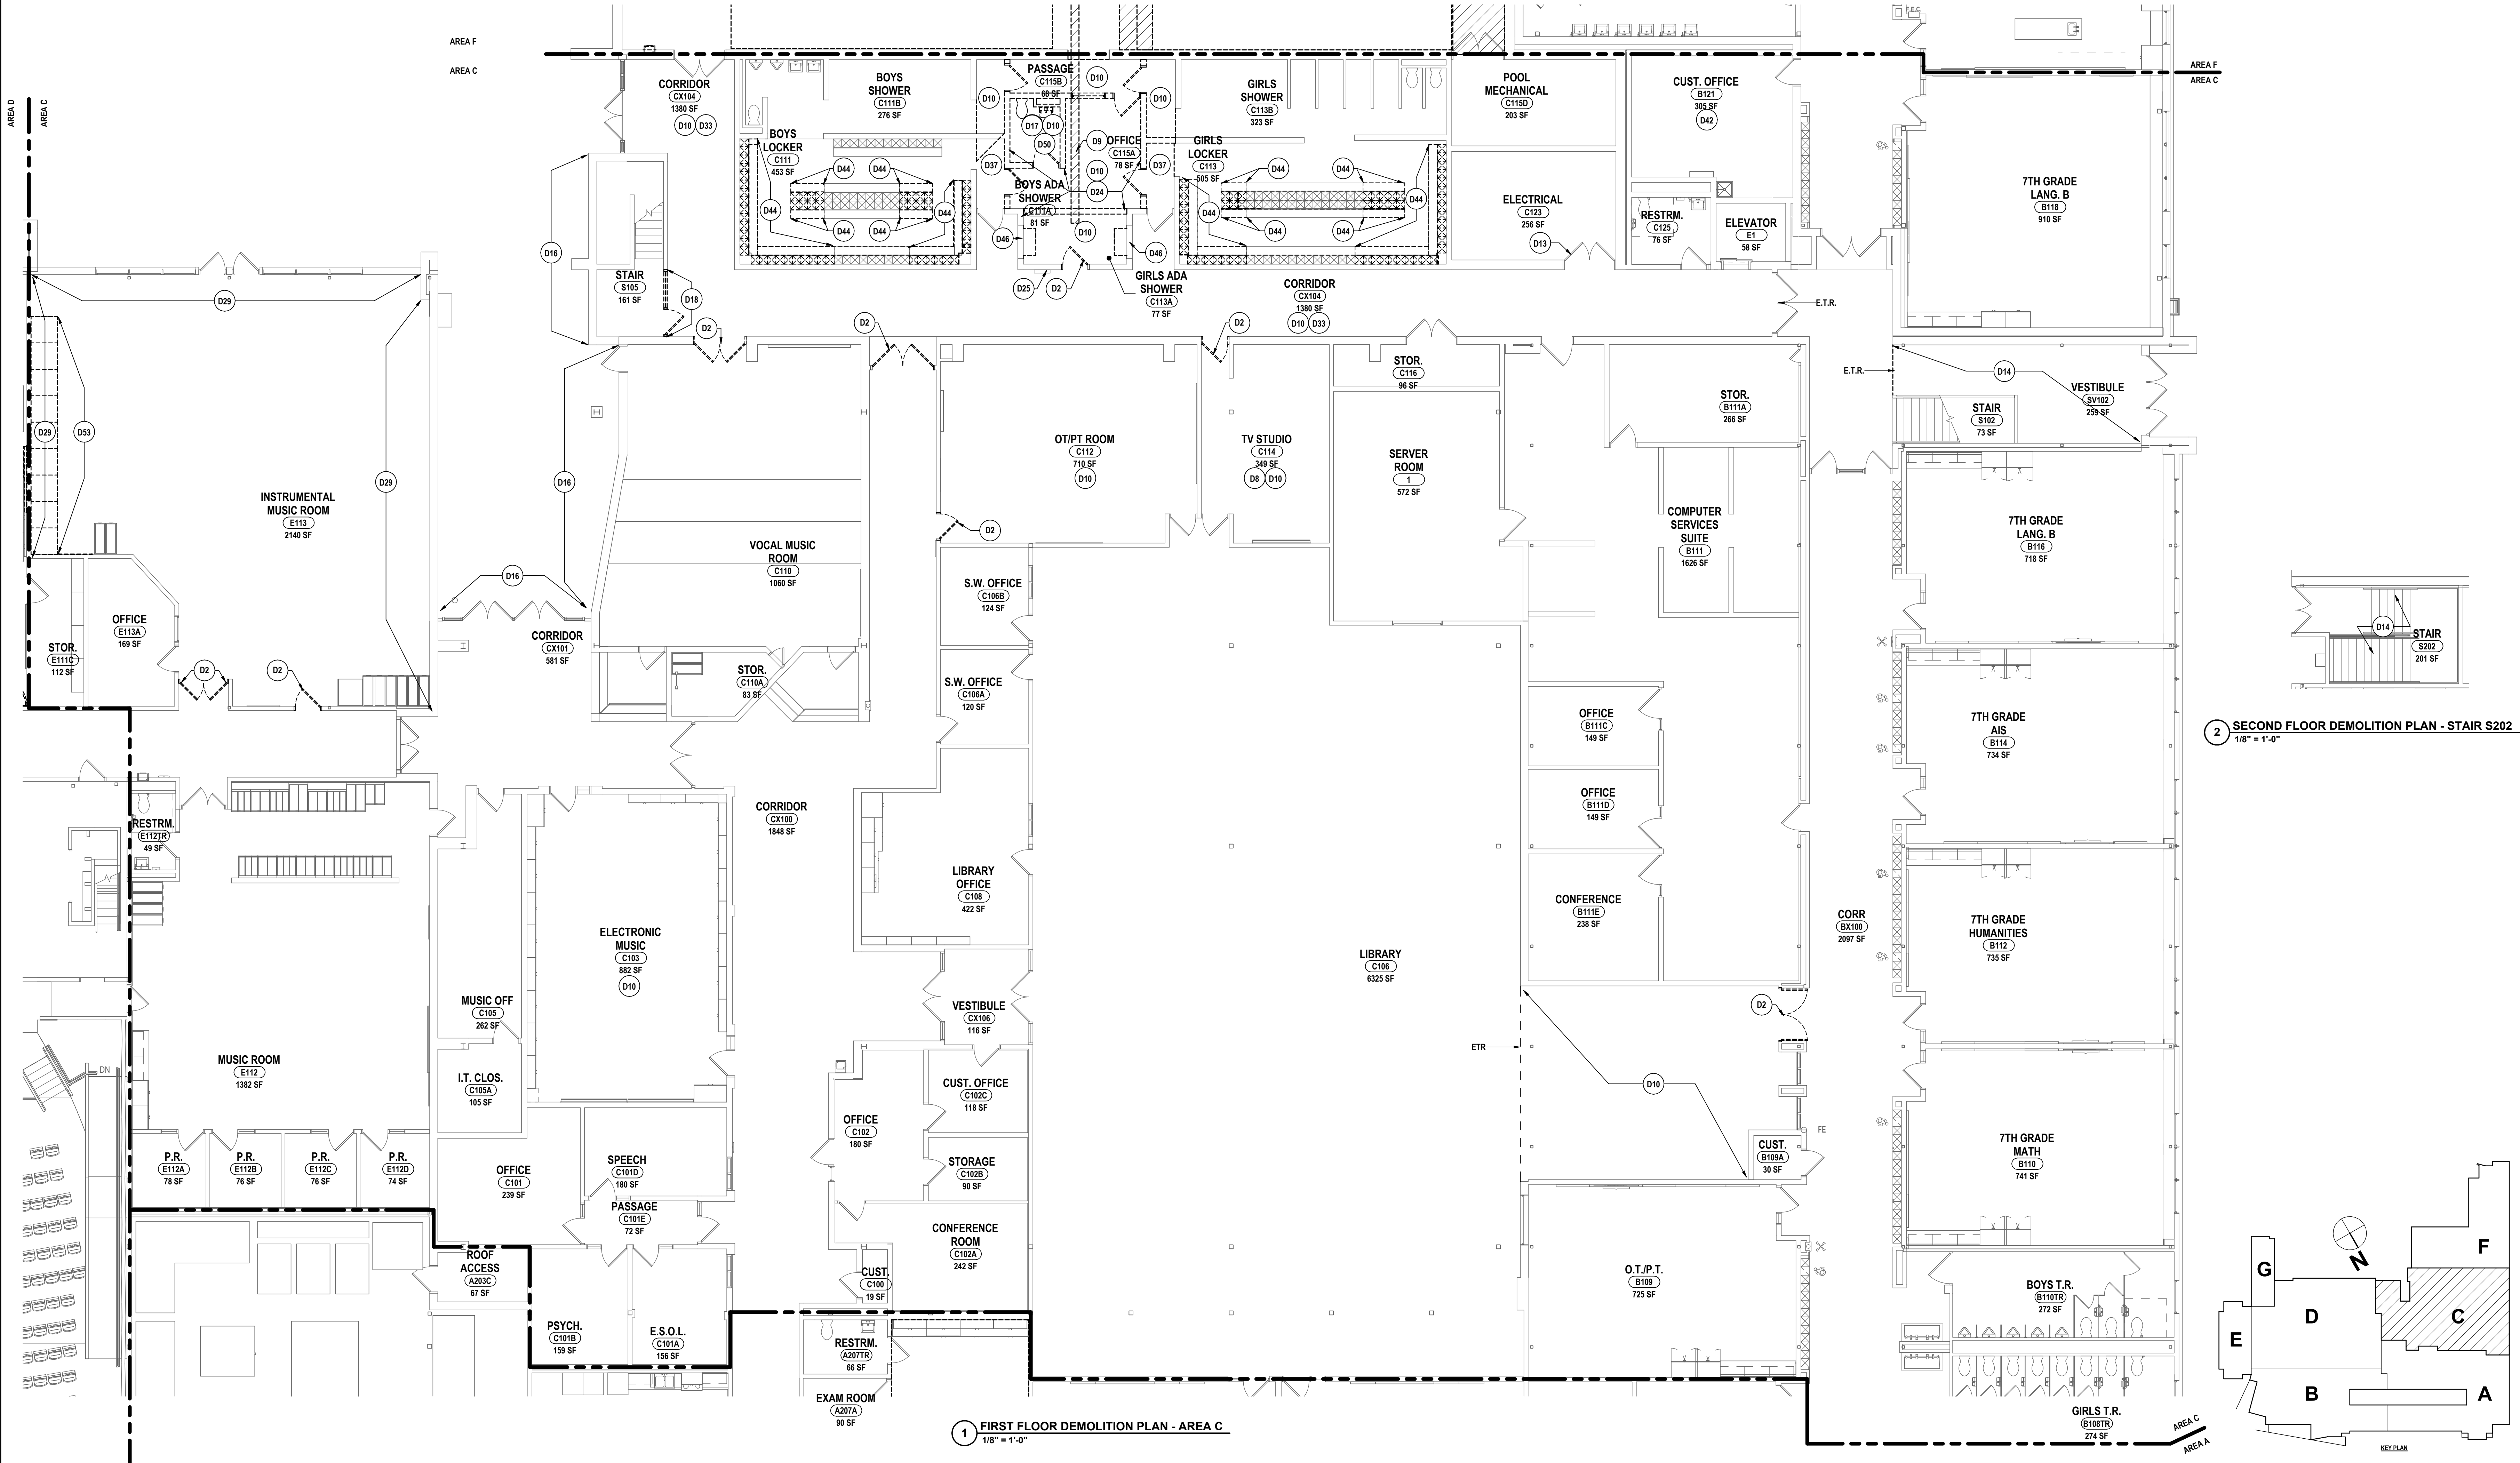

#	DATE:	DESCRIPTION OF REVISION:	ISSUED FOR:	PSR	MS	DATE:	05/09/2025	DATE:	05/09/2025	DATE:	05/09/2025
1	10/02/2025	ISSUED FOR B0									
IT IS A VIOLATION OF THE LAW FOR ANY PERSON TO MAKE UNAUTHORIZED ALTERATIONS OR ADDITIONS TO PLANS. SEALING & LICENSED ARCHITECTS & SURVEYORS ONLY.											

**HUNT** ENGINEERS | ARCHITECTS | SURVEYORS

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BINGHAMTON, NY 607-738-8881 ALBANY, NY 607-738-8801  
WWW.HUNTEAS.COM  
NY CERTIFICATE NO. 0016220 PA CERTIFICATE NO. 15C220013/464-1

FIRST FLOOR DEMOLITION PLAN - AREA C

2025 MIDDLE SCHOOL PHASE III ALTERATIONS PROJECT

CORNING-PAINTED POST ASD

35 VICTORY HIGHWAY, PAINTED POST, NY 14870

**MS-A0.3**

PROJECT NO: 2649-133







THE EXISTING ABUTMENT IS BEING PERFORMED. ASBESTOS CONTAINING MATERIALS ARE PRESENT IN THE ASBESTOS BUILDING. REFER TO AS DRAWINGS & SPECIFICATIONS FOR LOCATIONS AND SCHEDULES FOR REMOVAL OF ASBESTOS. CONTRACTOR SHALL VERIFY THE LOCATION OF ASBESTOS CONTAINING MATERIALS BY TESTING TO THE CONTRACTOR'S REFERENCE. IF SUSPECT MATERIAL NOT SCHEDULED IS ENCOUNTERED, STOP WORK IMMEDIATELY, DO NOT DISTURB THE MATERIAL AND NOTIFY THE OWNER'S REPRESENTATIVE AND THE MAINTAIN EXISTING STRUCTURAL SYSTEMS AT ALL TIMES. PROVIDE TEMPORARY SHORING AND BRACING AT LOCATIONS WHERE THE EXISTING STRUCTURE IS BEING MODIFIED. PROTECT THE EXISTING STRUCTURE FROM COLLAPSE BY PROVIDING SHORING AND BRACING UNTIL THE NEW STRUCTURE IS BARRIED AND READY TO ACCEPT LOADS. CONTRACTOR TO PROVIDE PROTECTIVE BARRIER AT ALL AREAS OF DEMOLITION. KEEP ALL EXITS FREE FROM OBSTRUCTION. CONTRACTOR SHALL MAINTAIN ACCESS TO ALL EXITS AT ALL TIMES. THE OWNER RESERVES THE RIGHT TO RETAIN ANY REMOVED ITEMS AFTER CONTRACTOR REMOVAL. THE CONTRACTOR SHALL REMOVE FROM THE SITE AND DISPOSE OF ALL REMOVED ITEMS THE OWNER DOES NOT WISH TO RETAIN.

REMOVE ALL REMAINS OF SUBSTRATES OF DIFFERENT HEIGHTS IN THE SAME AREA IS REQUIRED AT WALL REMOVALS AND NEW FINISHES IN EX. WALLS TO ALLOW THE NEW FINISHES TO ALIGN BETWEEN ADJACENT ROOMS AND ADJACENT ROOMS THAT BECOME ONE ROOM.

REMOVE ALL EXISTING MATERIALS AND FINISHES TO EXPOSE THE STRUCTURE AND DAMAGE. CONTRACTOR TO COORDINATE THE WORK OF THIS CONTRACT WITH THE WORK OF OTHER TRADES. DIMENSIONS SHOWN FOR ALL NEW OPENINGS IN EXISTING CONSTRUCTION SHOULD BE COORDINATED WITH THE NEW PLANS AND EXISTING CONDITIONS IN THE FIELD.

ROOM NUMBERS INDICATED ON DRAWINGS SHALL BE REFERRED TO NEW FLOOR PLAN (DRAWING SERIES FOR NEW ROOM NUMBERING).

REMOVE EXISTING WOOD BLOCKING FOR EXISTING PENCIL, SHARPENERS, BULLETIN BOARDS ETC. THAT INTERFERE WITH NEW LOCATIONS OR NEW ROOM FINISHES AND WALL TREATMENTS. TYPICAL FOR ALL AREAS SHOWN ARE INTENDED TO GIVE APPROXIMATE QUANTITY, LOCATION AND TYPE. CONTRACTOR RESPONSIBLE FOR VERIFYING ACTUAL QUANTITIES AND EXISTING FIELD CONDITIONS, IN ORDER TO DETERMINE THE ACTUAL QUANTITIES AND LOCATIONS.

COORDINATE ANY WALL PATCHING INFILL THAT IS CAUSED BY THE REMOVAL OF EQUIPMENT IN THE "H," "P," "E," AND "D" TWINGS. AND PREPARE SURFACE TO RECEIVE NEW FINISHES.

INFILL SLOOSR GARDEN WALLS AND FLOOR FINISHING, SEE "D" TWING. PATCH TO MATCH.

PREPARE TO RECEIVE NEW FINISHES.

01 REMOVE LOOSE CONC. PAVING AT TRENCH DRAIN AND PATCH SPALLING AREA W/ CONC. REPAIR PRODUCT.

02 REMOVE EXISTING DOOR, FRAME, AND HARDWARE IN THEIR ENTIRETY TO EXTENDS SHOWN ON PLAN. PATCH

03 DAMAGED SURFACES SCHEDULED TO REMAIN IN PLACE TO MATCH EXISTING CONSTRUCTION AND PREPARE

04 SURFACES TO RECEIVE NEW FINISHES AND DOOR.

05 PATCH DAMAGED SURFACES SCHEDULED TO REMAIN IN PLACE AT DRINKING FOUNTAIN REMOVAL. TO MATCH

06 EXISTING CONSTRUCTION. PREPARE SURFACES FOR NEW INSTALLATION.

07 REPLACE ENTIRE FENCE. PREPARE SURFACES FOR NEW FINISHES.

08 BY ALTERNATE #2, REMOVE EXISTING BLEACHER SYSTEM IN ITS ENTIRETY. PATCH DAMAGED SURFACES SCHEDULED

09 TO REMAIN IN PLACE. PREPARE SURFACES FOR NEW INSTALLATION.

10 REMOVE EXISTING BASKETBALL BACKSPOUS. PREPARE FOR NEW INSTALLATION.

11 REMOVE EXISTING SCORE BOARD. PATCH DAMAGED SURFACES TO REMAIN. PREPARE SURFACES FOR NEW SCORE

12 BOARD INSTALLATION.

13 REMOVE LVIT VOT FLOORING. PATCH DAMAGED SURFACES DISTURBED BY DEMOLITION. PREPARE CONCRETE SLAB

14 FOR INSTALLATION OF NEW FINISHES.

15 REMOVE EXISTING CONC. SLAB AS INDICATED BY HATCH. COORD. WITH "A" & "D" W/INGS.

16 REMOVE EXISTING CEILING SYSTEM AND ALL SUPPORTING STRUCTURE. ADJUST JOISTS, AND SOFFITS IN THEIR

17 ENTIRETY TO EXTENDS SHOWN ON PLAN. REPAIR ALL DAMAGED SURFACES SCHEDULED TO REMAIN. PREPARE

18 FOR NEW INSTALLATION.

19 REMOVE EXISTING STOREFRONT SYSTEM IN THEIR ENTIRETY TO EXTENDS SHOWN ON PLAN. PATCH DAMAGED

20 SURFACES SCHEDULED TO REMAIN IN PLACE TO MATCH EXISTING CONSTRUCTION. CLEAN AND SCRAPE STEEL

21 LIFTELS TO REMOVE LOOSE PAINT AND ALL RUST. PATCH EXISTING SURFACES TO RECEIVE NEW FINISHES.

22 REMOVE EXISTING WHITEBOARD. PATCH DAMAGED SURFACES SCHEDULED TO REMAIN. PREPARE

23 SURFACES FOR NEW WHITEBOARD INSTALLATION.

24 REMOVE DOOR HARDWARE. PREPARE DOOR FOR NEW HARDWARE. DOOR AND FRAME TO REMAIN.

25 BY ALTERNATE #2, REMOVE EXISTING WALL TILES IN THEIR ENTIRETY. PATCH DAMAGED SURFACES SCHEDULED TO

26 REMAIN IN PLACE. PREPARE SURFACES FOR NEW FINISHES.

27 REMOVE ALL LOOSE CONCRETE AND ALL PATCHING MATERIAL. CLEAN EXPOSED REINFORCING TO REMOVE RUST

28 AND PATCH WITH A VERTICAL OR OVERHEAD CONCRETE PATCH B.O.D. SIA. PATCH SURFACES 223 TO PREVENT ADDITIONAL

29 REINFORCEMENT.

30 REMOVE EXISTING FACADE AT VEREADICE FACE OF CANOPY. PATCH DAMAGED SURFACES SCHEDULED TO REMAIN IN

31 PLACE. PREPARE SURFACES FOR NEW FINISH INSTALLATION.

32 REMOVE CERAMIC TILE FLOORING. PATCH ADJACENT SURFACES DISTURBED BY DEMOLITION. PREPARE CONCRETE

33 SLAB FOR INSTALLATION OF NEW FINISHES.

34 REMOVE EXISTING STOREFRONT SYSTEM IN ITS ENTIRETY. PREPARE SURFACES FOR NEW STOREFRONT SYSTEM.

35 REFER TO ACCESSIBS ABATEMENT PLAN FOR BACKSTOP REMOVAL.

36 REMOVE PORTION OF EXISTING FLOOR SLAB AS NEEDED FOR POOL. GUTTER SYSTEM INSTALLATION. COORDINATE

37 WITH NEW CONSTRUCTION.

38 REMOVE EXISTING FIRE SHUTTER ASSEMBLY IN ITS ENTIRETY. PREPARE FOR WALL INFLU AND NEW FINISHES.

39 REMOVE EXISTING CMU TOILET PARTITIONS IN THEIR ENTIRETY. PREPARE FOR NEW CONSTRUCTION.

40 REMOVE EXISTING HANDRAIL AND PREPARE FOR NEW

41 REMOVE EXISTING CLO PARTITION TO W/CH. PREPARE FOR NEW CONSTRUCTION.

42 PROTECT IN PLACE AERIOBLED CONTROL STATION.

43 REMOVE SOFFIT PLASTER AND LIGHT.

44 REMOVE (2) LAYERS OF EXISTING WALL TILE AT CORRIDOR WALL AND PREPARE FOR NEW FINISHES. PROTECT ALL

45 ADJACENT FINISHES TO REMAIN.

46 REMOVE EXPOSED FLOORING AND WALL, BASE IN ITS ENTIRETY AND PREPARE FOR NEW FLOOR FINISH.

47 REMOVE TUBING WALL PANELS AND PREPARE FOR NEW FINISHES.

48 REMOVE DETACHED BOARDS AND STARTER BLOCKS AND PREPARE FOR NEW IN SAME LOCATION.

49 DISCONNECT AND REMOVE ALL KITCHEN EQUIPMENT WITH CARE AND STORE FOR REINSTALLATION, INCLUDING BUT

50 NOT LIMITED TO: REFRIGERATORS, FREEZERS, DISHWASHERS, REFRIGERATOR FREEZERS.

51 REMOVE, SALVAGE STORE AND PROTECT EXISTING BUILT-IN CASEWORKS/SHELVING UNITS AND ASSOCIATED WORK

52 SURFACES AS REQUIRED FOR FLOORING REPLACEMENT. CASEWORK AND ACCESSORIES TO BE REINSTALLED IN

53 PLACE. RETAINING WALLS TO REMAIN. PATCH DAMAGED SURFACES SCHEDULED TO REMAIN IN PLACE TO MATCH EXISTING

54 CONSTRUCTION AND PREPARE SURFACES TO RECEIVE NEW FINISHES.

55 REMOVE EXISTING CONCRETE FLOOR TO ACCOMMODATE NEW T2 IN FILL.

56 REMOVE WINDOW, FRAME, HARDWARE, AND WINDOW TREATMENT SYSTEMS IN THEIR ENTIRETY. REPAIR DAMAGED

57 SURFACES SCHEDULED TO REMAIN IN PLACE TO MATCH EXISTING CONSTRUCTION AND PREPARE SURFACES TO

58 RECEIVE NEW FINISHES.

59 REMOVE POOL FLOOR SLAB AND FOUNDATION AT THE SHALLOW END AS SHOWN AND PREPARE FOR NEW FLOOR

60 SLAB AND FOUNDATION AT A NEW DEPTH. COORDINATE WITH PROPOSED FLOOR PLAN AND DETAILS.

61 REMOVE POOL FLOOR. REMOVE BALCONY FLOOR. REMOVE EXISTING RAILINGS.

62 REMOVE PORTION OF EX. CEILING AS REQUIRED FOR DEMOLITION OF ADJACENT COMPONENTS.

63 REMOVE POOL WALL, IN ITS ENTIRETY TO PREPARE FOR NEW POOL FLOOR OR NEW POOL RAMP. REFER TO NEW

64 CONSTRUCTION PLANS FOR ADDITIONAL INFORMATION.

65 REMOVE POOL FLOOR. PATCH DAMAGED SURFACES SHOWN ON PLAN TO ACCOMMODATE NEW RAMP. REFER TO NEW

66 CONSTRUCTION PLAN FOR ADDITIONAL INFORMATION.

67 TRENCH PORTION OF FLOOR AS SHOWN FOR NEW TRENCH DRAIN. COORDINATE WITH PLUMBING DRAWINGS

68 REMOVE +/-3" OF POOL WALL DOWN FROM FINISHED FLOOR AND PREPARE TO REBUILD. COORDINATE W/ ARCH

69 DRAWINGS AND DETAILS.

70 REMOVE WITH CARE AND SALVAGE CEILING TILES AND SECONDARY RAILINGS IN SAFE LOCATION FOR LATER

71 REINSTALLATION AS REQUIRED FOR HVAC SCOPE. SEE "H" DWGS

72 REMOVE EXISTING LOCKERS IN THEIR ENTIRETY. CLEAN AND REPAIR TERRAZZO FLOOR IMPACTED BY LOCKER

73 REMOVAL. AS NEEDED.

74 REMOVE EXISTING LOCKERS, ACCESSORIES, AND BENCH SEATING IN THEIR ENTIRETY. PATCH FLOOR AS REQUIRED

75 FOR SMOOTH FINISH. PREPARE FOR FLOOR FINISH PATCHING.

76 REMOVE EXISTING CONCRETE SLAB TO ACCOMMODATE NEW FLOOR. PATCH EXISTING FLOOR EXTENTS FOR NEW PLUMBING.

77 REMOVE COUNTERTOP HEIGHT OVER HEAD DOOR, COUNTER, AND ALL ASSOCIATED ACCESSORIES.

78 REMOVE EXISTING POOL FINISHES INCLUDING BUT NOT LIMITED TO THE RACING LINES, THE MARKINGS, AND BOTH

79 LAYERS OF MARCITE WITHIN THE SWIMMING POOL IN ITS ENTIRETY. PREPARE SURFACES TO RECEIVE NEW

80 FINISHES.

81 REMOVE PORTION OF CMU WALL TO ACCOMMODATE NEW PLUMBING LAYOUT

82 REMOVE EXISTING TOILET PARTITIONS, ASSOCIATED BRACING, ACCESSORIES AND ALL WALL MOUNTED ITEMS

83 INCLUDING, BUT NOT LIMITED TO MIRRORS, SOAP DISPENSERS, GRAB BARS, ETC. PREPARE FLOOR AND WALL

84 SURFACES FOR NEW FINISHES.


85 REMOVE, SALVAGE AND PROTECT CEILING GRID AS REQUIRED FOR WALL FINISH SCOPE.

86 REMOVE CASEWORK AND ASSOCIATED ACCESSORIES IN ITS ENTIRETY. REPAIR DAMAGED SURFACES SCHEDULED TO

87 REMAIN.

88 REMOVE BASKETBALL BACKBOARD AND ASSOCIATED HARDWARE. EXISTING BACKSTOP FRAMING TO REMAIN.

89 REMOVE COUNTERTOP, SALVAGE AND SAFETY STORE CASEWORK BENEATH FOR LATER REINSTALLATION.

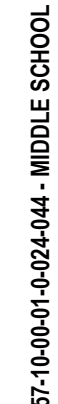

35 VICTORY HIGHWAY, PAINTED POST, NY 14870

NY CERTIFICATE NO. 0018220 PA CERTIFICATE NO. TSC2203131464-1

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GENERAL NOTES:

- A. EXTEND ALL PARTITIONS TO DECK ABOVE UNLESS NOTED OTHERWISE. INSTALL FIRE STOPPING AT DECK FLUTES IN AREAS OF METAL DECKING WHERE FIRE SEPARATION IS REQUIRED.
- B. ALL PENETRATIONS THROUGH FIRE RATED PARTITIONS TO BE SEALED W APPROVED U.L. FIRE RATED ASSEMBLIES.
- C. FILL ALL VOIDS AND IMPERFECTIONS IN WALLS AND FLOORS CREATED BY DEMOLITION. PATCH TO MATCH EXISTING & PREPARE TO RECEIVE NEW FINISHES.
- D. ALL NEW DOOR FRAMES INSTALLED IN METAL STUD SHALL BE MOUNTED 4" FROM ADJACENT WALLS (6" TO DOOR), UNLESS NOTED OTHERWISE.
- E. INSTALL SOLID WOOD BLOCKING IN METAL STUD WALLS AT ALL AREAS OF CASEWORK, TACK/MARKER BOARDS, TOILET ACCESSORIES AND ALL WALL MOUNTED EQUIPMENT AND ACCESSORIES.
- F. ALL NEW INTERIOR PARTITIONS TO BE TYPE 1 UNLESS NOTED OTHERWISE.
- G. ALL NEW DOORS TO BE WOOD WITH HOLLOW METAL FRAME UNLESS NOTED OTHERWISE.

GENERAL NOTES:




- H. ITEMS SHOWN ARE INTENDED TO GIVE APPROXIMATE QUANTITY, LOCATION & TYPE. THE CONTRACTOR IS RESPONSIBLE FOR VERIFYING ACTUAL QUANTITY & EXISTING FIELD CONDITIONS.
- I. VERIFY WITH OWNER EXACT SIZE OF ALL EQUIPMENT FURNISHED BY OWNER FOR PROPER FIT WITH CONTRACTOR SUPPLIED CASEWORK AND MILWORK.
- J. ALL DIMENSIONS ARE TAKEN FROM FACE OF WALL TO FACE OF WALL, UNLESS NOTED OTHERWISE.
- K. THERE SHALL BE A MINIMUM OF 1'-6" CLEAR FLOOR SPACE ON THE PULL SIDE OF ALL NEW DOORS; THERE SHALL BE A MINIMUM OF 1'-0" CLEAR FLOOR SPACE ON THE PUSH SIDE OF ALL NEW DOORS.
- L. THE WHEELCHAIR SYMBOL INDICATES HANDICAP ACCESSIBLE FIXTURE AND SHALL CONFORM WITH CABOJANSI A117.1 AND ADAAG.
- M. CONTRACTOR TO PROVIDE RESCUE WINDOW LABELS AT ALL NEW WINDOW LOCATION AS INDICATED ON SHEET C01.1.

PLAN DRAWING NOTES:

1. PATCH WALL AT EXPOSED REBAR WITH CONCRETE TO MATCH, APPROXIMATELY 4 LF.
2. REPAIR MASONRY WALL CRACKING. RAKE LOOSE MORTAR AND REPOINT MORTAR JOINTS.
3. REPAIR ELASTOMERIC CAULK TO SEAL SEPARATIONS AS REQ.
4. REPAIR SPALLING CONCRETE AT FLOOR. PATCH WITH (SIKA REPAIR 222) FOR CONCRETE, APPROXIMATELY 14 SF.
5. FURNISH WALL PADS FOR ABATEMENT CONTRACTOR TO INSTALL. ABATEMENT CONTRACTOR TO PATCH AND REFINISH WALLS TO MATCH EXG. CONSTRUCTION AS REQUIRED.
6. PROVIDE DIVING BOARD AND STAND AS SHOWN. REFERENCE SPECIFICATION SECTION 13 11 00 FOR MORE INFORMATION.
7. CLEAN AND PAINT EXISTING HANDRAIL.
8. CLEAN AND PAINT EXISTING LINTEL.
9. APPROXIMATE AREA OF FLOOR CRACKING PROVIDE CONTROL JOINT. VERIFY EXTENTS IN FIELD. REFER TO INTERIOR FINISH DRAWINGS.
10. PROVIDE POWDER COATED METAL FENCE AS SHOWN.
11. BY ALTERNATE #2. SAND AND FINISH FLOOR UNDER BLEACHER TYP.
12. PROVIDE BASKETBALL BACKSTOP WITH GLASS BACKBOARDS.
13. PROVIDE LED SCORE BOARD.
14. PROVIDE NEW ZINC PLATED SUB STRUCTURE, POWDER COATED STES, ALUMINUM DECK, STAINLESS STEEL FASTENERS, MANUAL TELESCOPIC BLEACHER AND HANDRAIL SYSTEM IN COMPLIANCE WITH ADA.
15. PRIME AND PAINT STEEL LINTELS WITH CHLORINE CORROSION RESISTANT PAINT.
16. PROVIDE PRE ENGINEERED CANOPY. SEE SPECIFICATION SECTION
17. PROVIDE SLEEVE FOR BACKSTROKE MARKER POSTS
18. PROVIDE RACING LANE ANCHORS

PLAN DRAWING NOTES:

20. PROVIDE STL GAUDDRAIL FASTENED TO EXG CURB. SEE REF. DETAILS ON PLAN.
22. PROVIDE CASEWORK. SEE INTERIOR ELEVATIONS AND CASEWORK SCHEDULE FOR ADDITIONAL INFORMATION.
23. PROVIDE ADA TOILET ACCESSORIES INCLUDING BUT NOT LIMITED TO HANDRAILS, TOILET TISSUE DISPENSERS, PAPER TOWEL DISPENSORS, GRAB BARS, PARTITIONS, SANITARY WASTE BINS, MIRRORS, SOAP DISPENSERS, ETC. PROVIDE BLOCKING AT ALL WALL MOUNTED ACCESSORIES.
24. PROVIDE MISSING EXPANSION JOINT COVER AS NEEDED ON WALL AND/OR FLOOR SURFACE. COVER TO MATCH EXISTING ASSEMBLY.
25. SCOREBOARD SHOWN FOR REFERENCE. COORD. WITH "E" DWGS.
26. RECAULK CONTROL JOINTS BETWEEN VERTICAL FINS AND BUILDING FAÇADE, APPROXIMATELY 350 LF.
27. REFER TO TRADES FOR ACCESS CONTROL, MODIFY WALL AS REQUIRED, PATCH AND MATCH ADJ. FINISHES AS REQUIRED.
28. INFILL WALL OPENING AS SHOWN ON PLAN TO MATCH EXISTING WALL THICKNESS AND PREPARE FOR NEW FINISHES.
29. INFILL PATCH AND REFINISH WALL AT AREA OF REMOVED DRINKING FOUNTAIN
30. REPOINT THE BOTTOM 3 COURSES OF FACEBRICK
31. BY ALTERNATE #2. PROVIDE NEW MOTORIZED BLEACHER AND HANDRAIL SYSTEM IN COMPLIANCE WITH ADA.
32. SURFACED MOUNTED SHOWER SHOWN FOR REFERENCE. COORD. WITH "P" DWGS
33. PROVIDE STARTING PLATFORM. REFER TO SPECIFICATION SECTION 13 11 00.
34. PROVIDE METAL SOFFIT AND RECESSED LIGHT
35. BY ALTERNATE #3. PROVIDE VENTILATED POOL EQUIPMENT STORAGE UNITS.
36. PROVIDE DOWNSPOUT ATTACHED TO GUTTER SYSTEM ABOVE. SEE "L" DWGS FOR TIE-IN COORDINATION.
37. PROVIDE WALL MOUNTED BACKSTOP. SEE SPECIFICATIONS.
38. PROVIDE P-LAM COUNTERTOP. REINSTALL BENEATH COUNTERTOP PREVIOUSLY SALVAGED CASEWORK. MODIFY CASEWORK AS NECESSARY TO ACCOMMODATE HVAC WORK.
39. PROVIDE SWIMSUIT DRYER UNIT. SEE SPECIFICATIONS AND COORD. WITH "E" DWGS.

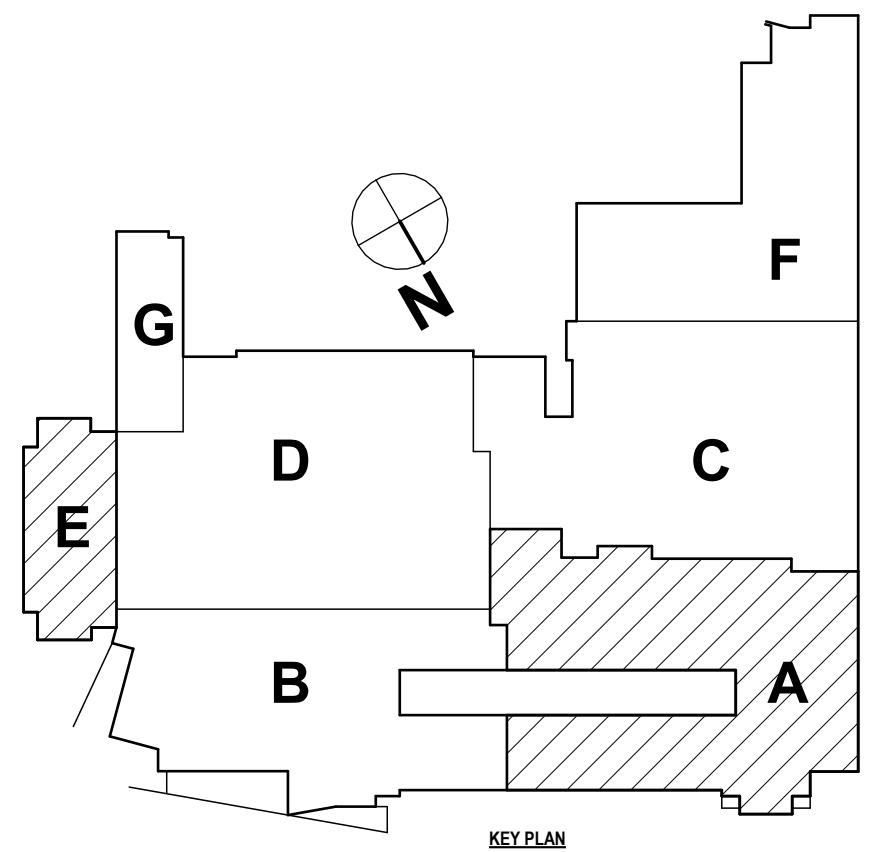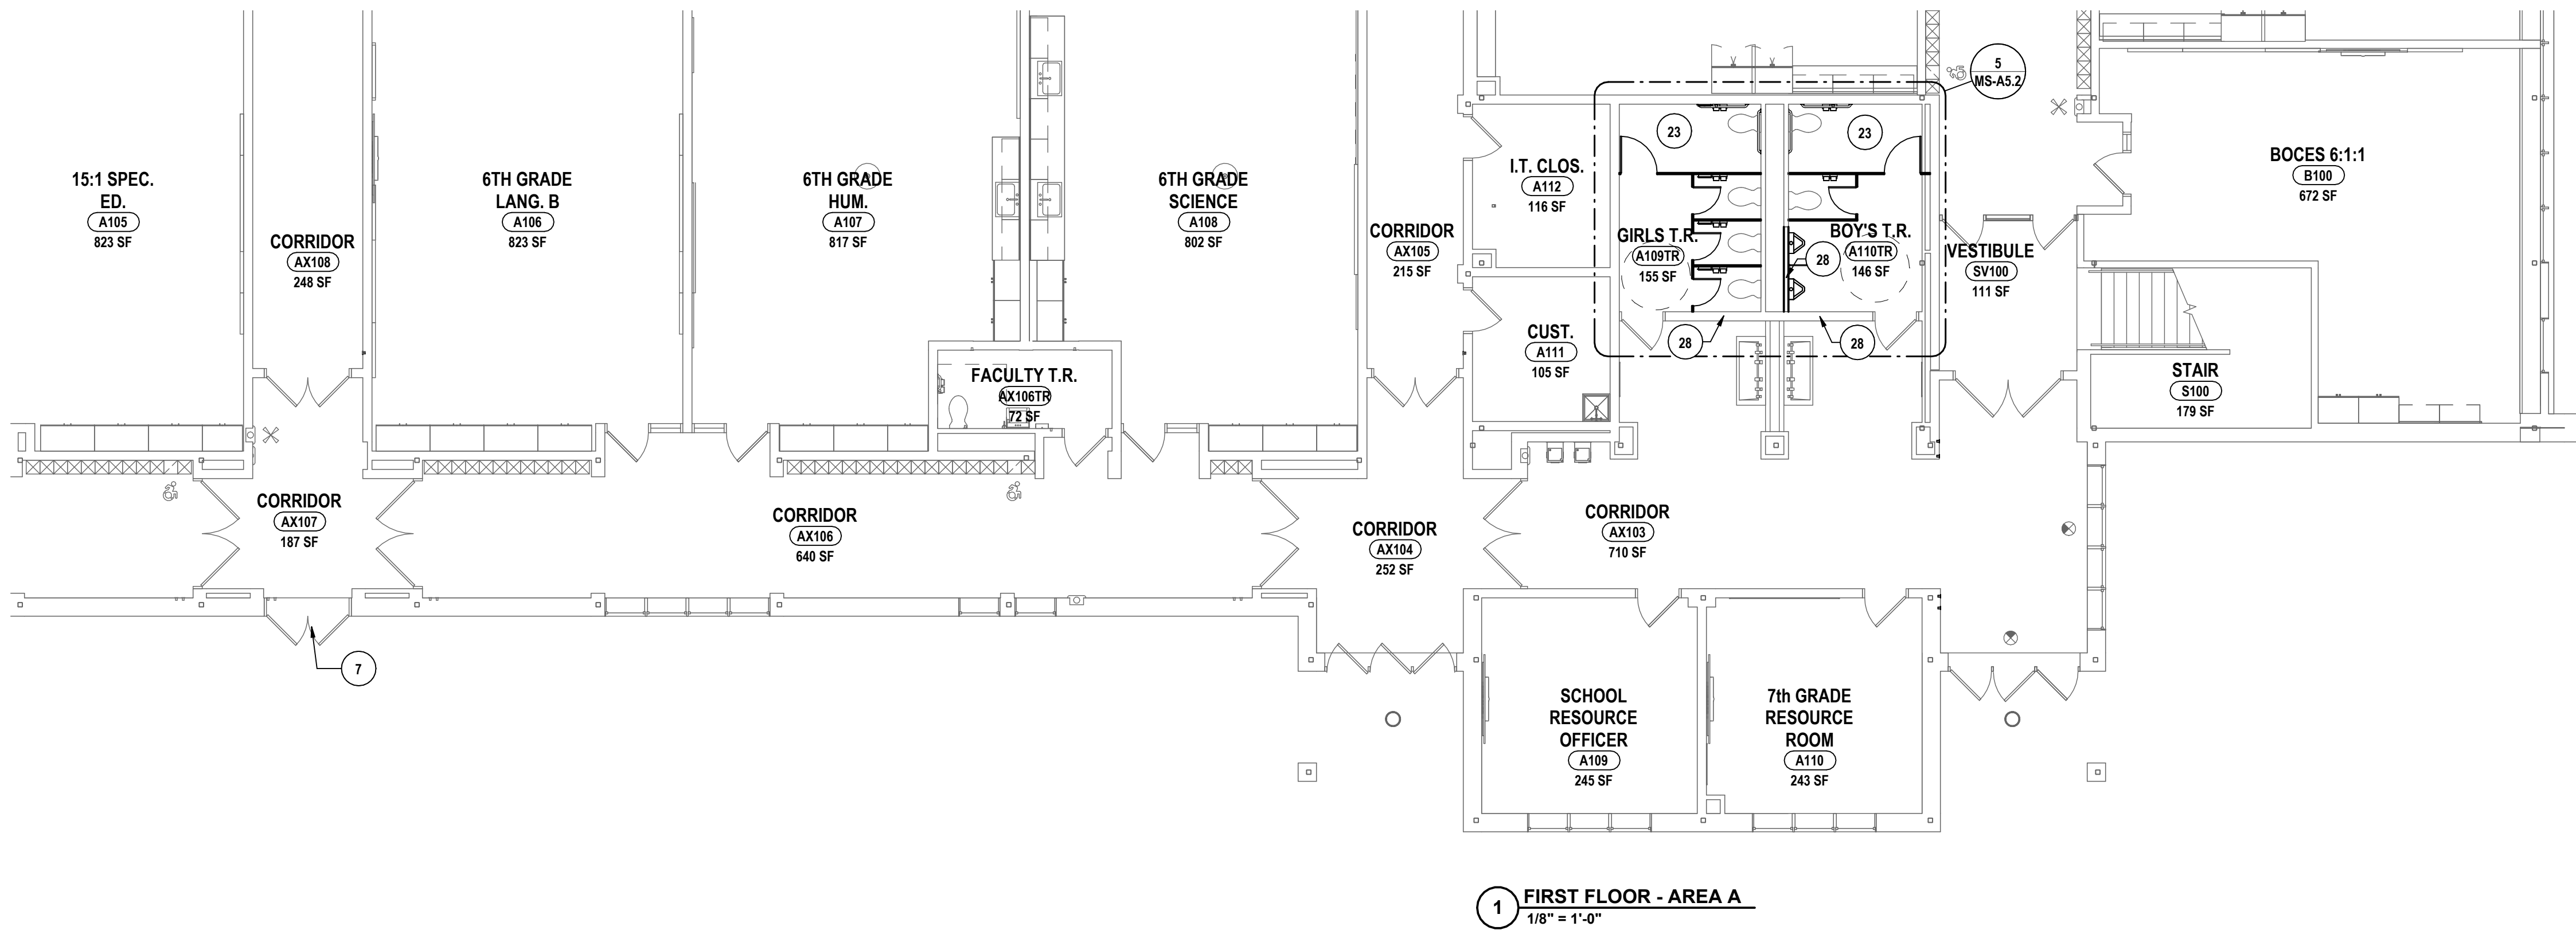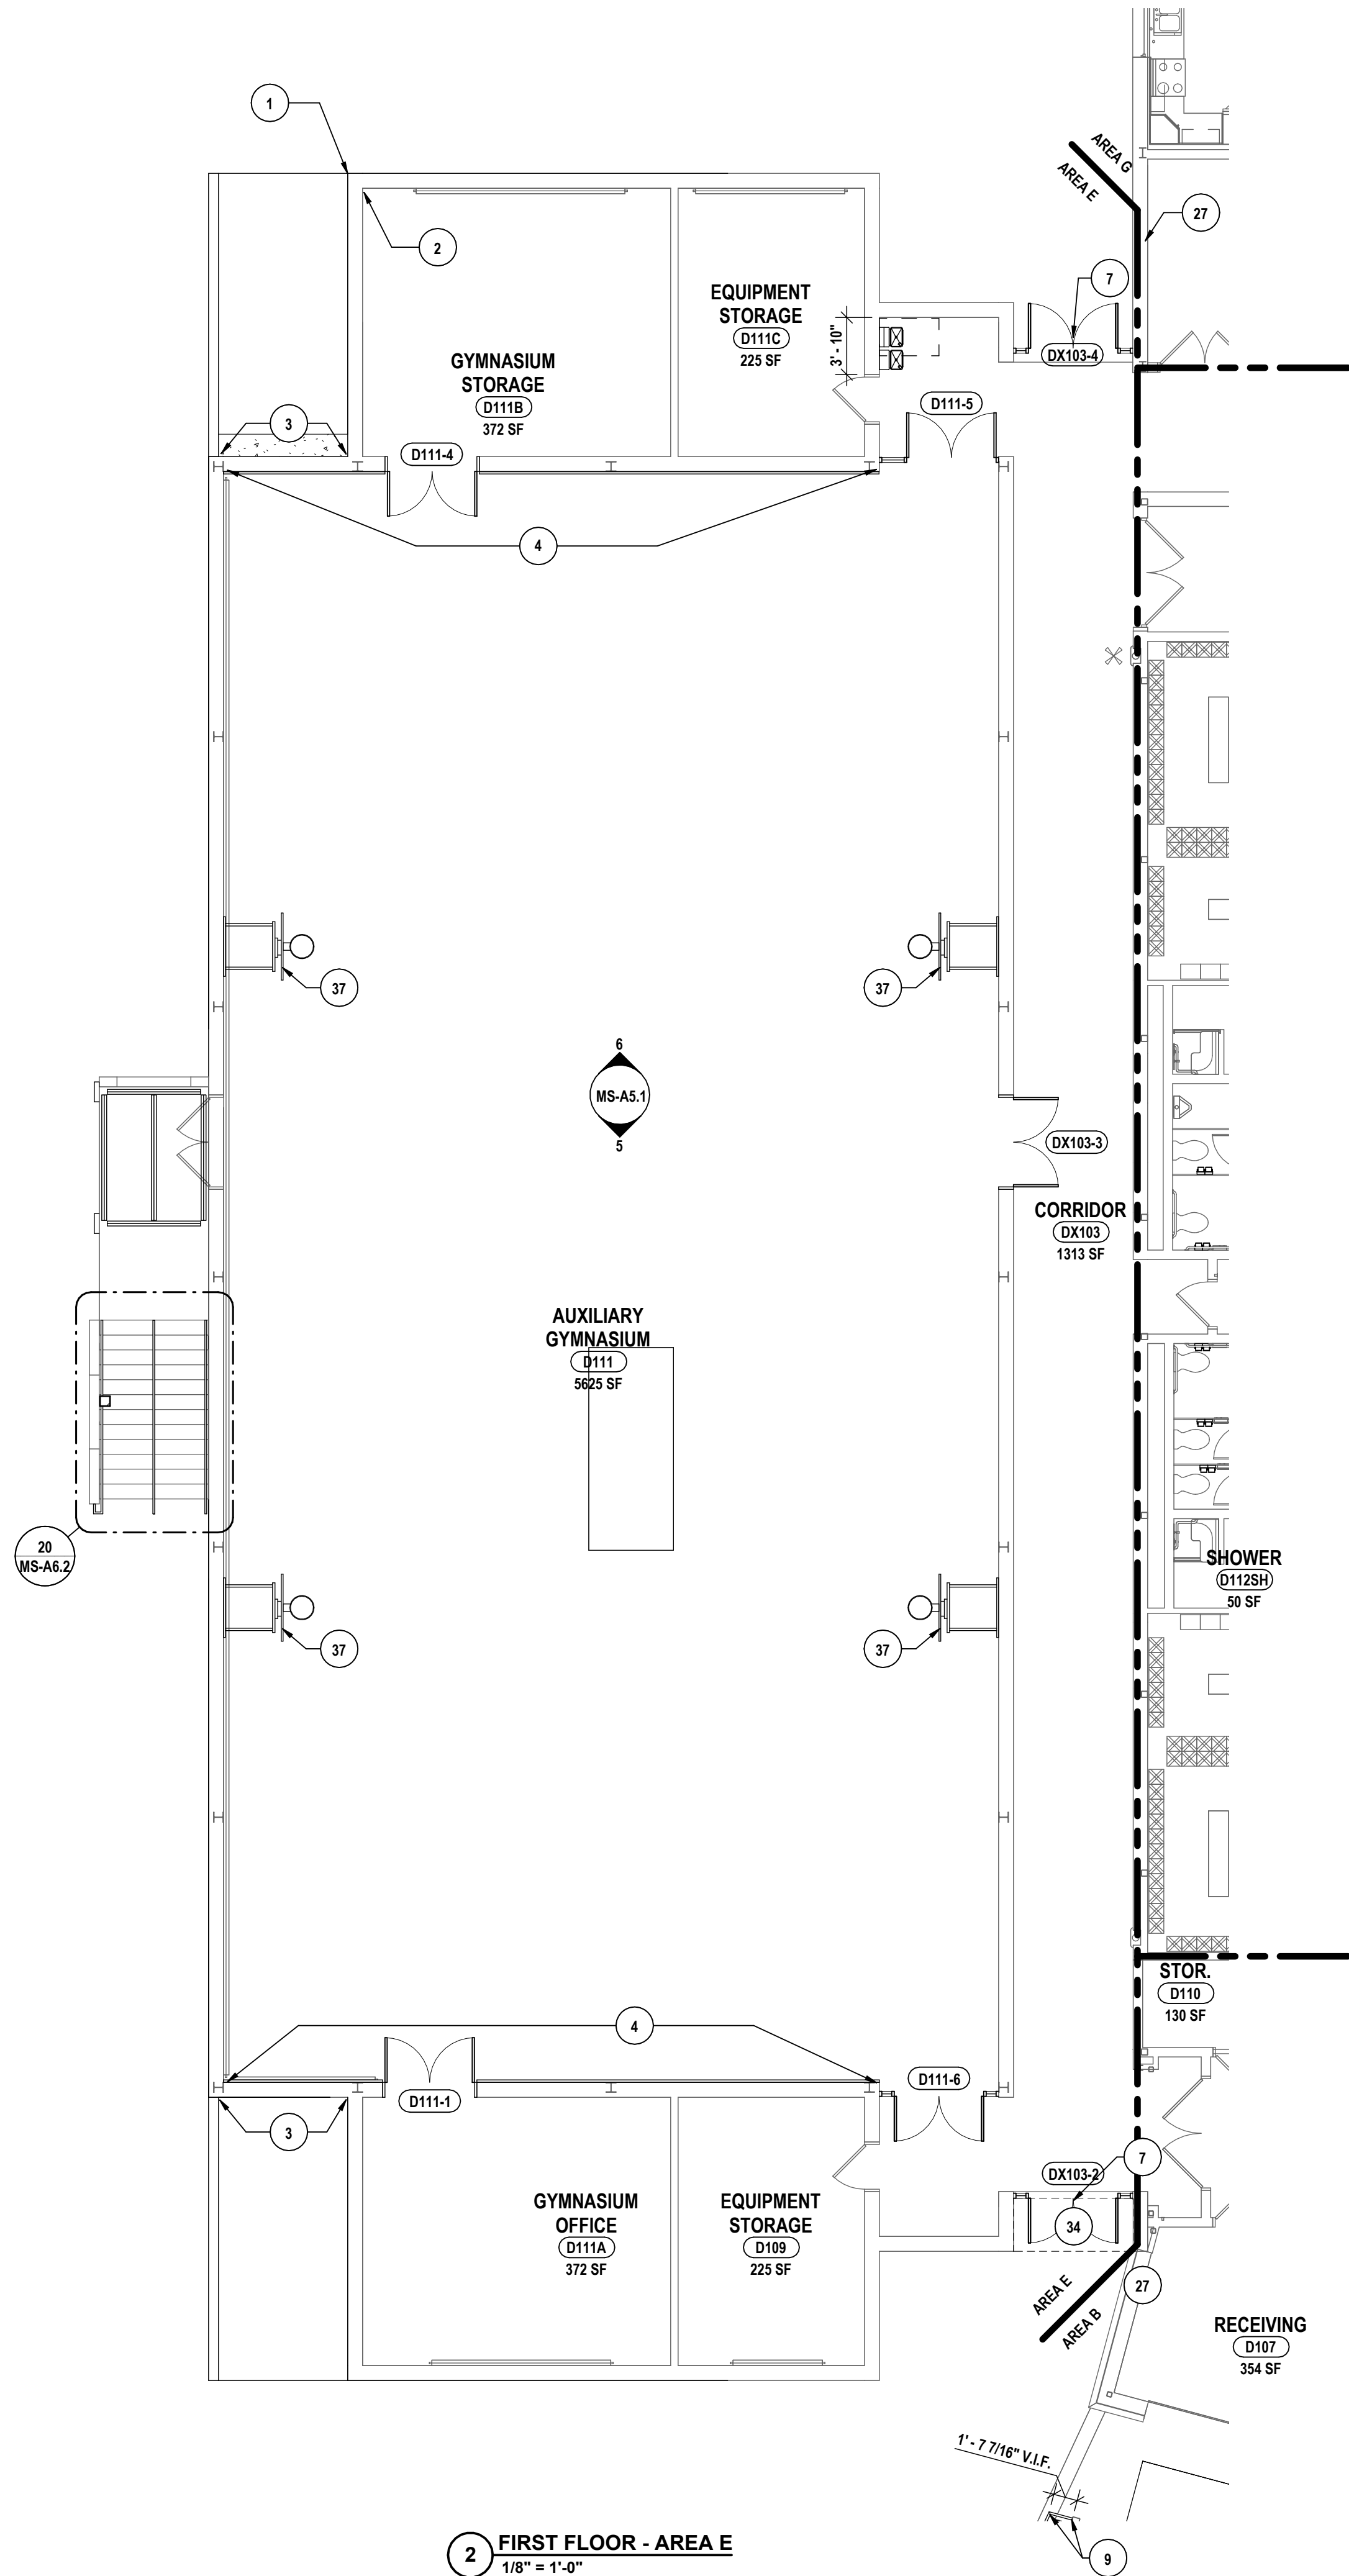

57-10-00-01-002-044 - MIDDLE SCHOOL

FIRST FLOOR PLAN - AREA A & E

2025 MIDDLE SCHOOL PHASE III ALTERATIONS PROJECT

CORNING-PAINTED POST ASD

35 VICTORY HIGHWAY, PAINTED POST, NY 14870

HUNT ENGINEERS | ARCHITECTS | SURVEYORS

HORSEHEADS, NY 607-263-1000 ROCHESTER, NY 585-237-7668 TOWNAND, PA 570-265-4606

BINGHAMTON, NY 607-798-8881 ALBANY, NY 607-798-8801

WWW.HUNT-EAS.COM

NY CERTIFICATE NO. 0016220 PA CERTIFICATE NO. TSC2202013464-1

MS-A1.1

PROJECT NO: 2649-153

DATE: 11/03/2025

DESCRIPTION OF REVISION: ISSUED FOR BID

# 1

DATE: 05/09/2025

CHECKED BY: MS

PHASE: CD

DRAWN BY: PSF

11" IS A VIOLATION OF THE LAW FOR ANY PERSON TO MAKE UNAUTHORIZED ALTERATIONS OR ADDITIONS TO PLANS

SEALING & LICENSING REQUIREMENTS: CONTRACTORS MUST SEAL THEIR OWN WORK

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SEALING & LICENSING REQUIREMENTS: CONTRACTORS MUST SEAL THEIR OWN WORK



GENERAL NOTES:

- A EXTEND ALL PARTITIONS TO DECK ABOVE UNLESS NOTED OTHERWISE. INSTALL FIRE STOPPING AT DECK FLUTES IN AREAS OF METAL DECKING WHERE FIRE SEPARATION IS REQUIRED.
- B ALL PENETRATIONS THROUGH FIRE RATED PARTITIONS TO BE SEALED W/ APPROVED U.L. FIRE RATED ASSEMBLIES.
- C FILL ALL VOIDS AND IMPERFECTIONS IN WALLS AND FLOORS CREATED BY DEMOLITION. PATCH TO MATCH EXISTING & PREPARE TO RECEIVE NEW FINISHES.
- D ALL NEW DOOR FRAMES INSTALLED IN METAL STUD SHALL BE MOUNTED 4" FROM ADJACENT WALLS (8" TO DOOR), UNLESS NOTED OTHERWISE.
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- F ALL NEW INTERIOR PARTITIONS TO BE TYPE 1 UNLESS NOTED OTHERWISE.
- G ALL NEW DOORS TO BE WOOD WITH HOLLOW METAL FRAME UNLESS NOTED OTHERWISE.

GENERAL NOTES:


- H ITEMS SHOWN ARE INTENDED TO GIVE APPROXIMATE QUANTITY, LOCATION & TYPE. THE CONTRACTOR IS RESPONSIBLE FOR VERIFYING ACTUAL QUANTITY & EXISTING FIELD CONDITIONS.
- I VERIFY WITH OWNER EXACT SIZE OF ALL EQUIPMENT FURNISHED BY OWNER FOR PROPER FIT WITH CONTRACTOR SUPPLIED CASEWORK AND MILLWORK.
- J ALL DIMENSIONS ARE TAKEN FROM FACE OF WALL TO FACE OF WALL, UNLESS NOTED OTHERWISE.
- K THERE SHALL BE A MINIMUM OF 1'-6" CLEAR FLOOR SPACE ON THE PULL SIDE OF ALL NEW DOORS, THERE SHALL BE A MINIMUM OF 1'-0" CLEAR FLOOR SPACE ON THE PUSH SIDE OF ALL NEW DOORS.
- L THE WHEELCHAIR SYMBOL INDICATES HANDICAP ACCESSIBLE FIXTURE AND SHALL CONFORM WITH CABOIAN/ANSI A117.1 AND ADAAG.
- M CONTRACTOR TO PROVIDE RESCUE WINDOW LABELS AT ALL NEW WINDOW LOCATION AS INDICATED ON SHEET CD1.1.

PLAN DRAWING NOTES:


- 1 PATCH WALL AT EXPOSED REBAR WITH CONCRETE TO MATCH, APPROXIMATELY 4 LF.
- 2 REPAIR MASONRY WALL CRACKING: RAKE LOOSE MORTAR AND REPOINT MORTAR JOINTS. PROVIDE ELASTOMERIC CAULK TO SEAL SEPARATIONS AS REQ.
- 3 REPAIR SPALLING CONCRETE AT FLOOR. PATCH WITH (SIKA REPAIR 222) FOR CONCRETE, APPROXIMATELY 14 SF.
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- 5 PROVIDE DIVING BOARD AND STAND AS SHOWN. REFERENCE SPECIFICATION SECTION 13 11 00 FOR MORE INFORMATION.
- 6 CLEAN AND PAINT EXISTING HANDRAIL.
- 7 CLEAN AND PAINT EXISTING LINTEL.
- 8 APPROXIMATE AREA OF FLOOR CRACKING PROVIDE CONTROL JOINT. VERIFY EXTENTS IN FIELD. REFER TO INTERIOR FINISH DRAWINGS.
- 9 PROVIDE POWDER COATED METAL FENCE AS SHOWN.
- 10 BY ALTERNATE #2, SAND AND FINISH FLOOR UNDER BLEACHER TYP.
- 12 PROVIDE BASKETBALL BACKSTOP WITH GLASS BACKBOARDS.
- 13 PROVIDE LED SCORE BOARD.
- 14 PROVIDE NEW ZINC PLATED SUB STRUCTURE, POWDER COATED STES, ALUMINUM DECK, STAINLESS STEEL FASTENERS, MANUAL TELESCOPIC BLEACHER AND HANDRAIL SYSTEM IN COMPLIANCE WITH ADA.
- 15 PRIME AND PAINT STEEL LINELS WITH CHLORINE CORROSION RESISTANT PAINT.
- 16 PROVIDE PRE ENGINEERED CANOPY. SEE SPECIFICATION SECTION
- 17 PROVIDE SLEEVE FOR BACKSTROKE MARKER POSTS
- 19 PROVIDE RACING LANE ANCHORS

PLAN DRAWING NOTES:

- 20 PROVIDE STL GAUDDRAIL FASTENED TO EXG CURB. SEE REF. DETAILS ON PLAN.
- 22 PROVIDE CASEWORK. SEE INTERIOR ELEVATIONS AND CASEWORK SCHEDULE FOR ADDITIONAL INFORMATION.
- 23 PROVIDE ADA TOILET ACCESSORIES INCLUDING BUT NOT LIMITED TO HANDRAILS, TOILET TISSUE DISPENSERS, PAPER TOWEL DISPENSERS, GRAB BARS, PARTITIONS, SANITARY WASTE BINS, MIRRORS, SOAP DISPENSERS, ETC. PROVIDE BLOCKING AT ALL WALL MOUNTED ACCESSORIES.
- 24 PROVIDE MISSING EXPANSION JOINT COVER AS NEEDED ON WALL AND/OR FLOOR SURFACE. COVER TO MATCH EXISTING ASSEMBLY.
- 25 SCOREBOARD SHOWN FOR REFERENCE. COORD. WITH "E" DWGS.
- 26 RECAULK CONTROL JOINTS BETWEEN VERTICAL FINS AND BUILDING FAÇADE, APPROXIMATELY 350 LF.
- 27 REFER TO TRADES FOR ACCESS CONTROL. MODIFY WALL AS REQUIRED, PATCH AND MATCH ADJ. FINISHES AS REQUIRED.
- 28 INFILL WALL OPENING AS SHOWN ON PLAN TO MATCH EXISTING WALL THICKNESS AND PREPARE FOR NEW FINISHES.
- 29 INFILL PATCH AND REFINISH WALL AT AREA OF REMOVED DRINKING FOUNTAIN
- 30 REPOINT THE BOTTOM 3 COURSES OF FACEBRICK
- 31 BY ALTERNATE #2, PROVIDE NEW MOTORIZED BLEACHER AND HANDRAIL SYSTEM IN COMPLIANCE WITH ADA.
- 32 SURFACED MOUNTED SHOWER SHOWN FOR REFERENCE. COORD. WITH "PP" DWGS
- 33 PROVIDE STARTING PLATFORM. REFER TO SPECIFICATION SECTION 13 11 00.
- 34 PROVIDE METAL SOFFIT AND RECESSED LIGHT
- 35 BY ALTERNATE #3, PROVIDE VENTILATED POOL EQUIPMENT STORAGE UNITS.
- 36 PROVIDE DOWNSPOUT ATTACHED TO GUTTER SYSTEM ABOVE. SEE "L" DWGS FOR TIE-IN COORDINATION.
- 37 PROVIDE WALL MOUNTED BACKSTOP. SEE SPECIFICATIONS.
- 38 PROVIDE P-LAM COUNTERTOP. REINSTALL BENEATH COUNTERTOP PREVIOUSLY SALVAGED CASEWORK. MODIFY CASEWORK AS NECESSARY TO ACCOMMODATE HVAC WORK.
- 39 PROVIDE SWIMSUIT DRYER UNIT. SEE SPECIFICATIONS AND COORD. WITH "E" DWGS.

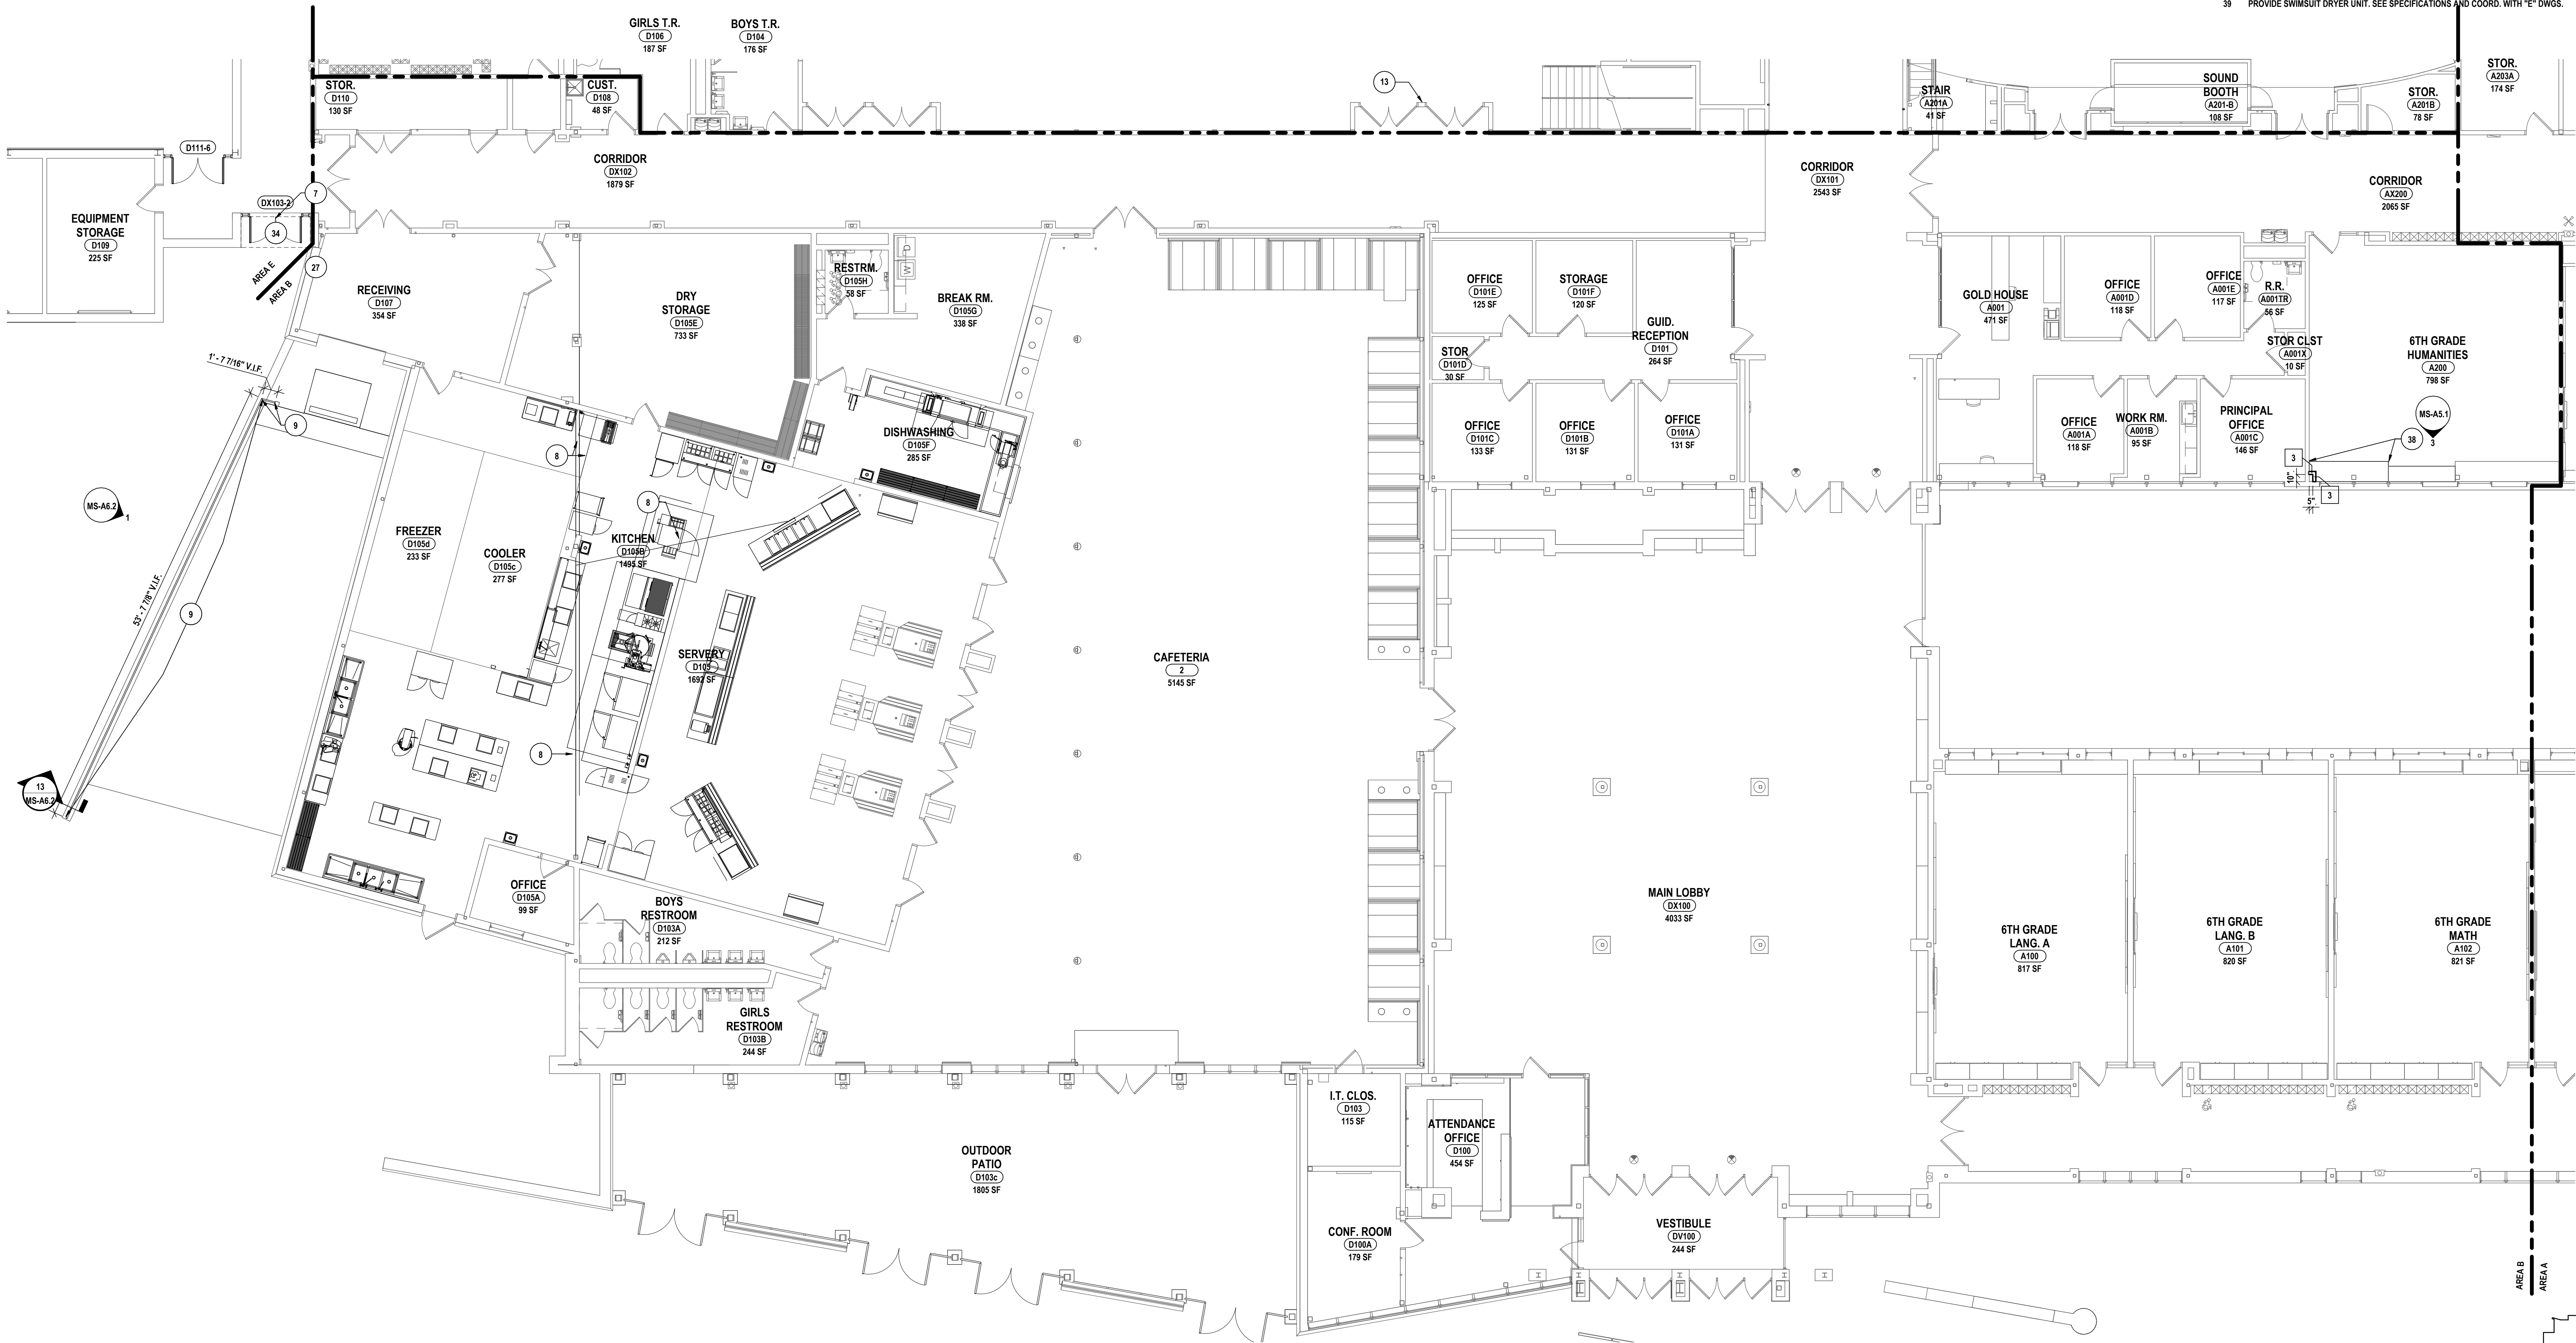

1 FIRST FLOOR - AREA B  
1/8" = 1'-0"

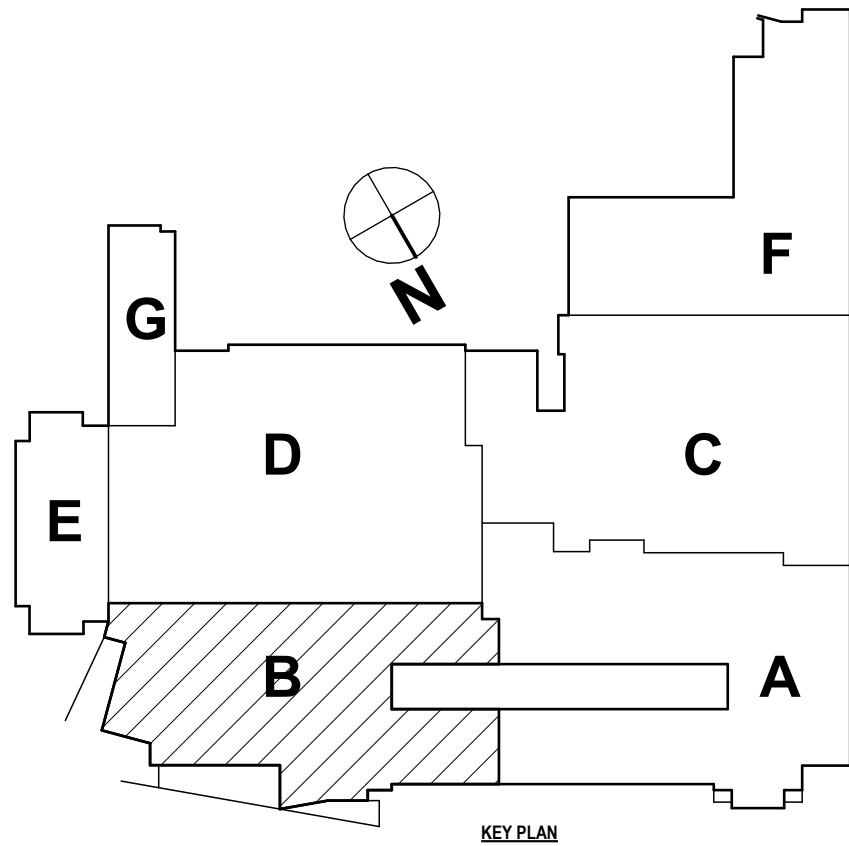

DRAWN BY: PSB	
CHECKED BY: MS	
DATE: 05/09/2025	
PHASE: CD	
#	DATE
1	10/02/2025

DESCRIPTION OF REVISION:  
ISSUED FOR BID

IT IS A VIOLATION OF THE LAW FOR ANY PERSON TO MAKE UNAUTHORIZED ALTERATIONS OR ADDITIONS TO PLANS DRAWN BY A LICENSED SURVEYOR. VIOLATORS WILL BE PROSECUTED.

**HUNT** ENGINEERS | ARCHITECTS | SURVEYORS

HORSEHEADS, NY 607-263-1000 ROCHESTER, NY 585-237-7549 TOWNAND, PA 570-265-4606  
BINGHAMTON, NY 607-738-8881 ALBANY, NY 607-738-8801  
WWW.HUNTEAS.COM

NY CERTIFICATE NO. 0016220 PA CERTIFICATE NO. TSC22020131464-1

FIRST FLOOR PLAN - AREA B

2025 MIDDLE SCHOOL PHASE III ALTERATIONS PROJECT

CORNING-PAINTED POST ASD

35 VICTORY HIGHWAY, PAINTED POST, NY 14870

MS-A1.2

PROJECT NO: 2649-133



GENERAL NOTES:

- A. EXTEND ALL PARTITIONS TO DECK ABOVE UNLESS NOTED OTHERWISE. INSTALL FIRE STOPPING AT DECK FLUTES IN AREAS OF METAL DECKING WHERE FIRE SEPARATION IS REQUIRED.
- B. ALL PENETRATIONS THROUGH FIRE RATED PARTITIONS TO BE SEALED W/ APPROVED U/L FIRE RATED ASSEMBLIES.
- C. FILL ALL VOIDS AND IMPERFECTIONS IN WALLS AND FLOORS CREATED BY DEMOLITION. PATCH TO MATCH EXISTING & PREPARE TO RECEIVE NEW FINISHES.
- D. ALL NEW DOOR FRAMES INSTALLED IN METAL STUD SHALL BE MOUNTED 4" FROM ADJACENT WALLS (P" TO DOOR). UNLESS NOTED OTHERWISE.
- E. INSTALL SOLID WOOD BLOCKING IN METAL STUD WALLS AT ALL AREAS OF CASEWORK, TACK/MARKER BOARDS, TOILET ACCESSORIES AND ALL WALL MOUNTED EQUIPMENT AND ACCESSORIES.
- F. ALL NEW INTERIOR PARTITIONS TO BE TYPE "I" UNLESS NOTED OTHERWISE.
- G. ALL NEW DOORS TO BE WOOD WITH HOLLOW METAL FRAME UNLESS NOTED OTHERWISE.

GENERAL NOTES:


- H. ITEMS SHOWN ARE INTENDED TO GIVE APPROXIMATE QUANTITY, LOCATION & TYPE. THE CONTRACTOR IS RESPONSIBLE FOR VERIFYING ACTUAL QUANTITY & EXISTING FIELD CONDITIONS.
- I. VERIFY WITH OWNER EXACT SIZE OF ALL EQUIPMENT FURNISHED BY OWNER FOR PROPER FIT WITH CONTRACTOR SUPPLIED CASEWORK AND MILLWORK.
- J. ALL DIMENSIONS ARE TAKEN FROM FACE OF WALL TO FACE OF WALL, UNLESS NOTED OTHERWISE.
- K. THERE SHALL BE A MINIMUM OF 1'-4" CLEAR FLOOR SPACE ON THE PULL SIDE OF ALL NEW DOORS; THERE SHALL BE A MINIMUM OF 1'-4" CLEAR FLOOR SPACE ON THE PUSH SIDE OF ALL NEW DOORS.
- L. THE WHEELCHAIR SYMBOL INDICATES HANDICAP ACCESSIBLE FIXTURE AND SHALL CONFORM WITH CABOJANSI A117.1 AND ADAAG.
- M. CONTRACTOR TO PROVIDE RESCUE WINDOW LABELS AT ALL NEW WINDOW LOCATION AS INDICATED ON SHEET C01.1.

PLAN DRAWING NOTES:

1. PATCH WALL AT EXPOSED REBAR WITH CONCRETE TO MATCH. APPROXIMATELY 4 L.F.
2. REPAIR MASONRY WALL CRACKING-RAKE LOOSE MORTAR AND REPOINT MORTAR JOINTS. PROVIDE ELASTOMERIC CAULK TO SEAL SEPARATIONS AS REQ.
3. REPAIR SPALLING CONCRETE AT FLOOR. PATCH WITH (SIKA REPAIR 222) FOR CONCRETE, APPROXIMATELY 14 SF.
4. FURNISH WALL PADS FOR ABATEMENT CONTRACTOR TO INSTALL. ABATEMENT CONTRACTOR TO PATCH AND REFINISH WALLS TO MATCH EXG. CONSTRUCTION AS REQUIRED.
5. PROVIDE DIVING BOARD AND STAND AS SHOWN. REFERENCE SPECIFICATION SECTION 13 11 00 FOR MORE INFORMATION.
6. CLEAN AND PAINT EXISTING HANDRAIL.
7. CLEAN AND PAINT EXISTING LINTEL.
8. APPROXIMATE AREA OF FLOOR CRACKING PROVIDE CONTROL JOINT. VERIFY EXTENTS IN FIELD. REFER TO INTERIOR FINISH DRAWINGS.
9. PROVIDE POWDER COATED METAL FENCE AS SHOWN.
10. BY ALTERNATE #2. SAND AND FINISH FLOOR UNDER BLEACHER TYP.
12. PROVIDE BASKETBALL BACKSTOP WITH GLASS BACKBOARDS.
13. PROVIDE LED SCORE BOARD.
14. PROVIDE NEW ZINC PLATED SUB STRUCTURE, POWDER COATED STES, ALUMINUM DECK, STAINLESS STEEL FASTENERS, MANUAL TELESCOPIC BLEACHER AND HANDRAIL SYSTEM IN COMPLIANCE WITH ADA.
15. PRIME AND PAINT STEEL LINTELS WITH CHLORINE CORROSION RESISTANT PAINT.
16. PROVIDE PRE ENGINEERED CANOPY. SEE SPECIFICATION SECTION
17. PROVIDE SLEEVE FOR BACKSTROKE MARKER POSTS
19. PROVIDE RACING LANE ANCHORS

PLAN DRAWING NOTES:

20. PROVIDE STL GAUDDRAIL, FASTENED TO EXG CURB. SEE REF. DETAILS ON PLAN.
22. PROVIDE CASEWORK, SEE INTERIOR ELEVATIONS AND CASEWORK SCHEDULE FOR ADDITIONAL INFORMATION.
23. PROVIDE ADA TOILET ACCESSORIES INCLUDING BUT NOT LIMITED TO HANDRAILS, TOILET TISSUE DISPENSERS, PAPER TOWEL DISPENSERS, GRAB BARS, PARTITIONS, SANITARY WASTE BINS, MIRRORS, SOAP DISPENSERS, ETC. PROVIDE BLOCKING AT ALL WALL MOUNTED ACCESSORIES. PROVIDE MISSING EXPANSION JOINT COVER AS NEEDED ON WALL AND/OR FLOOR SURFACE. COVER TO MATCH EXISTING ASSEMBLY.
25. SCOREBOARD SHOWN FOR REFERENCE. COORD. WITH "E" DWGS.
26. RECAULK CONTROL JOINTS BETWEEN VERTICAL FINIS AND BUILDING FAÇADE, APPROXIMATELY 350 L.F.
27. REFER TO TRADES FOR ACCESS CONTROL, MODIFY WALL AS REQUIRED, PATCH AND MATCH ADJ. FINISHES AS REQUIRED.
28. INFILL WALL OPENING AS SHOWN ON PLAN TO MATCH EXISTING WALL THICKNESS AND PREPARE FOR NEW FINISHES.
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30. REPOINT THE BOTTOM 3 COURSES OF FACEBRICK
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32. SURFACED MOUNTED SHOWER SHOWN FOR REFERENCE. COORD. WITH "P" DWGS
33. PROVIDE STARTING PLATFORM. REFER TO SPECIFICATION SECTION 13 11 00.
34. PROVIDE METAL SOFFIT AND RECESSED LIGHT.
35. BY ALTERNATE #3. PROVIDE VENTILATED POOL EQUIPMENT STORAGE UNITS.
36. PROVIDE DOWNSPOUT ATTACHED TO GUTTER SYSTEM ABOVE. SEE "L" DWGS FOR TIE-IN COORDINATION.
37. PROVIDE WALL MOUNTED BACKSTOP. SEE SPECIFICATIONS.
38. PROVIDE P-LAM COUNTERTOP. REINSTALL BENEATH COUNTERTOP PREVIOUSLY SALVAGED CASEWORK. MODIFY CASEWORK AS NECESSARY TO ACCOMMODATE HVAC WORK.
39. PROVIDE SWIMSUIT DRYER UNIT. SEE SPECIFICATIONS AND COORD. WITH "E" DWGS.

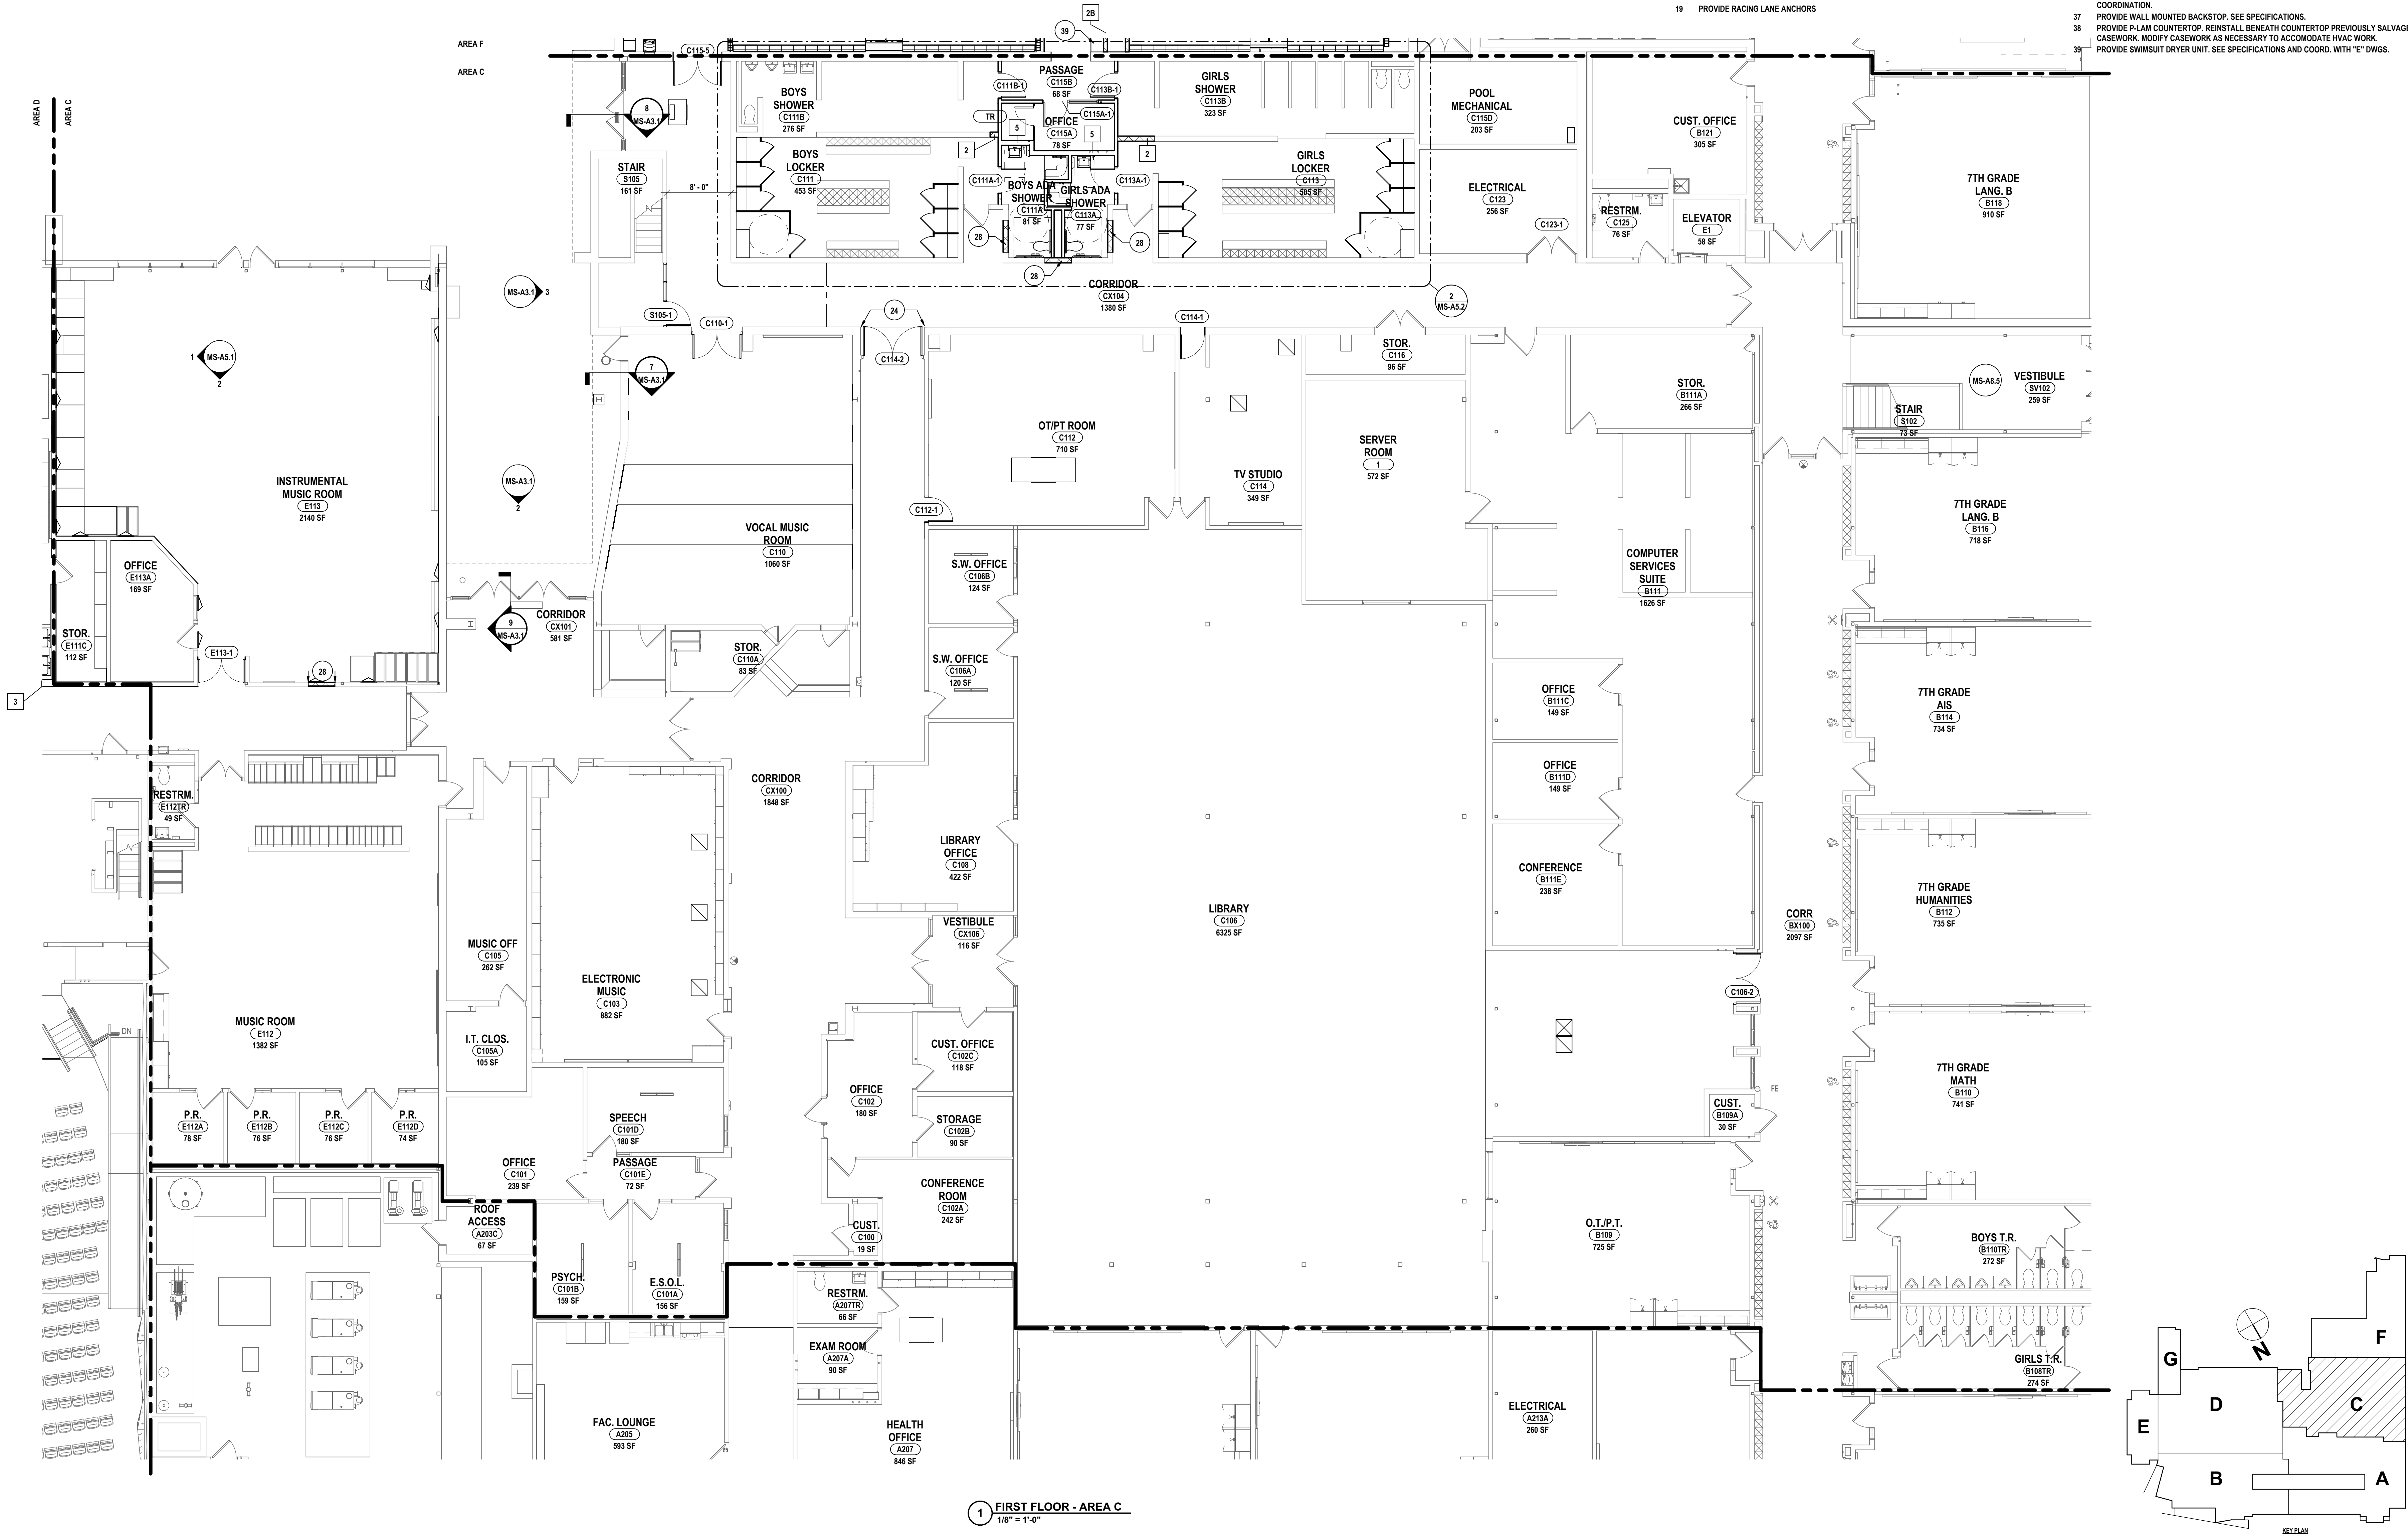

1 FIRST FLOOR - AREA C  
1/8" = 1'-0"

57-10-00-01-002-044 - MIDDLE SCHOOL

FIRST FLOOR PLAN - AREA C

2025 MIDDLE SCHOOL PHASE III ALTERATIONS PROJECT

CORNING-PAINTED POST ASD

35 VICTORY HIGHWAY, PAINTED POST, NY 14870

**HUNT** ENGINEERS | ARCHITECTS | SURVEYORS  
HORSEHEADS, NY 607-263-1000 ROCHESTER, NY 585-337-7849 TOWNANDA, PA 570-265-4606  
BINGHAMTON, NY 607-738-8081 ALBANY, NY 607-738-8001  
WWW.HUNTHEAS.COM  
NY CERTIFICATE NO. 0016220 PA CERTIFICATE NO. TSC2200131464-1

# DATE: 1 10/02/2025

DESCRIPTION OF REVISION:  
ISSUED FOR BID

PHASE:

DRAWN BY: PSP

CHECKED BY: MS

DATE: 05/09/2025

PHASE: CD

IT IS A VIOLATION OF THE LAW FOR ANY PERSON TO MAKE UNAUTHORIZED ALTERATIONS OR ADDITIONS TO PLANS  
DRAWING & LICENSED ENGINEER'S SEAL

DATE: 05/09/2025

PHASE: CD

DRAWN BY: PSP

CHECKED BY: MS

DATE: 05/09/2025

PHASE: CD

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GENERAL NOTES:

- A. EXTEND ALL PARTITIONS TO DECK ABOVE UNLESS NOTED OTHERWISE. INSTALL FIRE STOPPING AT DECK FLUTES IN AREAS OF METAL DECKING WHERE FIRE SEPARATION IS REQUIRED.
- B. ALL PENETRATIONS THROUGH FIRE RATED PARTITIONS TO BE SEALED W/ APPROVED U/L FIRE RATED ASSEMBLIES.
- C. FILL ALL VOIDS AND IMPERFECTIONS IN WALLS AND FLOORS CREATED BY DEMOLITION. PATCH TO MATCH EXISTING & PREPARE TO RECEIVE NEW FINISHES.
- D. ALL NEW DOOR FRAMES INSTALLED IN METAL STUD SHALL BE MOUNTED 4" FROM ADJACENT WALLS (6" TO DOOR), UNLESS NOTED OTHERWISE.
- E. INSTALL SOLID WOOD BLOCKING IN METAL STUD WALLS AT ALL AREAS OF CASEWORK, TACKMARKER BOARDS, TOILET ACCESSORIES AND ALL WALL MOUNTED EQUIPMENT AND ACCESSORIES.
- F. ALL NEW INTERIOR PARTITIONS TO BE TYPE 1 UNLESS NOTED OTHERWISE.
- G. ALL NEW DOORS TO BE WOOD WITH HOLLOW METAL FRAME UNLESS NOTED OTHERWISE.
- H. ITEMS SHOWN ARE INTENDED TO GIVE APPROXIMATE QUANTITY, LOCATION & TYPE. THE CONTRACTOR IS RESPONSIBLE FOR VERIFYING ACTUAL QUANTITY & EXISTING FIELD CONDITIONS.
- I. VERIFY WITH OWNER EXACT SIZE OF ALL EQUIPMENT FURNISHED BY OWNER FOR PROPER FIT WITH CONTRACTOR SUPPLIED CASEWORK AND MILLWORK.
- J. ALL DIMENSIONS ARE TAKEN FROM FACE OF WALL TO FACE OF WALL, UNLESS NOTED OTHERWISE.
- K. THERE SHALL BE A MINIMUM OF 1'-3" CLEAR FLOOR SPACE ON THE PULL SIDE OF ALL NEW DOORS. THERE SHALL BE A MINIMUM OF 1'-0" CLEAR FLOOR SPACE ON THE PUSH SIDE OF ALL NEW DOORS.
- L. THE WHEELCHAIR SYMBOL INDICATES HANDICAP ACCESSIBLE FIXTURE AND SHALL CONFORM WITH CABOJANSI A117.1 AND ADA443.
- M. CONTRACTOR TO PROVIDE RESCUE WINDOW LABELS AT ALL NEW WINDOW LOCATION AS INDICATED ON SHEET C01.1.

PLAN DRAWING NOTES:

1. PATCH WALL AT EXPOSED REBAR WITH CONCRETE TO MATCH, APPROXIMATELY 4 LF.
2. REPAIR MASONRY WALL CRACKING; RAKE LOOSE MORTAR AND REPOINT MORTAR JOINTS. PROVIDE ELASTOMERIC CAULK TO SEAL SEPARATIONS AS REQ.
3. REPAIR SPALLING CONCRETE AT FLOOR. PATCH WITH (SIKA REPAIR 222) FOR CONCRETE, APPROXIMATELY 14 SF.
4. FURNISH WALL PADS FOR ABATEMENT CONTRACTOR TO INSTALL. ABATEMENT CONTRACTOR TO PATCH AND REFINISH WALLS TO MATCH EXG. CONSTRUCTION AS REQUIRED.
5. PROVIDE DIVING BOARD AND STAND AS SHOWN. REFERENCE SPECIFICATION SECTION 13 11 00 FOR MORE INFORMATION.
6. CLEAN AND PAINT EXISTING HANDRAIL.
7. CLEAN AND PAINT EXISTING LINTEL.
8. APPROXIMATE AREA OF FLOOR CRACKING PROVIDE CONTROL JOINT. VERIFY EXTENTS IN FIELD. REFER TO INTERIOR FINISH DRAWINGS.
9. PROVIDE POWDER COATED METAL FENCE AS SHOWN.
10. BY ALTERNATE #2, SAND AND FINISH FLOOR UNDER BLEACHER TYP.
11. PROVIDE BASKETBALL BACKSTOP WITH GLASS BACKBOARDS.
12. PROVIDE LED SCORE BOARD.
13. PROVIDE NEW ZINC PLATED SUB STRUCTURE, POWDER COATED STEEL, ALUMINUM DECK, STAINLESS STEEL FASTENERS, MANUAL TELESCOPIC BLEACHER AND HANDRAIL SYSTEM IN COMPLIANCE WITH ADA.
14. PROVIDE PRE ENGINEERED CANOPY. SEE SPECIFICATION SECTION.
15. PROVIDE SLEEVE FOR BACKSTROKE MARKER POSTS.
16. PROVIDE RACING LANE ANCHORS.
17. PROVIDE STL GAUDDRAIL FASTENED TO EXG CURB. SEE REF. DETAILS ON PLAN.
18. PROVIDE CASEWORK. SEE INTERIOR ELEVATIONS AND CASEWORK SCHEDULE FOR ADDITIONAL INFORMATION.
19. PROVIDE ADA TOILET ACCESSORIES INCLUDING BUT NOT LIMITED TO HANDRAILS, TOILET TISSUE DISPENSERS, PAPER TOWEL DISPENSERS, GRAB BARS, PARTITIONS, SANITARY WASTE BINS, MIRRORS, SOAP DISPENSERS, ETC. PROVIDE BLOCKING AT ALL WALL MOUNTED ACCESSORIES.
20. PROVIDE MISSING EXPANSION JOINT COVER AS NEEDED ON WALL AND/OR FLOOR SURFACE. COVER TO MATCH EXISTING ASSEMBLY.
21. SCOREBOARD SHOWN FOR REFERENCE. COORD. WITH "E" DWGS.
22. RECAULK CONTROL JOINTS BETWEEN VERTICAL FINIS AND BUILDING FAÇADE, APPROXIMATELY 350 LF.
23. REFER TO TRADES FOR ACCESS CONTROL, MODIFY WALL AS REQUIRED, PATCH AND MATCH ADJ. FINISHES AS REQUIRED.
24. INFILL WALL OPENING AS SHOWN ON PLAN TO MATCH EXISTING WALL THICKNESS AND PREPARE FOR NEW FINISHES.
25. INFILL PATCH AND REFINISH WALL AT AREA OF REMOVED DRINKING FOUNTAIN.
26. REPOINT THE BOTTOM 3 COURSES OF FACEBRICK.
27. PROVIDE METAL SOFFIT AND RECESSED LIGHT.
28. BY ALTERNATE #3, PROVIDE VENTILATED POOL EQUIPMENT STORAGE UNITS.
29. PROVIDE DOWNSPOUT ATTACHED TO GUTTER SYSTEM ABOVE. SEE "L" DWGS FOR TIE-IN COORDINATION.
30. PROVIDE WALL MOUNTED BACKSTOP. SEE SPECIFICATIONS.
31. PROVIDE P-LAM COUNTERTOP. REINSTALL BENEATH COUNTERTOP PREVIOUSLY SALVAGED CASEWORK. MODIFY CASEWORK AS NECESSARY TO ACCOMMODATE HVAC WORK.
32. PROVIDE SWIMSUIT DRYER UNIT. SEE SPECIFICATIONS AND COORD. WITH "E" DWGS.

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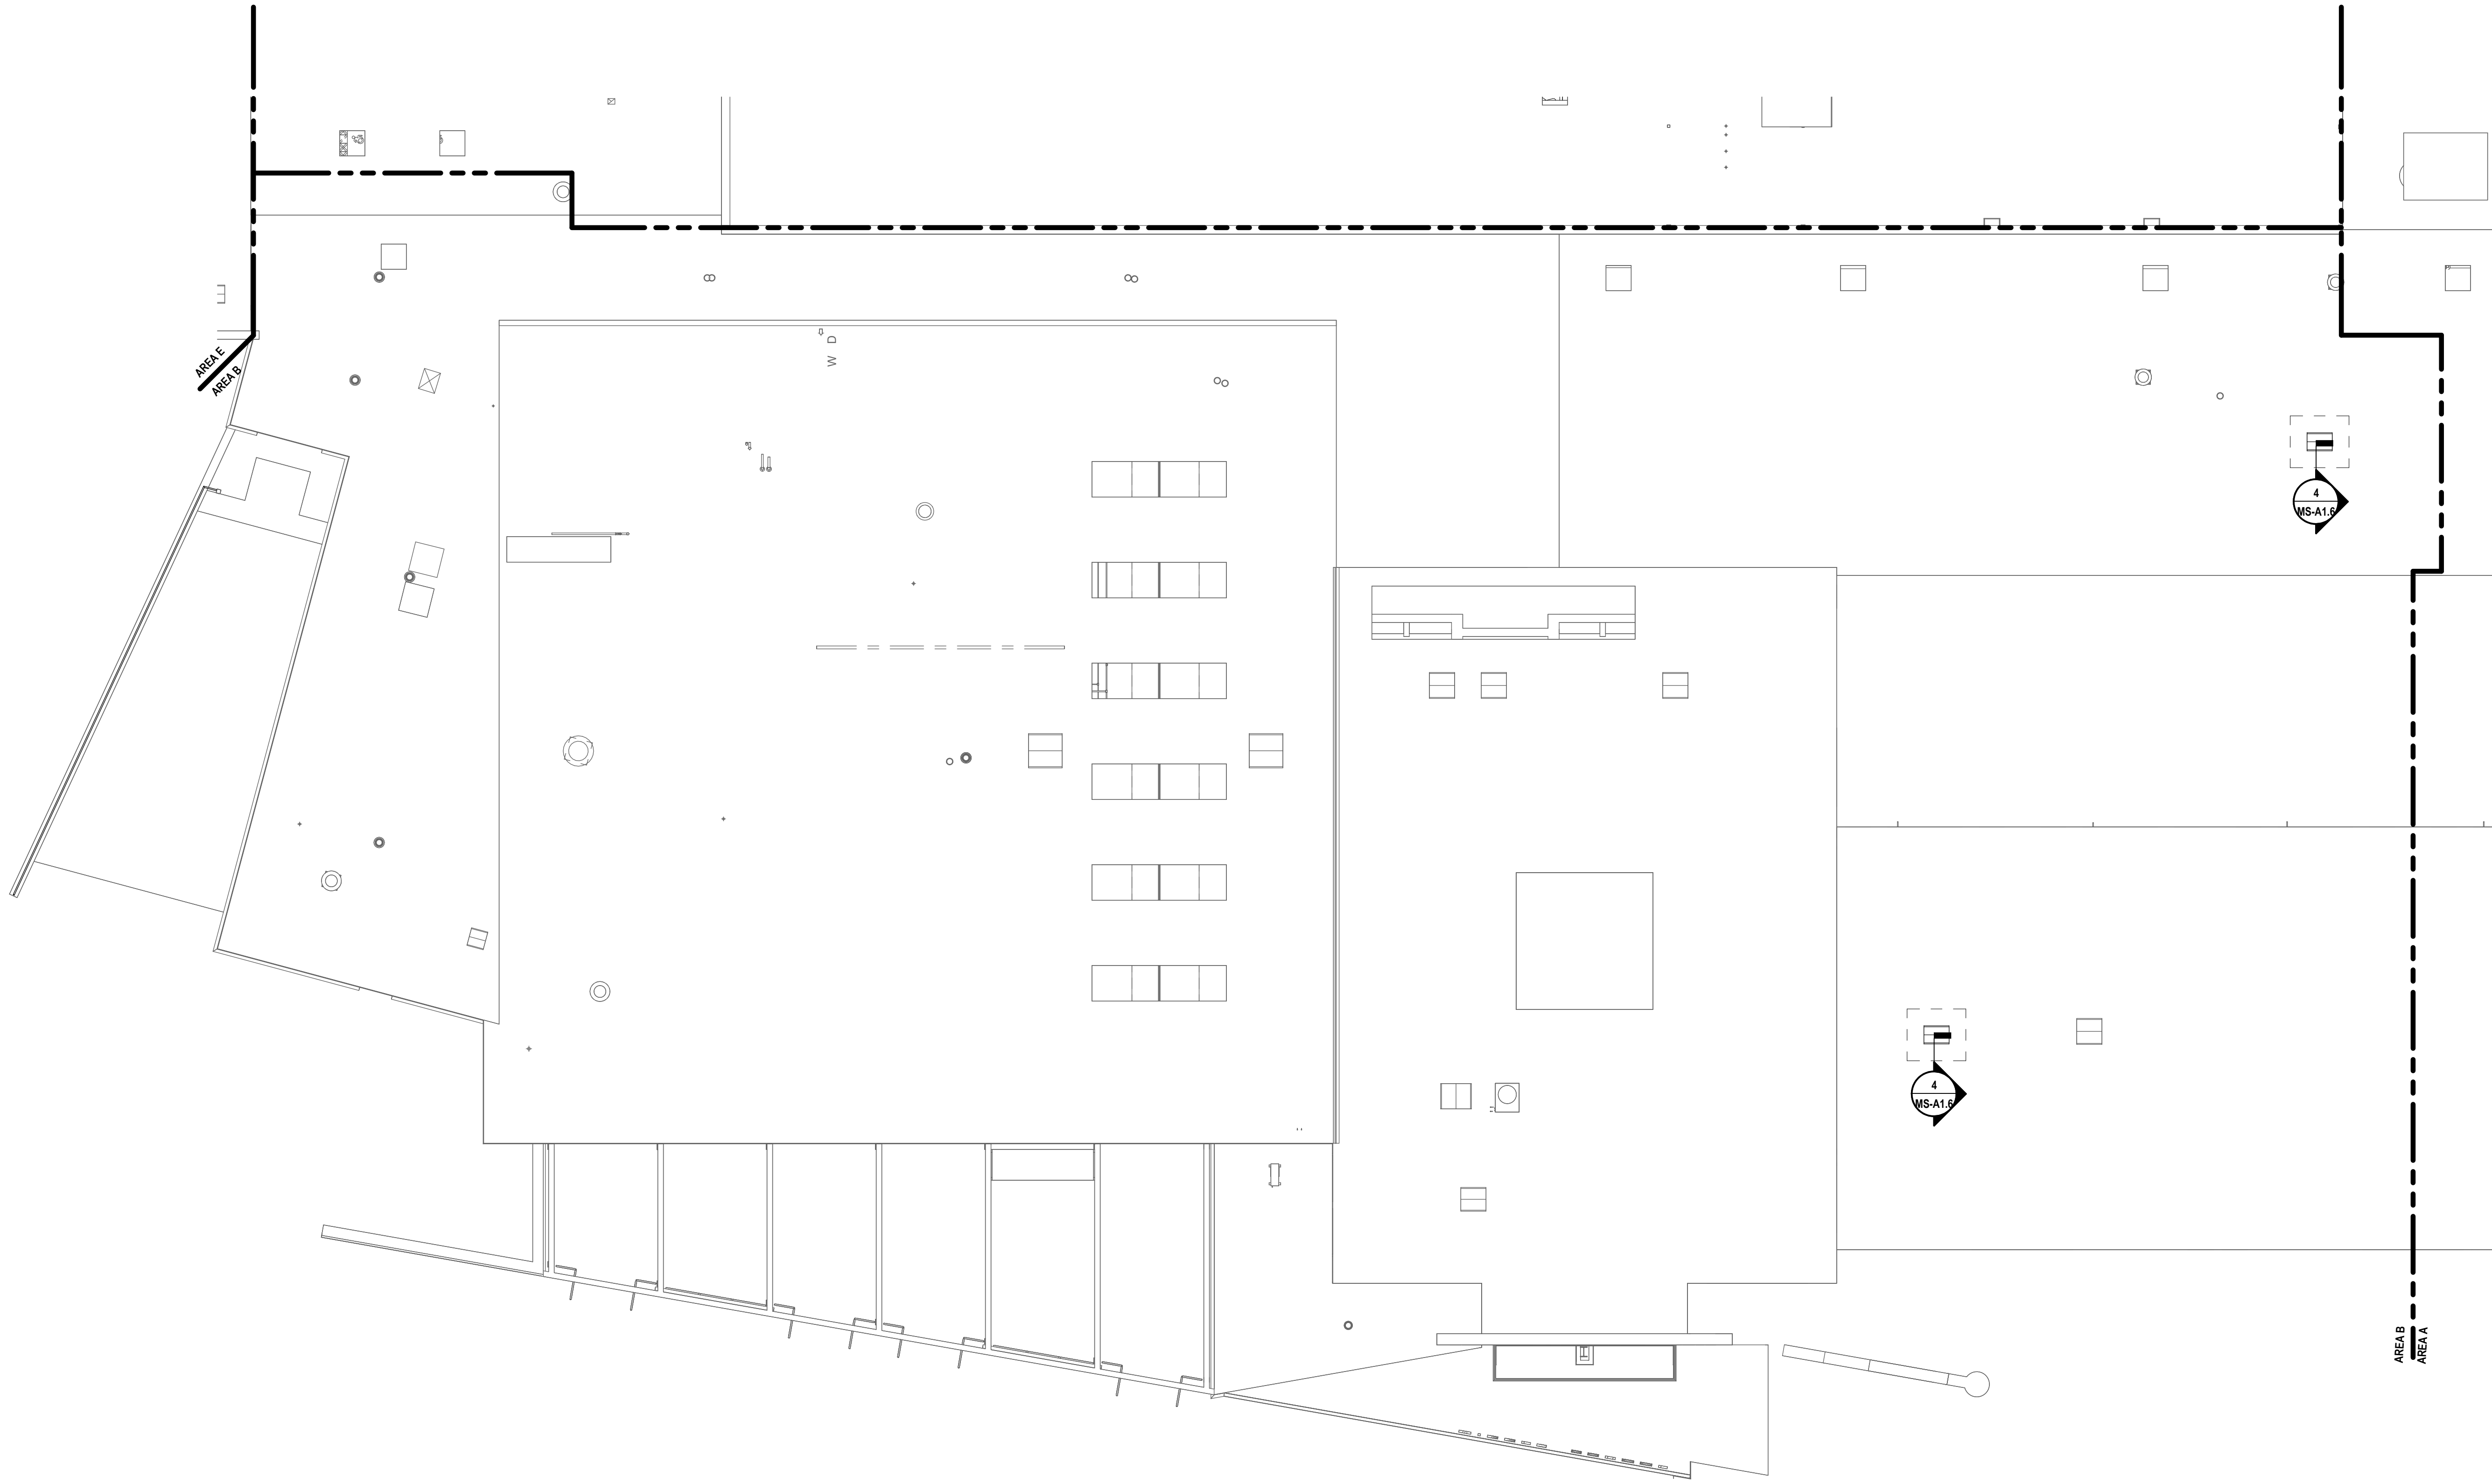
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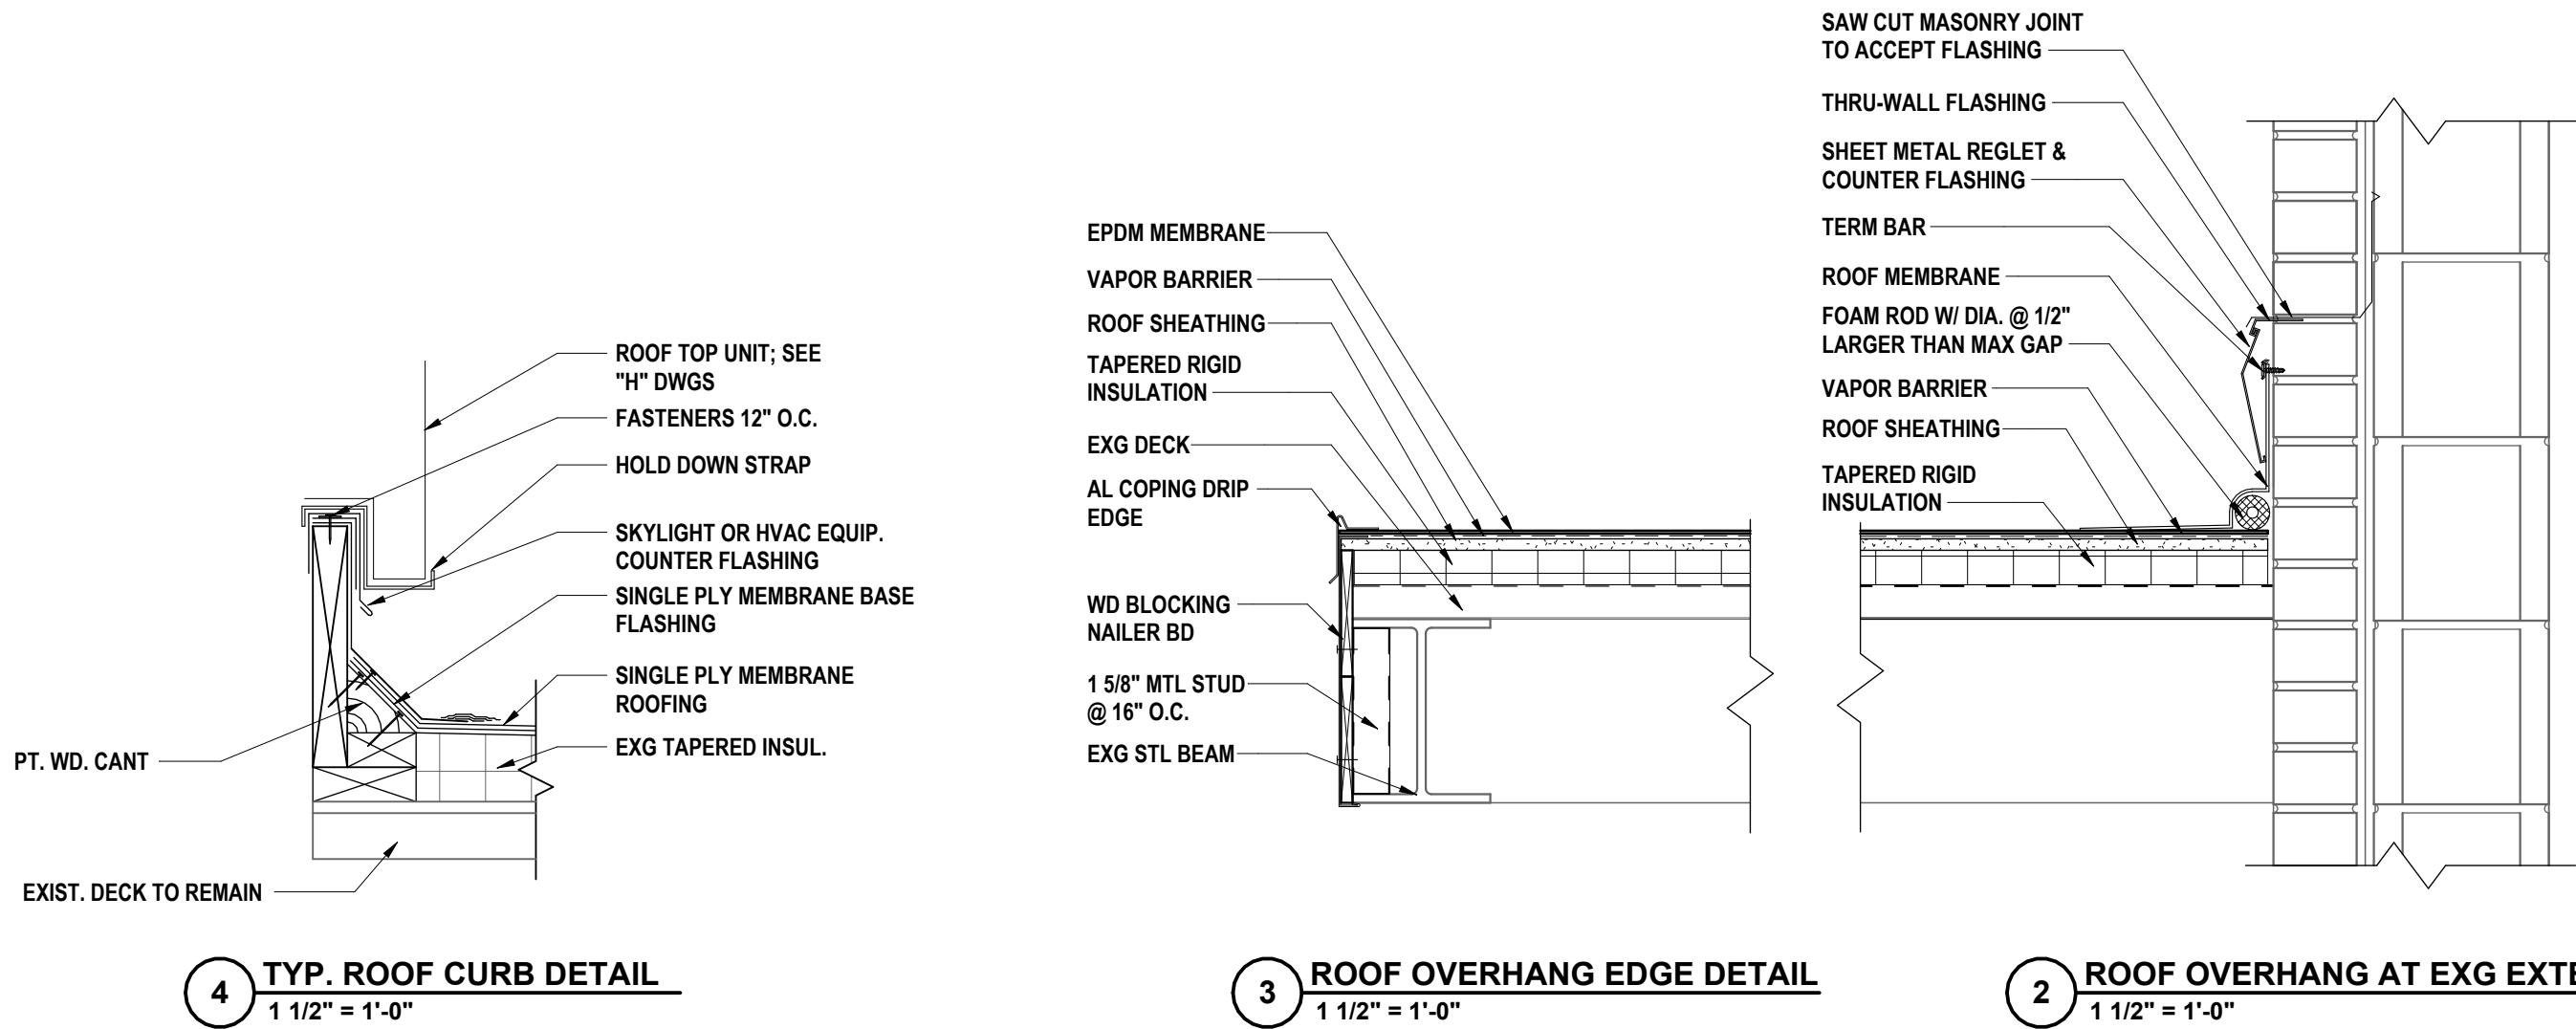
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TOWNHALL, PA 17101-1000

ALBANY, NY





1 ROOF PLAN - AREA B  
3/32" = 1'-0"



4 TYP. ROOF CURB DETAIL  
1 1/2" = 1'-0"

3 ROOF OVERHANG EDGE DETAIL  
1 1/2" = 1'-0"

2 ROOF OVERHANG AT EXG EXTERIOR WALL  
1 1/2" = 1'-0"

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- FOR AREAS NOT SPECIFICALLY CALLED OUT, THE CONTRACTOR SHALL PROVIDE ADDITIONAL BLOCKING AT ALL ROOF PENETRATIONS WHERE REQUIRED TO PROVIDE A MINIMUM HEIGHT OF CURB TO BE 12" ABOVE THE ROOF SURFACE. THE CONTRACTOR SHALL PROVIDE NEW BOOTS. REFER TO HVAC DRAWINGS.
- REFER TO H/E-DRAWINGS FOR WORK BY HVAC AND ELECTRICAL CONTRACTORS ASSOCIATED WITH EXISTING EQUIPMENT REMOVALS.
- THE CONTRACTOR TO PROVIDE ANY ADDITIONAL BLOCKING AND ANY ASSOCIATED ACCESSORIES REQUIRED BASED ON INSULATION LAYOUT.
- PREVENT DEBRIS FROM ENTERING THE ROOF DRAINS AND DRAIN LINES (LEADERS) DURING CONSTRUCTION. THE CONTRACTOR SHALL SNAKE DRAIN LINES AT COMPLETION OF WORK.
- PROVIDE CRICKETS AT ALL CURBS, RAILS, ETC. WHICH RUN IN LENGTH GREATER THAN 24" PERPENDICULAR TO THE SLOPE OF ROOF INSULATION. SLOPE OF CRICKETS SHALL BE 12" VERTICAL PER 12" HORIZONTAL.
- IF EXISTING ROOF DECK OR STRUCTURAL SYSTEM DAMAGE IS SUSPECTED, NOTIFY THE OWNER'S REPRESENTATIVE IMMEDIATELY.

ROOF DRAWING KEYNOTES:

- PROVIDE TYPICAL CURB DETAIL AND METAL DECK OPENING AROUND VERTICAL DUCTWORK FROM ROOFTOP UNIT THROUGH ROOF STRUCTURE. V.I.F. EXACT DIMENSIONS. SEE DETAIL 2.
- REMOVE EXISTING CURB AND PROVIDE NEW ACOUSTICAL CURB. SEE MECHANICAL DRAWINGS AND DETAIL 2 THIS SHEET. INFILL ANY ABANDONED ROOF OPENINGS PER DETAIL 18MS-S3.1.
- PROVIDE MECHANICAL EQUIPMENT RAILS AT EACH SUPPORT AS INDICATED. SEE MECHANICAL DRAWINGS. SEE DETAIL 3 THIS SHEET.
- PROVIDE METAL DECK INFILL AT EQUIPMENT REMOVAL PER STRUCTURAL INFILL DETAIL 18MS-S3.1.

57-10-00-01-002-044 - MIDDLE SCHOOL

ROOF PLAN - AREA B

2025 MIDDLE SCHOOL PHASE III ALTERATIONS PROJECT  
CORNING-PAINTED POST ASD

35 VICTORY HIGHWAY, PAINTED POST, NY 14870

MS-A1.6

PROJECT NO: 2649-133

HUNT ENGINEERS | ARCHITECTS | SURVEYORS

HORSEHEADS, NY 607-263-1000 ROCHESTER, NY 585-537-7849 TOWNAND, PA 570-265-4666  
BINGHAMTON, NY 607-738-8881 ALBANY, NY 607-738-8801

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NY CERTIFICATE NO. 001620 PA CERTIFICATE NO. TSC220213/464-1

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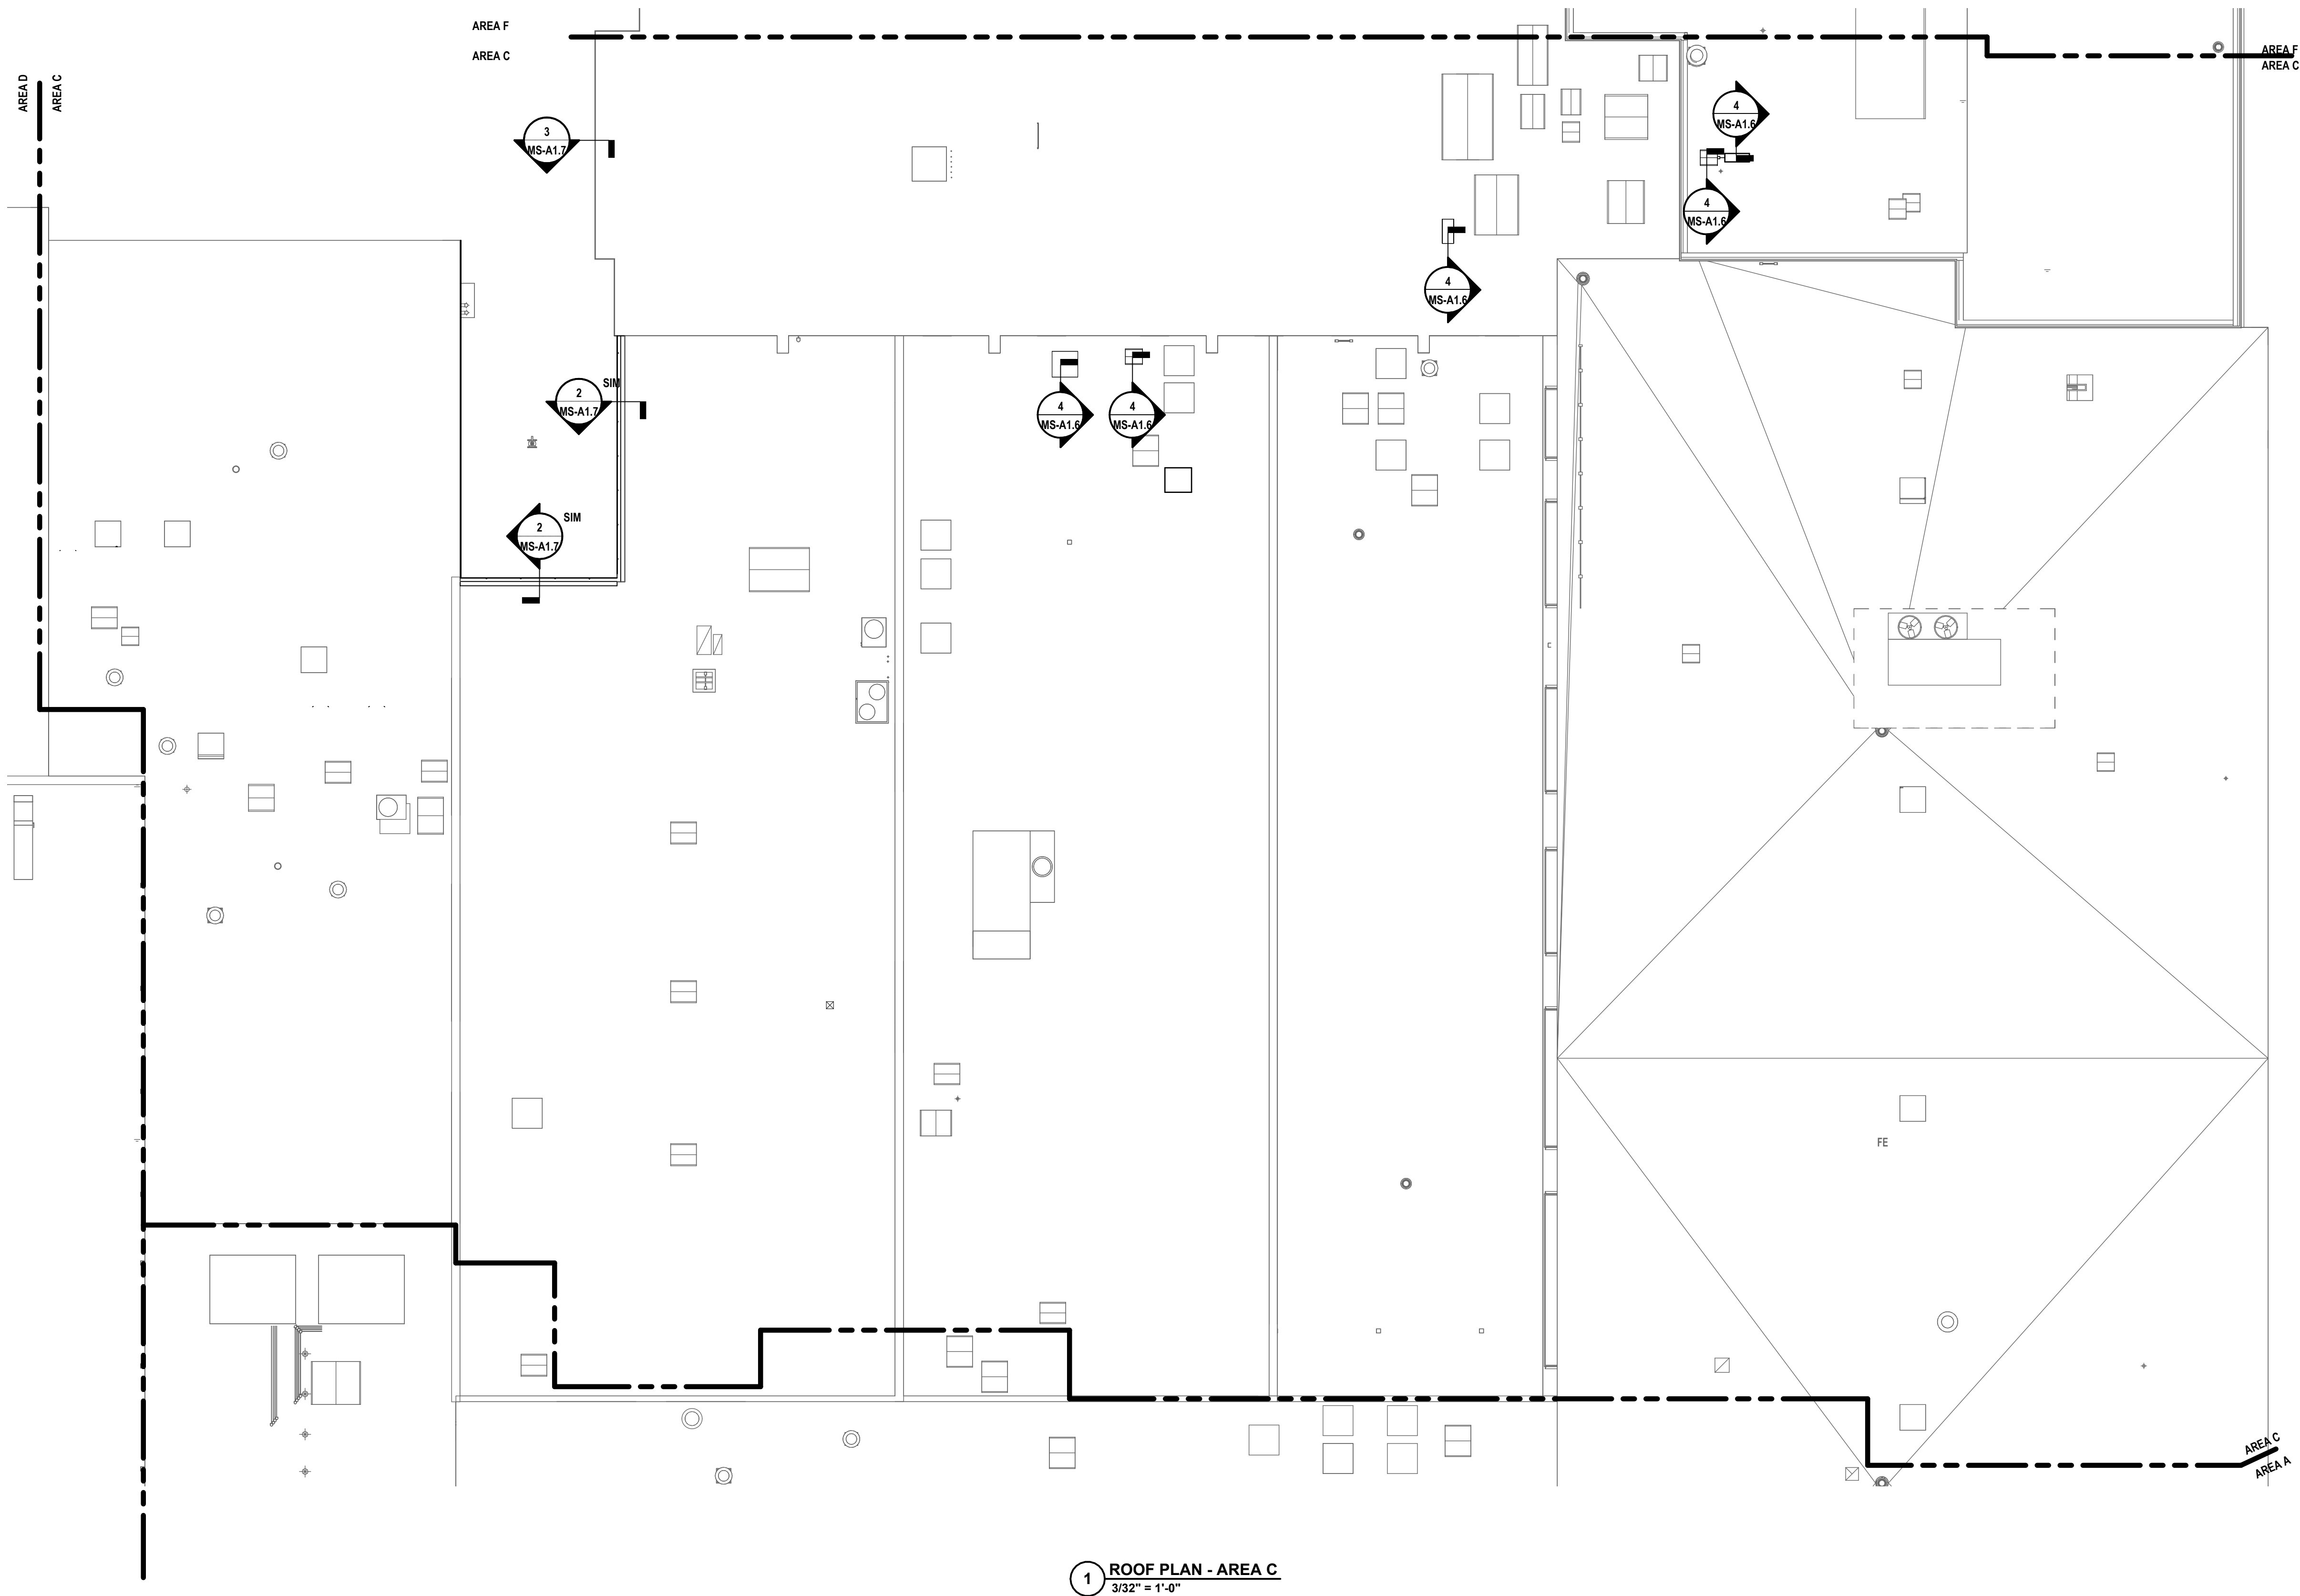
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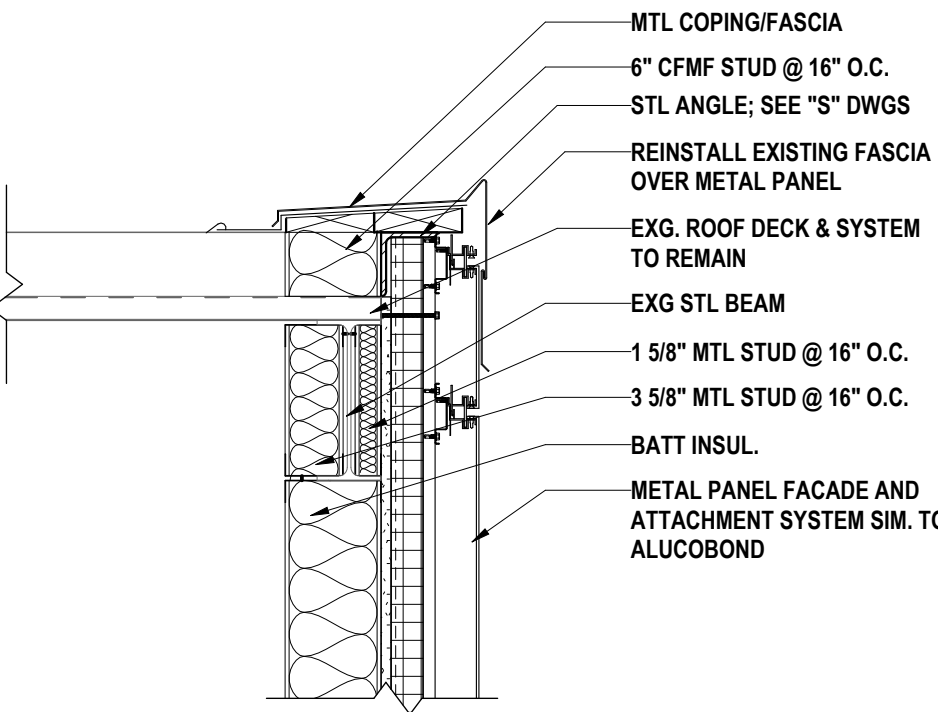
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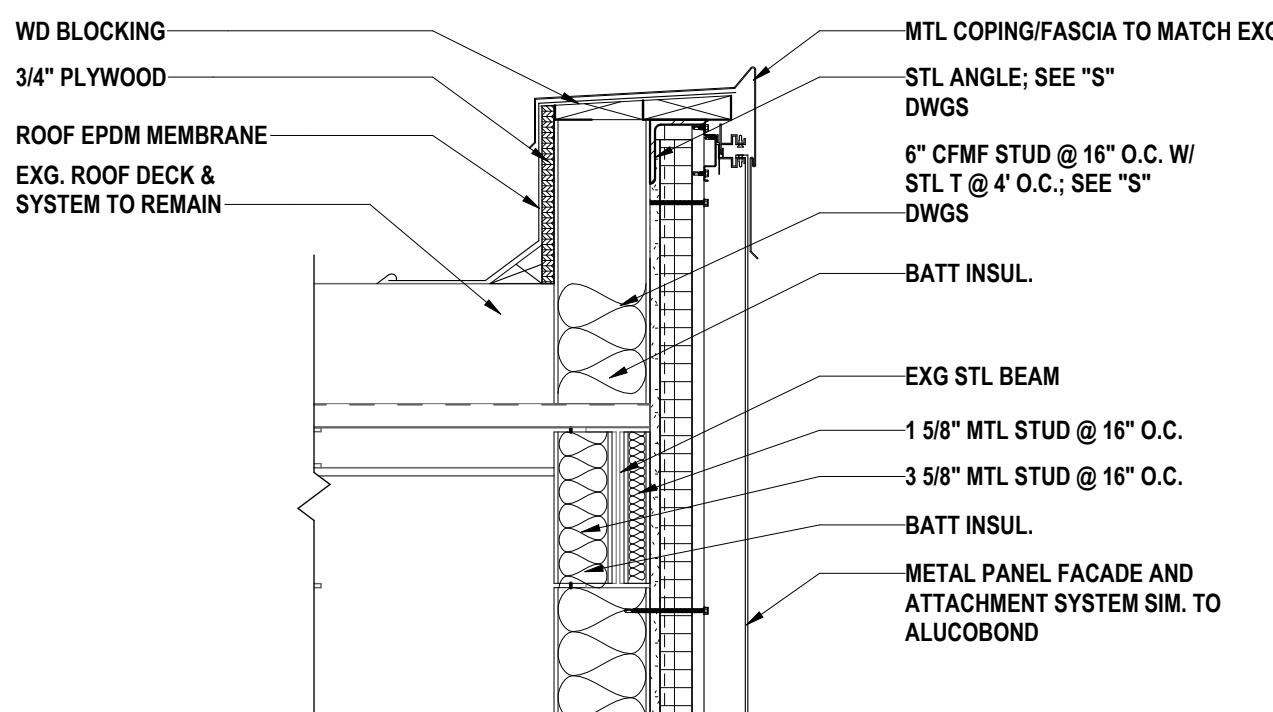




1 ROOF PLAN - AREA C  
3/32" = 1'-0"



3 ROOF EDGE B AT POOL ENTRY  
1" = 1'-0"




2 ROOF EDGE A AT POOL ENTRY  
1" = 1'-0"

#### GENERAL ROOF NOTES:

- A ALL WORK SHALL CONFORM TO THE NEW YORK STATE BUILDING CODE AND ADOPTED REFERENCE STANDARDS.  
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M IF EXISTING ROOF DECK OR STRUCTURAL SYSTEM DAMAGE IS SUSPECTED, NOTIFY THE OWNER'S REPRESENTATIVE IMMEDIATELY.

#### ROOF DRAWING KEYNOTES:

- 1 PROVIDE TYPICAL CURB DETAIL AND METAL DECK OPENING AROUND VERTICAL DUCTWORK FROM ROOFTOP UNIT THROUGH ROOF STRUCTURE, V.I.F. EXACT DIMENSIONS. SEE DETAIL 2.  
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KEY PLAN

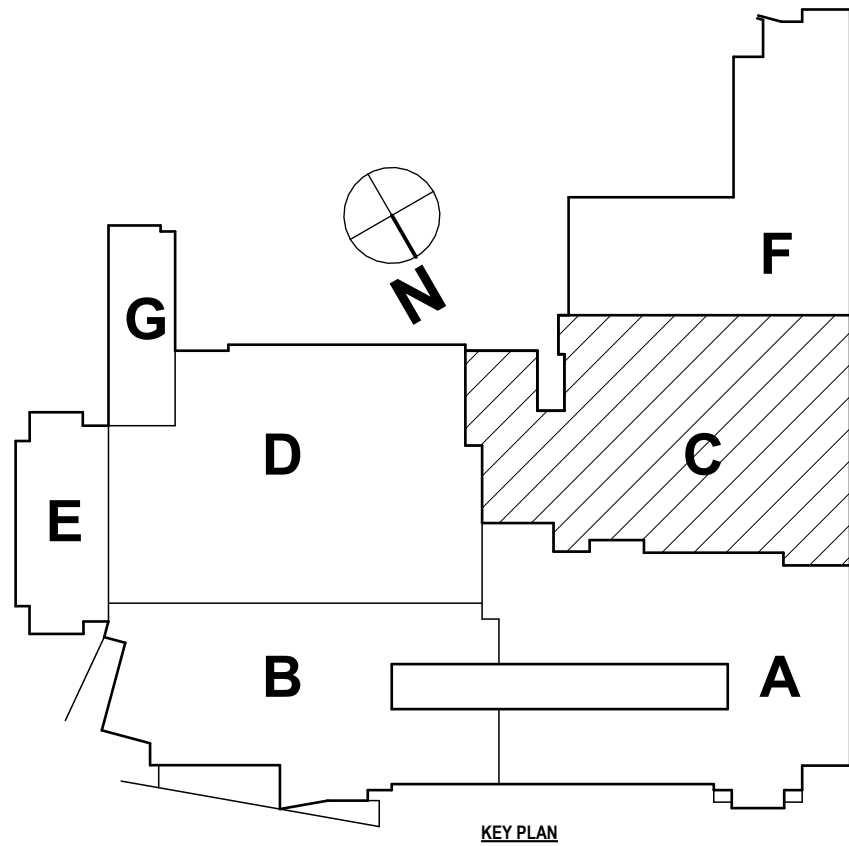ROOF PLAN - AREA C

2025 MIDDLE SCHOOL PHASE III ALTERATIONS PROJECT  
CORNING-PAINTED POST ASD

35 VICTORY HIGHWAY, PAINTED POST, NY 14870

MS-A1.7

PROJECT NO: 2649-133

HUNT ENGINEERS | ARCHITECTS | SURVEYORS

HORSEHEADS, NY 607-263-1000 ROCHESTER, NY 585-537-7668 TOWNHALL, PA 670-265-4606  
BINGHAMTON, NY 607-738-8881 ALBANY, NY 607-738-4801

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NY CERTIFICATE NO. 0016220 PA CERTIFICATE NO. TSC2202013/464-1


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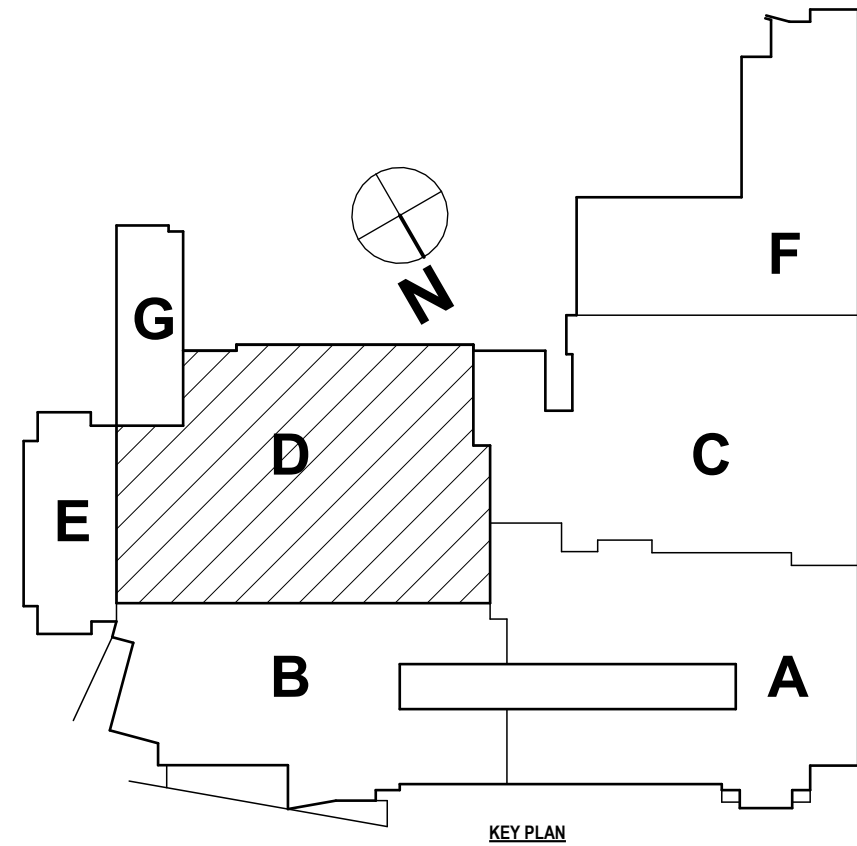
IT IS A VIOLATION OF THE LAW FOR ANY PERSON TO MAKE UNAUTHORIZED ALTERATIONS OR ADDITIONS TO PLANS DRAWN BY A LICENSED ENGINEER, ARCHITECT, OR SURVEYOR'S SEAL.

DRAWN BY: MBH  
CHECKED BY: SZ  
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PHASE: CD





1 ROOF PLAN - AREA D  
3/32" = 1'-0"

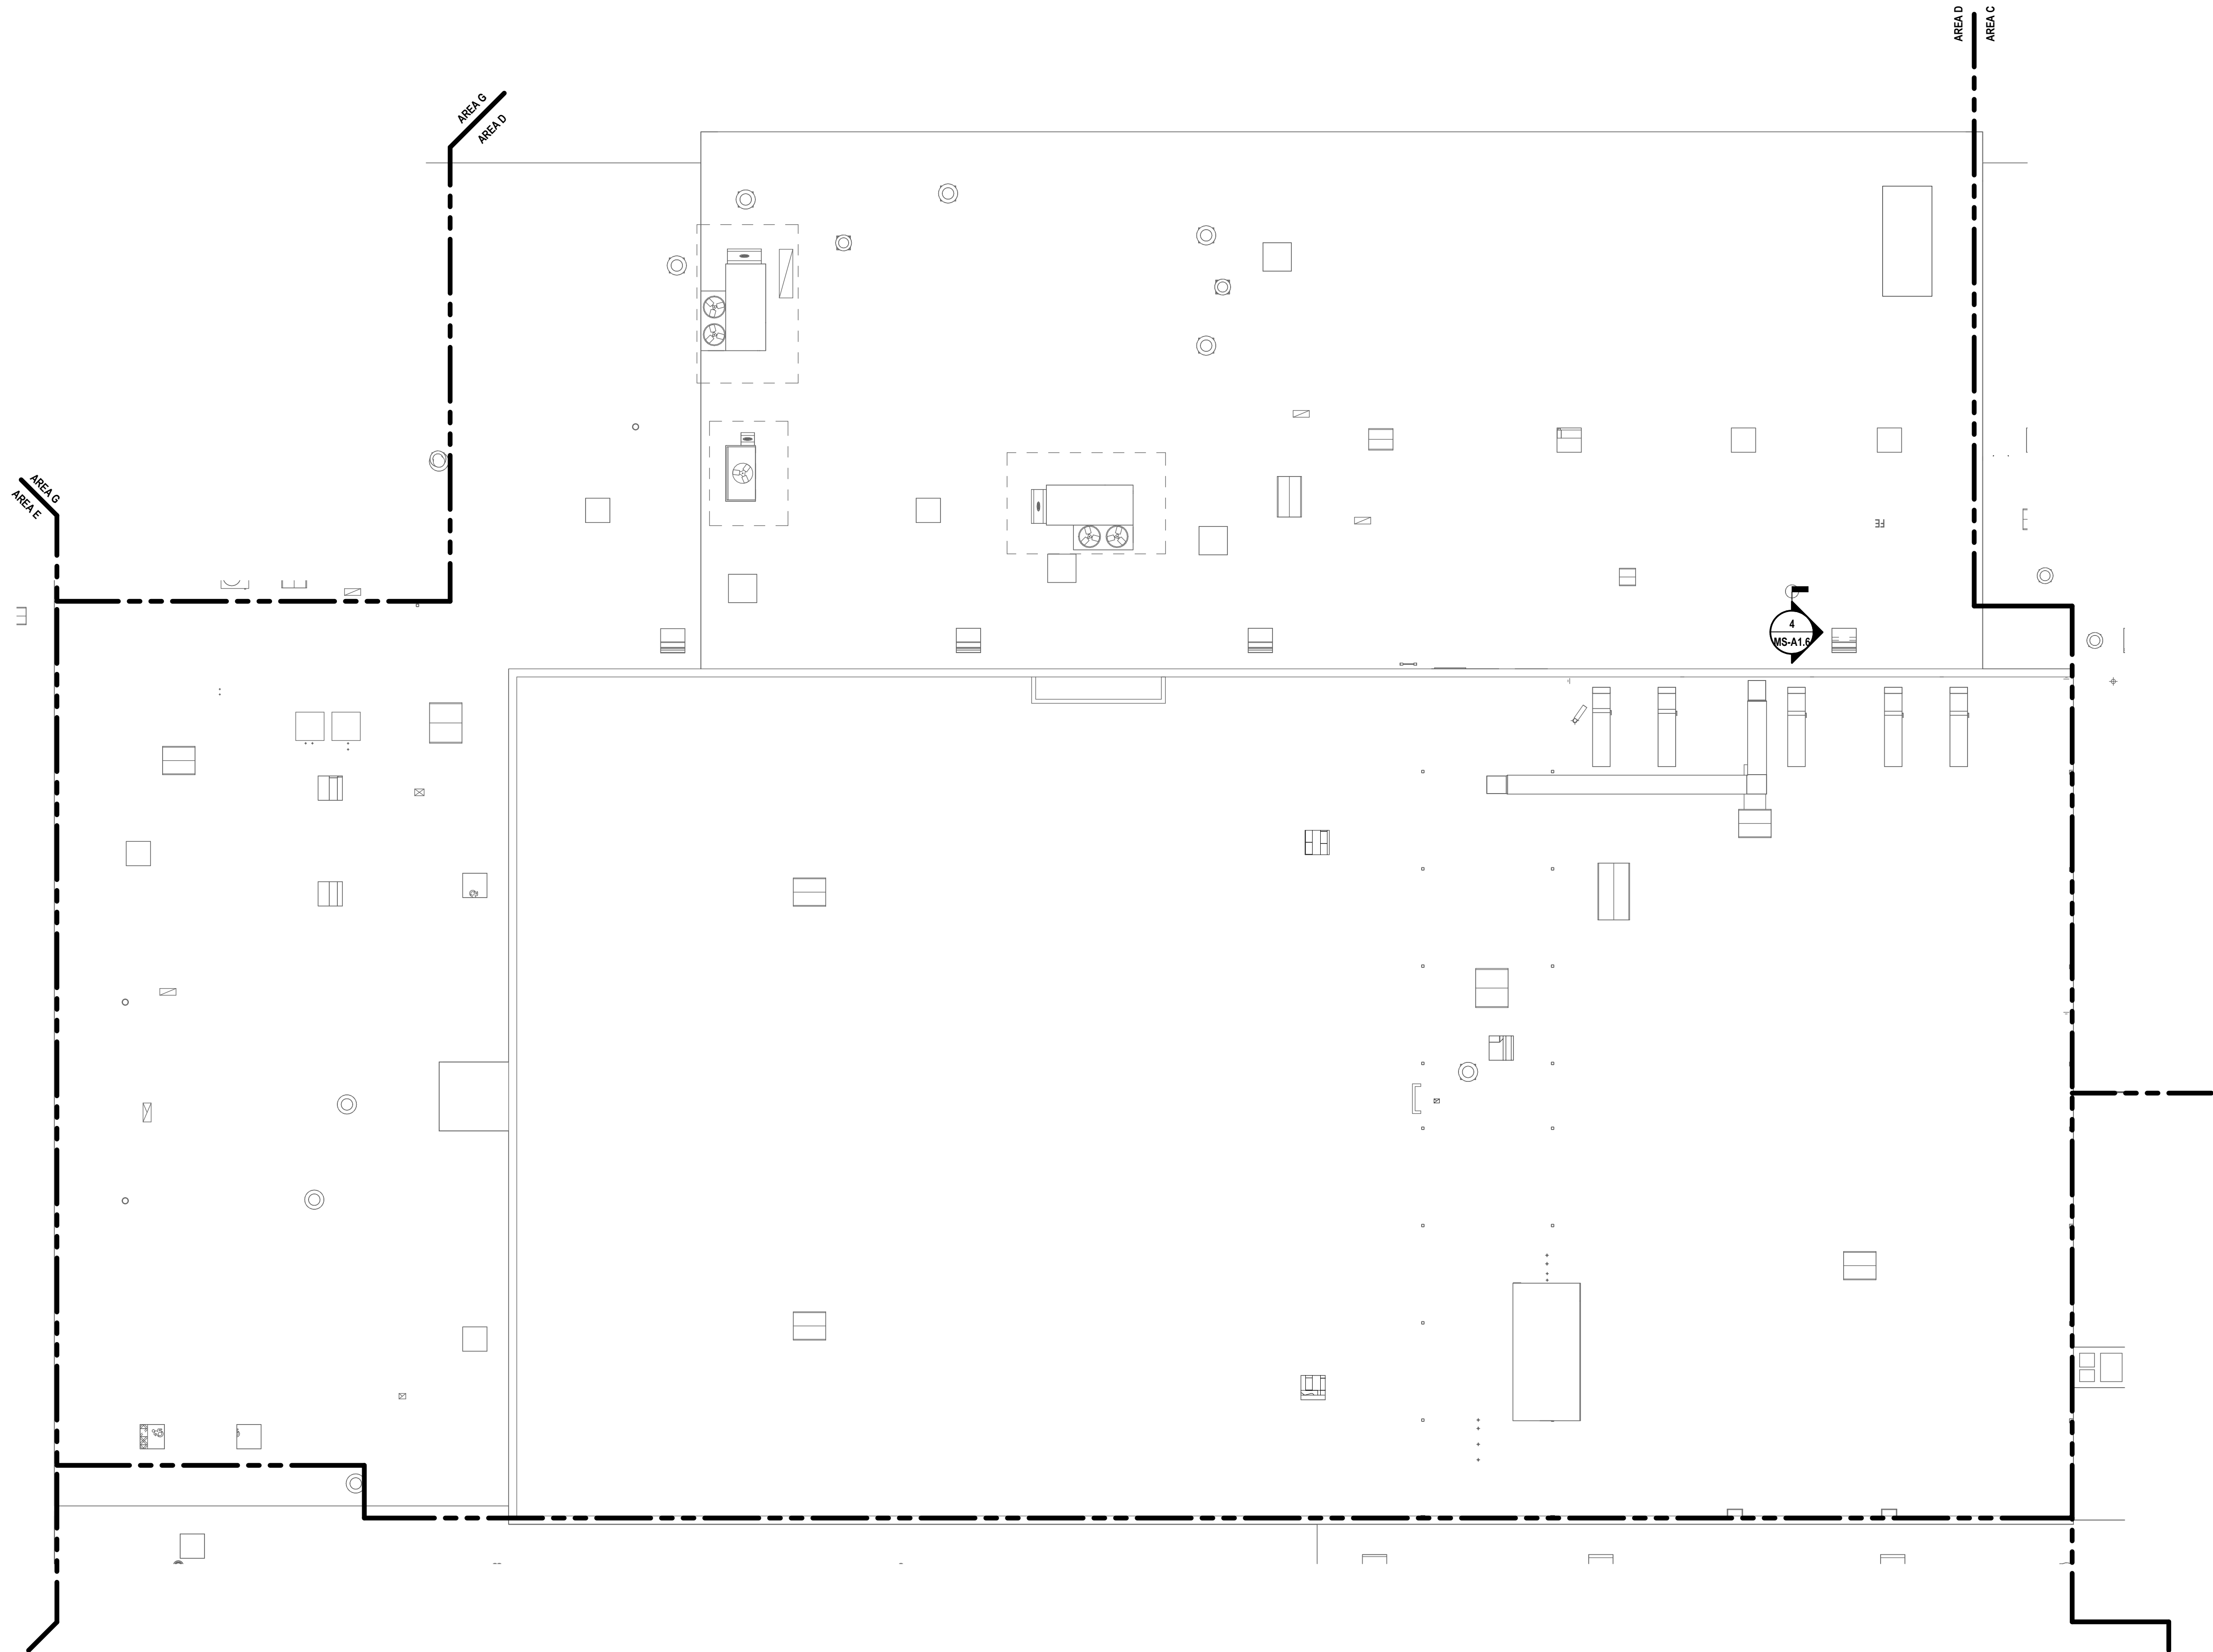

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57-10-00-01-002-044 - MIDDLE SCHOOL

ROOF PLAN - AREA D

2025 MIDDLE SCHOOL PHASE III ALTERATIONS PROJECT  
CORNING-PAINTED POST ASD

35 VICTORY HIGHWAY, PAINTED POST, NY 14870

MS-A1.8

PROJECT NO: 2649-133

HUNT ENGINEERS | ARCHITECTS | SURVEYORS

HORSEHEADS, NY 607-263-1000 ROCHESTER, NY 585-537-7868 TOWNAND, PA 570-265-4606

BINGHAMTON, NY 607-798-8881 ALBANY, NY 607-798-8801

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DRAWN BY LICENSED ENGINEER, ARCHITECT, OR SURVEYOR'S SEAL.





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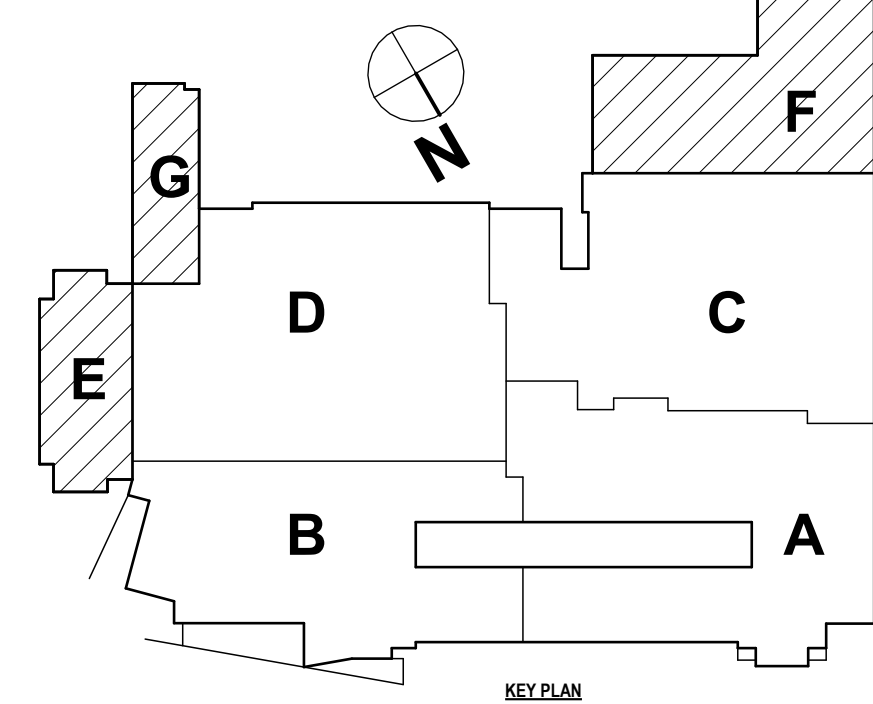
FULLY ADHERED TO ONE LAYER OF EXTERIOR ROOF SHEATHING MECHANICALLY FASTENED WITH ONE LAYER OF 4-40 MIL RUBBERIZED ASPHALTIC VAPOR RETARDER OVER METAL ROOF DECK.

EXISTING ROOF SYSTEM TO REMAIN

ARROW INDICATES DIRECTION OF SLOPE FOR THE ROOF STRUCTURE OR TAPERED INSULATION (SEE STRUCTURAL DRAWINGS)

+8" HP INSULATION THK @ HIGH POINT

+2" LP INSULATION THK @ LOW POINT







GENERAL CEILING NOTES:

- A ALL CORRIDOR CEILINGS ARE TO BE 8'-0" UNLESS NOTED OTHERWISE. ALCOVES ARE TO BE 8'-0" U.N.D. AND ALL CLASSROOM CEILINGS TO BE 9'-0" A.F. AT THE FIRST FLOOR AND SECOND FLOOR UNLESS NOTED OTHERWISE.
- B ALL SOFFITS TO BE 2" LOWER THAN CEILING HEIGHT UNLESS NOTED OTHERWISE.
- C CENTER ALL ELECTRICAL DEVICES WITHIN 2X2 CEILING TILES UNO.
- D REFER TO FINISH SCHEDULE FOR INDIVIDUAL CEILING TYPES.
- E VERIFY IN FIELD THE AMOUNT OF EXISTING LIGHTS TO BE REMOVED AND REINSTALLED.
- F ALL NEW CEILING SYSTEMS TO BE INSTALLED DIRECTLY TO STRUCTURE.
- G CENTER ALL MECHANICAL PENETRATIONS WITHIN CEILING TILES UNLESS NOTED OTHERWISE.
- H COORDINATE ALL MECHANICAL DUCTWORK, PIPING, SPRINKLER LINES & CABLE TRAY TO AVOID CONFLICTS WITH LIGHTS AND STRUCTURE.
- I ARCHITECTURAL DRAWINGS TAKE PRECEDENCE OVER ENGINEERING DRAWINGS FOR LOCATION OF LIGHT FIXTURES& MECHANICAL LOUVERS. SEE ELECTRICAL AND MECHANICAL DRAWINGS FOR ALL FIXTURES.
- K ALL CEILINGS SHOWN ON THE PLAN ARE NEW CONSTRUCTION

REFLECTED CEILING PLAN

DRAWING NOTES:

- 1 REINSTALL EXG. CEILING AS REQUIRED TO ACCOMMODATE NEW CONSTRUCTION.
- 2 PROVIDE BREAK METAL TRIM AROUND ENTIRE SKYLIGHT OPENING. SEE RMS-A2.8.
- 3 PROVIDE ACOUSTICAL SPRAY. REFER TO SPEC.
- 4 REINSTALL SALVAGED PORTIONS CEILING AFTER COMPLETION OF HVAC WORK TO MATCH EXG EXISTING CEILING HEIGHT. SEE "H" DIVIS.
- 5 REINSTALL CEILING AS REQUIRED TO ACCOMMODATE WALL FINISH SCOPE.
- 6 REINSTALL EXG. CEILING AND EXTENT TO MEET NEW CONSTRUCTION.
- 7 REMOVE RUST, CLEAN, AND PAINT CORRODED METAL DECK.
- 8 PROVIDE CEILING CLOUD ACOUSTIC BAFFLES. REFER TO A8 DRAWINGS, FINISH KEY AND SPECS FOR MORE INFORMATION.
- 9 PROVIDE CEILING CLOUD ACOUSTIC PANELS. REFER TO A8 DRAWINGS, FINISH KEY AND SPECS FOR MORE INFORMATION.

HUNT ENGINEERS | ARCHITECTS | SURVEYORS  
HORSEHEADS, NY 607-268-1000 ROCHESTER, NY 585-337-7868 TOWANDA, PA 570-265-4606  
BINGHAMTON, NY 607-738-8881 ALBANY, NY 607-738-8801  
WWW.HUNTEAS.COM  
NY CERTIFICATE NO. 0016220 PA CERTIFICATE NO. TSC2200131464-1

REFLECTED CEILING PLAN - AREA A  
2025 MIDDLE SCHOOL PHASE III ALTERATIONS PROJECT  
CORNING-PAINTED POST ASD  
35 VICTORY HIGHWAY, PAINTED POST, NY 14870

MS-A2.1  
PROJECT NO: 2649-133


57-10-00-01-0004-04 - MIDDLE SCHOOL

REFLECTED CEILING PLAN - AREA A  
2025 MIDDLE SCHOOL PHASE III ALTERATIONS PROJECT  
CORNING-PAINTED POST ASD  
35 VICTORY HIGHWAY, PAINTED POST, NY 14870

REFLECTED CEILING PLAN - AREA A  
2025 MIDDLE SCHOOL PHASE III ALTERATIONS PROJECT  
CORNING-PAINTED POST ASD  
35 VICTORY HIGHWAY, PAINTED POST, NY 14870

HUNT ENGINEERS | ARCHITECTS | SURVEYORS  
HORSEHEADS, NY 607-268-1000 ROCHESTER, NY 585-337-7868 TOWANDA, PA 570-265-4606  
BINGHAMTON, NY 607-738-8881 ALBANY, NY 607-738-8801  
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**GENERAL NOTES:**

REFER TO DRAWING MS-A2.1 FOR GENERAL PLAN NOTES.

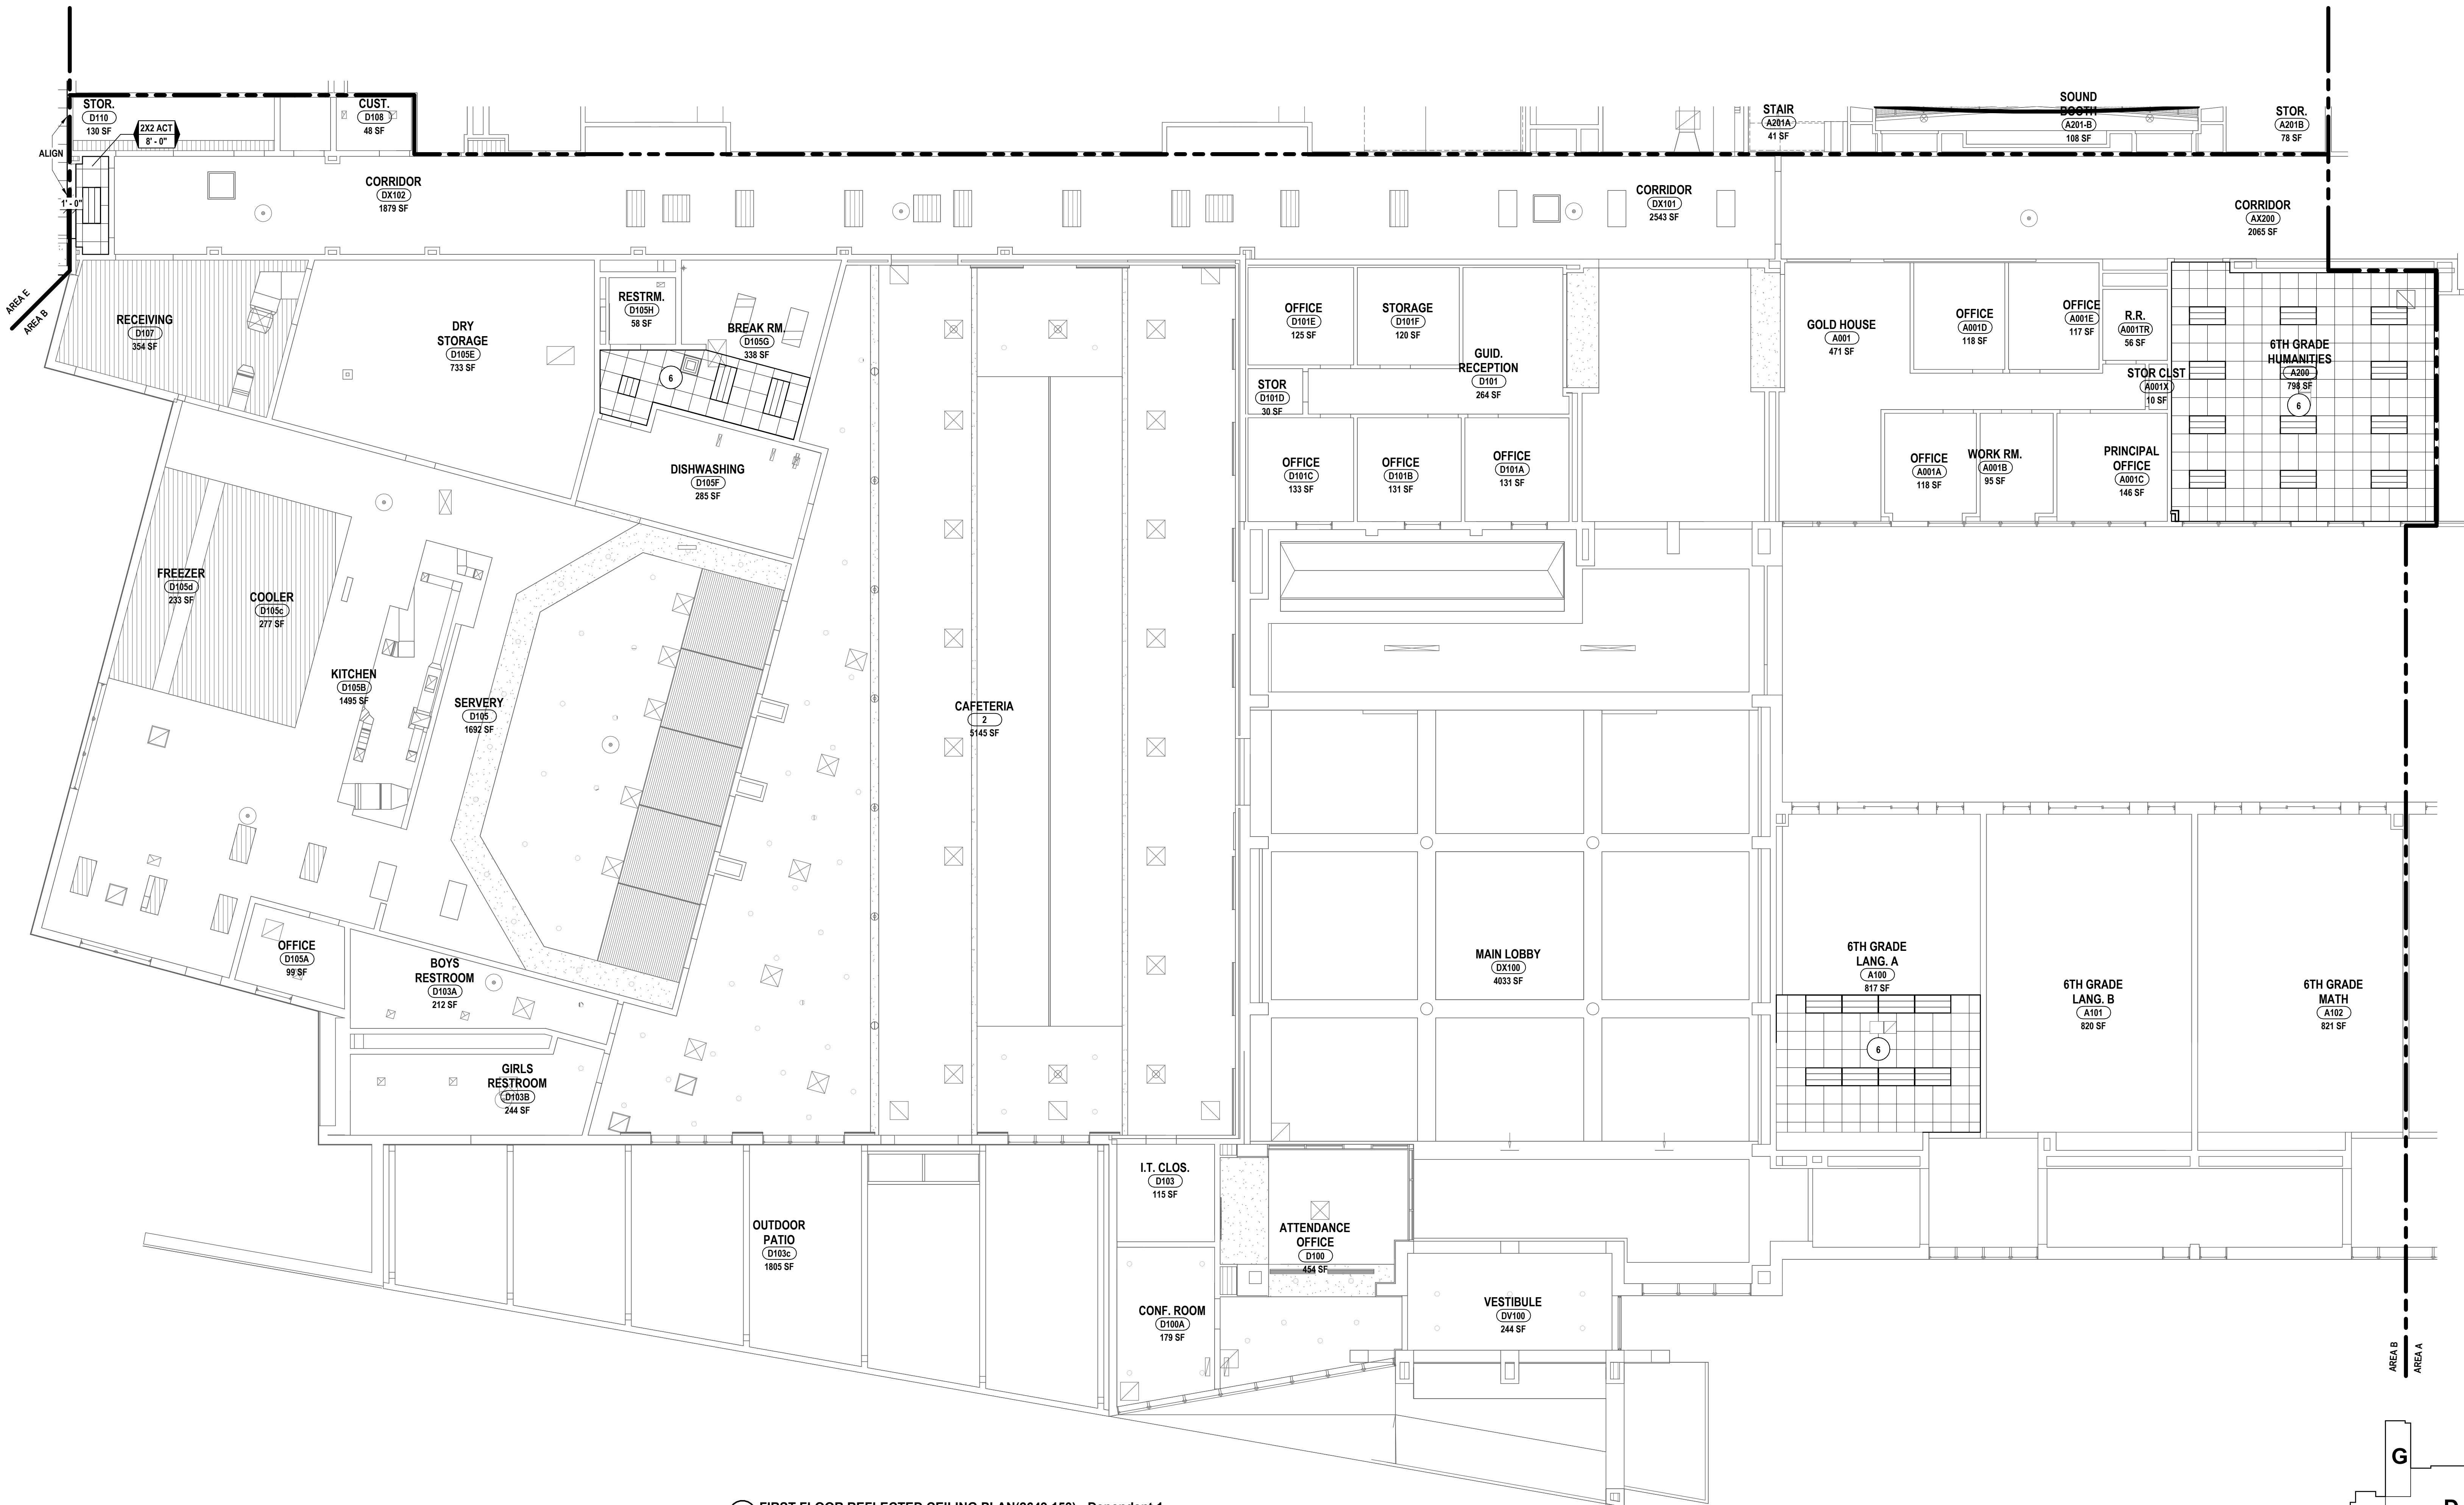**# REFLECTED CEILING PLAN  
DRAWING NOTES:**

- 1 REINSTALL EXG. CEILING AS REQUIRED TO ACCOMMODATE NEW CONSTRUCTION.
- 2 PROVIDE BREAK METAL TRIM AROUND ENTIRE SKYLIGHT OPENING. SEE 6/MS-A2.6.
- 3 PROVIDE ACOUSTICAL SPRAY. REFER TO SPEC.
- 4 REINSTALL SALVAGED PORTIONS CEILING AFTER COMPLETION OF HVAC WORK TO MATCH EXG EXISTING CEILING HEIGHT. SEE "H" DWGS.
- 5 REINSTALL CEILING AS REQUIRED TO ACCOMMODATE WALL FINISH SCOPE.
- 6 REINSTALL EXG. CEILING AND EXTENT TO MEET NEW CONSTRUCTION.
- 7 REMOVE RUST, CLEAN, AND PAINT CORRODED METAL DECK.
- 8 PROVIDE CEILING CLOUD ACOUSTIC BAFFLES. REFER TO A8 DRAWINGS, FINISH KEY AND SPECS FOR MORE INFORMATION.
- 9 PROVIDE CEILING CLOUD ACOUSTIC PANELS. REFER TO A8 DRAWINGS, FINISH KEY AND SPECS FOR MORE INFORMATION.

DRAWN BY:	MBH
CHECKED BY:	SZ
DATE:	05/09/2025
PHASE:	CD
#	1
DATE:	11/03/2025
DESCRIPTION OF REVISION:	ISSUED FOR BID
IT IS A VIOLATION OF THE LAW FOR ANY PERSON TO MAKE UNAUTHORIZED ALTERATIONS OR ADDITIONS TO PLANS DRAWN BY A LICENSED SURVEYOR. EXCEPT AS SHOWN ON THESE PLANS.	

**HUNT** ENGINEERS | ARCHITECTS | SURVEYORS

HORSEHEADS, NY 607-263-1000 ROCHESTER, NY 585-537-7549 TOWNANDRA, PA 570-265-4606  
BINGHAMTON, NY 607-738-8881 ALBANY, NY 607-738-8801  
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NY CERTIFICATE NO. 0016220 PA CERTIFICATE NO. TSC2202013464-1


REFLECTED CEILING PLAN - AREA B  
2025 MIDDLE SCHOOL PHASE III ALTERATIONS PROJECT  
CORNING-PAINTED POST ASD

35 VICTORY HIGHWAY, PAINTED POST, NY 14870

57-10-00-01-002-044 - MIDDLE SCHOOL

**MS-A2.2**

PROJECT NO: 2649-153

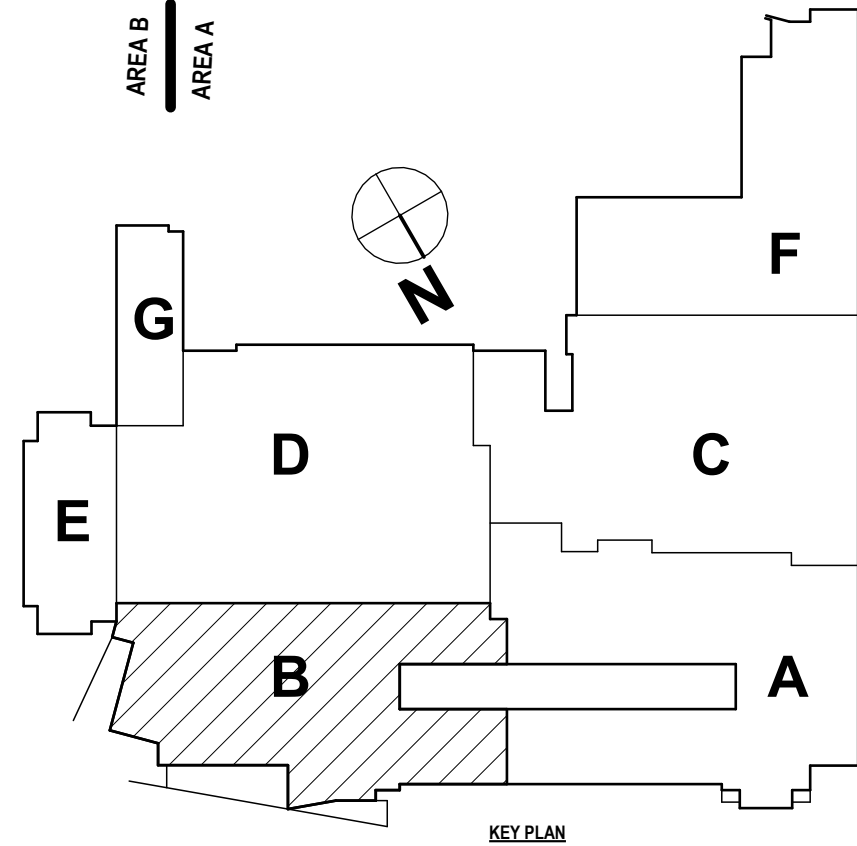

**1 FIRST FLOOR REFLECTED CEILING PLAN(2649.153) - Dependent 1**  
1/8" = 1'-0"




GENERAL NOTES:

REFER TO DRAWING MS-A2.1 FOR GENERAL PLAN NOTES.

REFLECTED CEILING PLAN  
# DRAWING NOTES:

- 1 REINSTALL EXG. CEILING AS REQUIRED TO ACCOMMODATE NEW CONSTRUCTION.
- 2 PROVIDE BREAK METAL TRIM AROUND ENTIRE SKYLIGHT OPENING. SEE 6/MS-A2.6.
- 3 PROVIDE ACOUSTICAL SPRAY. REFER TO SPEC.
- 4 REINSTALL SALVAGED PORTIONS CEILING AFTER COMPLETION OF HVAC WORK TO MATCH EXG EXISTING CEILING HEIGHT. SEE "H" DWGS.
- 5 REINSTALL CEILING AS REQUIRED TO ACCOMMODATE WALL FINISH SCOPE.
- 6 REINSTALL EXG. CEILING AND EXTENT TO MEET NEW CONSTRUCTION.
- 7 REMOVE RUST, CLEAN, AND PAINT CORRODED METAL DECK.
- 8 PROVIDE CEILING CLOUD ACOUSTIC BAFFLES. REFER TO A8 DRAWINGS, FINISH KEY AND SPECS FOR MORE INFORMATION.
- 9 PROVIDE CEILING CLOUD ACOUSTIC PANELS. REFER TO A8 DRAWINGS, FINISH KEY AND SPECS FOR MORE INFORMATION.

CEILING FINISH LEGEND:

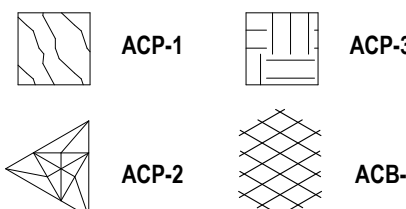

DRAWN BY: PSP  
CHECKED BY: MS  
DATE: 05/09/2025  
PHASE: CD

DESCRIPTION OF REVISION:  
# DATE: 1 11/03/2025  
ISSUED FOR BID

IT IS A VIOLATION OF THE LAW FOR ANY PERSON TO MAKE UNAUTHORIZED ALTERATIONS OR ADDITIONS TO PLANS  
DRAWING A LICENSED ARCHITECT'S SEAL

**HUNT** ENGINEERS | ARCHITECTS | SURVEYORS  
HORSEHEADS, NY 607-263-1000 ROCHESTER, NY 585-337-7569 TOWNAND, PA 570-265-4606  
BINGHAMTON, NY 607-738-8881 ALBANY, NY 807-738-8801  
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NY CERTIFICATE NO. 0016220 PA CERTIFICATE NO. TSC220013464-1

REFLECTED CEILING PLAN - AREA C  
2025 MIDDLE SCHOOL PHASE III ALTERATIONS PROJECT  
CORNING-PAINTED POST ASD  
35 VICTORY HIGHWAY, PAINTED POST, NY 14870

MS-A2.3

PROJECT NO: 2649-153



1 FIRST FLOOR REFLECTED CEILING PLAN - AREA C  
1/8" = 1'-0"



GENERAL NOTES:



REFER TO DRAWING MS-A2.1 FOR GENERAL PLAN NOTES.

REFLECTED CEILING PLAN


# DRAWING NOTES:

- 1 REINSTALL EXG. CEILING AS REQUIRED TO ACCOMMODATE NEW CONSTRUCTION.
- 2 PROVIDE BREAK METAL TRIM AROUND ENTIRE SKYLIGHT OPENING. SEE 6IMS-A2.6.
- 3 PROVIDE ACOUSTICAL SPRAY, REFER TO SPEC.
- 4 REINSTALL SALVAGED PORTIONS CEILING AFTER COMPLETION OF HVAC WORK TO MATCH EXG EXISTING CEILING HEIGHT. SEE "H" DWGS.
- 5 REINSTALL CEILING AS REQUIRED TO ACCOMMODATE WALL FINISH SCOPE.
- 6 REINSTALL EXG. CEILING AND EXTENT TO MEET NEW CONSTRUCTION.
- 7 REMOVE RUST, CLEAN, AND PAINT CORRODED METAL DECK.
- 8 PROVIDE CEILING CLOUD ACOUSTIC BAFFLES. REFER TO A8 DRAWINGS. FINISH KEY AND SPECS FOR MORE INFORMATION.
- 9 PROVIDE CEILING CLOUD ACOUSTIC PANELS. REFER TO A8 DRAWINGS. FINISH KEY AND SPECS FOR MORE INFORMATION.

CEILING FINISH LEGEND:

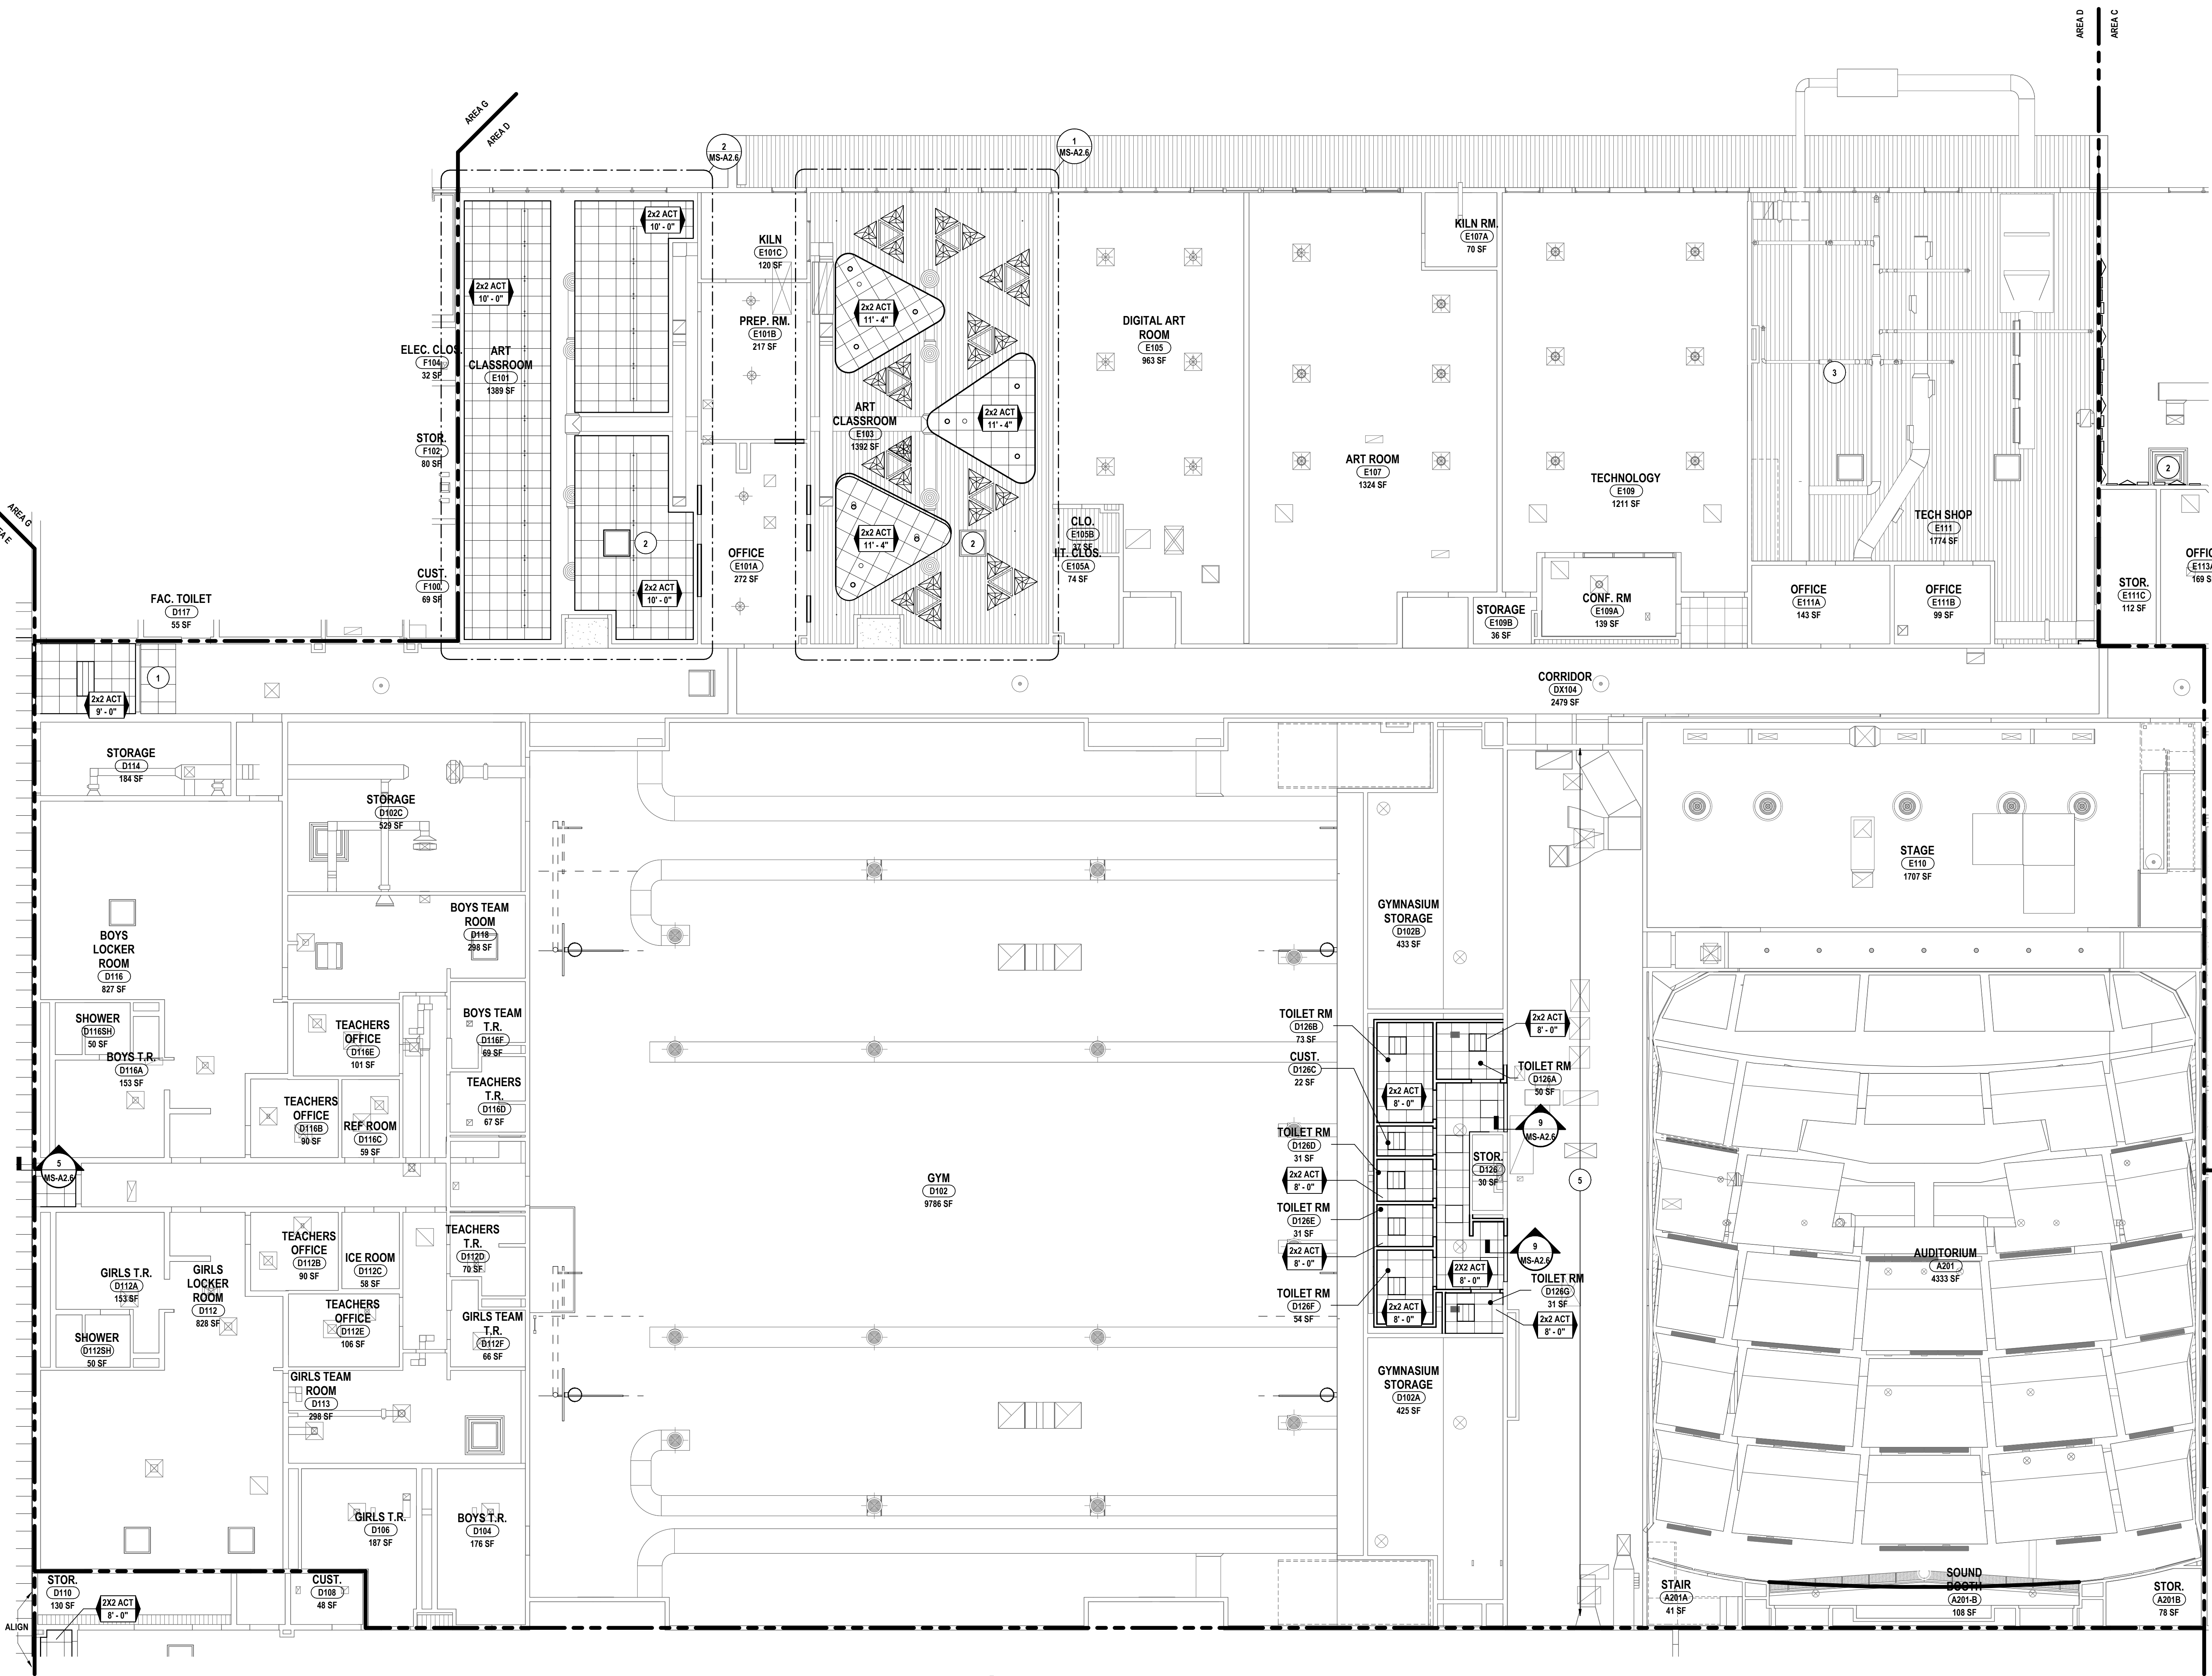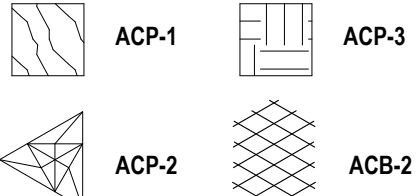

1 FIRST FLOOR REFLECTED CEILING PLAN - AREA D  
1/8" = 1'-0"

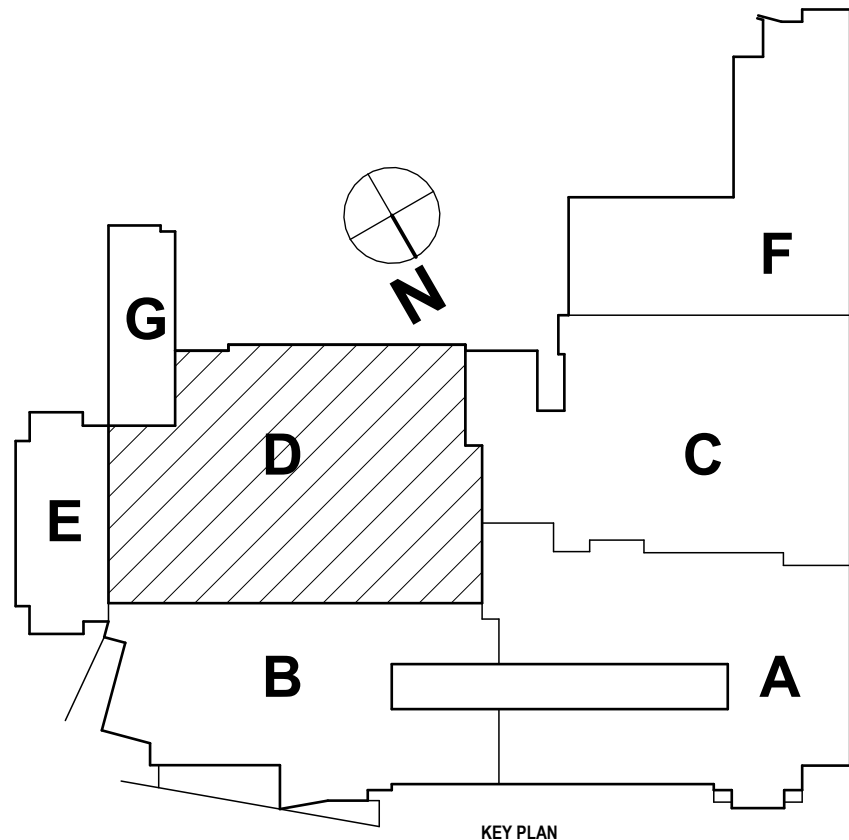

HUNT ENGINEERS | ARCHITECTS | SURVEYORS  
HORSEHEADS, NY 807-263-1000 ROCHESTER, NY 585-337-7569 TOWNHALL, PA 470-265-4606  
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NY CERTIFICATE NO. 0016220 PA CERTIFICATE NO. TSC220313464-1

REFLECTED CEILING PLAN - AREA D  
2025 MIDDLE SCHOOL PHASE III ALTERATIONS PROJECT  
CORNING-PAINTED POST ASD  
35 VICTORY HIGHWAY, PAINTED POST, NY 14870

MS-A2.4  
PROJECT NO: 2649-133

57-16-00-01-002-04-04 - MIDDLE SCHOOL

DRAWN BY: PSB  
CHECKED BY: MS  
DATE: 05/09/2025  
PHASE: CD

# DATE: 1 11/03/2025

DESCRIPTION OF REVISION:  
ISSUED FOR BID

IT IS A VIOLATION OF THE LAW FOR ANY PERSON TO MAKE UNAUTHORIZED ALTERATIONS OR ADDITIONS TO PLANS  
DRAWING & CALCULATIONS, ENGINEERING, ARCHITECT'S OR SURVEYOR'S SEAL.




GENERAL CEILING NOTES:

- A ALL CORRIDOR CEILINGS ARE TO BE 8'-4" UNLESS NOTED OTHERWISE. ALCOVES ARE TO BE 8'-0" U.N.O. AND ALL CLASSROOM CEILINGS TO BE 9'-0" A.F.F AT THE FIRST FLOOR AND SECOND FLOOR UNLESS NOTED OTHERWISE.
- B ALL SOFFITS TO BE 2" LOWER THAN CEILING HEIGHT UNLESS NOTED OTHERWISE.
- C CENTER ALL ELECTRICAL DEVICES WITHIN 2X2 CEILING TILES UNO.
- D REFER TO FINISH SCHEDULE FOR INDIVIDUAL CEILING TYPES.
- E VERIFY IN FIELD THE AMOUNT OF EXISTING LIGHTS TO BE REMOVED AND REINSTALLED.
- F ALL NEW CEILING SYSTEMS TO BE INSTALLED DIRECTLY TO STRUCTURE.
- G CENTER ALL MECHANICAL PENETRATIONS WITHIN CEILING TILES. UNLESS NOTED OTHERWISE.
- H COORDINATE ALL MECHANICAL DUCTWORK, PIPING, SPRINKLER LINES & CABLE TRAY TO AVOID CONFLICTS WITH LIGHTS AND STRUCTURE.
- I ARCHITECTURAL DRAWINGS TAKE PRECEDENCE OVER ENGINEERING DRAWINGS FOR LOCATION OF LIGHT FIXTURES& MECHANICAL LOUVERS. SEE ELECTRICAL AND MECHANICAL DRAWINGS FOR ALL FIXTURES.
- K ALL CEILINGS SHOWN ON THE PLAN ARE NEW CONSTRUCTION


REFLECTED CEILING PLAN

# DRAWING NOTES:

- 1 REINSTALL EXG. CEILING AS REQUIRED TO ACCOMMODATE NEW CONSTRUCTION.
- 2 PROVIDE BREAK METAL TRIM AROUND ENTIRE SKYLIGHT OPENING. SEE DMS-A2.6
- 3 PROVIDE ACOUSTICAL SPRAY, REFER TO SPEC.
- 4 REINSTALL SALVAGED PORTIONS CEILING AFTER COMPLETION OF HVAC WORK TO MATCH EXG EXISTING CEILING HEIGHT. SEE "H" DWGS.
- 5 REINSTALL CEILING AS REQUIRED TO ACCOMMODATE WALL FINISH SCOPE.
- 6 REINSTALL EXG. CEILING AND EXTENT TO MEET NEW CONSTRUCTION.
- 7 REMOVE RUST, CLEAN, AND PAINT CORRODED METAL DECK.
- 8 PROVIDE CEILING CLOUD ACOUSTIC BAPFLES. REFER TO A8 DRAWINGS. FINISH KEY AND SPECS FOR MORE INFORMATION.
- 9 PROVIDE CEILING CLOUD ACOUSTIC PANELS. REFER TO A8 DRAWINGS. FINISH KEY AND SPECS FOR MORE INFORMATION.

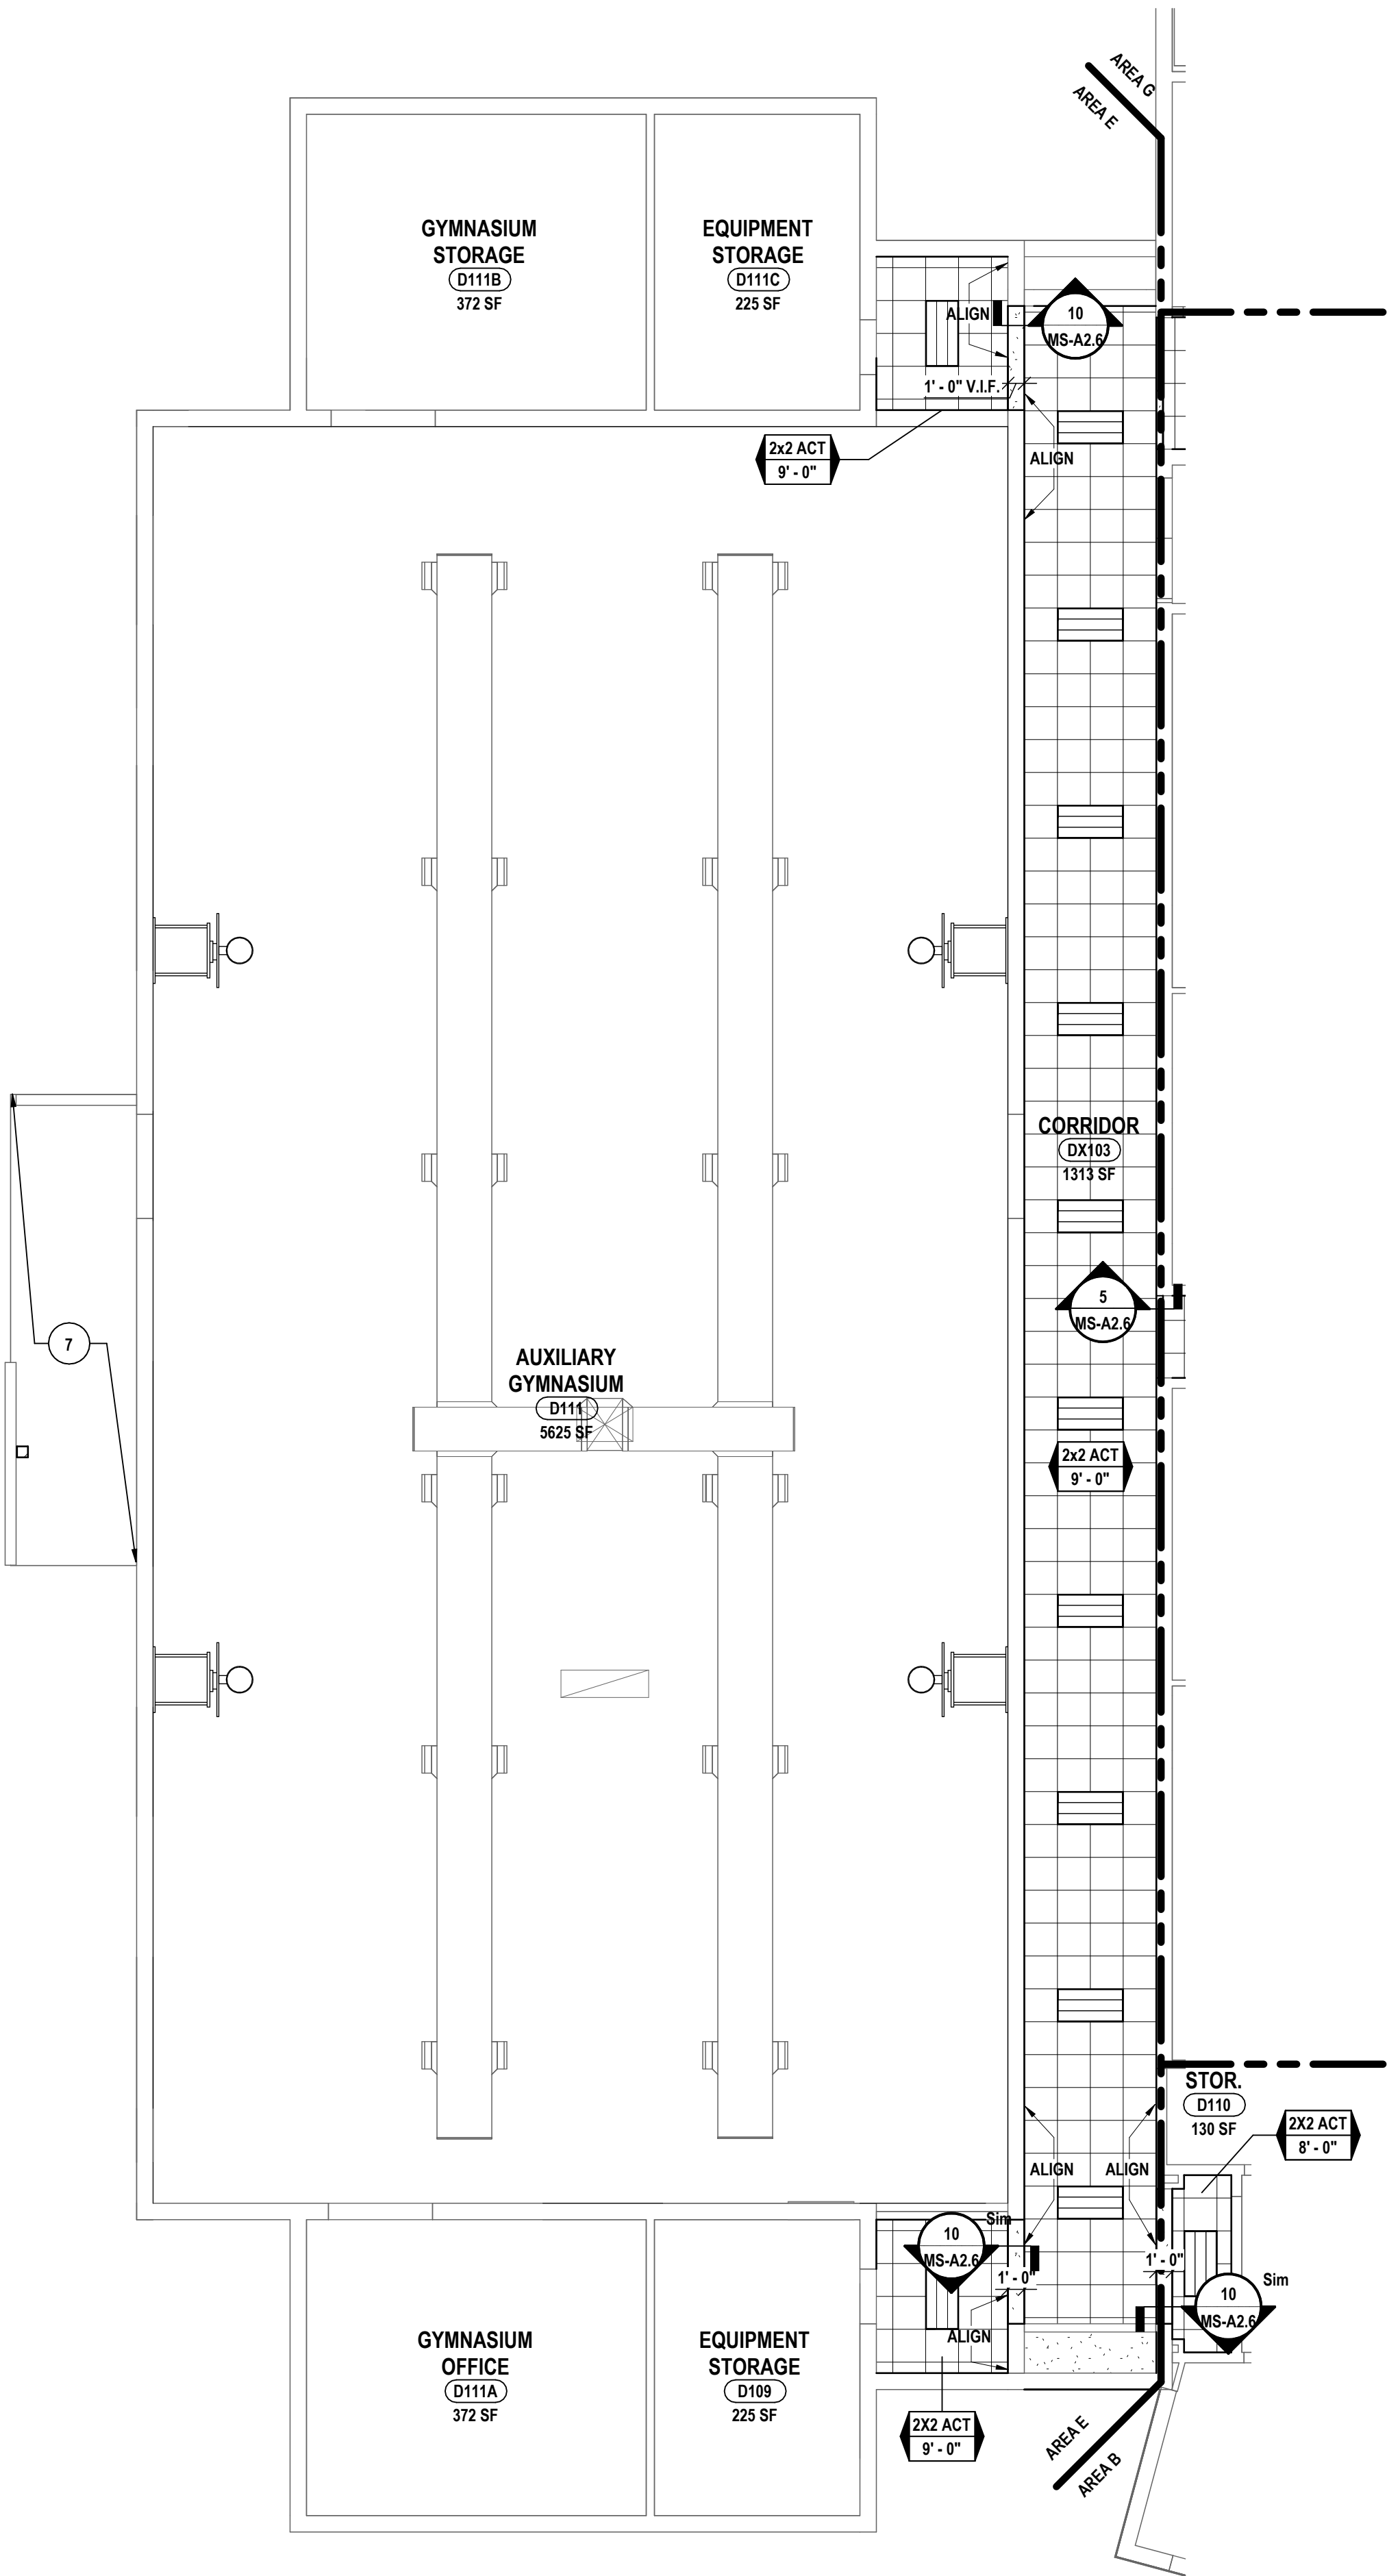

1 FIRST FLOOR REFLECTED CEILING PLAN - AREA E  
1/8" = 1'-0"

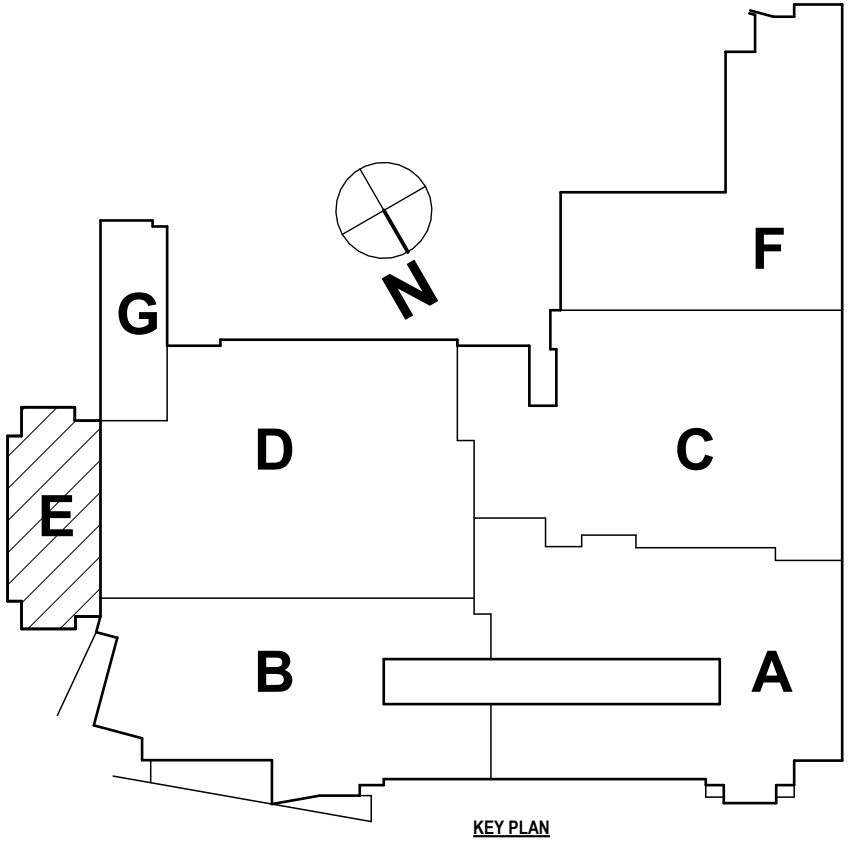

DESCRIPTION OF REVISION:

#	DATE	DESCRIPTION OF REVISION:
1	11/03/2023	ISSUED FOR BID

**HUNT** ENGINEERS | ARCHITECTS | SURVEYORS

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NY CERTIFICATE NO. 0016220 PA CERTIFICATE NO. TSC2220131464-1


REFLECTED CEILING PLAN - AREA E  
2025 MIDDLE SCHOOL PHASE III ALTERATIONS PROJECT  
CORNING-PAINTED POST ASD

35 VICTORY HIGHWAY, PAINTED POST, NY 14870


MS-A2.5

PROJECT NO: 2649-133




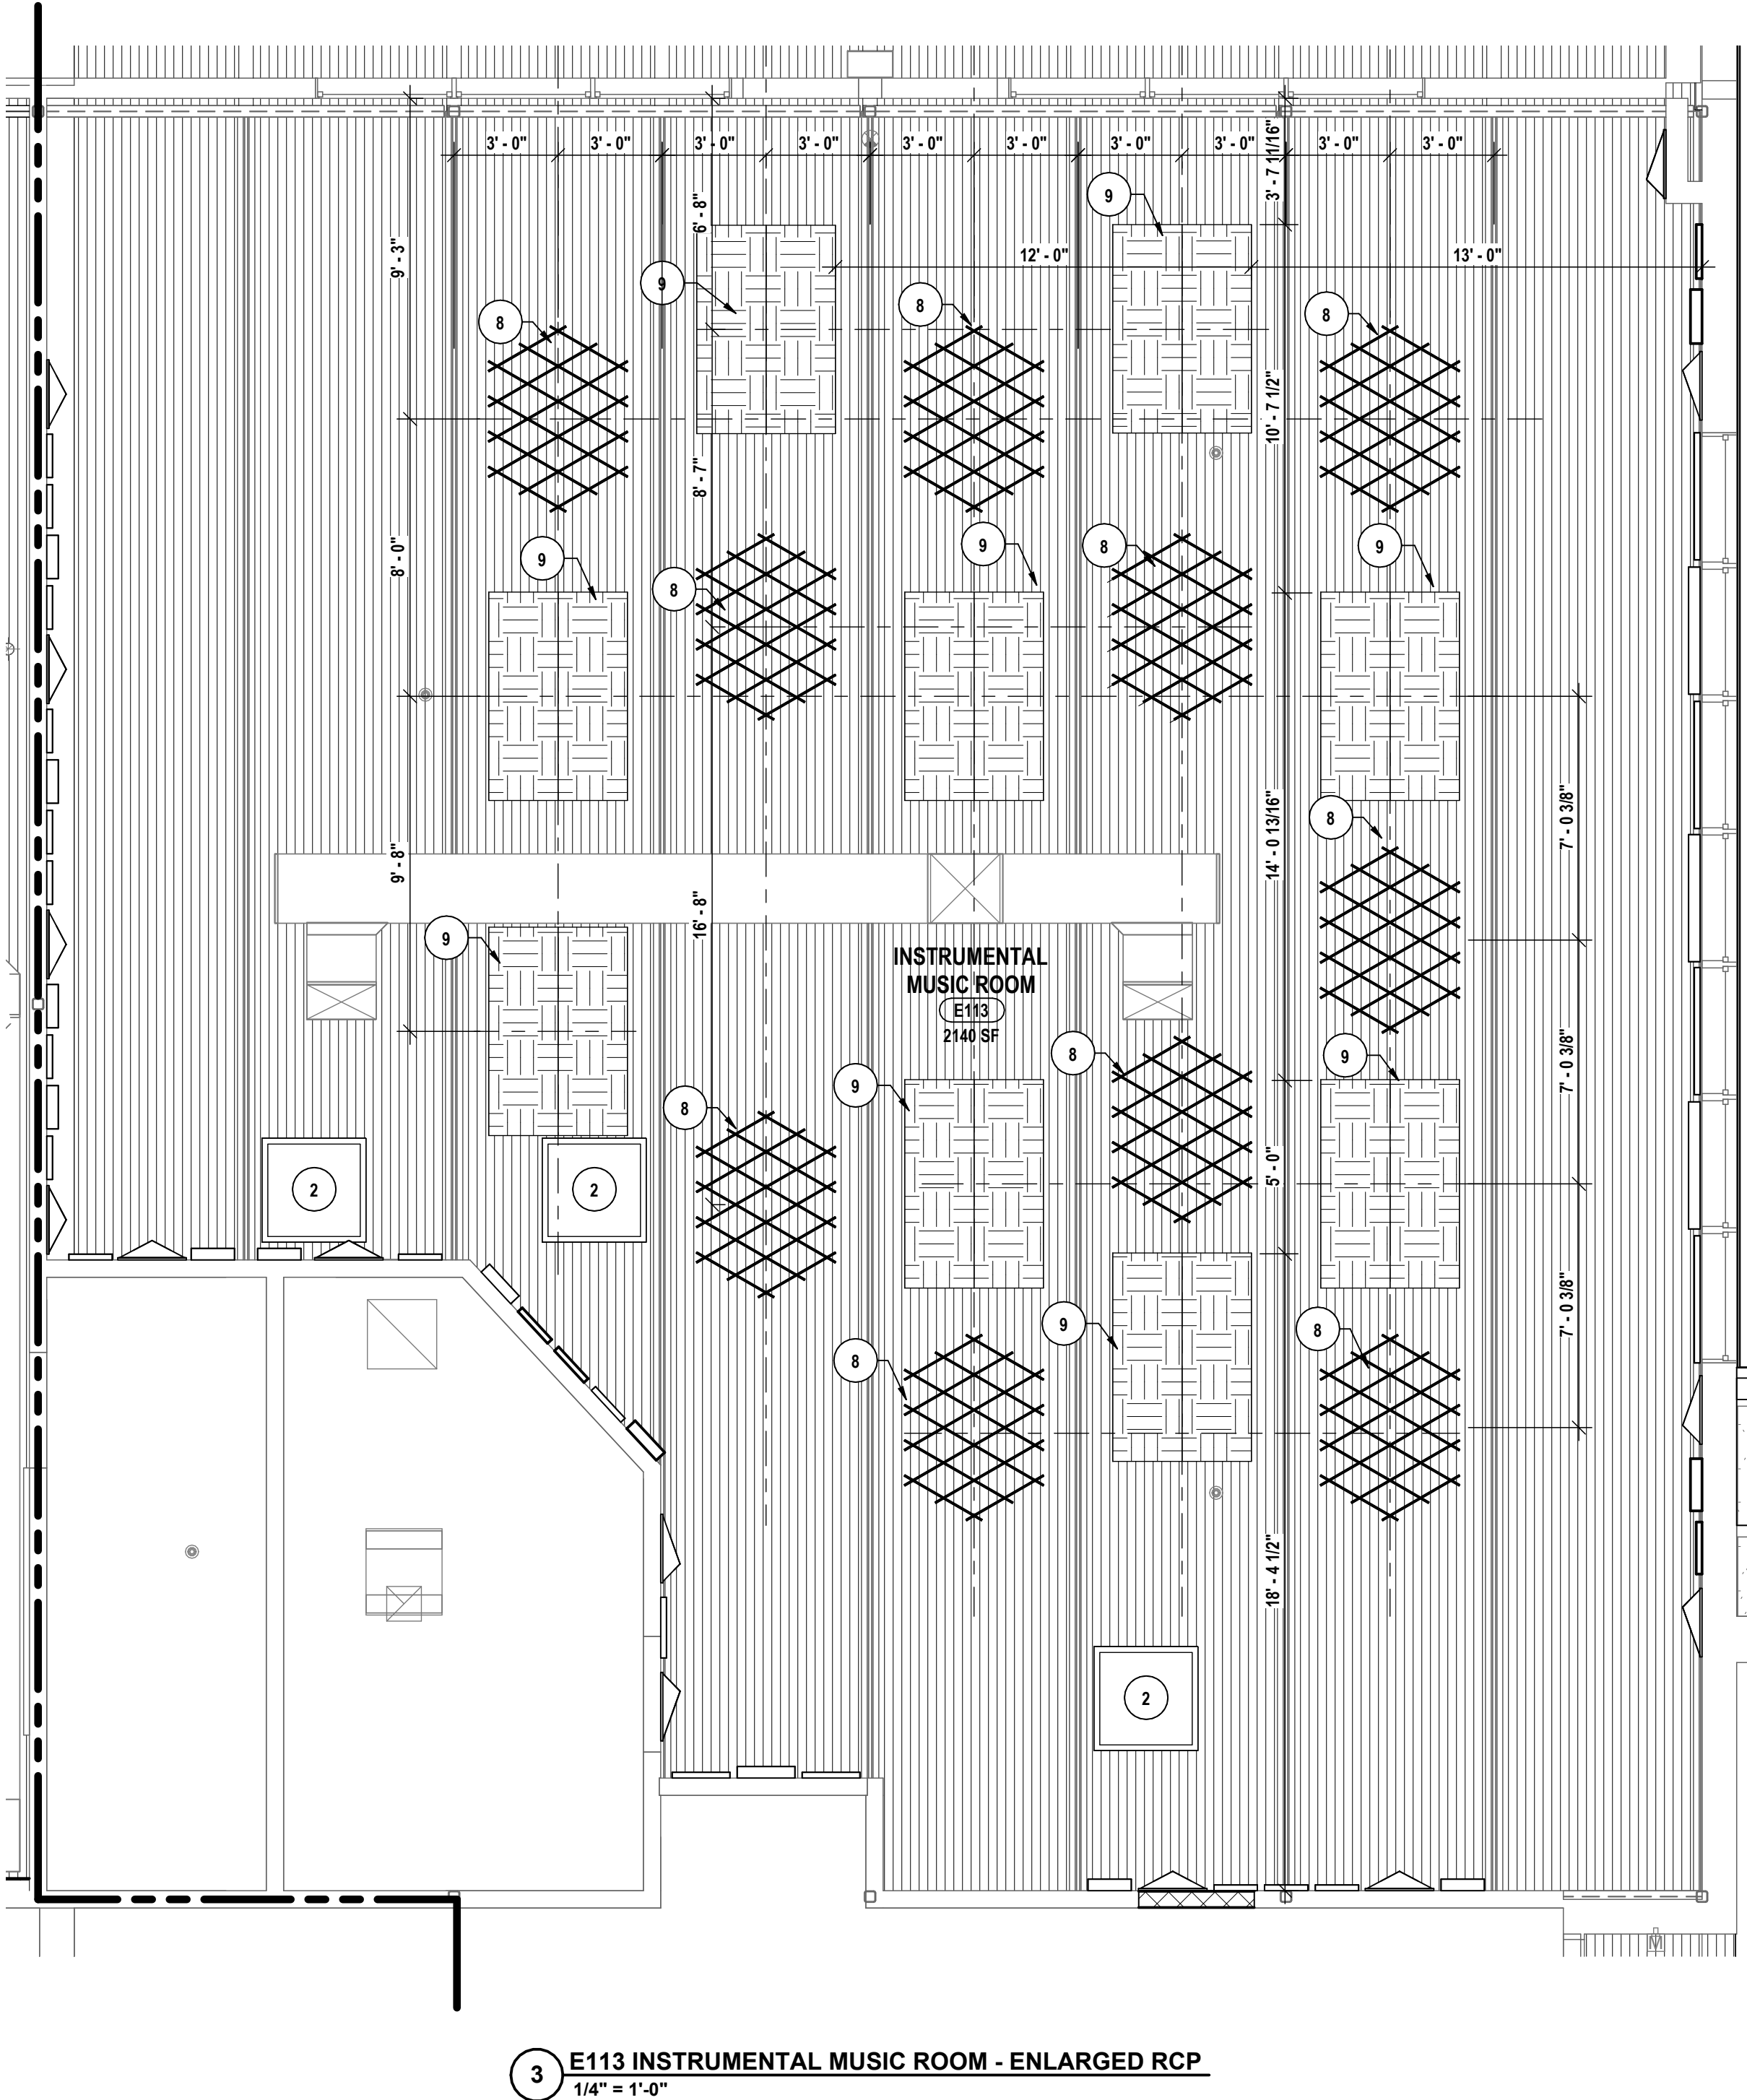


3 E113 INSTRUMENTAL MUSIC ROOM - ENLARGED RCP  
1/4" = 1'-0"

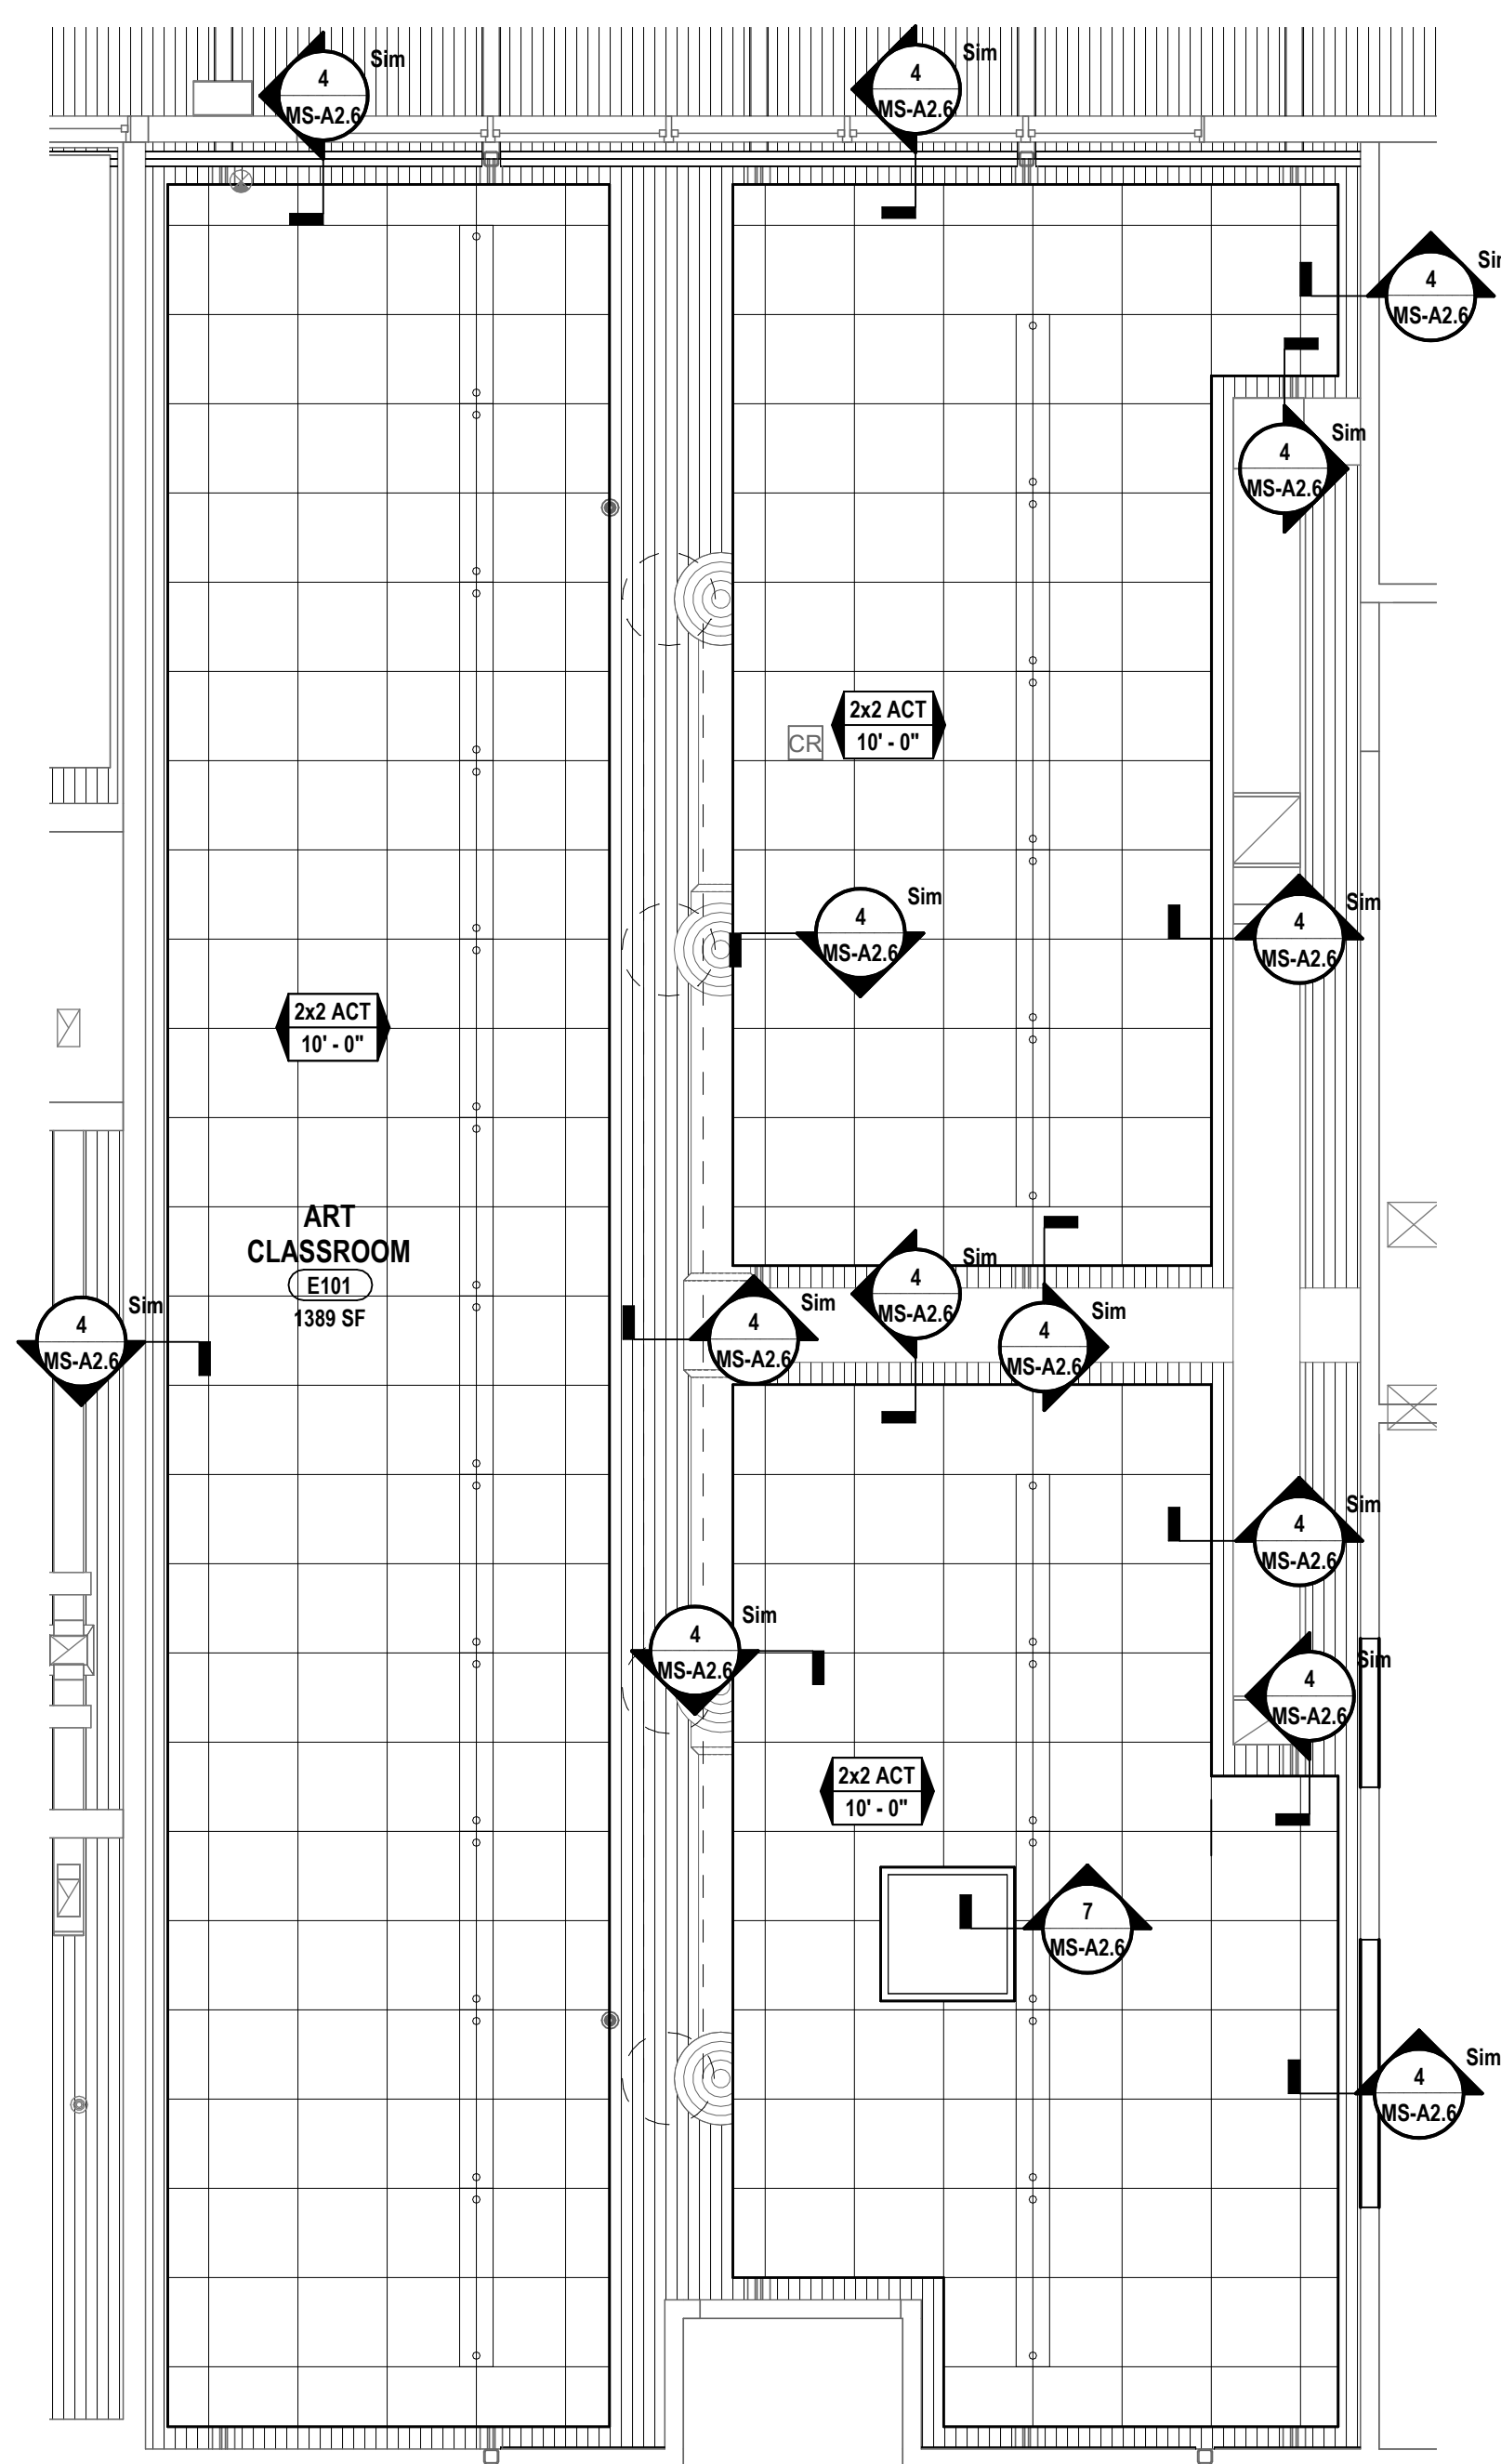


2 E101 ART CLASSROOM - ENLARGED RCP  
1/4" = 1'-0"

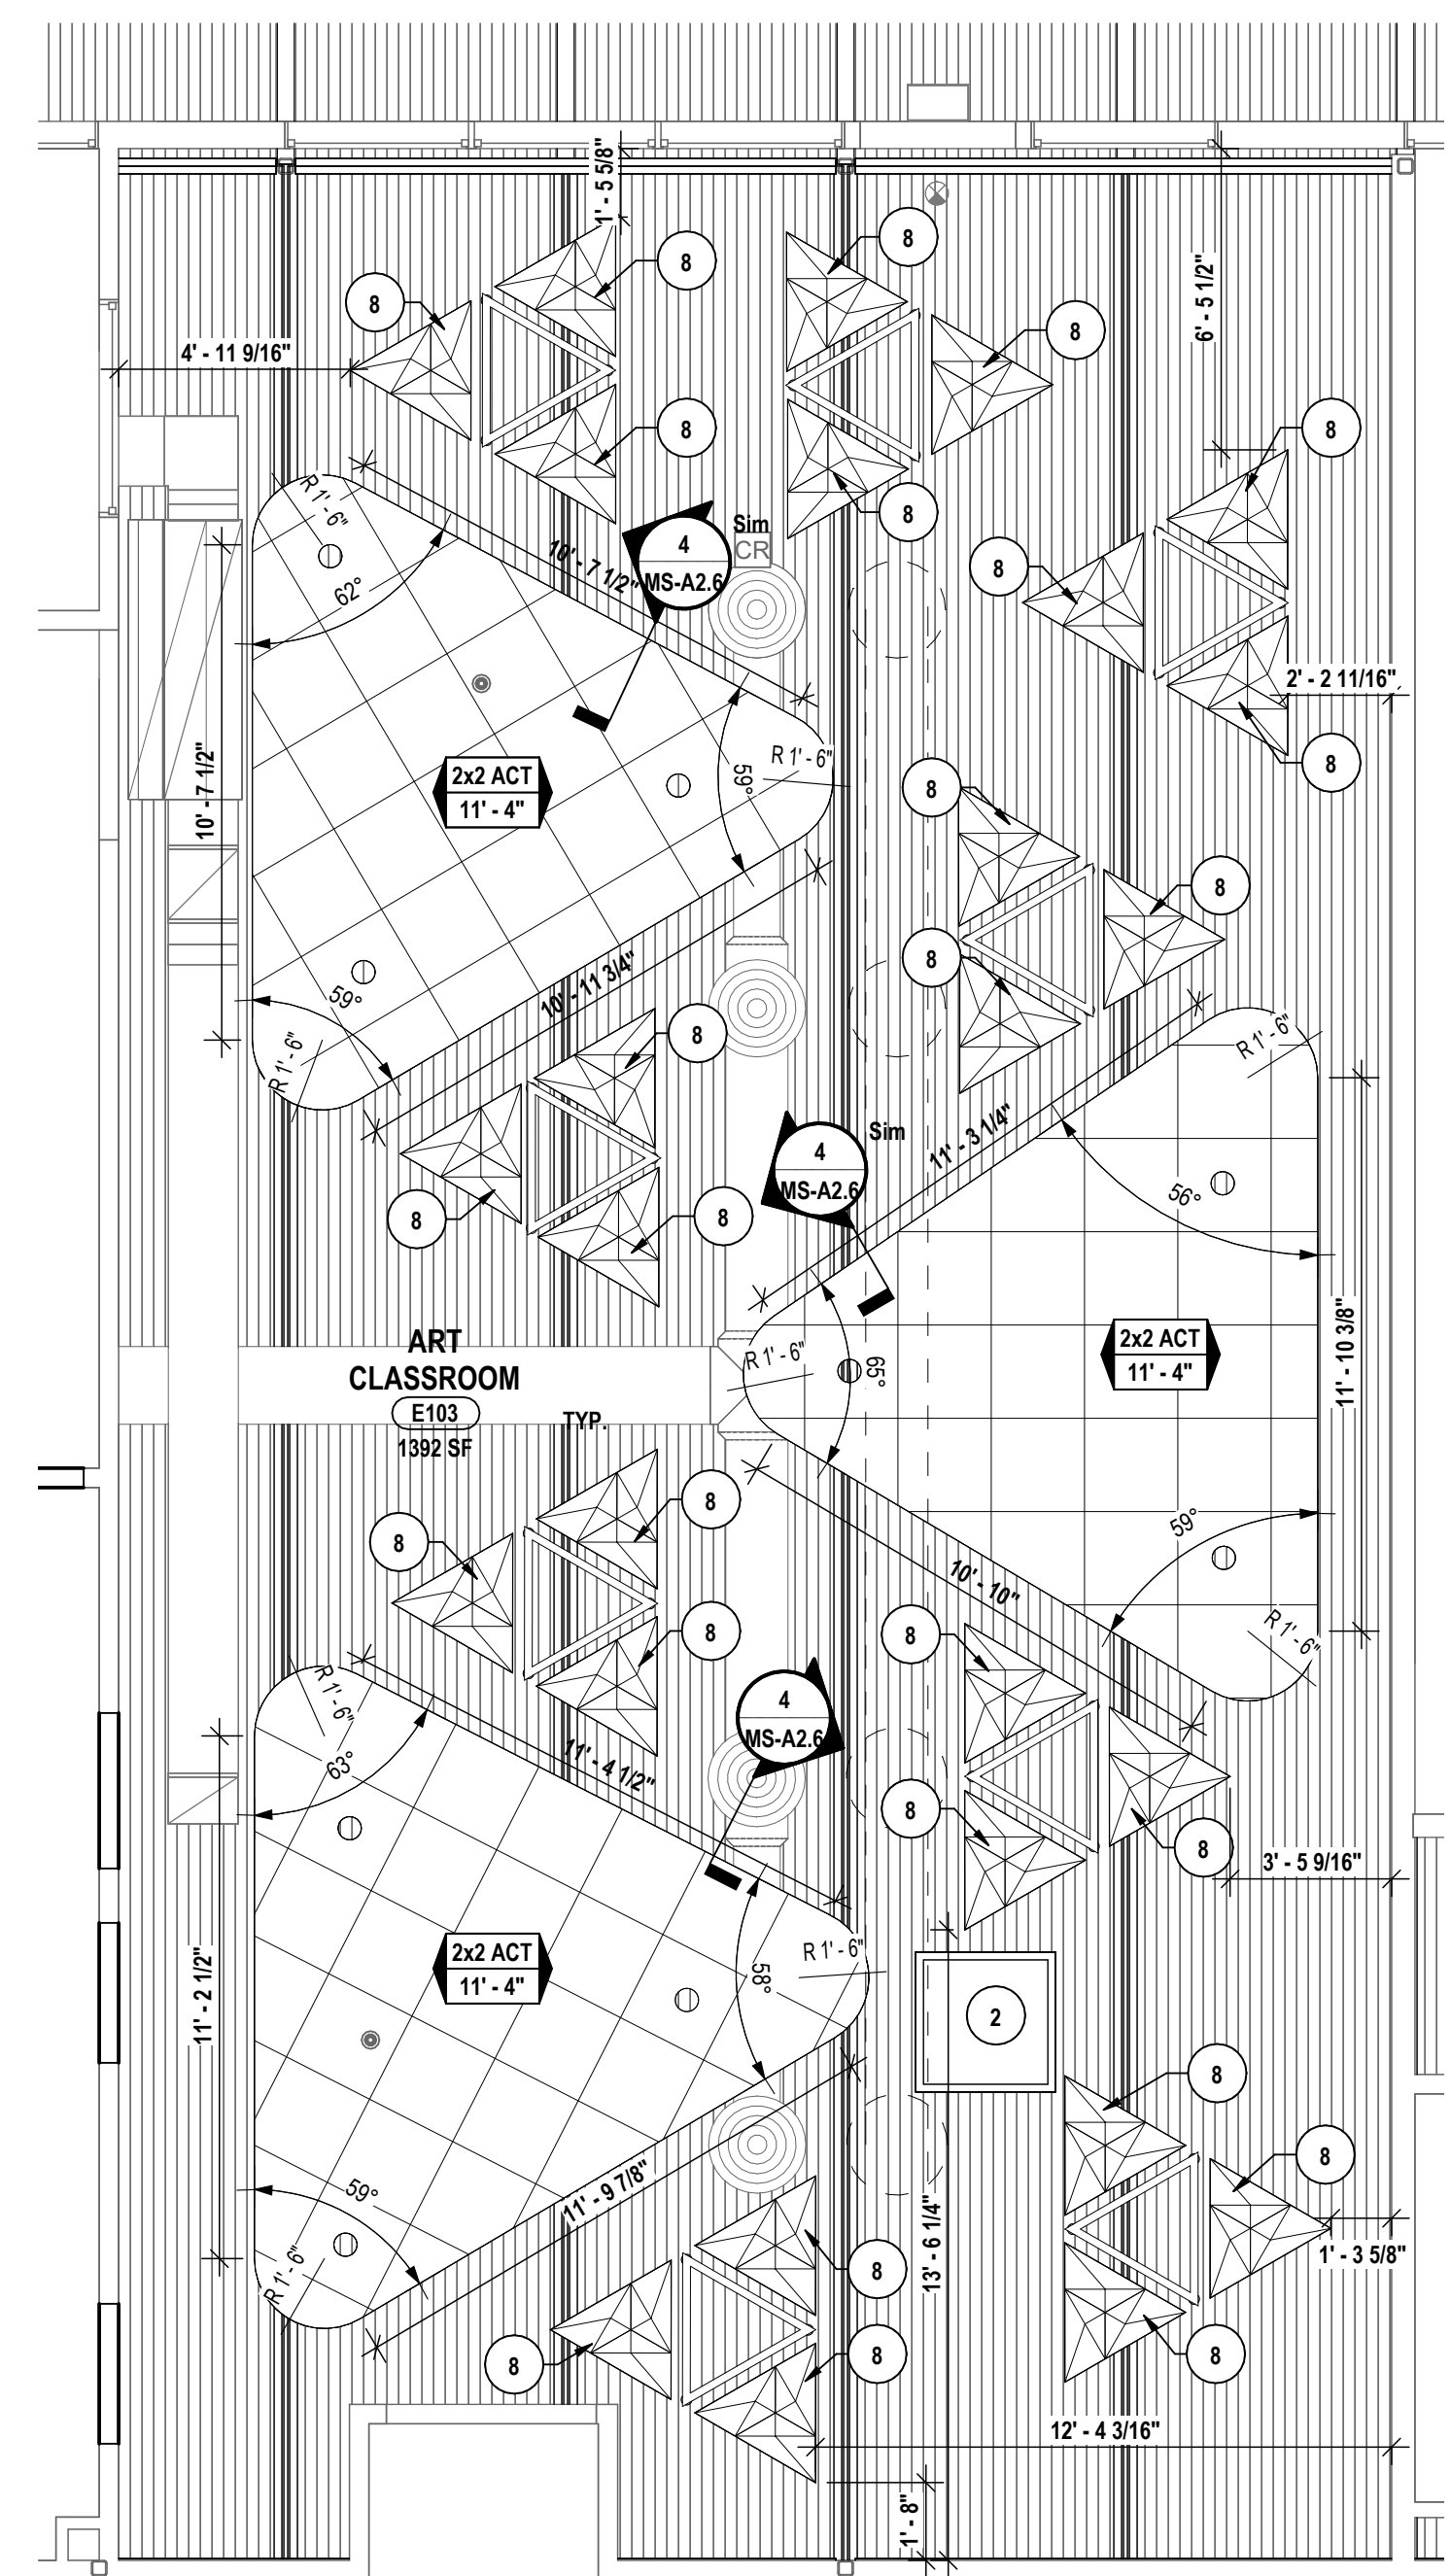


1 E103 ART CLASSROOM - ENLARGED RCP  
1/4" = 1'-0"

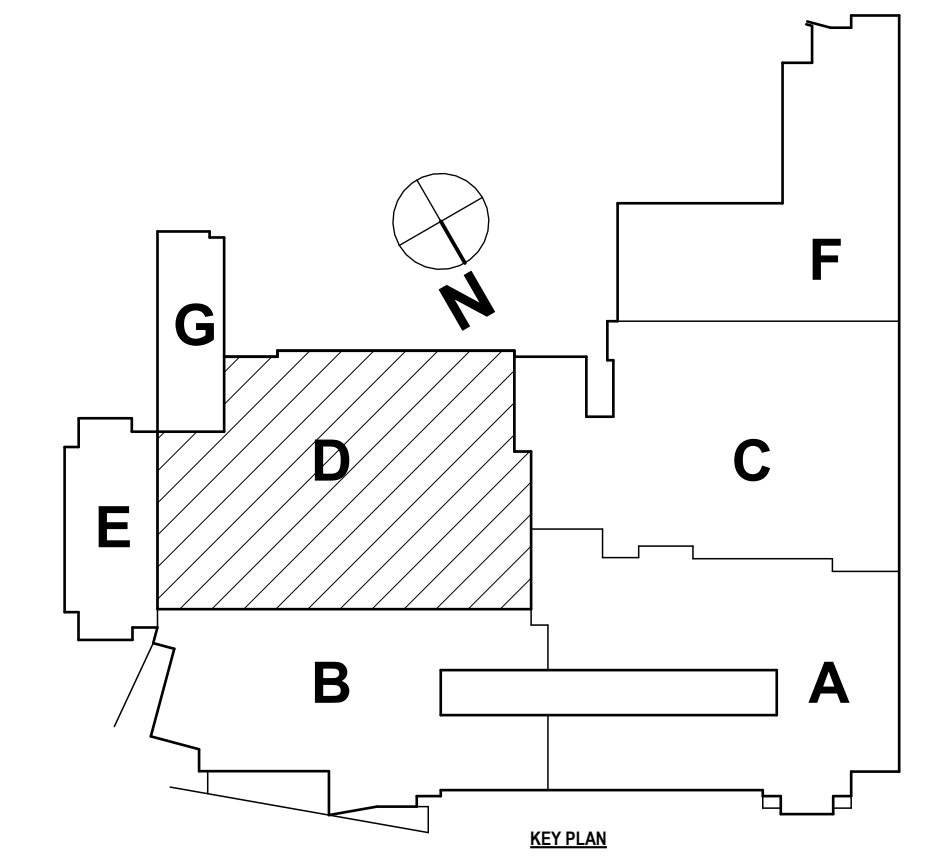


KEY PLAN

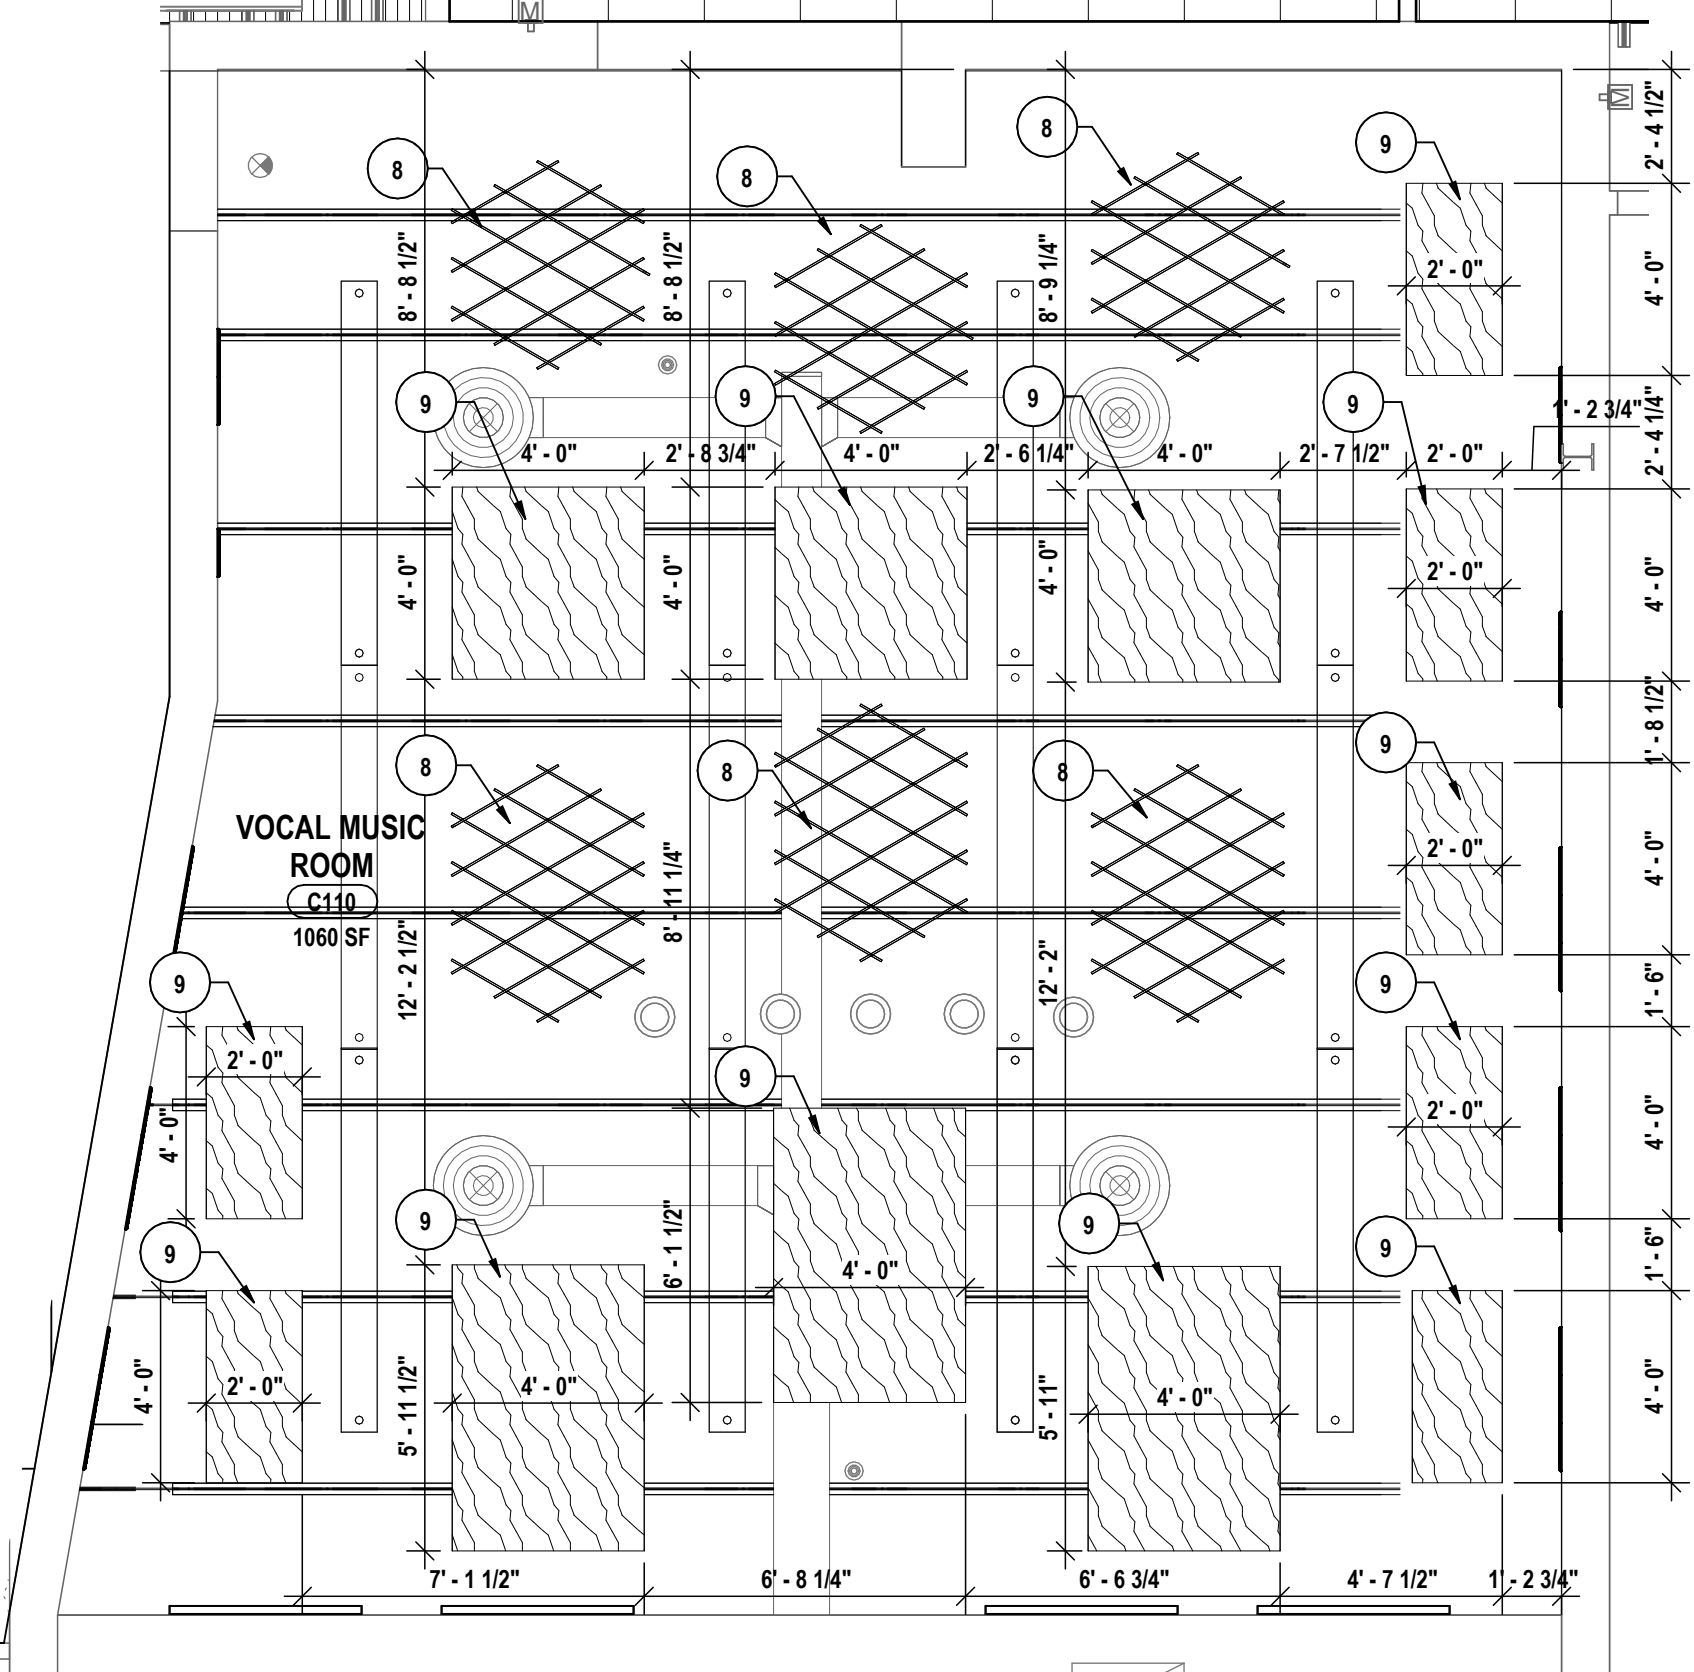


8 C110 VOCAL MUSIC ROOM - ENLARGED RCP  
1/4" = 1'-0"

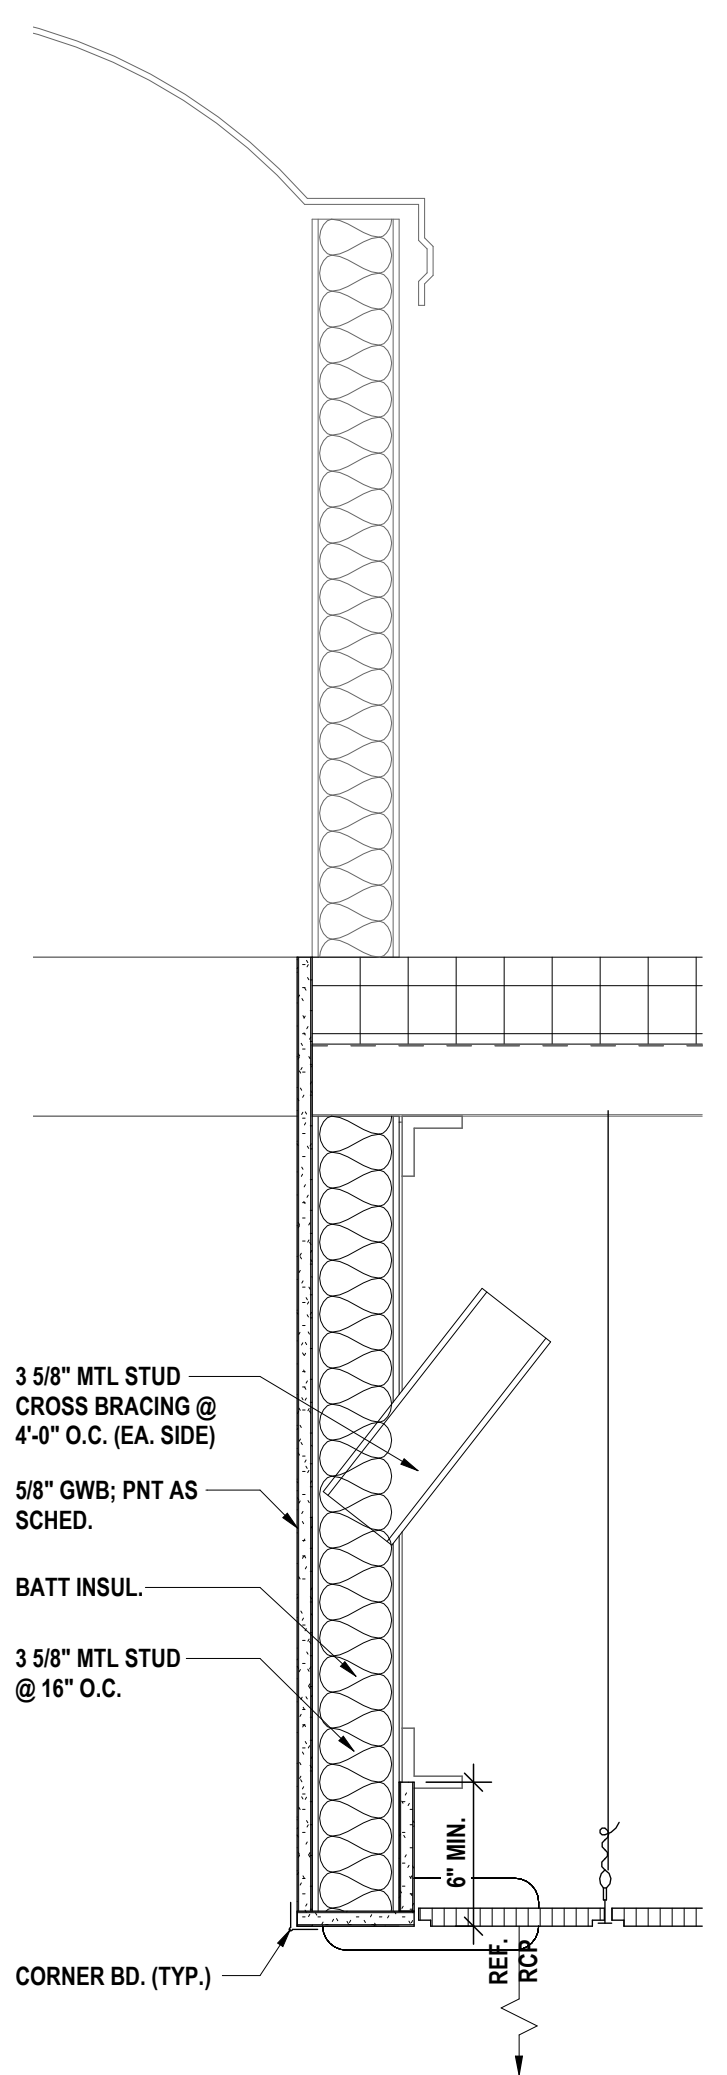


7 NEW CEILING AT EXISTING SKYLIGHT  
1 1/2" = 1'-0"

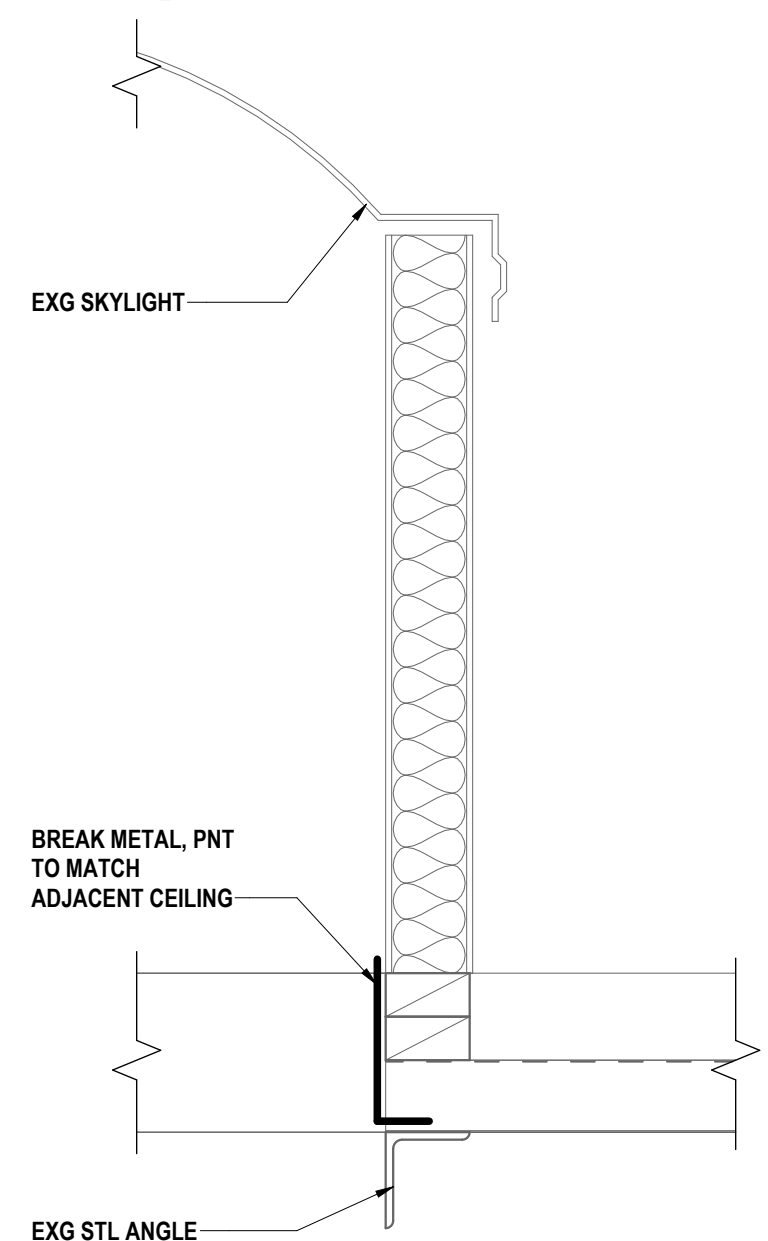


6 BREAK METAL AT EXISTING SKYLIGHT  
1 1/2" = 1'-0"

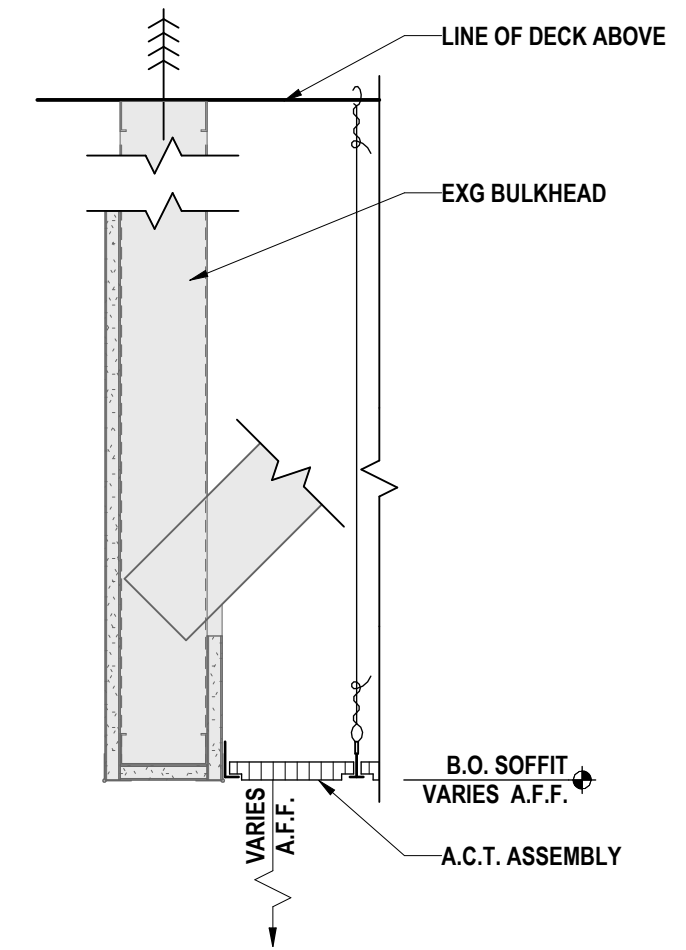


11 LIBRARY CEILING DETAIL 2  
1 1/2" = 1'-0"

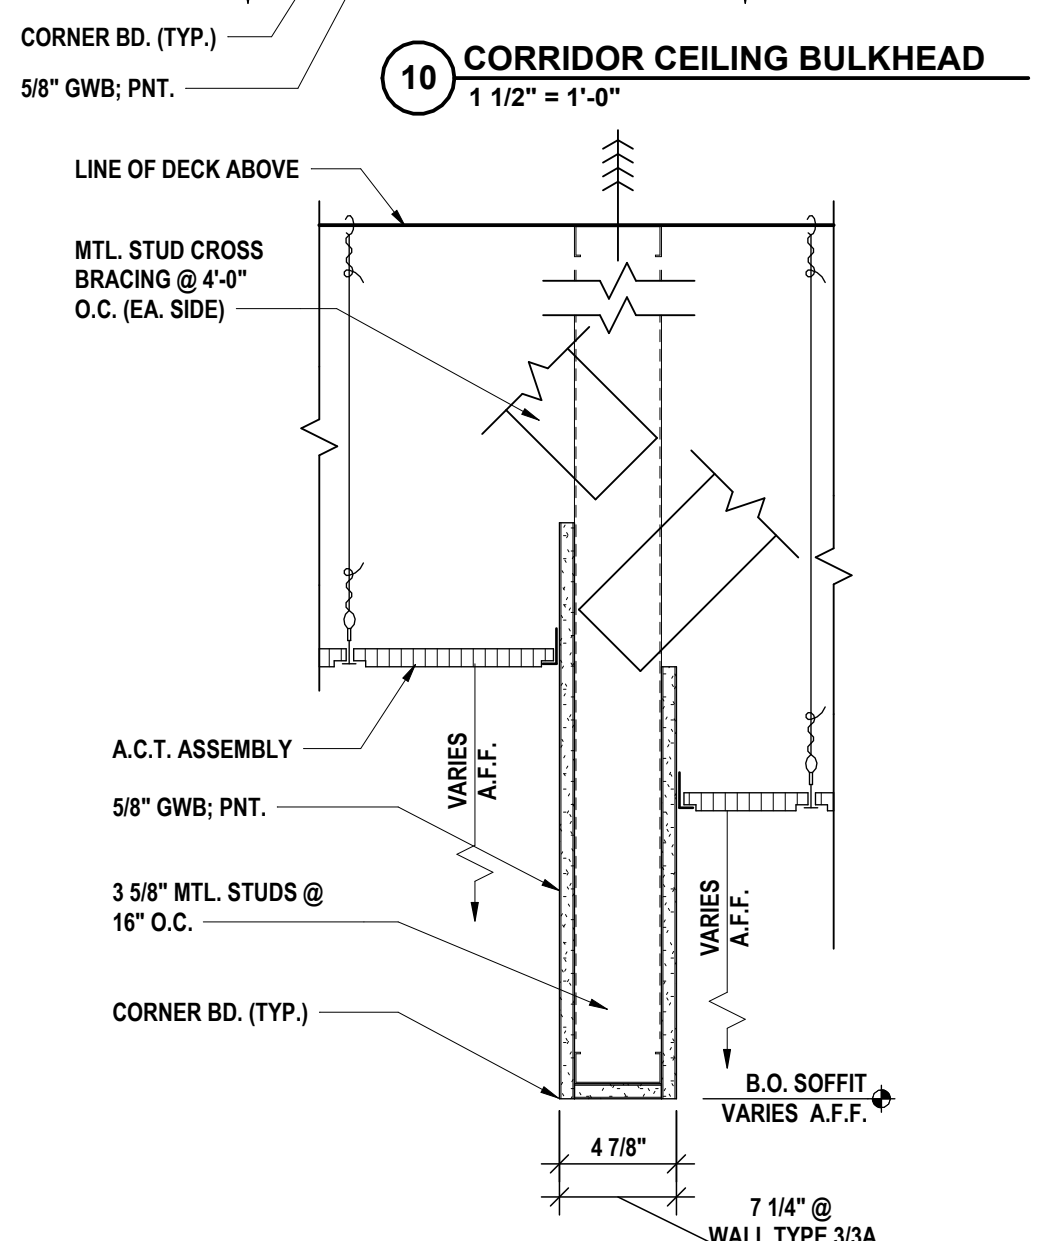


5 TYP. CEILING BULKHEAD  
1 1/2" = 1'-0"

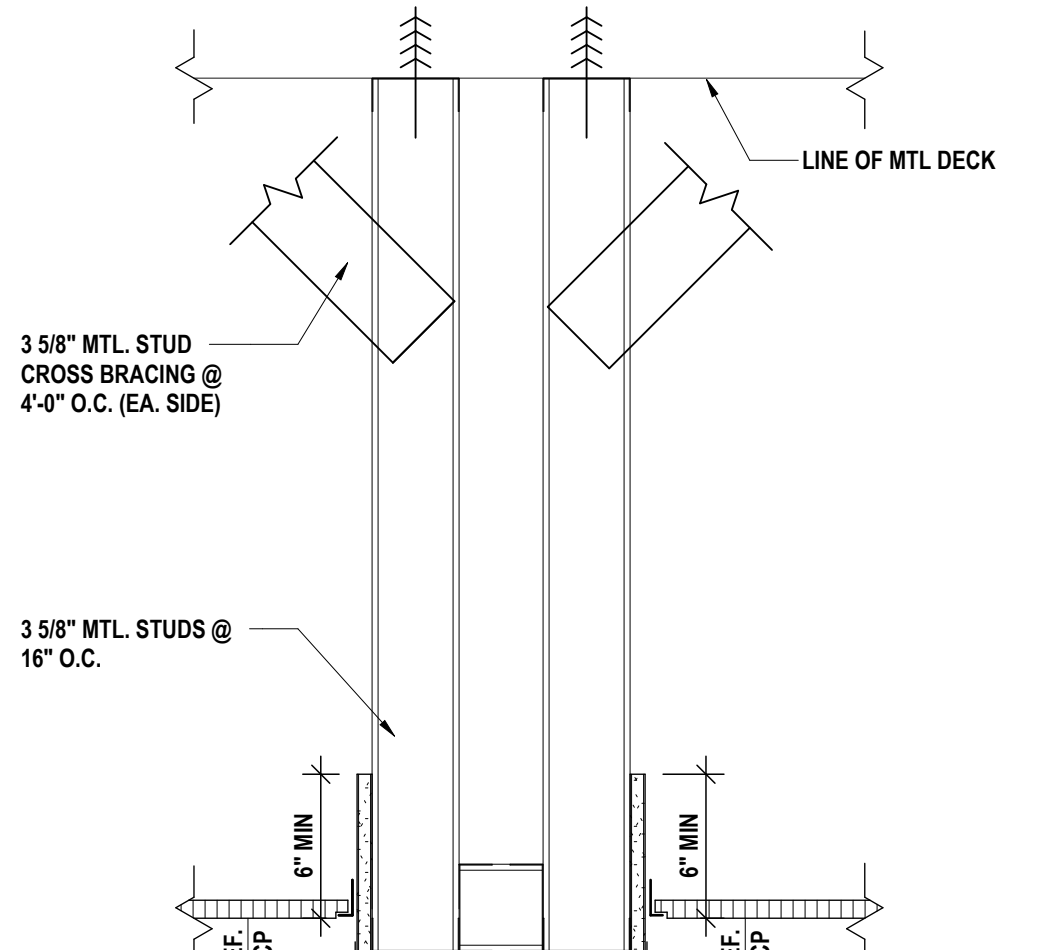

10 CORRIDOR CEILING BULKHEAD  
1 1/2" = 1'-0"

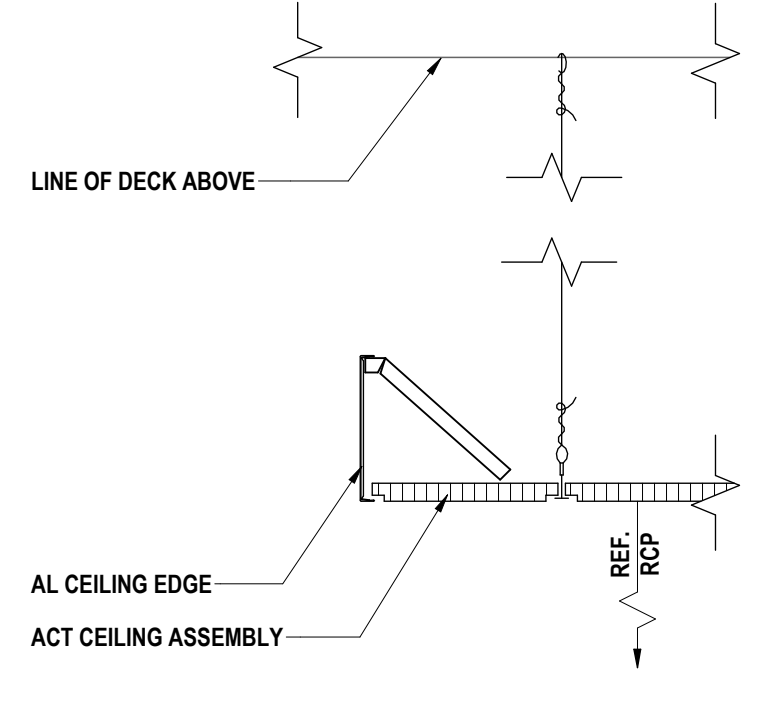

4 CEILING SOFFIT EDGE  
1 1/2" = 1'-0"

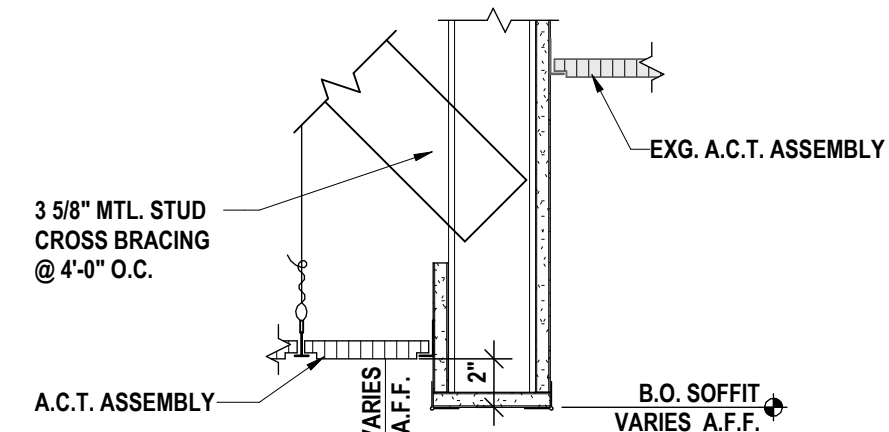

9 SOFFIT @ T.R. CORRIDOR  
1 1/2" = 1'-0"

GENERAL NOTES:


REFER TO DRAWING HS-A2.1 FOR GENERAL PLAN NOTES.

REFLECTED CEILING PLAN

DRAWING NOTES:

- REINSTALL EXG. CEILING AS REQUIRED TO ACCOMMODATE NEW CONSTRUCTION.
- PROVIDE BREAK METAL TRIM AROUND ENTIRE SKYLIGHT OPENING. SEE SMS-A2.4.
- PROVIDE ACOUSTICAL SPRAY, REFER TO SPEC.
- REINSTALL SALVAGED PORTIONS CEILING AFTER COMPLETION OF HVAC WORK TO MATCH EXG. EXISTING CEILING HEIGHT. SEE "H" DWGS.
- REINSTALL CEILING AS REQUIRED TO ACCOMMODATE WALL FINISH SCOPE.
- REINSTALL EXG. CEILING AND EXTEND TO MEET NEW CONSTRUCTION.
- REMOVE RUST, CLEAN, AND PAINT CORRODED METAL DECK.
- PROVIDE CEILING CLOUD ACOUSTIC BAFFLES. REFER TO A8 DRAWINGS. FINISH KEY AND SPECS FOR MORE INFORMATION.
- PROVIDE CEILING CLOUD ACOUSTIC PANELS. REFER TO A8 DRAWINGS. FINISH KEY AND SPECS FOR MORE INFORMATION.

CEILING FINISH LEGEND:

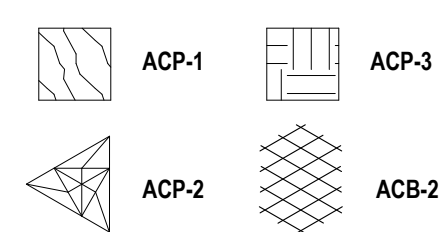

57-10-00-01-002-044 - MIDDLE SCHOOL

ENLARGED CEILING PLANS & CEILING DETAILS  
2025 MIDDLE SCHOOL PHASE III ALTERATIONS PROJECT  
CORNING-PAINTED POST ASD  
35 VICTORY HIGHWAY, PAINTED POST, NY 14870

MS-A2.6  
PROJECT NO: 2649-153


HUNT ENGINEERS ARCHITECTS | SURVEYORS  
HORSEHEADS, NY 607-263-1000 ROCHESTER, NY 585-637-7868 TOWNAND, PA 570-265-4606  
BINGHAMTON, NY 607-798-8881 ALBANY, NY 607-798-8801  
WWW.HUNTEAS.COM  
NY CERTIFICATE NO. 0016220 PA CERTIFICATE NO. TSC220313464-1

# DATE: 1 11/03/2025  
DESCRIPTION OF REVISION:  
ISSUED FOR BID


DRAWN BY: MBH  
CHECKED BY: SZ  
DATE: 05/09/2025  
PHASE: CD

THIS IS A VIOLATION OF THE LAW FOR ANY PERSON TO MAKE UNAUTHORIZED ALTERATIONS OR ADDITIONS TO PLANS  
DRAWING A LICENSED SURVEYOR'S SEAL




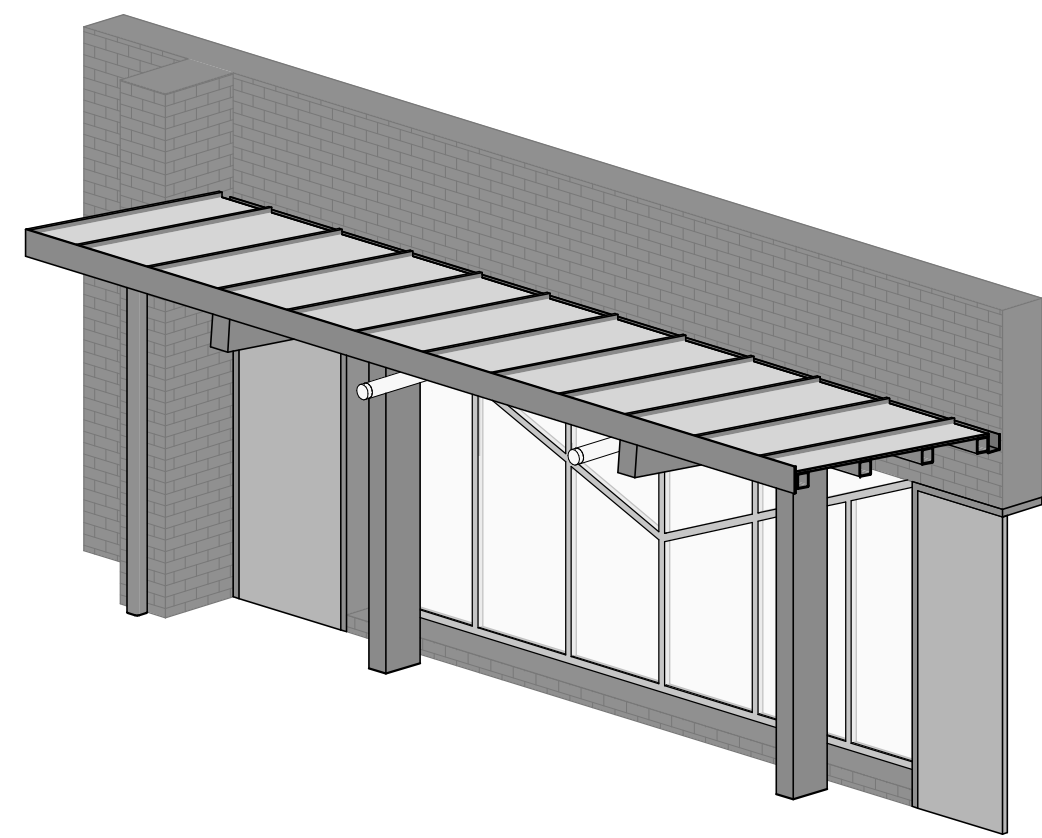

6 POOL CANOPY SECTION BOX

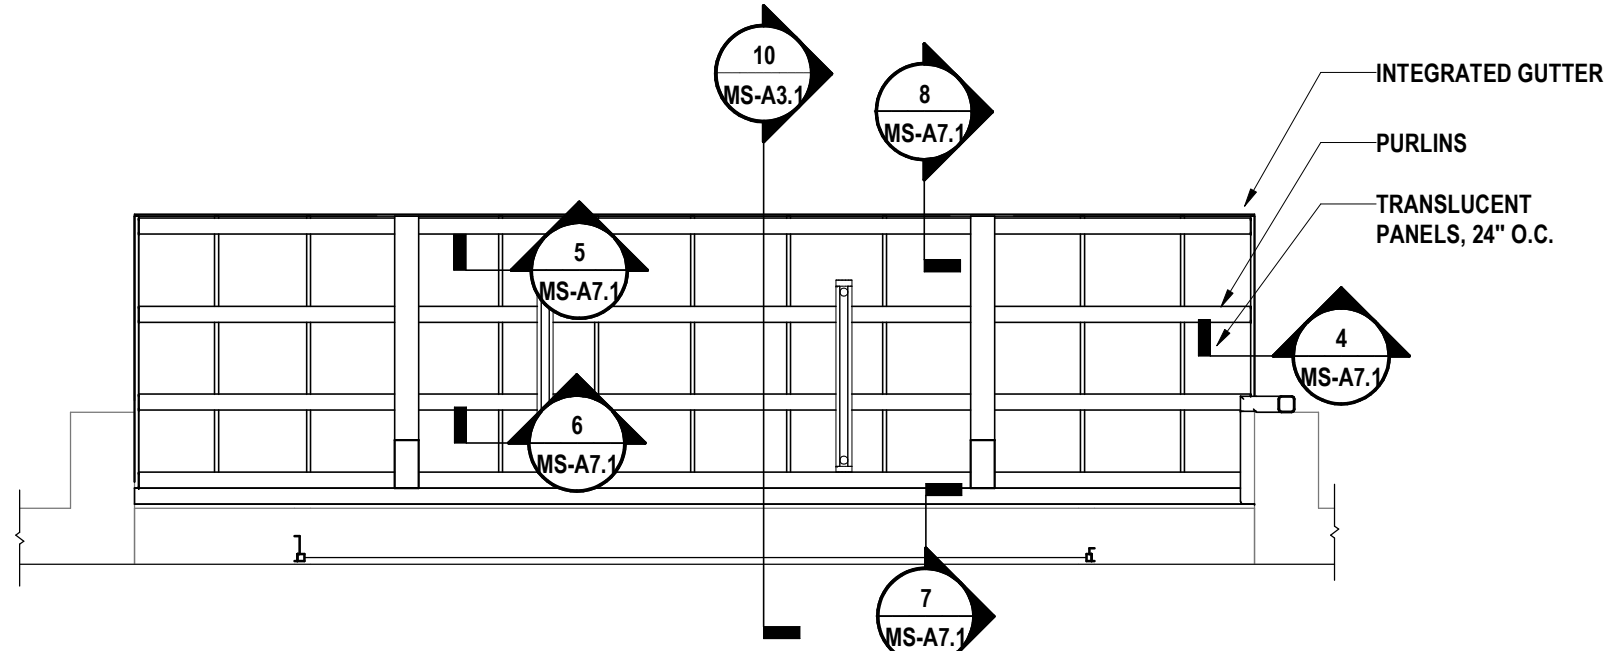


5 POOL CANOPY PLAN

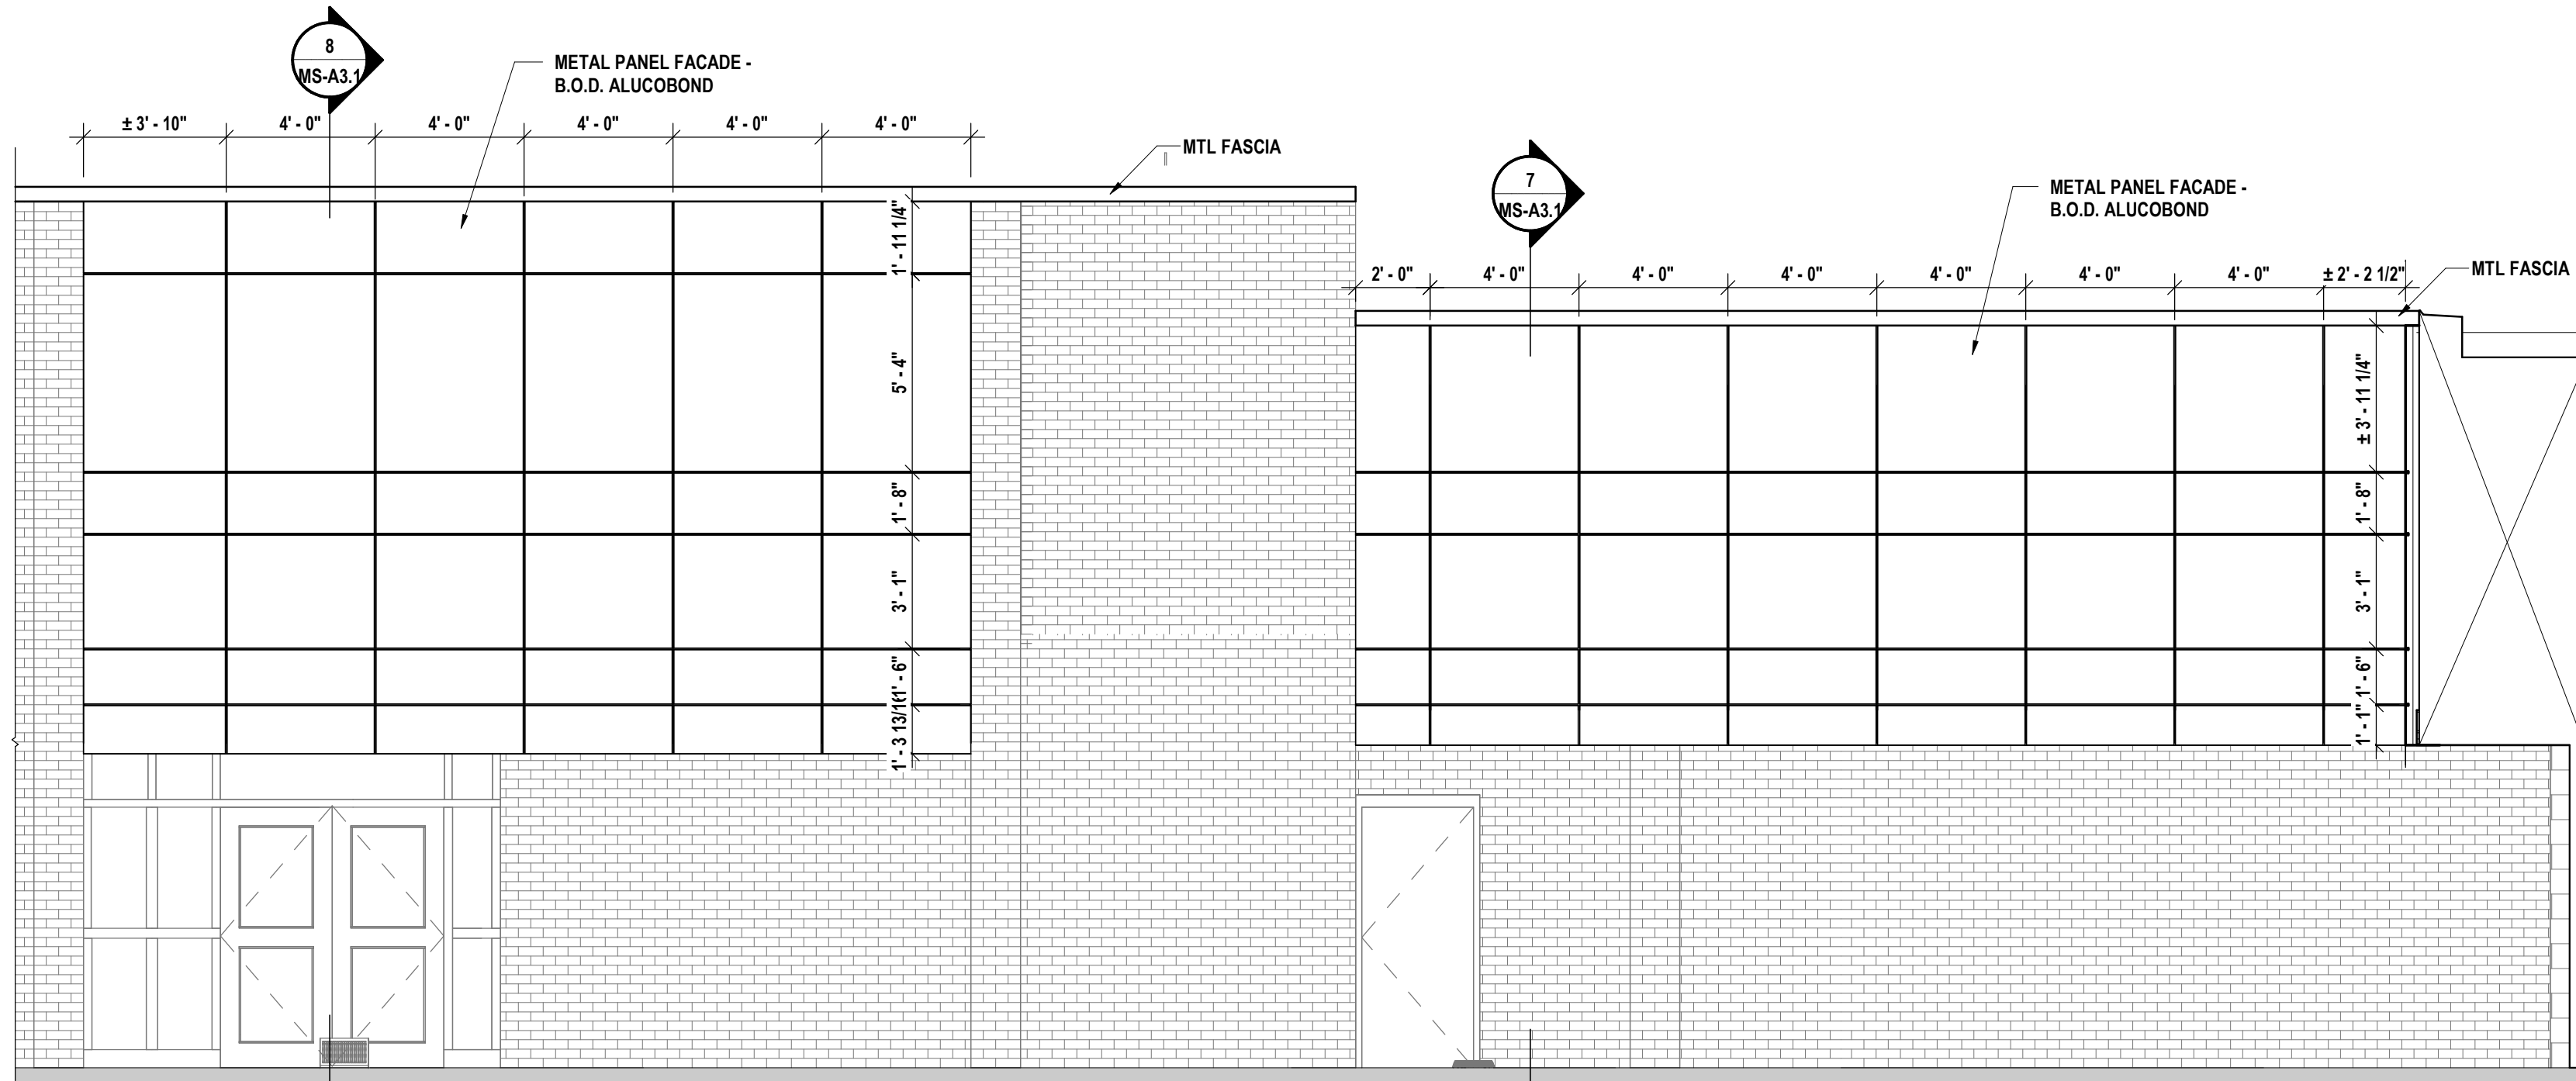


NOTE: V.I.F. EXG FACADE DIMENSIONS TO ENSURE PANELS FIT APPROPRIATELY.

3 POOL EXTERIOR ELEVATION 2

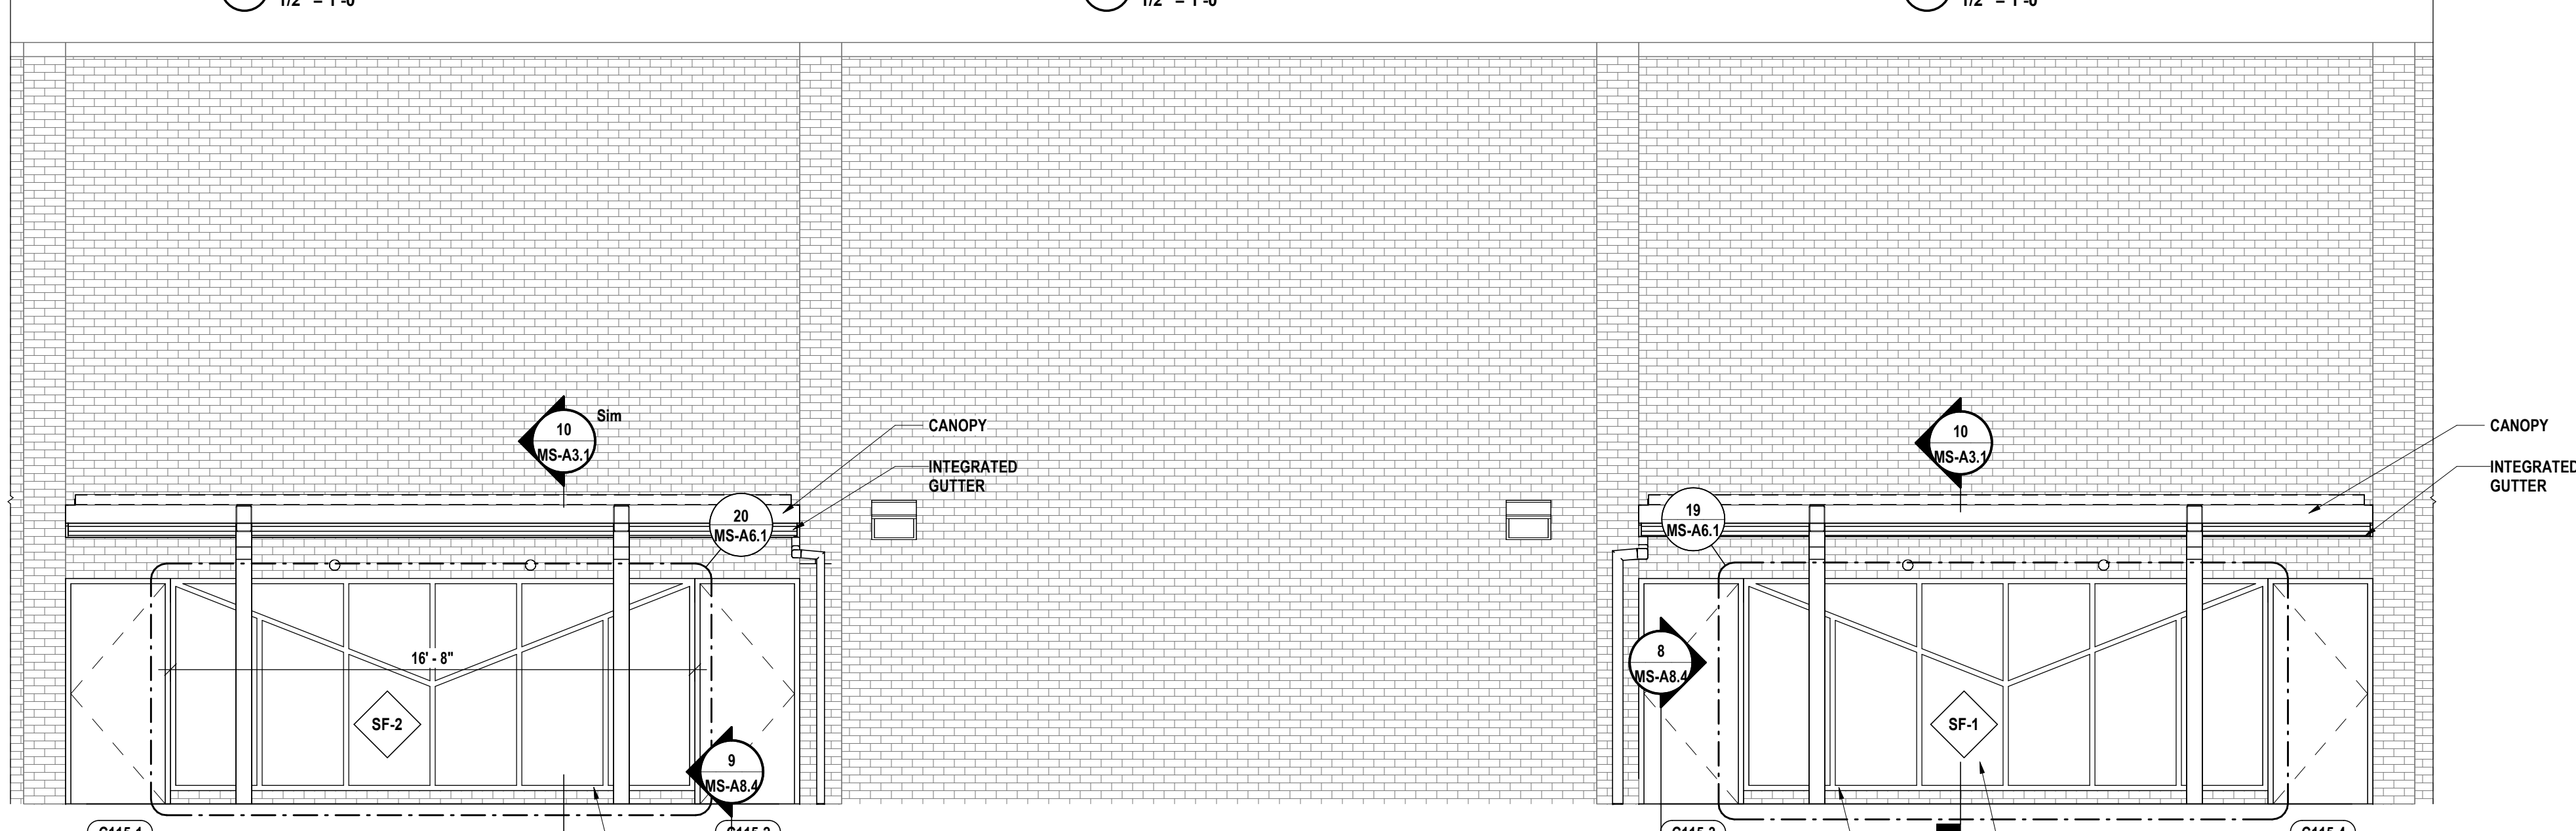


4 POOL EXTERIOR ELEVATION

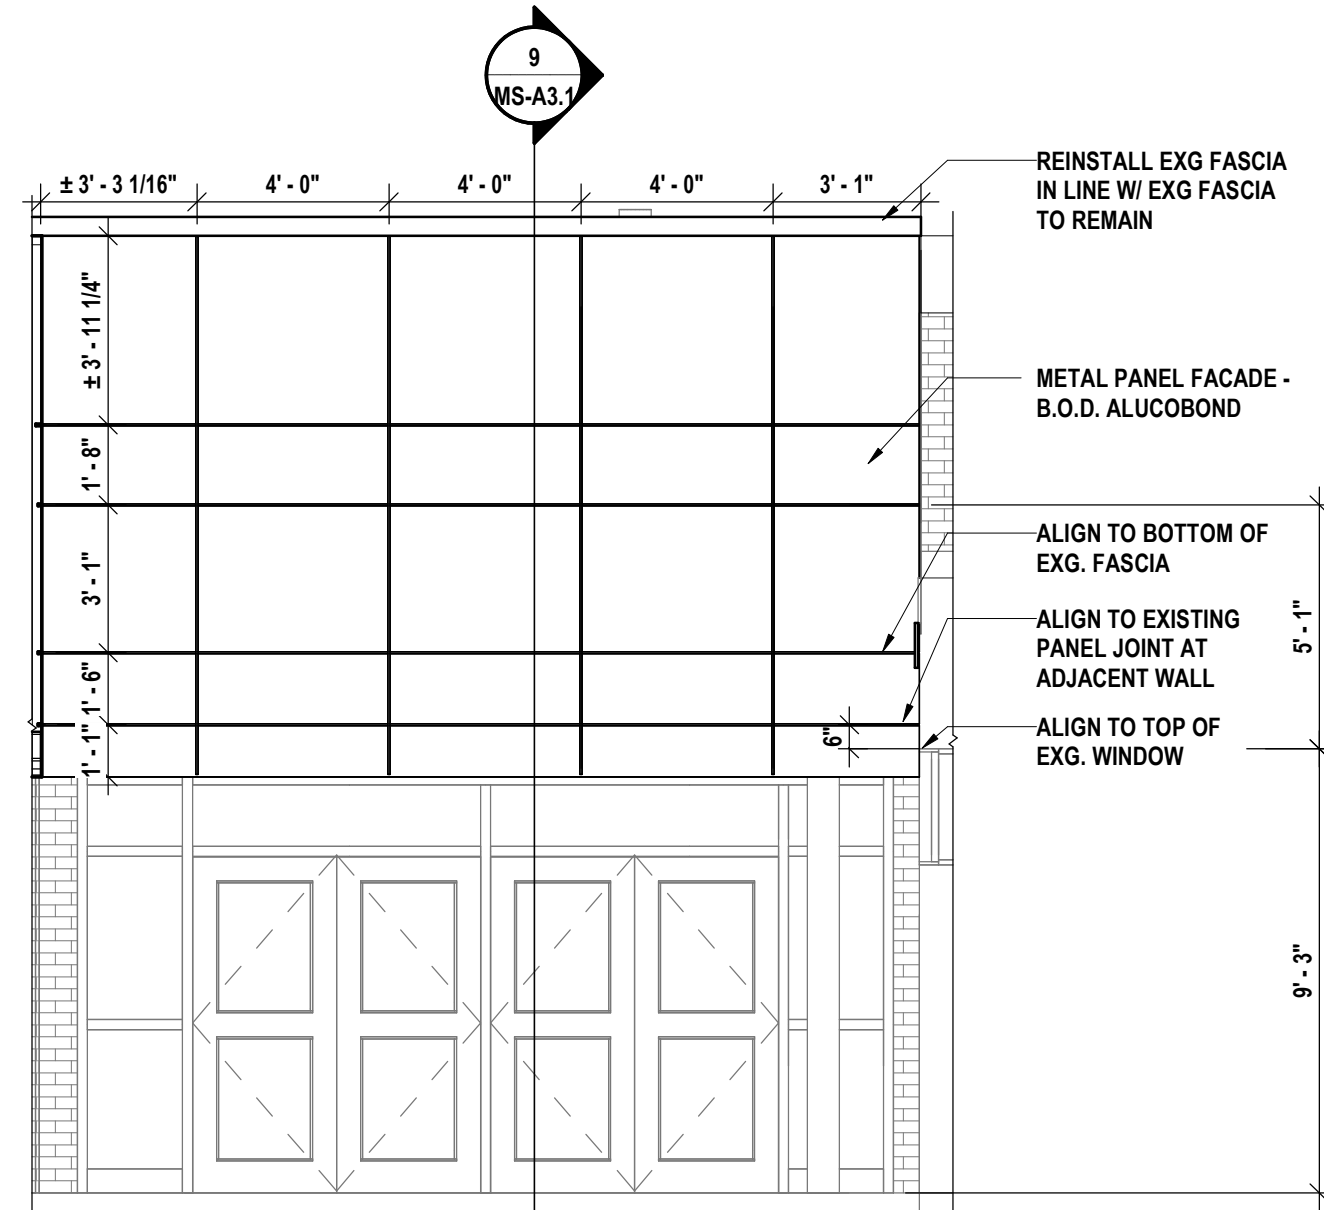


NOTE: V.I.F. EXG FACADE DIMENSIONS TO ENSURE PANELS FIT APPROPRIATELY.


2 POOL EXTERIOR ELEVATION 3

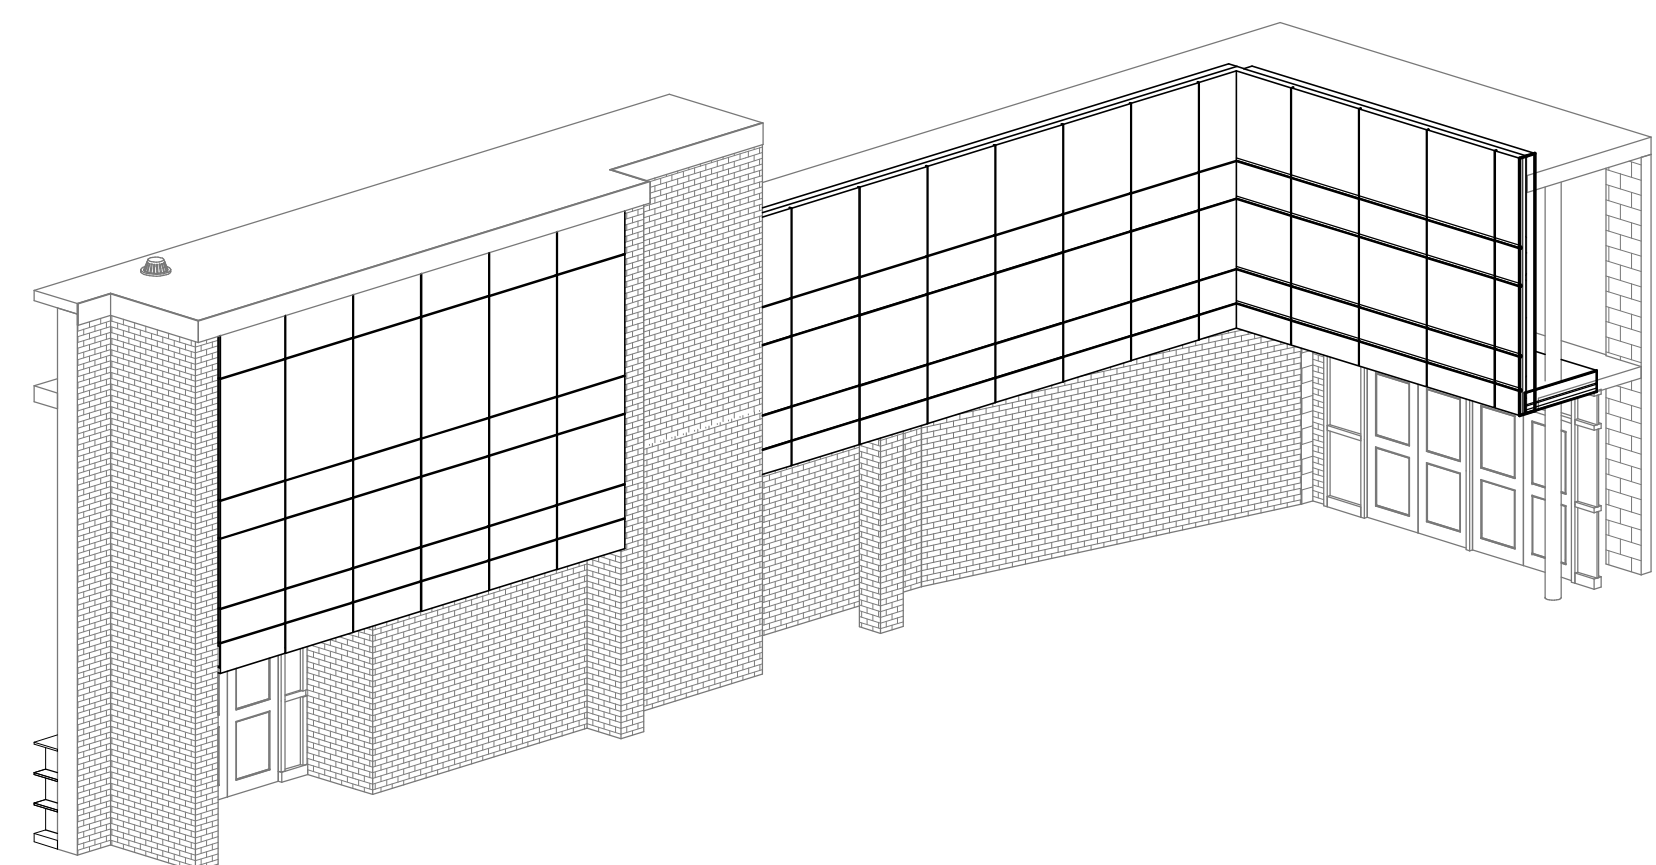


1 METAL PANEL FACADE SECTION BOX

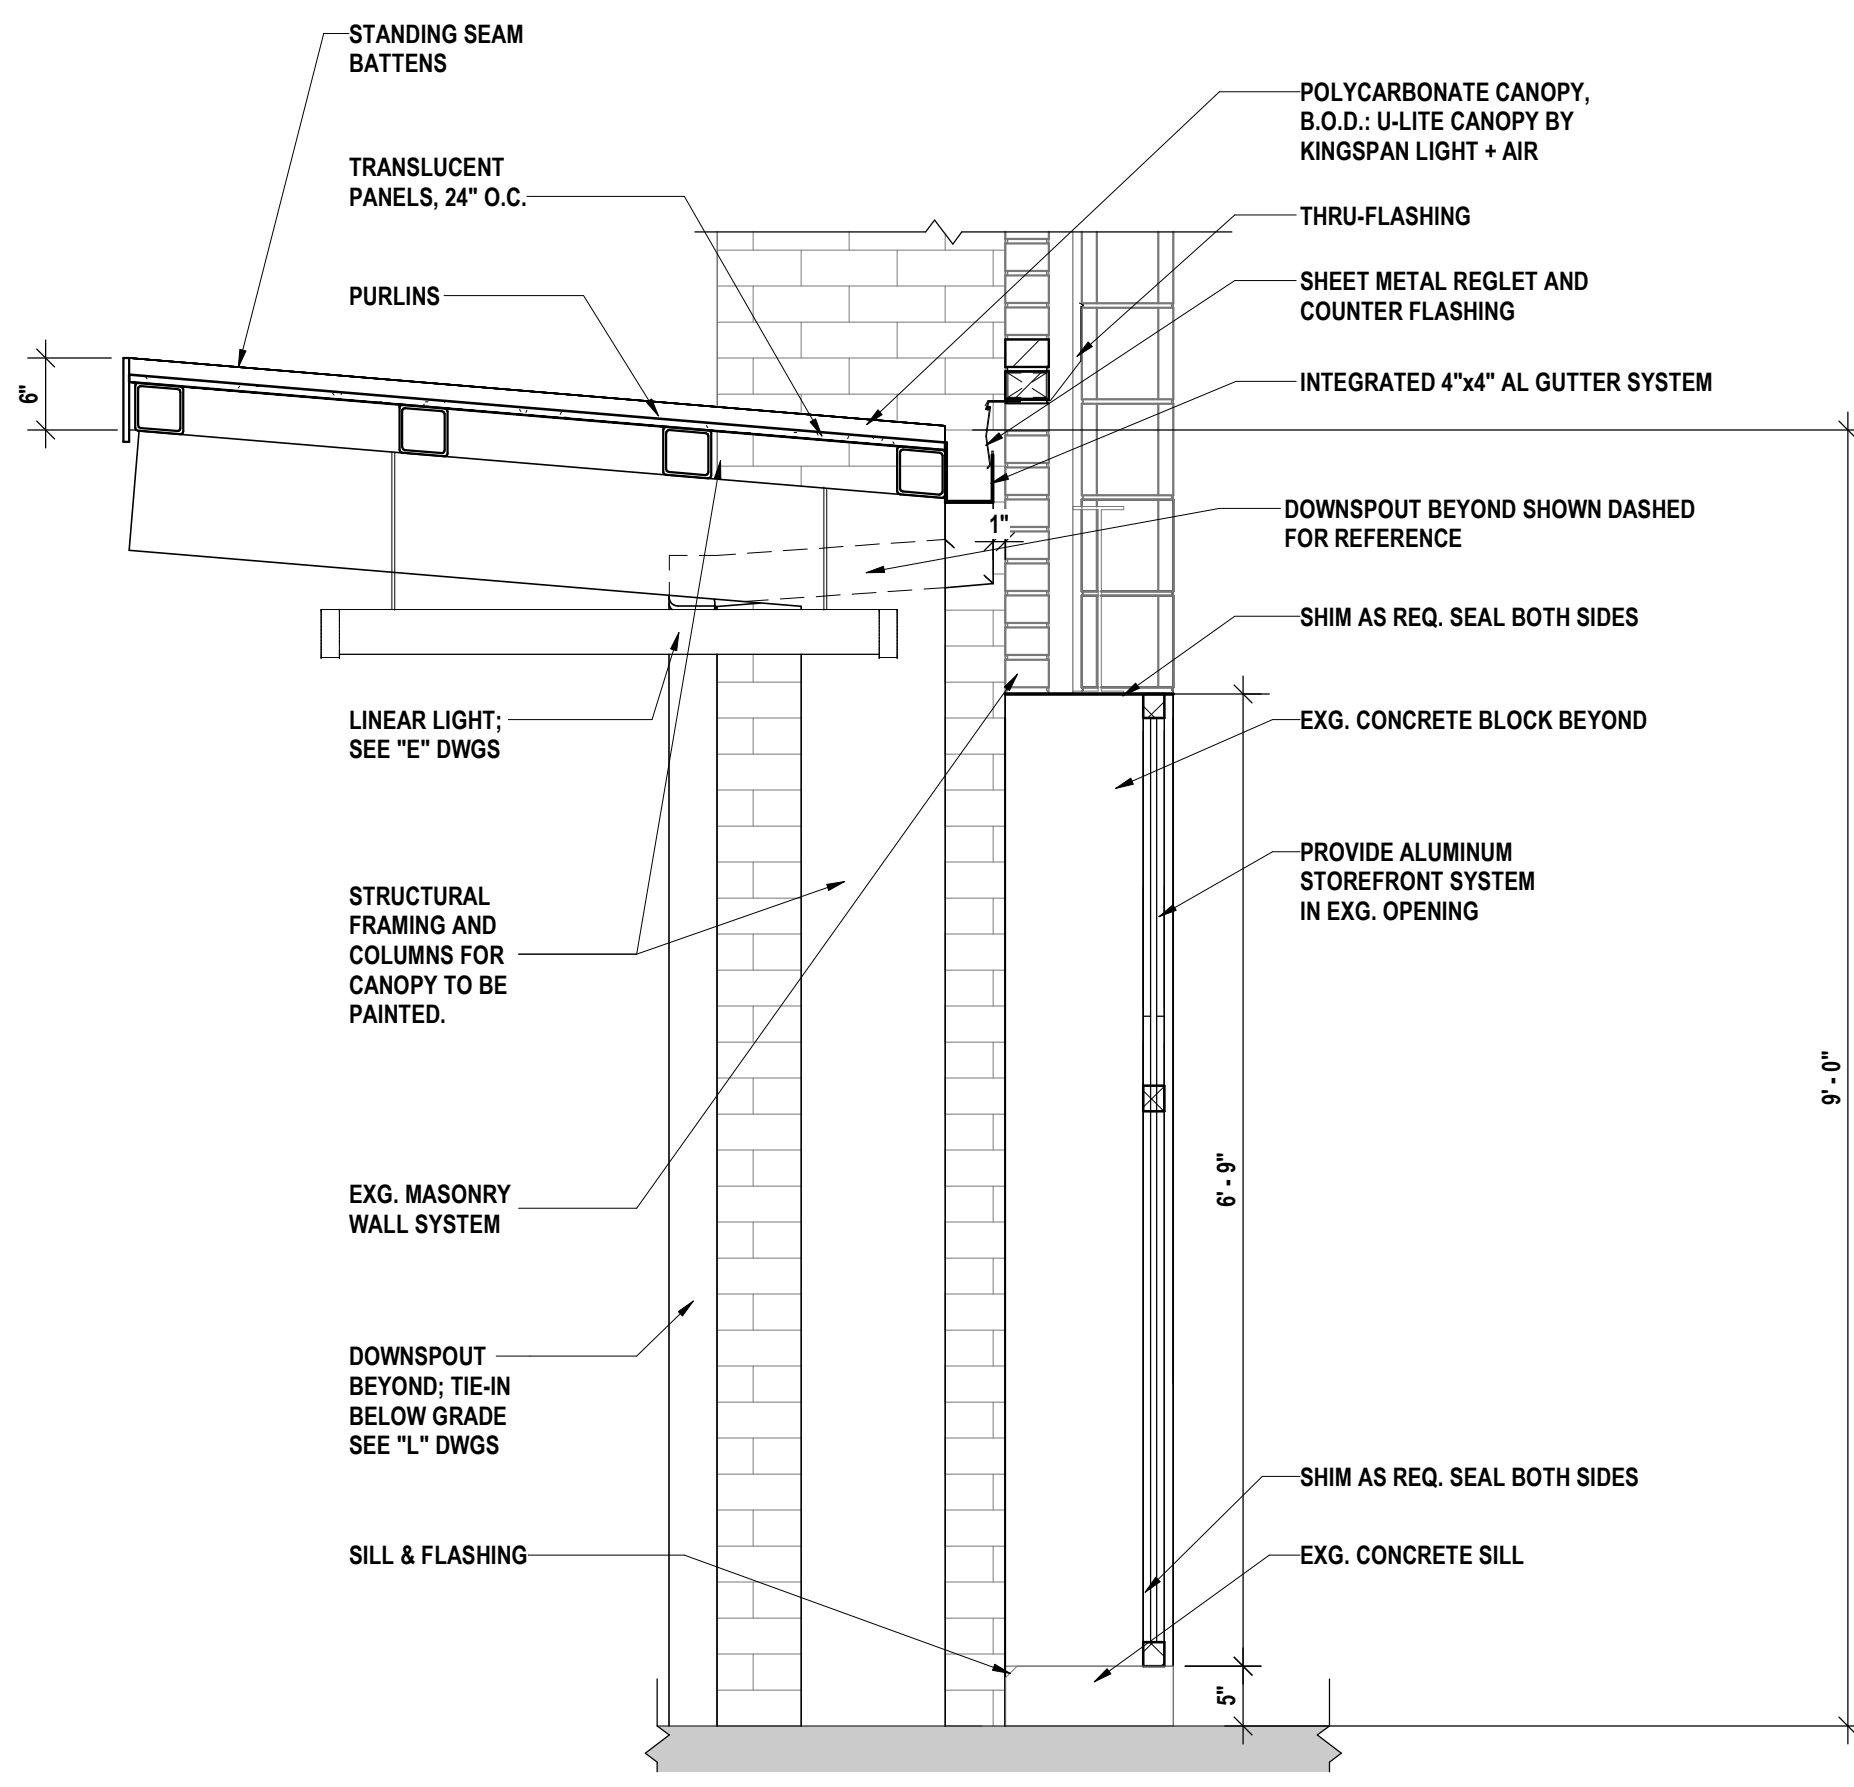


10 POOL WALL SECTION

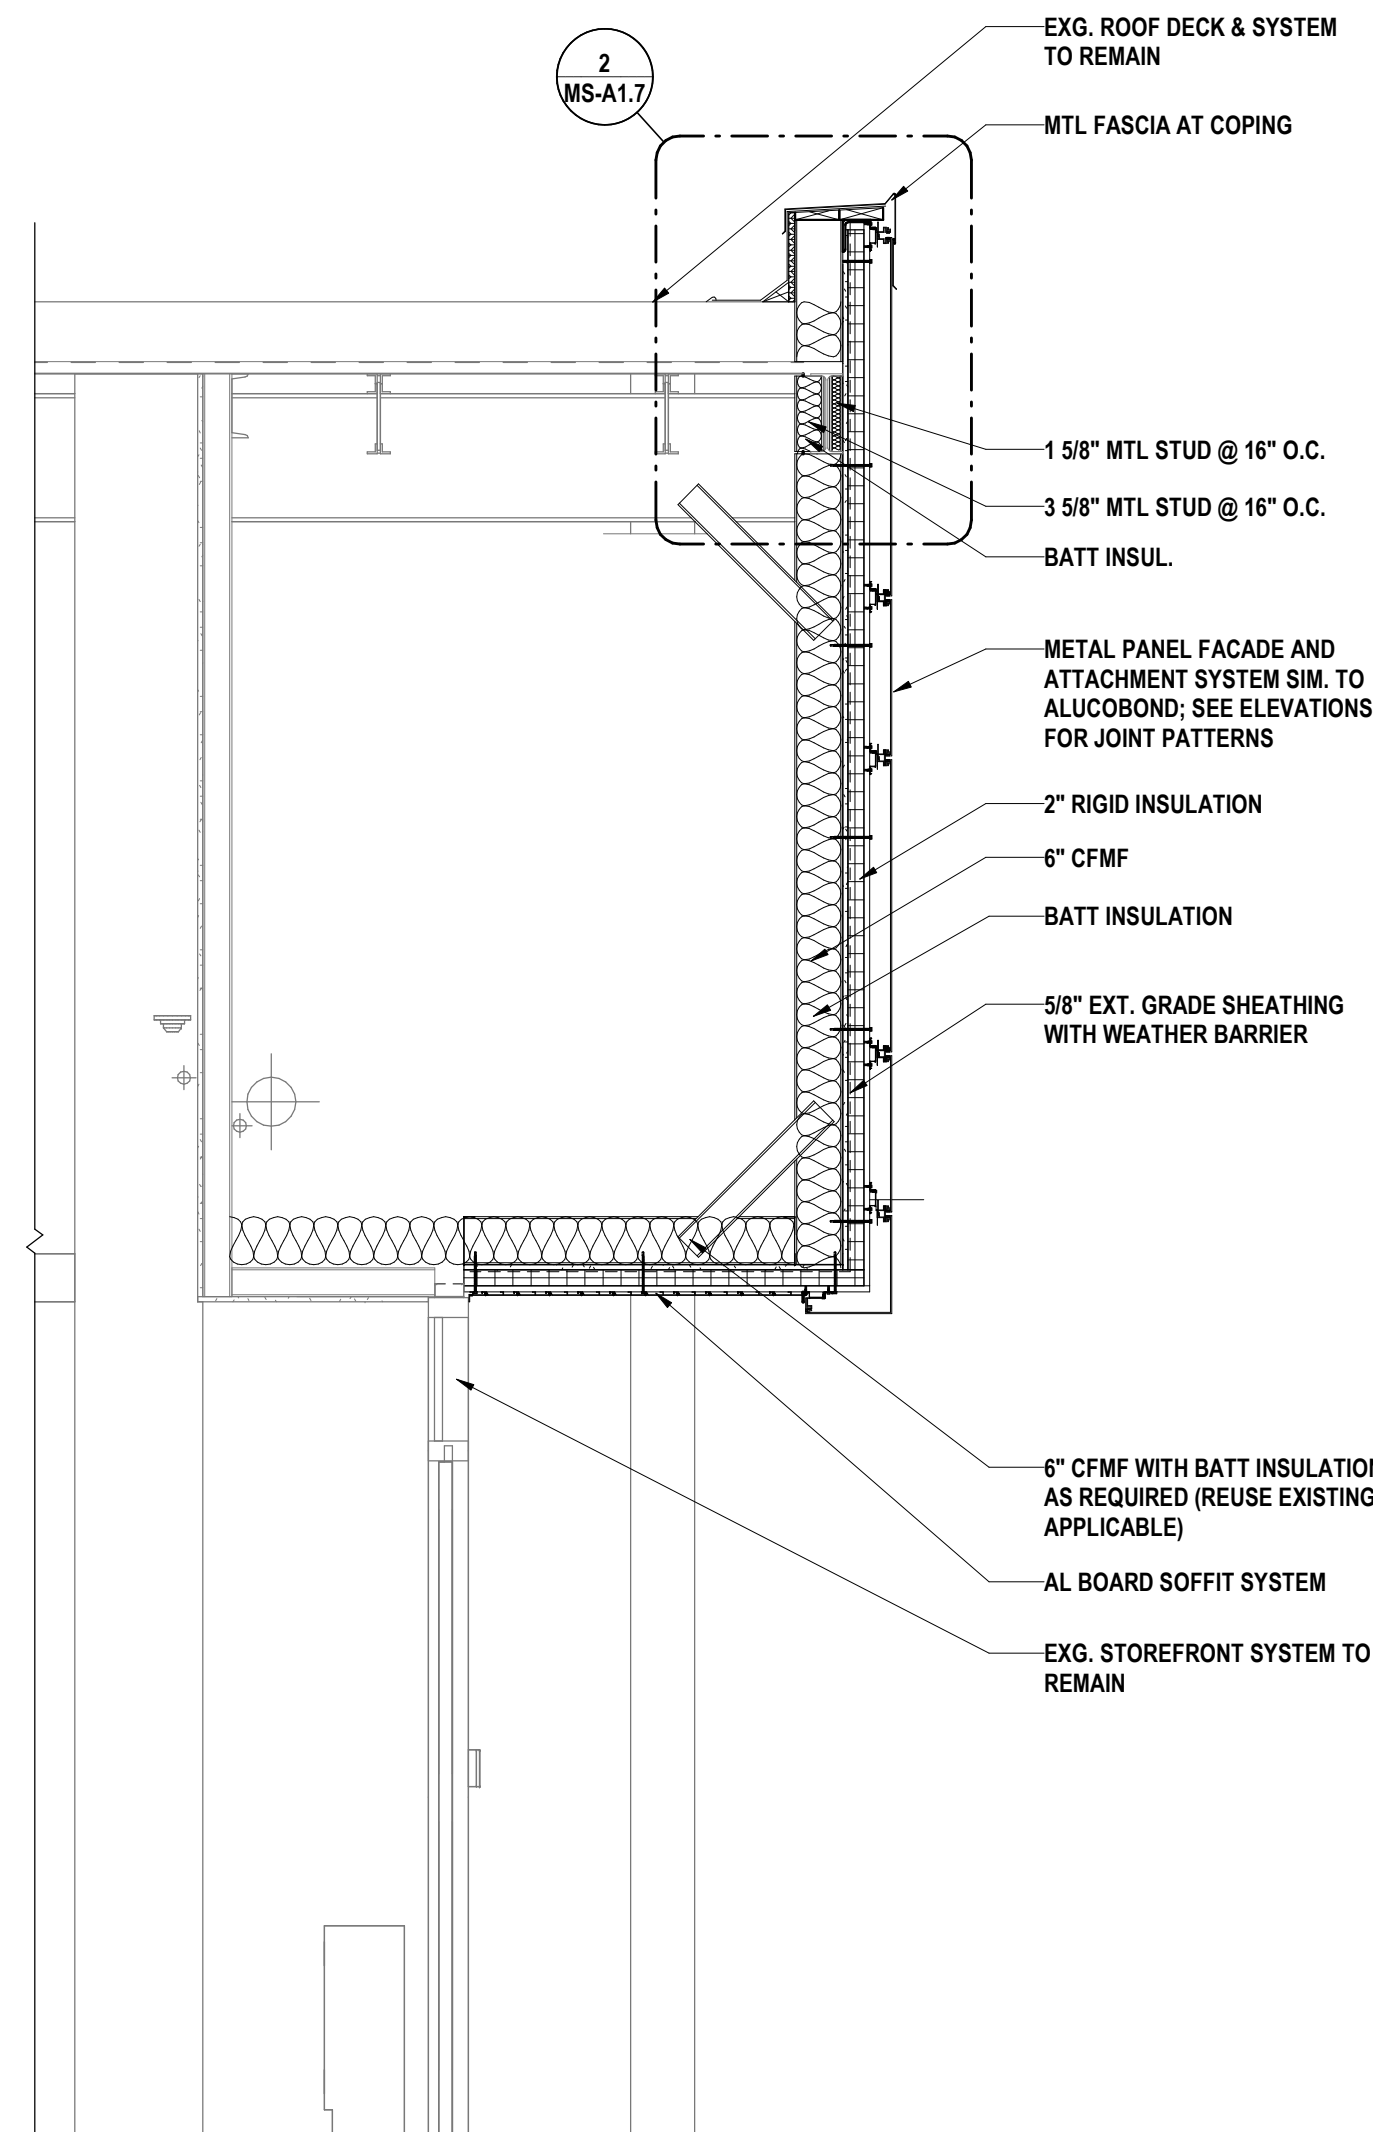

9 EXTERIOR SOFFIT SECTION 1

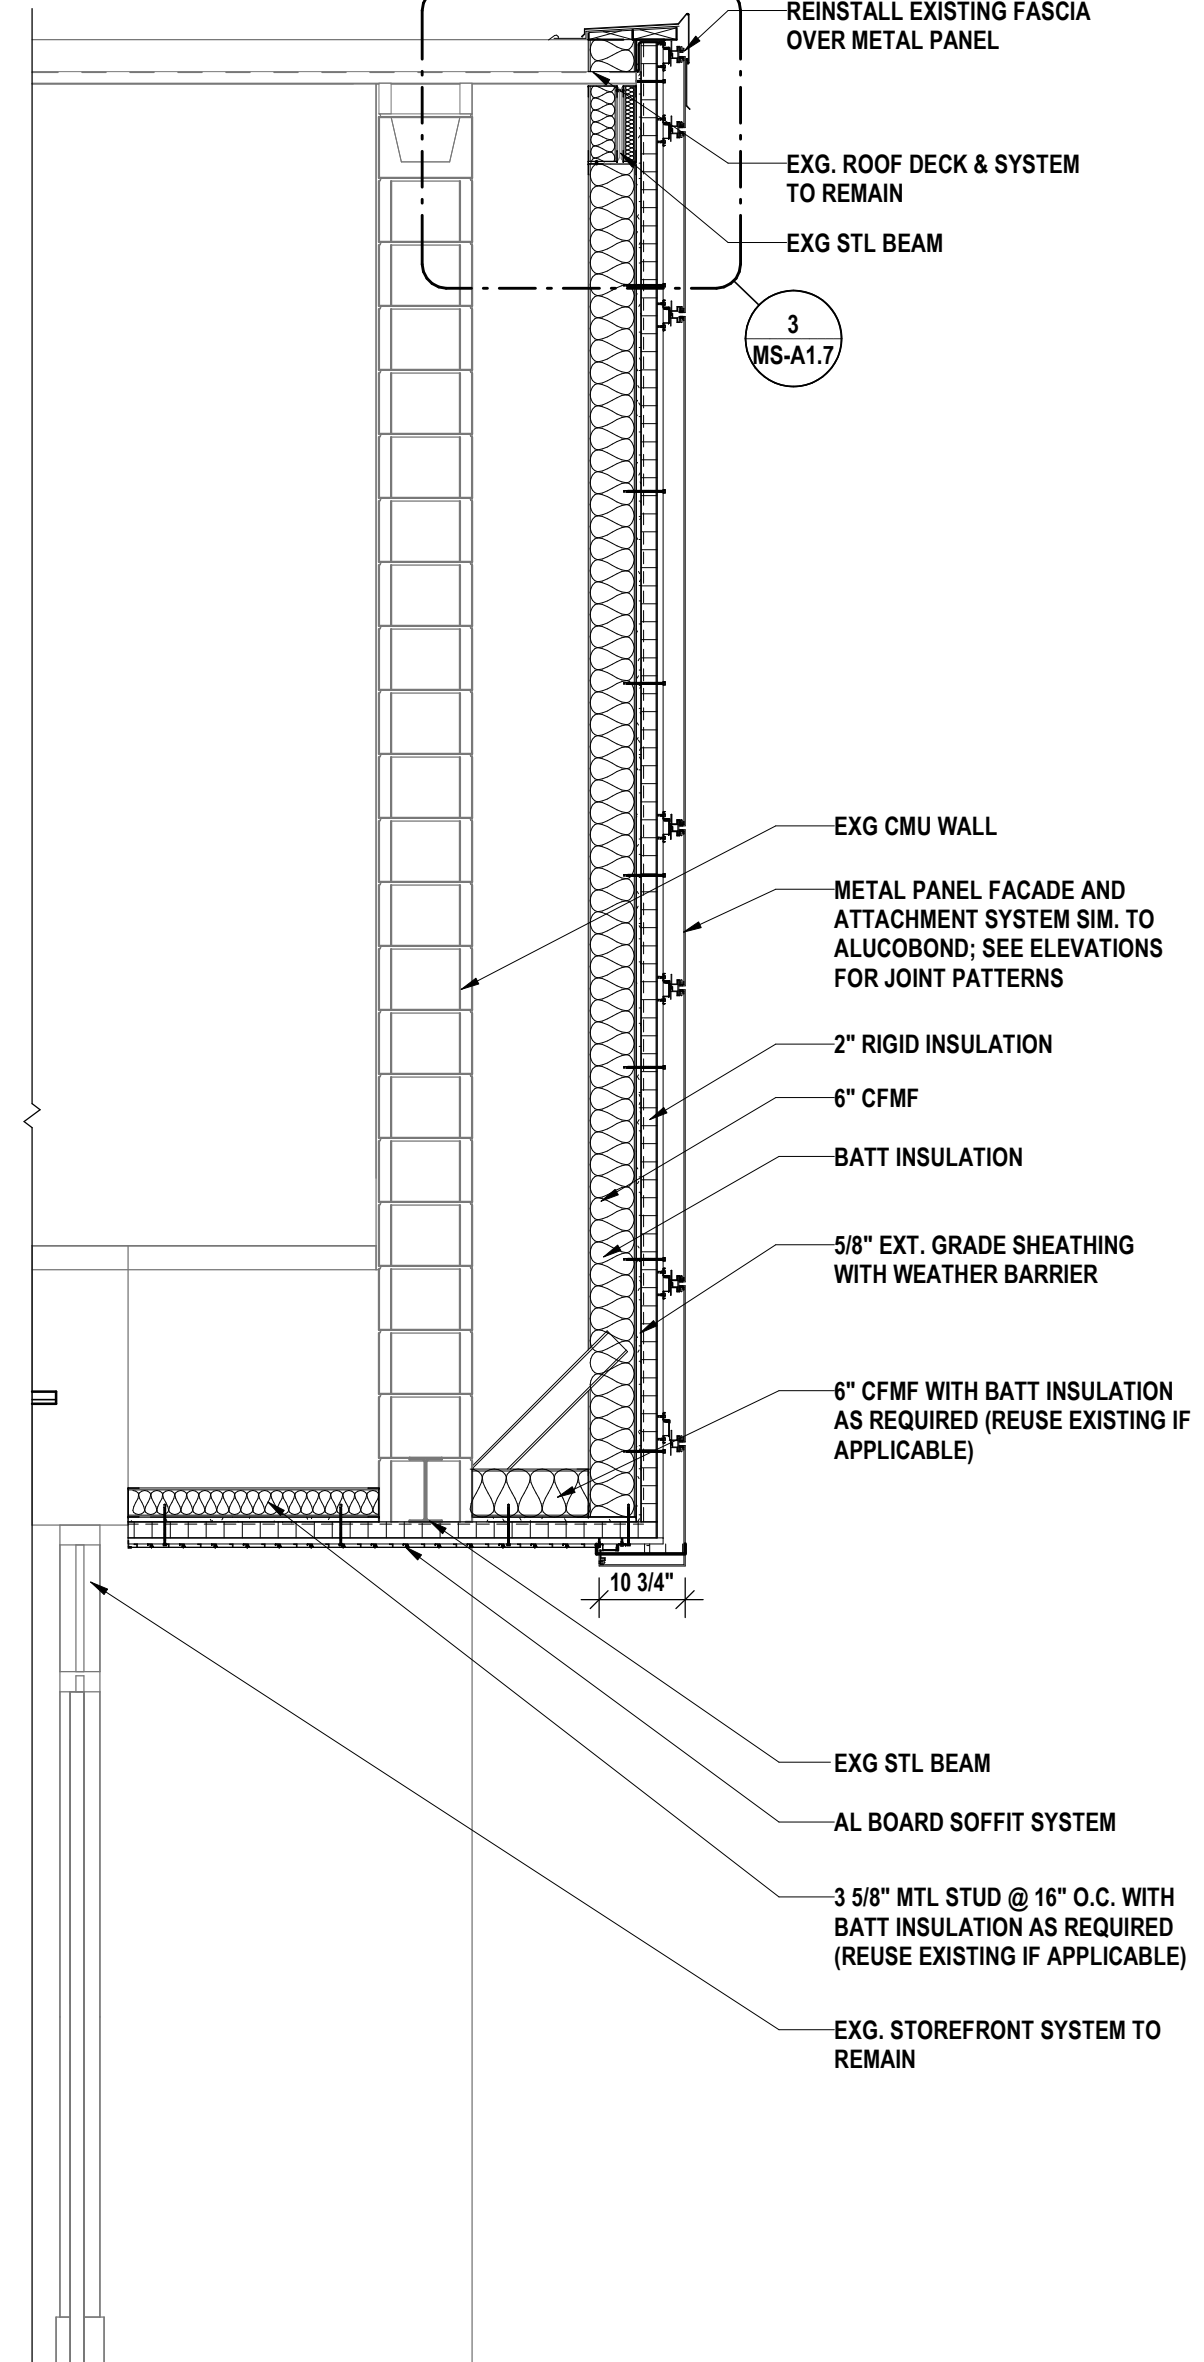


8 EXTERIOR SOFFIT SECTION 3

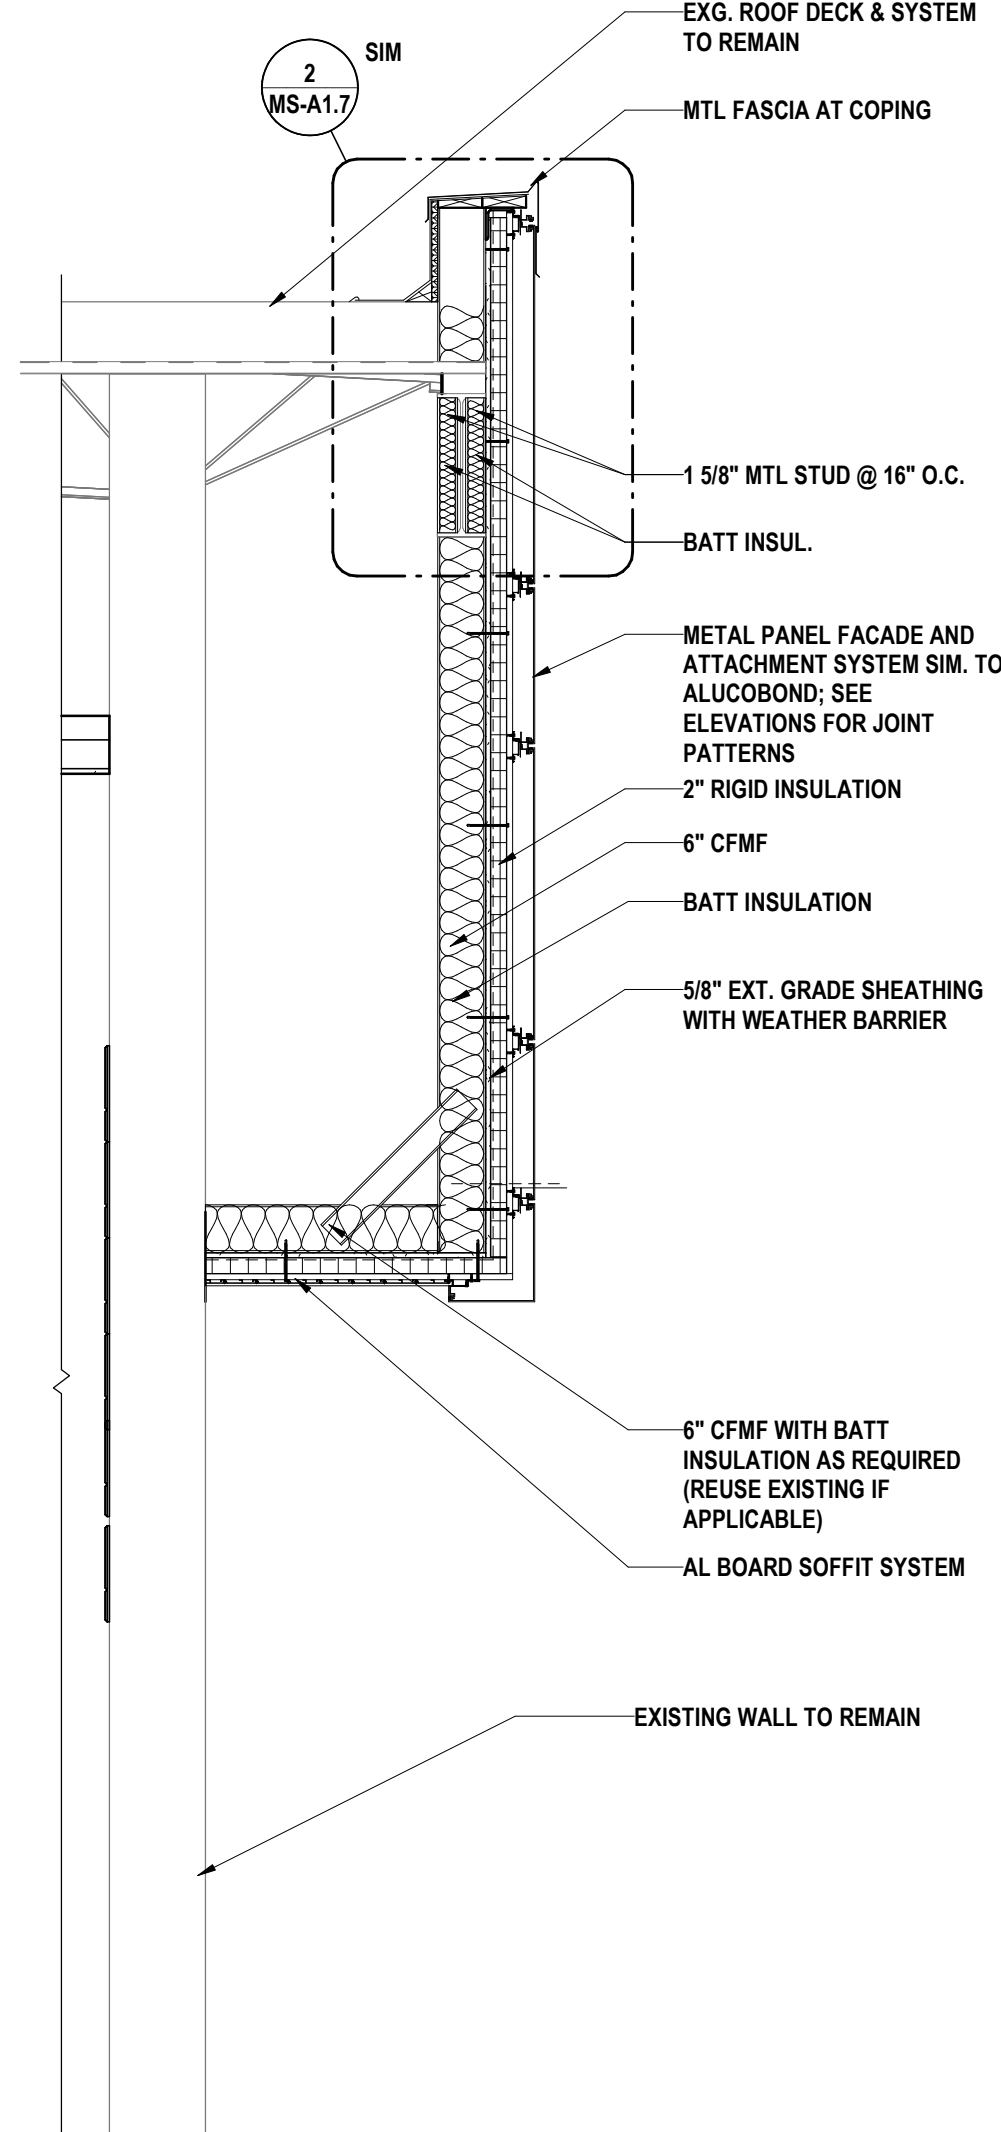


7 EXTERIOR SOFFIT SECTION 2




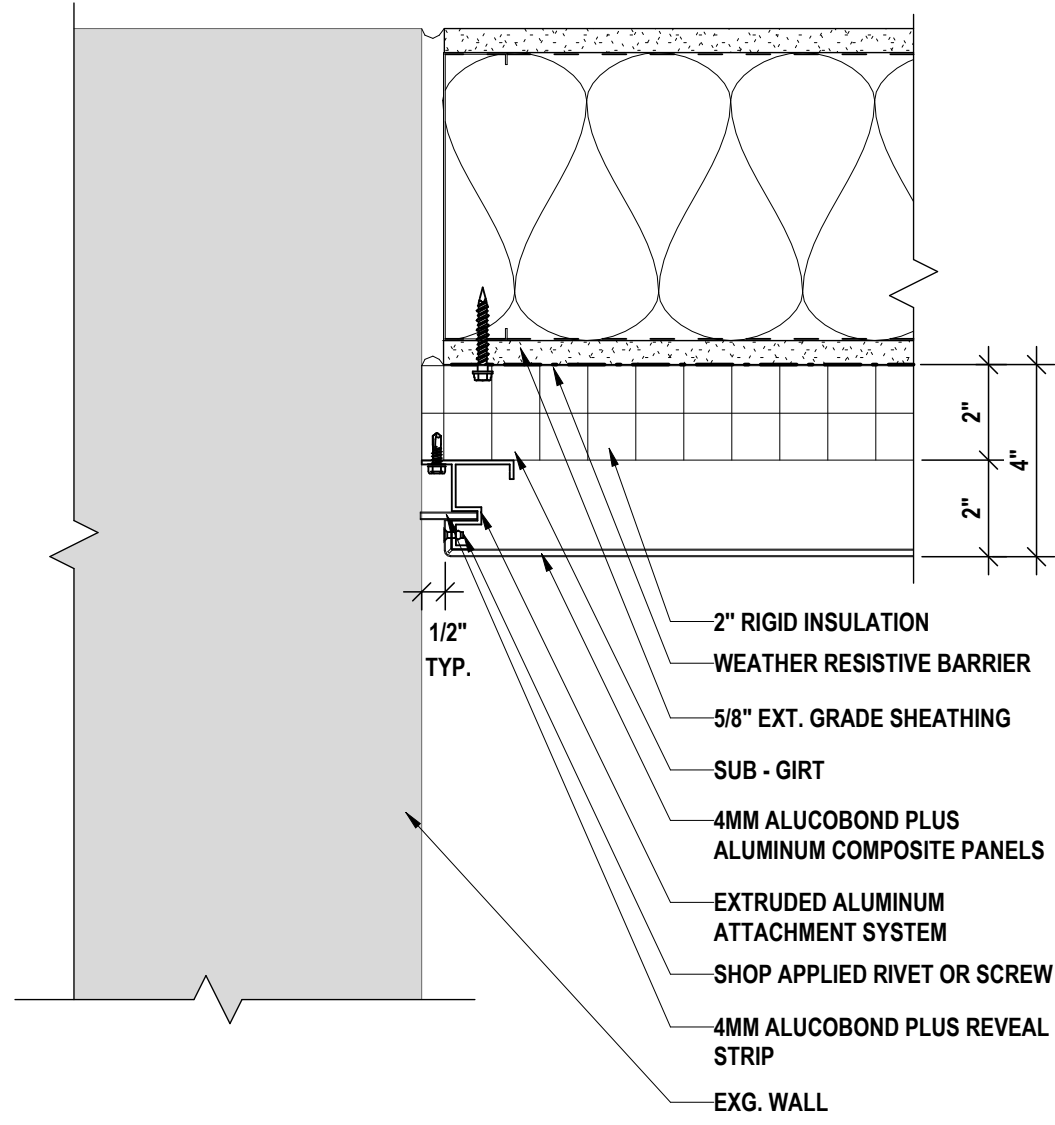


5 TYP. METAL PANELS END WALL CONDITION  
3" = 1'-0"

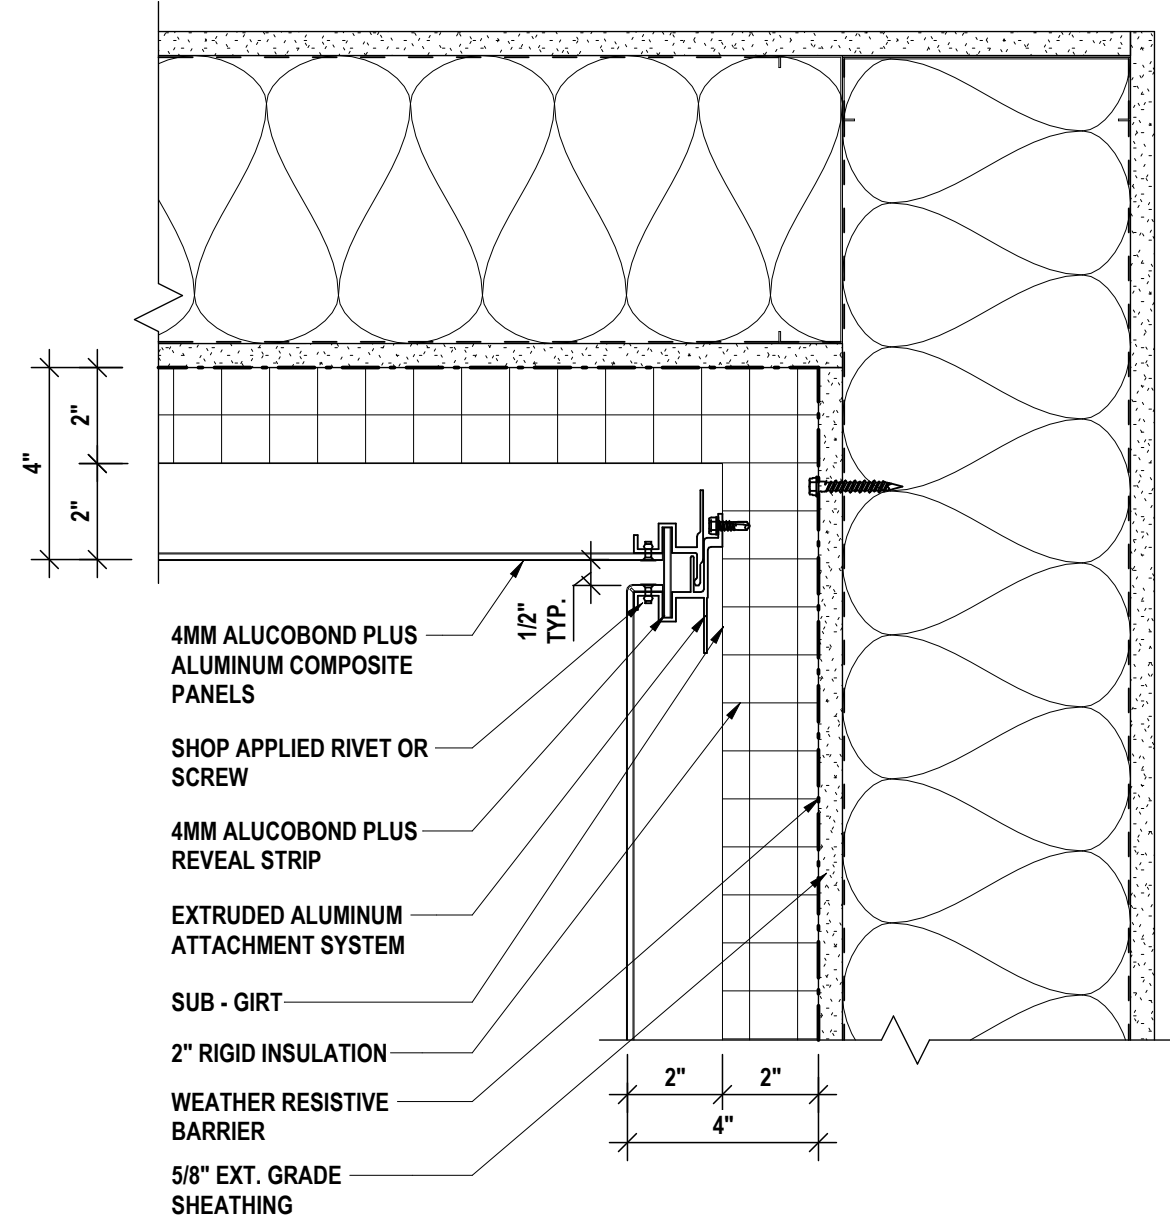


4 TYP. METAL PANELS INSIDE CORNER  
3" = 1'-0"

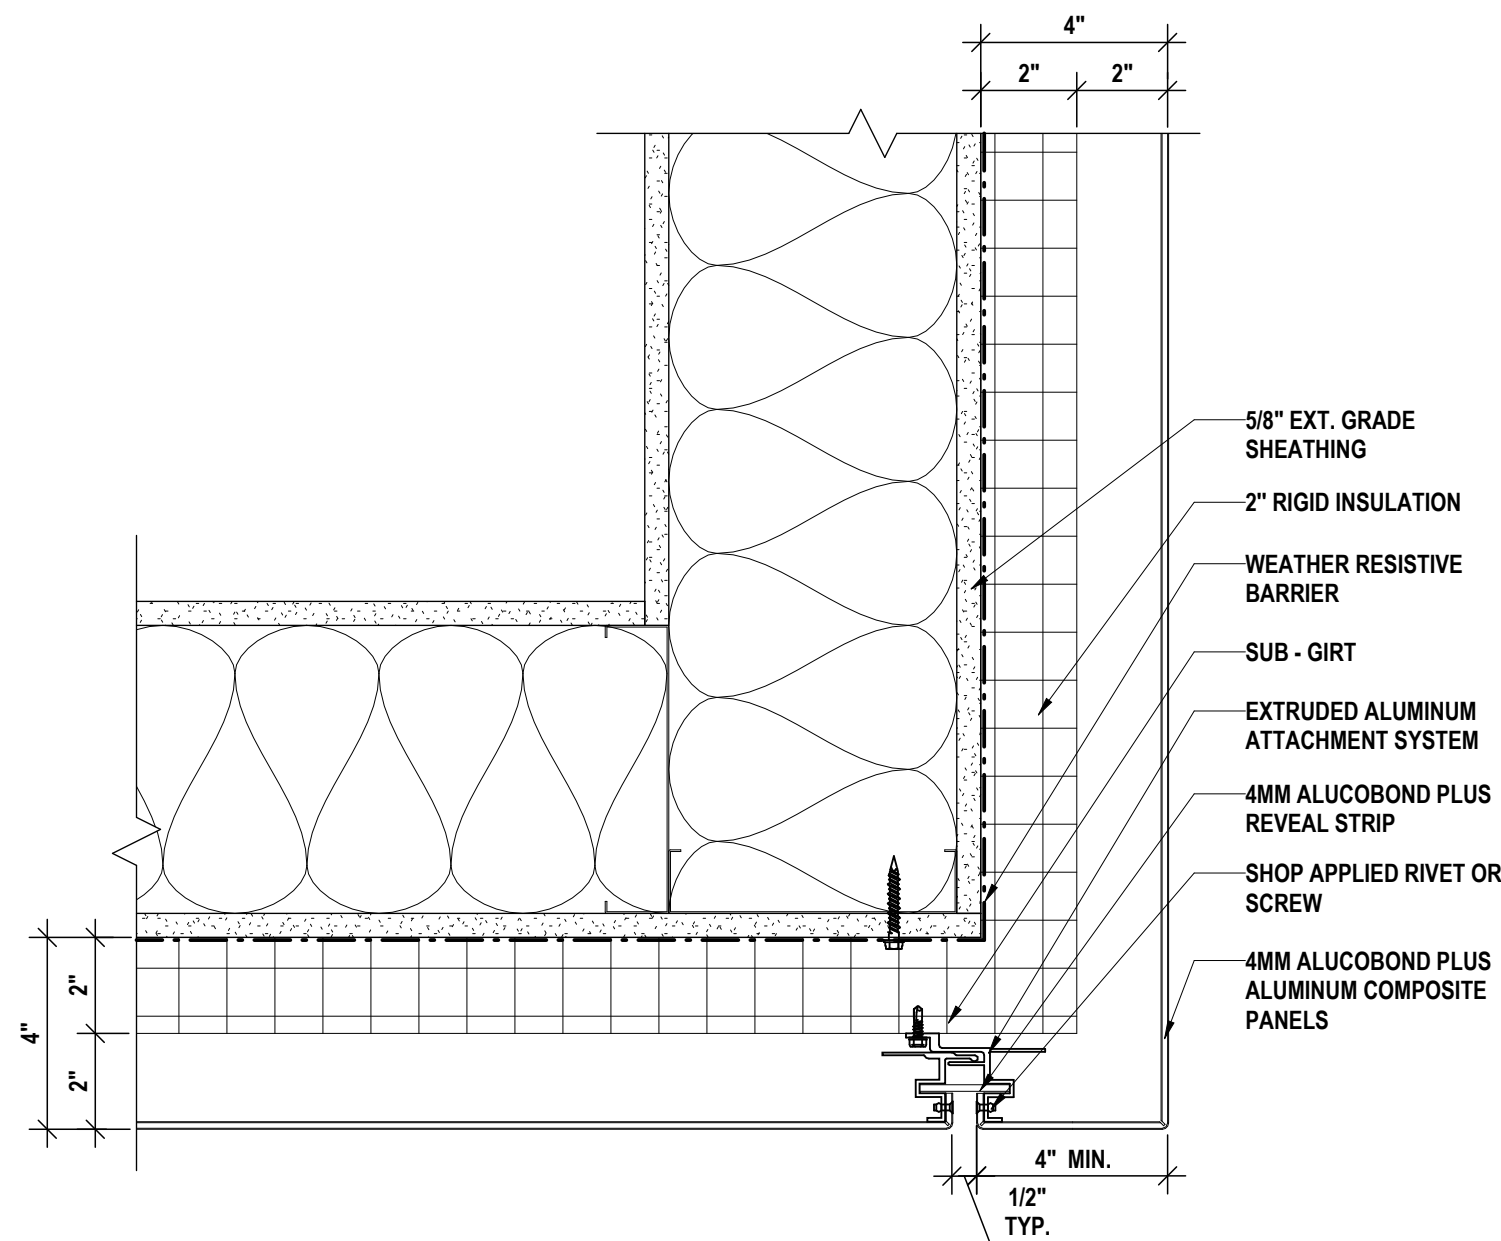


3 TYP. METAL PANELS WALL TO SOFFIT  
3" = 1'-0"

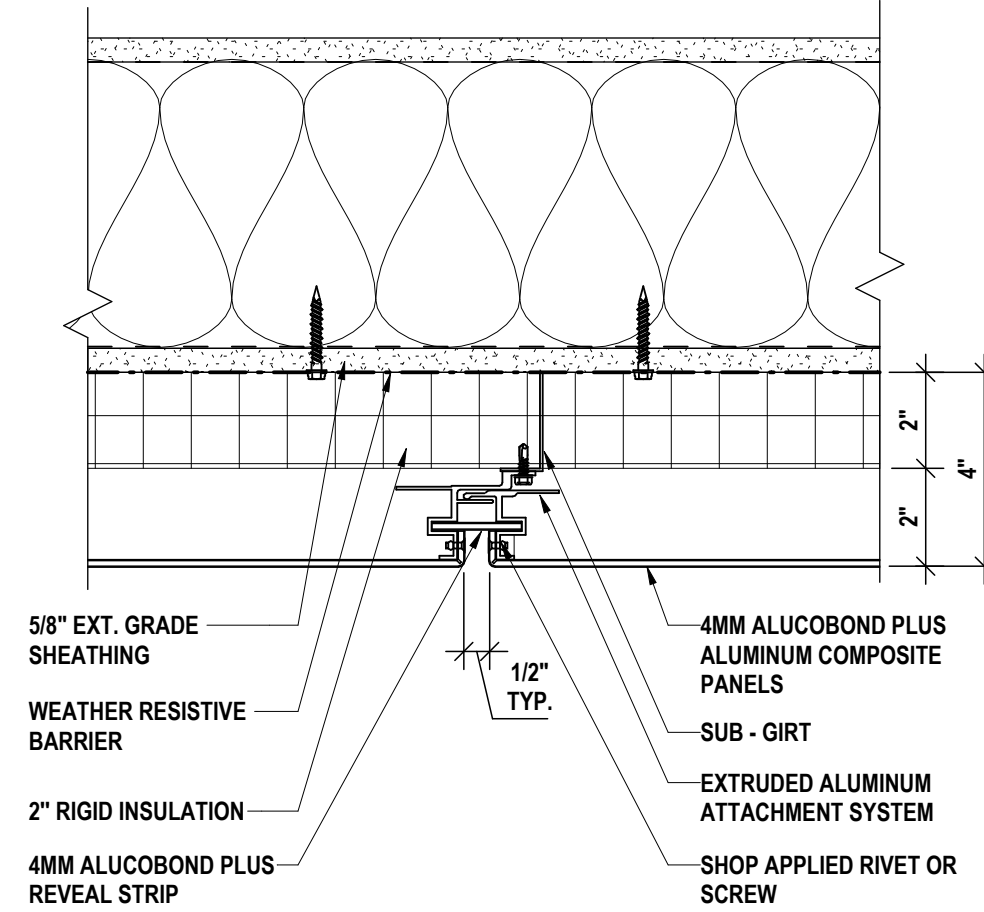

2 TYP. METAL PANELS VERTICAL JOINT  
3" = 1'-0"

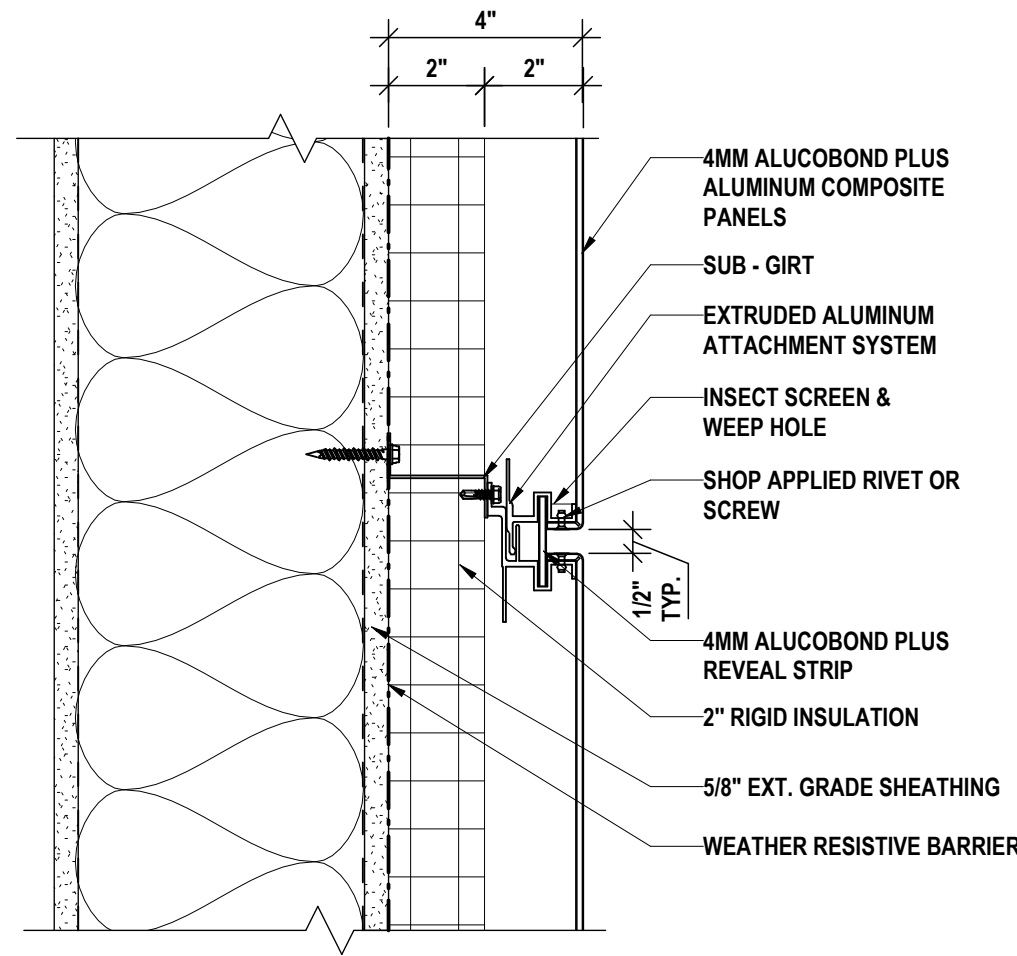

1 TYP. METAL PANELS HORIZONTAL JOINT  
3" = 1'-0"

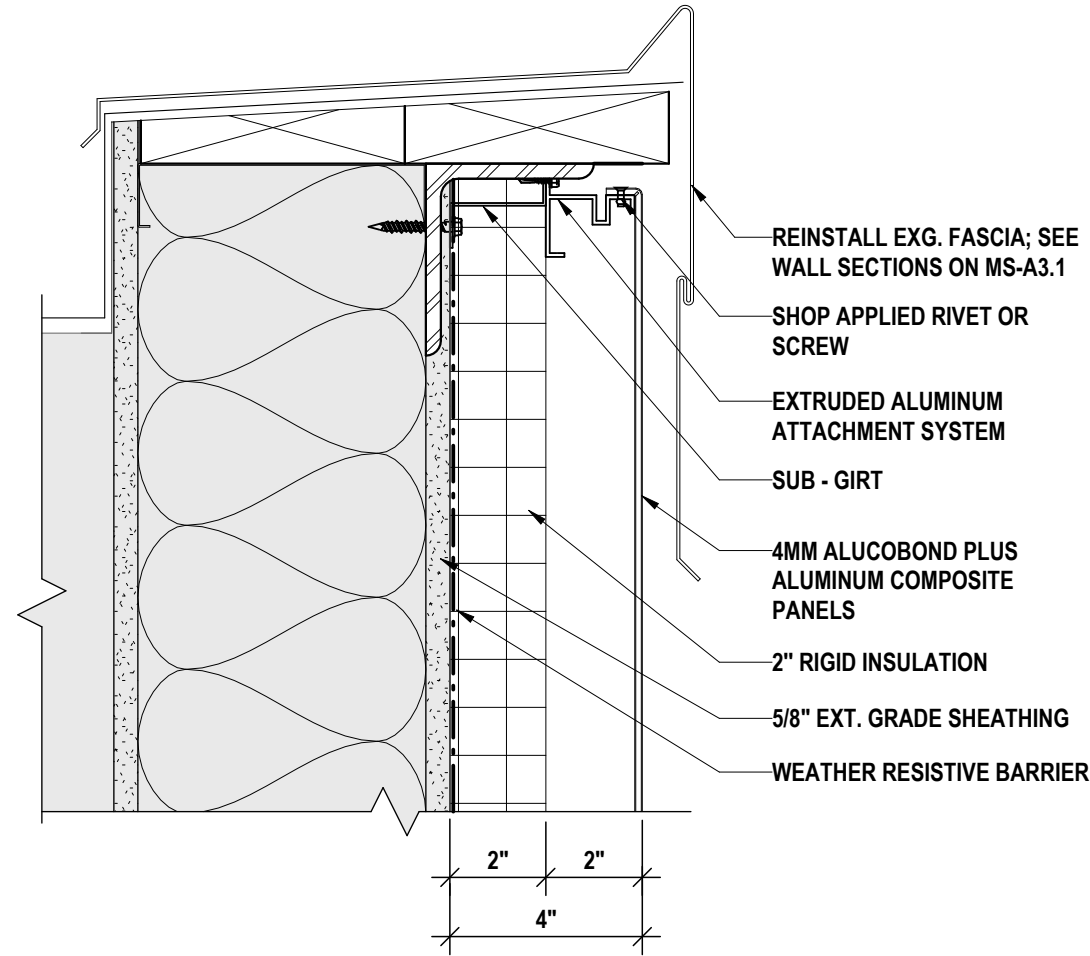


6 TYP. METAL PANELS FASCIA JOINT  
3" = 1'-0"


#	DATE	DESCRIPTION OF REVISION:
1	10/03/2025	ISSUED FOR BID
IT IS A VIOLATION OF THE LAW FOR ANY PERSON TO MAKE UNAUTHORIZED ALTERATIONS OR ADDITIONS TO PLANS DRAWN BY A LICENSED ENGINEER OR ARCHITECT'S SURVEYOR'S SEAL.		

DRAWN BY:	PSB
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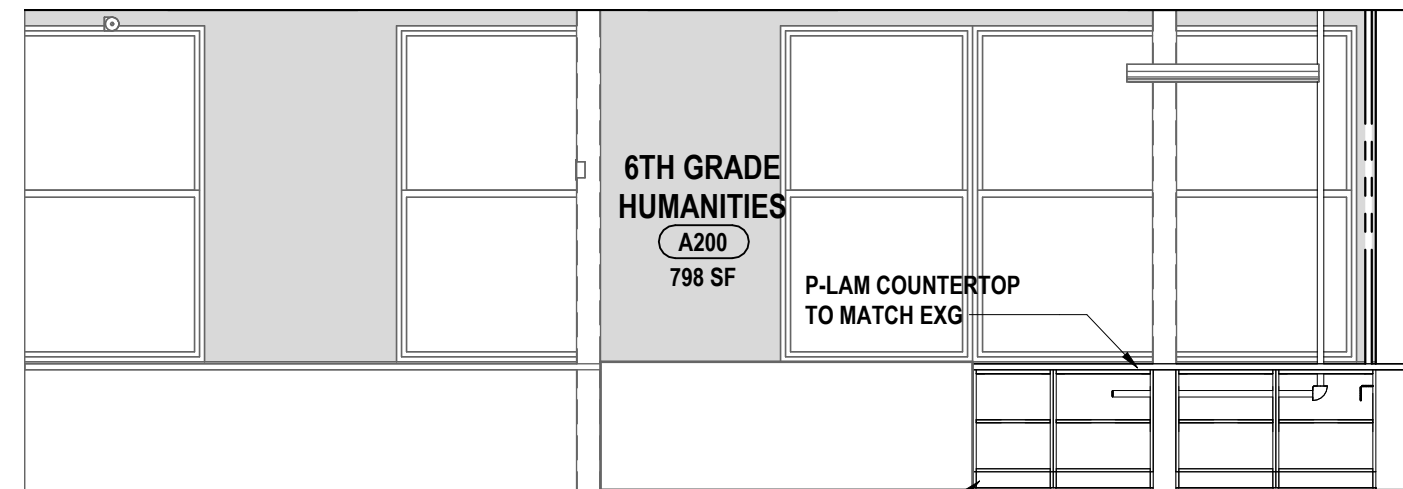


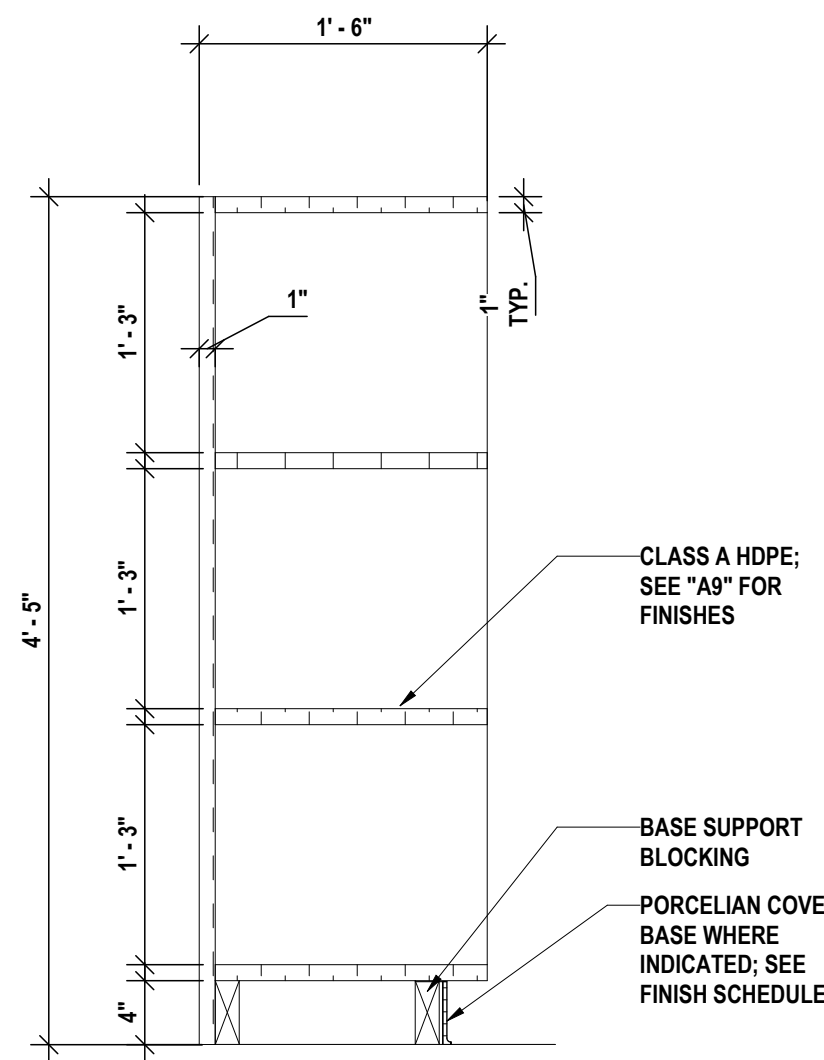


9 POOL CUBBIE SECTION (ALT. #3)  
1" = 1'-0"

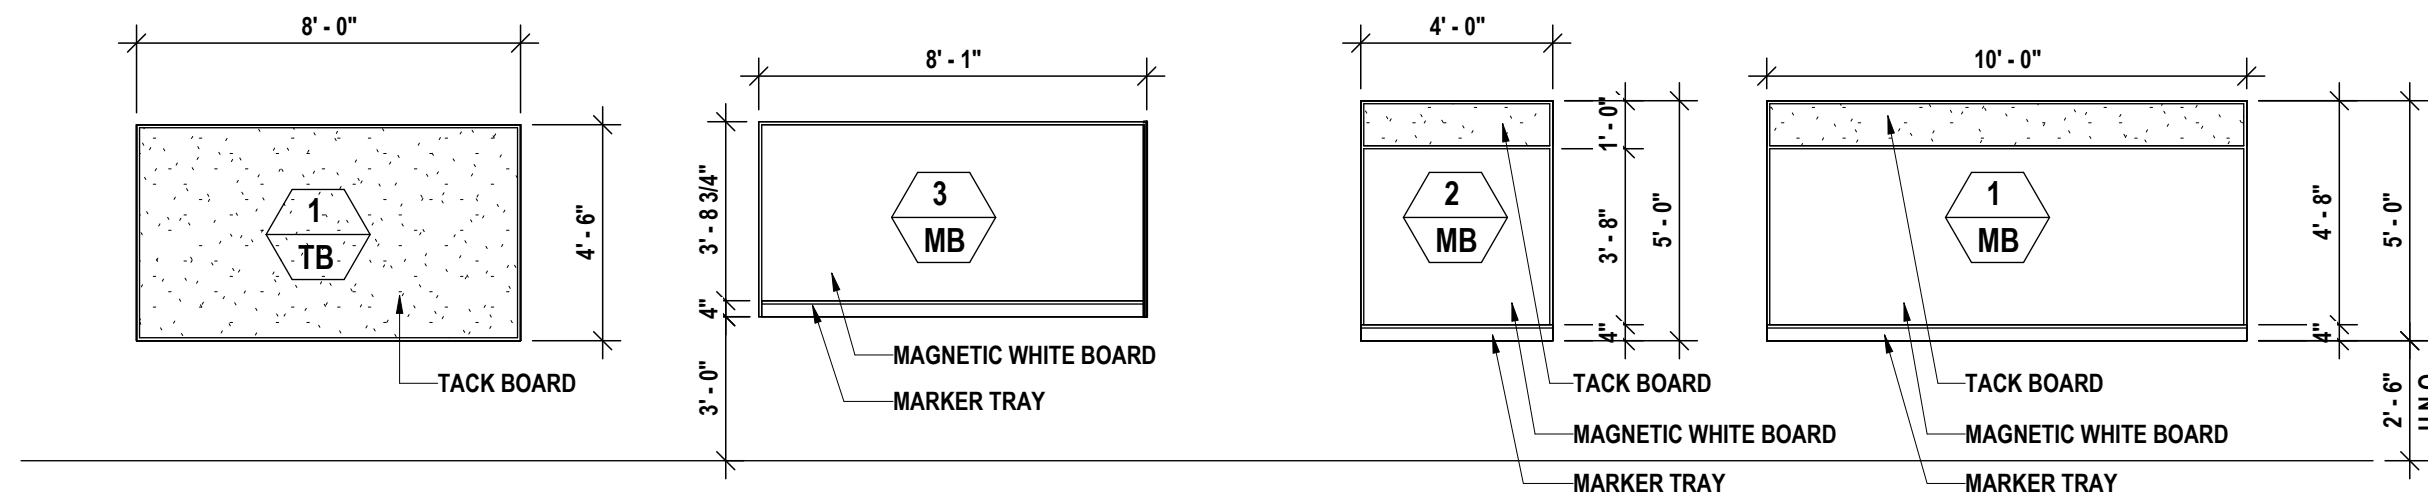


CASEWORK SCHEDULE						
MARK	HEIGHT	SIZE		DEPTH	MODEL	TYPE COMMENTS
MUSICAL INSTRUMENT CABINET						
MC-1	85 5/8"	27 1/2"	31 3/4"	#03		
MC-2	85 5/8"	27 1/2"	41 3/4"	#05		
MC-3	85 5/8"	27 1/2"	41 3/4"	#07		
MC-4	85 5/8"	27 1/2"	41 1/4"	#11		
MC-5	85 5/8"	48 1/2"	41 3/4"	#12		
MC-6	85 5/8"	48 1/2"	41 3/4"	#15		
POOL CUBBIES						
PC-1	53"	296"	18"		CLASS A HOPE CUSTOM CUBBIES	
SINK BASE CABINET						
SB-1	32 1/2"	82 1/2"	22 1/2"	#760 - (6'-10" WIDE)	SLOPED ADA ENCLOSURE PANEL	
WALL CABINET						
W-3	23 3/4"	81"	12"	4298 CUSTOM WIDTH		




3 6TH GRADE HUMANITIES ELEVATION 1  
1/4" = 1'-0"

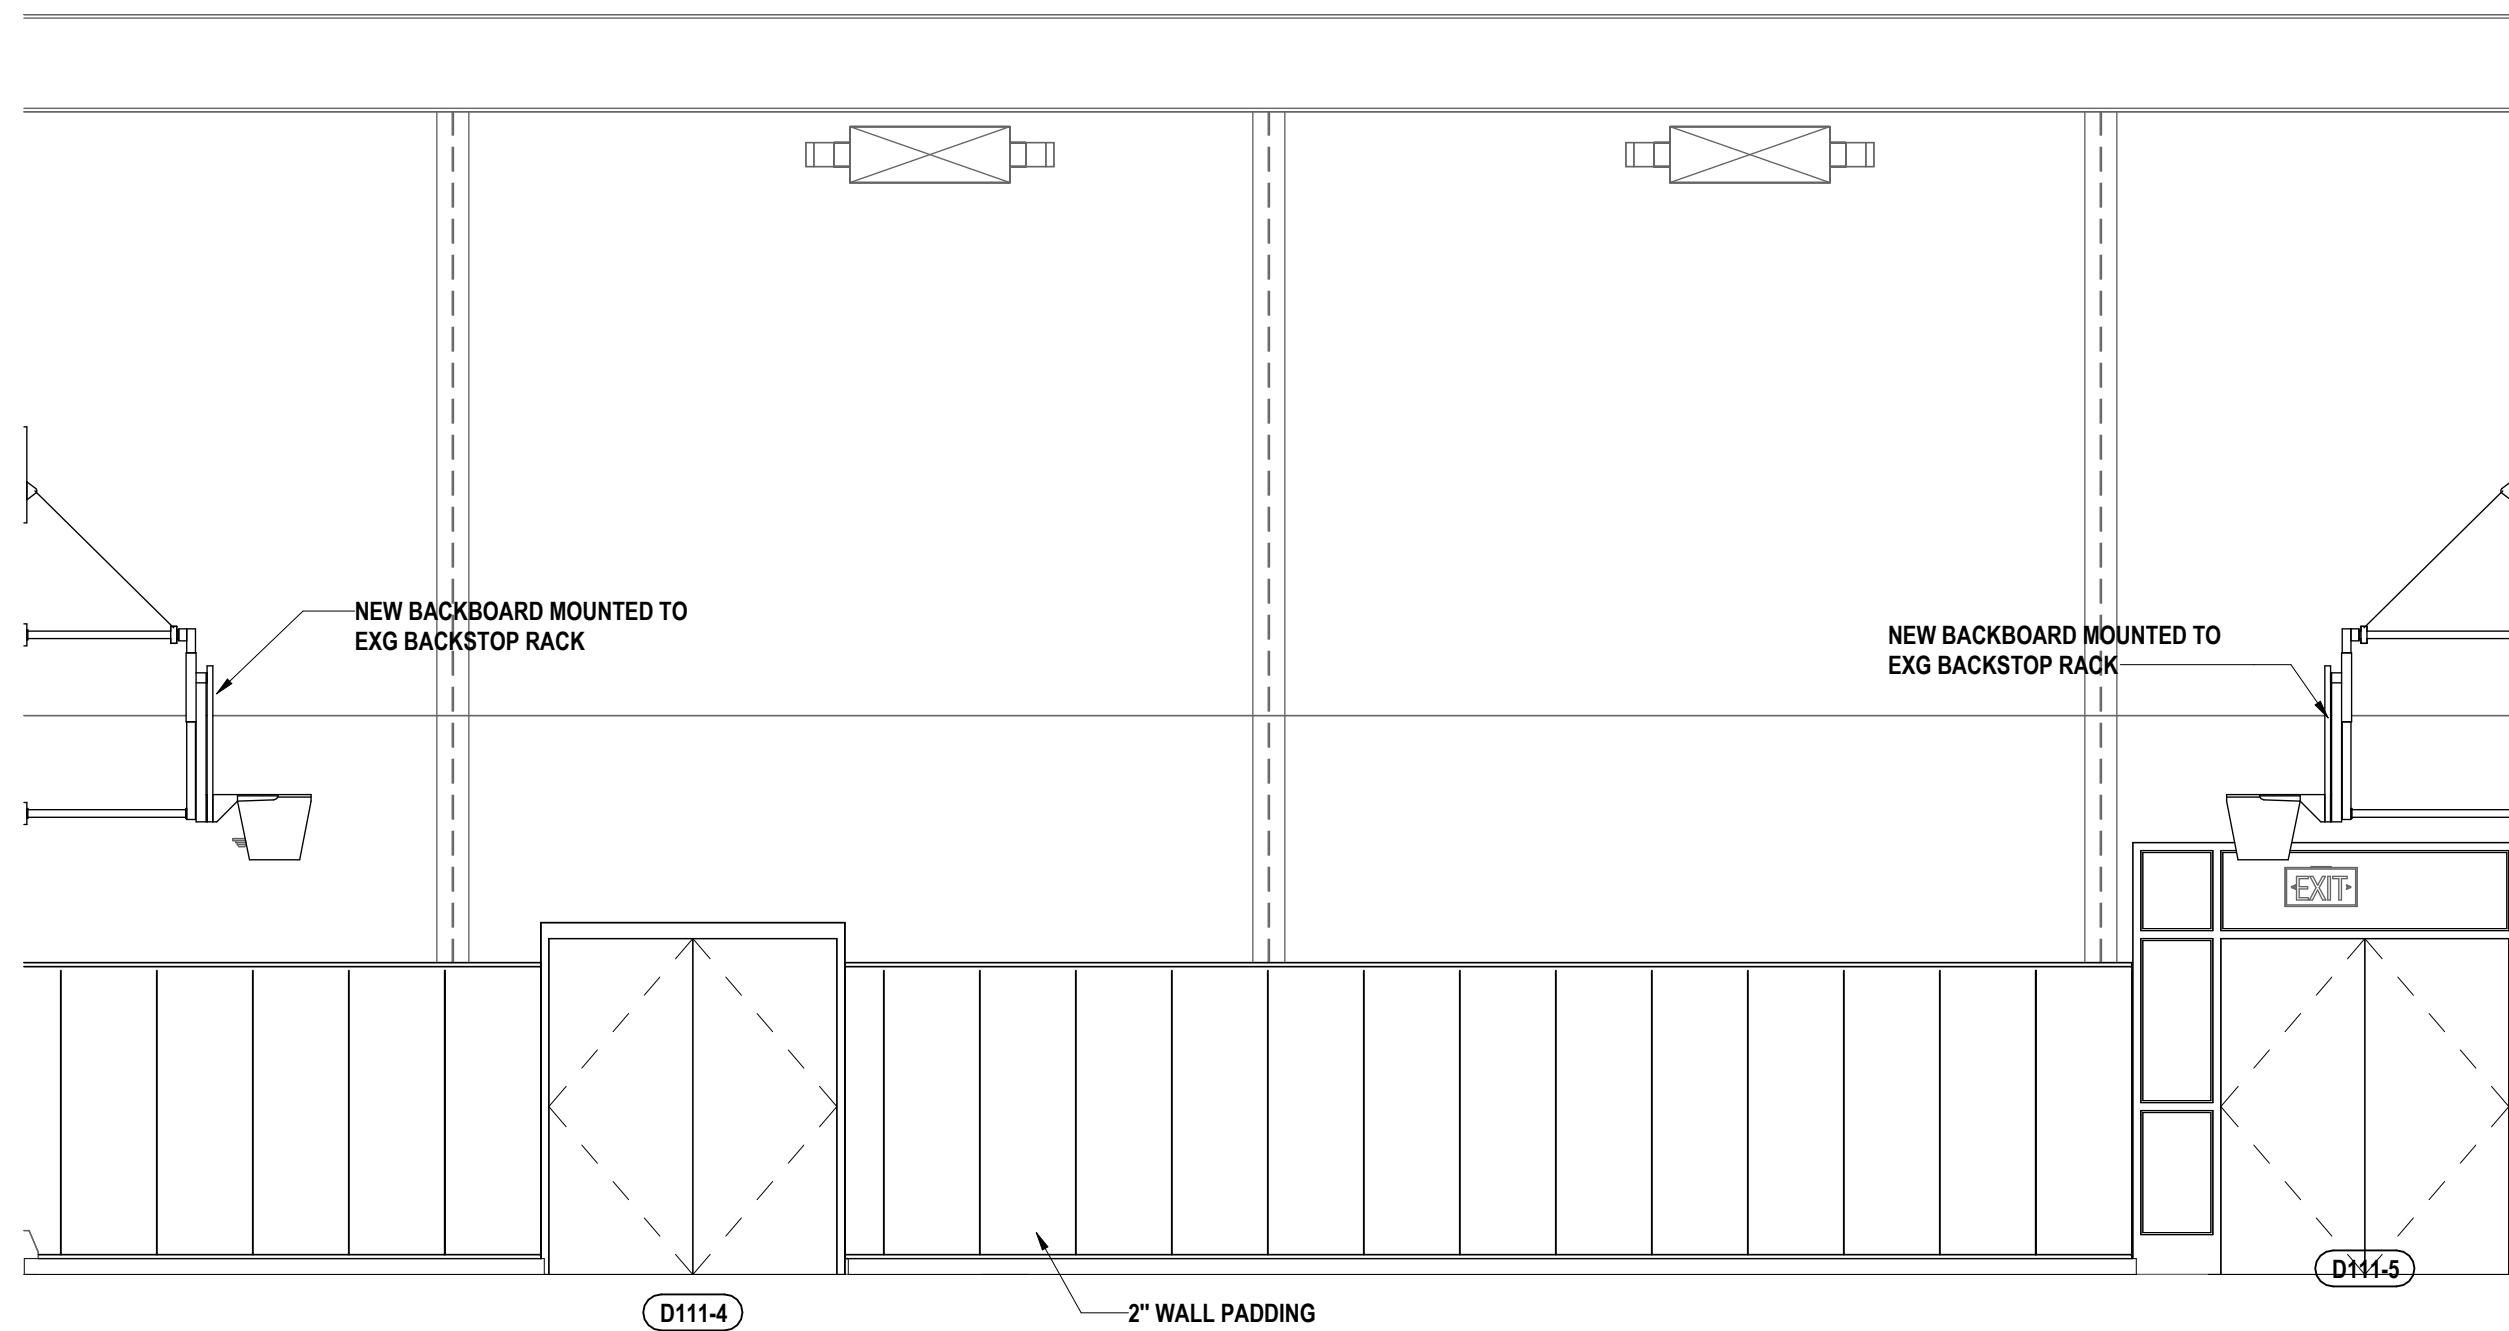


6 AUXILIARY GYMNASIUM ELEVATION 1  
1/4" = 1'-0"

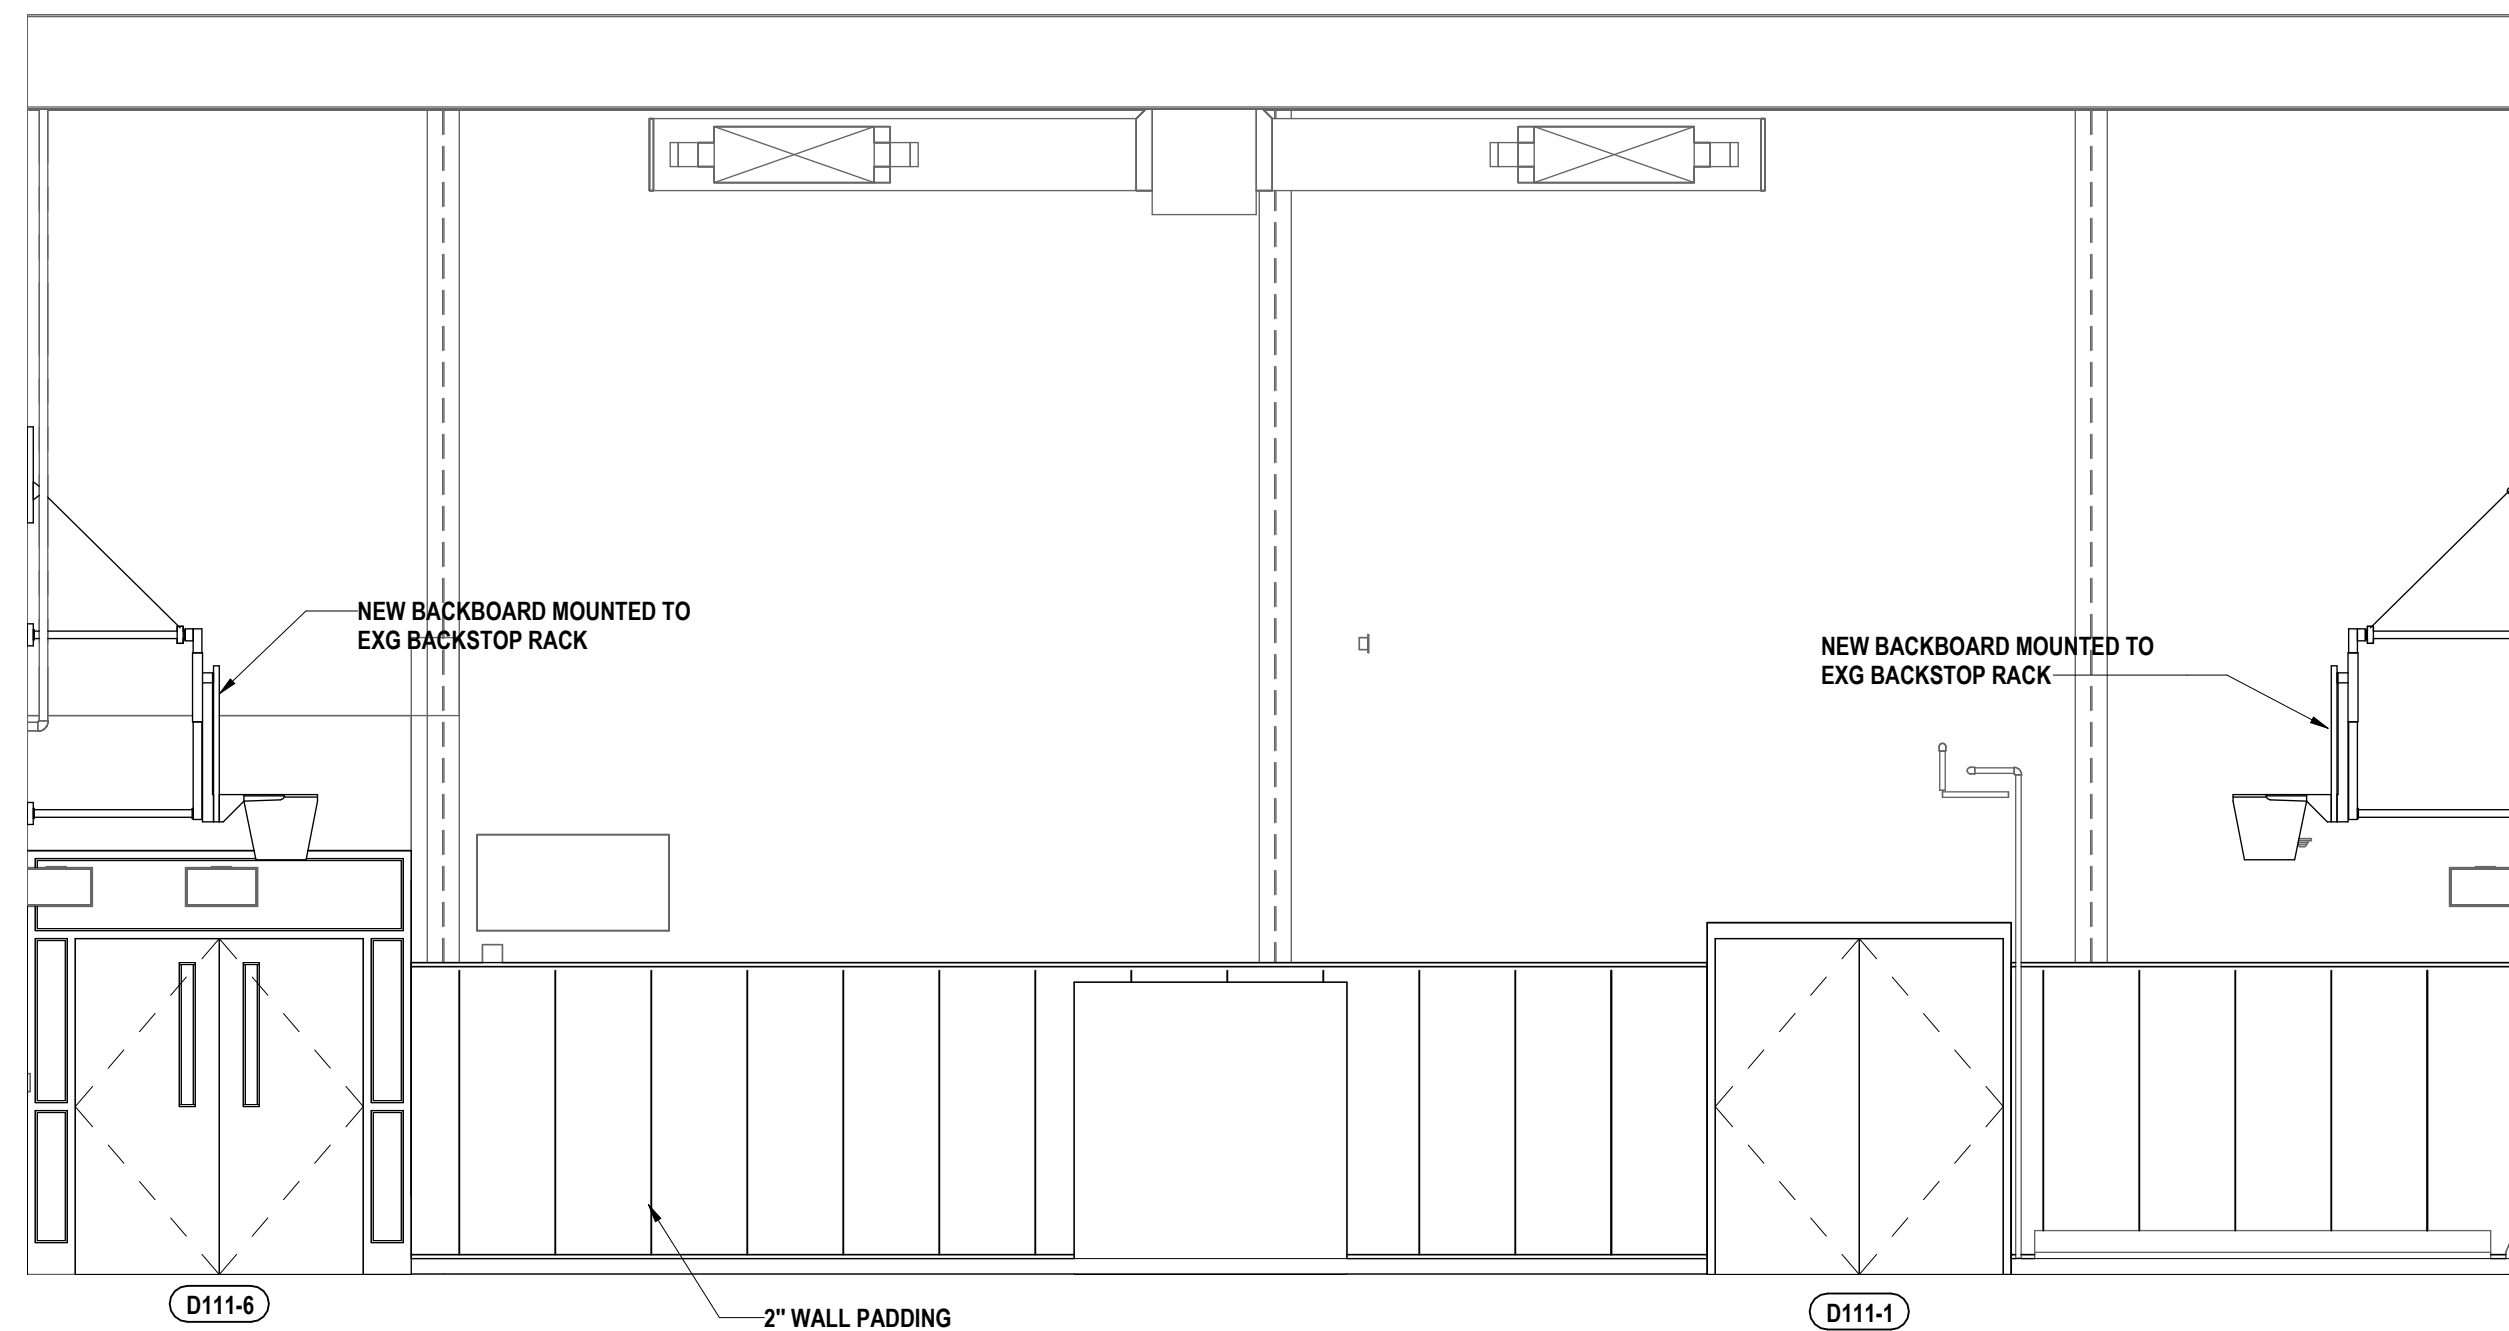


5 AUXILIARY GYMNASIUM ELEVATION 2  
1/4" = 1'-0"

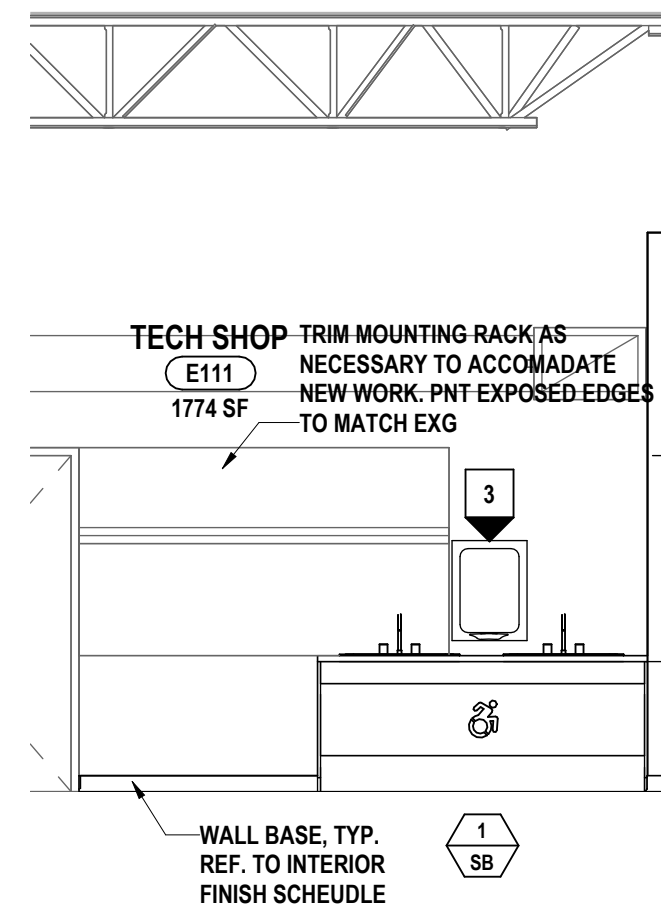


4 TECH ROOM INTERIOR ELEVATION 1  
1/4" = 1'-0"

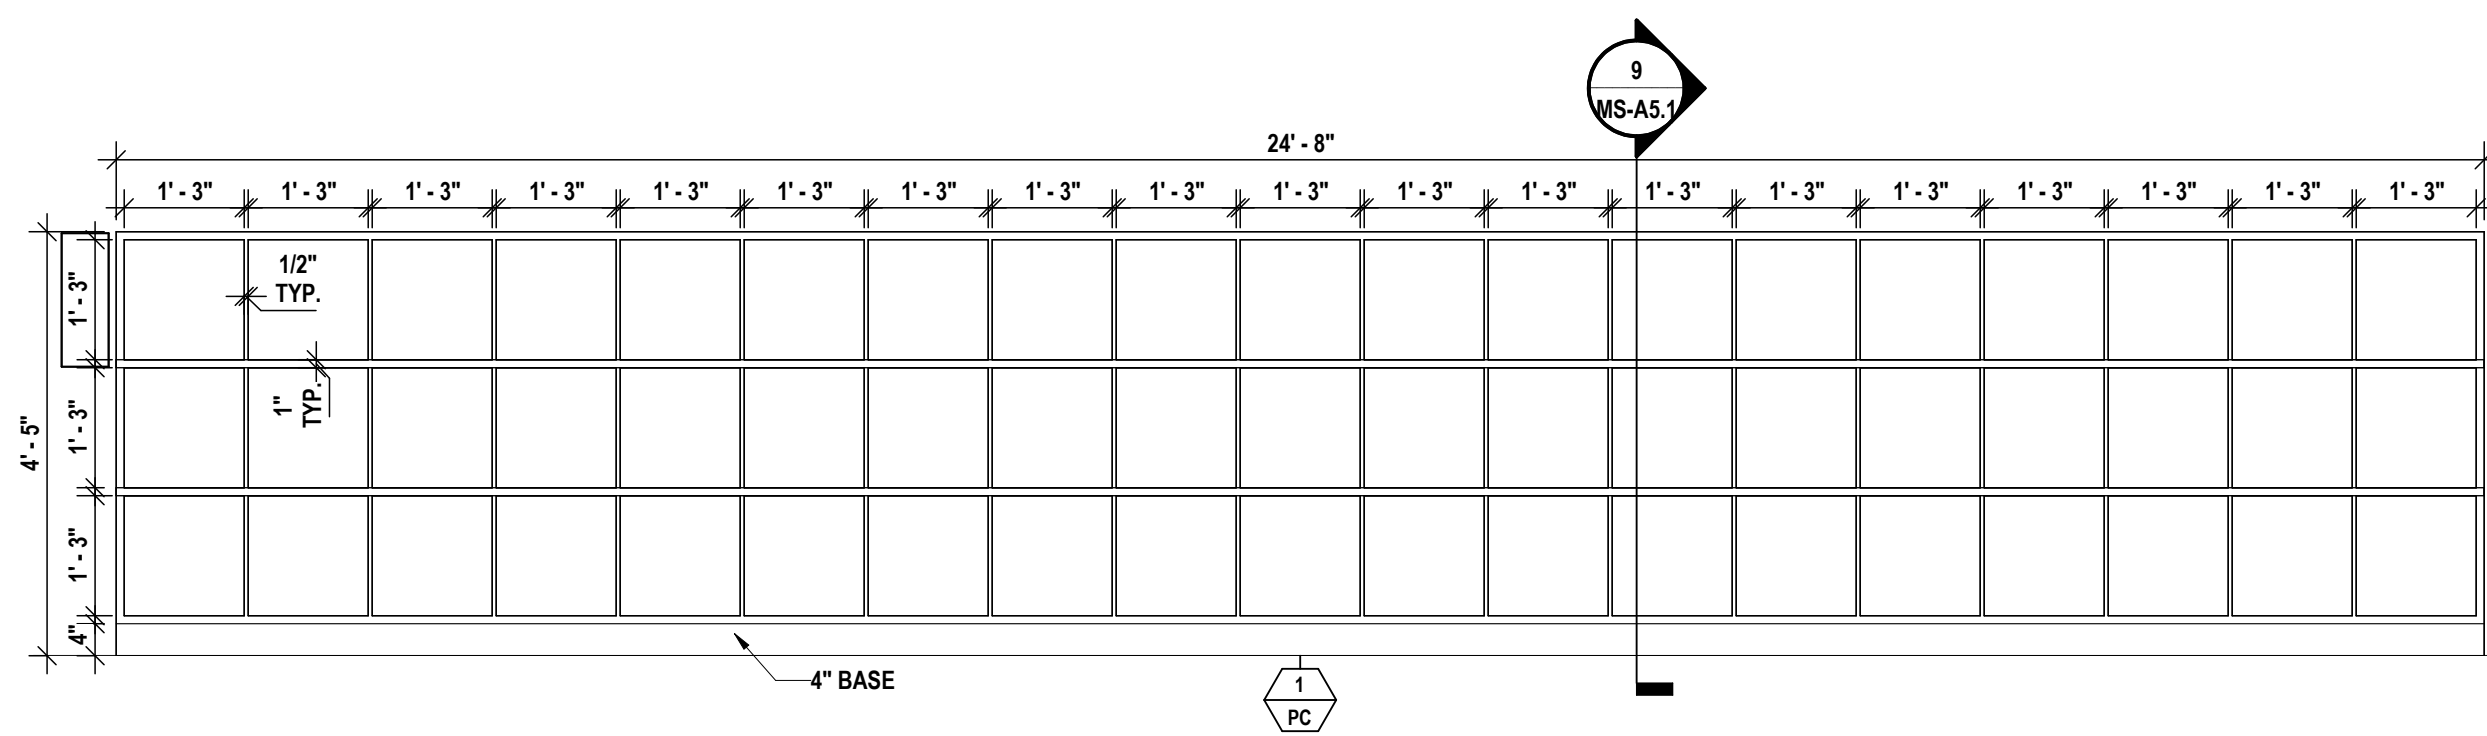

10 POOL CUBBIES AND LOCKERS ELEVATION (ALT. #3)  
1/2" = 1'-0"

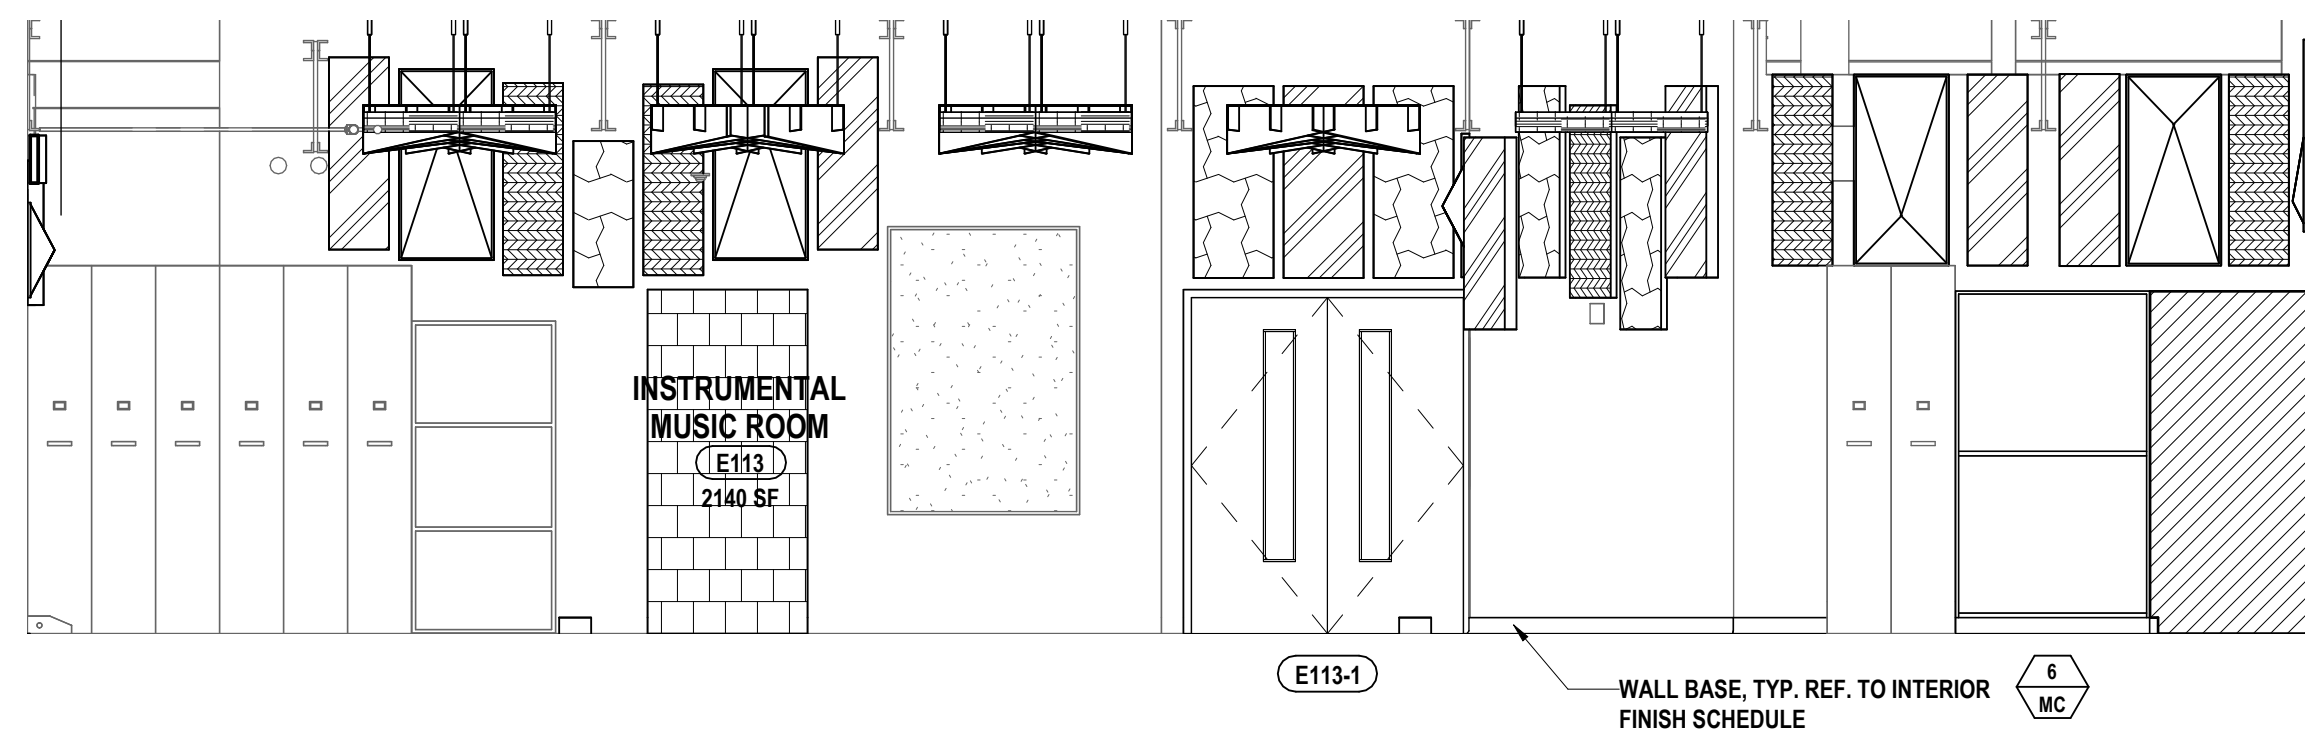


2 E113 INSTRUMENT MUSIC ROOM - INTERIOR ELEVATION B  
1/4" = 1'-0"

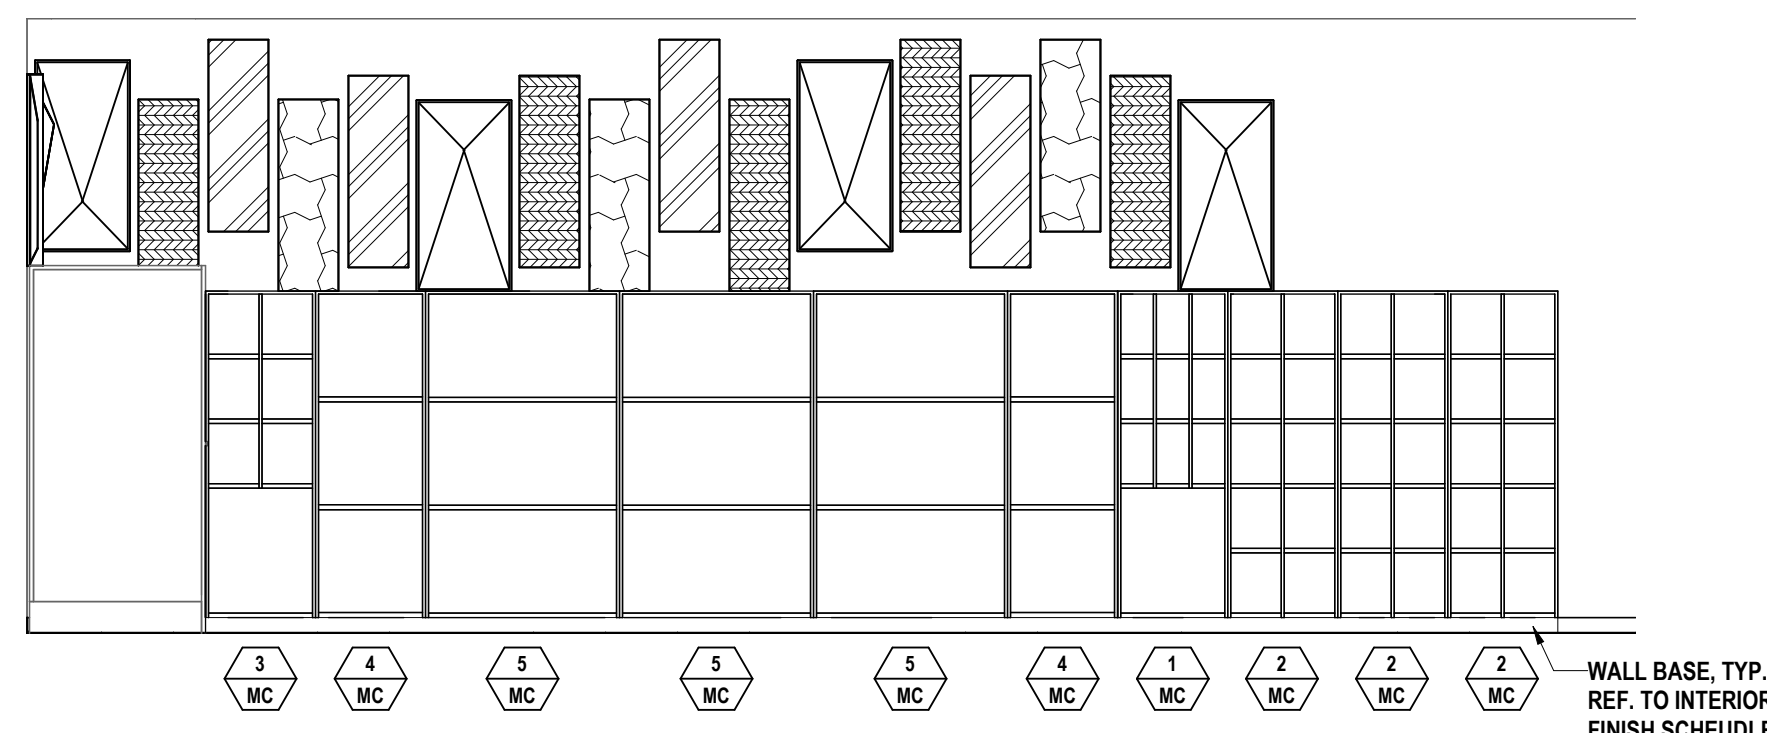








1 E113 INSTRUMENT MUSIC ROOM - INTERIOR ELEVATION A  
1/4" = 1'-0"



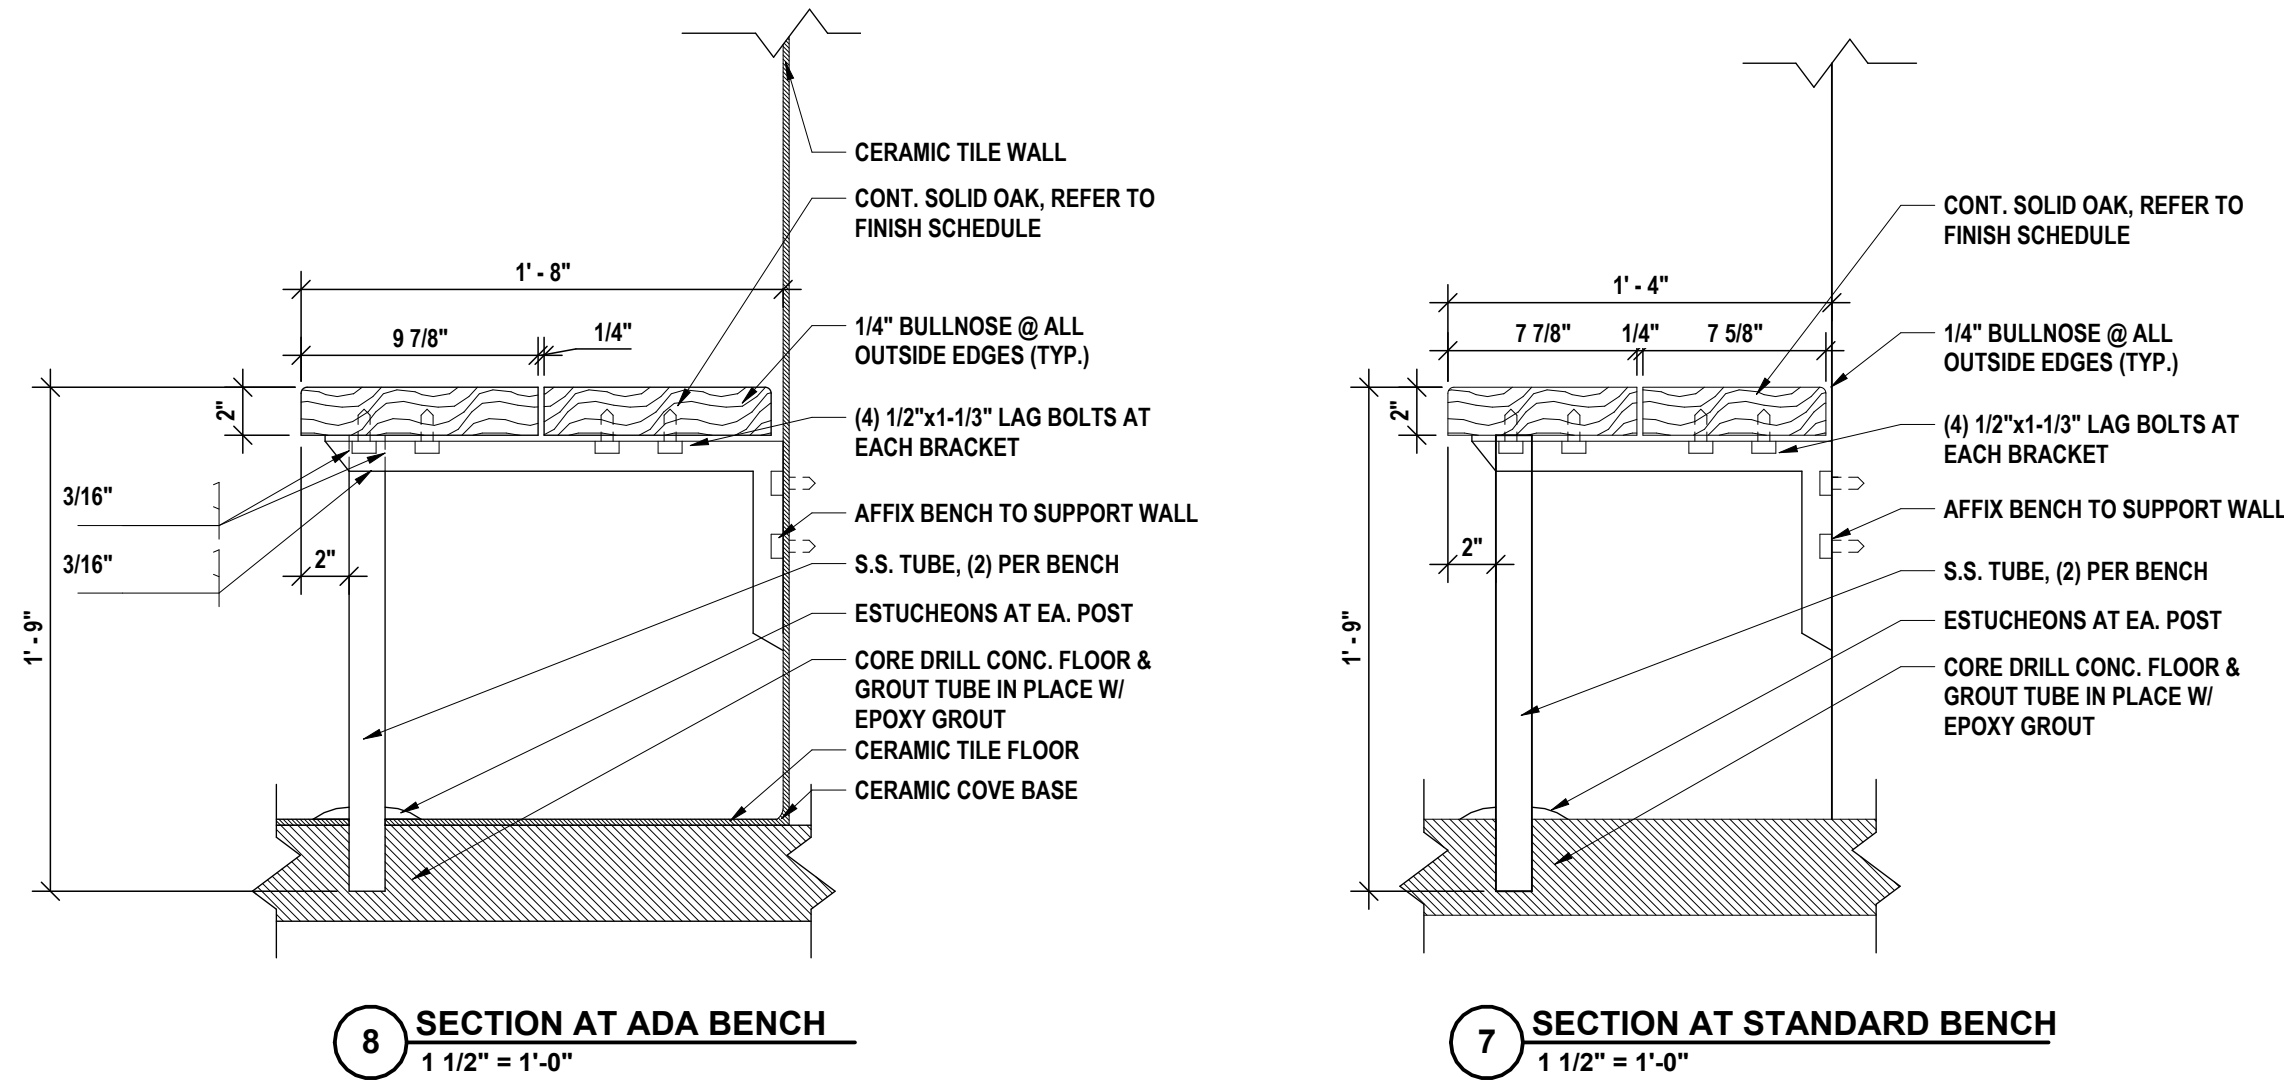

TOILET ROOM ACCESSORY SCHEDULE					
SYMBOL	DESCRIPTION	MANUFACT.	MODEL	SIZE	REMARKS
1A	GRAB BAR	AMERICAN SPECIALTIES INC.	#3800 SERIES	36"	
1B	GRAB BAR	AMERICAN SPECIALTIES INC.	#3800 SERIES	48"	
1C	GRAB BAR	AMERICAN SPECIALTIES INC.	#3800 SERIES	18"	
2	TOILET PAPER DISPENSER	AMERICAN SPECIALTIES INC.	74022-HSSM	-	FURNISHED BY OWNER INSTALLED BY CONTRACTOR
3	PAPER TOWEL DISPENSER	AMERICAN SPECIALTIES INC.	-	-	FURNISHED BY OWNER INSTALLED BY CONTRACTOR
4	URINAL SCREEN	American Sanitary Partition Corp.	0336-D	-	FURNISHED BY OWNER INSTALLED BY CONTRACTOR
5	SOAP DISPENSER	AMERICAN SPECIALTIES INC.	#600 SERIES	-	
6	MIRROR	AMERICAN SPECIALTIES INC.	1200-V42	42" X 72"	
7	SHOWER CURTAIN	INPRO COPORATION	-	-	
8	ADA SHOWER SEAT	AMERICAN SPECIALTIES INC.	#8208 SERIES	-	INCLUDES SOAP DISH (#7320) & TOWEL PIN (#7301)
9	BABY CHANGING STATION	RUBBERMAID COMMERCIAL PRODUCTS	#FG781888	-	
10	SANITARY NAPKIN DISPOSAL	AMERICAN SPECIALTIES INC.	#0473-1A SERIES	-	

- NOTES:
1. REFER TO FLOOR PLANS FOR QUANTITIES
  2. CUT ALL REQUIRED OPENINGS IN SCHEDULED WALL TYPES TO ACCOMMODATE RECESSED ACCESSORIES
  3. REFER TO SECTION 10170 OF PROJECT MANUAL FOR TOILET COMPARTMENTS AND URINAL SCREENS
  4. ALL DIMENSIONS FROM FACE OF FINISHED FLOOR OR WALL

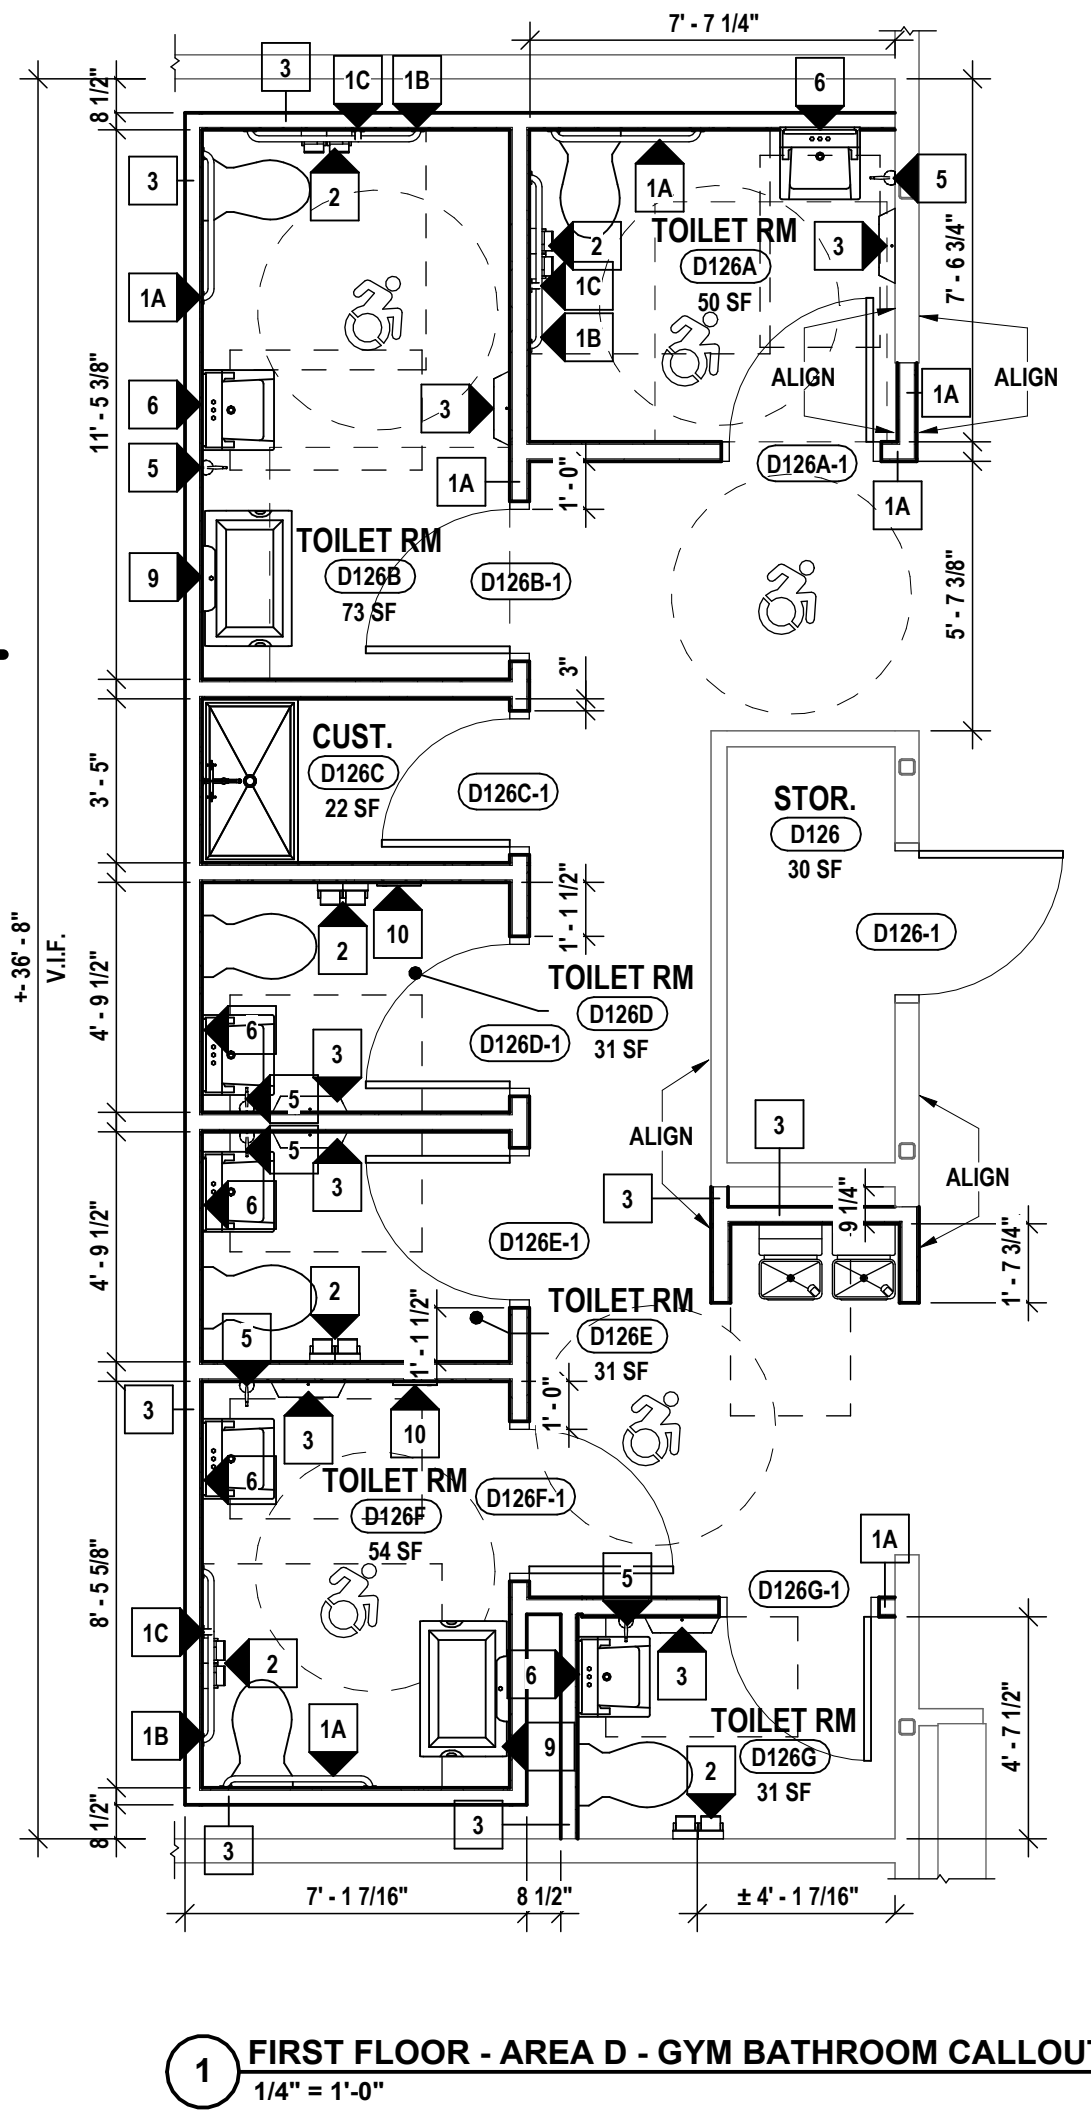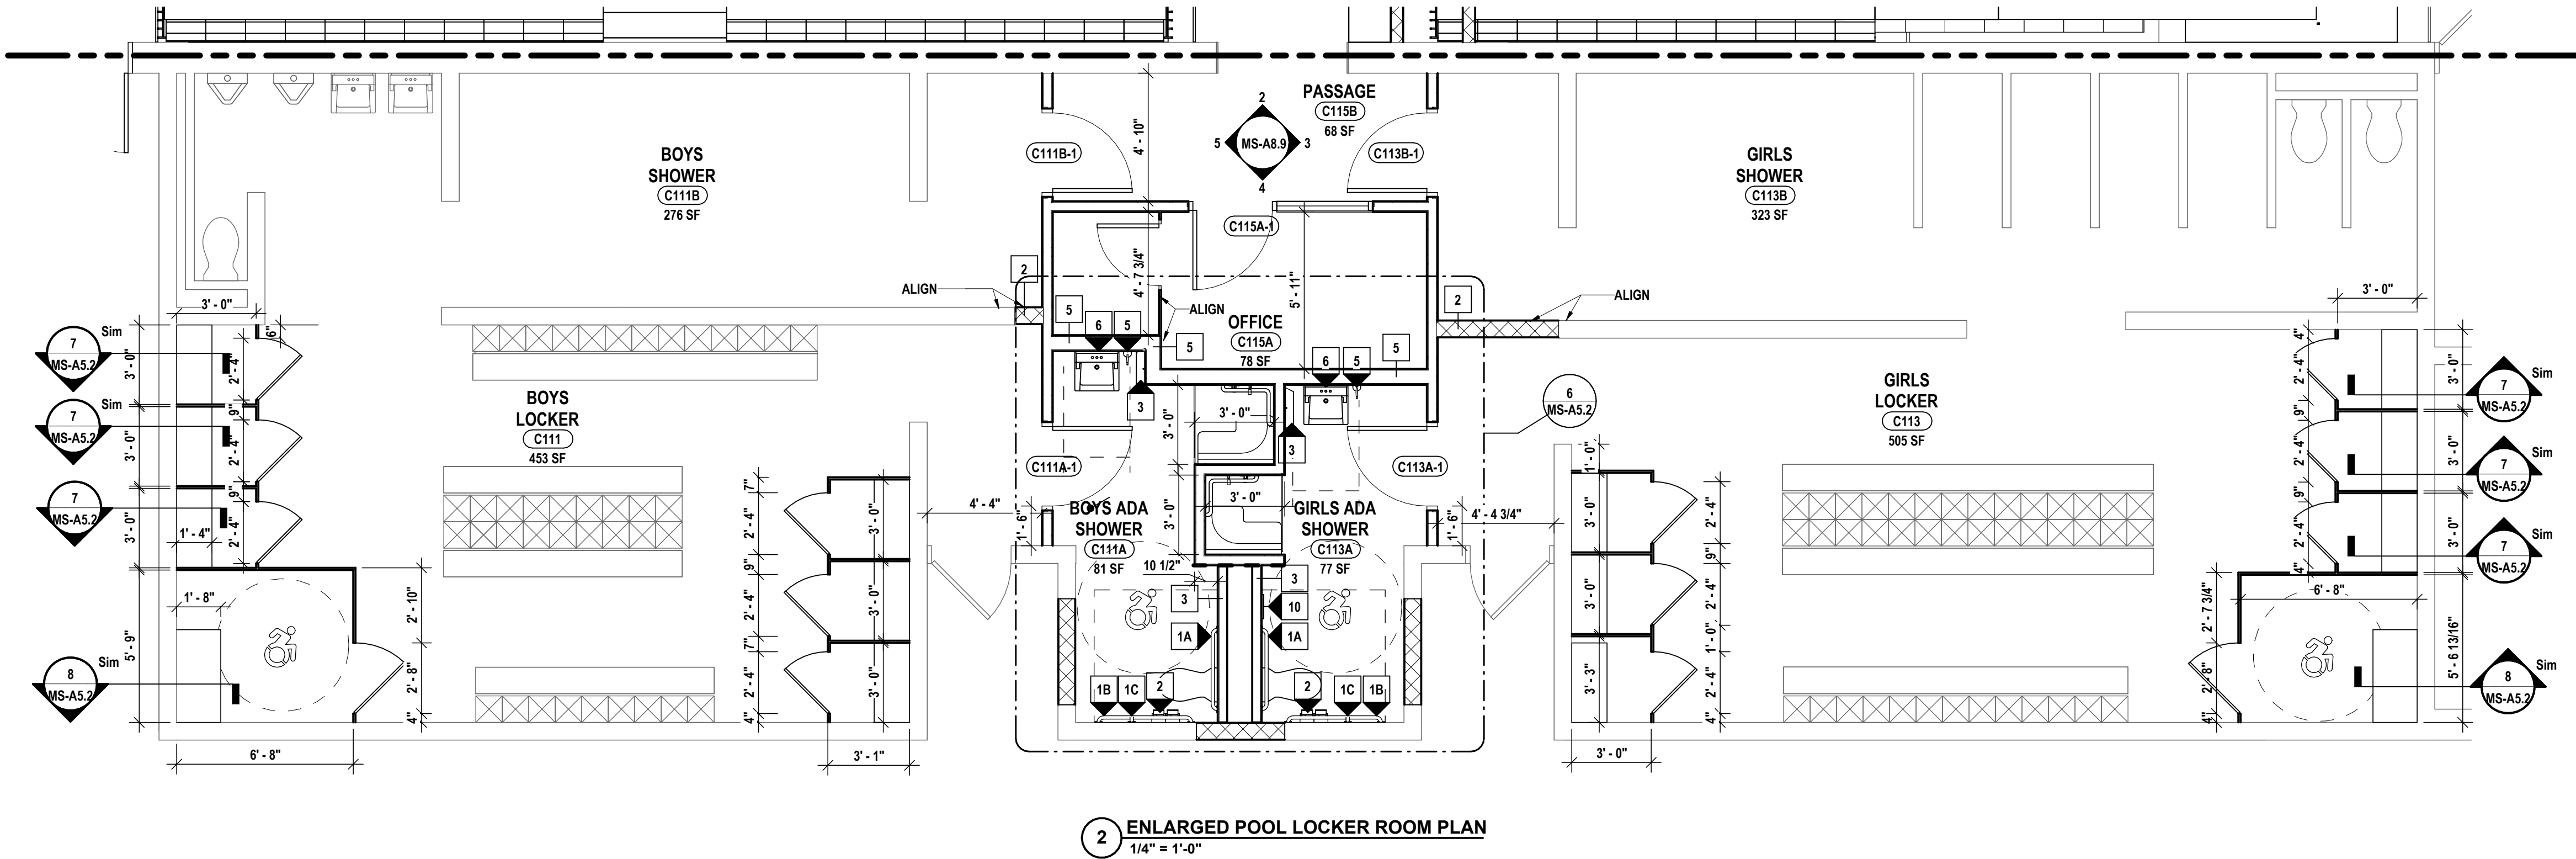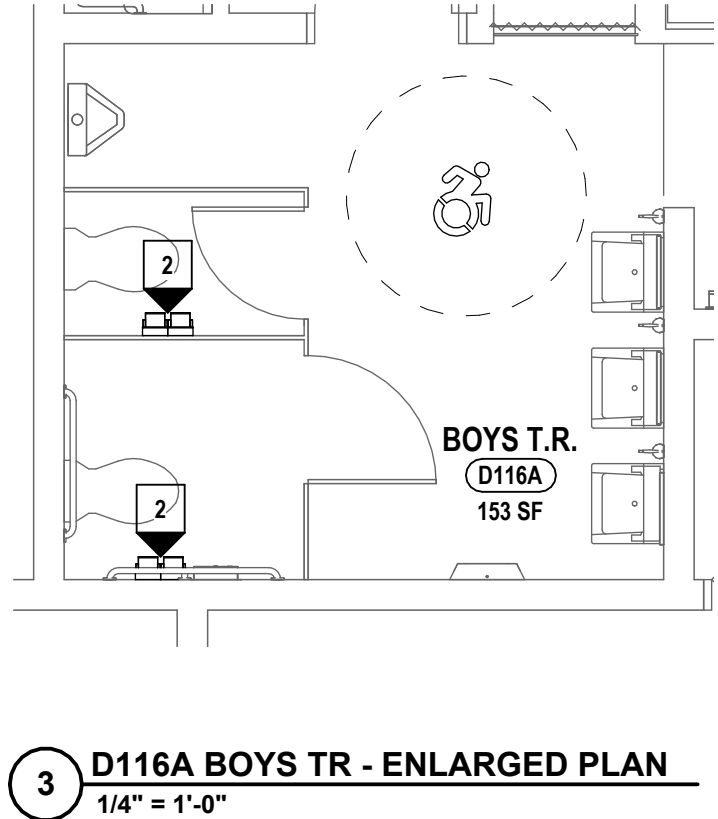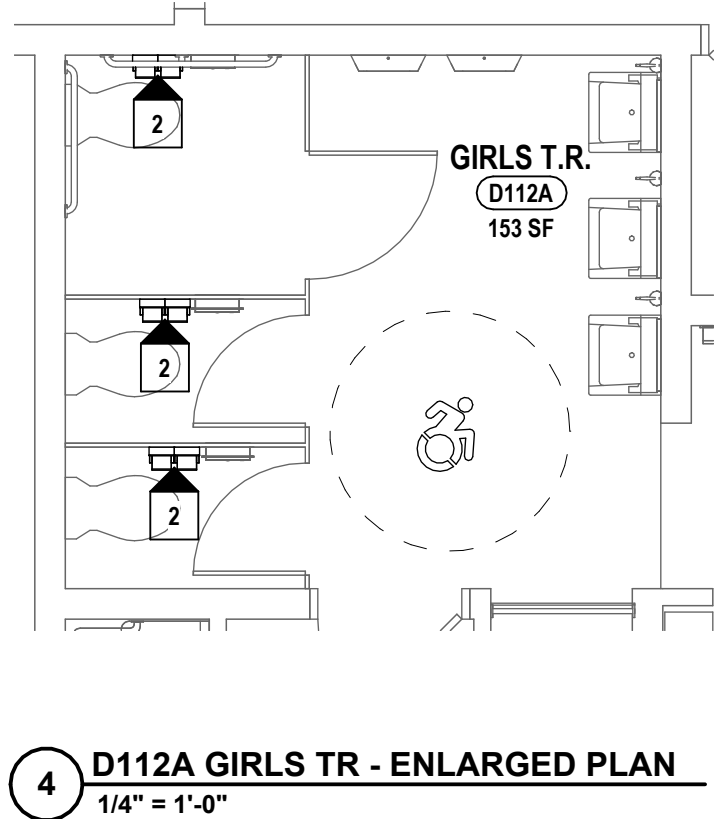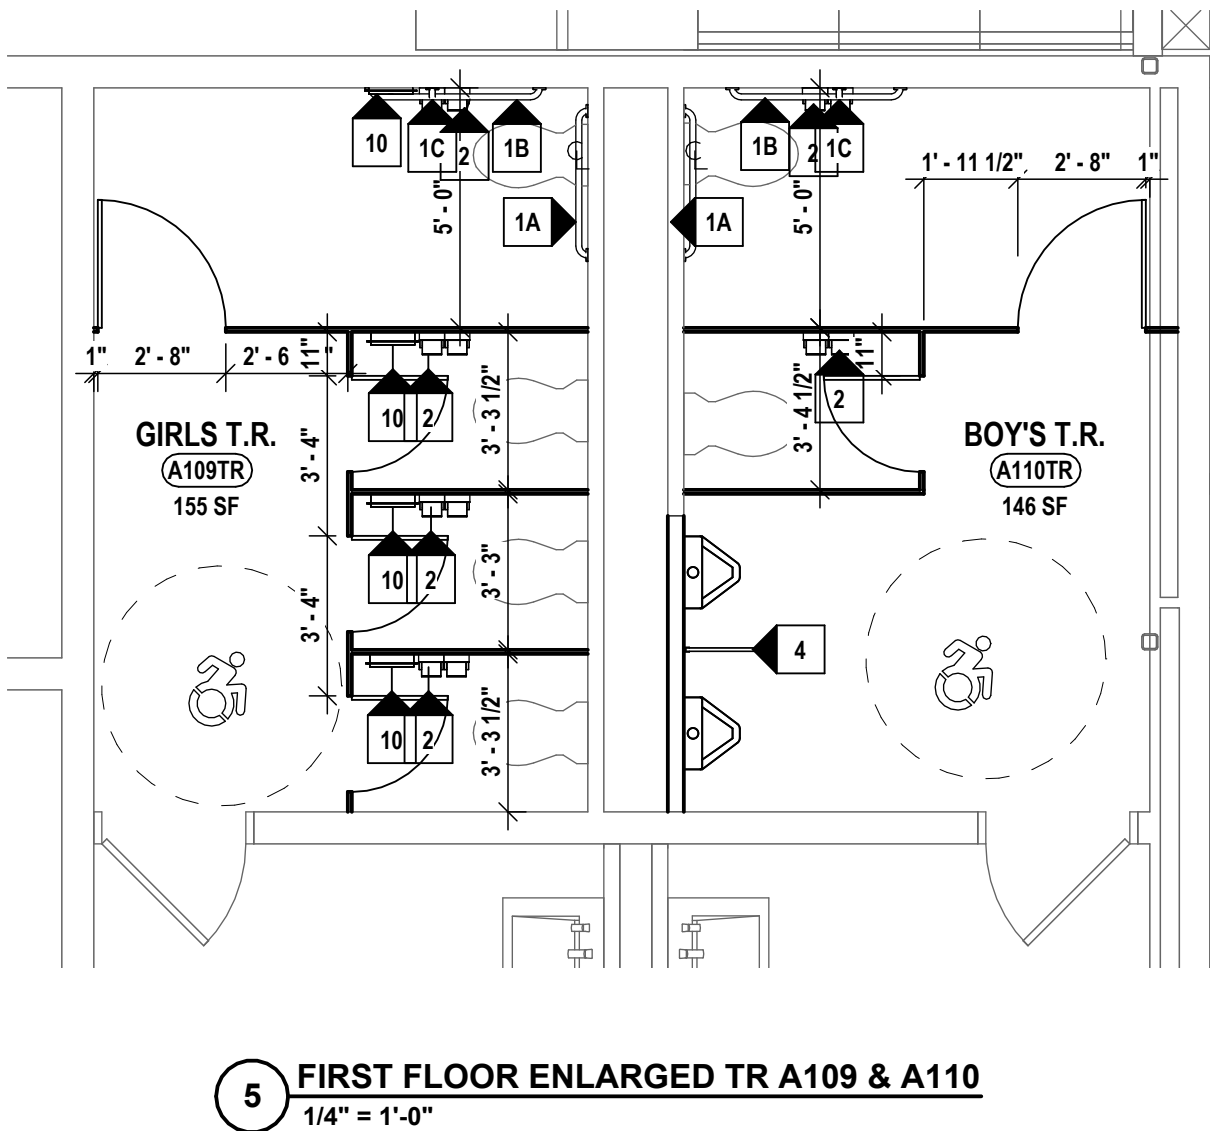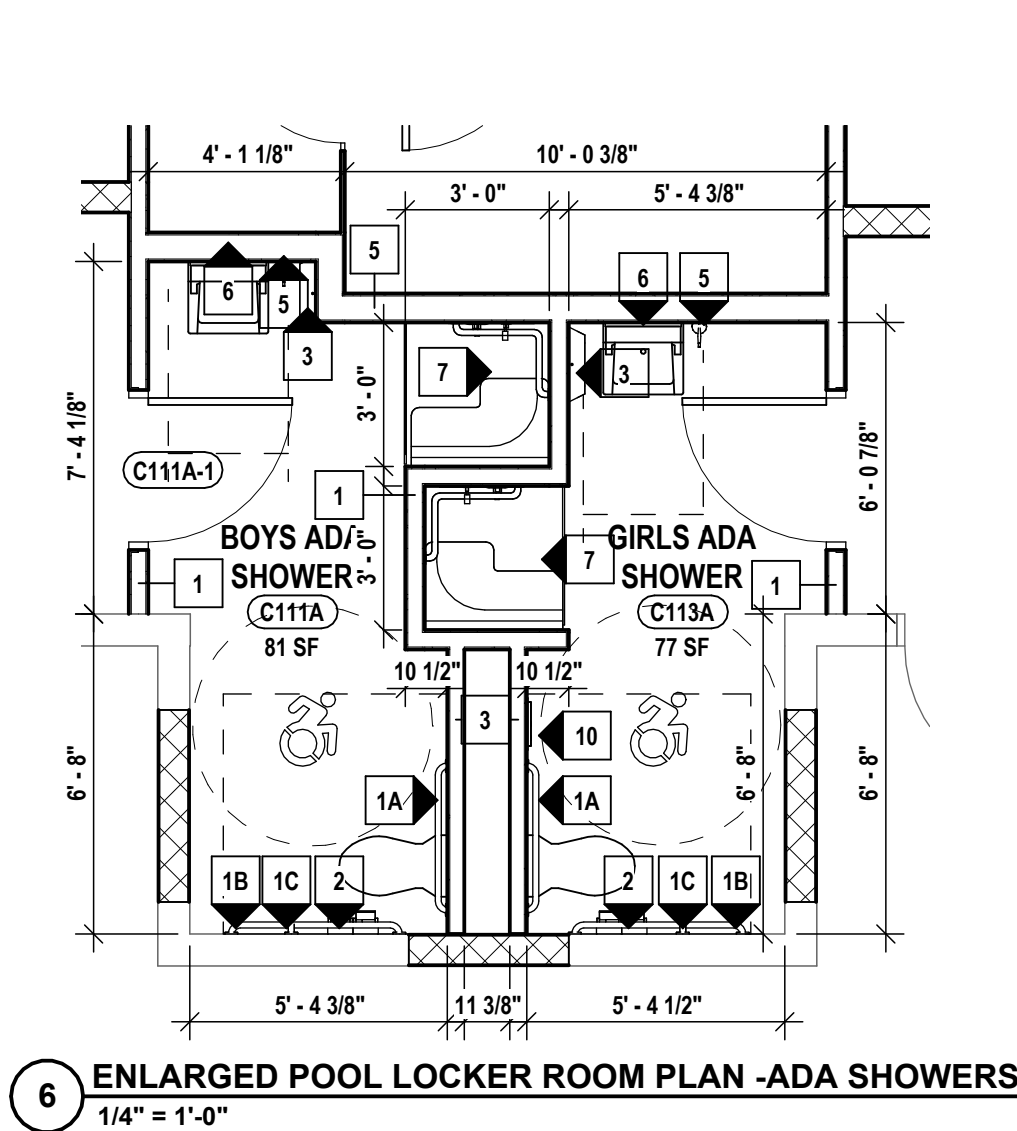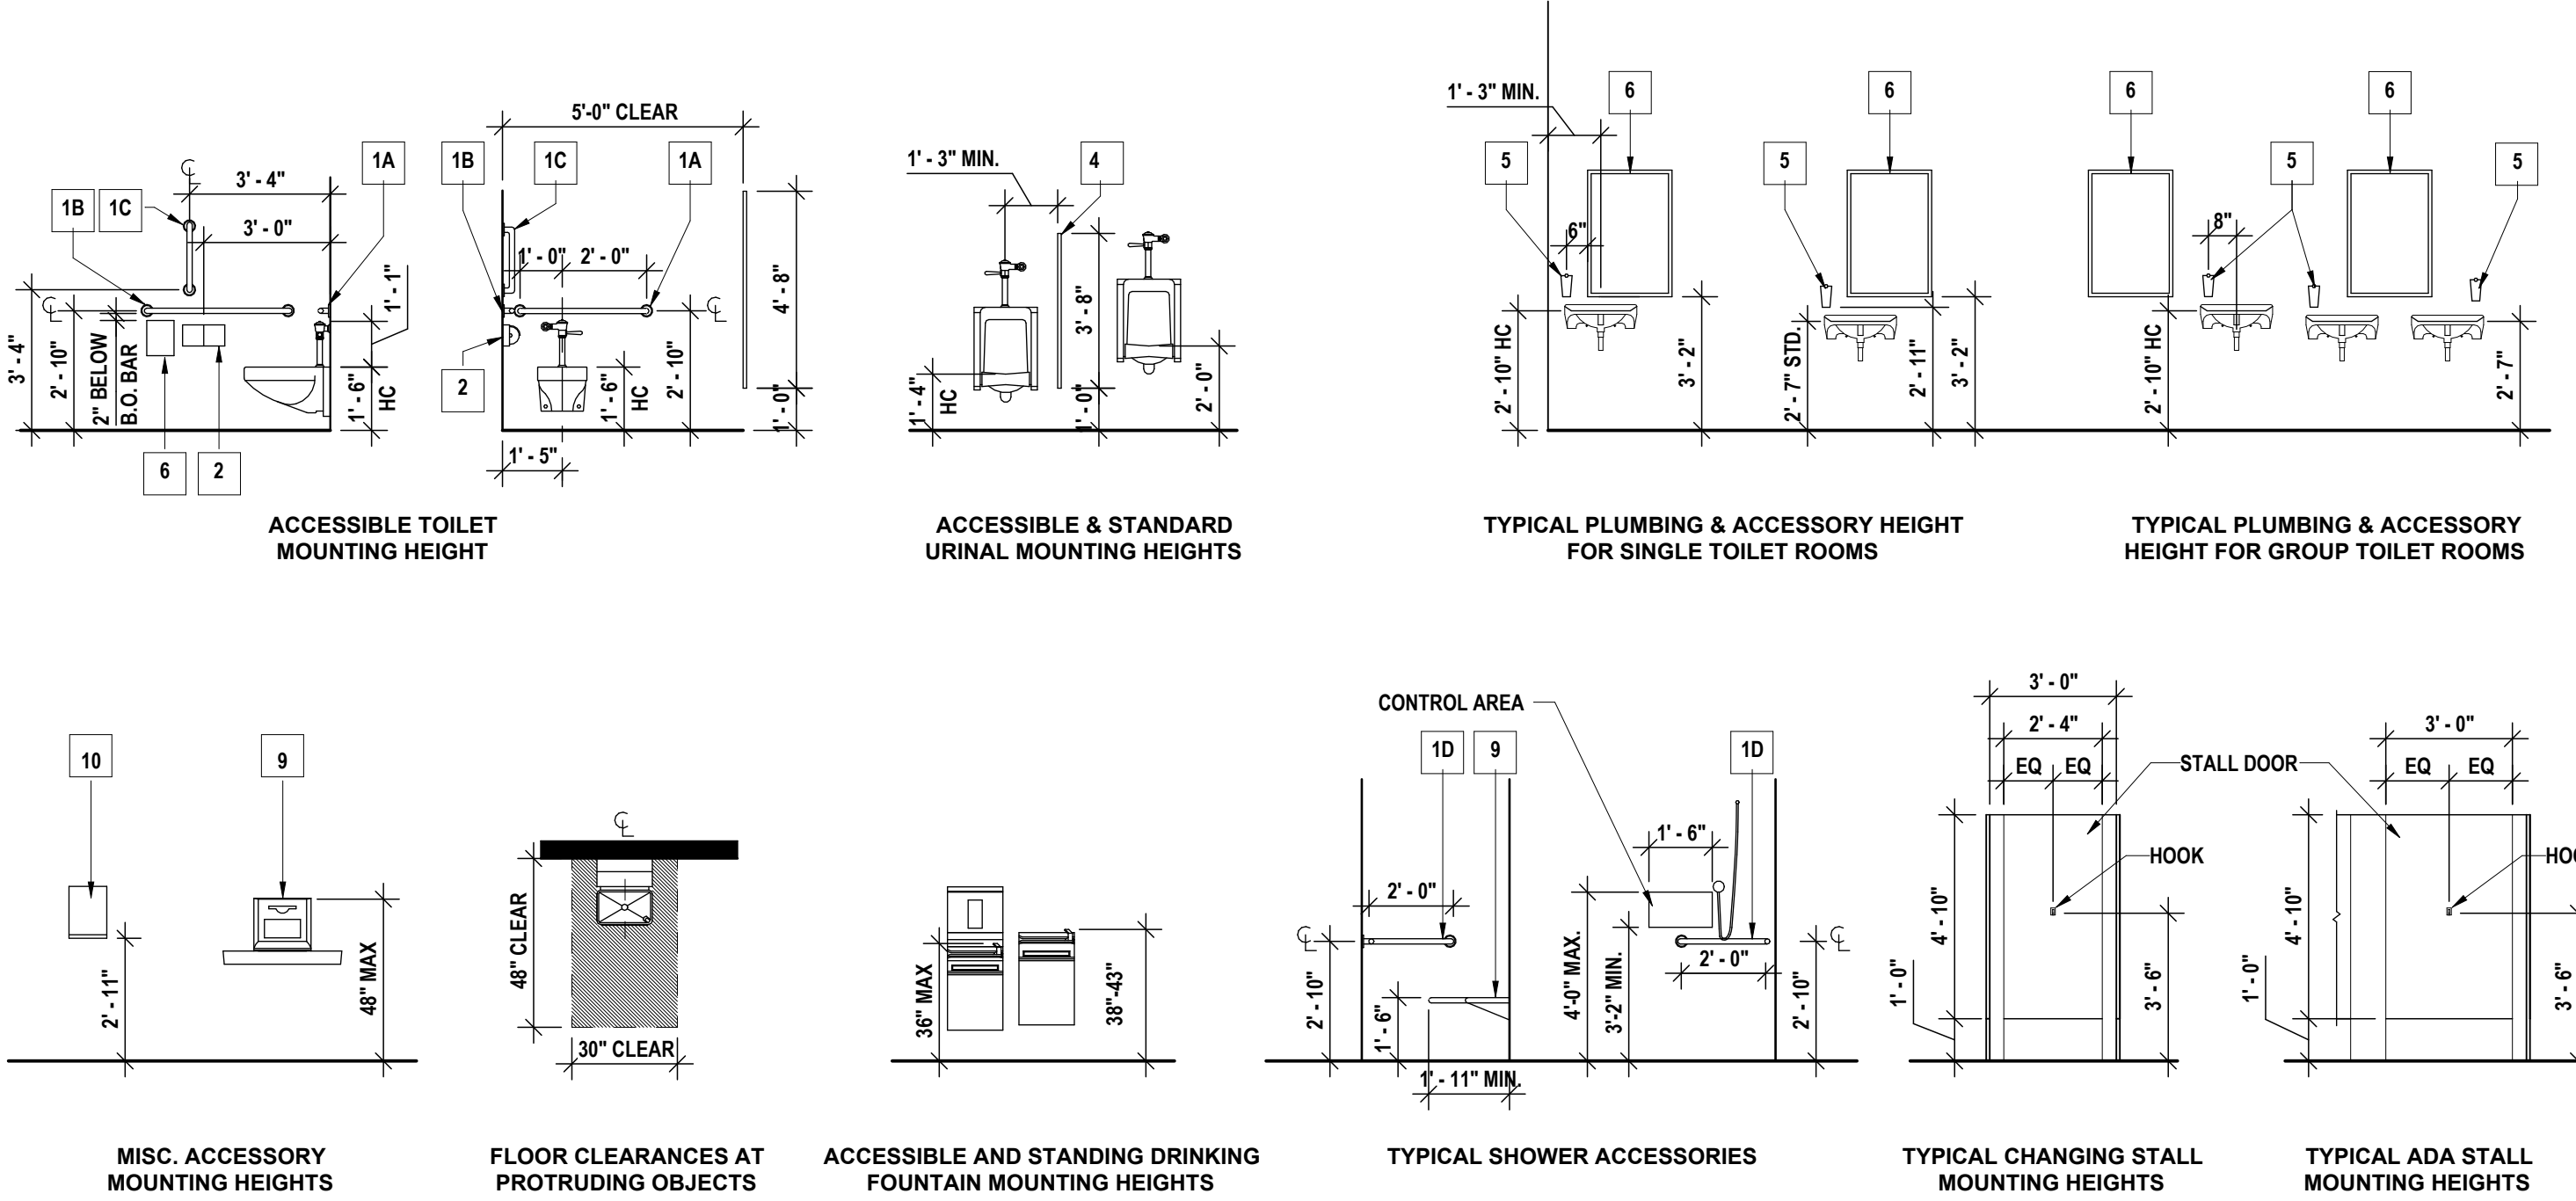


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DESCRIPTION OF REVISION: ISSUED FOR BID	
# DATE: 1 10/02/2025	

**HUNT ENGINEERS | ARCHITECTS | SURVEYORS**  
HORSEHEADS, NY 807-265-1000 ROCHESTER, NY 585-337-7868 TOWNANDA, PA 570-265-4606  
BINGHAMTON, NY 807-798-8881 ALBANY, NY 807-798-8801  
WWW.HUNTEAS.COM  
NY CERTIFICATE NO. 0016220 PA CERTIFICATE NO. TSC2202013464-1

**ENLARGED TOILET ROOMS AND LOCKER PLANS**  
**2025 MIDDLE SCHOOL PHASE III ALTERATIONS PROJECT**  
**CORNING-PAINTED POST ASD**  
35 VICTORY HIGHWAY, PAINTED POST, NY 14870

**MS-A5.2**  
PROJECT NO: 2649-133



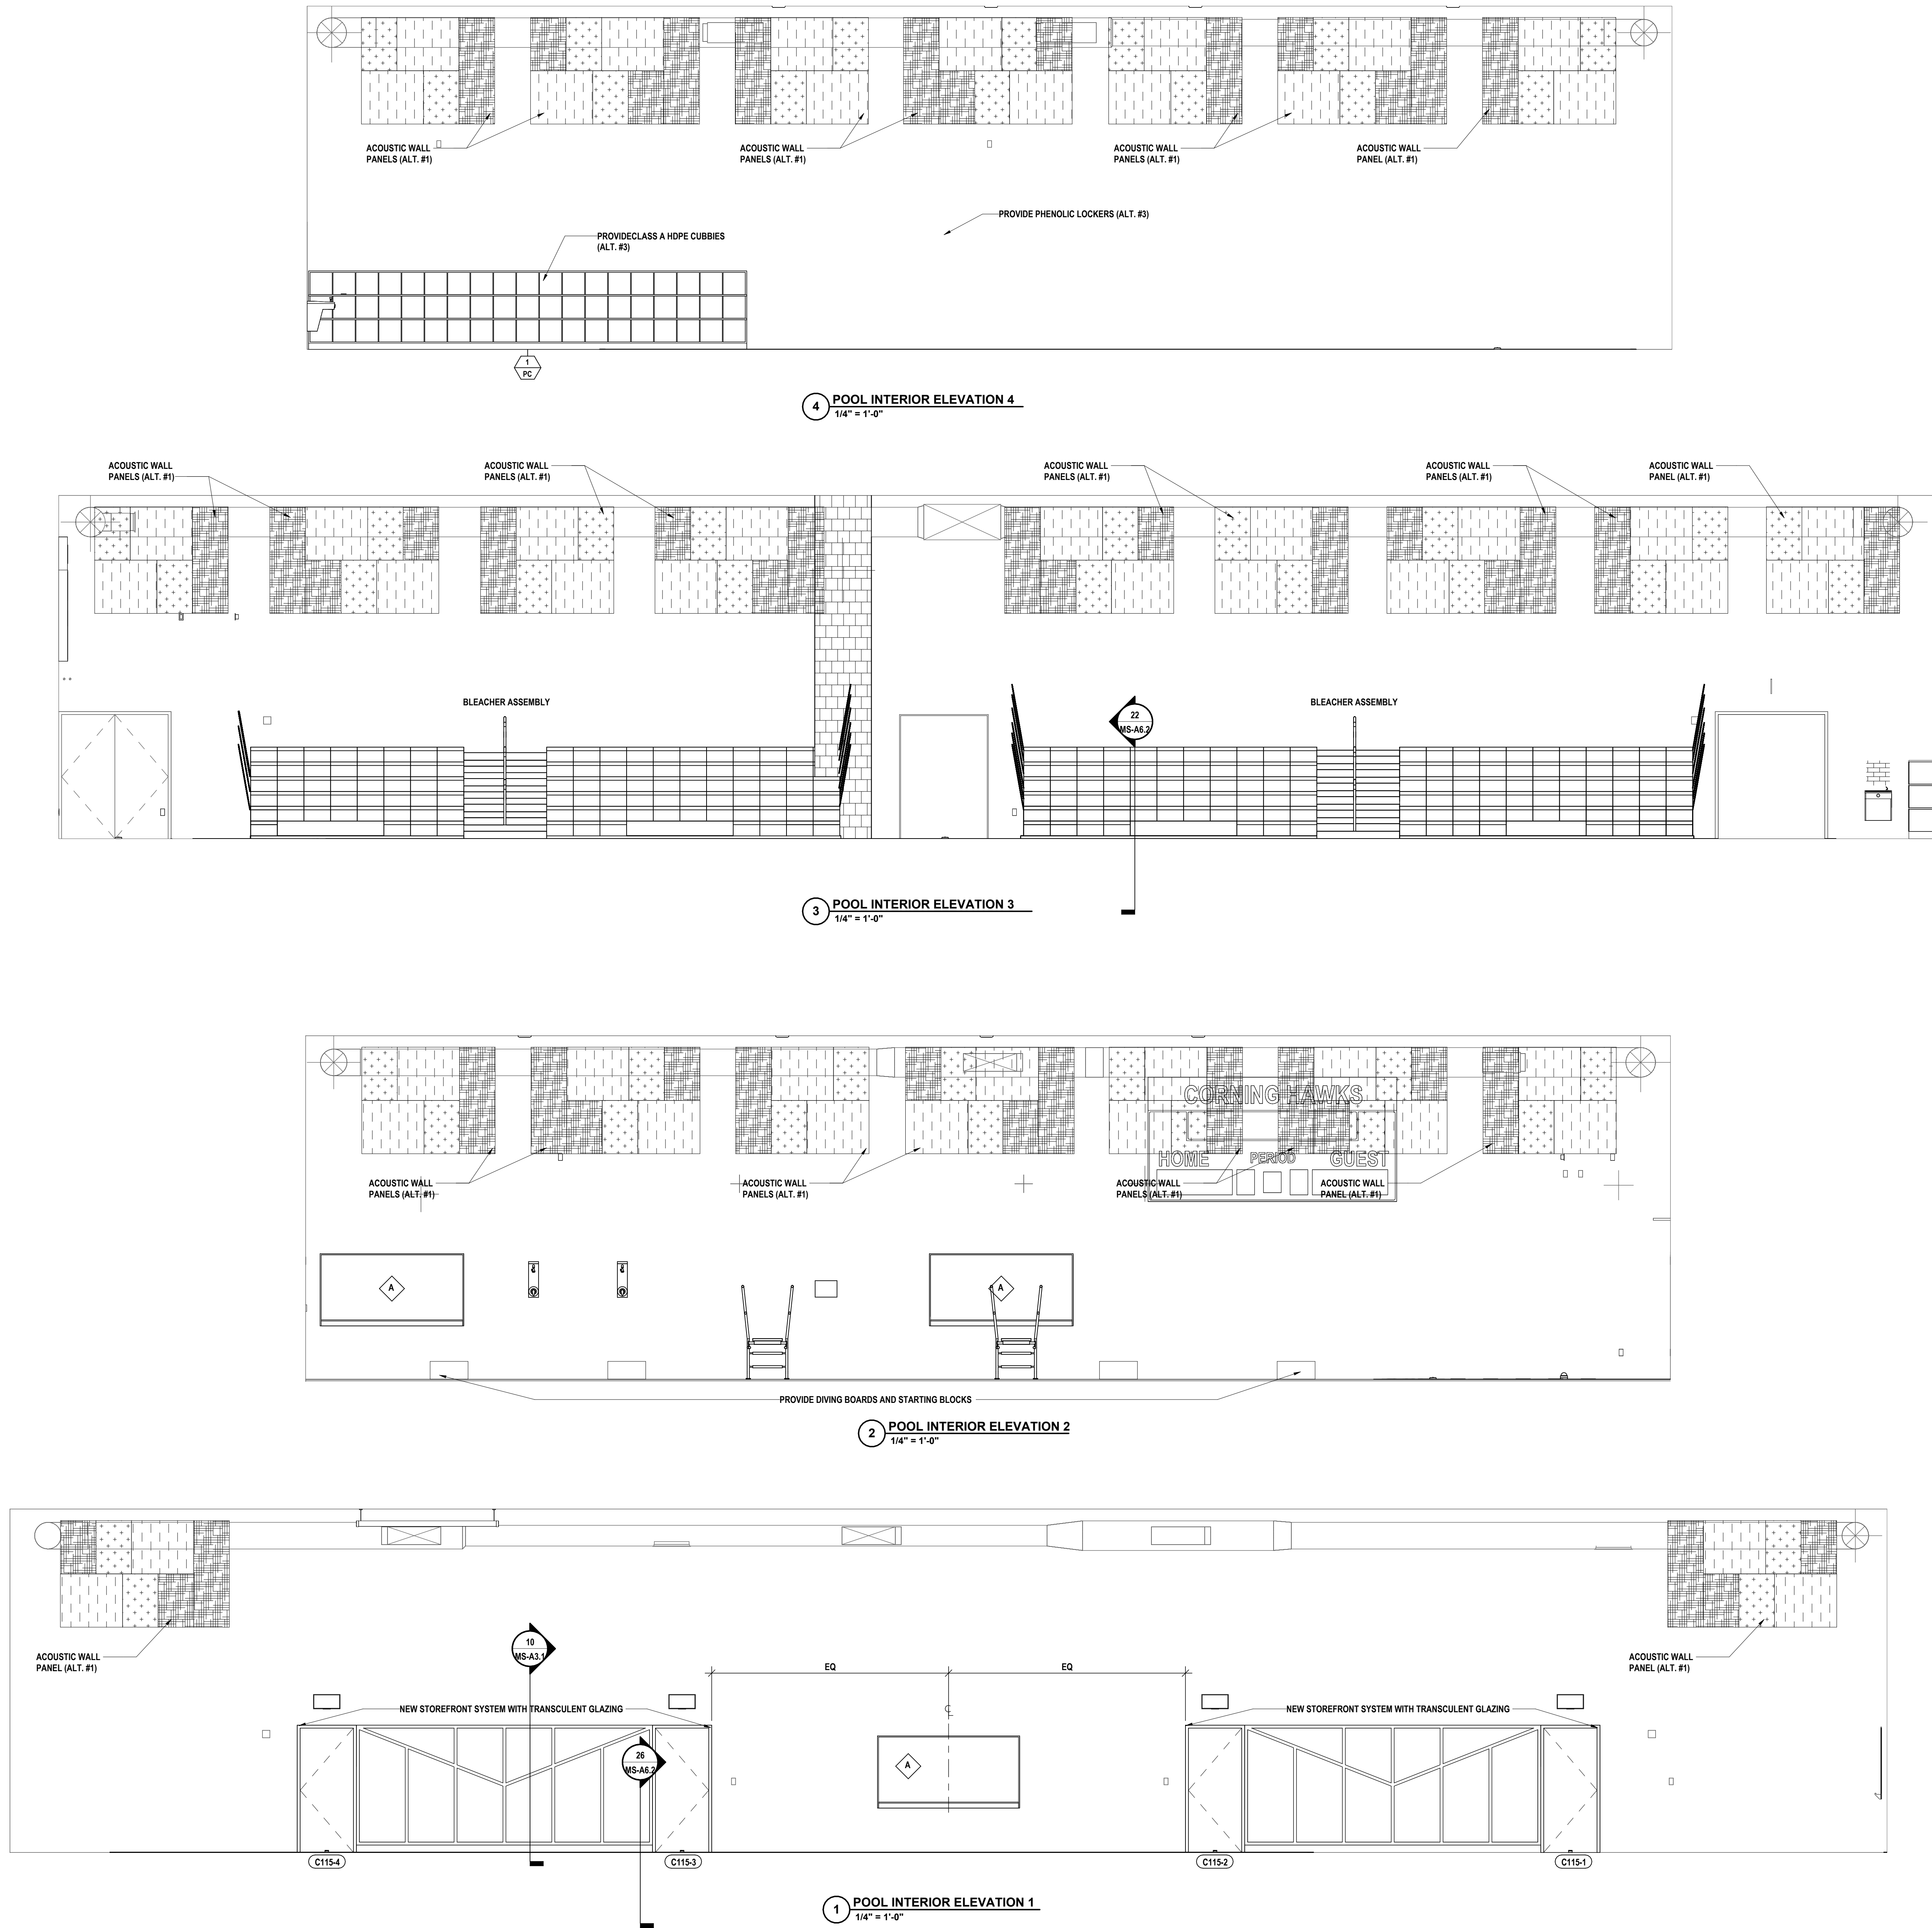

57-10-00-01-002-044 - MIDDLE SCHOOL

POOL INTERIOR ELEVATIONS & DETAILS

2025 MIDDLE SCHOOL PHASE III ALTERATIONS PROJECT

CORNING-PAINTED POST ASD

35 VICTORY HIGHWAY, PAINTED POST, NY 14870

MS-A5.3

PROJECT NO: 2649-153

**HUNT** ENGINEERS | ARCHITECTS | SURVEYORS

HORSEHEADS, NY 607-253-1000 ROCHESTER, NY 585-537-7549 TOWNANDRA, PA 570-265-4606  
BINGHAMTON, NY 607-798-8881 ALBANY, NY 607-798-8881

WWW.HUNTEAS.COM  
NY CERTIFICATE NO. 001620 PA CERTIFICATE NO. TSC220313464-1


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DESCRIPTION OF REVISION:  
ISSUED FOR BID


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DATE: 05/09/2025  
PHASE: CD

11 IS A VIOLATION OF THE LAW FOR ANY PERSON TO MAKE UNAUTHORIZED ALTERATIONS OR ADDITIONS TO PLANS  
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DATE: 05/09/2025  
PHASE: CD




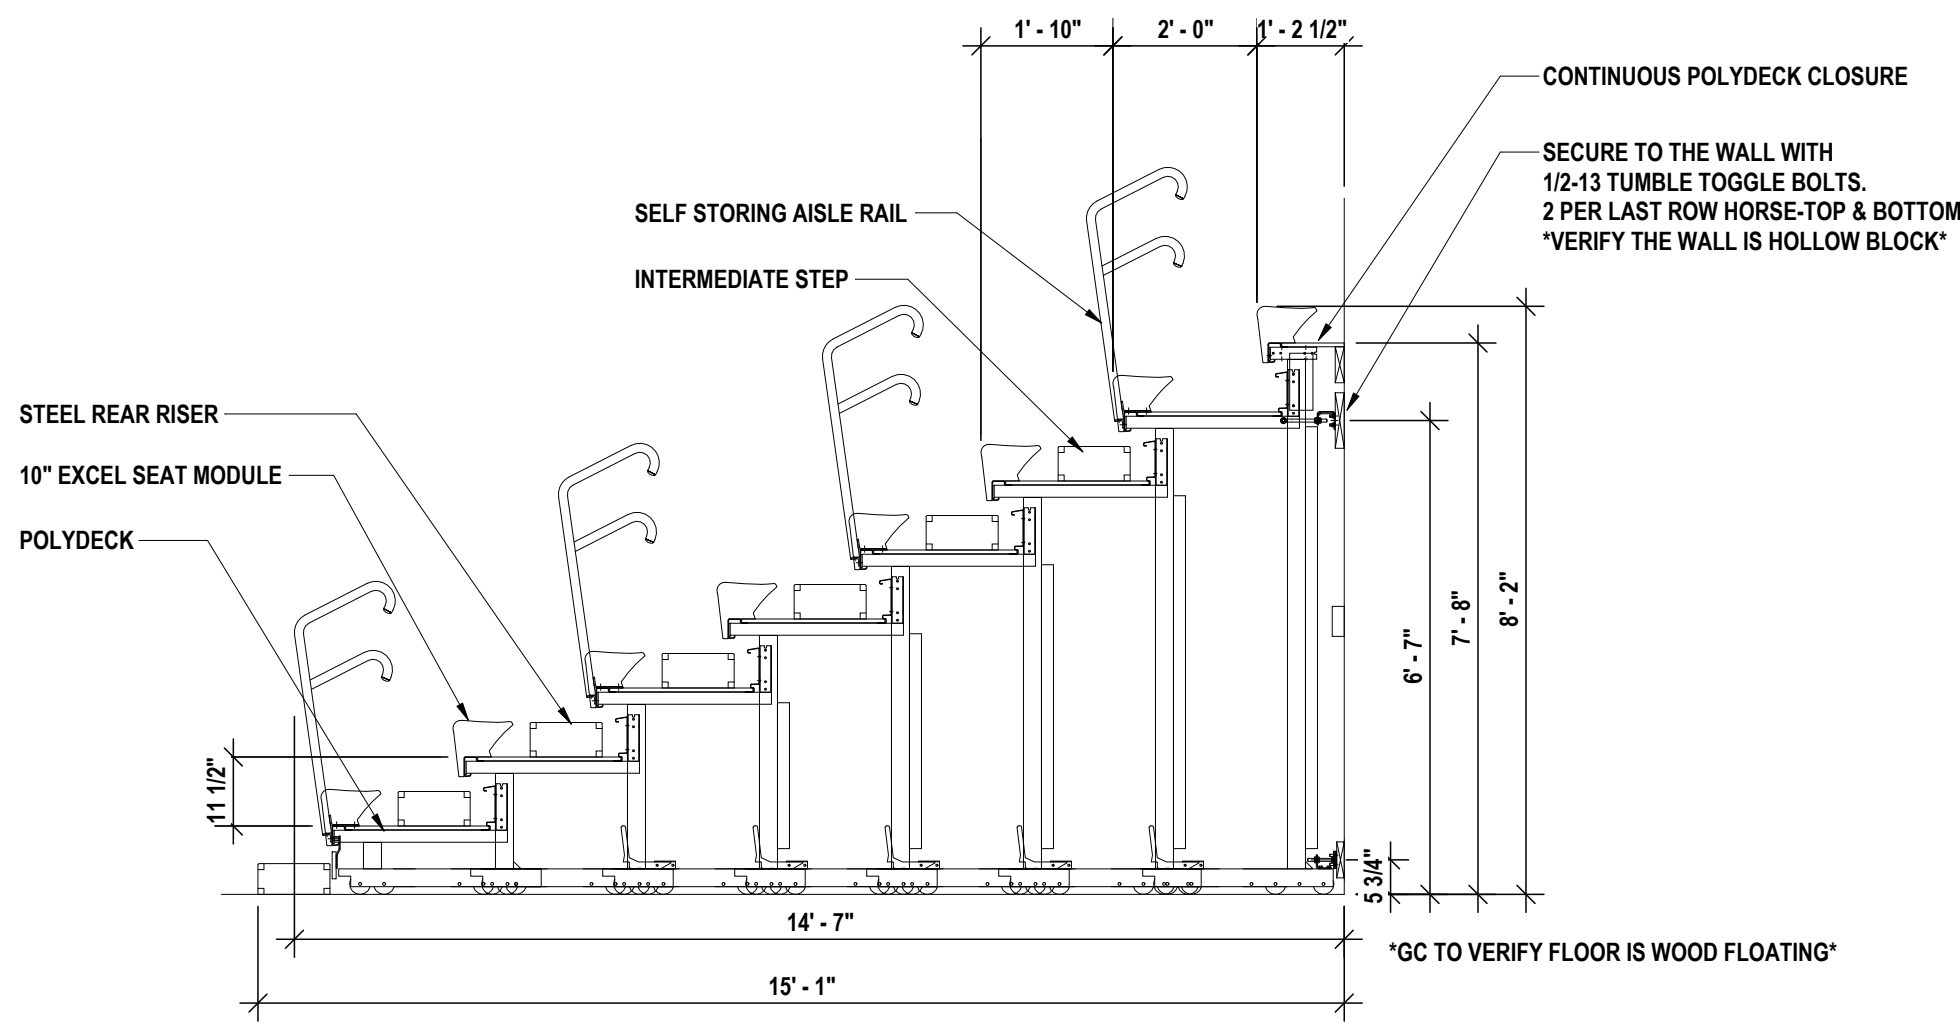


6 8 ROW BLEACHER BAY SECTION - EXTENDED  
3/8" = 1'-0"

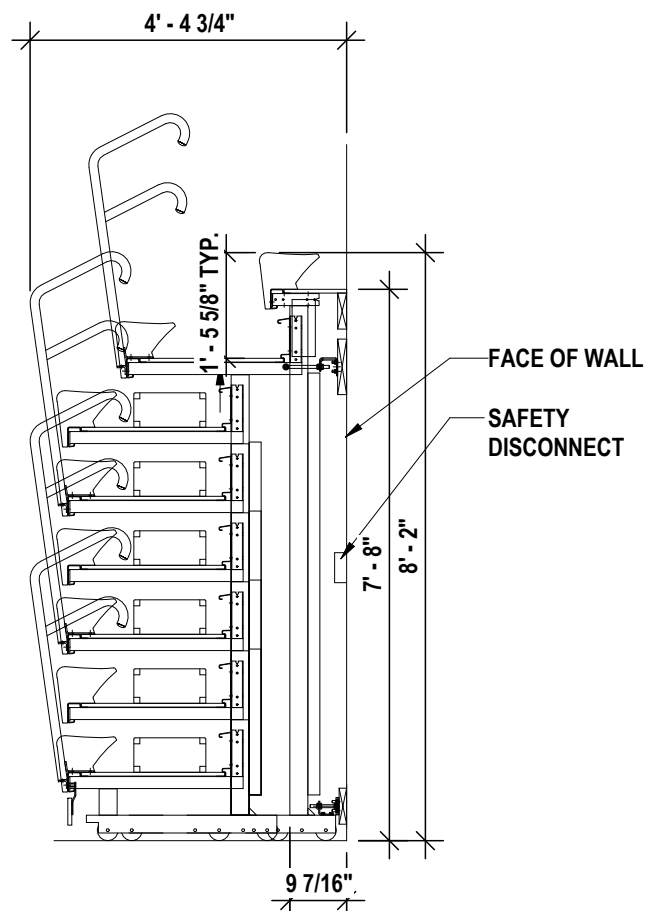


5 8 ROW BLEACHER BAY SECTION - RETRACTED  
3/8" = 1'-0"

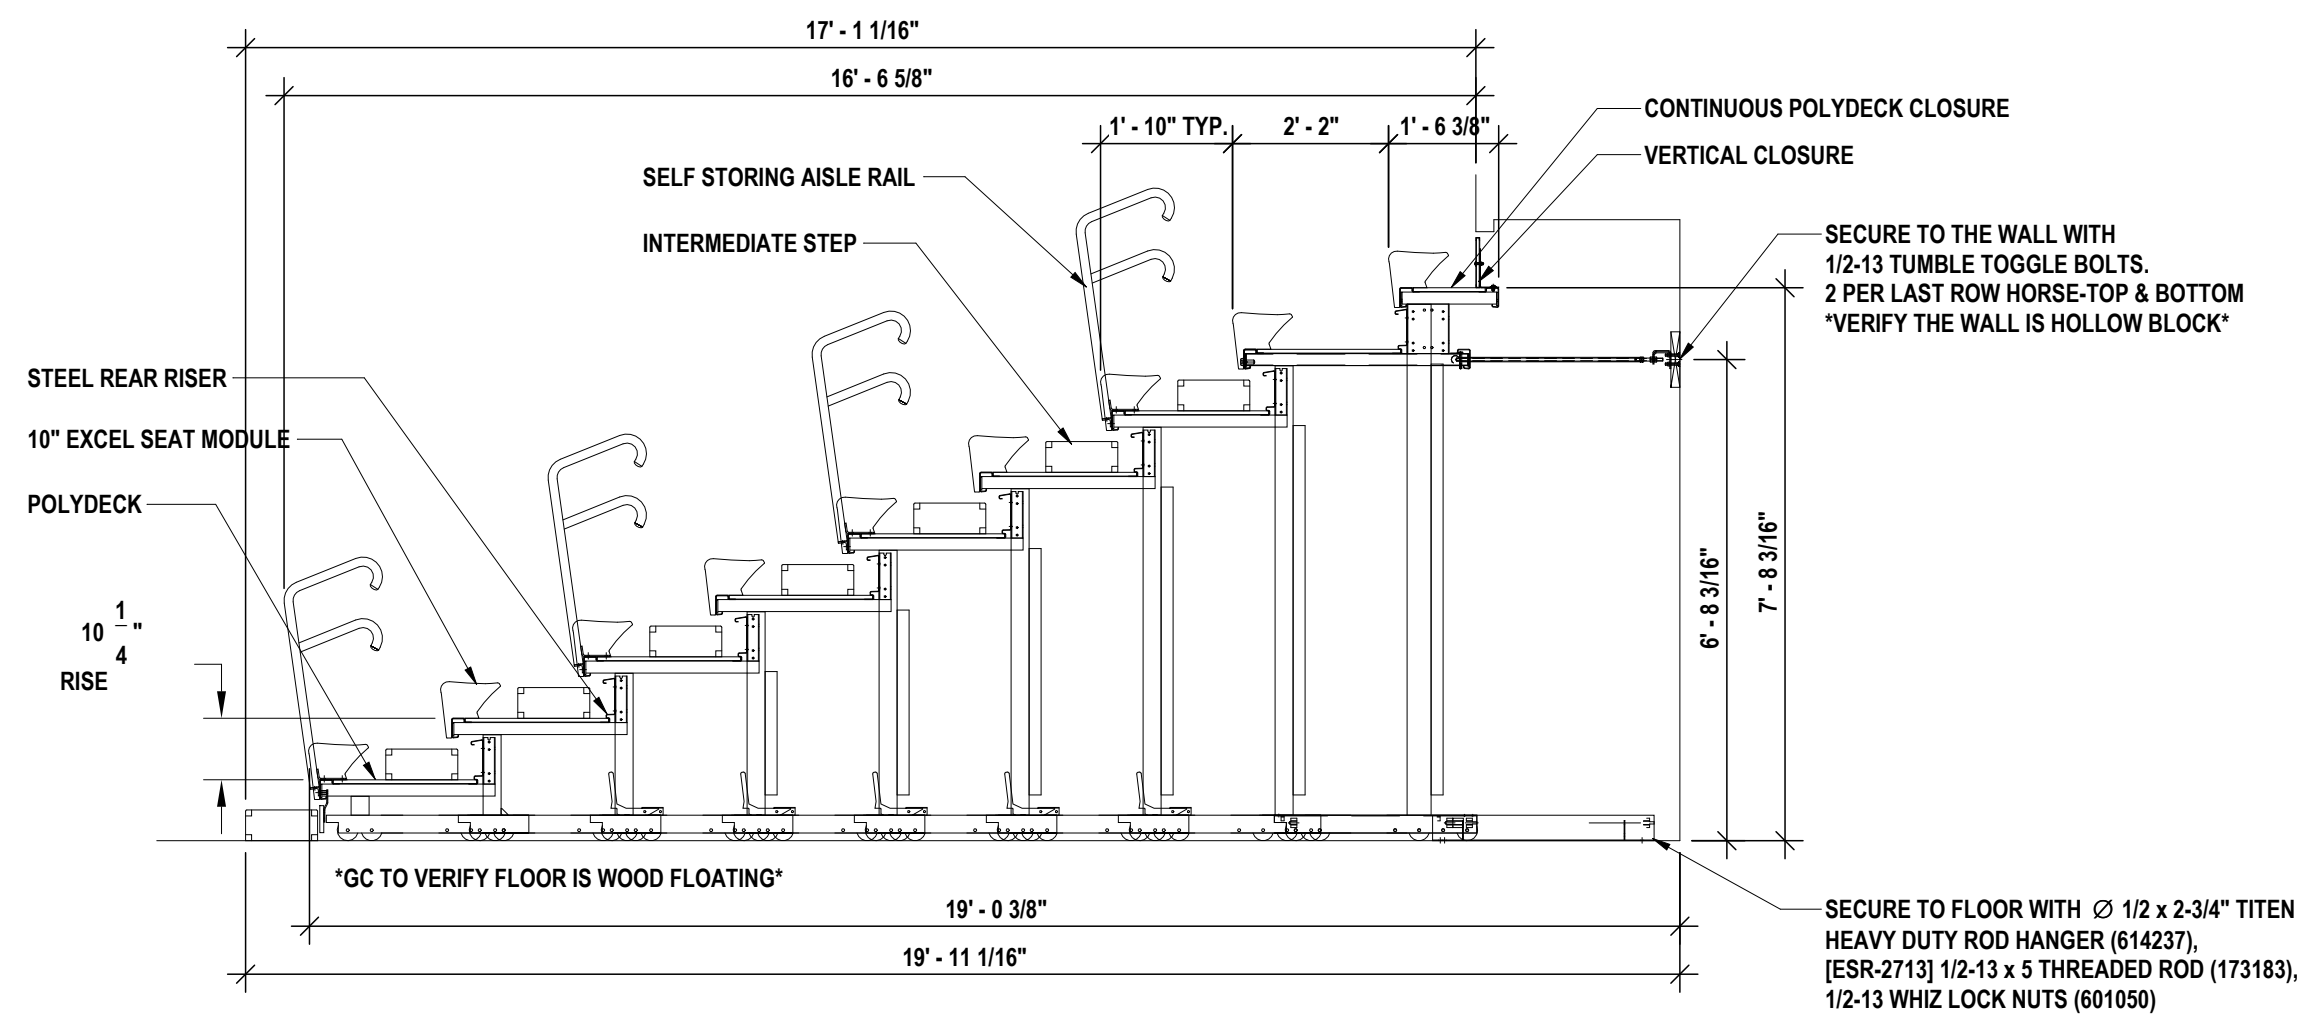


4 9 ROW BLEACHER BAY SECTION - EXTENDED  
3/8" = 1'-0"

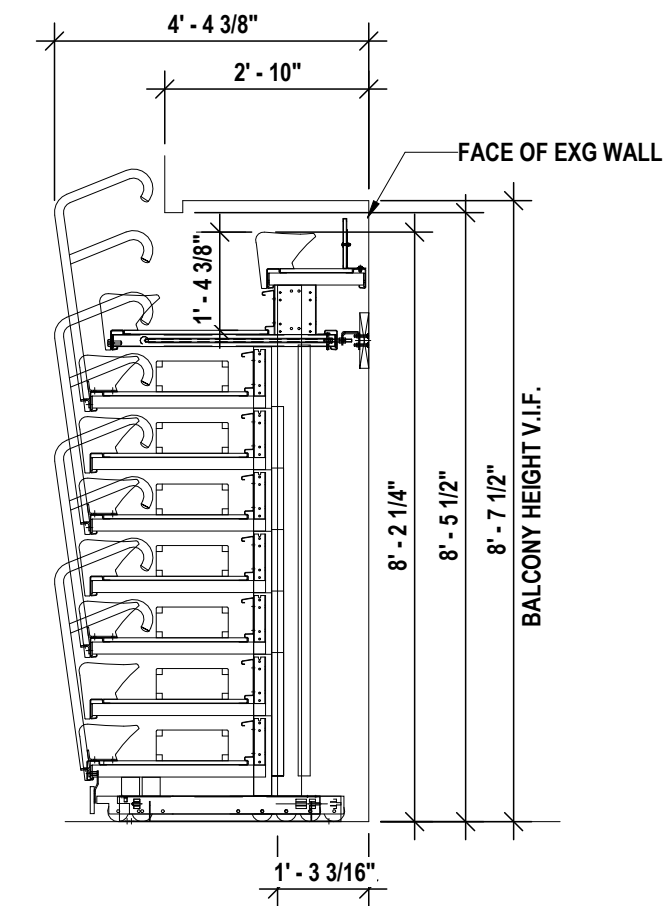


3 9 ROW BLEACHER BAY SECTION  
3/8" = 1'-0"

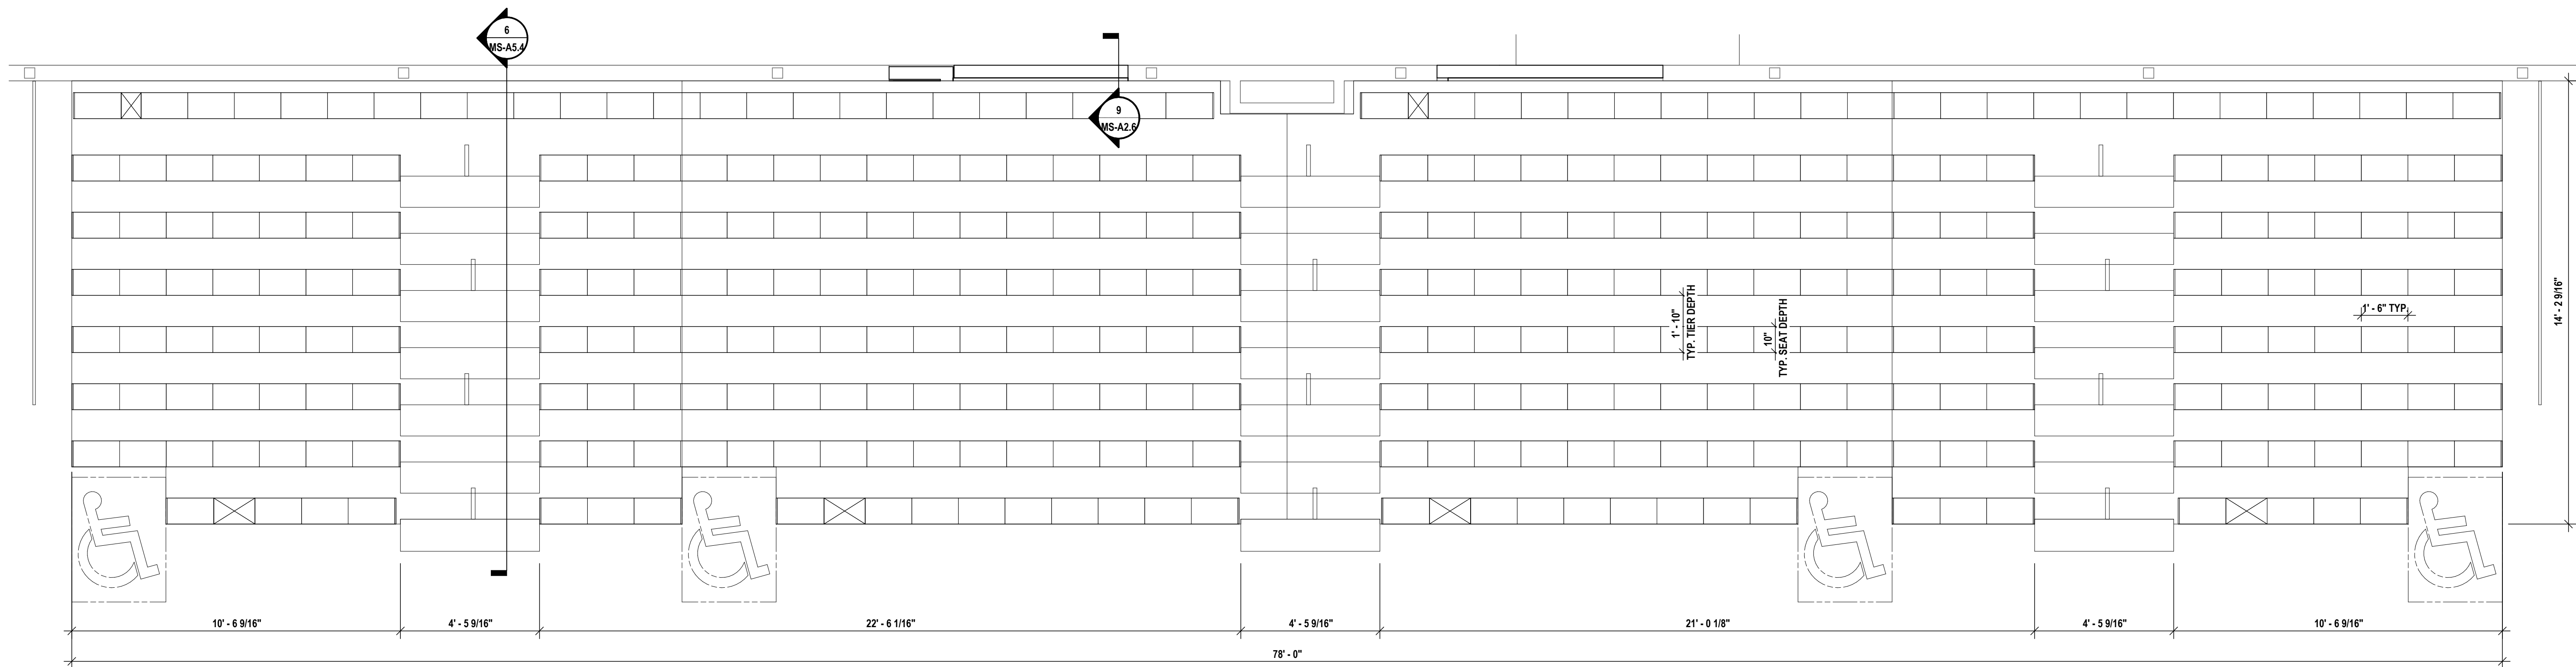

2 BY ALTERNATE #2 - GYM MEZZANINE - ENLARGED PLAN  
3/8" = 1'-0"

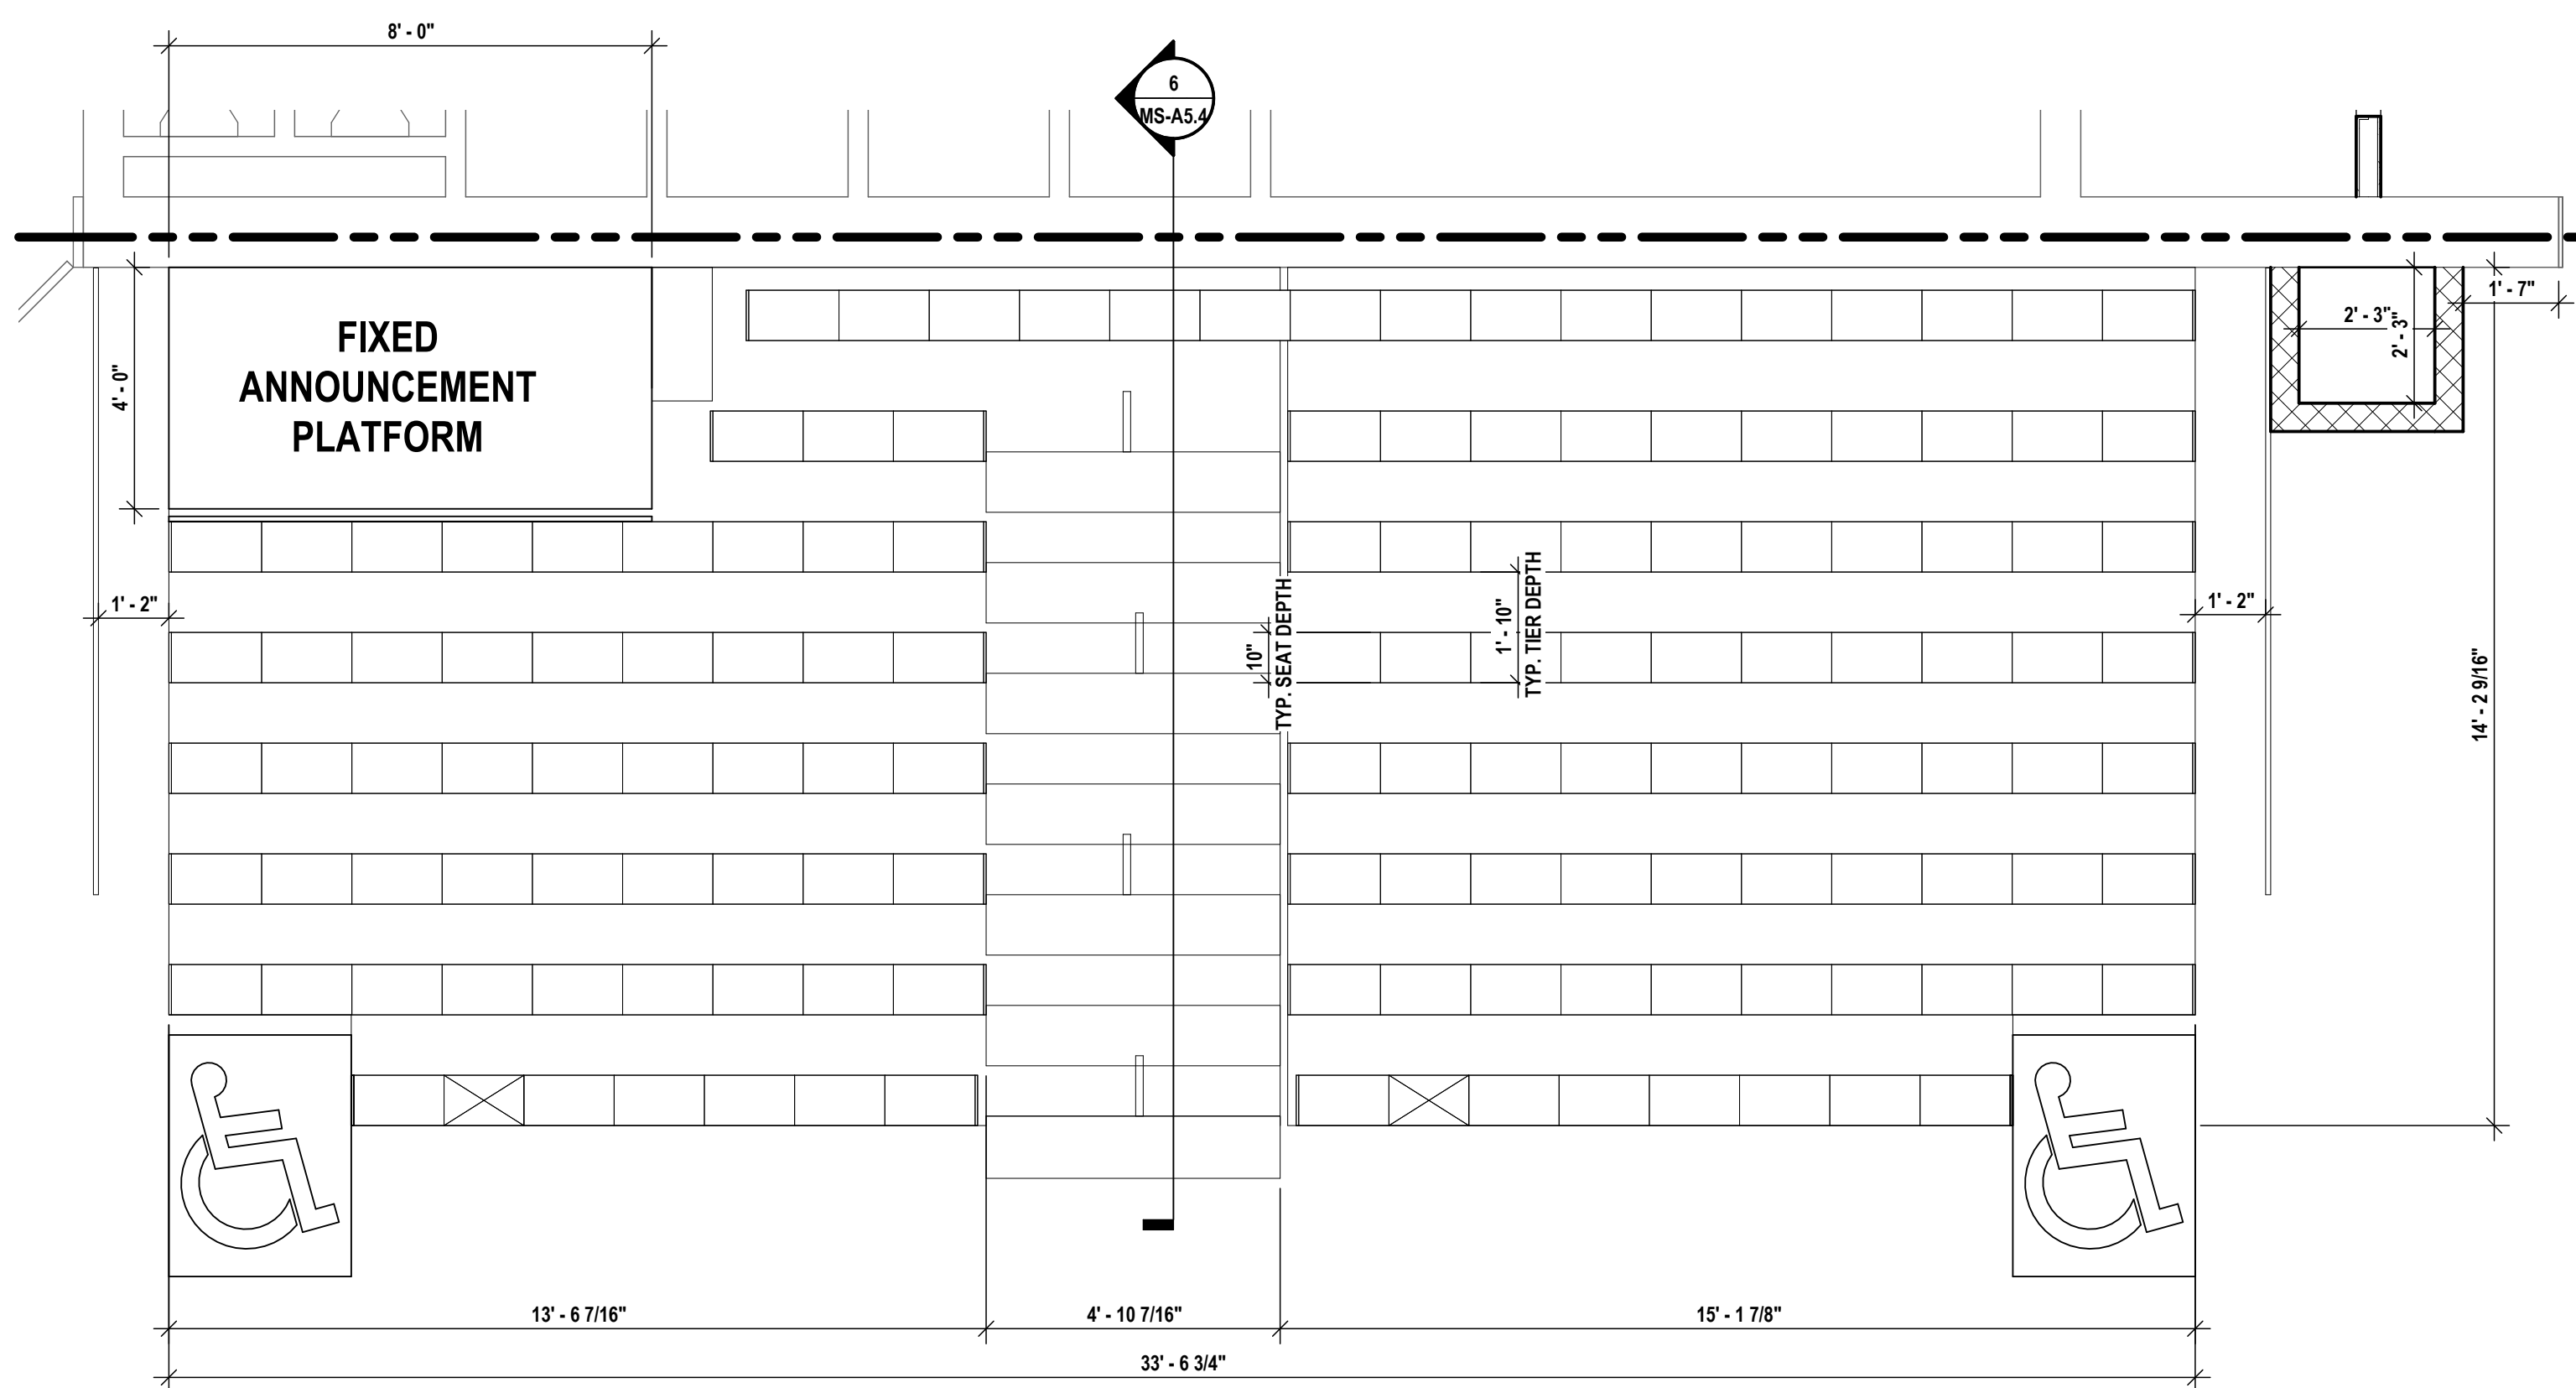

NOTE: PROVIDE 2 ADA SPACES PROVIDED PER ADA STANDARDS TABLE 221.2.1.1. BLEACHER BAY SEAT COUNT: 137


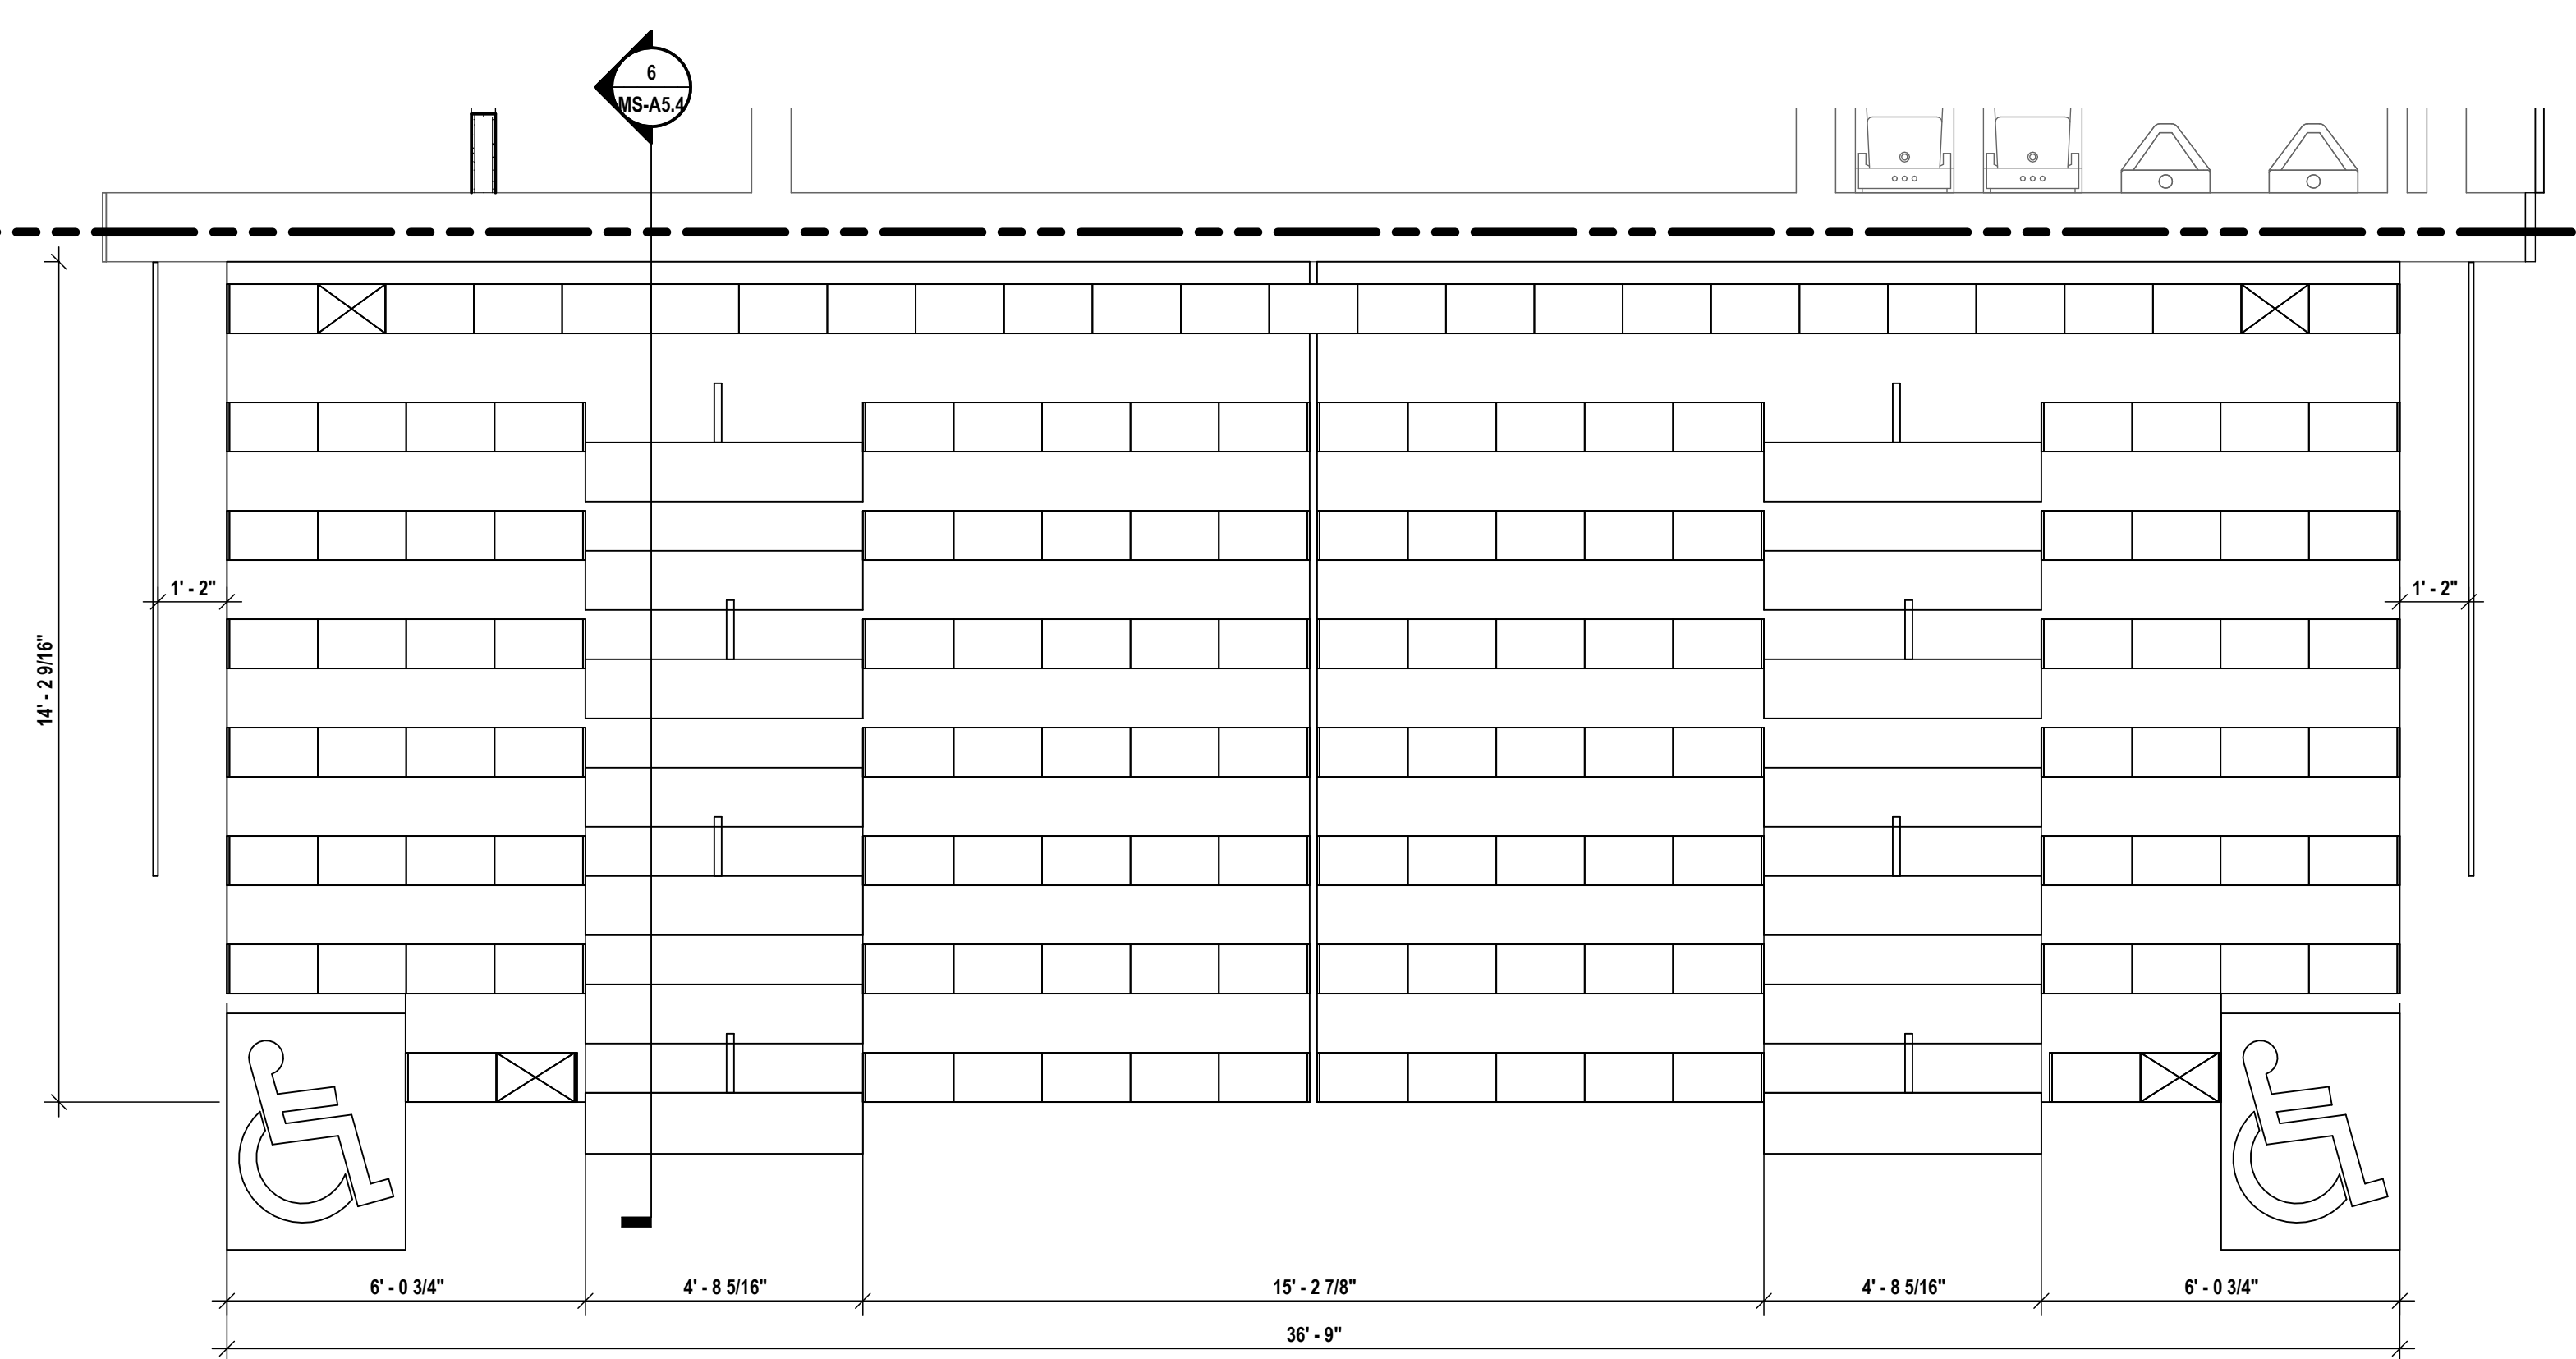


NOTE: PROVIDE 2 ADA SPACES PROVIDED PER ADA STANDARDS TABLE 221.2.1.1. BLEACHER BAY SEAT COUNT: 135

1 C115 POOL BLEACHERS - ENLARGED PLAN  
3/8" = 1'-0"

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1	11/03/2025
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57-10-00-01-002-044 - MIDDLE SCHOOL

BLEACHER ENLARGED PLANS

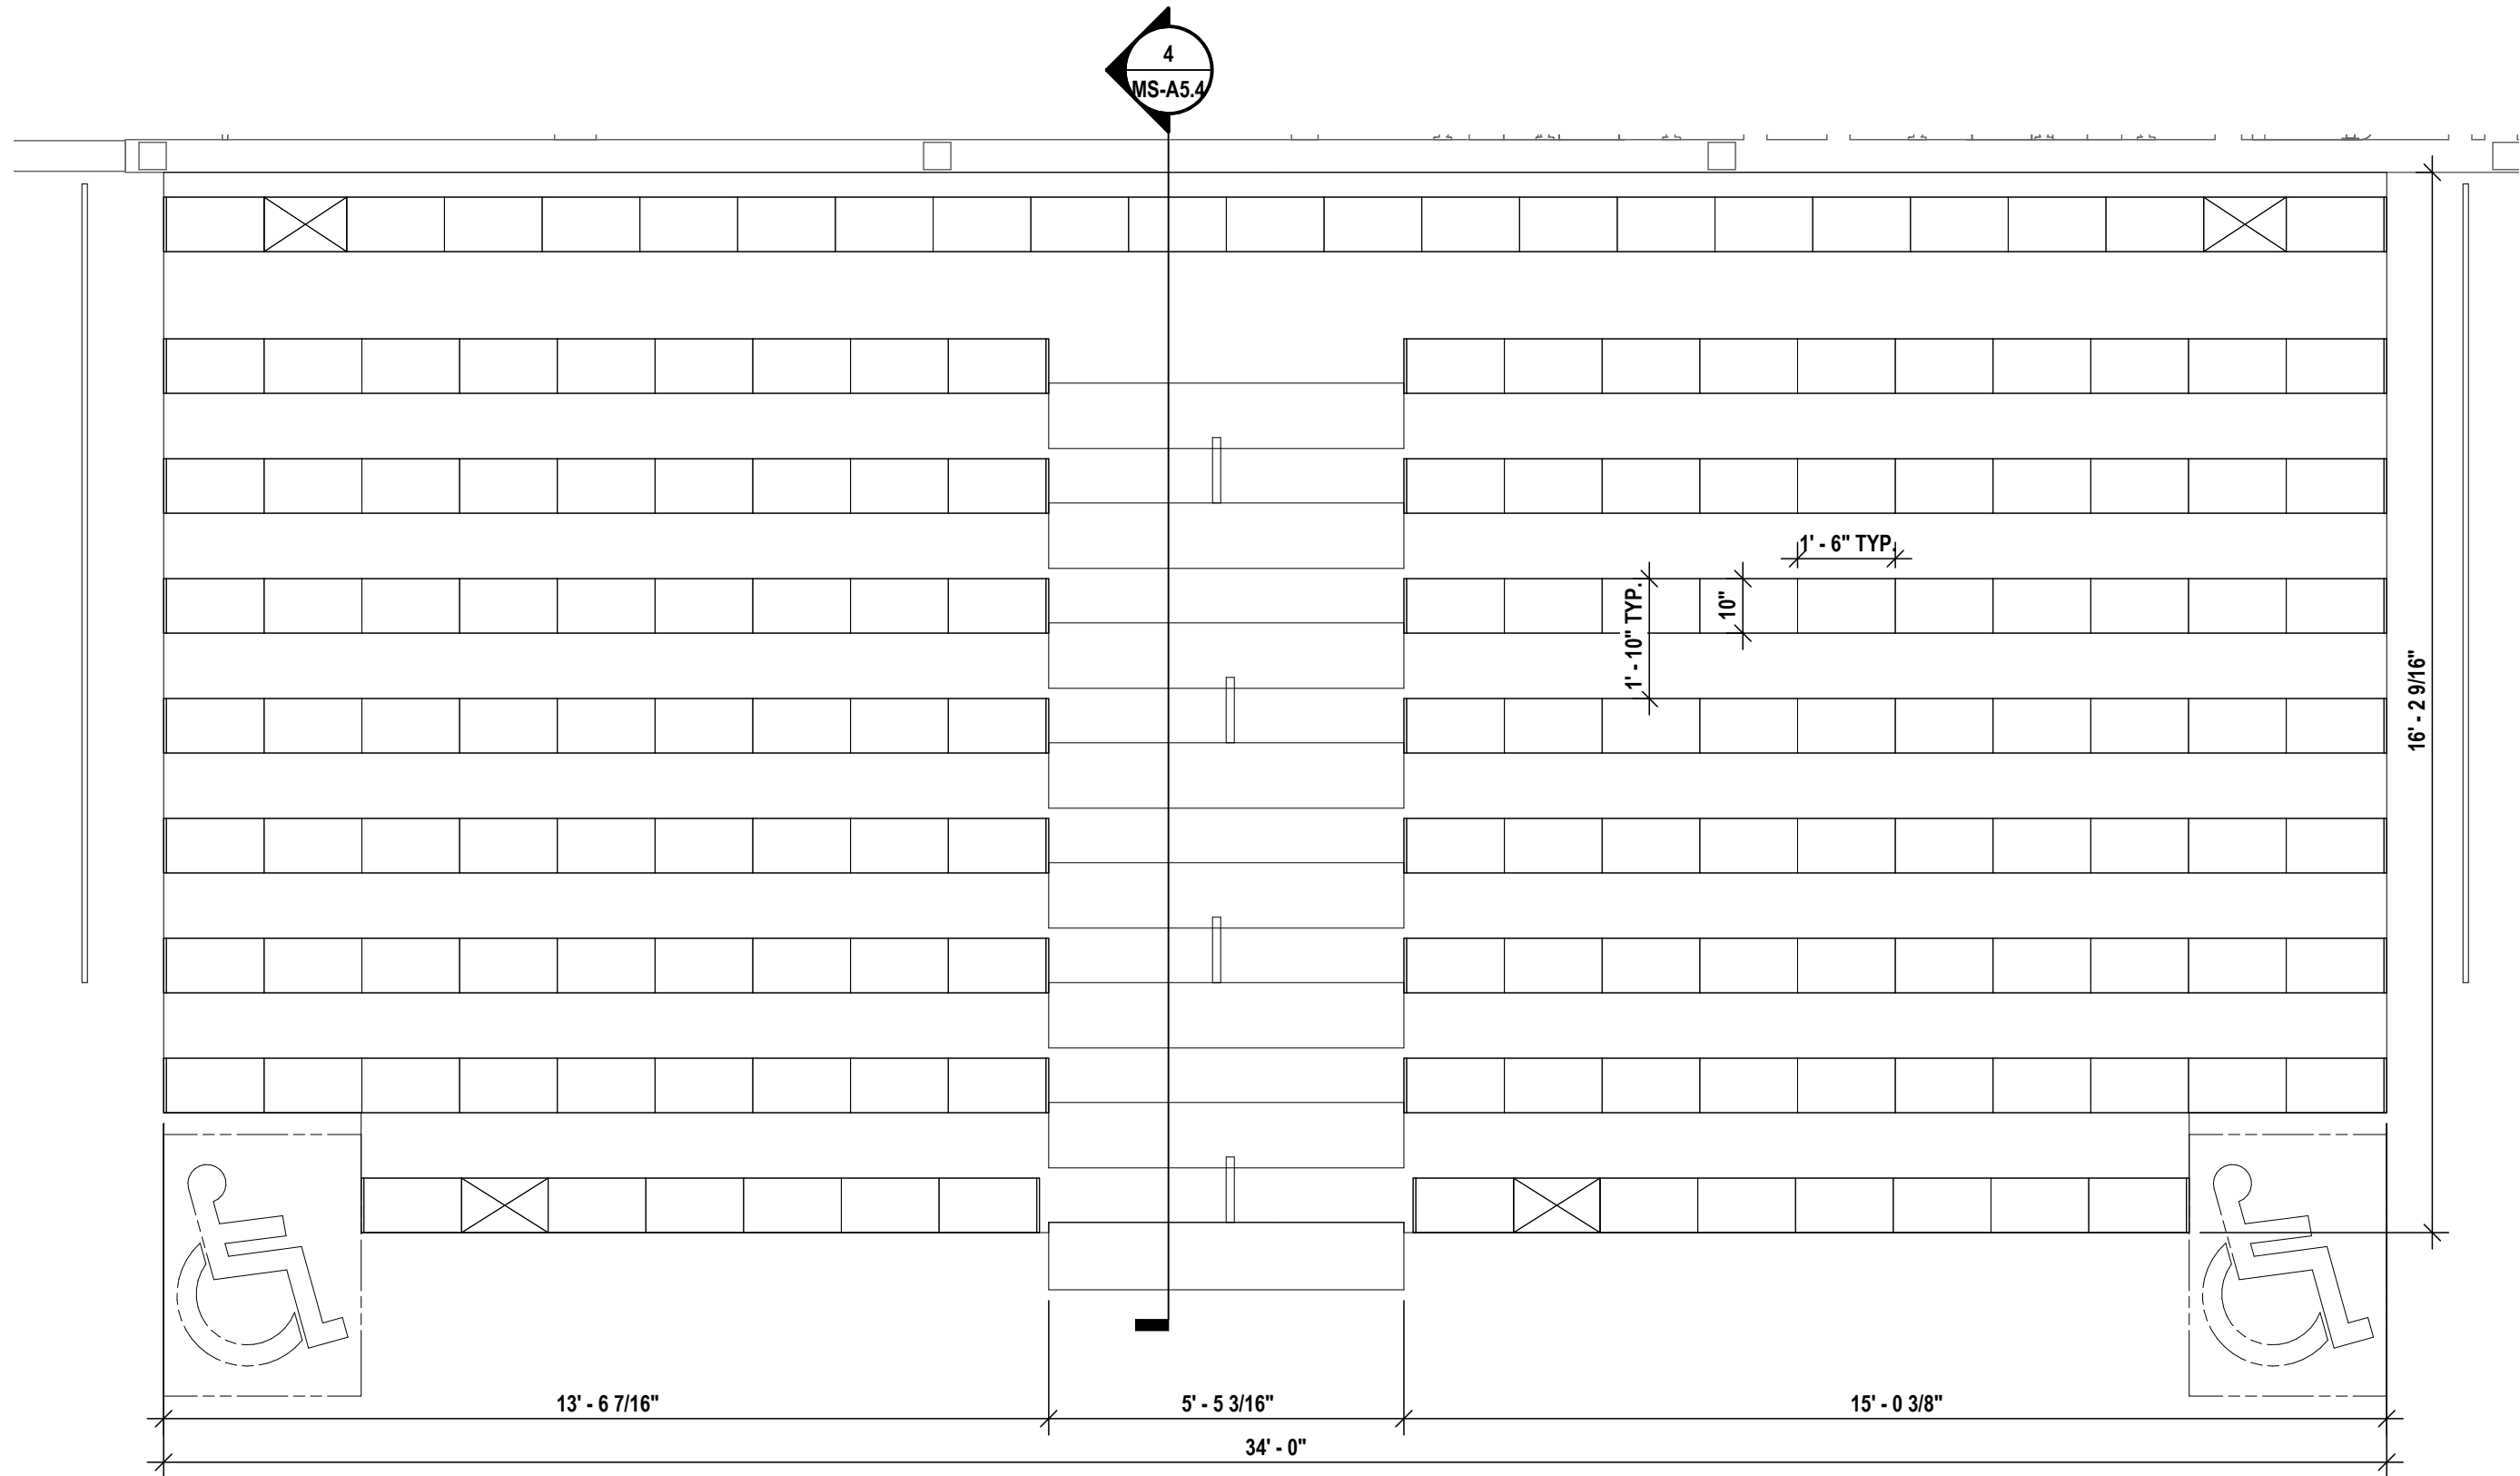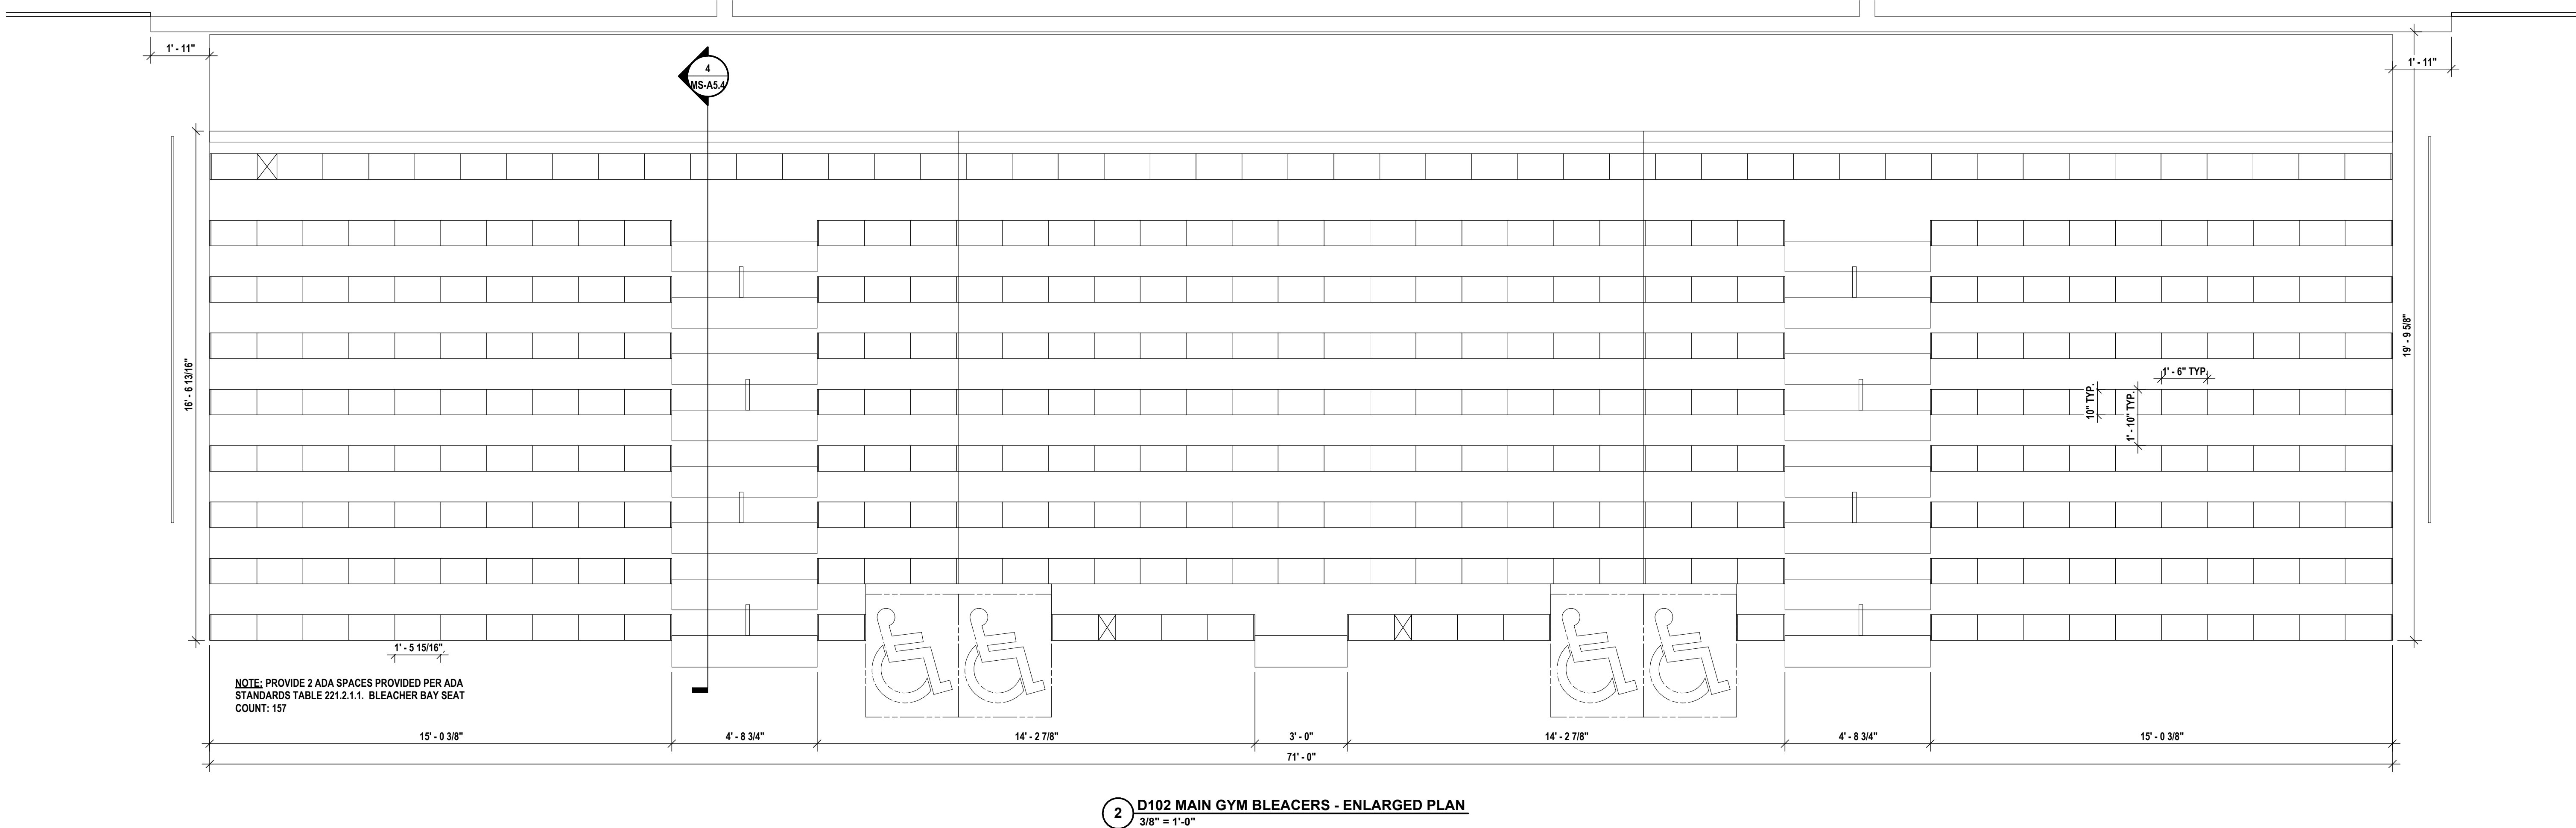2025 MIDDLE SCHOOL PHASE III ALTERATIONS PROJECT

CORNING-PAINTED POST ASD

35 VICTORY HIGHWAY, PAINTED POST, NY 14870

MS-A5.5  
PROJECT NO: 2649-133

**HUNT** ENGINEERS | ARCHITECTS | SURVEYORS  
HORSEHEADS, NY 607-263-1000 ROCHESTER, NY 585-537-7549 TOWNANDA, PA 570-265-4666  
BINGHAMTON, NY 607-798-8881 ALBANY, NY 607-798-8801  
WWW.HUNTEAS.COM  
NY CERTIFICATE NO. 001620 PA CERTIFICATE NO. TSC220313464-1

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1	10/03/2025	ISSUED FOR BID
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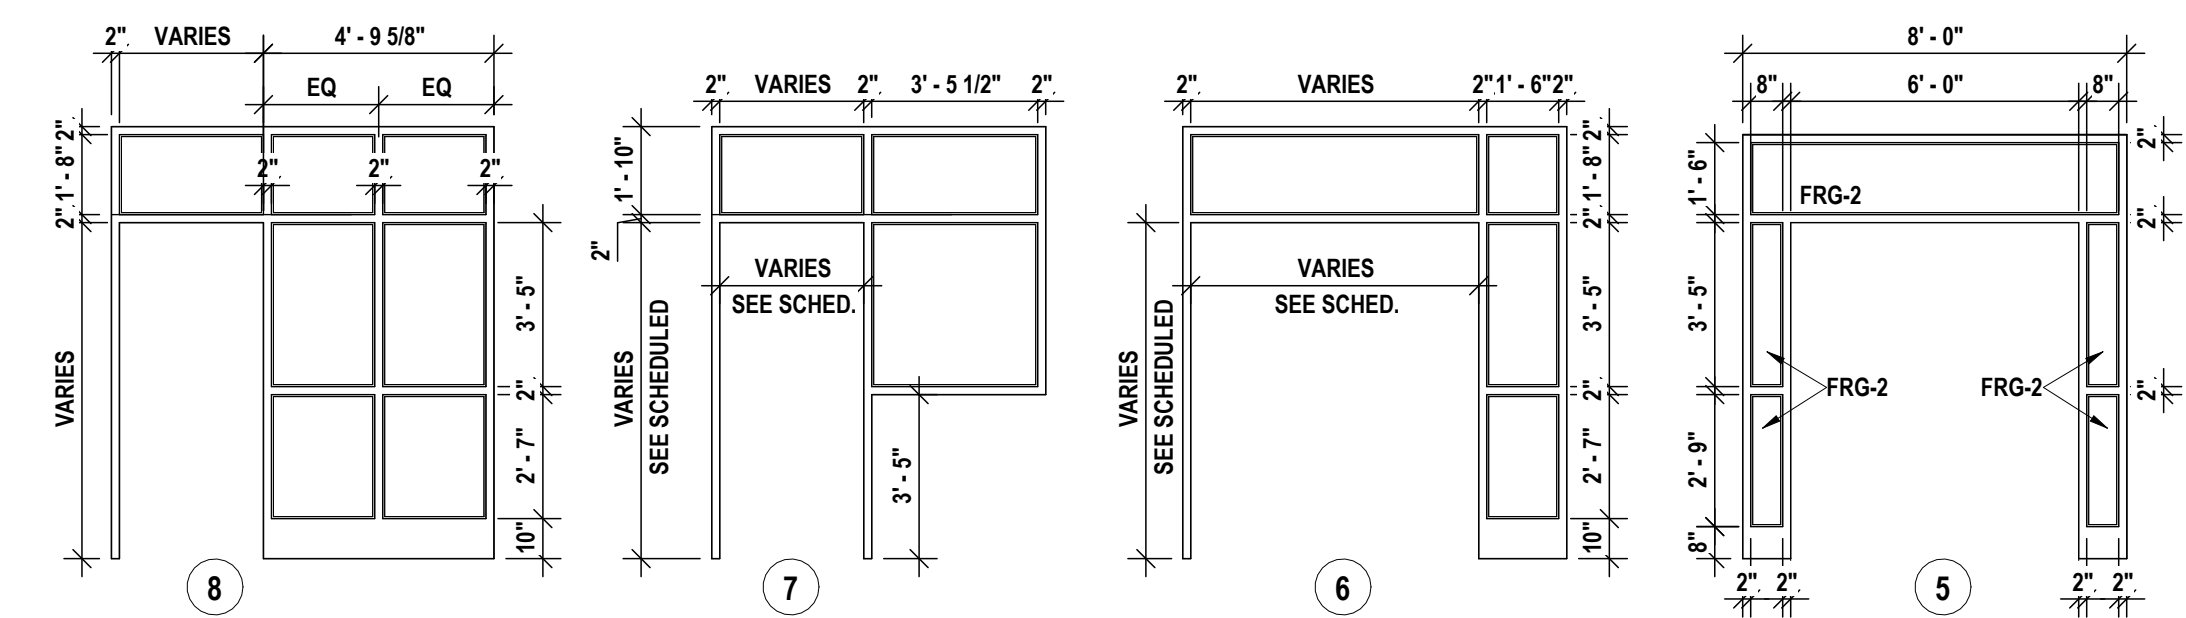
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CHECKED BY:	SZ
DATE:	05/09/2025
PHASE:	CD

05/09/2025




STOREFRONT SCHEDULE									
MARK	FRAME	FINISH	GLAZING	DETAIL			NOTES		
				HEAD	JAMB	SILL			
SF-1	AL	ANOD	IG-1, IG-2	13MS-A6.1	12MS-A6.1	11MS-A6.1			
SF-2	AL	ANOD	IG-1, IG-2	13MS-A6.1	12MS-A6.1	11MS-A6.1			


DOOR SCHEDULE																			
#	TYPE	LOCATION	WIDTH	HEIGHT	THICK	MATL.	FINISH	GLAZING	ASSEMBLY	HDWR SET	TYPE	FRAME	FINISH	HEAD	JAMB	SILL	NOTES		
C106-2	D	LIBRARY	6'-2"	7'-0"	1 3/4"	WD	STN-1	FRG-2	20	15.0	1	HM	PNT	3MS-A6.1	4MS-A6.1	6MS-A6.1	NEW DOOR & FRAME ASSEMBLY IN EXISTING OPENING. V.I.F. OPENING SIZE		
C110-1	C	CORRIDOR	6'-0"	7'-0"	1 3/4"	WD	STN-1	FRG-2	20	11.0	2	HM	PNT	1MS-A6.1	2MS-A6.1	6MS-A6.1	NEW DOOR IN EXG. MASONRY WALL OPENING		
C111A-1	A	BOYS ADA SHOWER	3'-0"	7'-0"	1 3/4"	FRP	FRP	--	--	7.0	1	FRP	FRP	3MS-A6.1	4MS-A6.1	6MS-A6.1	NEW DOOR IN NEW STUD WALL ASSEMBLY		
C111B-1	A	BOYS SHOWER	3'-0"	7'-0"	1 3/4"	FRP	FRP	--	--	3.0	1	FRP	FRP	3MS-A6.1	4MS-A6.1	6MS-A6.1	NEW DOOR IN NEW STUD WALL ASSEMBLY		
C112-1	C	CORRIDOR	3'-0"	7'-0"	1 3/4"	WD	STN-1	FRG-2	20	10.0	2	HM	PNT	1MS-A6.1	2MS-A6.1	6MS-A6.1	NEW DOOR IN EXISTING CMU OPENING		
C113A-1	A	GIRLS ADA SHOWER	3'-0"	7'-0"	1 3/4"	WD	STN	--	--	7.0	1	HM	PNT	3MS-A6.1	4MS-A6.1	6MS-A6.1	NEW DOOR IN NEW STUD WALL ASSEMBLY		
C113B-1	A	GIRLS SHOWER	3'-0"	7'-0"	1 3/4"	FRP	FRP	--	--	5.0	1	FRP	FRP	3MS-A6.1	4MS-A6.1	6MS-A6.1	NEW DOOR IN NEW STUD WALL ASSEMBLY		
C114-1	C	TV STUDIO	3'-0"	7'-0"	1 3/4"	WD	STN-1	FRG-2	20	9.0	2	HM	PNT	1MS-A6.1	2MS-A6.1	6MS-A6.1	NEW DOOR IN EXISTING CMU OPENING		
C114-2	B	CORRIDOR	7'-4"	7'-0"	1 3/4"	WD	STN-1	FRG-2	45	13.0	1	HM	PNT	3MS-A6.1	4MS-A6.1	6MS-A6.1	NEW DOOR IN EXG. STUD ASSEMBLY		
C115-1	A	POOL	3'-0"	7'-0"	1 3/4"	FRP	FRP	--	--	3.0	2	AL	ANOD	1MS-A6.1	2MS-A6.1	5MS-A6.1	NEW DOOR IN NEW STOREFRONT SYSTEM IN EXG. OPENING		
C115-2	A	POOL	3'-0"	7'-0"	1 3/4"	FRP	FRP	--	--	3.0	2	AL	ANOD	1MS-A6.1	2MS-A6.1	5MS-A6.1	NEW DOOR IN NEW STOREFRONT SYSTEM IN EXG. OPENING		
C115-3	A	POOL	3'-0"	7'-0"	1 3/4"	FRP	FRP	--	--	3.0	2	AL	ANOD	1MS-A6.1	2MS-A6.1	5MS-A6.1	NEW DOOR IN NEW STOREFRONT SYSTEM IN EXG. OPENING		
C115-4	A	POOL	3'-0"	7'-0"	1 3/4"	FRP	FRP	--	--	3.0	2	AL	ANOD	1MS-A6.1	2MS-A6.1	5MS-A6.1	NEW DOOR IN NEW STOREFRONT SYSTEM IN EXG. OPENING		
C115-5	A	POOL	6'-0"	7'-0"	1 3/4"	FRP	FRP	--	--	15	2	FRP	FRP	1MS-A6.1	2MS-A6.1	6MS-A6.1	NEW DOOR IN EXG. CMU WALL OPENING		
C115A-1	D	PASSAGE	3'-0"	7'-0"	1 3/4"	FRP	FRP	G-1	--	6.0	7	HM	PNT	3MS-A6.1	4MS-A6.1	6MS-A6.1	NEW DOOR IN STOREFRONT SYSTEM IN NEW STUD WALL ASSEMBLY. PROVIDE WINDOW SHADE AND PROVIDE SOLID SURFACE AT SIDELITE SILL.		
C123-1	A	CORRIDOR	6'-0"	7'-0"	1 3/4"	--	--	--	45	8.0	--	--	--	--	--	--	EXISTING DOOR & FRAME WITH NEW ADA COMPLIANT HARDWARE		
D102A-1	E	GYMNASIUM STORAGE	5'-0"	6'-6"	1 1/2"	STL	--	--	--	2.0	--	--	--	9MS-A6.1	8MS-A6.1	--	PROVIDE NEW OVERHEAD DOOR IN EXG. OPENING.		
D102A-2	E	GYMNASIUM STORAGE	5'-0"	6'-6"	1 1/2"	STL	--	--	--	2.0	--	--	--	9MS-A6.1	8MS-A6.1	--	PROVIDE NEW OVERHEAD DOOR IN EXG. OPENING.		
D111-1	A	GYMNASIUM OFFICE	6'-0"	7'-0"	1 3/4"	WD	STN-1	--	--	18.0	2	HM	PNT	1MS-A6.1	2MS-A6.1	6MS-A6.1	NEW DOOR IN EXG. CMU WALL OPENING		
D111-4	A	GYMNASIUM STORAGE	6'-0"	7'-0"	1 3/4"	WD	STN-1	--	--	19.0	2	HM	PNT	1MS-A6.1	2MS-A6.1	6MS-A6.1	NEW DOOR IN EXG. CMU WALL OPENING		
D111-5	C	AUXILIARY GYMNASIUM	6'-0"	7'-0"	1 3/4"	WD	STN-1	FRG-2	20	15.0	6	HM	PNT	1MS-A6.1	2MS-A6.1	6MS-A6.1	NEW DOOR IN EXG. CMU WALL OPENING		
D111-6	C	AUXILIARY GYMNASIUM	6'-0"	7'-0"	1 3/4"	WD	STN-1	FRG-2	20	15.0	5	HM	PNT	1MS-A6.1	2MS-A6.1	6MS-A6.1	NEW DOOR IN EXG. CMU WALL OPENING		
D126-1	A	STOR.	3'-0"	7'-0"	1 3/4"	WD	STN-1	--	20	17.0	2	HM	PNT	1MS-A6.1	2MS-A6.1	6MS-A6.1	NEW DOOR IN EXG. OPENING. V.I.F. WALL. CONSTRUCTION		
D126A-1	A	TOILET RM	3'-0"	7'-0"	1 3/4"	WD	STN-1	--	20	21.0	1	HM	PNT	3MS-A6.1	4MS-A6.1	6MS-A6.1	NEW DOOR IN NEW STUD WALL ASSEMBLY		
D126B-1	A	TOILET RM	3'-0"	7'-0"	1 3/4"	WD	STN-1	--	20	21.0	1	HM	PNT	3MS-A6.1	4MS-A6.1	6MS-A6.1	OWNER FURNISHED. GC INSTALLED DOOR AND HARDWARE IN NEW STUD WALL ASSEMBLY		
D126C-1	A	CUST.	2'-8"	7'-0"	1 3/4"	WD	STN-1	--	20	17.0	1	HM	PNT	3MS-A6.1	4MS-A6.1	6MS-A6.1	NEW DOOR IN NEW STUD WALL ASSEMBLY		
D126D-1	A	TOILET RM	3'-0"	7'-0"	1 3/4"	WD	STN-1	--	20	21.0	1	HM	PNT	3MS-A6.1	4MS-A6.1	6MS-A6.1	NEW DOOR IN NEW STUD WALL ASSEMBLY		
D126E-1	A	TOILET RM	3'-0"	7'-0"	1 3/4"	WD	STN-1	--	20	21.0	1	HM	PNT	3MS-A6.1	4MS-A6.1	6MS-A6.1	NEW DOOR IN NEW STUD WALL ASSEMBLY		
D126F-1	A	TOILET RM	3'-0"	7'-0"	1 3/4"	WD	STN-1	--	20	21.0	1	HM	PNT	3MS-A6.1	4MS-A6.1	6MS-A6.1	OWNER FURNISHED. GC INSTALLED DOOR AND HARDWARE IN NEW STUD WALL ASSEMBLY		
D126G-1	A	TOILET RM	3'-0"	7'-0"	1 3/4"	WD	STN-1	--	20	21.0	1	HM	PNT	3MS-A6.1	4MS-A6.1	6MS-A6.1	NEW DOOR IN NEW STUD WALL ASSEMBLY		
DX103-1	C	CORRIDOR	7'-4"	7'-2"	1 3/4"	WD	STN-1	FRG-2	45	13.0	3	HM	PNT	1MS-A6.1	2MS-A6.1	6MS-A6.1	NEW DOOR WITH TRANSOM IN EXISTING WALL OPENING. V.I.F. CONSTRUCTION; SEE 7MS-A6.1. ADJUST HOLD OPENS AS REQUIRED.		
DX103-2	B	CORRIDOR	6'-0"	7'-0"	1 3/4"	AL	ANOD.	IG	--	4.0	4	AL	ANOD	1MS-A6.1	2MS-A6.1	6MS-A6.1	NEW DOOR IN EXG. OPENING. V.I.F. WALL. CONSTRUCTION. PROVIDE ACCESS CONTROL.		
DX103-3	A	AUXILIARY GYMNASIUM	6'-0"	7'-0"	1 3/4"	WD	STN-1	--	20	16.0	2	HM	PNT	1MS-A6.1	2MS-A6.1	6MS-A6.1	NEW DOOR IN EXG. CMU WALL OPENING WITH METAL THRESHOLD		
DX103-4	B	CORRIDOR	6'-0"	7'-0"	1 3/4"	AL	ANOD.	IG	--	4.0	4	AL	ANOD	1MS-A6.1	2MS-A6.1	6MS-A6.1	NEW DOOR IN EXG. OPENING. V.I.F. WALL. CONSTRUCTION. PROVIDE ACCESS CONTROL. MULLION TO BE REMOVABLE WITH ELECTRIC STRIKE. PROVIDE ACCESS CONTROL.		
E113-1	C	INSTRUMENTAL MUSIC ROOM	5'-8"	7'-0"	1 3/4"	WD	STN-1	FRG-2	20	12.0	1	HM	PNT	1MS-A6.1	2MS-A6.1	6MS-A6.1	NEW DOOR IN EXG. OPENING. V.I.F. WALL. CONSTRUCTION		
S105-1	C	STAIR	3'-0"	7'-0"	1 3/4"	WD	STN-1	FRG-2	45	14.0	8	HM	PNT	1MS-A6.1	2MS-A6.1	6MS-A6.1	NEW DOOR IN EXG. CMU WALL OPENING		




FRAME TYPES KEY  
1/4" = 1'-0"

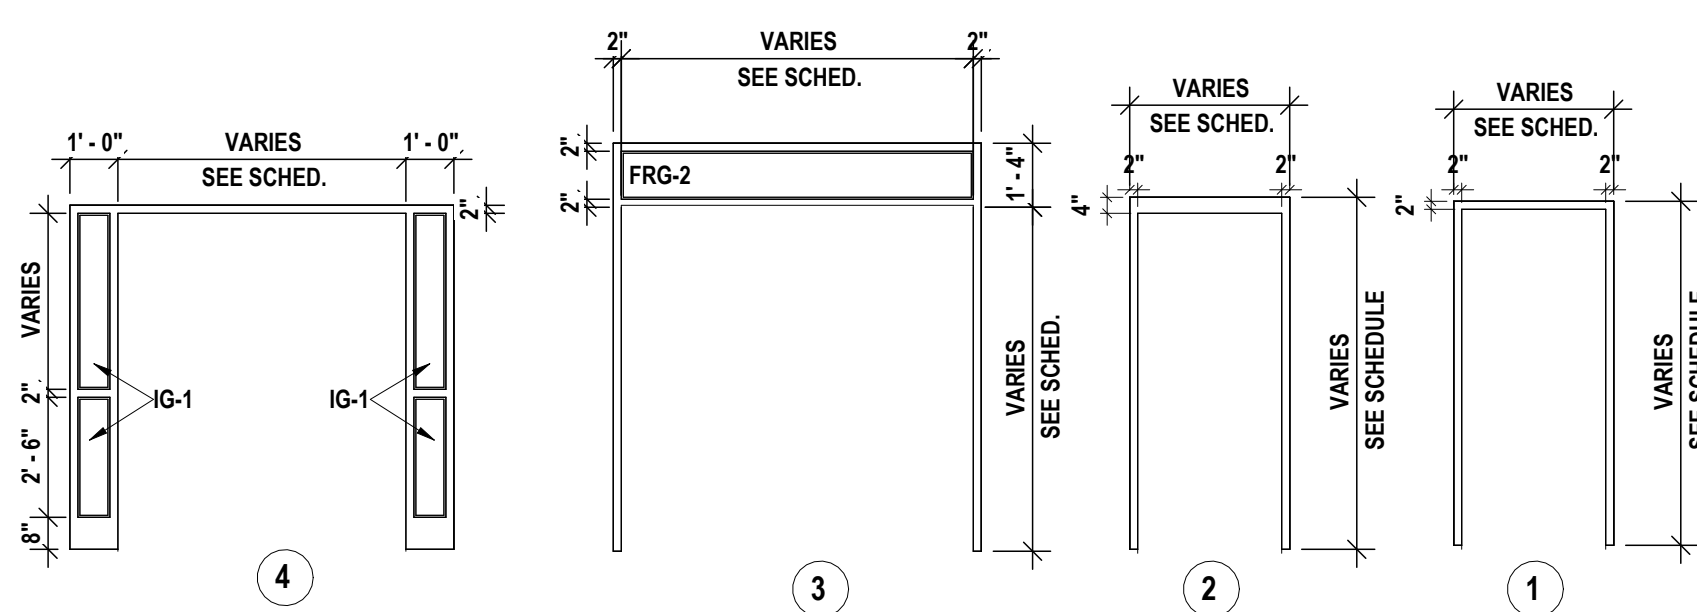


DOOR TYPES KEY  
1/4" = 1'-0"

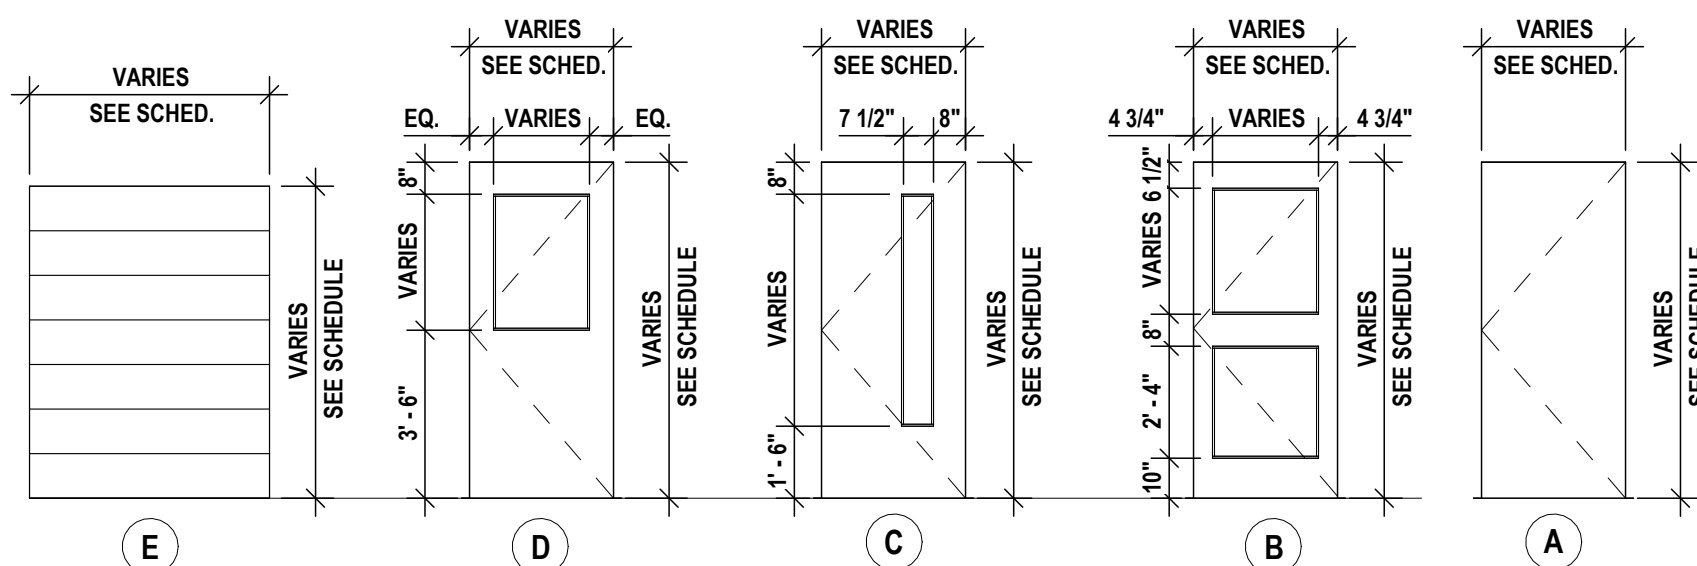


9 EXG. MASONRY WALL HEAD DETAIL 'D'  
1 1/2" = 1'-0"

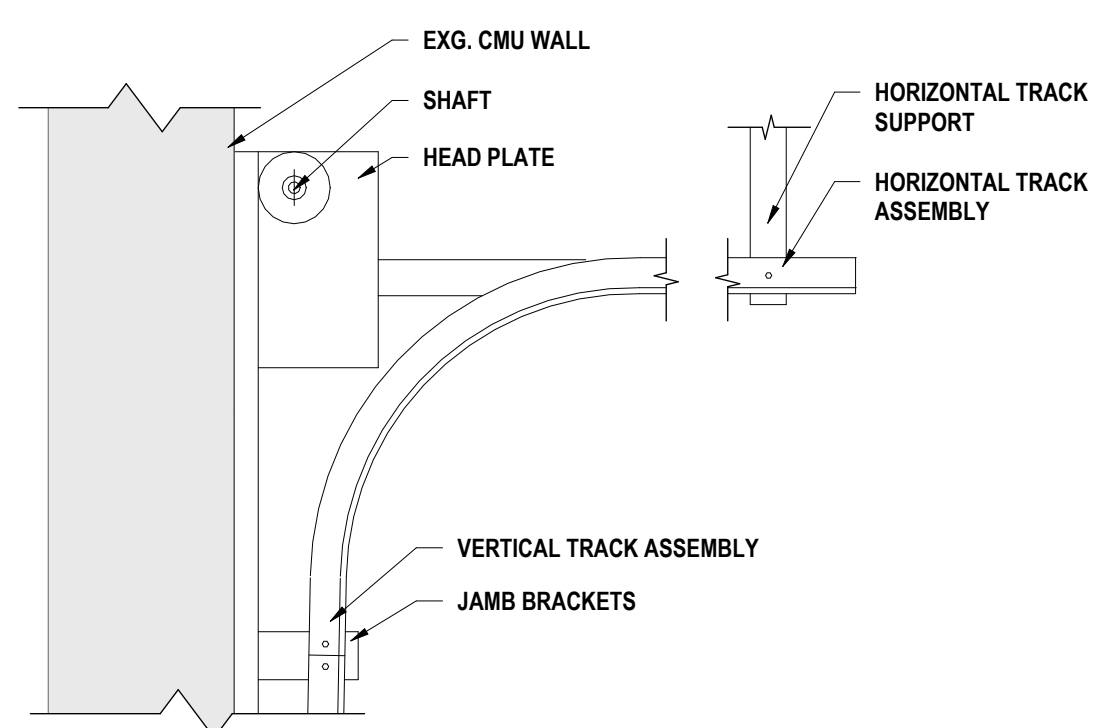


8 EXG. MASONRY WALL JAMB DETAIL 'D'  
1 1/2" = 1'-0"

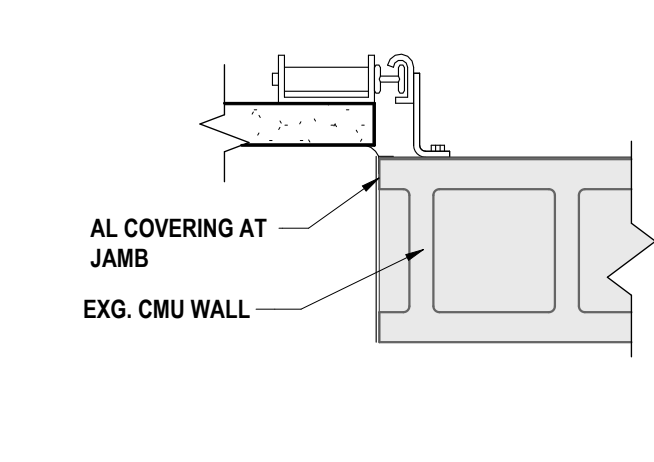


7 TRANSOM HEAD DETAIL 'C'  
3" = 1'-0"

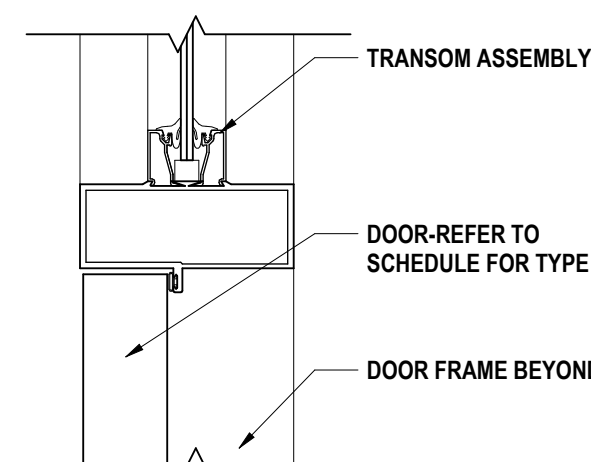


6 THRESHOLD DETAIL 'A'  
3" = 1'-0"

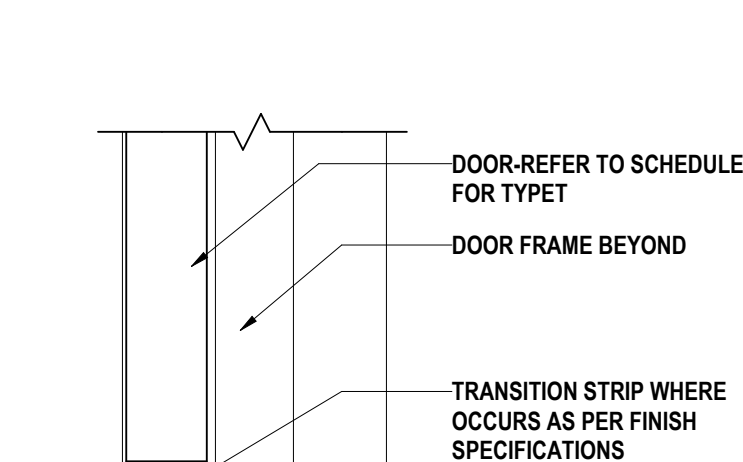


5 THRESHOLD DETAIL 'B'  
3" = 1'-0"

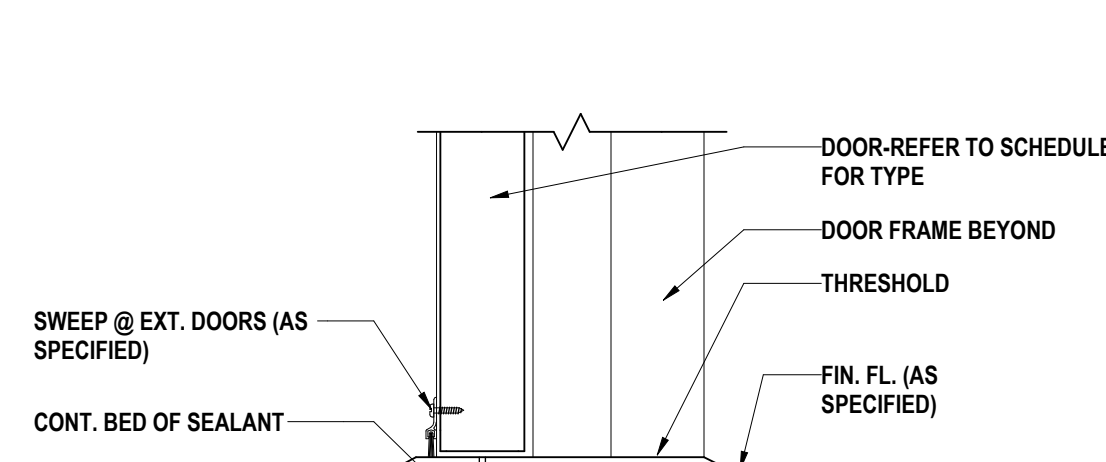


14 INTERIOR STOREFRONT HEAD DETAIL  
1 1/2" = 1'-0"

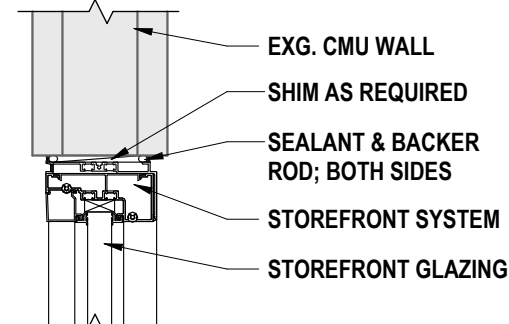


13 EXTERIOR STOREFRONT HEAD DETAIL  
1 1/2" = 1'-0"

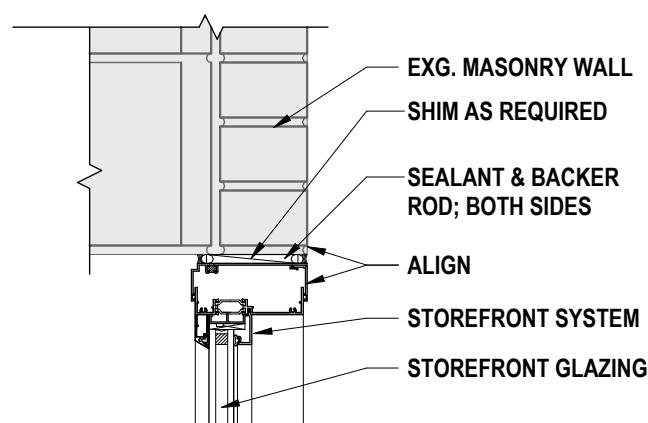


12 EXTERIOR STOREFRONT JAMB DETAIL  
1 1/2" = 1'-0"

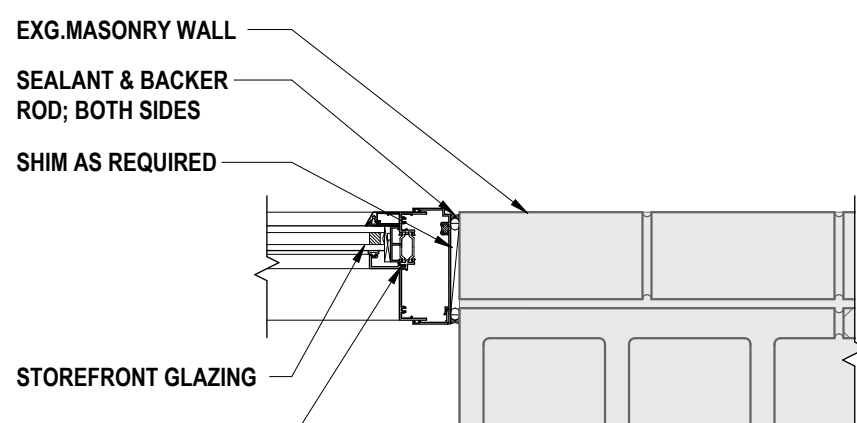


11 EXTERIOR STOREFRONT SILL DETAIL  
1 1/2" = 1'-0"

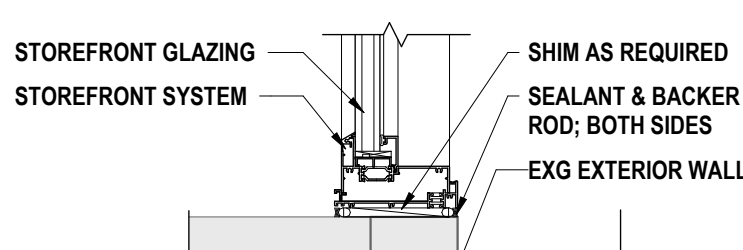


4 HM JAMB AT METAL STUD WALL DETAIL  
3" = 1'-0"

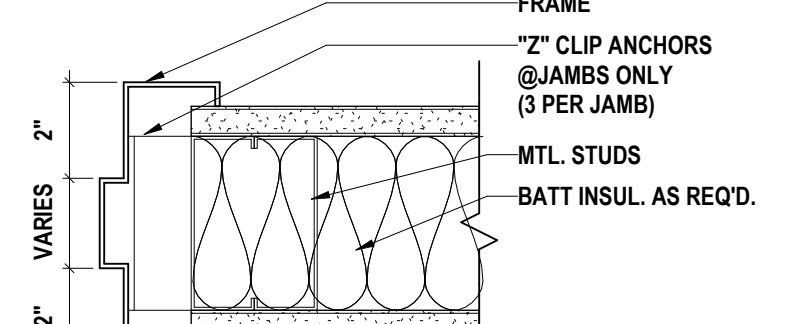


3 HM HEAD AT METAL STUD WALL HEAD DETAIL  
3" = 1'-0"

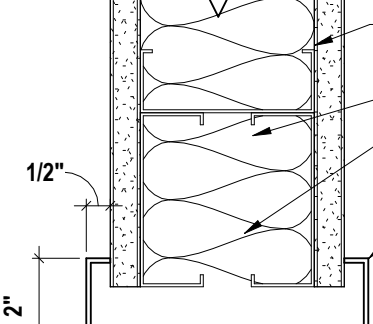

2 EXG. MASONRY WALL JAMB DETAIL 'B'  
3" = 1'-0"

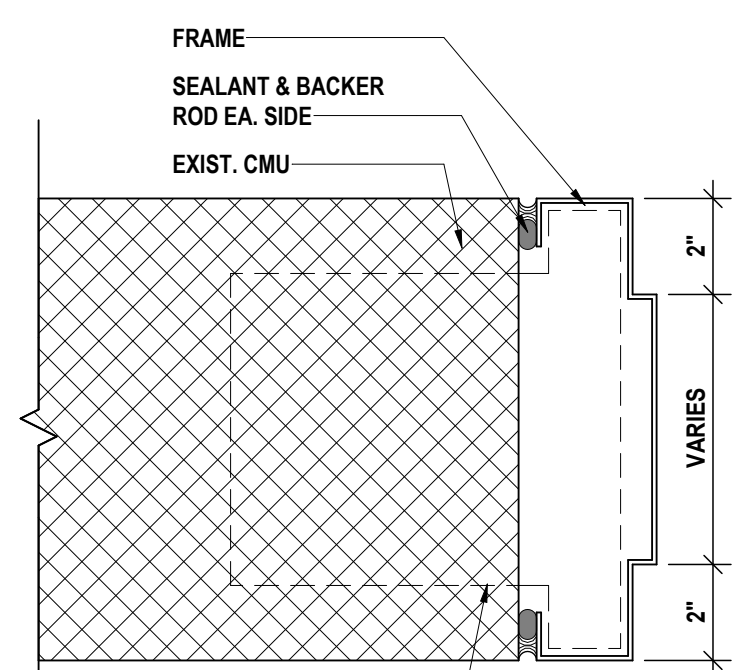

1 EXG. MASONRY WALL HEAD DETAIL 'B'  
3" = 1'-0"

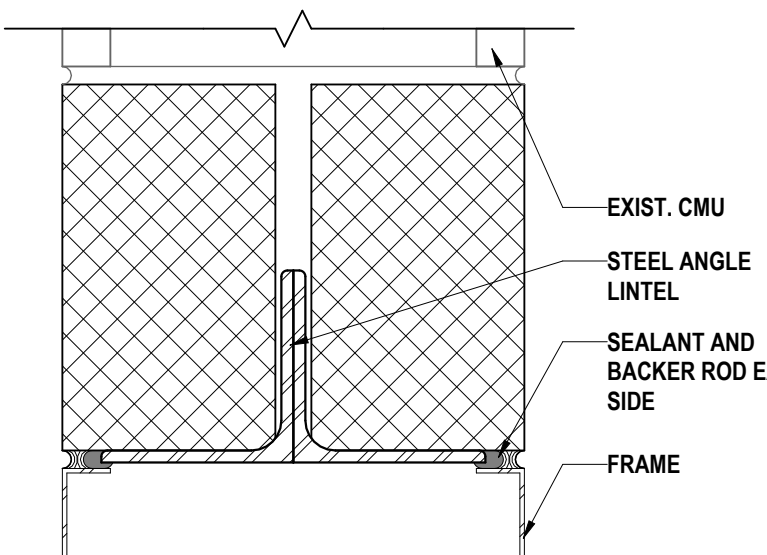

DOOR AND STOREFRONT SCHEDULES AND DETAILS

2025 MIDDLE SCHOOL PHASE III ALTERATIONS PROJECT

CORNING-PAINTED POST ASD

35 VICTORY HIGHWAY, PAINTED POST, NY 14870

HUNT ENGINEERS | ARCHITECTS | SURVEYORS

HORSEHEADS, NY 607-263-1000 ROCHESTER, NY 585-337-7668 TOWNAND, PA 570-265-4606 BINGHAMTON, NY 607-798-8081 ALBANY, NY 607-798-8081

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NY CERTIFICATE NO. 0016220 PA CERTIFICATE NO. TSC220131464-1

# DATE: 1 10/20/2025

DESCRIPTION OF REVISION: 1 ISSUED FOR BID

DRWN BY: ECW

CHECKED BY: MLR

DATE: 05/09/2025

PHASE: CD

11 IS A VIOLATION OF THE LAW FOR ANY PERSON TO MAKE UNAUTHORIZED ALTERATIONS OR ADDITIONS TO PLANS

SEALING & LICENSING ENGINEERS, ARCHITECTS & SURVEYORS STATE

Copyright 2025

MS-A6.1


PROJECT NO: 2649-133

57-10-00-01-00-04-044 - MIDDLE SCHOOL









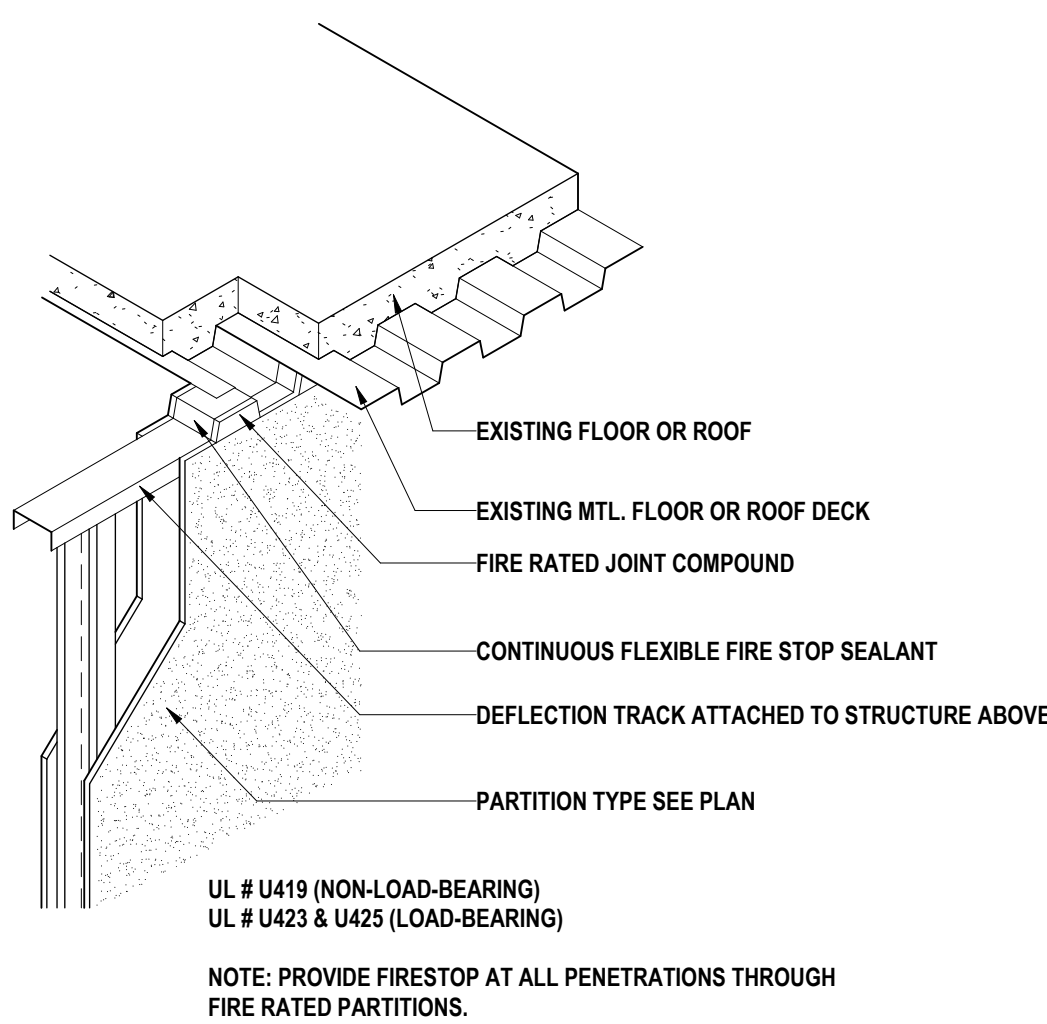

**2B FIRESTOPPING DETAIL**  
3/4" = 1'-0"

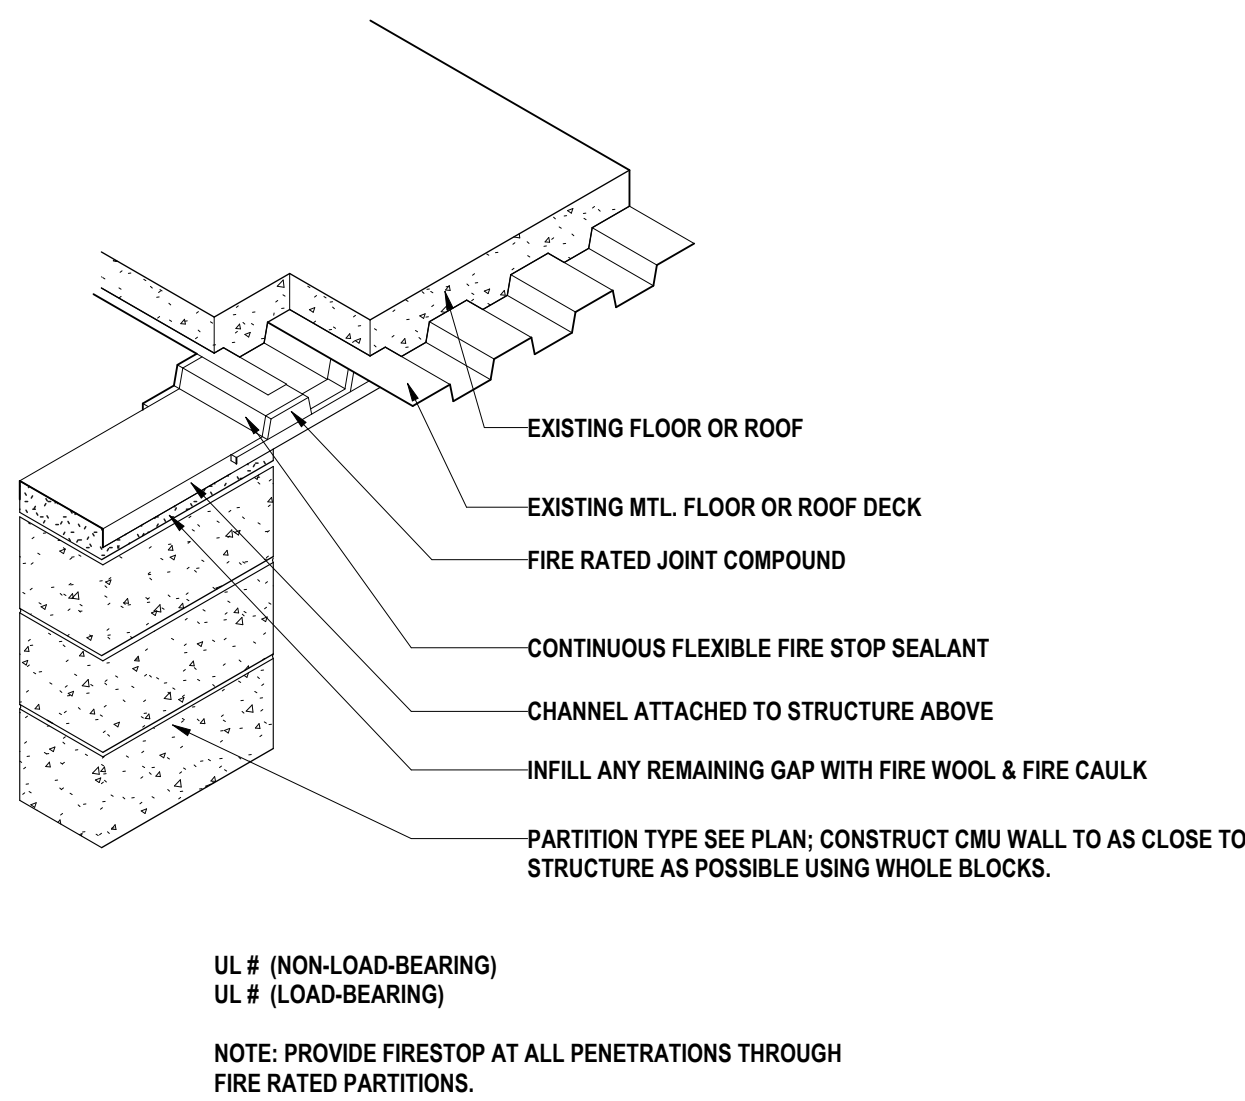


**2A FIRESTOPPING DETAIL**  
3/4" = 1'-0"

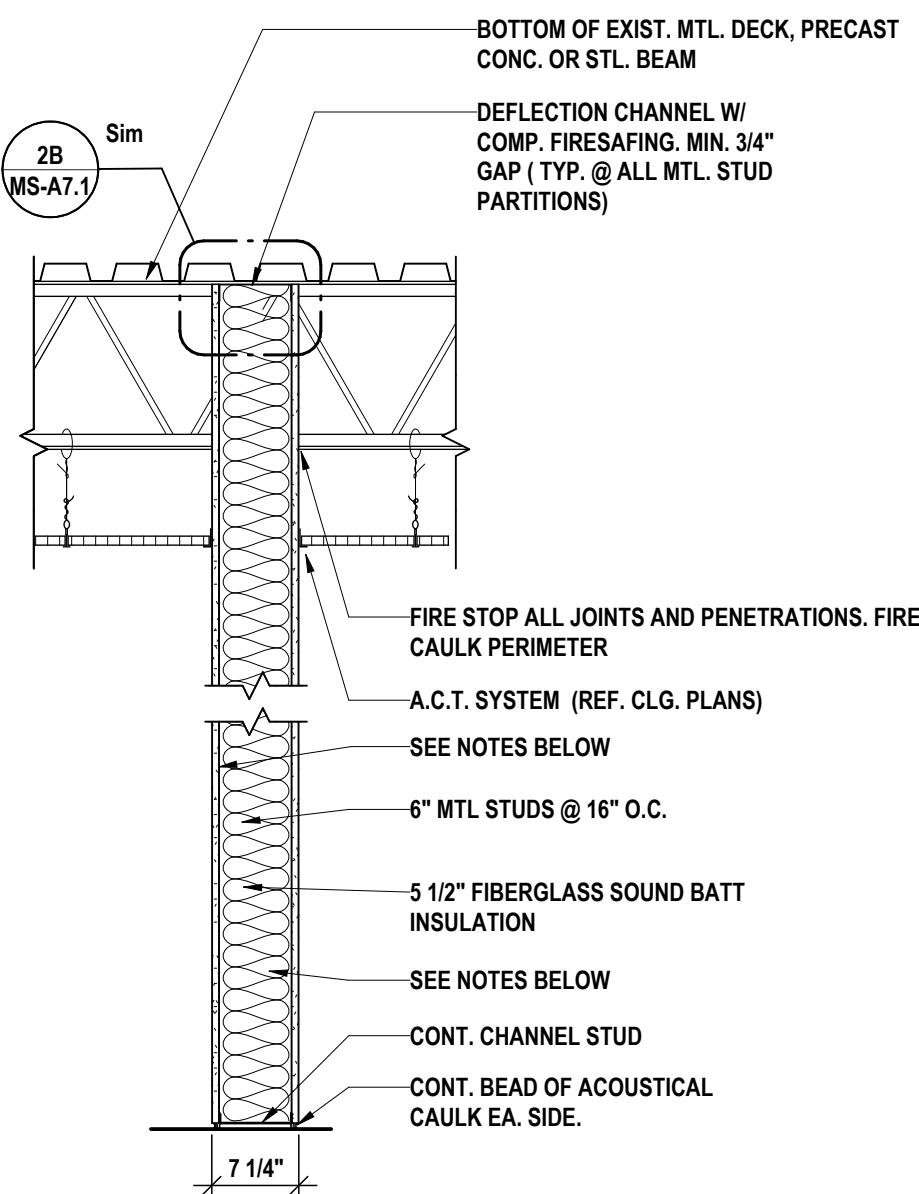


**PARTITION TYPE**

- 5** (1) LAYER 5/8" GWB EA. SIDE; MOISTURE RESISTANT GWB WITHIN 4'-0" OF A WET LOCATION
- 5A** (1) LAYER 5/8" TYPE "X" FIRE RATED GWB EA. SIDE W/ FIRE CAULK; UL# U465, 1HR

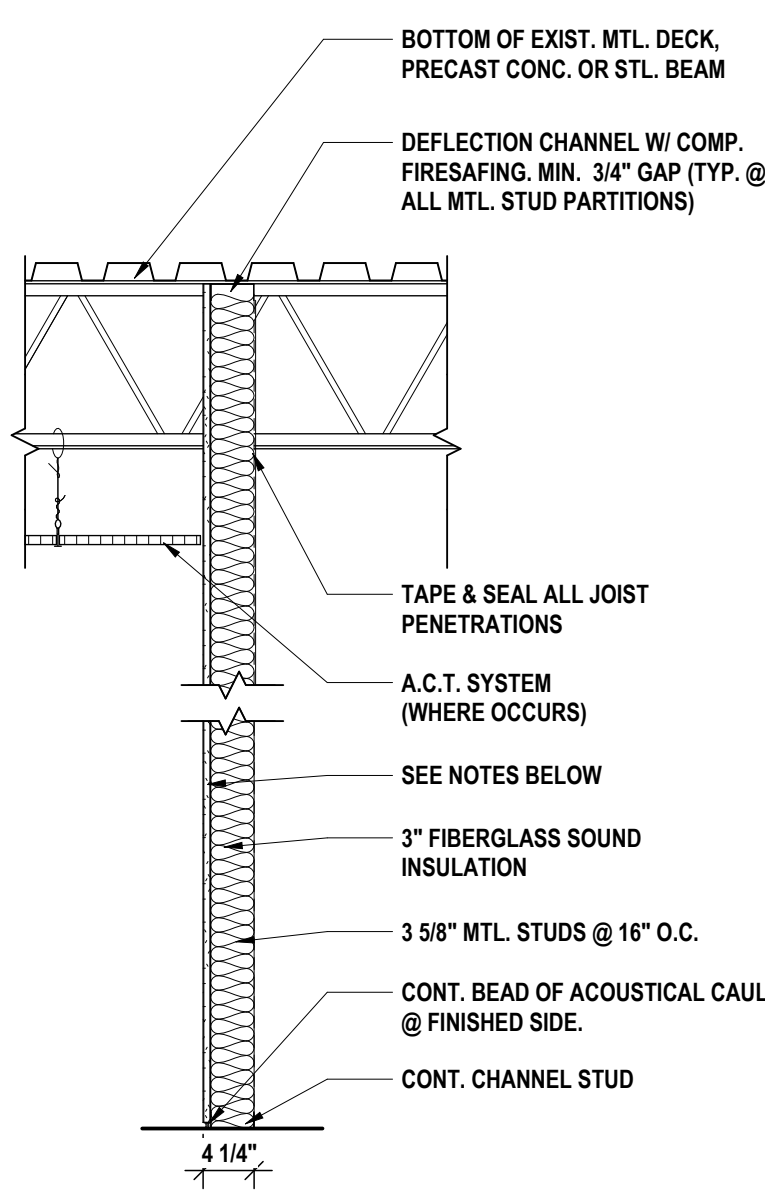


**PARTITION TYPE**

- 3** 3-5/8" MTL STUDS; 1 LAYER 5/8" EA. MOISTURE RESISTANT WITHIN 4'-0" OF A WET LOCATION

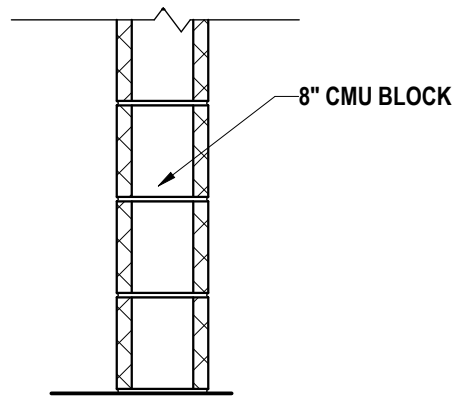


**PARTITION TYPE**

- 2** 8" CMU BLOCK & 5/8" G.W.B.;

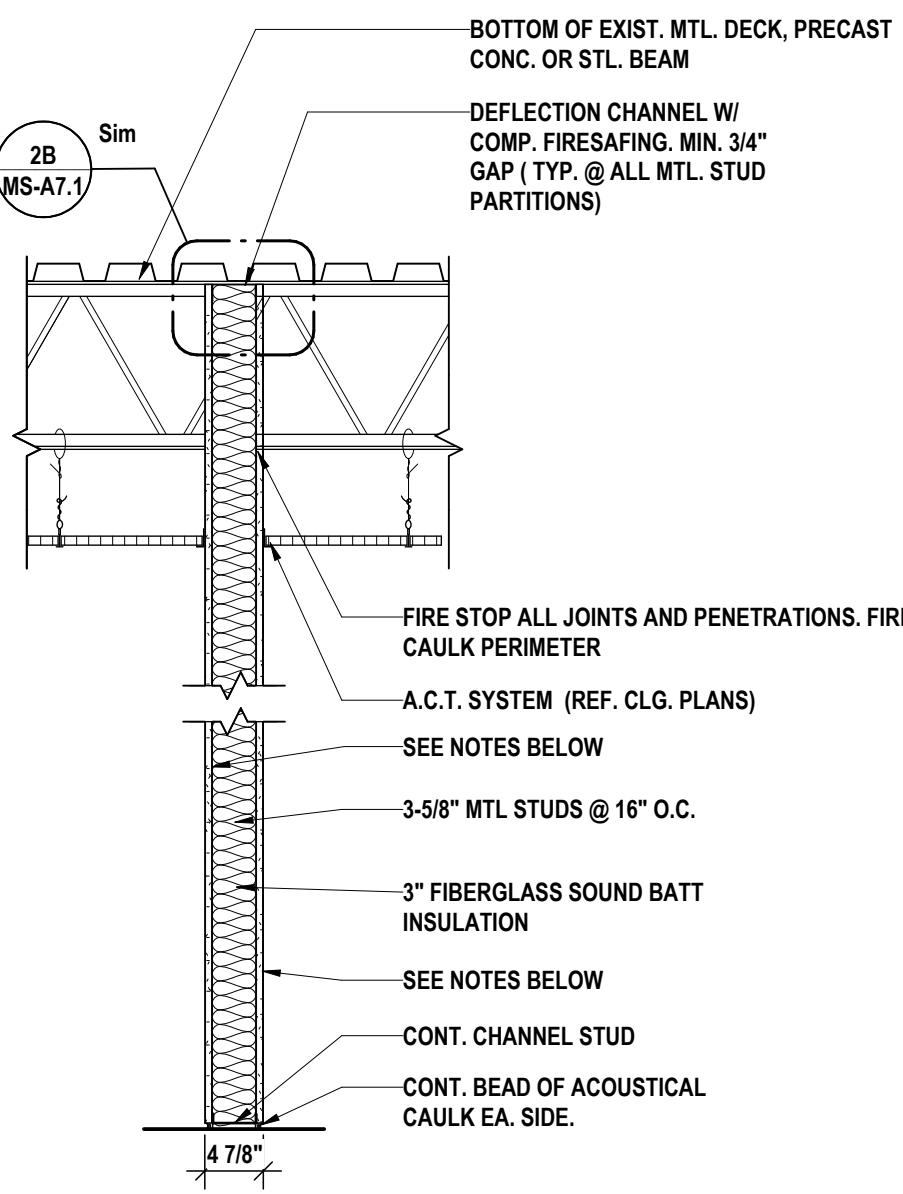


**PARTITION TYPE**


- 1** (1) LAYER 5/8" GWB EA. SIDE; MOISTURE RESISTANT GWB WITHIN 4'-0" OF A WET LOCATION
- 1A** (1) LAYER 5/8" TYPE "X" FIRE RATED GWB EA. SIDE W/ FIRE CAULK; UL# U465, 1HR

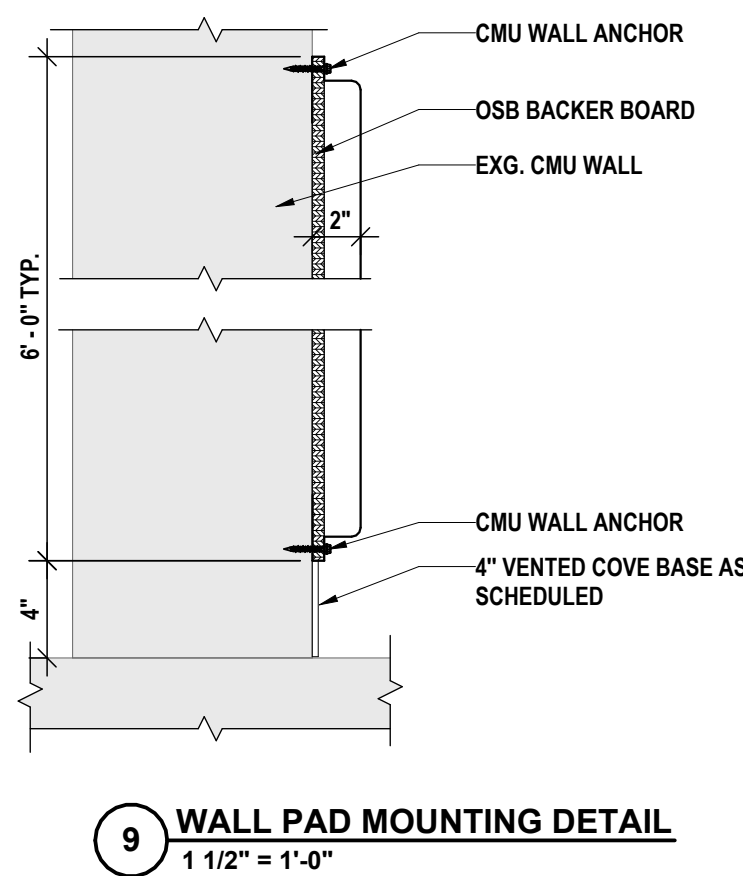


**9 WALL PAD MOUNTING DETAIL**  
1 1/2" = 1'-0"

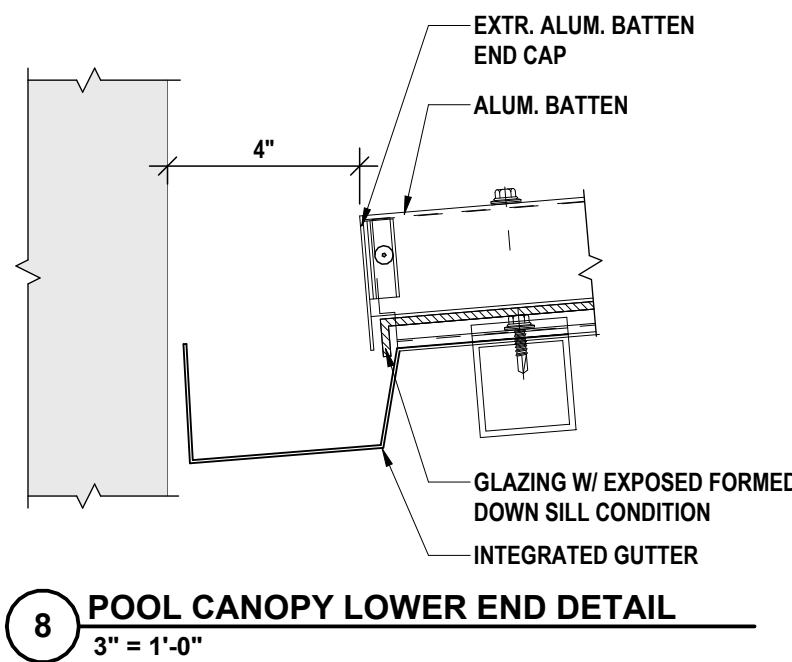


**8 POOL CANOPY LOWER END DETAIL**  
3" = 1'-0"

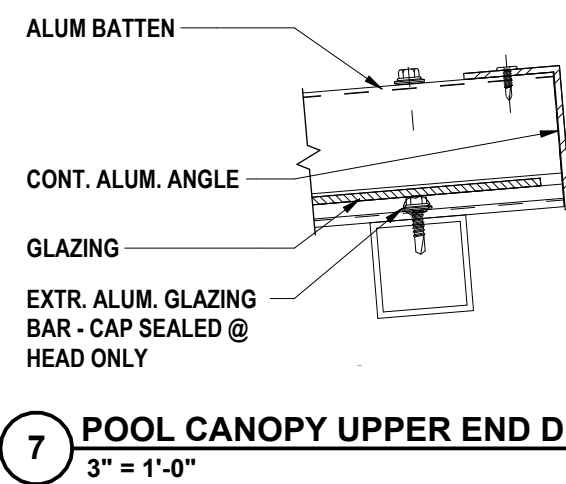


**7 POOL CANOPY UPPER END DETAIL**  
3" = 1'-0"

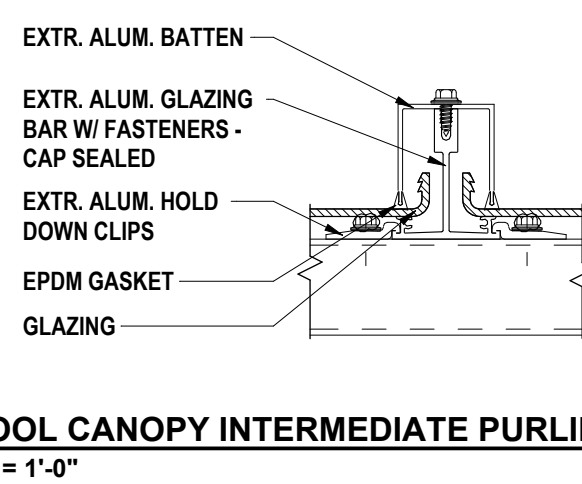

**6 POOL CANOPY INTERMEDIATE PURLIN DETAIL**  
3" = 1'-0"

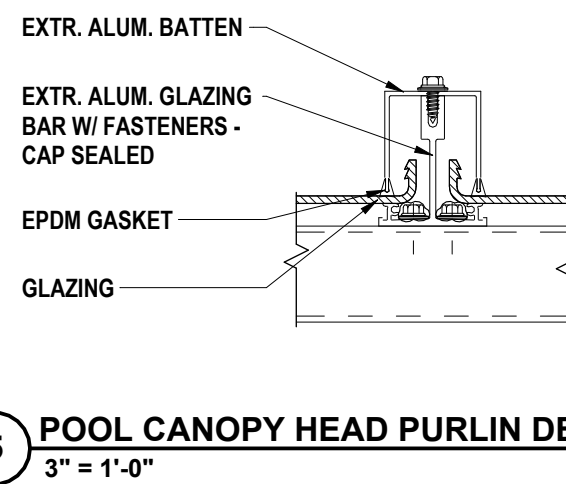

**5 POOL CANOPY HEAD PURLIN DETAIL**  
3" = 1'-0"

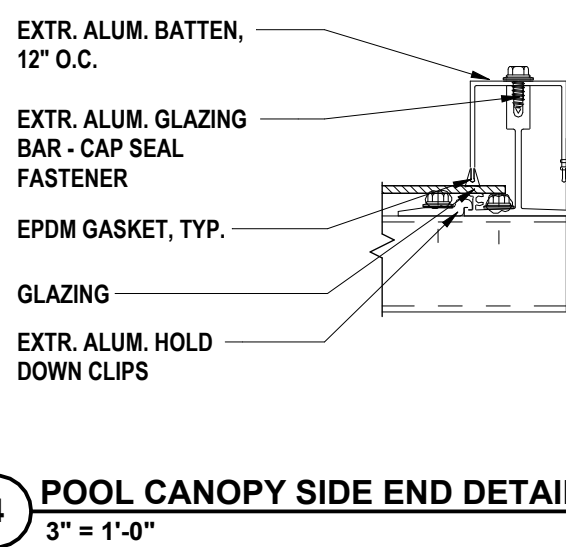

**4 POOL CANOPY SIDE END DETAIL**  
3" = 1'-0"

**NOTE:** SEAL AND FIRESTOP ALL PENETRATIONS THROUGH ALL PARTITIONS SEE SECTION 07 84 00 TYPICAL ALL WALL TYPES.

**NOTE:** LOCATION OF UL DESIGNATED PARTITIONS AND THE LENGTH OF THEIR FIRE RATINGS ARE INDICATED ON DRAWING MS-C01.1, 2 & 3




GENERAL NOTES - INTERIOR FLOOR FINISH:

- A ALL FLOOR FINISHES SHALL BE INSTALLED ABUTTING NEW BUILT-IN CASEWORK, EVEN WHEN NOT SHOWN ON FLOOR FINISH PLANS, UNLESS OTHERWISE NOTED.
- B ALL FLOOR FINISHES TO TRANSITION AT CENTERLINE OF DOOR JAM UNLESS OTHERWISE NOTED ON FLOOR FINISH PLANS.
- C FLOOR FINISHES TO EXTEND UNDERNEATH COUNTERTOPS WHERE FLOORING WOULD OTHERWISE BE EXPOSED.
- D REFER TO FINISH KEY AND ROOM FINISH SCHEDULE FOR ALL FINISHES NOT INDICATED ON FLOOR FINISH PLANS.
- E PREP FLOORS ACCORDING TO SPECIFICATION 09 05 61, "COMMON WORK RESULTS FOR FLOOR PREPARATION".
- F PROVIDE ADA COMPLIANT TRANSITION STRIP WHEN ABUTTING FLOOR FINISHES DIFFER IN THICKNESS OR MATERIAL. REFER TO FINISH KEY AND ROOM FINISH SCHEDULE FOR DETAILS.


CONSTRUCTION NOTES - INTERIOR FLOOR FINISH

- 1 FLOOR TO RECEIVE PORCELAIN MOSAIC FLOOR TILE, FT-1. PROVIDE PORCELAIN WALL BASE CB-2.
- 2 FLOOR TO RECEIVE RUBBER FLOOR TILE, RF-1,2,3 IN GRID INSTALLATION PATTERN. PROVIDE RB-2 AS BASE.
- 3 FLOOR TO RECEIVE TERRAZZO, TZ-1,2,3. PROVIDE PRE-CAST TERRAZZO BASE, TZB-1. REFER TO 2IMS-A8.2 FOR INSTALLATION PATTERN & DETAILS.
- 4 KITCHEN & SERVERY FLOOR TO RECEIVE PORCELAIN FLOOR TILE, FT-2 IN GRID INSTALLATION PATTERN. PROVIDE CERAMIC BASE, CB-1. PROVIDE CONTROL JOINTS AND MOVEMENT JOINTS AS RECOMMENDED BY MANUFACTURER.
- 5 PATCH TO MATCH FLOORING WHERE NEW CONSTRUCTION AFFECTS EXISTING FLOOR FINISH CONDITIONS.
- 6 FLOOR TO RECEIVE CARPET TILE, CPT-1 IN MONOLITHIC INSTALLATION PATTERN. PROVIDE RB-2 AS BASE.
- 7 BASE BID: ETR.
- 8 ALTERNATE #2: GYM MEZZANINE FLOOR TO RECEIVE POLISHED CONCRETE TOPPER, CF-1. PROVIDE BASE AS SCHEDULED.
- 9 POOL DECK TO RECEIVE PORCELAIN MOSAIC TILE, FT-3,4,5,6,7,8. PROVIDE CB-3 AS BASE.
- 10 POOL RAMP TO RECEIVE PORCELAIN MOSAIC TILE, FT-4,7.
- 11 FLOOR TO RECEIVE POLISHED CONCRETE TOPPER, CF-1. PROVIDE BASE AS SCHEDULED.
- 12 PATCH TO MATCH FLOORING WHERE NEW CONSTRUCTION AFFECTS EXISTING FLOOR FINISH CONDITIONS. PROVIDE CERAMIC BASE, CB-3 AS SANITARY BASE.
- 13 CORRIDOR ALCOVES TO RECEIVE EPOXY TERRAZZO FLOORING. REFER TO FINISH KEY FOR COLORS.
- 14 POOL TO RECEIVE MARCITE FINISH, MC-1. LANE AND WALL MARKERS TO RECEIVE FT-8. REFER TO MS-A8.4 FOR LANE MARKER LAYOUT AND DETAILS.
- 15 BASE BID: ETR.
- 16 ALTERNATE #2: REFINISH GYM FLOORING UNDERNEATH BLEACHERS WITH STN-2.


FLOOR FINISH LEGEND:											
	RF-1		RF-3		FT-1		TZ-1		TZ-3		CPT-1
	RF-2		RF GRID		FT-1,3,4 GRID		TZ-2		TZ-4		CF-1
	TS-1		TS-3		TS-4		TS-5		TS-6		STN-2

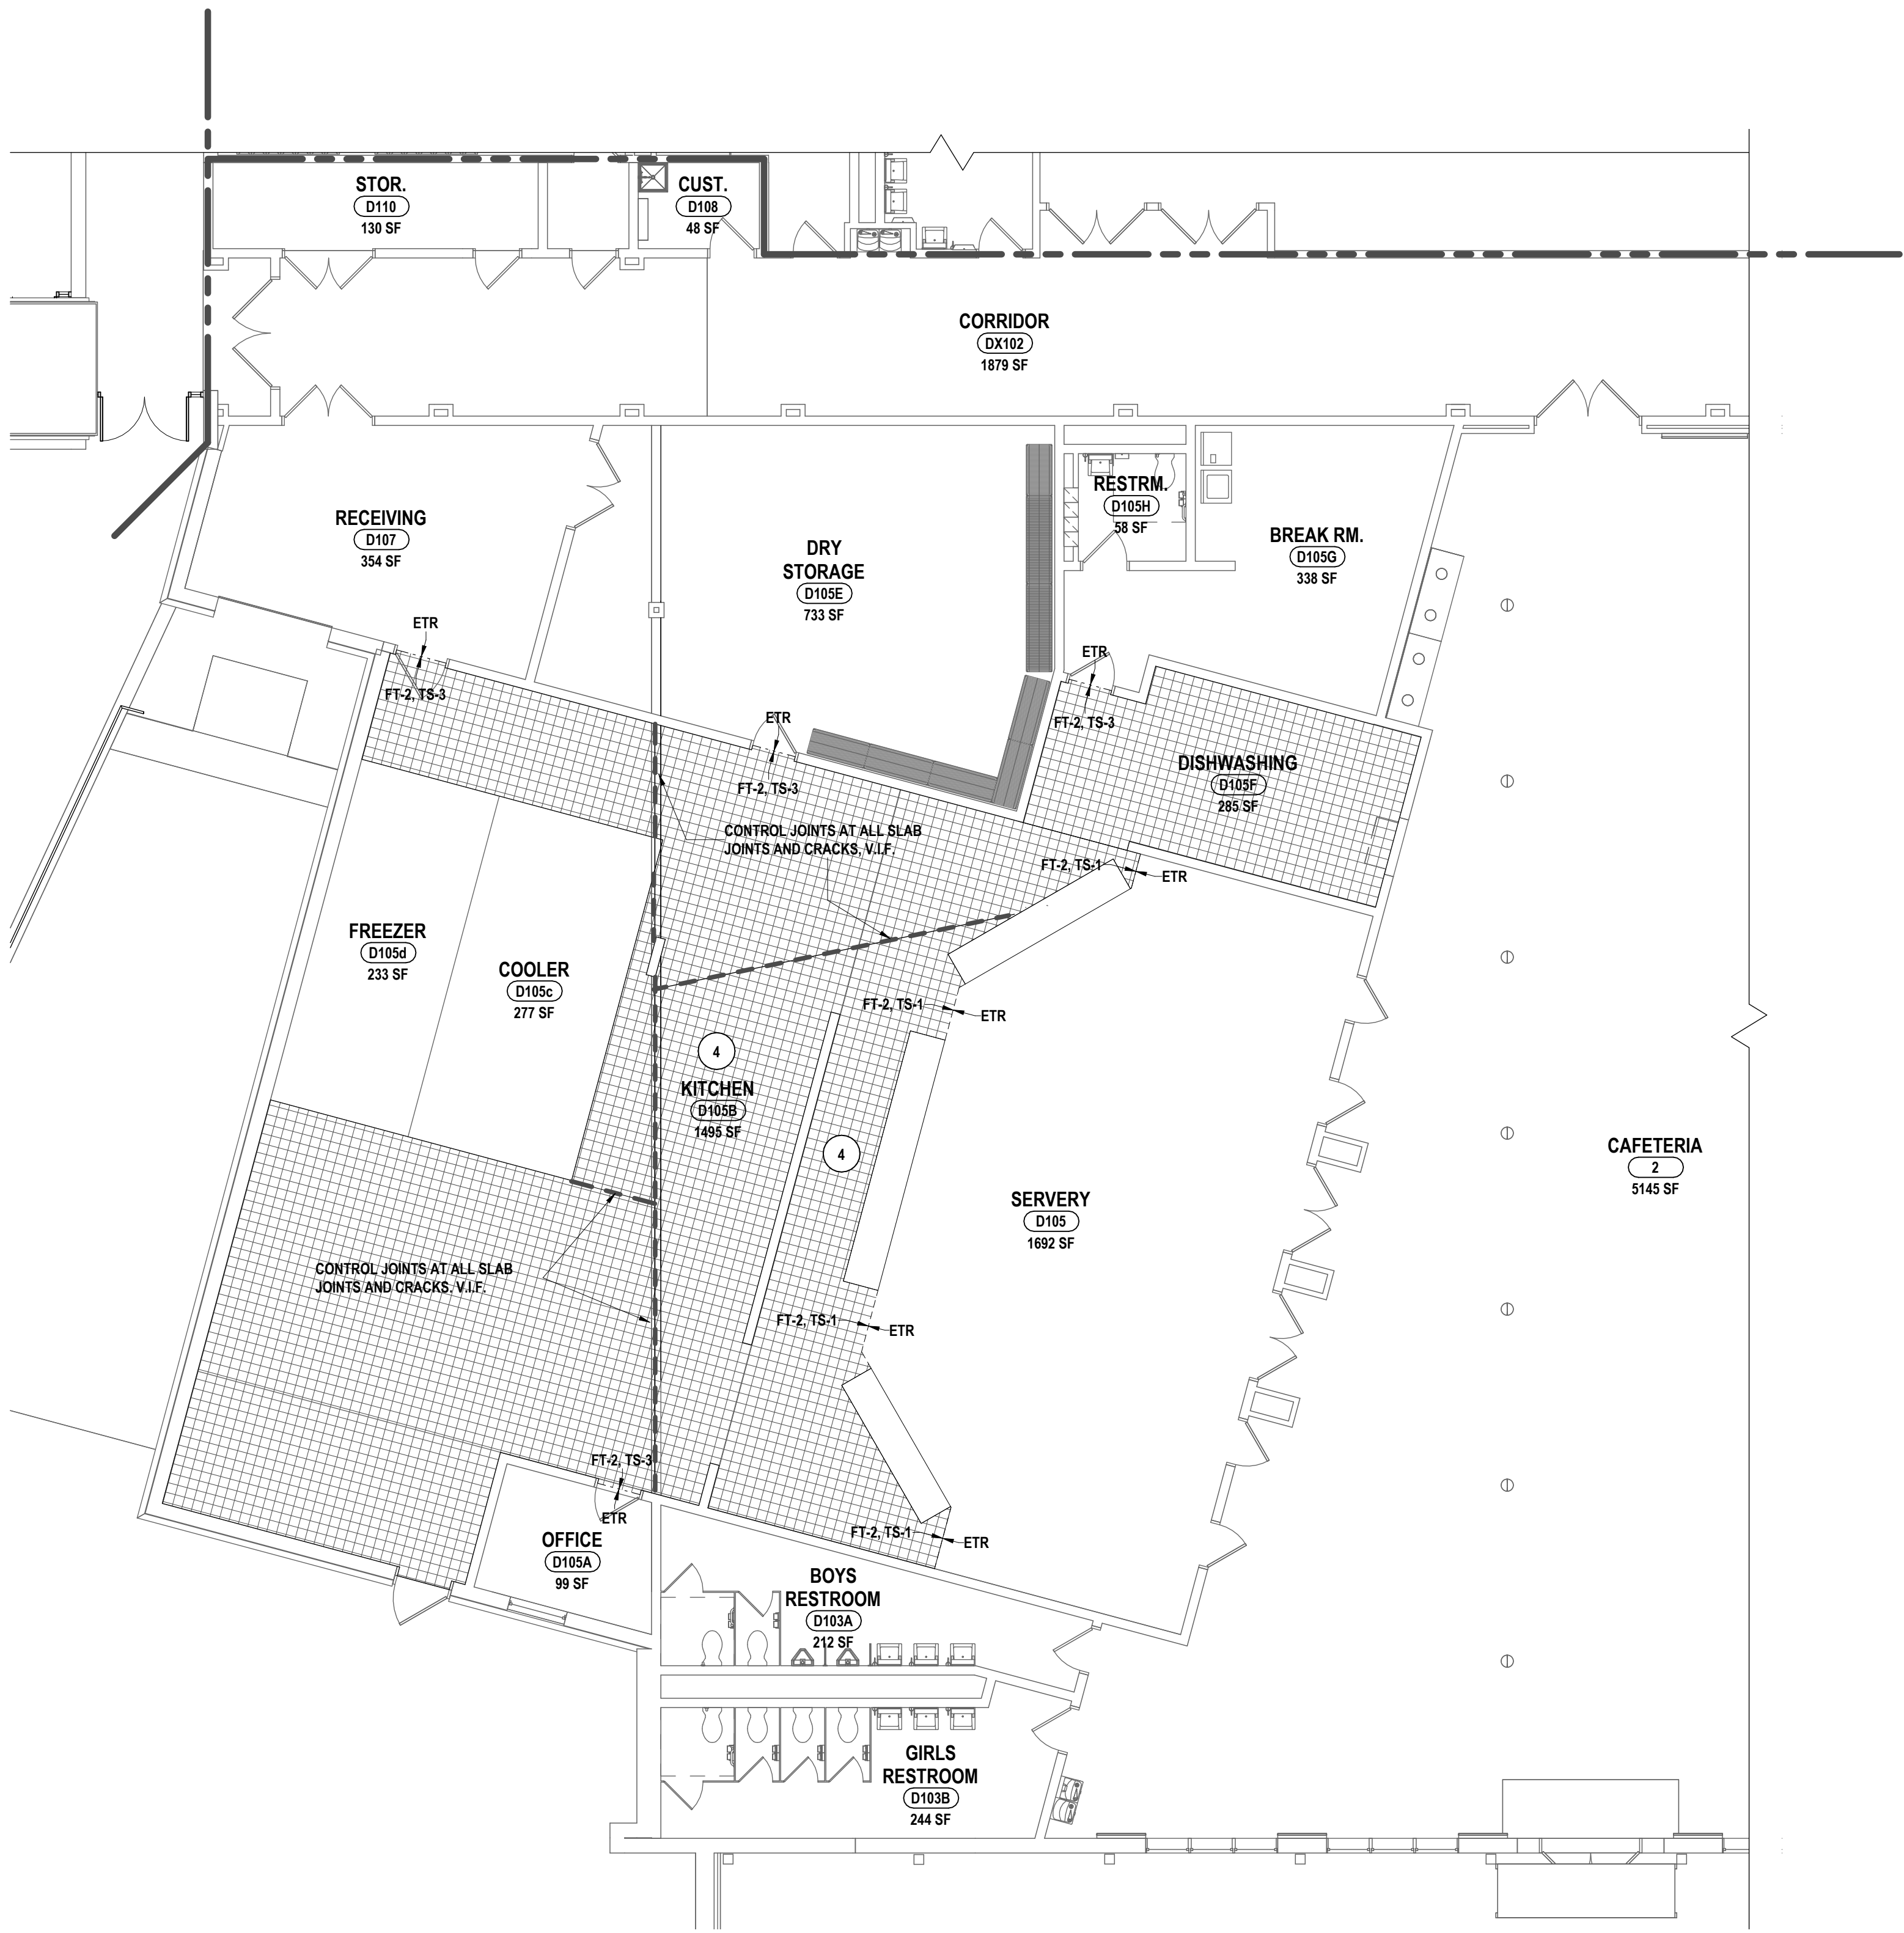

2 PARTIAL FIRST FLOOR FINISH PLAN - AREA B  
1/8" = 1'-0"

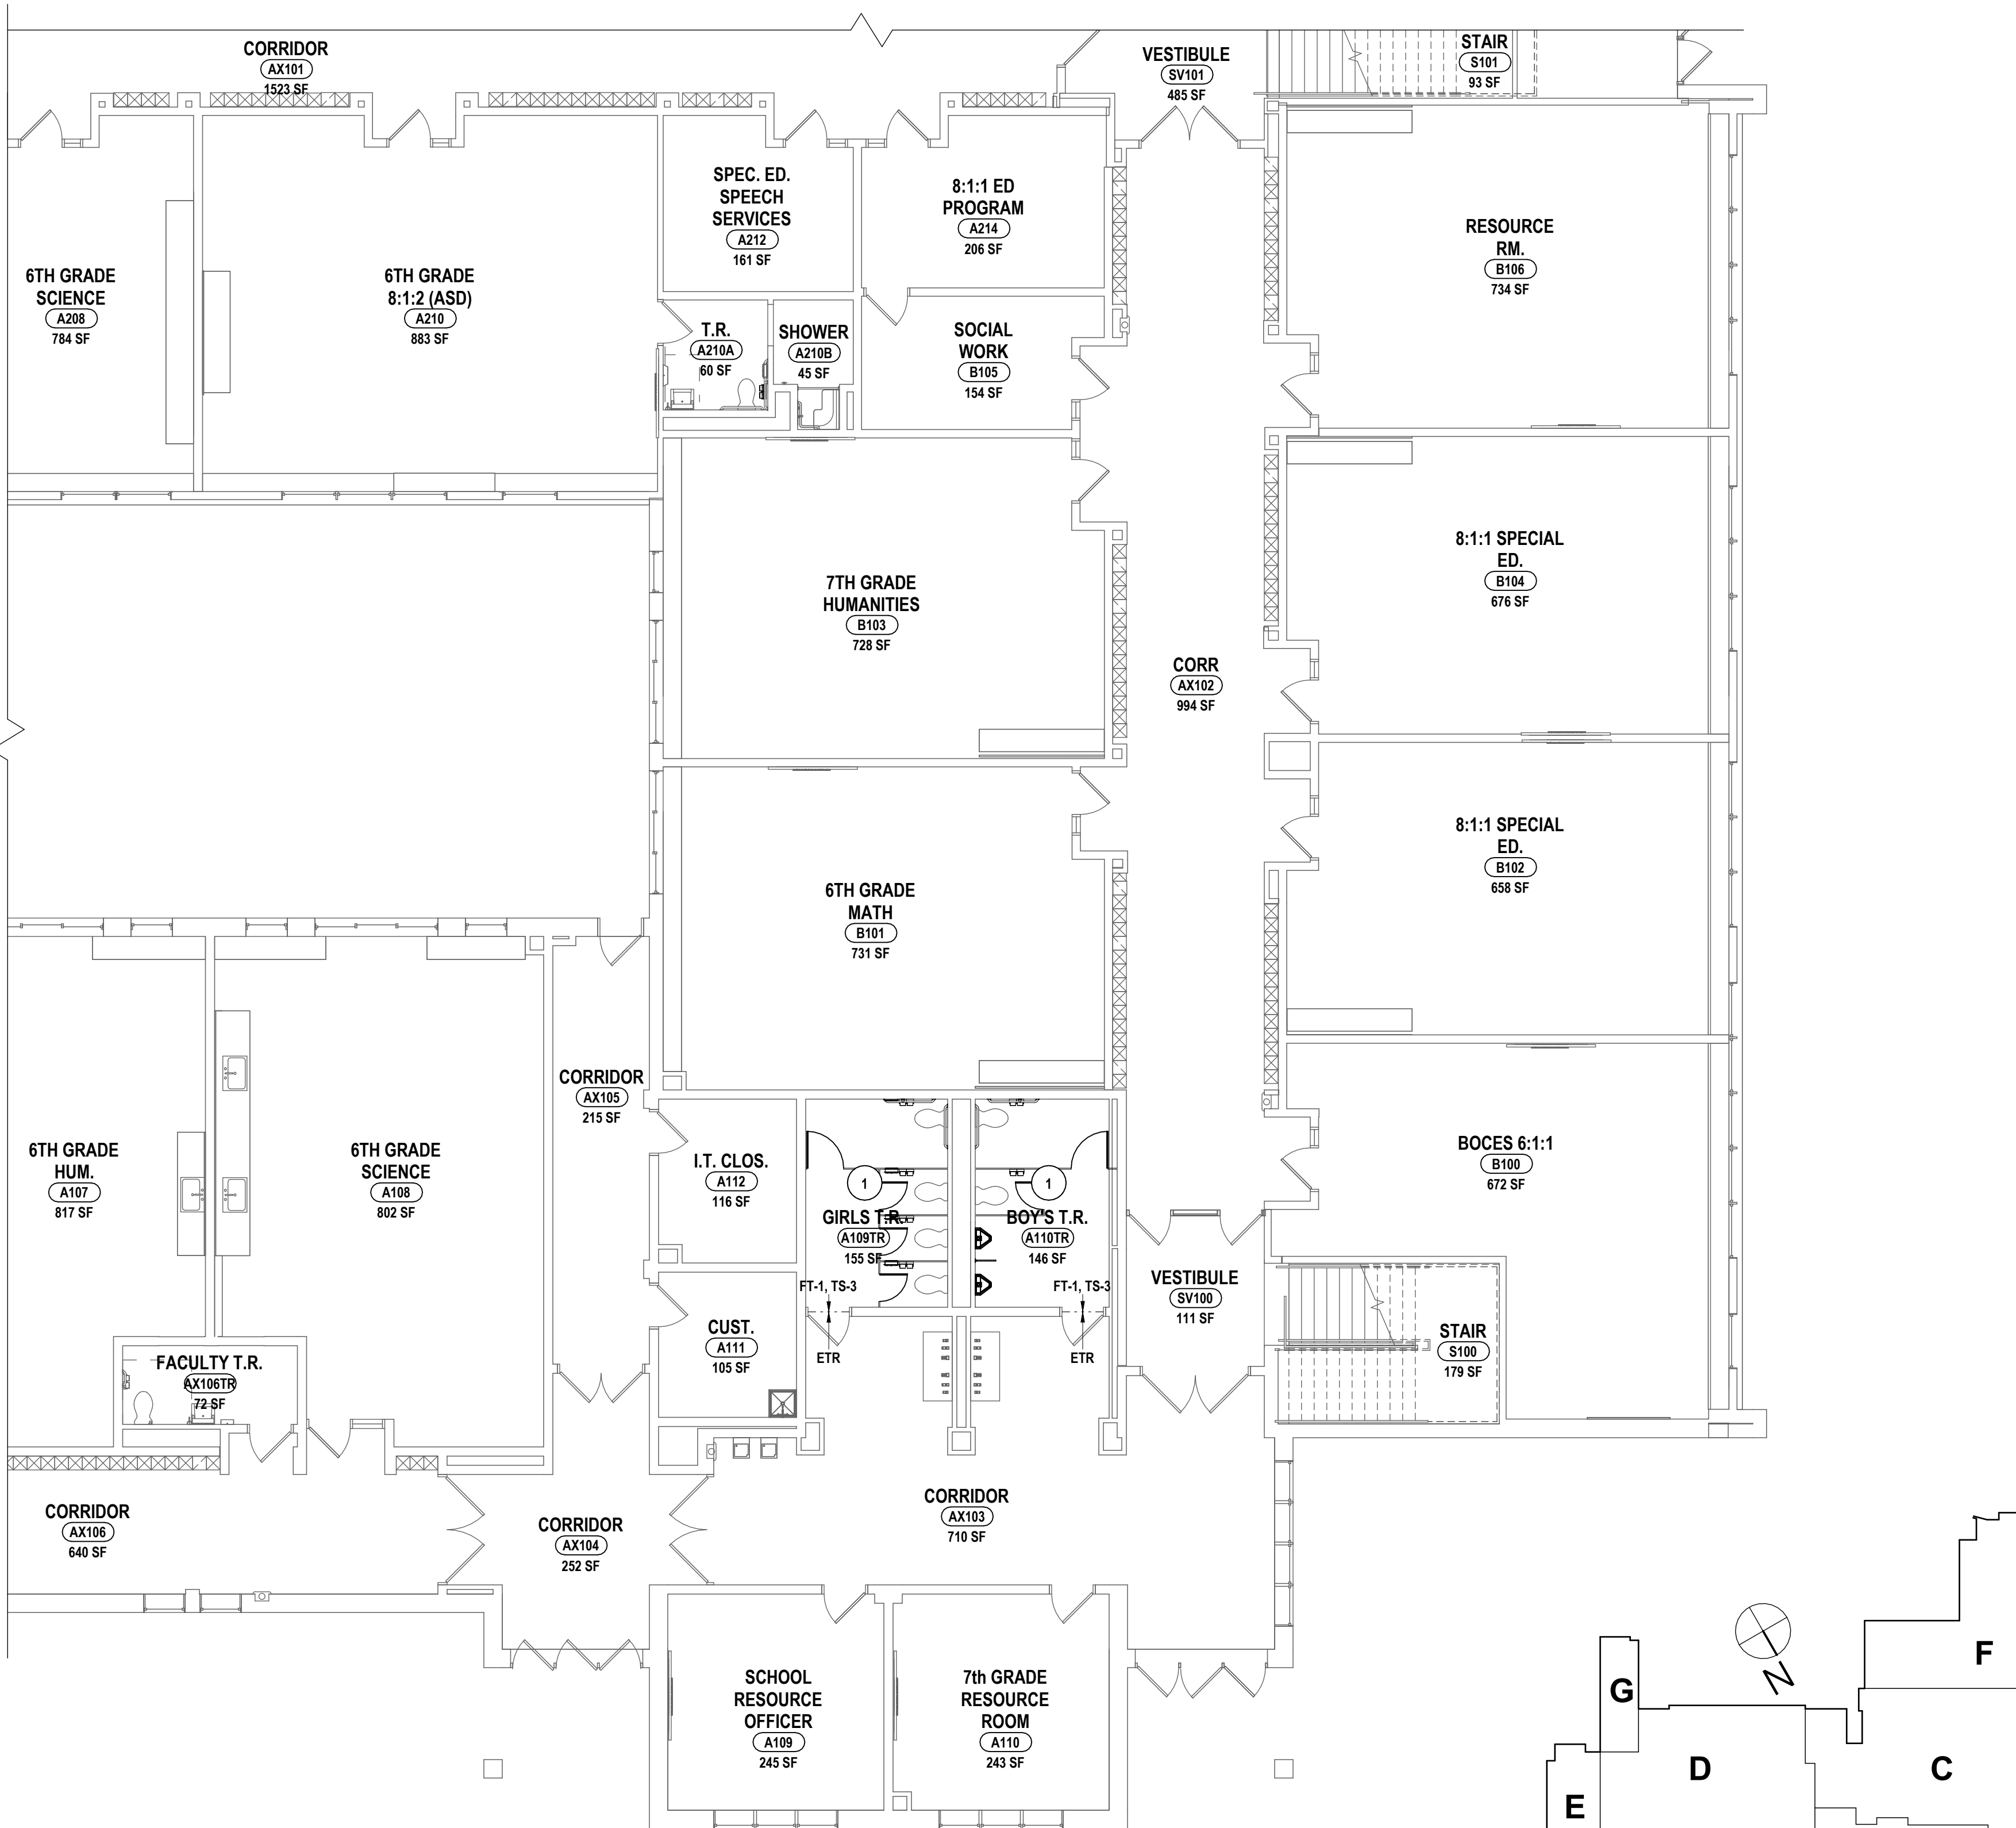

1 PARTIAL FIRST FLOOR FINISH PLAN - AREA A  
1/8" = 1'-0"

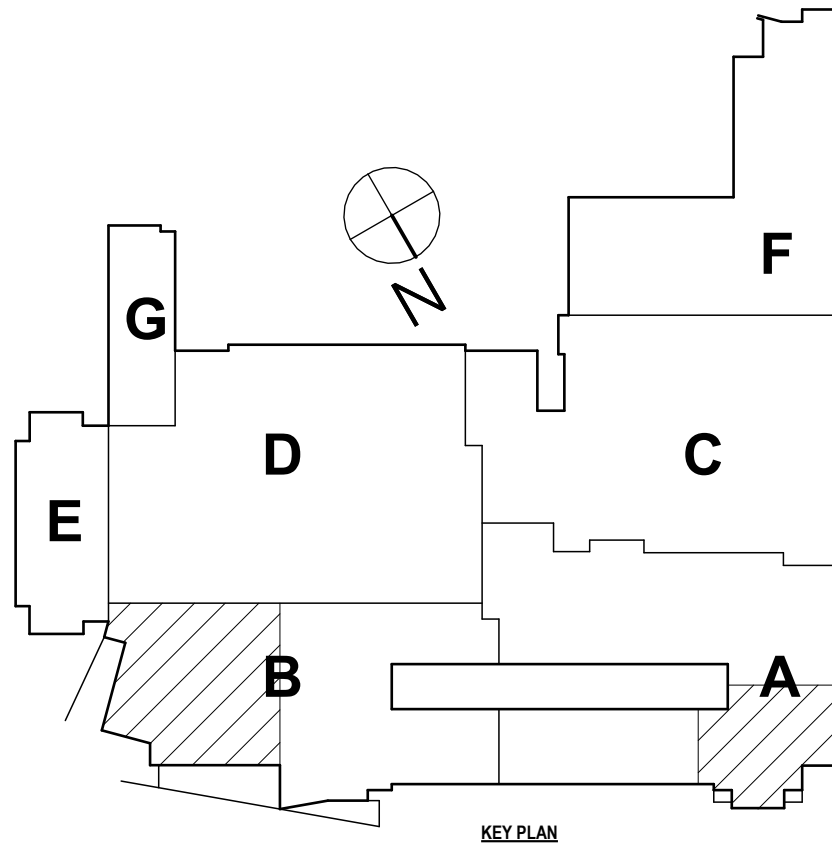



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- C FLOOR FINISHES TO EXTEND UNDERNEATH COUNTERTOPS WHERE FLOORING WOULD OTHERWISE BE EXPOSED.
- D REFER TO FINISH KEY AND ROOM FINISH SCHEDULE FOR ALL FINISHES NOT INDICATED ON FLOOR FINISH PLANS.
- E PREP FLOORS ACCORDING TO SPECIFICATION 09 05 61, "COMMON WORK RESULTS FOR FLOOR PREPARATION".
- F PROVIDE ADA COMPLIANT TRANSITION STRIP WHEN ABUTTING FLOOR FINISHES DIFFER IN THICKNESS OR MATERIAL. REFER TO FINISH KEY AND ROOM FINISH SCHEDULE FOR DETAILS.

CONSTRUCTION NOTES - INTERIOR FLOOR FINISH

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- 2 FLOOR TO RECEIVE RUBBER FLOOR TILE, RF-1.2.3 IN GRID INSTALLATION PATTERN. PROVIDE RB-2 AS BASE.
- 3 FLOOR TO RECEIVE TERRAZZO, TZ-1.2.3. PROVIDE PRE-CAST TERRAZZO BASE, TZB-1. REFER TO 2/MS-A8.2 FOR INSTALLATION PATTERN & DETAILS.
- 4 KITCHEN & SERVERY FLOOR TO RECEIVE PORCELAIN FLOOR TILE, FT-2 IN GRID INSTALLATION PATTERN. PROVIDE CERAMIC BASE, CB-1. PROVIDE CONTROL JOINTS AND MOVEMENT JOINTS AS RECOMMENDED BY MANUFACTURER.
- 5 PATCH TO MATCH FLOORING WHERE NEW CONSTRUCTION AFFECTS EXISTING FLOOR FINISH CONDITIONS.
- 6 FLOOR TO RECEIVE CARPET TILE, CPT-1 IN MONOLITHIC INSTALLATION PATTERN. PROVIDE RB-2 AS BASE.
- 7 BASE BID: ETR.
- 8 ALTERNATE #2: GYM MEZZANINE FLOOR TO RECEIVE POLISHED CONCRETE TOPPER, CF-1. PROVIDE BASE AS SCHEDULED.
- 9 POOL DECK TO RECEIVE PORCELAIN MOSAIC TILE, FT-3.4.5.6.7.8. PROVIDE CB-3 AS BASE.
- 10 POOL RAMP TO RECEIVE PORCELAIN MOSAIC TILE, FT-6.7.
- 11 FLOOR TO RECEIVE POLISHED CONCRETE TOPPER, CF-1. PROVIDE BASE AS SCHEDULED.
- 12 PATCH TO MATCH FLOORING WHERE NEW CONSTRUCTION AFFECTS EXISTING FLOOR FINISH CONDITIONS. PROVIDE CERAMIC BASE, CB-3 AS SANITARY BASE.
- 13 CORRIDOR ALCOVES TO RECEIVE EPOXY TERRAZZO FLOORING. REFER TO FINISH KEY FOR COLORS.
- 14 POOL TO RECEIVE MARCITE FINISH, MC-1. LANE AND WALL MARKERS TO RECEIVE FT-8. REFER TO MS-A8.4 FOR LANE MARKER LAYOUT AND DETAILS.
- BASE BID: ETR.
- ALTERNATE #2: REFINISH GYM FLOORING UNDERNEATH BLEACHERS WITH STN-2.

FLOOR FINISH LEGEND:

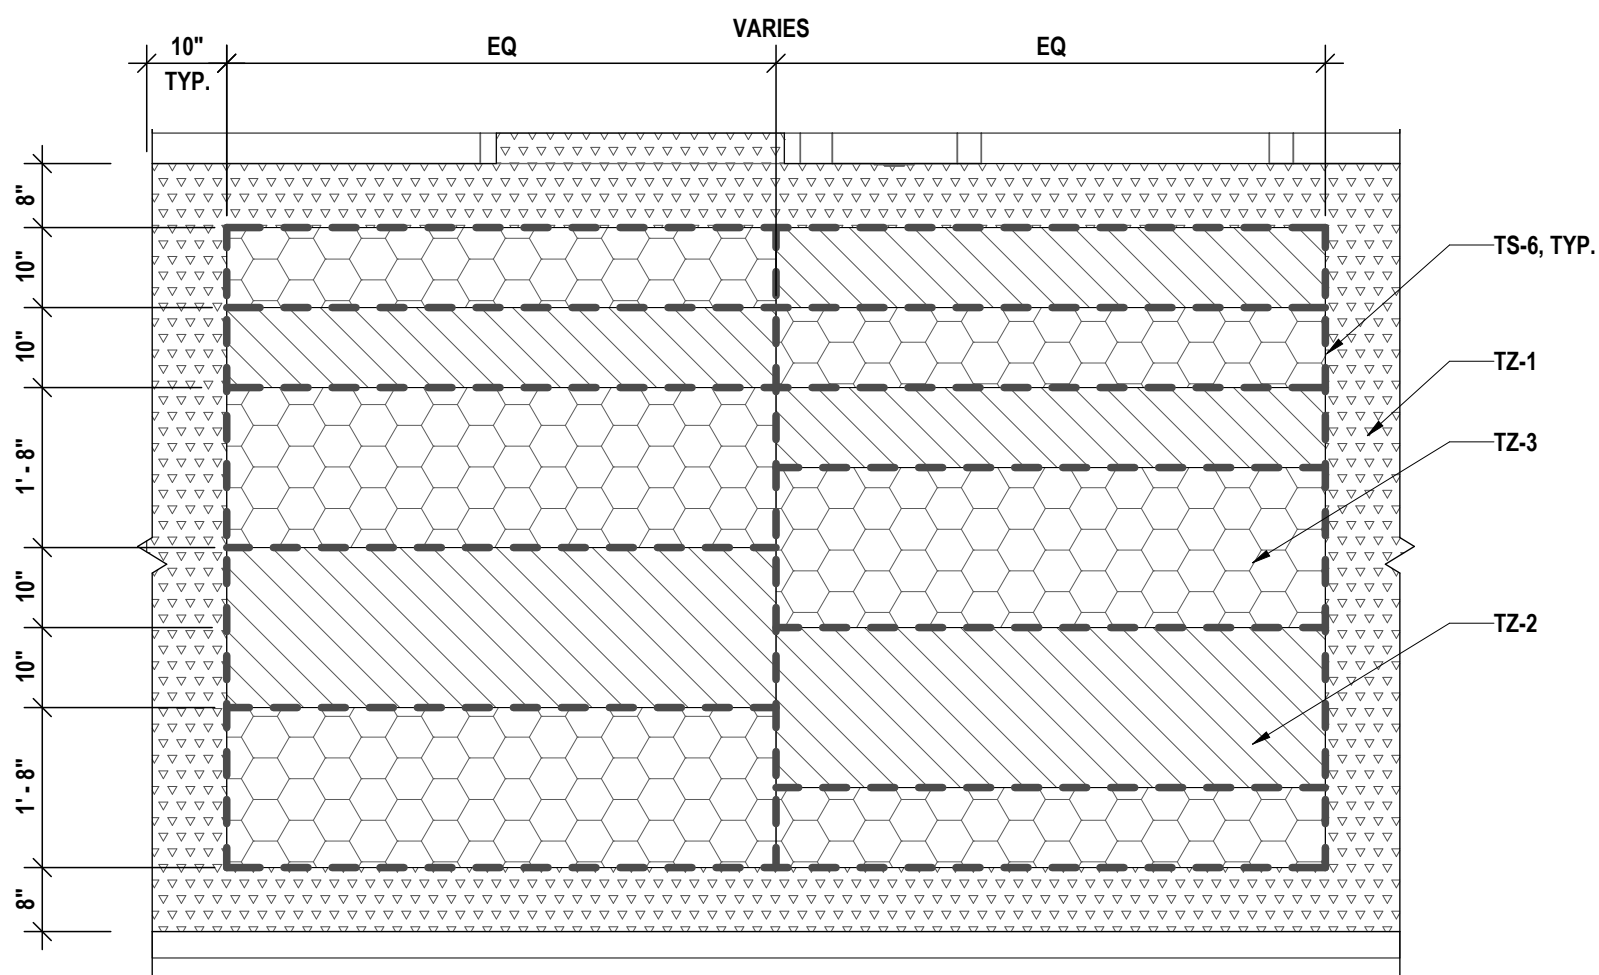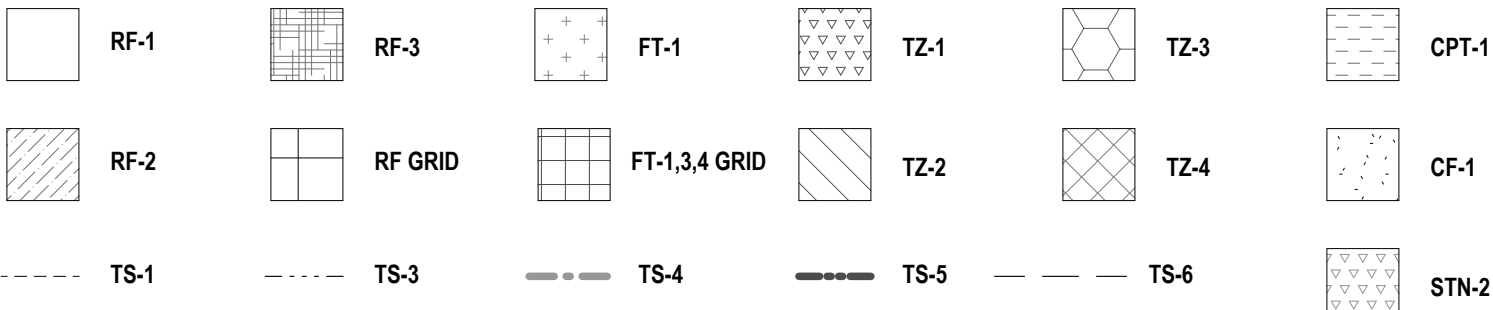


2 CORRIDOR TERRAZZO INSTALLATION DETAIL

1/2" = 1'-0"

\*NOTE: REFER TO 1/MS-A8.2 FOR COMPLETE TERRAZZO COLOR LOCATIONS

1 FIRST FLOOR FINISH PLAN - AREA C

1/8" = 1'-0"

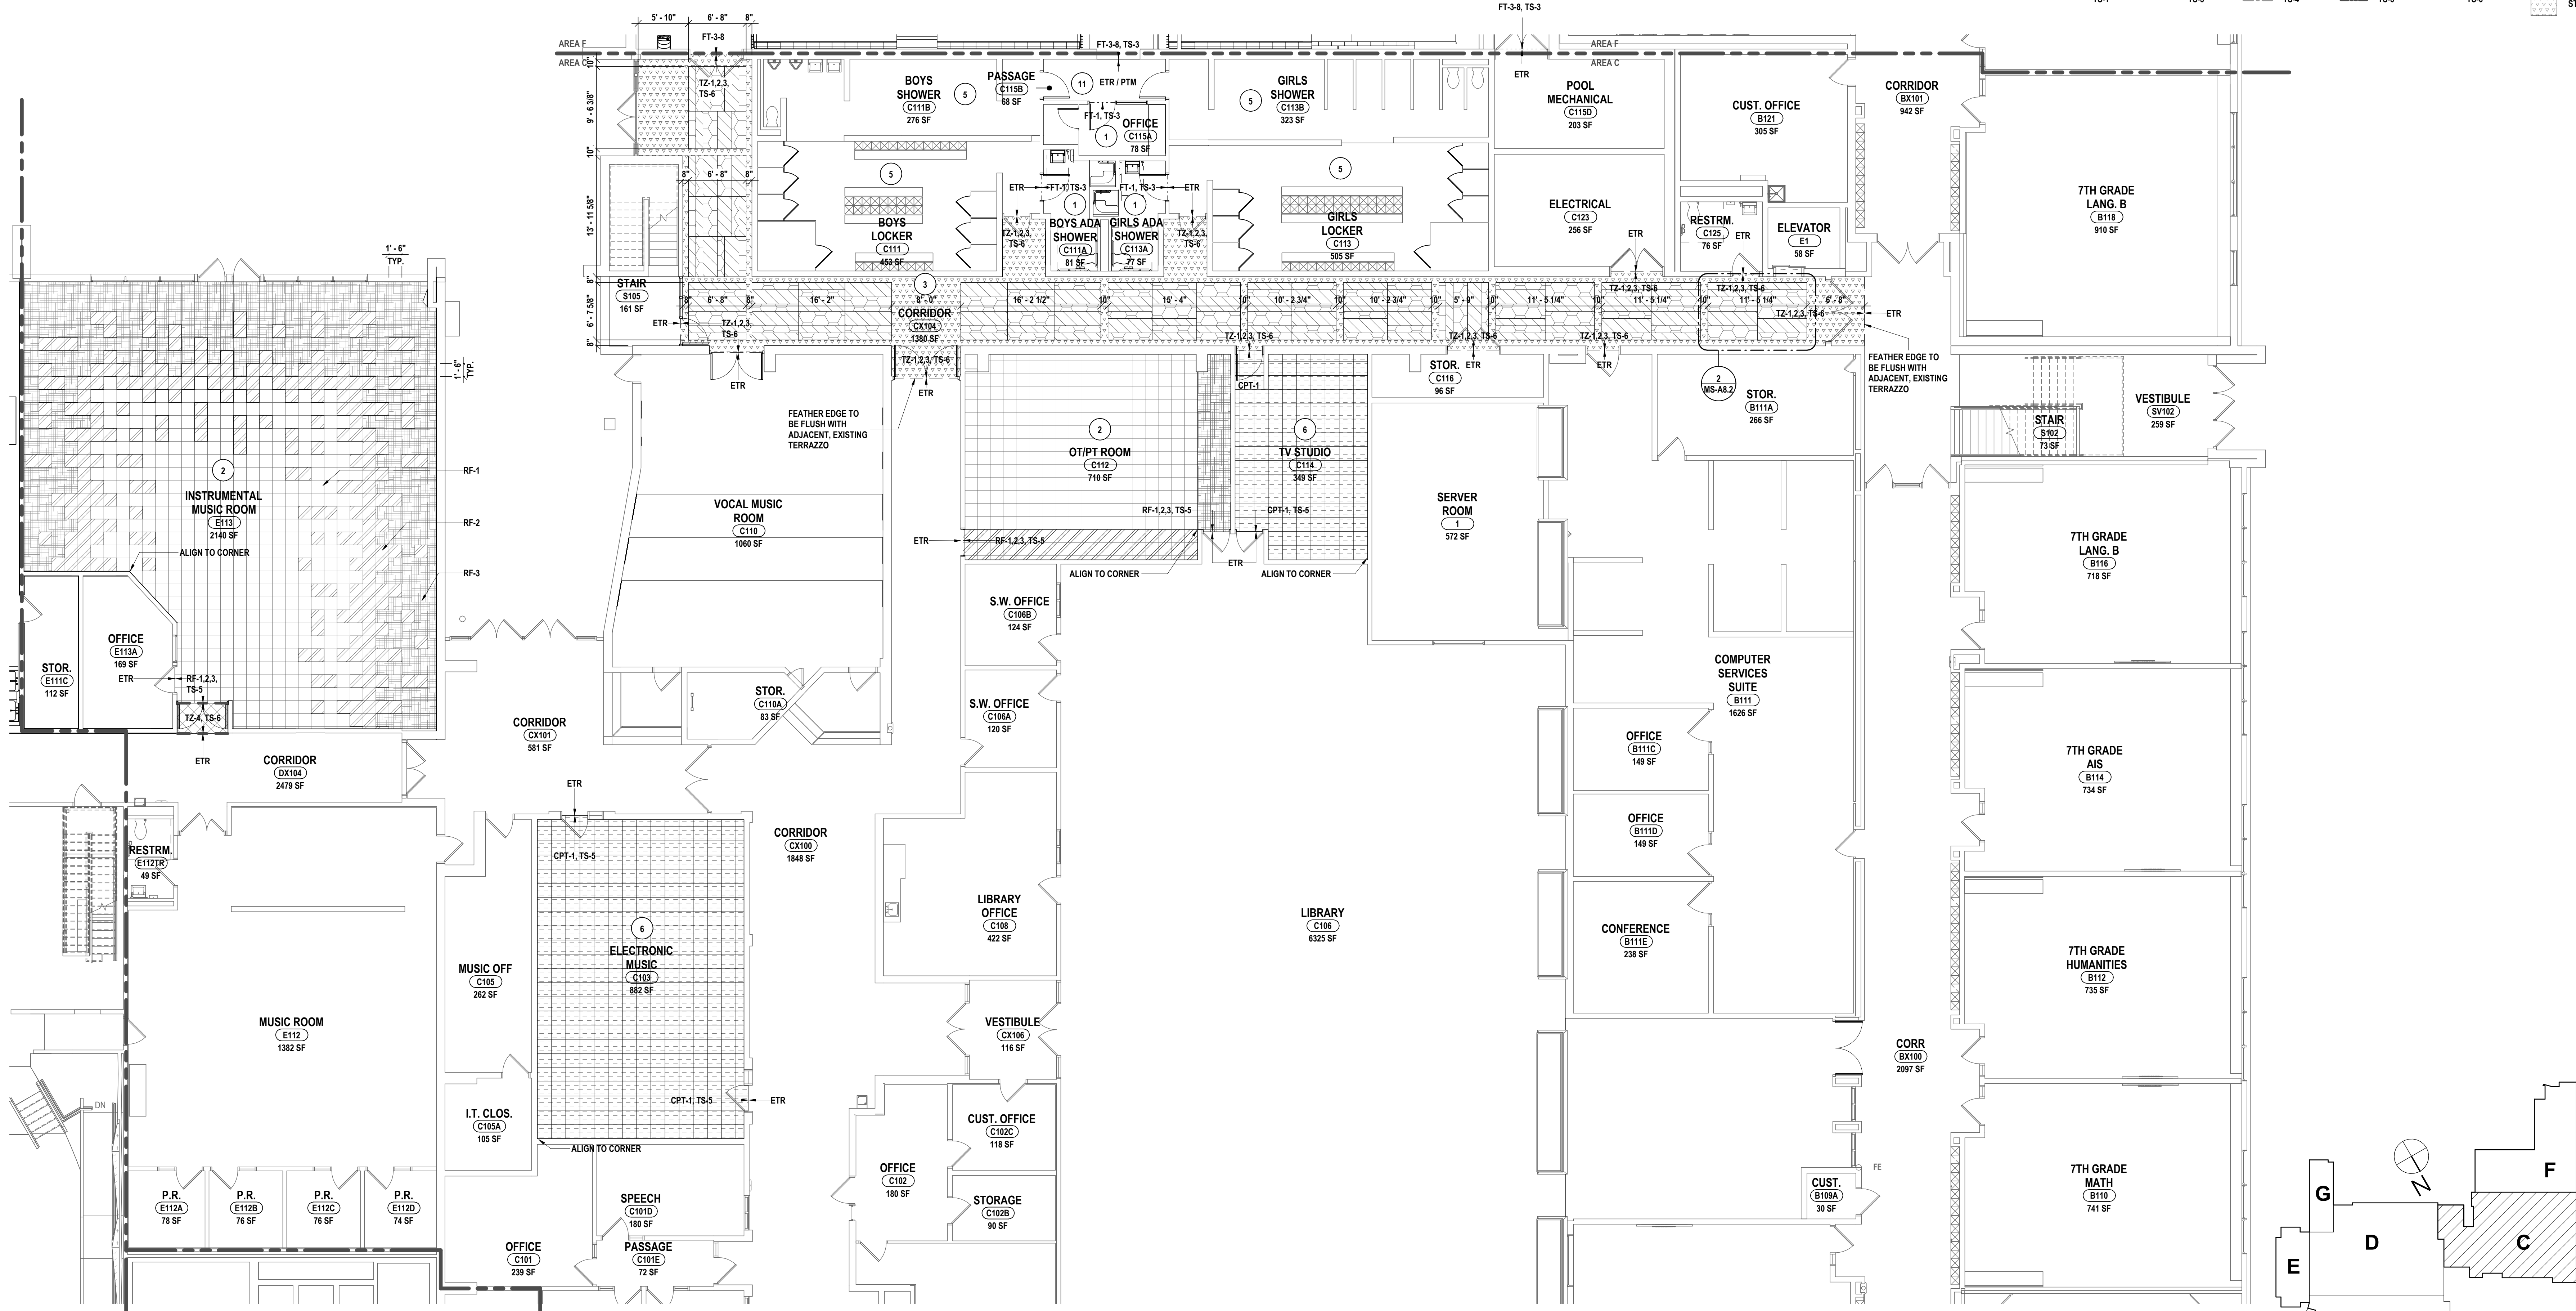

HUNT ENGINEERS ARCHITECTS | SURVEYORS

HORSEHEADS, NY 607-263-1000 ROCHESTER, NY 585-527-7549 TOWNAND, PA 670-265-4606 BINGHAMTON, NY 607-738-8881 ALBANY, NY 607-738-8881

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NY CERTIFICATE NO. 001620 PA CERTIFICATE NO. TSC220013/464-1

FIRST FLOOR FINISH PLAN - AREA C

2025 MIDDLE SCHOOL PHASE III ALTERATIONS PROJECT

CORNING-PAINTED POST ASD

35 VICTORY HIGHWAY, PAINTED POST, NY 14870

MS-A8.2

PROJECT NO: 2649-133




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- C FLOOR FINISHES TO EXTEND UNDERNEATH COUNTERTOPS WHERE FLOORING WOULD OTHERWISE BE EXPOSED.
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- E PREP FLOORS ACCORDING TO SPECIFICATION 09 05 61, "COMMON WORK RESULTS FOR FLOOR PREPARATION".
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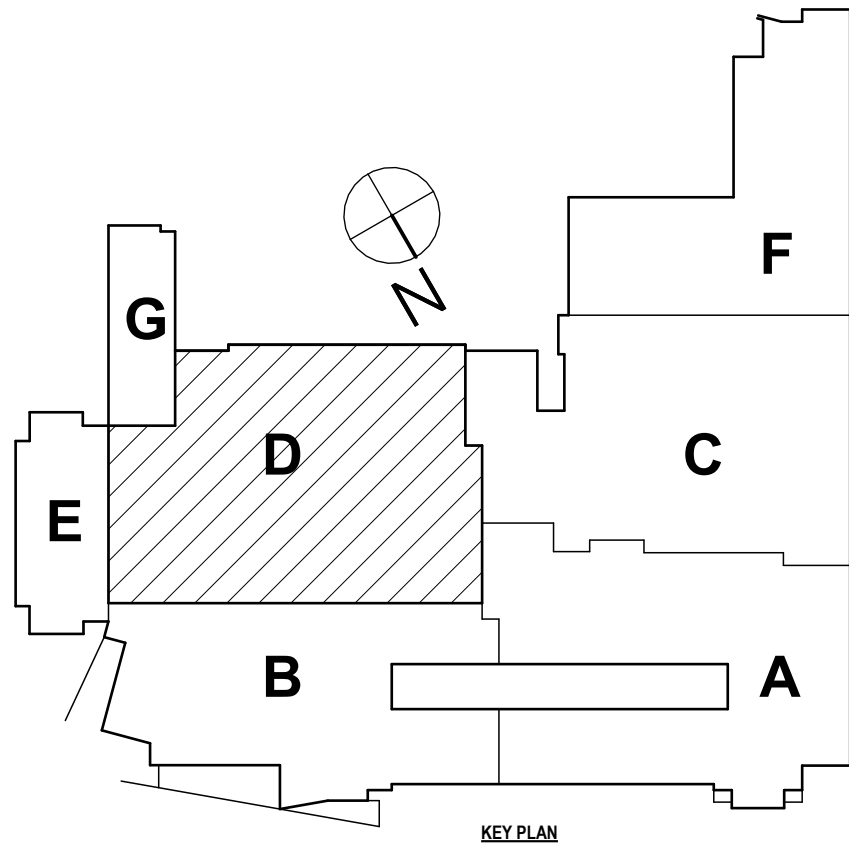
CONSTRUCTION NOTES - INTERIOR FLOOR FINISH

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- 2 FLOOR TO RECEIVE RUBBER FLOOR TILE, RF-1,2,3 IN GRID INSTALLATION PATTERN, PROVIDE RB-2 AS BASE.
- 3 FLOOR TO RECEIVE TERRAZZO, TZ-1,2,3, PROVIDE PRE-CAST TERRAZZO BASE, TZB-1, REFER TO 2/MS-A8.2 FOR INSTALLATION PATTERN & DETAILS.
- 4 KITCHEN & SERVERY FLOOR TO RECEIVE PORCELAIN FLOOR TILE, FT-2 IN GRID INSTALLATION PATTERN, PROVIDE CERAMIC BASE, CB-1, PROVIDE CONTROL JOINTS AND MOVEMENT JOINTS AS RECOMMENDED BY MANUFACTURER.
- 5 PATCH TO MATCH FLOORING WHERE NEW CONSTRUCTION AFFECTS EXISTING FLOOR FINISH CONDITIONS.
- 6 FLOOR TO RECEIVE CARPET TILE, CPT-1 IN MONOLITHIC INSTALLATION PATTERN, PROVIDE RB-2 AS BASE.
- 7 BASE BID: ETR.
- 8 ALTERNATE #2: GYM MEZZANINE FLOOR TO RECEIVE POLISHED CONCRETE TOPPER, CF-1, PROVIDE BASE AS SCHEDULED.
- 9 POOL DECK TO RECEIVE PORCELAIN MOSAIC TILE, FT-3,4,5,6,7,8, PROVIDE CB-3 AS BASE.
- 10 POOL RAMP TO RECEIVE PORCELAIN MOSAIC TILE, FT-4,7.
- 11 FLOOR TO RECEIVE POLISHED CONCRETE TOPPER, CF-1, PROVIDE BASE AS SCHEDULED.
- 12 PATCH TO MATCH FLOORING WHERE NEW CONSTRUCTION AFFECTS EXISTING FLOOR FINISH CONDITIONS, PROVIDE CERAMIC BASE, CB-3 AS SANITARY BASE.
- 13 CORRIDOR ALCOVES TO RECEIVE EPoxy TERRAZZO FLOORING, REFER TO FINISH KEY FOR COLORS.
- 14 POOL TO RECEIVE MARCITE FINISH, MC-1, LANE AND WALL MARKERS TO RECEIVE FT-8, REFER TO MS-A8.4 FOR LANE MARKER LAYOUT AND DETAILS.
- 15 BASE BID: ETR.
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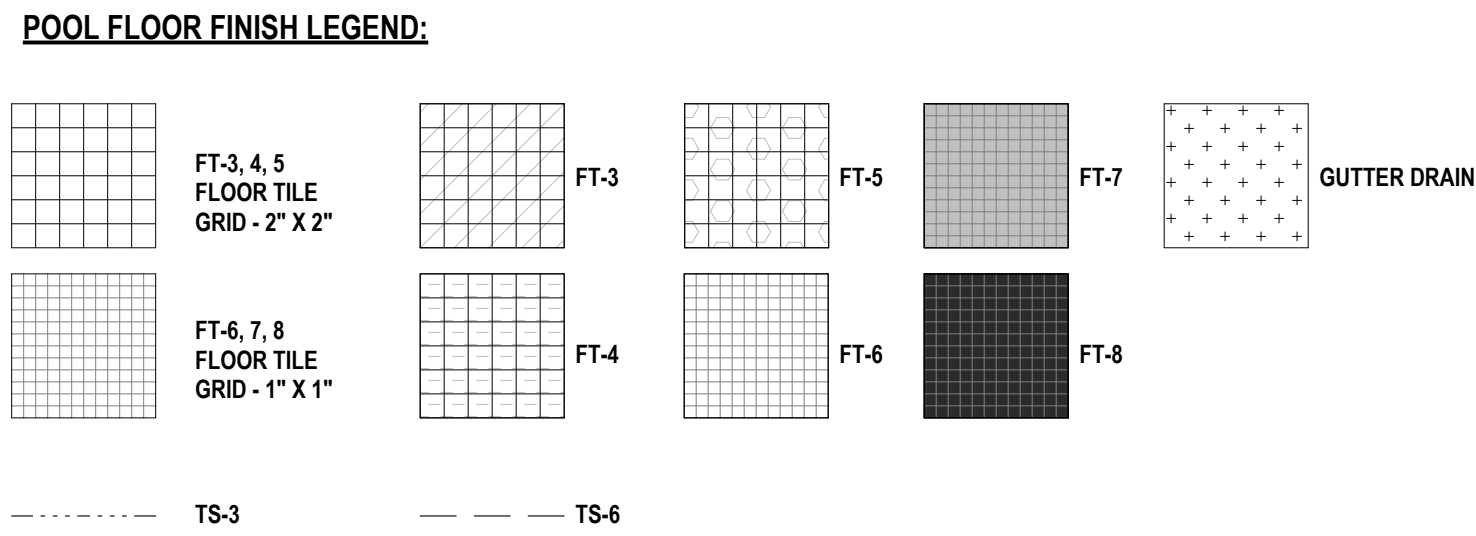
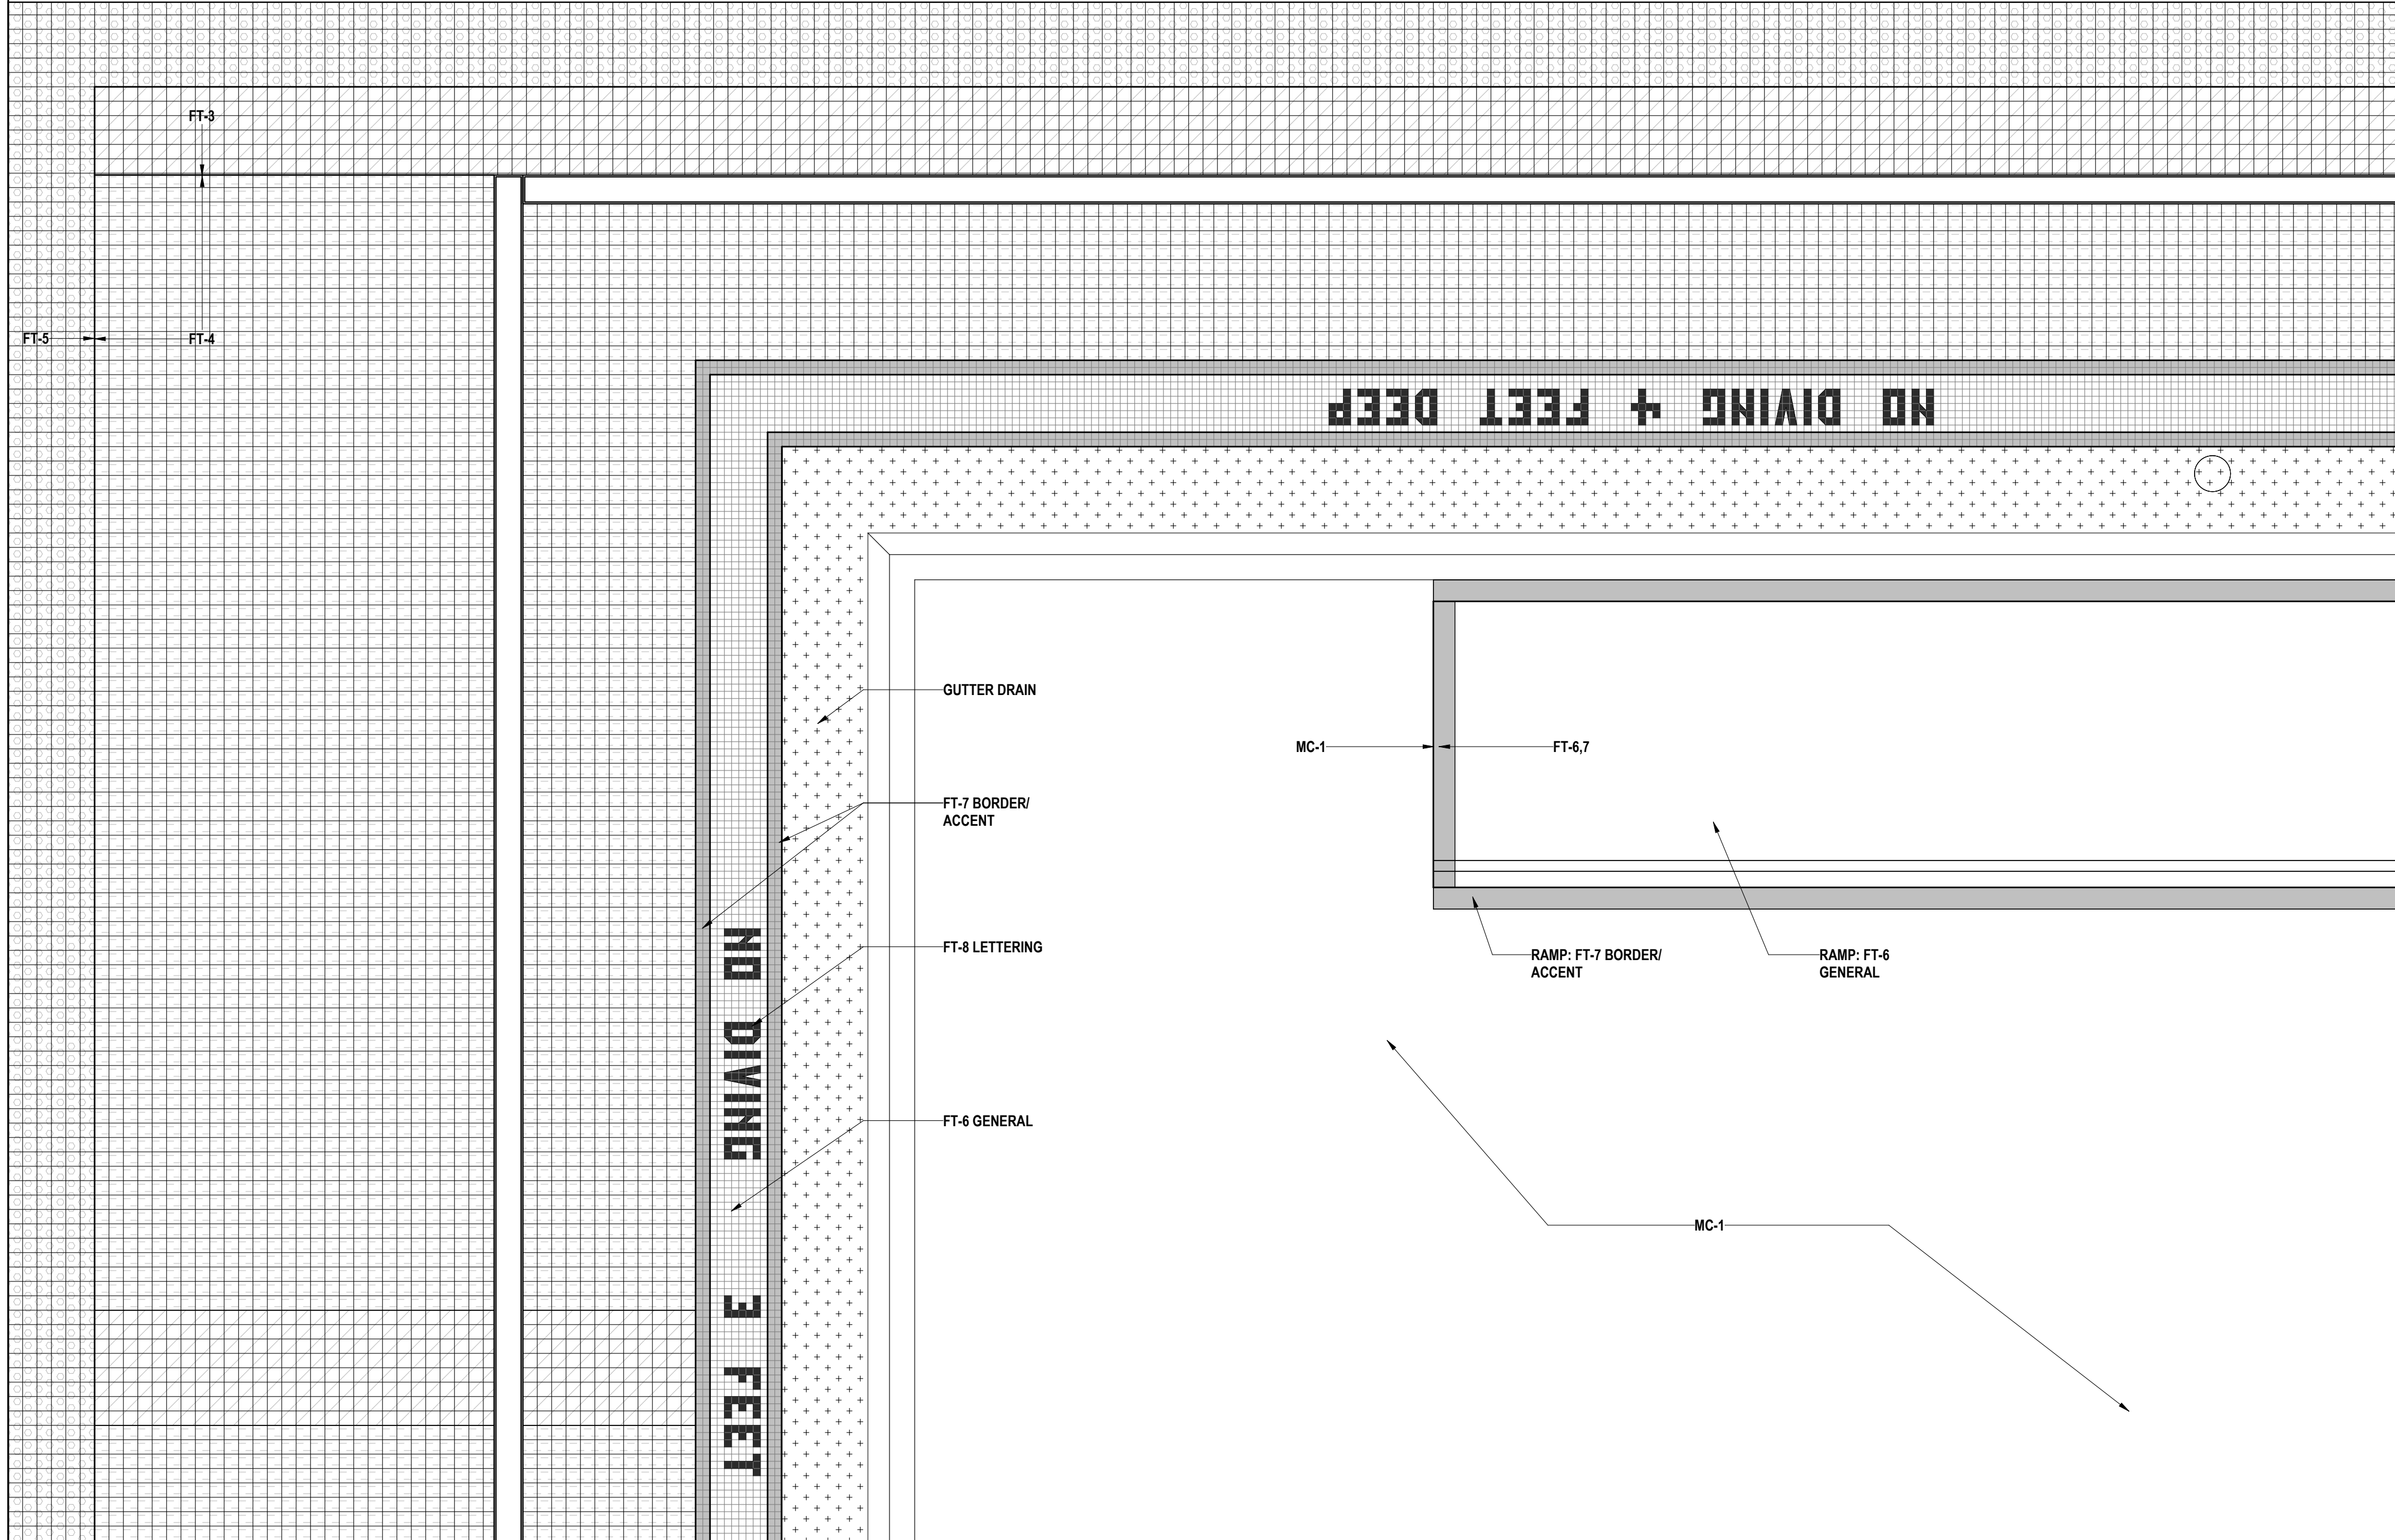
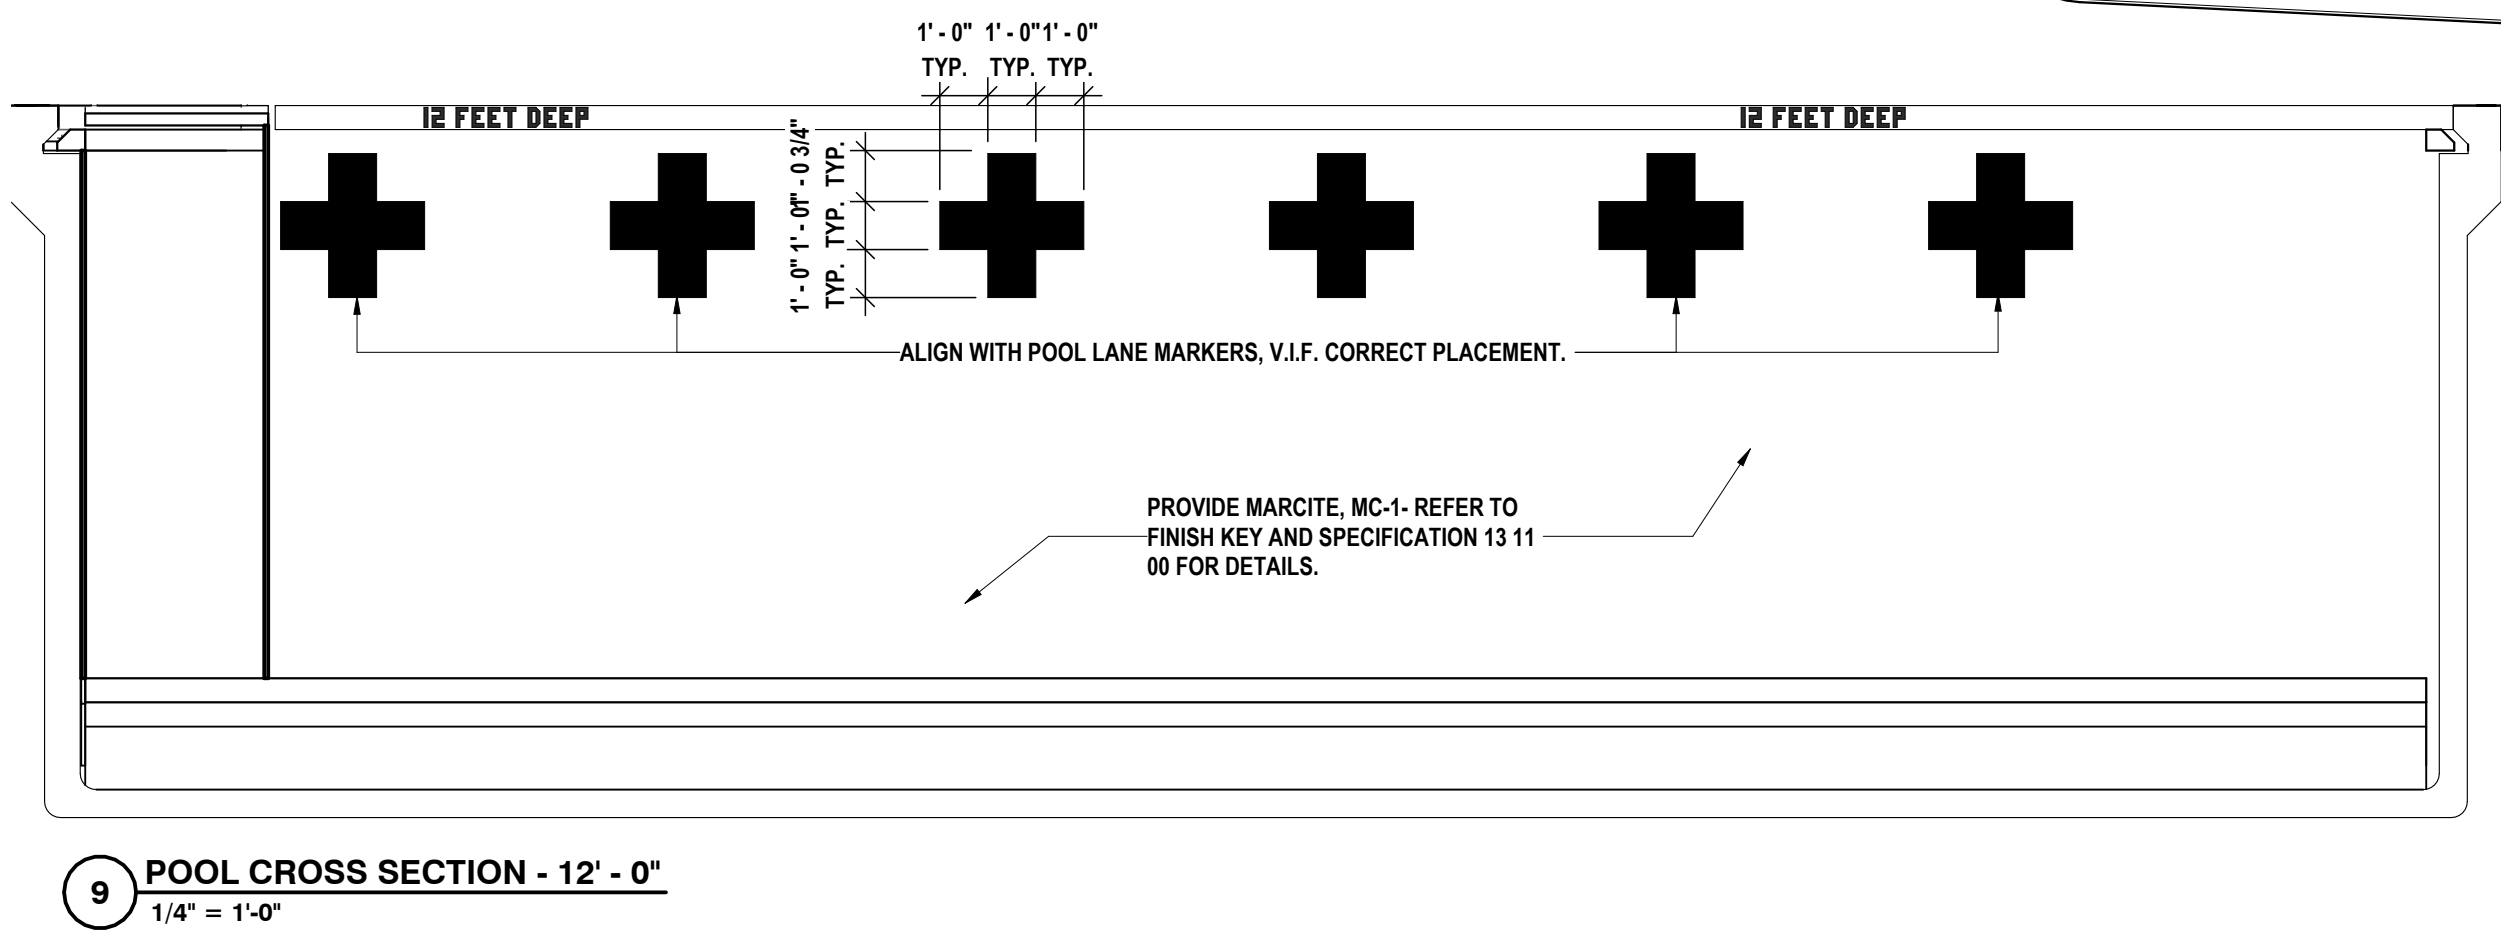
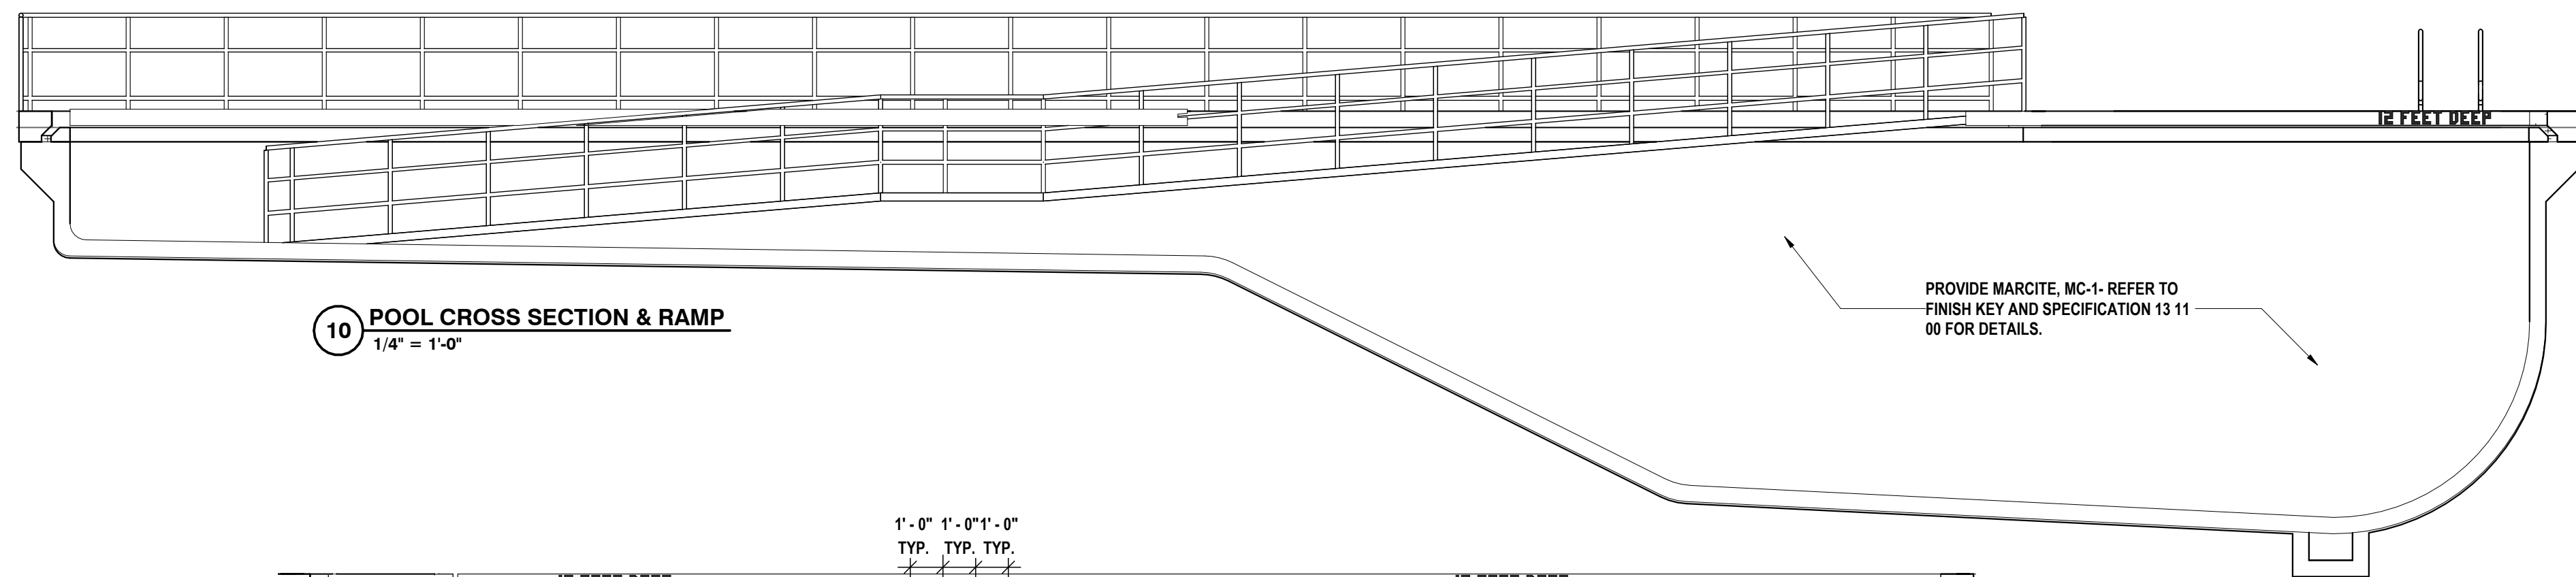
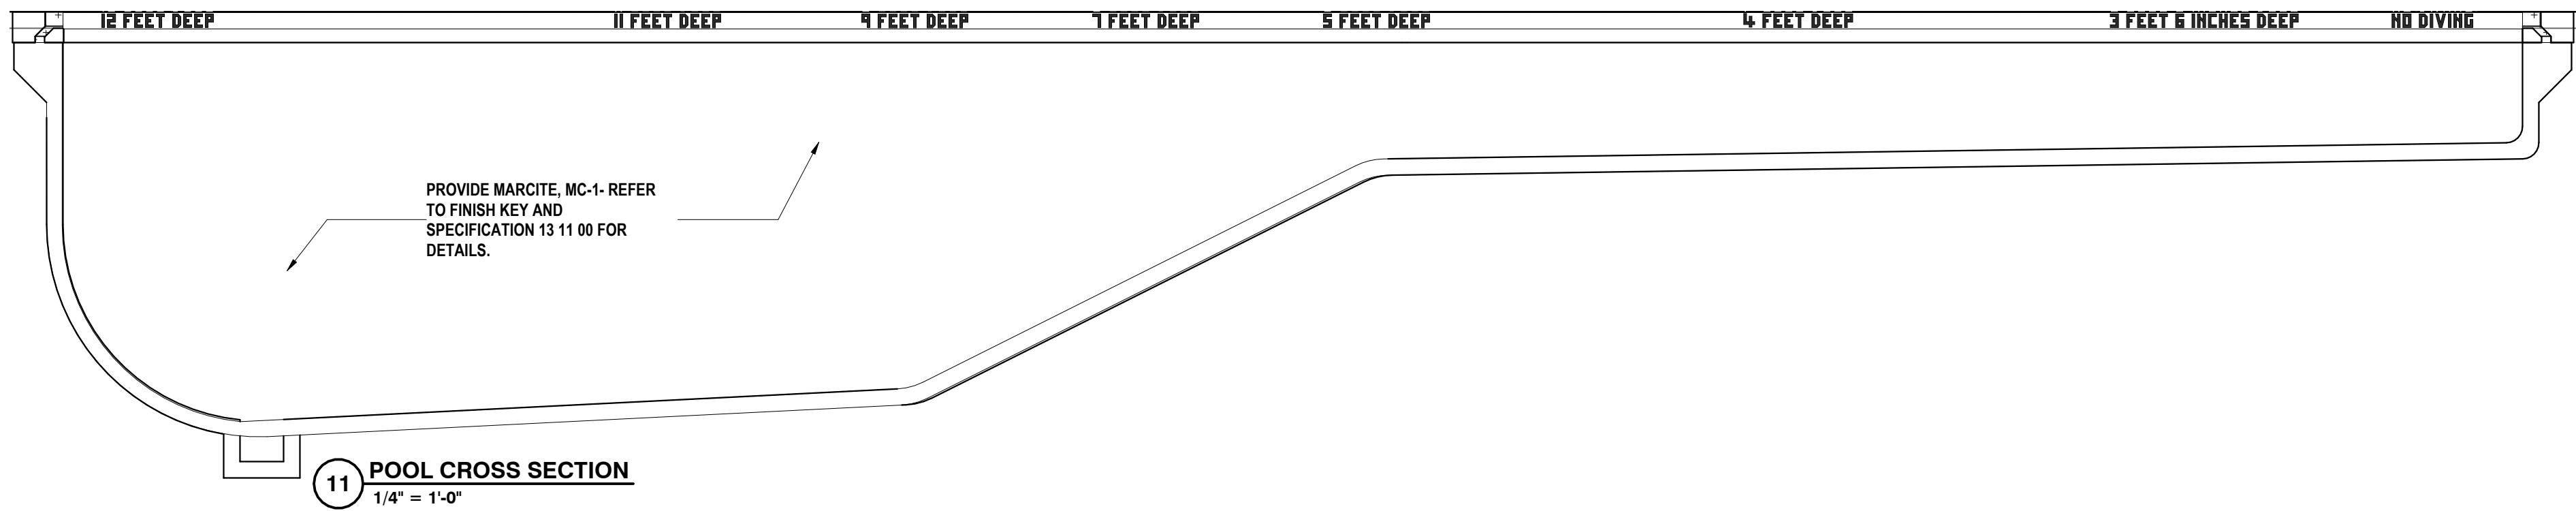
FLOOR FINISH LEGEND:									
RF-1	RF-3	FT-1	TZ-1	TZ-3	CPT-1				
RF-2	RF GRID	FT-1,3,4 GRID	TZ-2	TZ-4	CF-1				
TS-1	TS-3	TS-4	TS-5	TS-6	STN-2				



2 GYM MEZZANINE FLOOR FINISH PLAN  
1/8" = 1'-0"

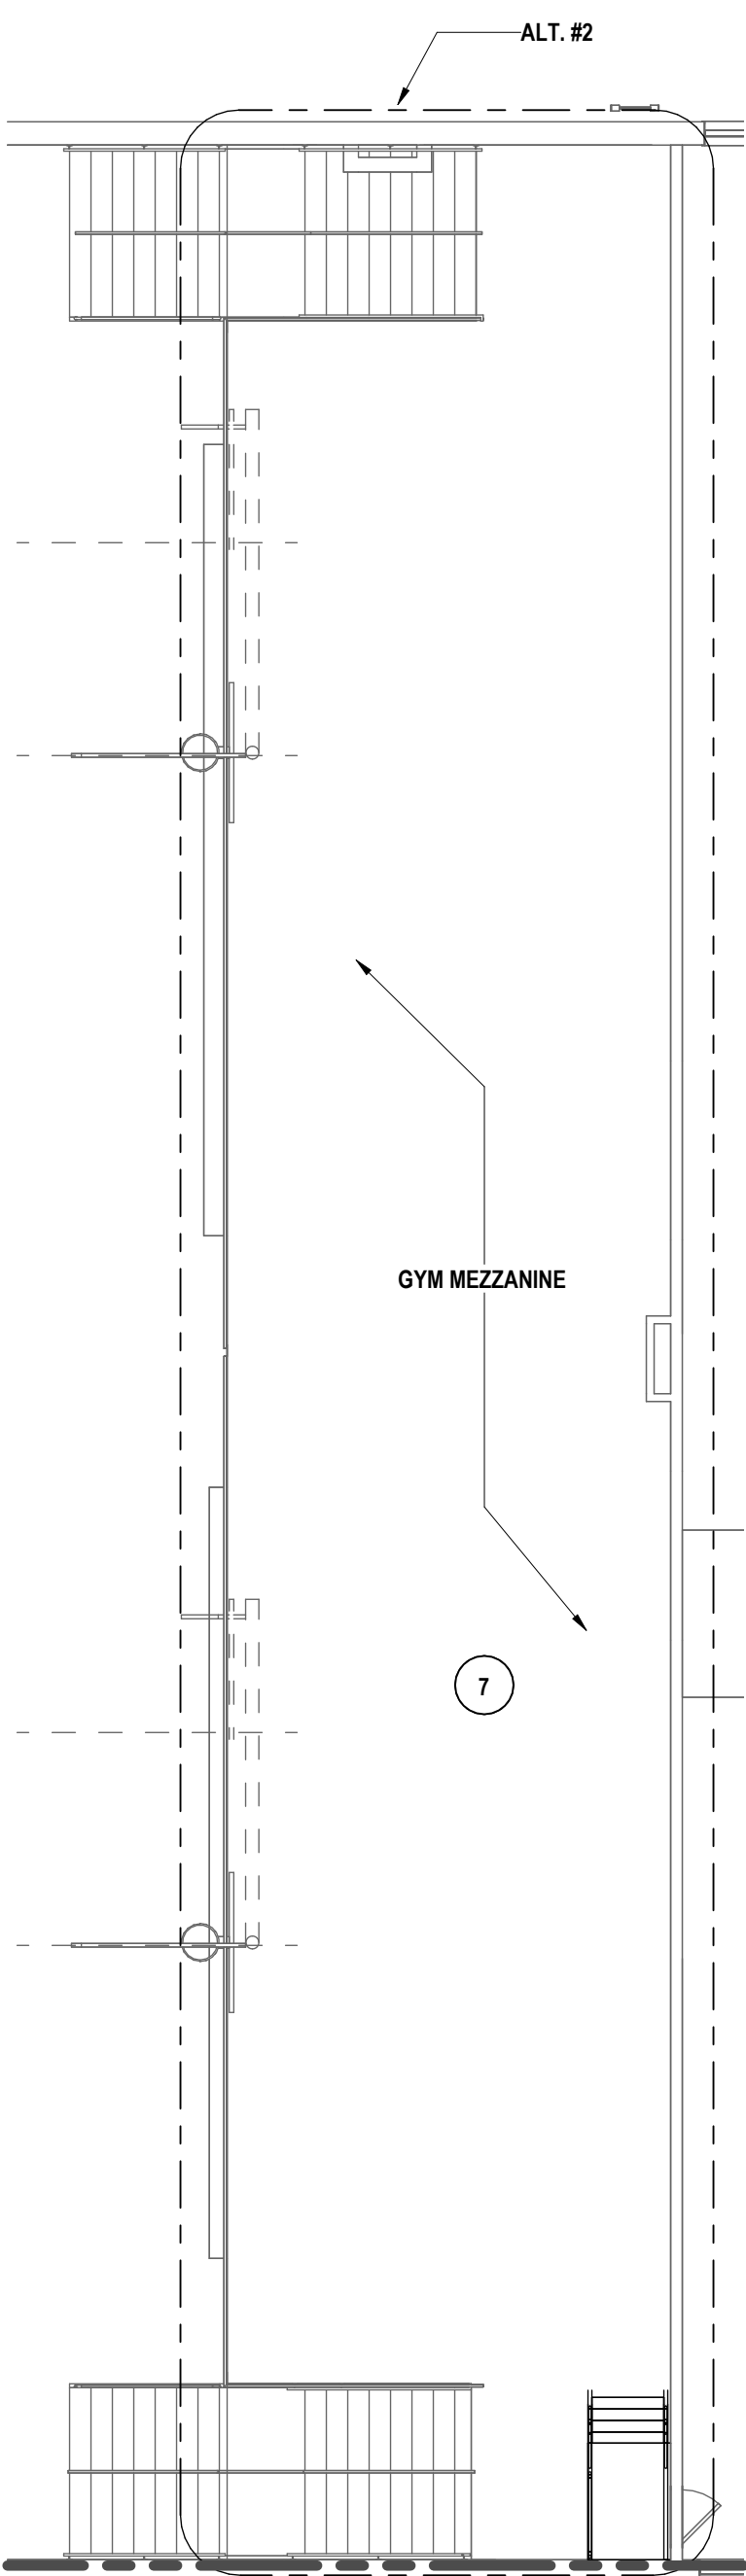


1 FIRST FLOOR FINISH PLAN - AREA D  
1/8" = 1'-0"




- GENERAL NOTES - INTERIOR FLOOR FINISH:**
- ALL FLOOR FINISHES SHALL BE INSTALLED ABUTTING NEW BUILT-IN CASEWORK, EVEN WHEN NOT SHOWN ON FLOOR FINISH PLANS, UNLESS OTHERWISE NOTED.
  - ALL FLOOR FINISHES TO TRANSITION AT CENTERLINE OF DOOR JAM UNLESS OTHERWISE NOTED ON FLOOR FINISH PLANS.
  - FLOOR FINISHES TO EXTEND UNDERNEATH COUNTERTOPS WHERE FLOORING WOULD OTHERWISE BE EXPOSED. REFER TO FINISH KEY AND ROOM FINISH SCHEDULE FOR ALL FINISHES NOT INDICATED ON FLOOR FINISH PLANS.
  - PREP FLOORS ACCORDING TO SPECIFICATION 09 05 61, "COMMON WORK RESULTS FOR FLOOR PREPARATION".
  - PROVIDE ADA COMPLIANT TRANSITION STRIP WHEN ABUTTING FLOOR FINISHES DIFFER IN THICKNESS OR MATERIAL. REFER TO FINISH KEY AND ROOM FINISH SCHEDULE FOR DETAILS.


- CONSTRUCTION NOTES - INTERIOR FLOOR FINISH**
- FLOOR TO RECEIVE PORCELAIN MOSAIC FLOOR TILE, FT-1. PROVIDE PORCELAIN WALL BASE CB-2.
  - FLOOR TO RECEIVE RUBBER FLOOR TILE, RF-1,2,3 IN GRID INSTALLATION PATTERN. PROVIDE RB-2 AS BASE.
  - FLOOR TO RECEIVE TERRAZZO, TZ-1,2,3. PROVIDE PRE-CAST TERRAZZO BASE, TZB-1. REFER TO 2MS-A8.2 FOR INSTALLATION PATTERN & DETAILS.
  - KITCHEN & SERVERY FLOOR TO RECEIVE PORCELAIN FLOOR TILE, FT-2 IN GRID INSTALLATION PATTERN. PROVIDE CERAMIC BASE, CB-1. PROVIDE CONTROL JOINTS AND MOVEMENT JOINTS AS RECOMMENDED BY MANUFACTURER.
  - PATCH TO MATCH FLOORING WHERE NEW CONSTRUCTION AFFECTS EXISTING FLOOR FINISH CONDITIONS.
  - FLOOR TO RECEIVE CARPET TILE, CPT-1 IN MONOLITHIC INSTALLATION PATTERN. PROVIDE RB-2 AS BASE.
  - BASE BID: ETR.
  - ALTERNATE #2: GYM MEZZANINE FLOOR TO RECEIVE POLISHED CONCRETE TOPPER, CF-1. PROVIDE BASE AS SCHEDULED.
  - POOL DECK TO RECEIVE PORCELAIN MOSAIC TILE, FT-3,4,5,6,7,8. PROVIDE CB-3 AS BASE.
  - POOL RAMP TO RECEIVE PORCELAIN MOSAIC TILE, FT-3,4,5,6,7,8. PROVIDE CB-3 AS BASE.
  - FLOOR TO RECEIVE POLISHED CONCRETE TOPPER, CF-1. PROVIDE BASE AS SCHEDULED.
  - PATCH TO MATCH FLOORING WHERE NEW CONSTRUCTION AFFECTS EXISTING FLOOR FINISH CONDITIONS. PROVIDE CERAMIC BASE, CB-3 AS SANITARY BASE.
  - CORRIDOR ALCOVES TO RECEIVE EPOXY TERRAZZO FLOORING. REFER TO FINISH KEY FOR COLORS.
  - POOL TO RECEIVE MARCITE FINISH, MC-1. LANE AND WALL MARKERS TO RECEIVE FT-8. REFER TO MS-A8.4 FOR LANE MARKER LAYOUT AND DETAILS.
  - BASE BID: ETR.
  - ALTERNATE #2: REFINISH GYM FLOORING UNDERNEATH BLEACHERS WITH STN-2.

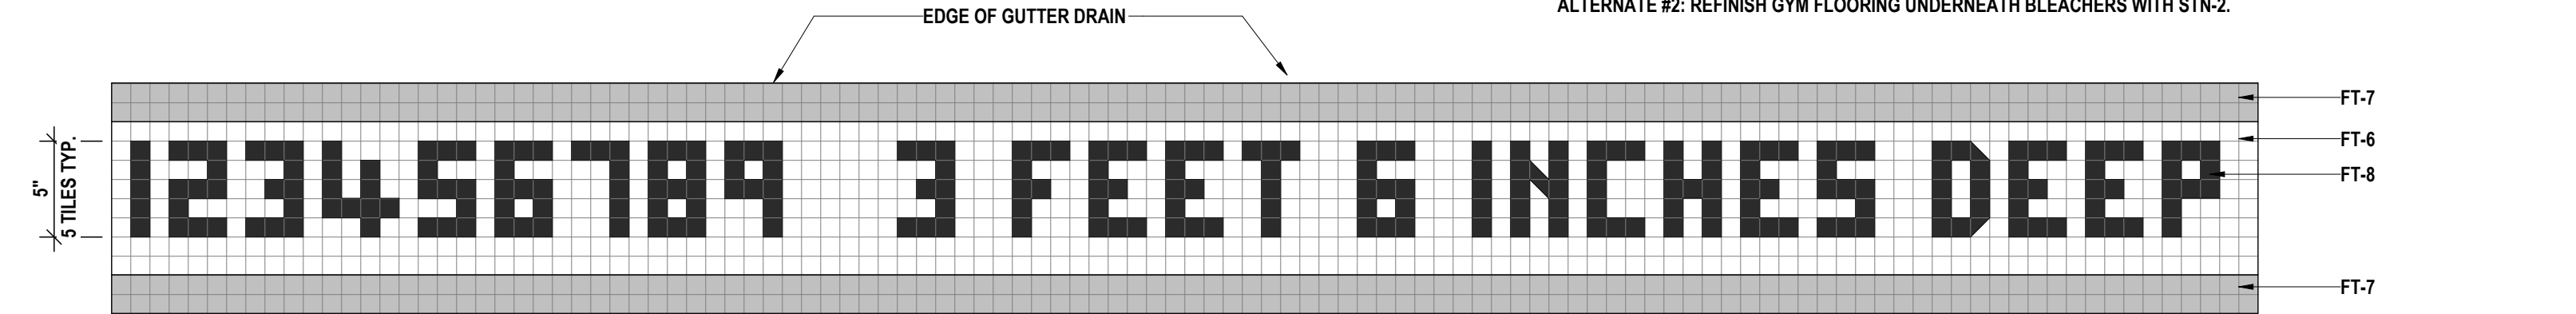

**3 TYP. DECK BORDER AND TILE TEXT DETAIL**  
1 1/2" = 1'-0"

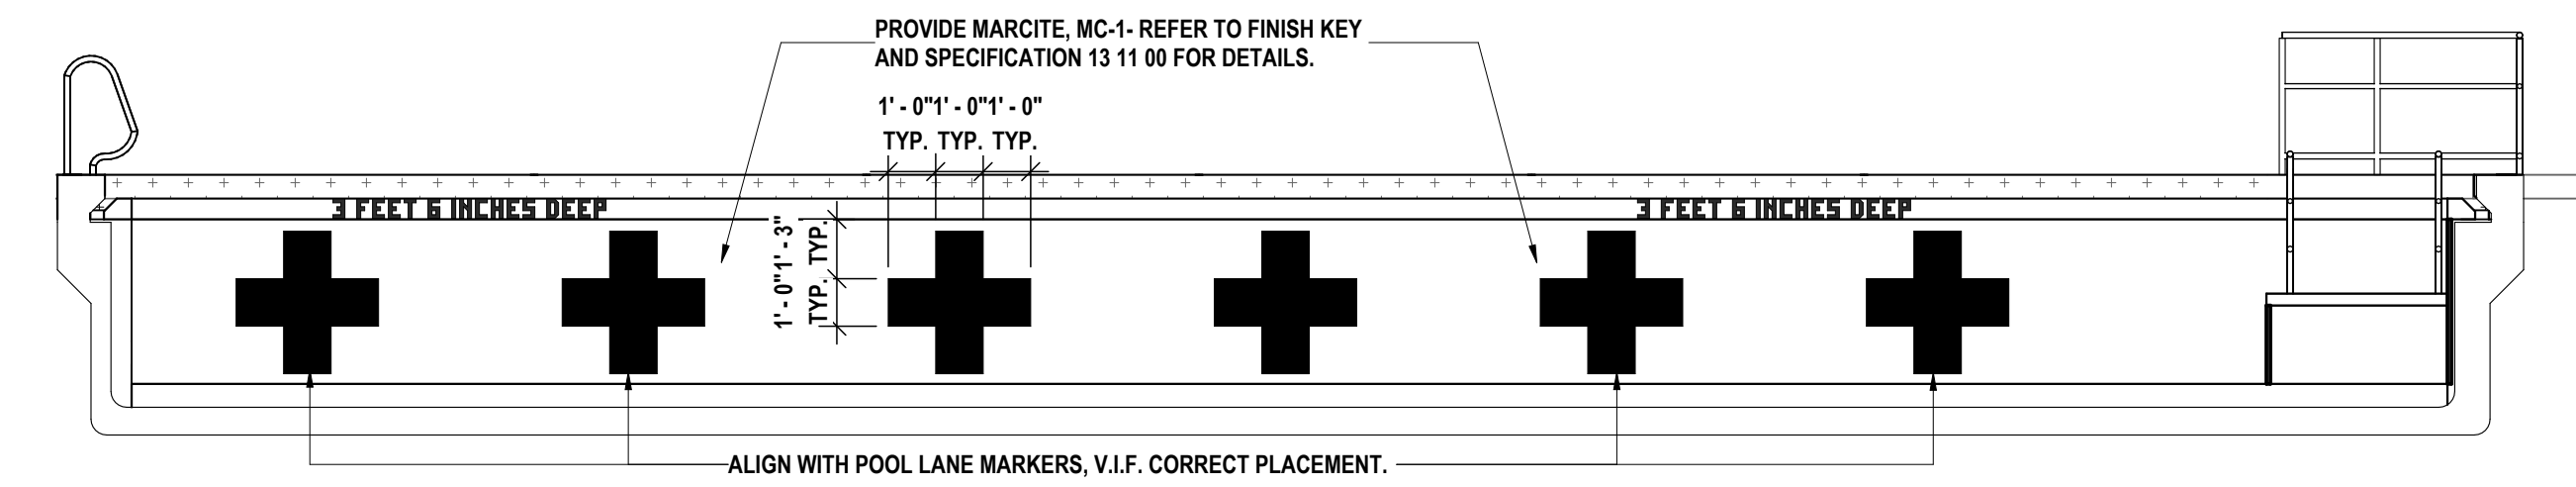


**8 POOL CROSS SECTION - 3' - 6"**  
1/4" = 1'-0"

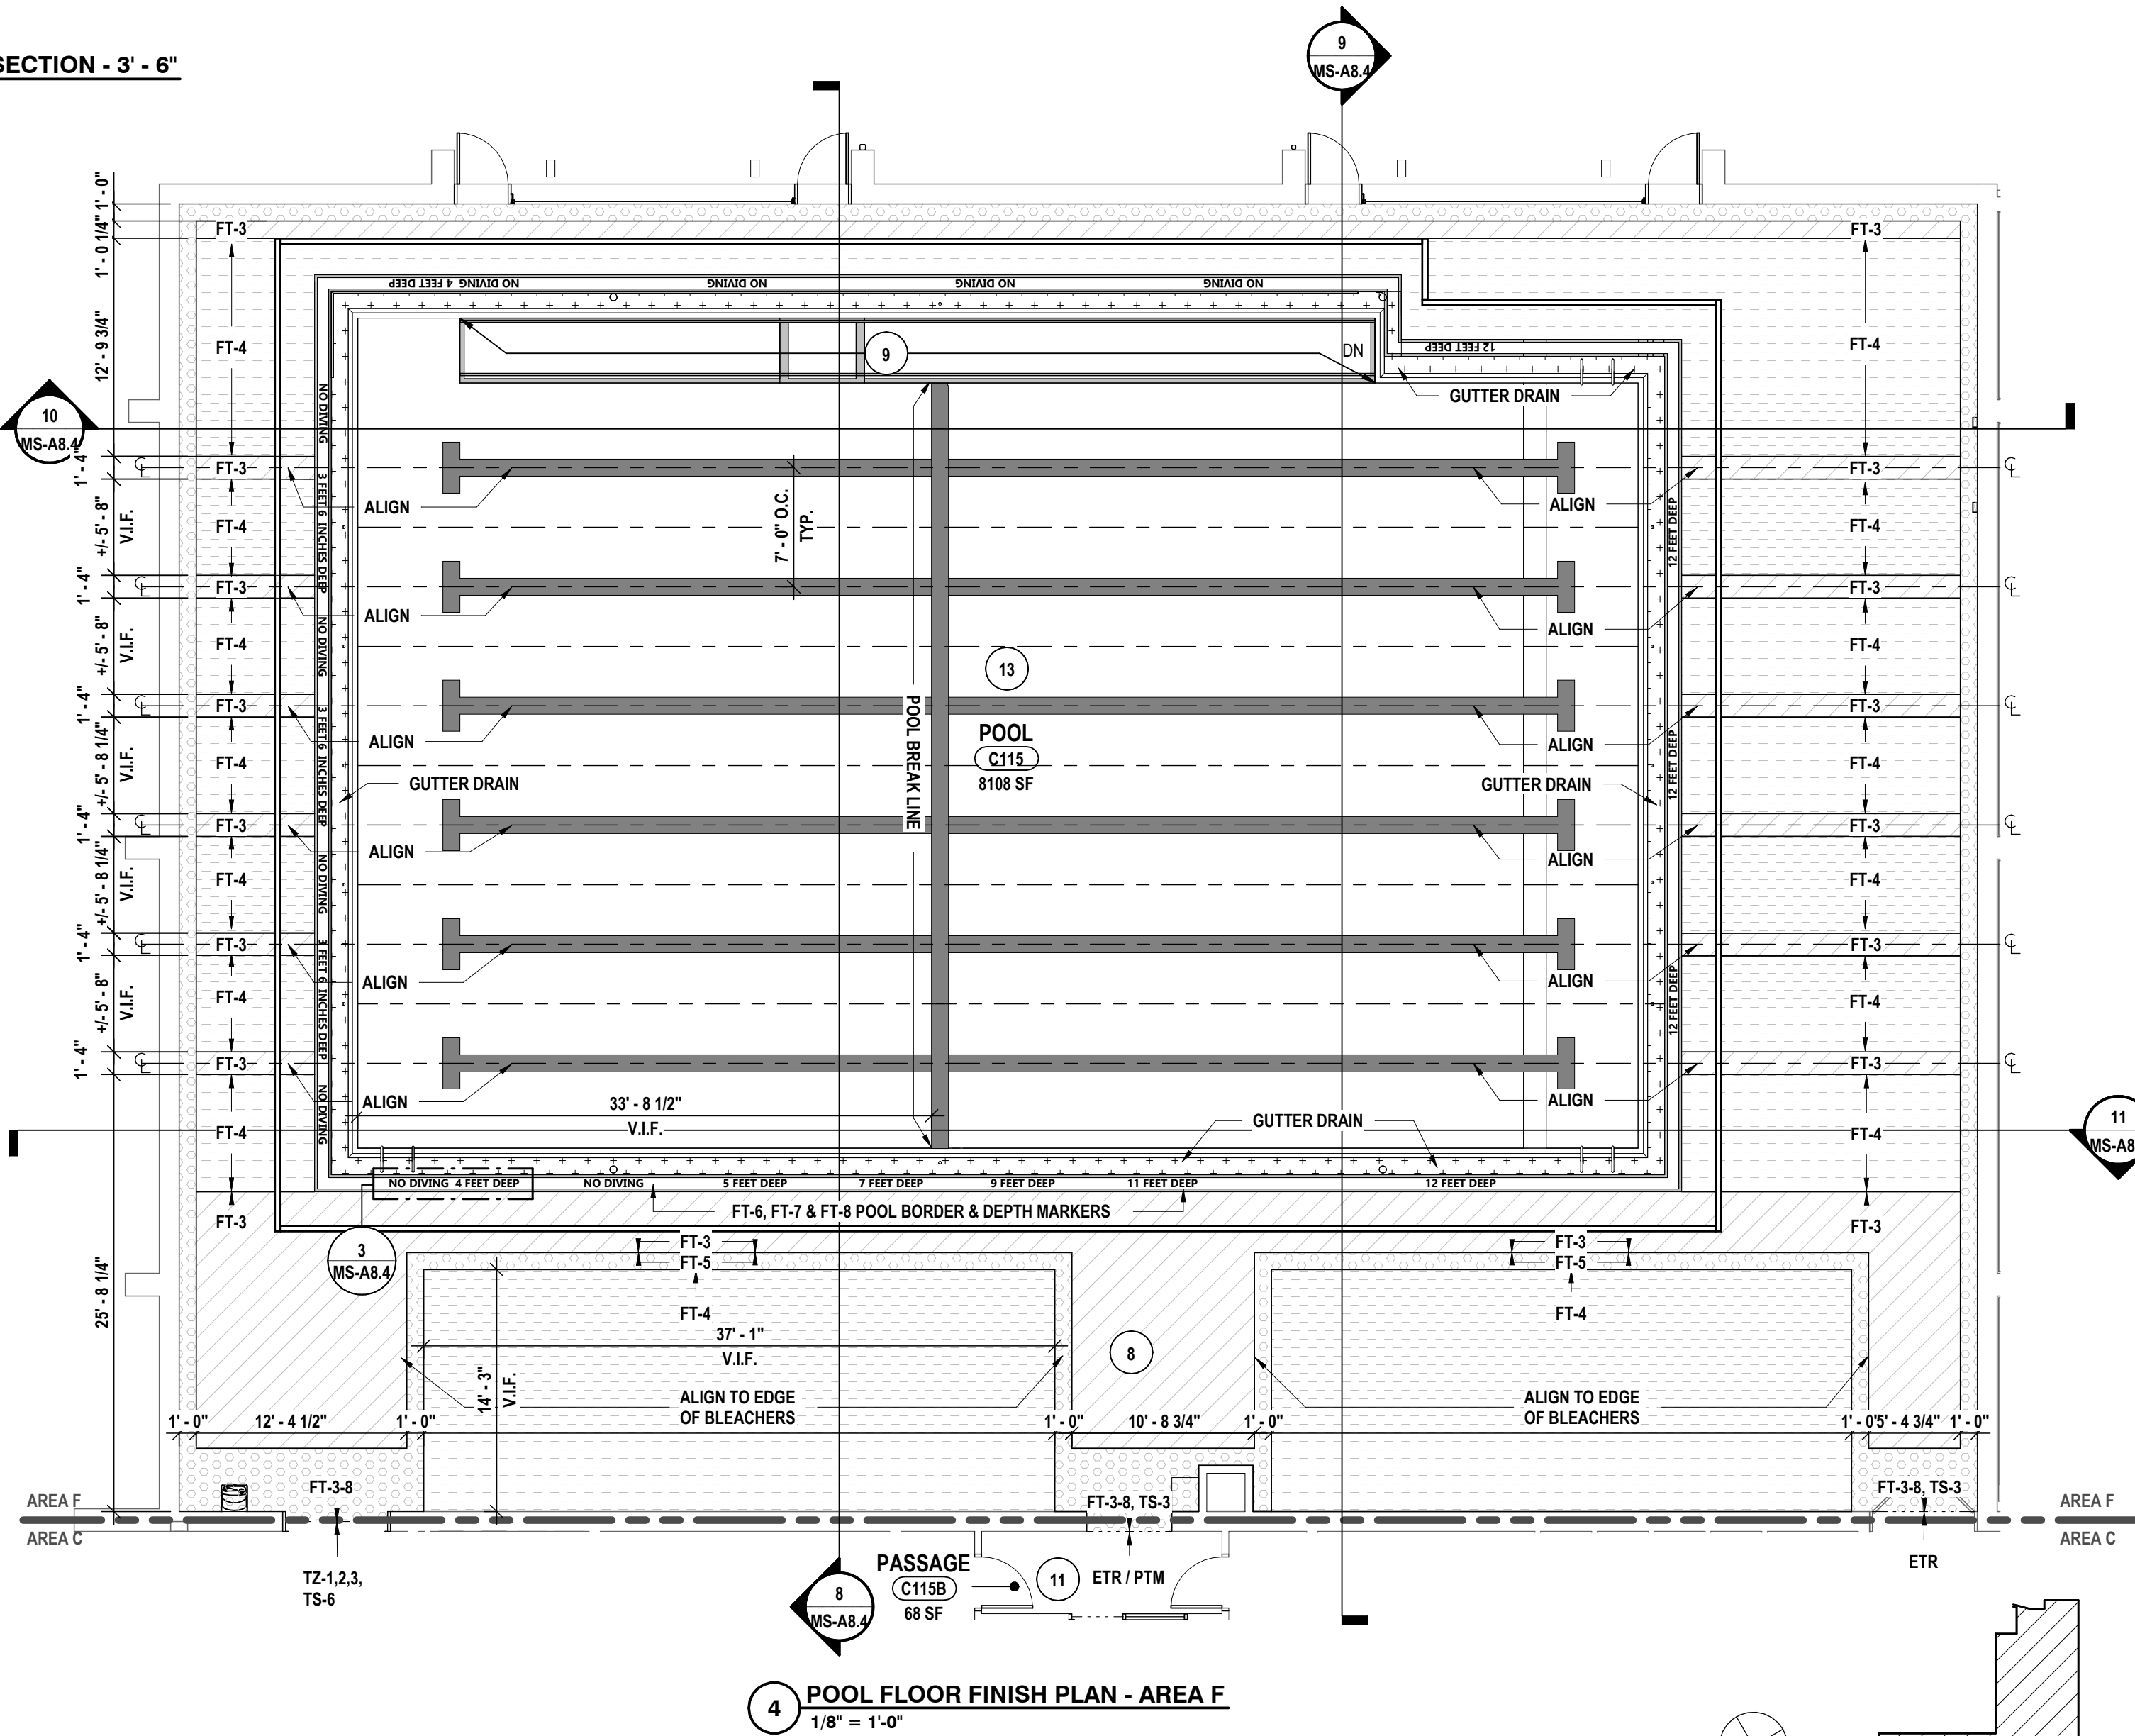


\*\*\*NOTES TO CONTRACTORS\*\*\*

COORDINATE LANE MARKER ALIGNMENT AND POOL DECK FT-3 ACCENT BANDS WITH STARTING BLOCK LOCATIONS.

ALL POOL DEPTH DIMENSIONS TO BE V.I.F. WHEN THE POOL IS EMPTY. POOL DEPTH MARKER LOCATIONS TO BE ADJUSTED TO ALIGN WITH THE CORRECT DEPTH.

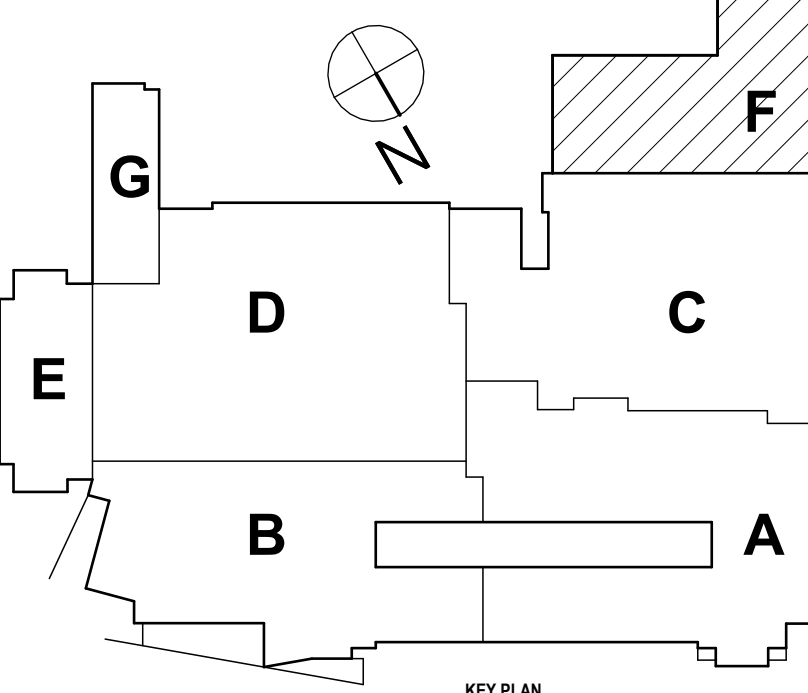



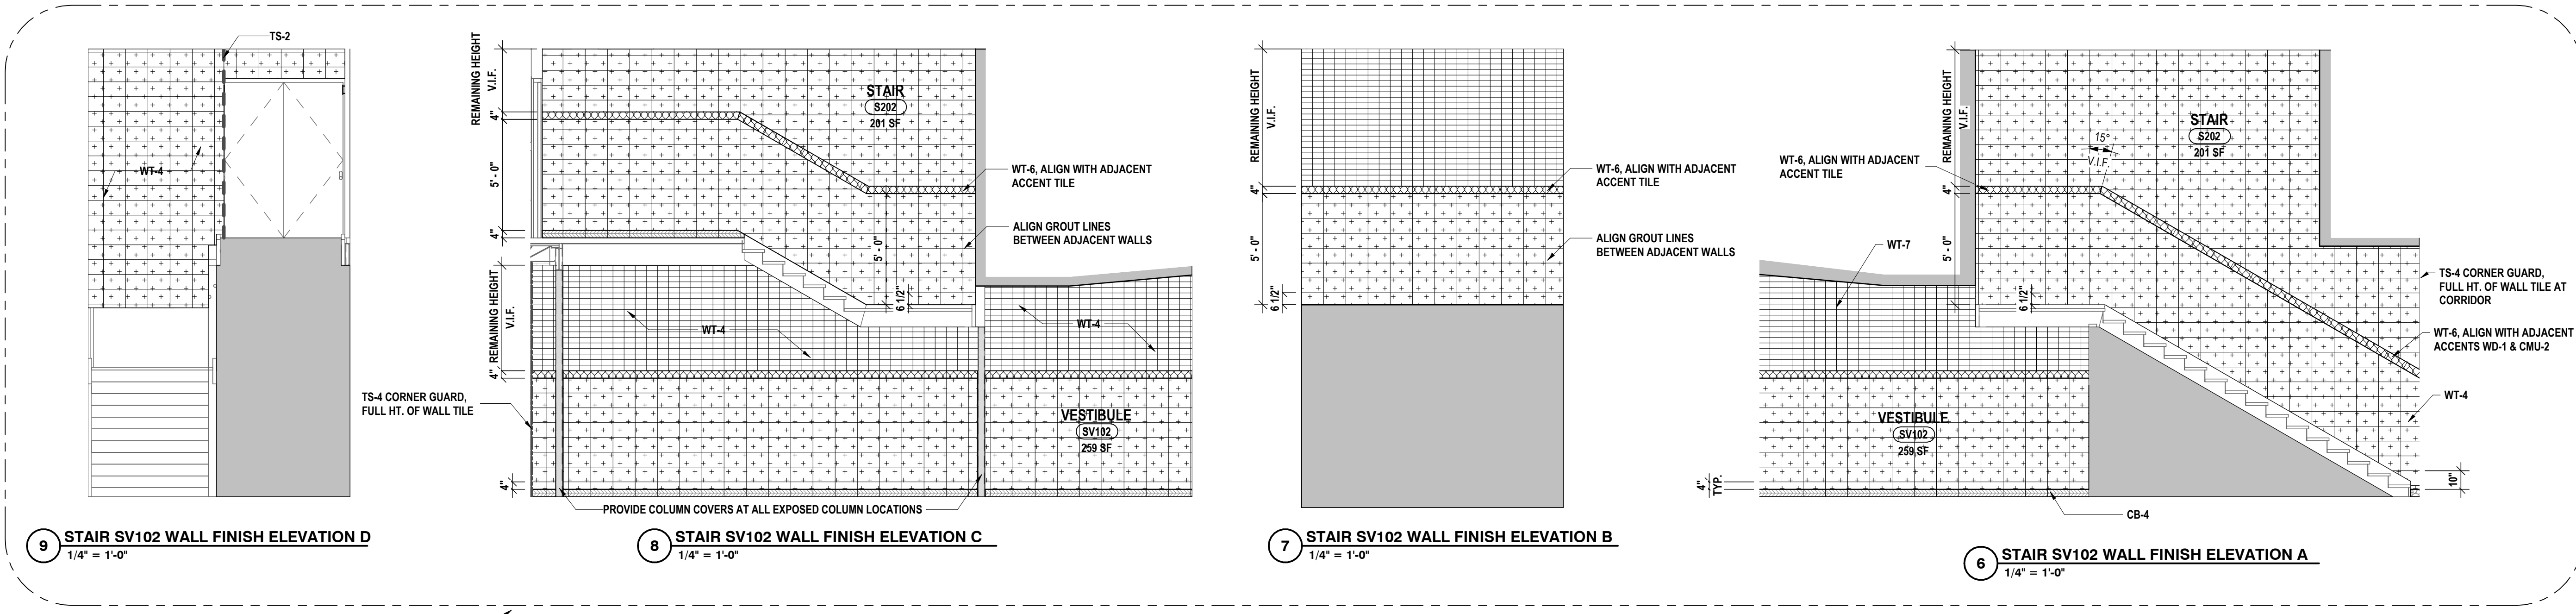


GENERAL NOTES - INTERIOR WALL FINISH:

- A DRAWINGS REPRESENT LOCATIONS OF NEW WALL FINISHES AND INDICATE PATTERNS FOR INSTALLATION. FOR A COMPLETE LIST OF FINISHES, REFER TO THE FINISH KEY AND ROOM FINISH SCHEDULE.
- B REFER TO A2 DRAWINGS FOR CEILING HEIGHTS. VERIFY CEILING HEIGHTS IN THE FIELD PRIOR TO START OF WORK.
- C PAINT ALL UNFINISHED EXPOSED HVAC EQUIPMENT INCLUDING DUCTWORK, AIR DIFFUSERS AND RETURNS AT CEILING PLANE TO MATCH ADJACENT CEILING FINISH/COLOR. ARCHITECT TO SELECT COLOR.
- D REFER TO WALL FINISH LEGEND AND ELEVATIONS FOR FINISHES THAT REQUIRE ADDITIONAL INFORMATION REGARDING EXTENTS OR INSTALLATION PATTERNING.
- E PAINT ALL NEW INTERIOR WINDOW TRIM AND DOOR FRAMES. REFER TO FINISH KEY FOR COLORS.

# CONSTRUCTION NOTES - INTERIOR WALL FINISH:

- 1 ALL WALLS TO RECEIVE PAINT, PNT-1 UNLESS NOTED OTHERWISE.
- 2 WALLS TO RECEIVE WALL TILE, WT-1 IN BRICK INSTALLATION PATTERN AT WAINSCOT HEIGHT OF 5'-4". PROVIDE CT-2 AS BULLNOSE ABOVE. PROVIDE CB-2 AS BASE. PAINT WALL ABOVE PNT-1. REFER TO 3MS-A8.5 FOR DETAILS.
- 3 CORRIDOR WALLS TO RECEIVE FULL HEIGHT WALL TILE, WT-3,4,5 IN BRICK INSTALLATION PATTERN. PROVIDE BASE AS SCHEDULED. REFER TO 3MS-A8.5 FOR DETAILS.
- 4 PAINT WALLS PNT-2.
- 5 WALL TO RECEIVE WALL PADS, WP-1,2. REFER TO 6,7MS-A8.8 FOR DETAILS.
- 6 PATCH TO MATCH ADJACENT WALL FINISHES WHERE NEW WORK AFFECTS EXISTING WALL FINISH CONDITIONS.
- 7 WALLS TO RECEIVE ACOUSTIC WALL PANELS, AWP-1,2,3,4,5. REFER TO 2,3,4,5,6MS-A8.6 FOR INSTALLATION DETAILS.
- 8 PROVIDE WINDOW SHADES, WS-1 AT WINDOWS. VERIFY SIZES & QUANTITY IN FIELD.
- 9 WALLS TO RECEIVE PORCELAIN STONE TILES, WT-6,7,8,9, AND CERAMIC TRIM ABOVE, CT-1. PAINT WALLS ABOVE PNT-6. REFER TO ELEVATIONS 2,3,4,5,6,7,8,9MS-A8.9 FOR DETAILS.
- 10 ALTERNATE #1: POOL WALLS TO RECEIVE ACOUSTIC WALL PANELS, AWP-7,8,9,10. REFER TO ELEVATIONS 7,8,9,10,11MS-A8.9 FOR DETAILS.
- 11 RELOCATE EXISTING SCHOOL LOGO AND NAME TO INDICATED AREA. REFER TO ELEVATIONS 2,5MS-A8.9 FOR PLACEMENT DETAILS.
- 12 WALLS TO RECEIVE ACOUSTIC WALL PANELS, AWP-1,6. REFER TO 2,3,4,5MS-A8.8 FOR INSTALLATION DETAILS.
- 13 WALL TO RECEIVE FULL HEIGHT WALL TILE, WT-2 IN HORIZONTAL STACKED PATTERN. REFER TO 4MS-A8.5 FOR DETAILS.
- 14 PROVIDE PARTITIONS, TP-1. REFER TO A5 DRAWINGS FOR DETAILS.
- 15 ALL WALLS TO RECEIVE PAINT, PNT-6 UNLESS OTHERWISE NOTED.
- 16 ACCENT WALL TO RECEIVE PAINT, PNT-5.
- 17 ALTERNATE #2: PROVIDE NEW MOTORIZED BLEACHERS AND HANDRAIL SYSTEM, BL-2 IN COMPLIANCE WITH ADA. REFER TO MS-A1.4 FOR DETAILS.
- 18 ALTERNATE #6: VESTIBULE & STAIRWELL WALLS TO RECEIVE FULL HEIGHT WALL TILE, WT-3,4,5 IN BRICK INSTALLATION PATTERN. PROVIDE BASE AS SCHEDULED. REFER TO 6,7,8,9MS-A8.5 FOR DETAILS.

WALL FINISH LEGEND:

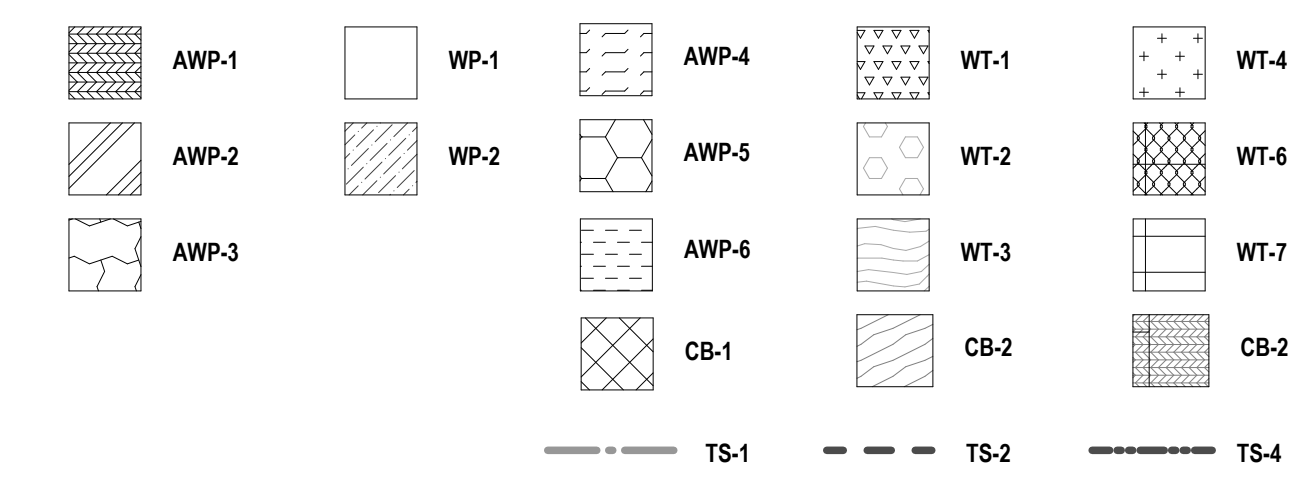


GENERAL NOTES - INTERIOR WALL FINISH:

- A. DRAWINGS REPRESENT LOCATIONS OF NEW WALL FINISHES AND INDICATE PATTERNS FOR INSTALLATION. FOR A COMPLETE LIST OF FINISHES, REFER TO THE FINISH KEY AND ROOM FINISH SCHEDULE.
- B. REFER TO A2 DRAWINGS FOR CEILING HEIGHTS. VERIFY CEILING HEIGHTS IN THE FIELD PRIOR TO START OF WORK.
- C. PAINT ALL UNFINISHED EXPOSED HVAC EQUIPMENT INCLUDING DUCTWORK, AIR DIFFUSERS AND RETURNS AT CEILING PLANE TO MATCH ADJACENT CEILING FINISH/COLOR. ARCHITECT TO SELECT COLOR.
- D. REFER TO WALL FINISH LEGEND AND ELEVATIONS FOR FINISHES THAT REQUIRE ADDITIONAL INFORMATION REGARDING EXTENTS OR INSTALLATION PATTERNING.
- E. PAINT ALL NEW INTERIOR WINDOW TRIM AND DOOR FRAMES. REFER TO FINISH KEY FOR COLORS.

# CONSTRUCTION NOTES - INTERIOR WALL FINISH:

1. ALL WALLS TO RECEIVE PAINT, PNT-1 UNLESS NOTED OTHERWISE.
2. WALLS TO RECEIVE WALL TILE, WT-1 IN BRICK INSTALLATION PATTERN AT WAINSCOT HEIGHT OF 5'-4". PROVIDE CT-2 AS BULLNOSE ABOVE. PROVIDE CB-2 AS BASE. PAINT WALL ABOVE PNT-1. REFER TO 3MS-A8.5 FOR DETAILS.
3. CORRIDOR WALLS TO RECEIVE FULL HEIGHT WALL TILE, WT-3,4,5 IN BRICK INSTALLATION PATTERN. PROVIDE BASE AS SCHEDULED. REFER TO 5MS-A8.5 FOR DETAILS.
4. PAINT WALLS PNT-2.
5. WALL TO RECEIVE WALL PADS, WP-1,2. REFER TO 6,7MS-A8.8 FOR DETAILS.
6. PATCH TO MATCH ADJACENT WALL FINISHES WHERE NEW WORK AFFECTS EXISTING WALL FINISH CONDITIONS.
7. WALLS TO RECEIVE ACOUSTIC WALL PANELS, AWP-1,2,3,4,5. REFER TO 2,3,4,5MS-A8.6 FOR INSTALLATION DETAILS.
8. PROVIDE WINDOW SHADES, WS-1 AT WINDOWS. VERIFY SIZES & QUANTITY IN FIELD.
9. WALLS TO RECEIVE PORCELAIN STONE TILES, WT-6,7,8,9 AND CERAMIC TRIM ABOVE, CT-1. PAINT WALLS ABOVE PNT-4. REFER TO ELEVATIONS 2,3,4,5,6,7,8,9MS-A8.9 FOR DETAILS.
10. ALTERNATE #1: POOL WALLS TO RECEIVE ACOUSTIC WALL PANELS, AWP-7,8,9,10. REFER TO ELEVATIONS 7,8,9,10,11MS-A8.9 FOR DETAILS.
11. RELOCATE EXISTING SCHOOL LOGO AND NAME TO INDICATED AREA. REFER TO ELEVATIONS 2,5MS-A8.9 FOR PLACEMENT DETAILS.
12. WALLS TO RECEIVE ACOUSTIC WALL PANELS, AWP-1,6. REFER TO 2,3,4,5MS-A8.8 FOR INSTALLATION DETAILS.
13. WALL TO RECEIVE FULL HEIGHT WALL TILE, WT-2 IN HORIZONTAL STACKED PATTERN. REFER TO 4MS-A8.5 FOR DETAILS. PROVIDE CB-2 AS BASE.
14. PROVIDE PARTITIONS, TPA-1. REFER TO A5 DRAWINGS FOR DETAILS.
15. ALL WALLS TO RECEIVE PAINT, PNT-6 UNLESS OTHERWISE NOTED.
16. ACCENT WALL TO RECEIVE PAINT, PNT-5.
17. ALTERNATE #2: PROVIDE NEW MOTORIZED BLEACHERS AND HANDRAIL SYSTEM, BL-2 IN COMPLIANCE WITH ADA. REFER TO MS-A1.4 FOR DETAILS.
18. ALTERNATE #3: VESTIBULE & STAIRWELL WALLS TO RECEIVE FULL HEIGHT WALL TILE, WT-3,4,5 IN BRICK INSTALLATION PATTERN. PROVIDE BASE AS SCHEDULED. REFER TO 6,7,8,9MS-A8.5 FOR DETAILS.

WALL FINISH LEGEND:

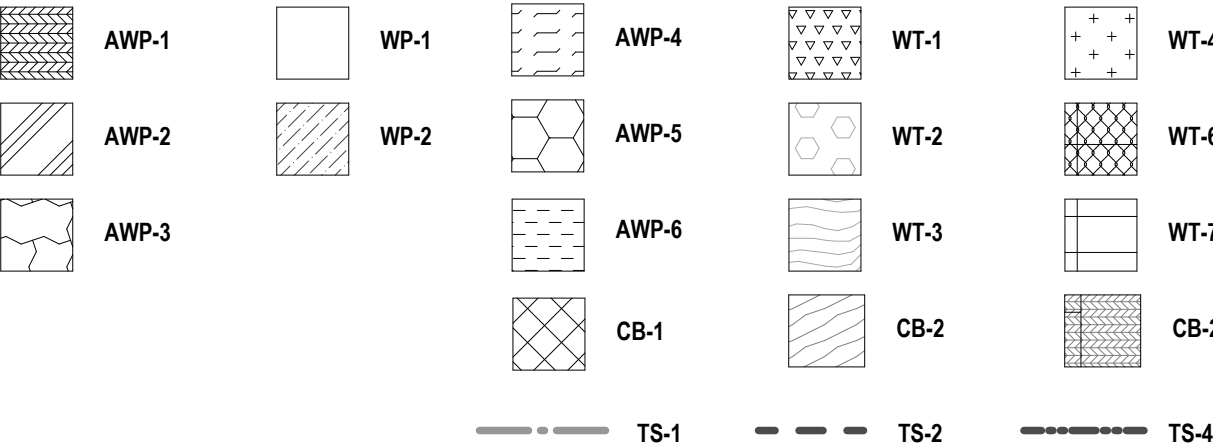

6 BAND ROOM WALL FINISH ELEVATION - WEST  
1/4" = 1'-0"

5 BAND ROOM WALL FINISH ELEVATION - NORTH  
1/4" = 1'-0"

4 BAND ROOM WALL FINISH ELEVATION - EAST  
1/4" = 1'-0"

3 BAND ROOM WALL FINISH ELEVATION - OFFICE WALL  
1/4" = 1'-0"

2 SECOND FLOOR PLAN - PARTIAL AREA C  
1/8" = 1'-0"

1 PARTIAL FIRST FLOOR WALL FINISH PLAN - AREA C  
1/8" = 1'-0"



1 ALL WALLS TO RECEIVE PAINT, PNT-1 UNLESS NOTED OTHERWISE.

2 WALLS TO RECEIVE WALL, WT-1 IN BRICK INSTALLATION PATTERN AT WANSOFT HEIGHT OF 5'-4". PROVIDE CT-2 AS

3 FINISH. PROVIDE CB-3 AS BASE. PAINT ABOVE PNT-1. REFER TO 3MS-A8.5 FOR DETAILS.

4 CORRIDOR WALLS TO RECEIVE FULL HEIGHT WALL, WT-3. 3MS-A8 IN BRICK INSTALLATION PATTERN. PROVIDE BASE AS

5 SCHEDULED. REFER TO 3MS-A8.5 FOR DETAILS.

6 PAINT WALLS PNT-2.

7 WALL TO RECEIVE WALL, PADS, WP-1.2. REFER TO 6MS-A8.9 FOR DETAILS.

8 PATCH TO MATCH ADJACENT WALL FINISHES WHERE NEW WORK EXISTS EXISTING WALL FINISH CONDITIONS.

9 WALLS TO RECEIVE ACOUSTIC WALL PANELS, AWP-1,2,3,4,5. REFER TO 2,3,4,5,6MS-A8.6 FOR INSTALLATION DETAILS.

10 PROVIDE WINDOW SHADDS, WS-1 AT WINDOWS. VERIFY SIZES & QUANTITY IN FIELD.

11 WALLS TO RECEIVE PORCELAIN STONE TILES, WT-6,7,8,5, AND CERAMIC TRIM ABOVE, CT-1. PAINT ELEVATIONS 7,8,9,10,11MS-A8.9

12 REFER TO 2,3,4,5,6,7,8MS-A8.9 FOR DETAILS.

13 ALTERNATE #1: POOL WALLS TO RECEIVE ACOUSTIC WALL PANELS, AWP-7,8,9,10. REFER TO ELEVATIONS 7,8,9,10,11MS-A8.9

14 FOR DETAILS.

15 RELOCATE EXISTING SCHOOL LOGO AND NAME TO INDICATED AREA. REFER TO ELEVATIONS 2,9MS-A8.9 FOR PLACEMENT

16 DETAILS.

17 WALLS TO RECEIVE ACOUSTIC WALL PANELS, AWP-1.6. REFER TO 2,3,4,5,6MS-A8.9 FOR INSTALLATION DETAILS.

18 WALL TO RECEIVE FULL HEIGHT WALL, WT-12 IN HORIZONTAL STACKED PATTERN. REFER TO 4MS-A8.9 FOR DETAILS.

19 PROVIDE CB-3 AS BASE.

20 PROVIDE PARTITIONS, TP-1. REFER TO AS DRAWINGS FOR DETAILS.

21 ALL WALLS TO RECEIVE PAINT, PNT-4 UNLESS OTHERWISE NOTED.

22 ACCENT WALL TO RECEIVE PAINT, PNT-5.

23 ALTERNATE #2: PROVIDE NEW MOTORIZED BLEACHERS AND HANDRAIL SYSTEM, BL-2 IN COMPLIANCE WITH ADA. REFER TO

24 MS-A14 FOR DETAILS.

25 ALTERNATE #3: VESTIBULE & STARWALLS TO RECEIVE TO RECEIVE FULL HEIGHT WALL, WT-3,4,5 IN BRICK INSTALLATION

26 PATTERN. PROVIDE BASE AS SCHEDULED. REFER TO 6,7,8,9MS-A8.5 FOR DETAILS.


DRAWINGS REPRESENT LOCATIONS OF NEW WALL FINISHES AND INDICATE PATTERNS FOR INSTALLATION. FOR A COMPLETE LIST OF FINISHES, REFER TO THE FINISH KEY AND ROOM FINISH SCHEDULE.

REFER TO 2 DRAWINGS FOR CEILING HEIGHTS. VERIFY CEILING HEIGHTS IN THE FIELD PRIOR TO START OF WORK.


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REFER TO WALL FINISH LEGEND AND ELEVATIONS FOR FINISHES THAT REQUIRE ADDITIONAL INFORMATION REGARDING EXTENTS OR INSTALLATION PATTERNING.

PAINT ALL NEW INTERIOR WINDOW TRIM AND DOOR FRAMES. REFER TO FINISH KEY FOR COLORS.

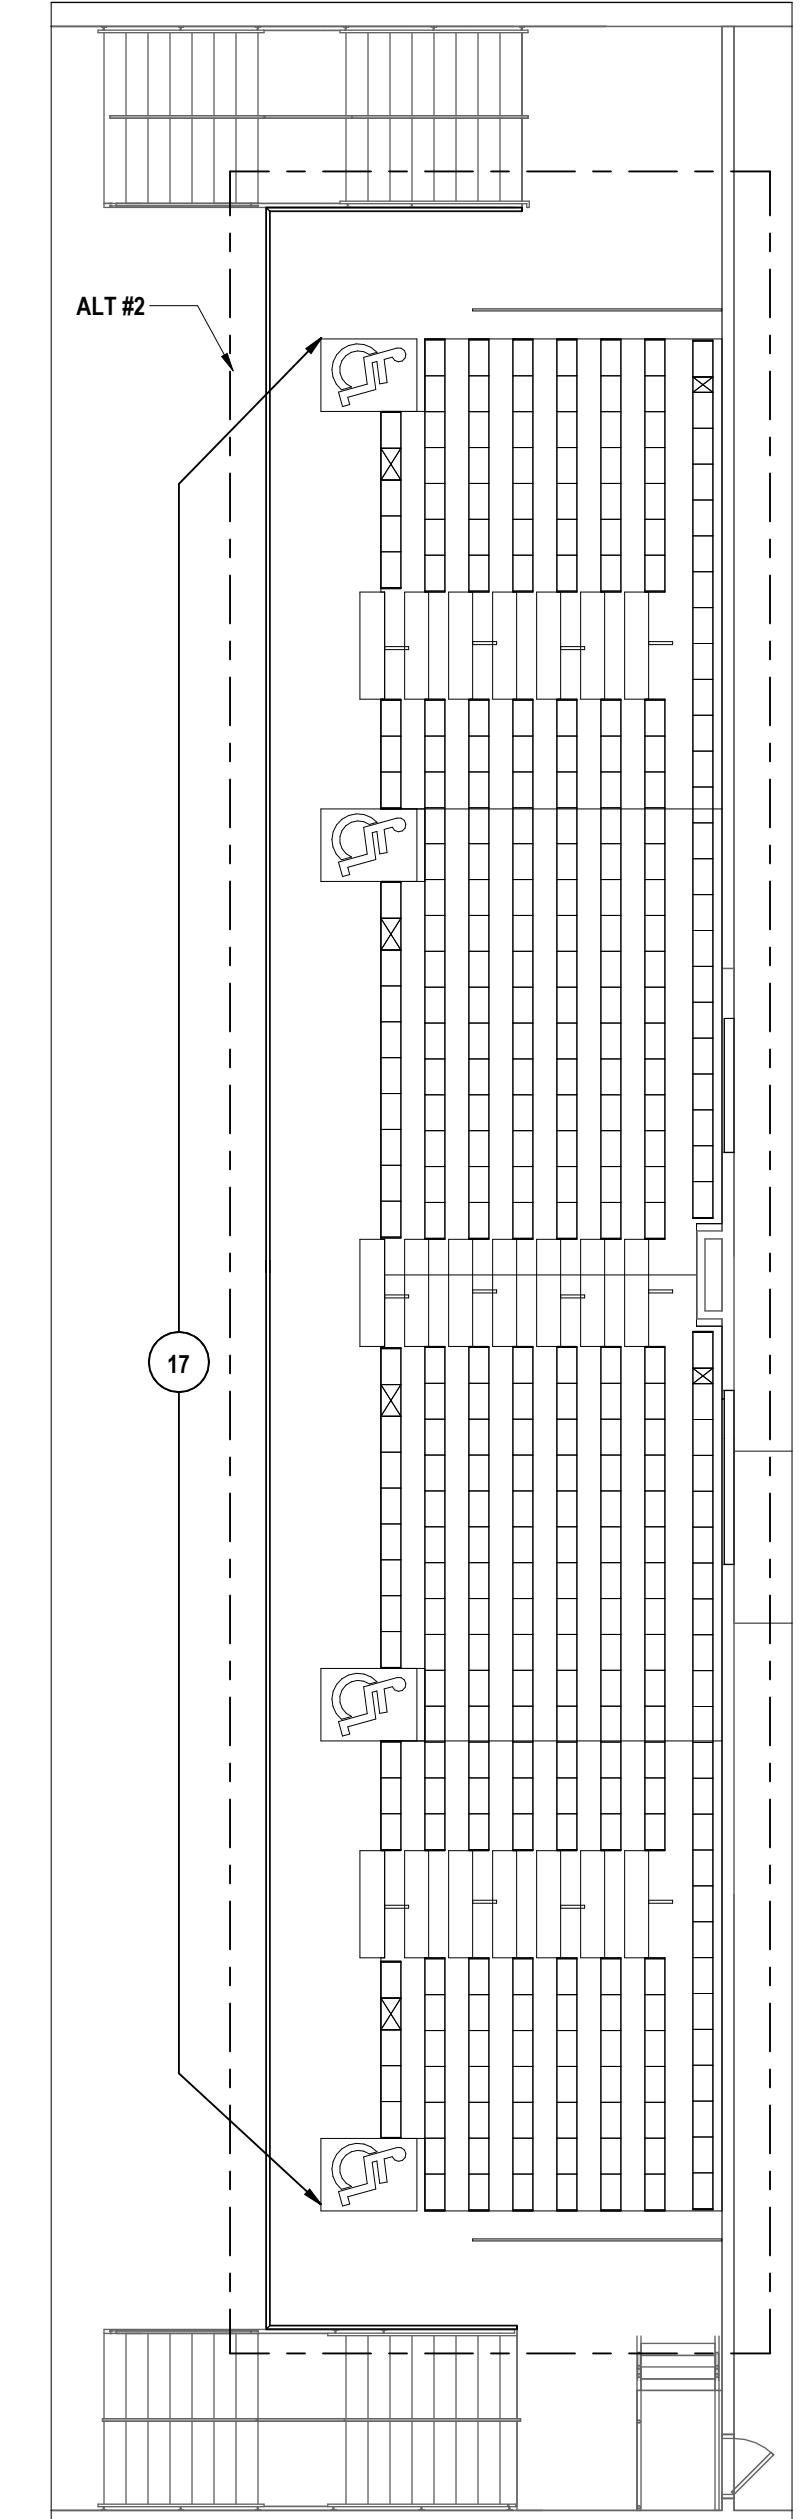

**2 GYM MEZZANINE WALL FINISH PLAN**  
1/8" = 1'-0"

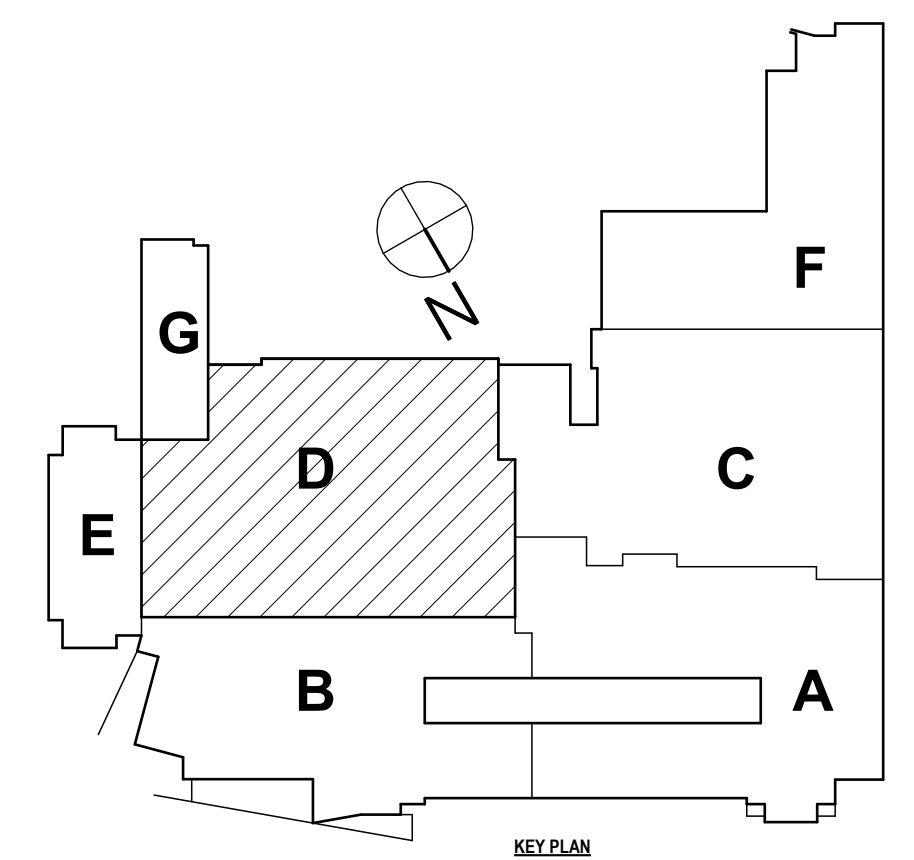

### KEY PLAN

#	DATE:	DESCRIPTION OF REVISION:
1	10/20/2025	ISSUED FOR BID

**HUNT**  
ENGINEERS | ARCHITECTS | SURVEYORS

HORSEHEADS, NY 607-353-1000 ROCHESTER, NY 585-337-7949 TOWANDA, PA 570-265-4888  
BINGHAMTON, NY 607-758-8841 BIRNY, NY 607-708-7908

FIRST FLOOR WALL FINISH PLAN - AREA D  
2025 MIDDLE SCHOOL PHASE III ALTERATIONS PROJECT  
CORNING-PAINTED POST ASD  
35 VICTORY HIGHWAY, PAINTED POST, NY 14870

**MS-A8.7**

PROJECT NO: 2649-153



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- B REFER TO A2 DRAWINGS FOR CEILING HEIGHTS. VERIFY CEILING HEIGHTS IN THE FIELD PRIOR TO START OF WORK.
- C PAINT ALL UNFINISHED EXPOSED HVAC EQUIPMENT INCLUDING DUCTWORK, AIR DIFFUSERS AND RETURNS AT CEILING PLANE TO MATCH ADJACENT CEILING FINISH/COLOR. ARCHITECT TO SELECT COLOR.
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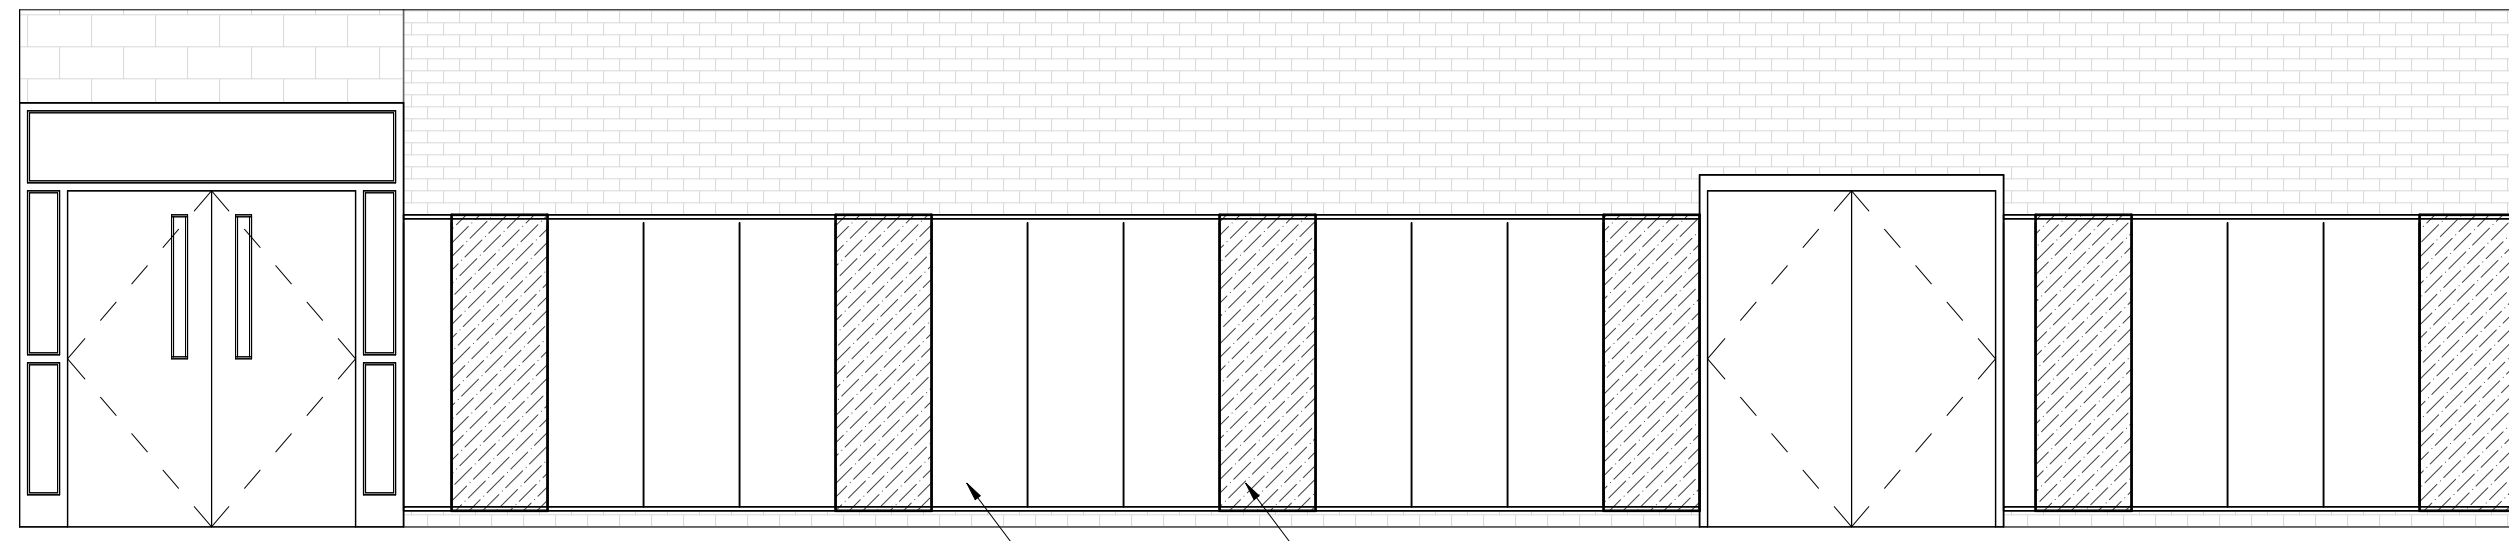
# CONSTRUCTION NOTES - INTERIOR WALL FINISH:

- 1 ALL WALLS TO RECEIVE PAINT, PNT-1 UNLESS NOTED OTHERWISE.
- 2 WALLS TO RECEIVE WALL TILE, WT-1 IN BRICK INSTALLATION PATTERN AT WAINSCOT HEIGHT OF 5'-4". PROVIDE CT-2 AS BULLNOSE ABOVE. PROVIDE CB-2 AS BASE. PAINT WALL ABOVE PNT-1. REFER TO 3/MS-A8.5 FOR DETAILS.
- 3 CORRIDOR WALLS TO RECEIVE FULL HEIGHT WALL TILE, WT-3,4,5 IN BRICK INSTALLATION PATTERN. PROVIDE BASE AS SCHEDULED. REFER TO 5/MS-A8.5 FOR DETAILS.
- 4 PAINT WALLS PNT-2.
- 5 WALL TO RECEIVE WALL PADS, WP-1,2. REFER TO 6/7/MS-A8.8 FOR DETAILS.
- 6 PATCH TO MATCH ADJACENT WALL FINISHES WHERE NEW WORK AFFECTS EXISTING WALL FINISH CONDITIONS.
- 7 WALLS TO RECEIVE ACOUSTIC WALL PANELS, AWP-1,2,3,4,5. REFER TO 2,3,4,5,6/MS-A8.6 FOR INSTALLATION DETAILS.
- 8 PROVIDE WINDOW SHADES, WS-1 AT WINDOWS. VERIFY SIZES & QUANTITY IN FIELD.
- 9 WALLS TO RECEIVE PORCELAIN STONE TILES, WT-6,7,8,9. AND CERAMIC TRIM ABOVE, CT-1. PAINT WALLS ABOVE PNT-4. REFER TO ELEVATIONS 2,3,4,5,6,7,8,9/MS-A8.9 FOR DETAILS.
- 10 ALTERNATE #1: POOL WALLS TO RECEIVE ACOUSTIC WALL PANELS, AWP-7,8,9,10. REFER TO ELEVATIONS 7,8,9,10,11/MS-A8.9 FOR DETAILS.
- 11 RELOCATE EXISTING SCHOOL LOGO AND NAME TO INDICATED AREA, REFER TO ELEVATIONS 2,5/MS-A8.9 FOR PLACEMENT DETAILS.
- 12 WALLS TO RECEIVE ACOUSTIC WALL PANELS, AWP-1,6. REFER TO 2,3,4,5/MS-A8.8 FOR INSTALLATION DETAILS.
- 13 WALL TO RECEIVE FULL HEIGHT WALL TILE, WT-2 IN HORIZONTAL STACKED PATTERN. REFER TO 4/MS-A8.5 FOR DETAILS. PROVIDE CB-2 AS BASE.
- 14 PROVIDE PARTITIONS, TP-1. REFER TO A5 DRAWINGS FOR DETAILS.
- 15 ALL WALLS TO RECEIVE PAINT, PNT-6 UNLESS OTHERWISE NOTED.
- 16 ACCENT WALL TO RECEIVE PAINT, PNT-5.
- 17 ALTERNATE #2: PROVIDE NEW MOTORIZED BLEACHERS AND HANDRAIL SYSTEM, BL-2 IN COMPLIANCE WITH ADA. REFER TO MS-A1.4 FOR DETAILS.
- 18 ALTERNATE #8: VESTIBULE & STAIRWELL WALLS TO RECEIVE FULL HEIGHT WALL TILE, WT-3,4,5 IN BRICK INSTALLATION PATTERN. PROVIDE BASE AS SCHEDULED. REFER TO 6,7,8,9/MS-A8.5 FOR DETAILS.


WALL FINISH LEGEND:




7 AUXILIARY GYM WALL FINISH ELEVATION - SOUTH  
1/4" = 1'-0"

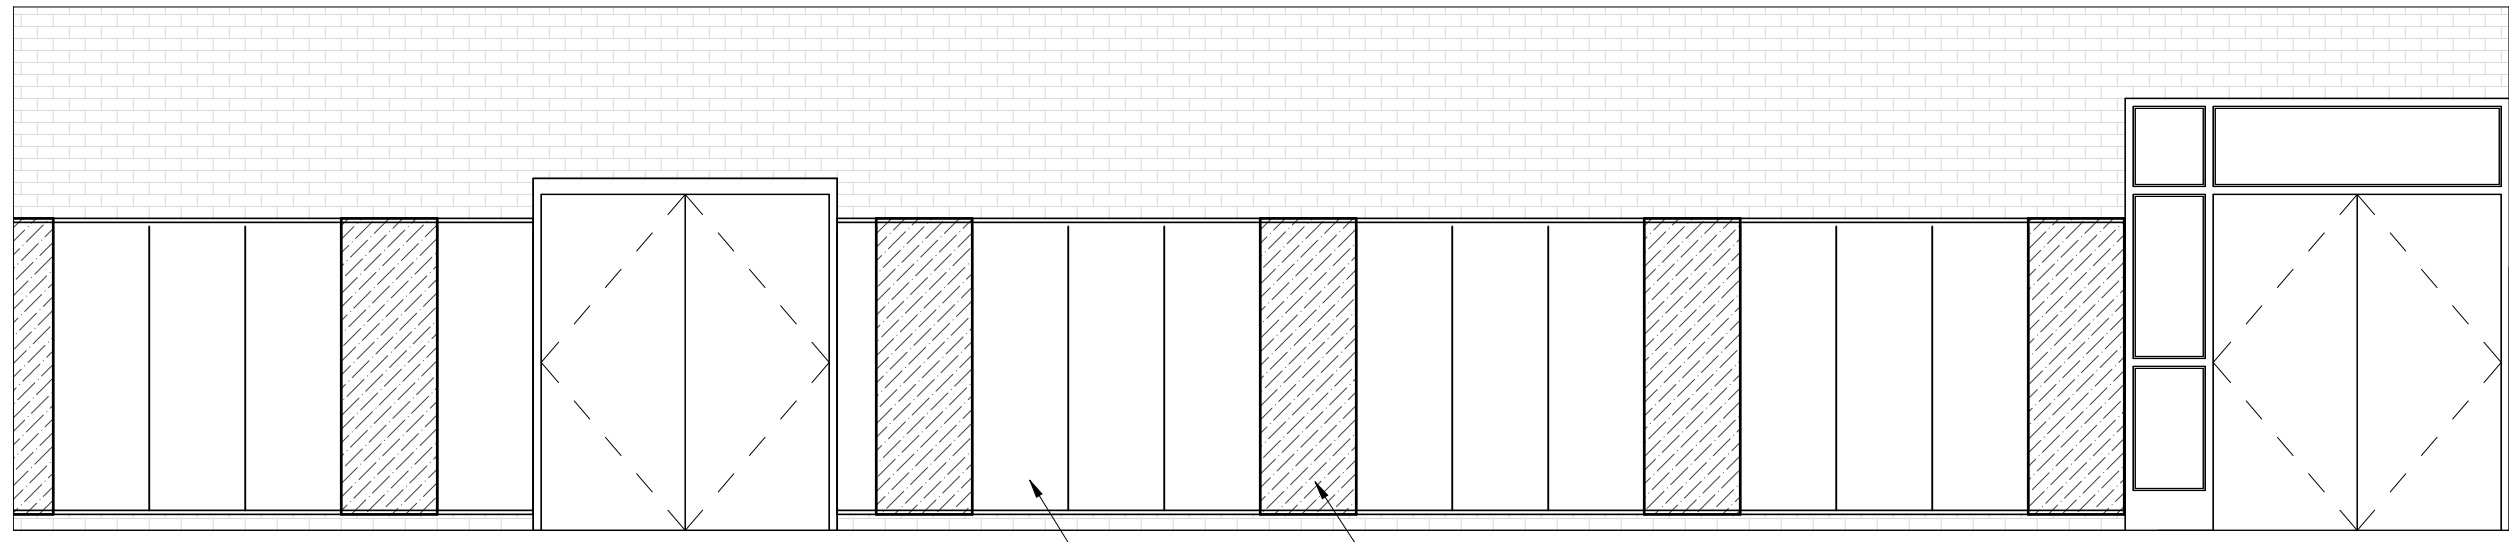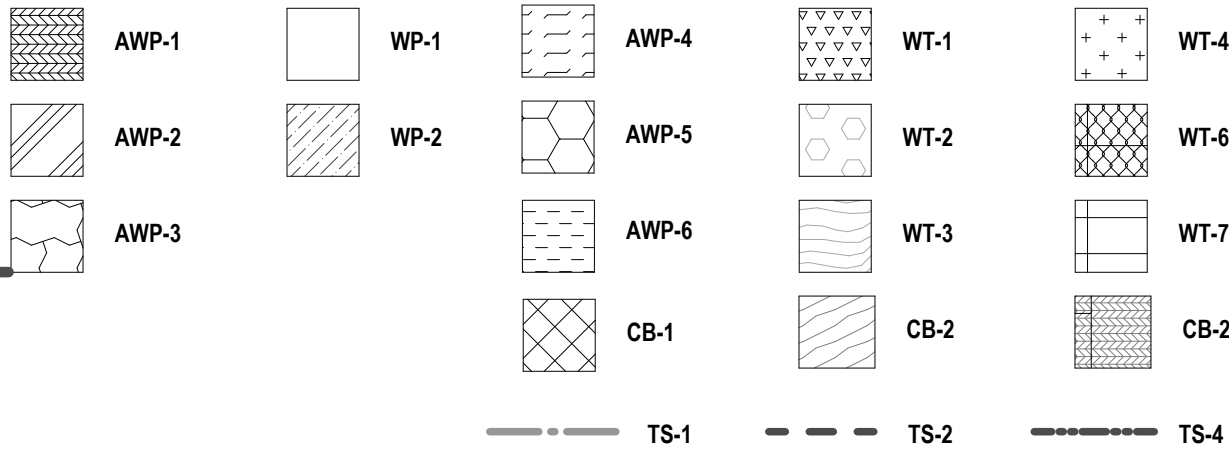


6 AUXILIARY GYM WALL FINISH ELEVATION - NORTH  
1/4" = 1'-0"

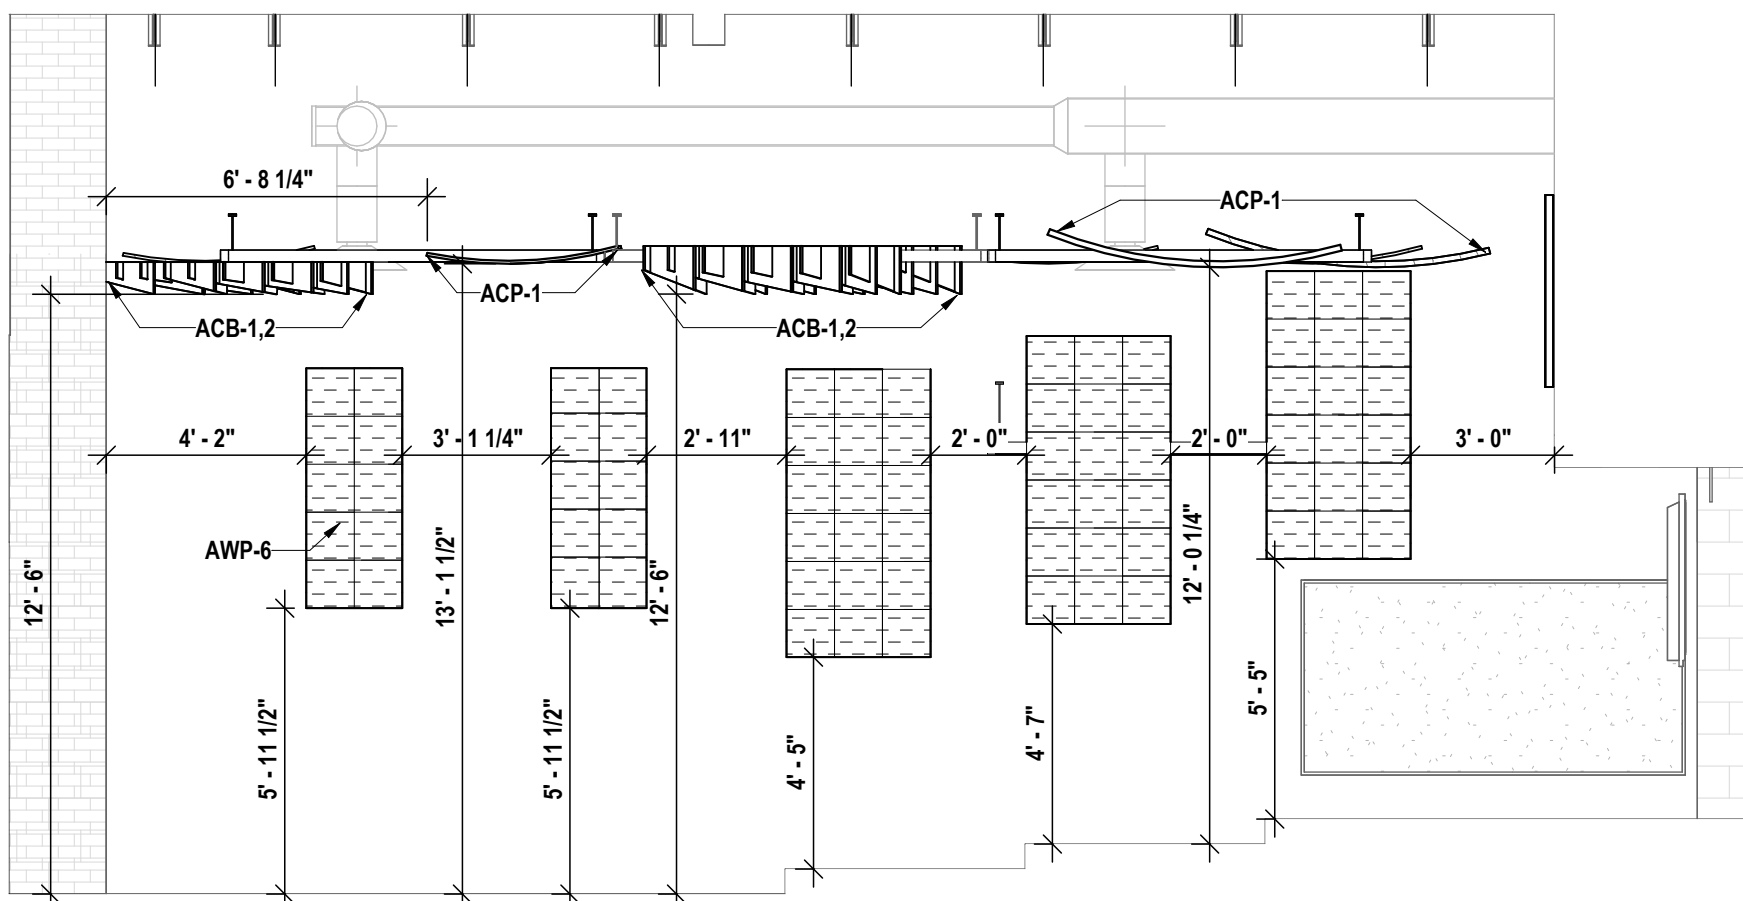


5 CHORAL ROOM ELEVATION - EAST  
1/4" = 1'-0"

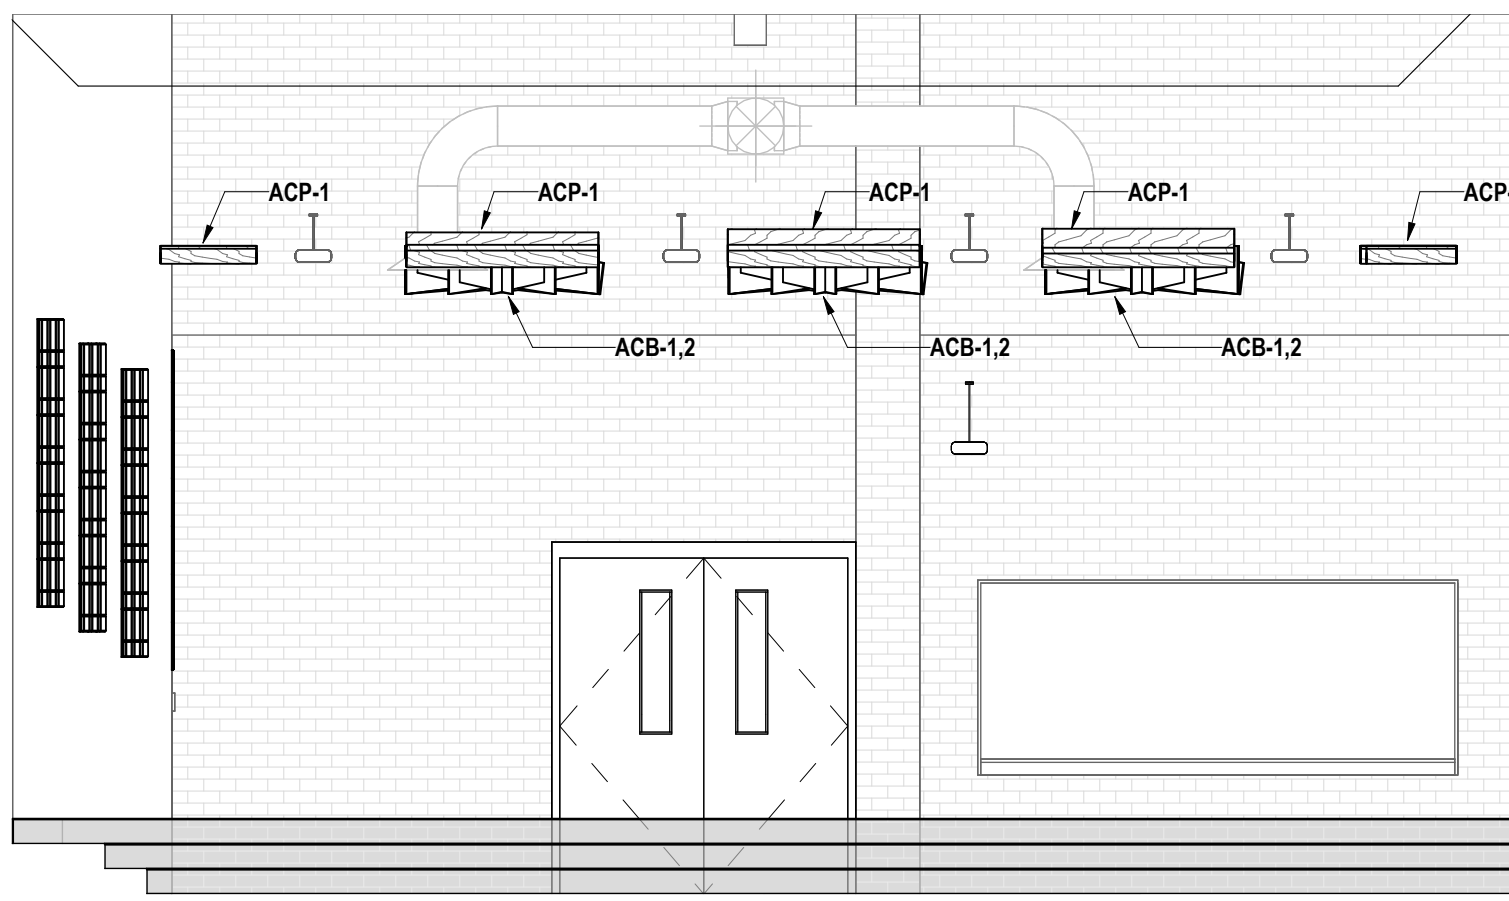


4 CHORAL ROOM ELEVATION - NORTH  
1/4" = 1'-0"

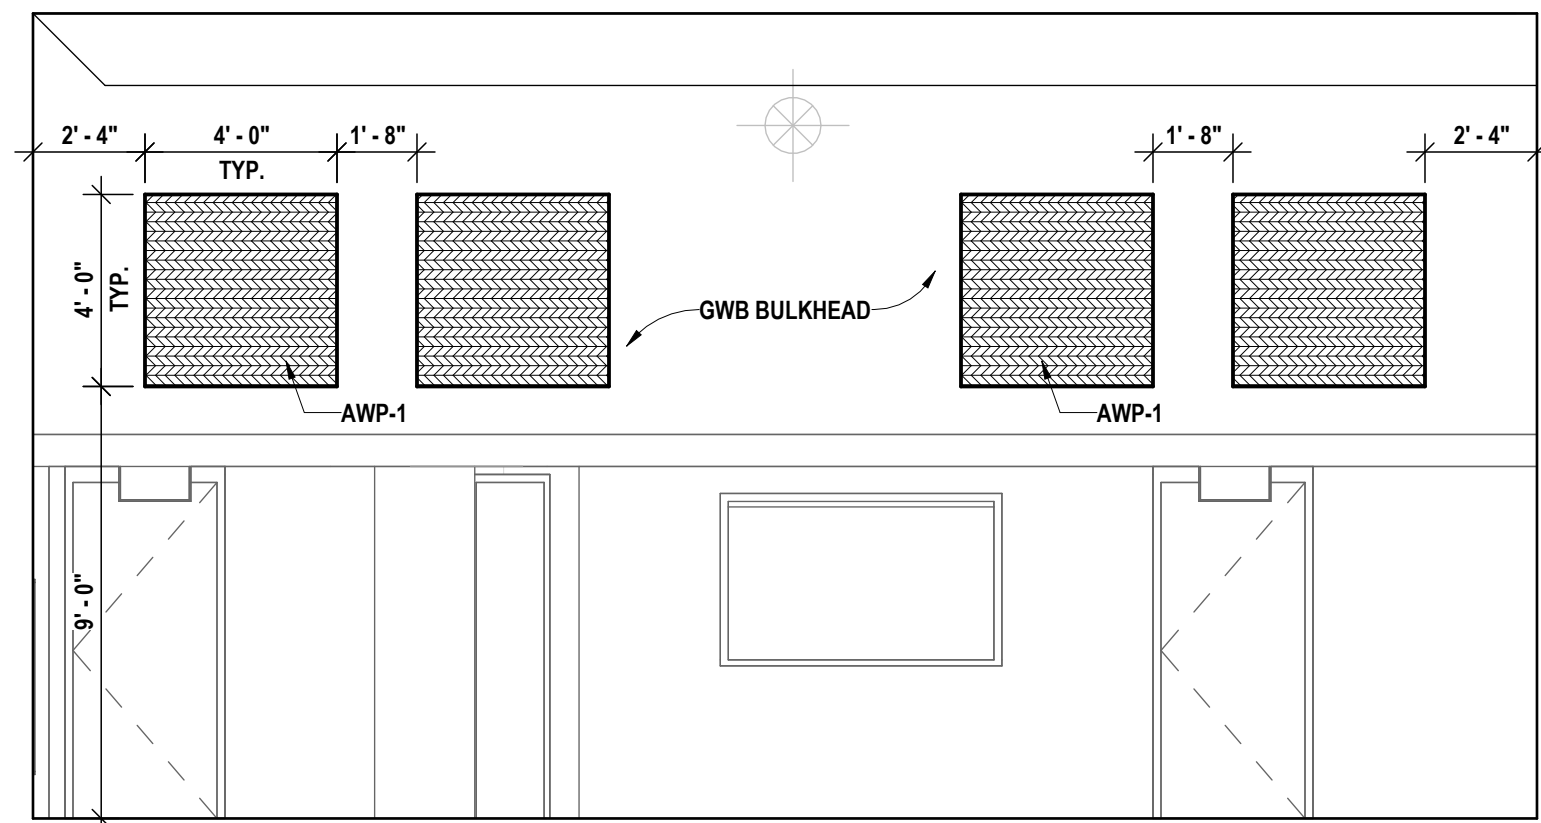


3 CHORAL ROOM ELEVATION - SOUTH  
1/4" = 1'-0"

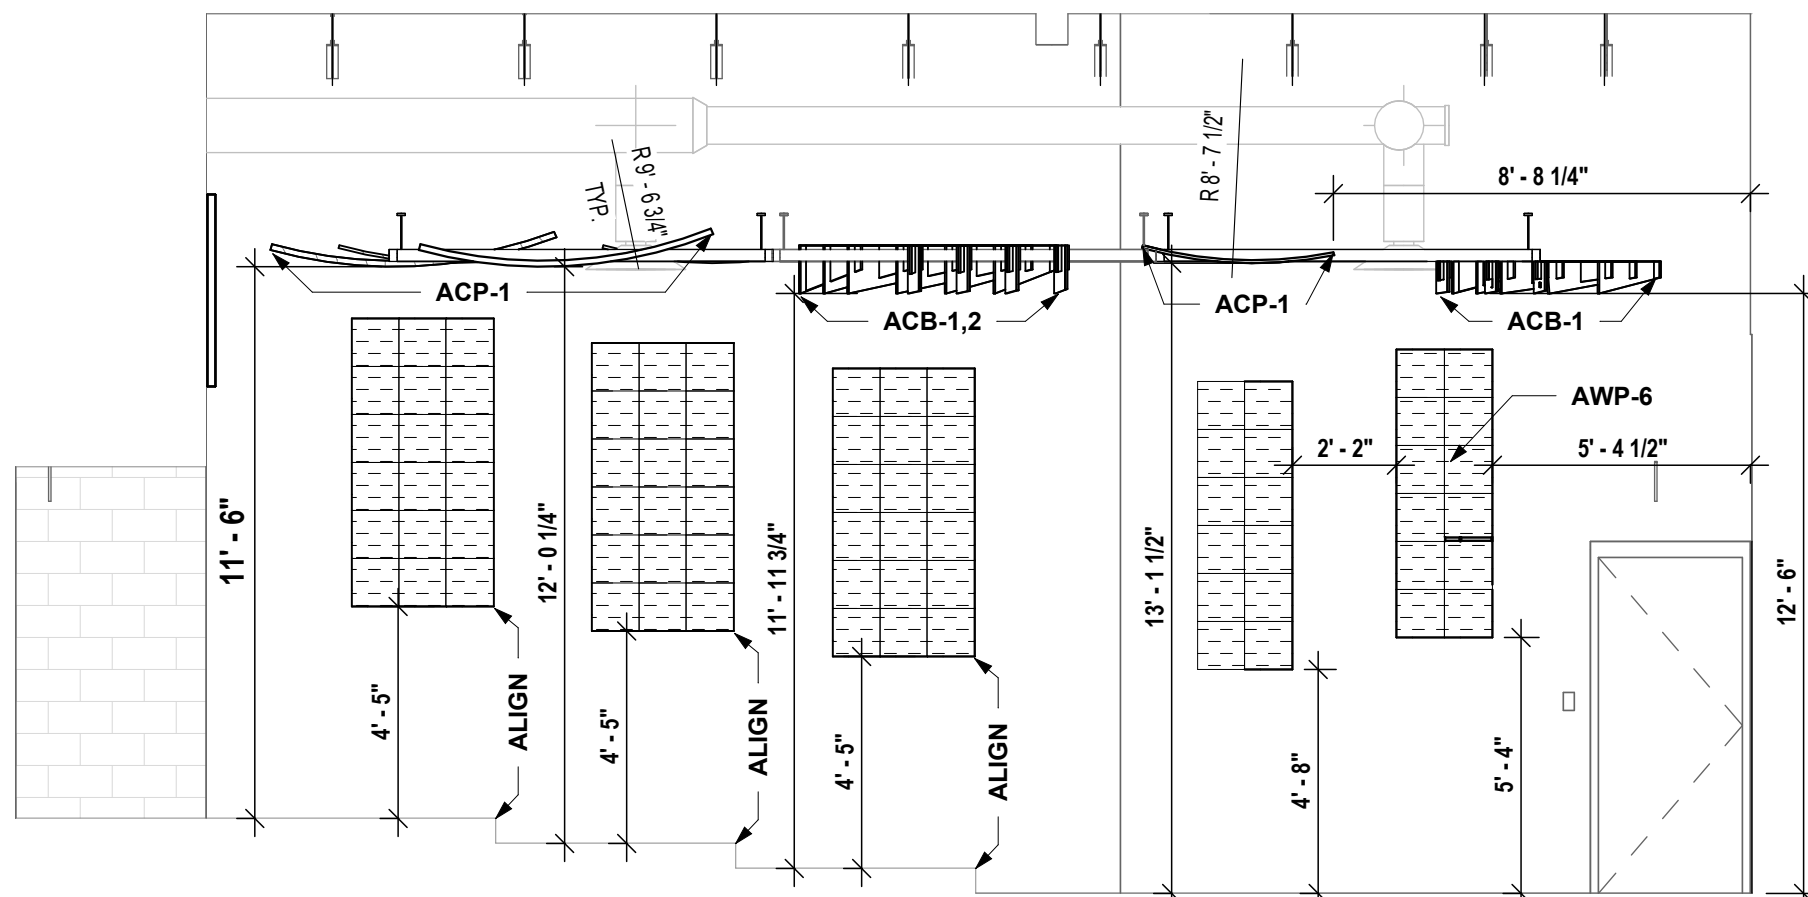

2 CHORAL ROOM ELEVATION - WEST  
1/4" = 1'-0"

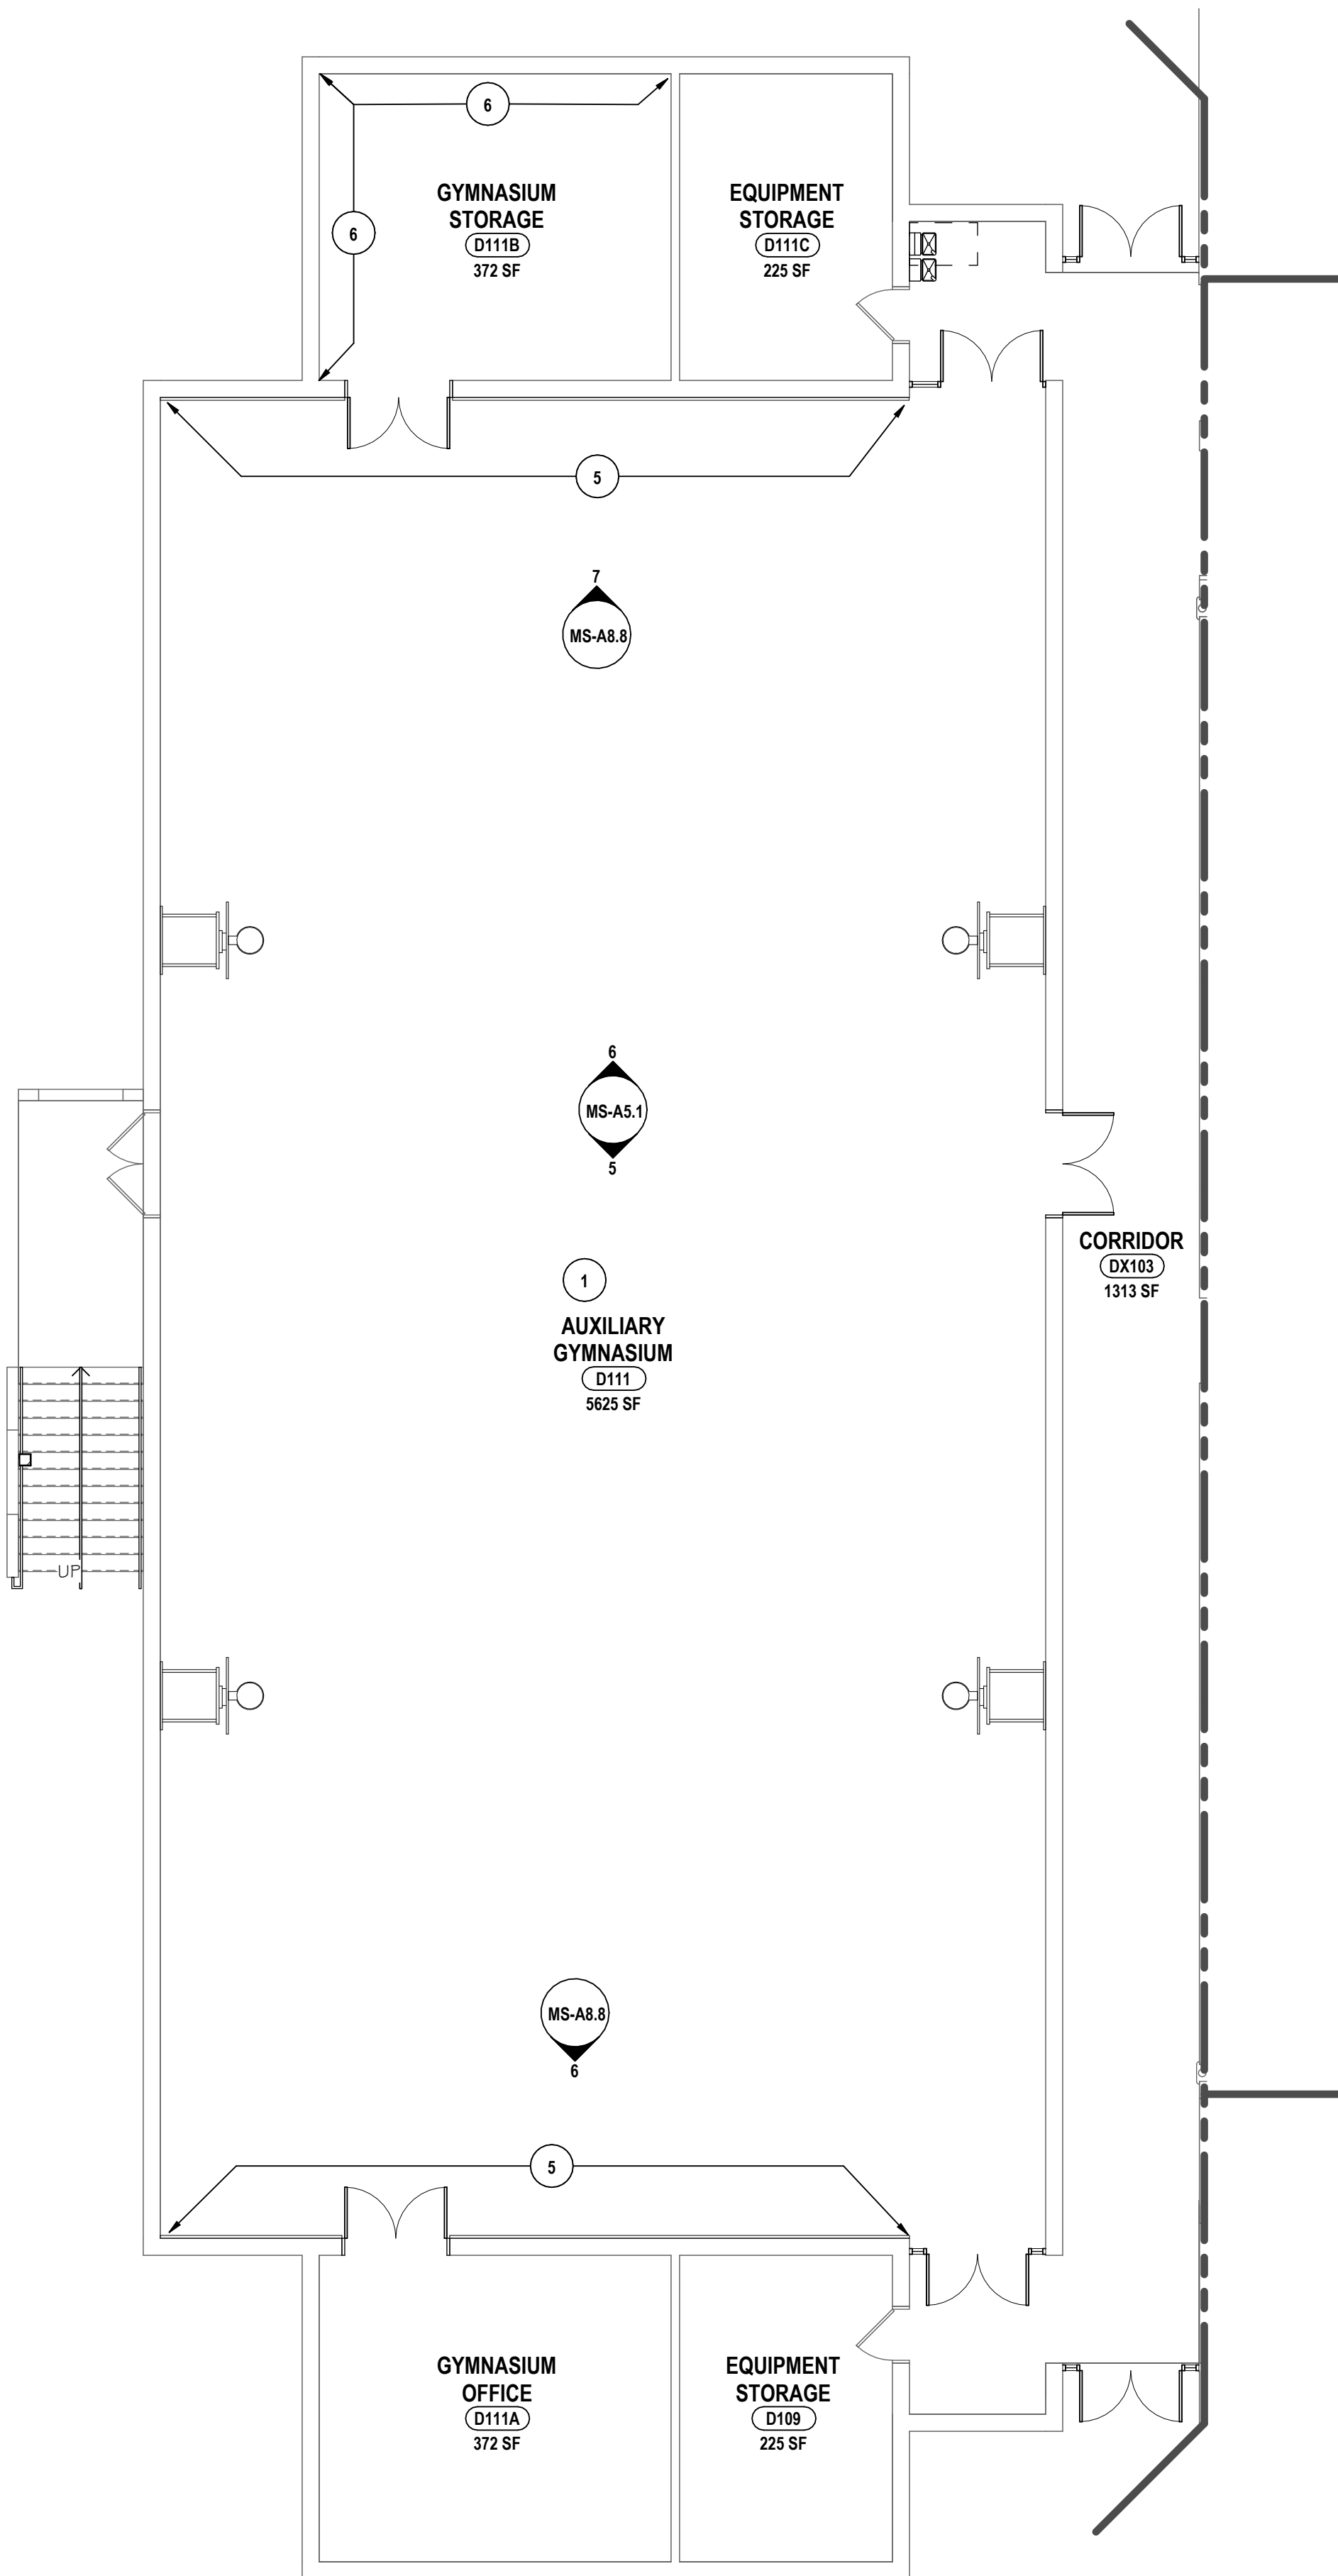

1 FIRST FLOOR WALL FINISH PLAN (2649.153) - AREA E  
1/8" = 1'-0"

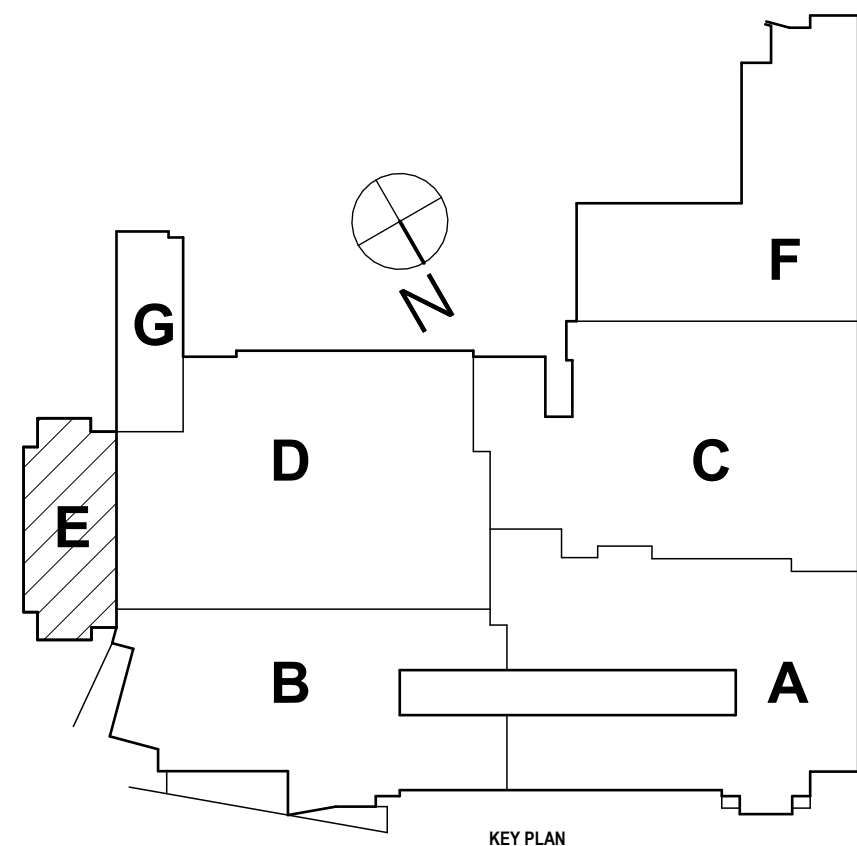





# CONSTRUCTION NOTES - INTERIOR WALL FINISH:

- 1 ALL WALLS TO RECEIVE PAINT, PNT-1 UNLESS NOTED OTHERWISE.
- 2 WALLS TO RECEIVE WALL TILE, WT-1 IN BRICK INSTALLATION PATTERN AT WAINSCOT HEIGHT OF 5'-4". PROVIDE CT-2 AS BULLMOOSE ABOVE. PROVIDE CB-2 AS BASE. PAINT WALL ABOVE PNT-1. REFER TO 3MS-A8.5 FOR DETAILS.
- 3 CORRIDOR WALLS TO RECEIVE FULL HEIGHT WALL TILE, WT-3,4,5 IN BRICK INSTALLATION PATTERN. PROVIDE BASE AS SCHEDULED. REFER TO 5MS-A8.5 FOR DETAILS.
- 4 PAINT WALLS PNT-2.
- 5 WALL TO RECEIVE WALL PADS, WP-1,2. REFER TO 6,7MS-A8.8 FOR DETAILS.
- 6 PATCH TO MATCH ADJACENT WALL FINISHES WHERE NEW WORK AFFECTS EXISTING WALL FINISH CONDITIONS.
- 7 WALLS TO RECEIVE ACOUSTIC WALL PANELS, AWP-1,2,3,4,5. REFER TO 2,3,4,5,6MS-A8.8 FOR INSTALLATION DETAILS.
- 8 PROVIDE WINDOW SHADES, WS-1 AT WINDOWS. VERIFY SIZES & QUANTITY IN FIELD.
- 9 WALLS TO RECEIVE PORCELAIN STONE TILES, WT-4,7,8,9, AND CERAMIC TRIM ABOVE, CT-1. PAINT WALLS ABOVE PNT-4. REFER TO ELEVATIONS 2,3,4,5,6,7,8,9MS-A8.9 FOR DETAILS.
- 10 ALTERNATE #1: POOL WALLS TO RECEIVE ACOUSTIC WALL PANELS, AWP-7,8,9,10. REFER TO ELEVATIONS 7,8,9,10,11MS-A8.9 FOR DETAILS.
- 11 RELOCATE EXISTING SCHOOL LOGO AND NAME TO INDICATED AREA, REFER TO ELEVATIONS 2,5MS-A8.9 FOR PLACEMENT DETAILS.
- 12 WALLS TO RECEIVE ACOUSTIC WALL PANELS, AWP-1,6. REFER TO 2,3,4,5MS-A8.8 FOR INSTALLATION DETAILS.
- 13 WALL TO RECEIVE FULL HEIGHT WALL TILE, WT-2 IN HORIZONTAL STACKED PATTERN. REFER TO 4MS-A8.5 FOR DETAILS. PROVIDE CB-2 AS BASE.
- 14 PROVIDE PARTITIONS, TP-1. REFER TO A5 DRAWINGS FOR DETAILS.
- 15 ALL WALLS TO RECEIVE PAINT, PNT-6 UNLESS OTHERWISE NOTED.
- 16 ACCENT WALL TO RECEIVE PAINT, PNT-5.
- 17 ALTERNATE #2: PROVIDE NEW MOTORIZED BLEACHERS AND HANDRAIL SYSTEM, BL-2 IN COMPLIANCE WITH ADA. REFER TO MS-A1.4 FOR DETAILS.
- 18 ALTERNATE #3: VESTIBULE & STAIRWELL WALLS TO RECEIVE FULL HEIGHT WALL TILE, WT-3,4,5 IN BRICK INSTALLATION PATTERN. PROVIDE BASE AS SCHEDULED. REFER TO 6,7,8,9MS-A8.5 FOR DETAILS.


GENERAL NOTES - INTERIOR WALL FINISH:

- A DRAWINGS REPRESENT LOCATIONS OF NEW WALL FINISHES AND INDICATE PATTERNS FOR INSTALLATION. FOR A COMPLETE LIST OF FINISHES, REFER TO THE FINISH KEY AND ROOM FINISH SCHEDULE.
- B REFER TO A2 DRAWINGS FOR CEILING HEIGHTS. VERIFY CEILING HEIGHTS IN THE FIELD PRIOR TO START OF WORK.
- C PAINT ALL UNFINISHED EXPOSED HVAC EQUIPMENT INCLUDING DUCTWORK, AIR DIFFUSERS AND RETURNS AT CEILING PLANE TO MATCH ADJACENT CEILING FINISH/COLOR. ARCHITECT TO SELECT COLOR.
- D REFER TO WALL FINISH LEGEND AND ELEVATIONS FOR FINISHES THAT REQUIRE ADDITIONAL INFORMATION REGARDING EXTENTS OR INSTALLATION PATTERNING.
- E PAINT ALL NEW INTERIOR WINDOW TRIM AND DOOR FRAMES. REFER TO FINISH KEY FOR COLORS.


POOL WALL FINISH LEGEND:

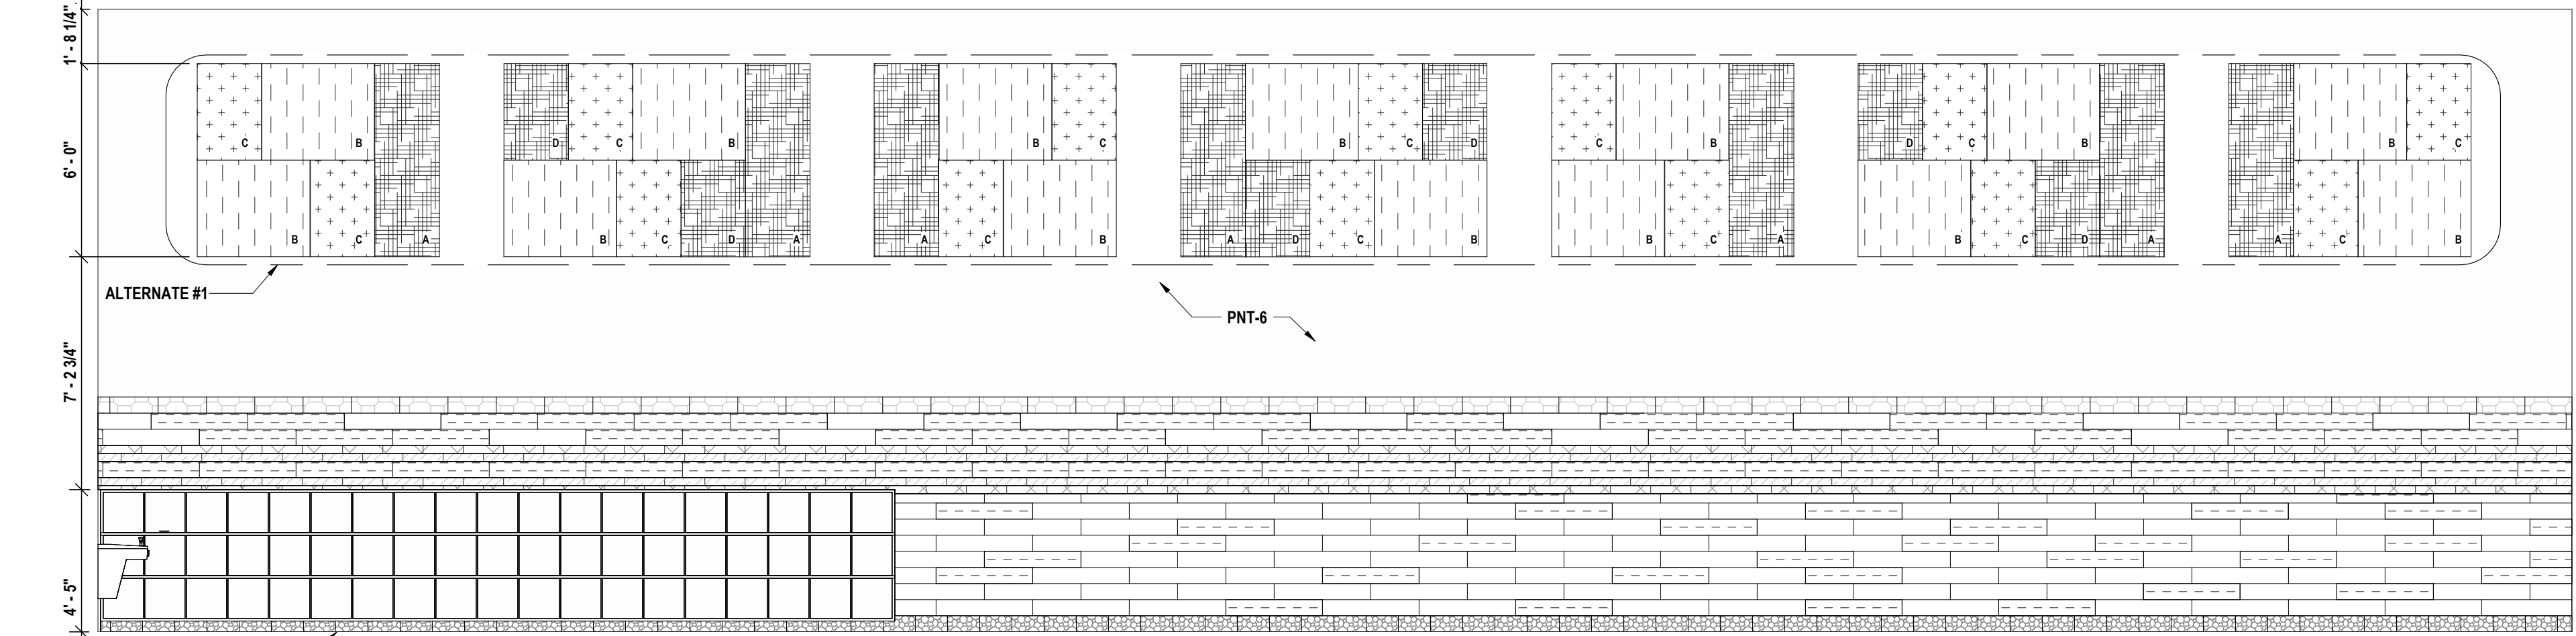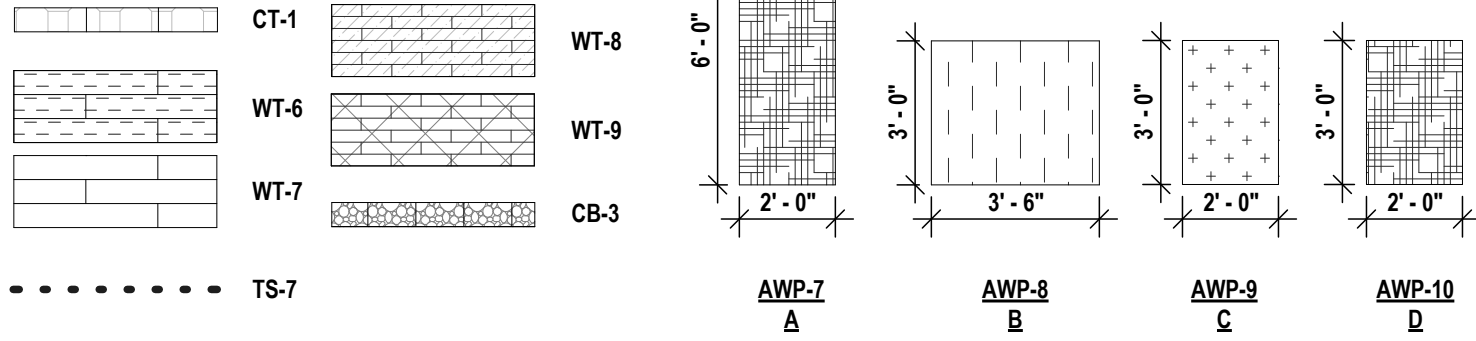


11 POOL ELEVATION - EAST  
1/4" = 1'-0"

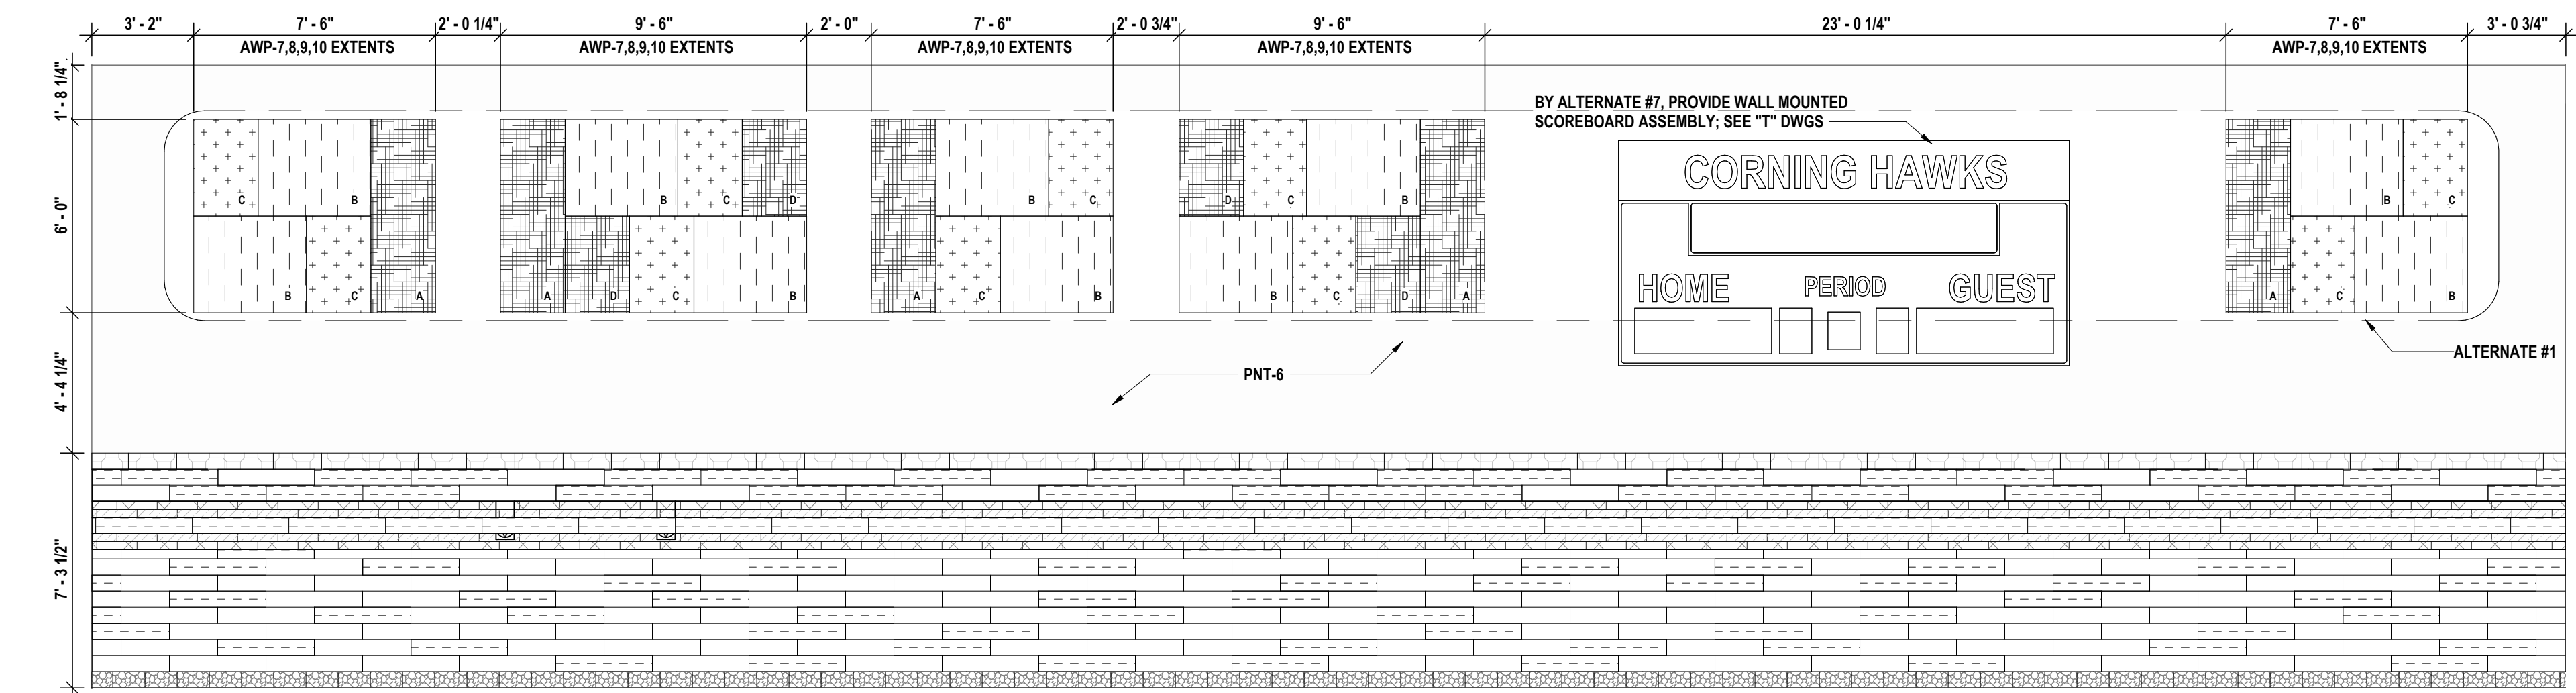


9 POOL ELEVATION - WEST  
1/4" = 1'-0"

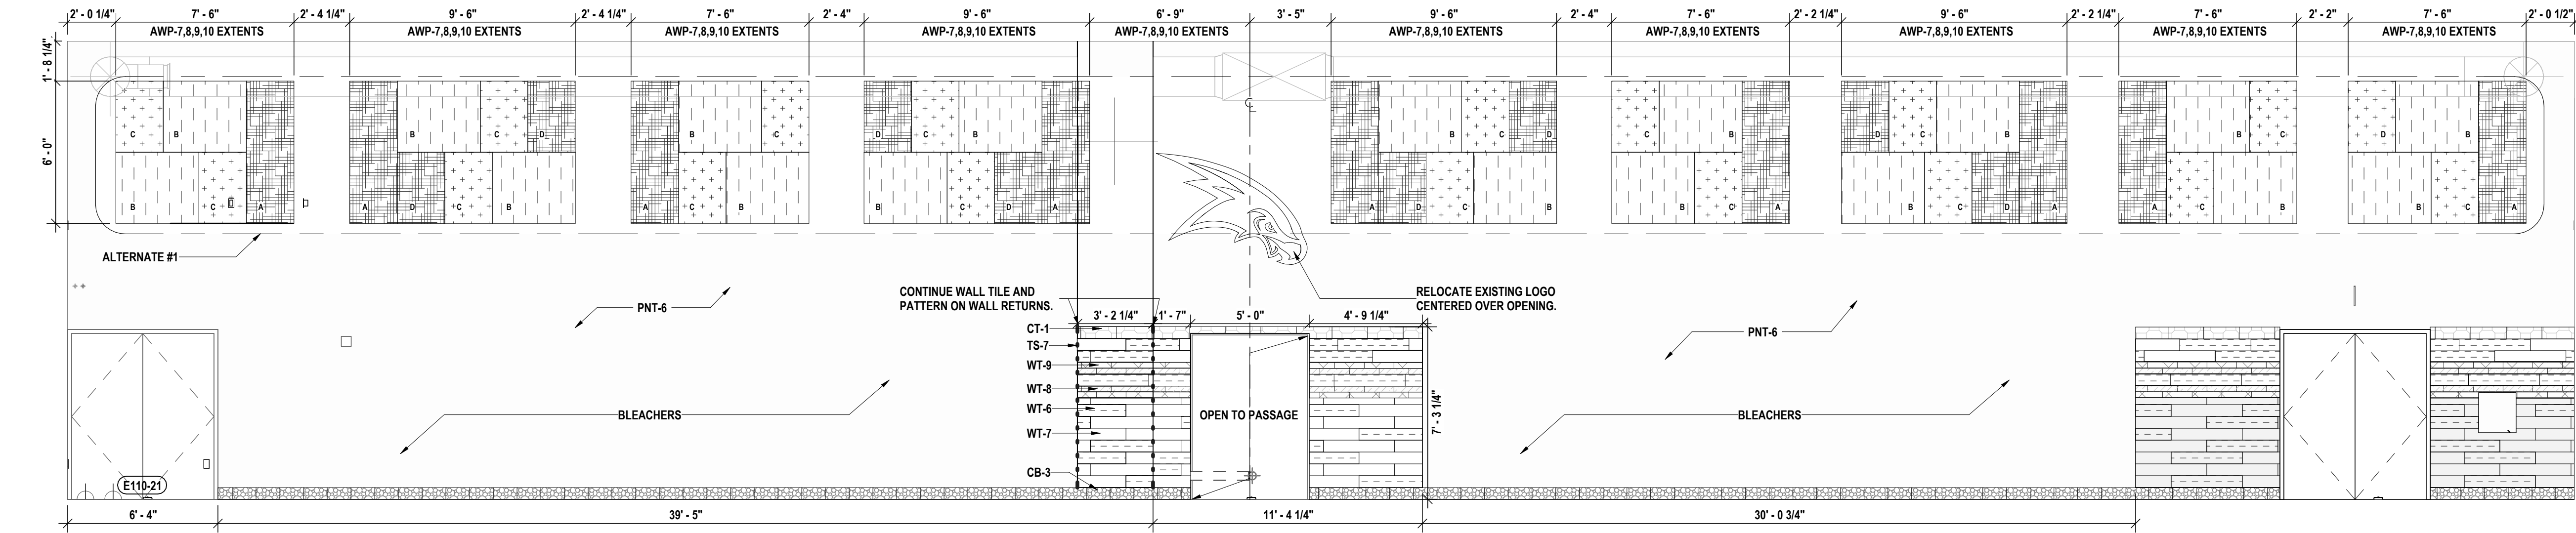


8 POOL ELEVATION - NORTH  
1/4" = 1'-0"

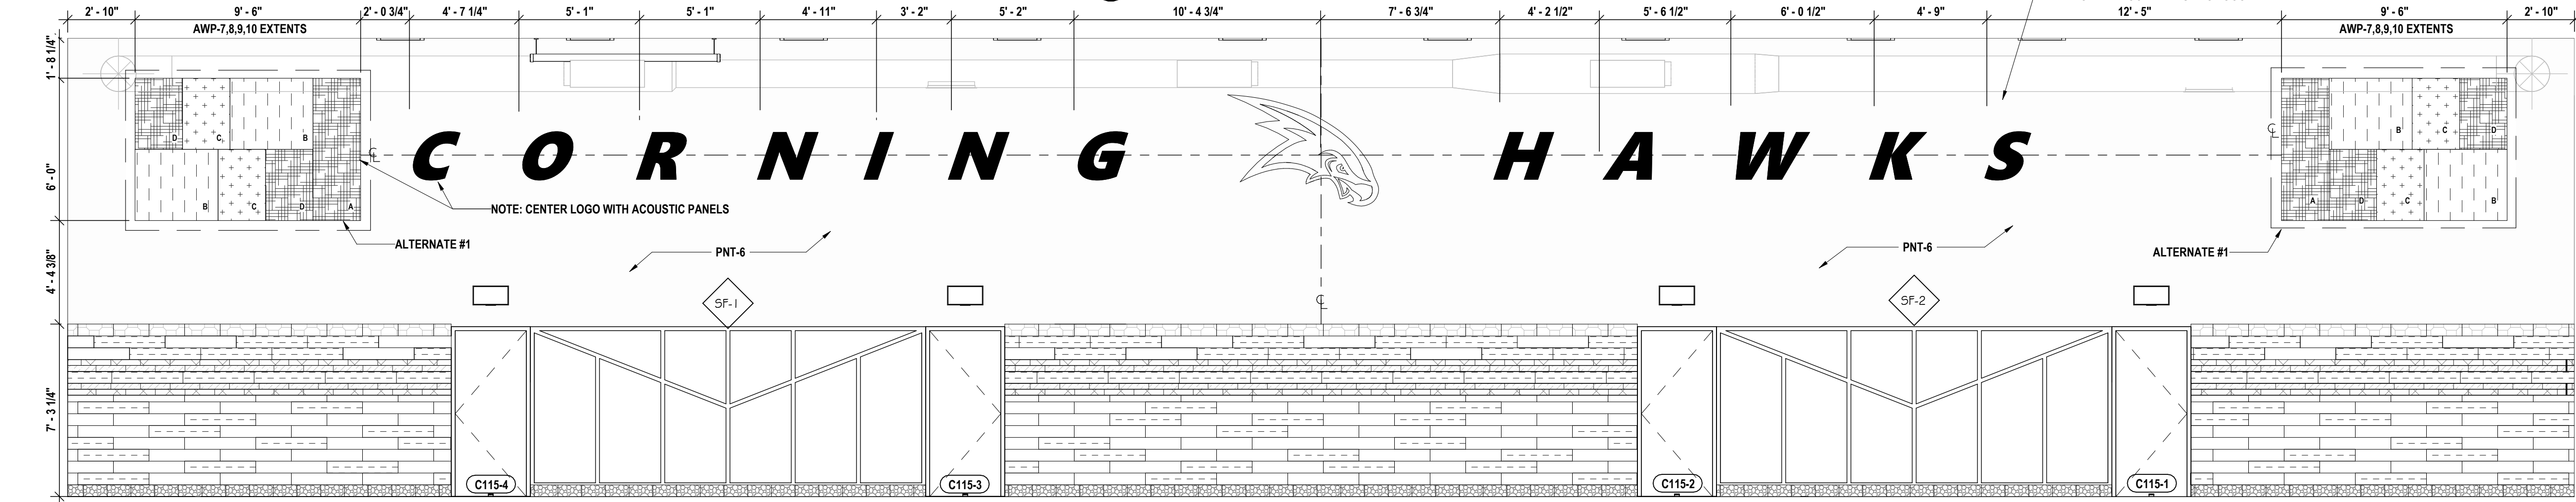


7 POOL ELEVATION - SOUTH  
1/4" = 1'-0"

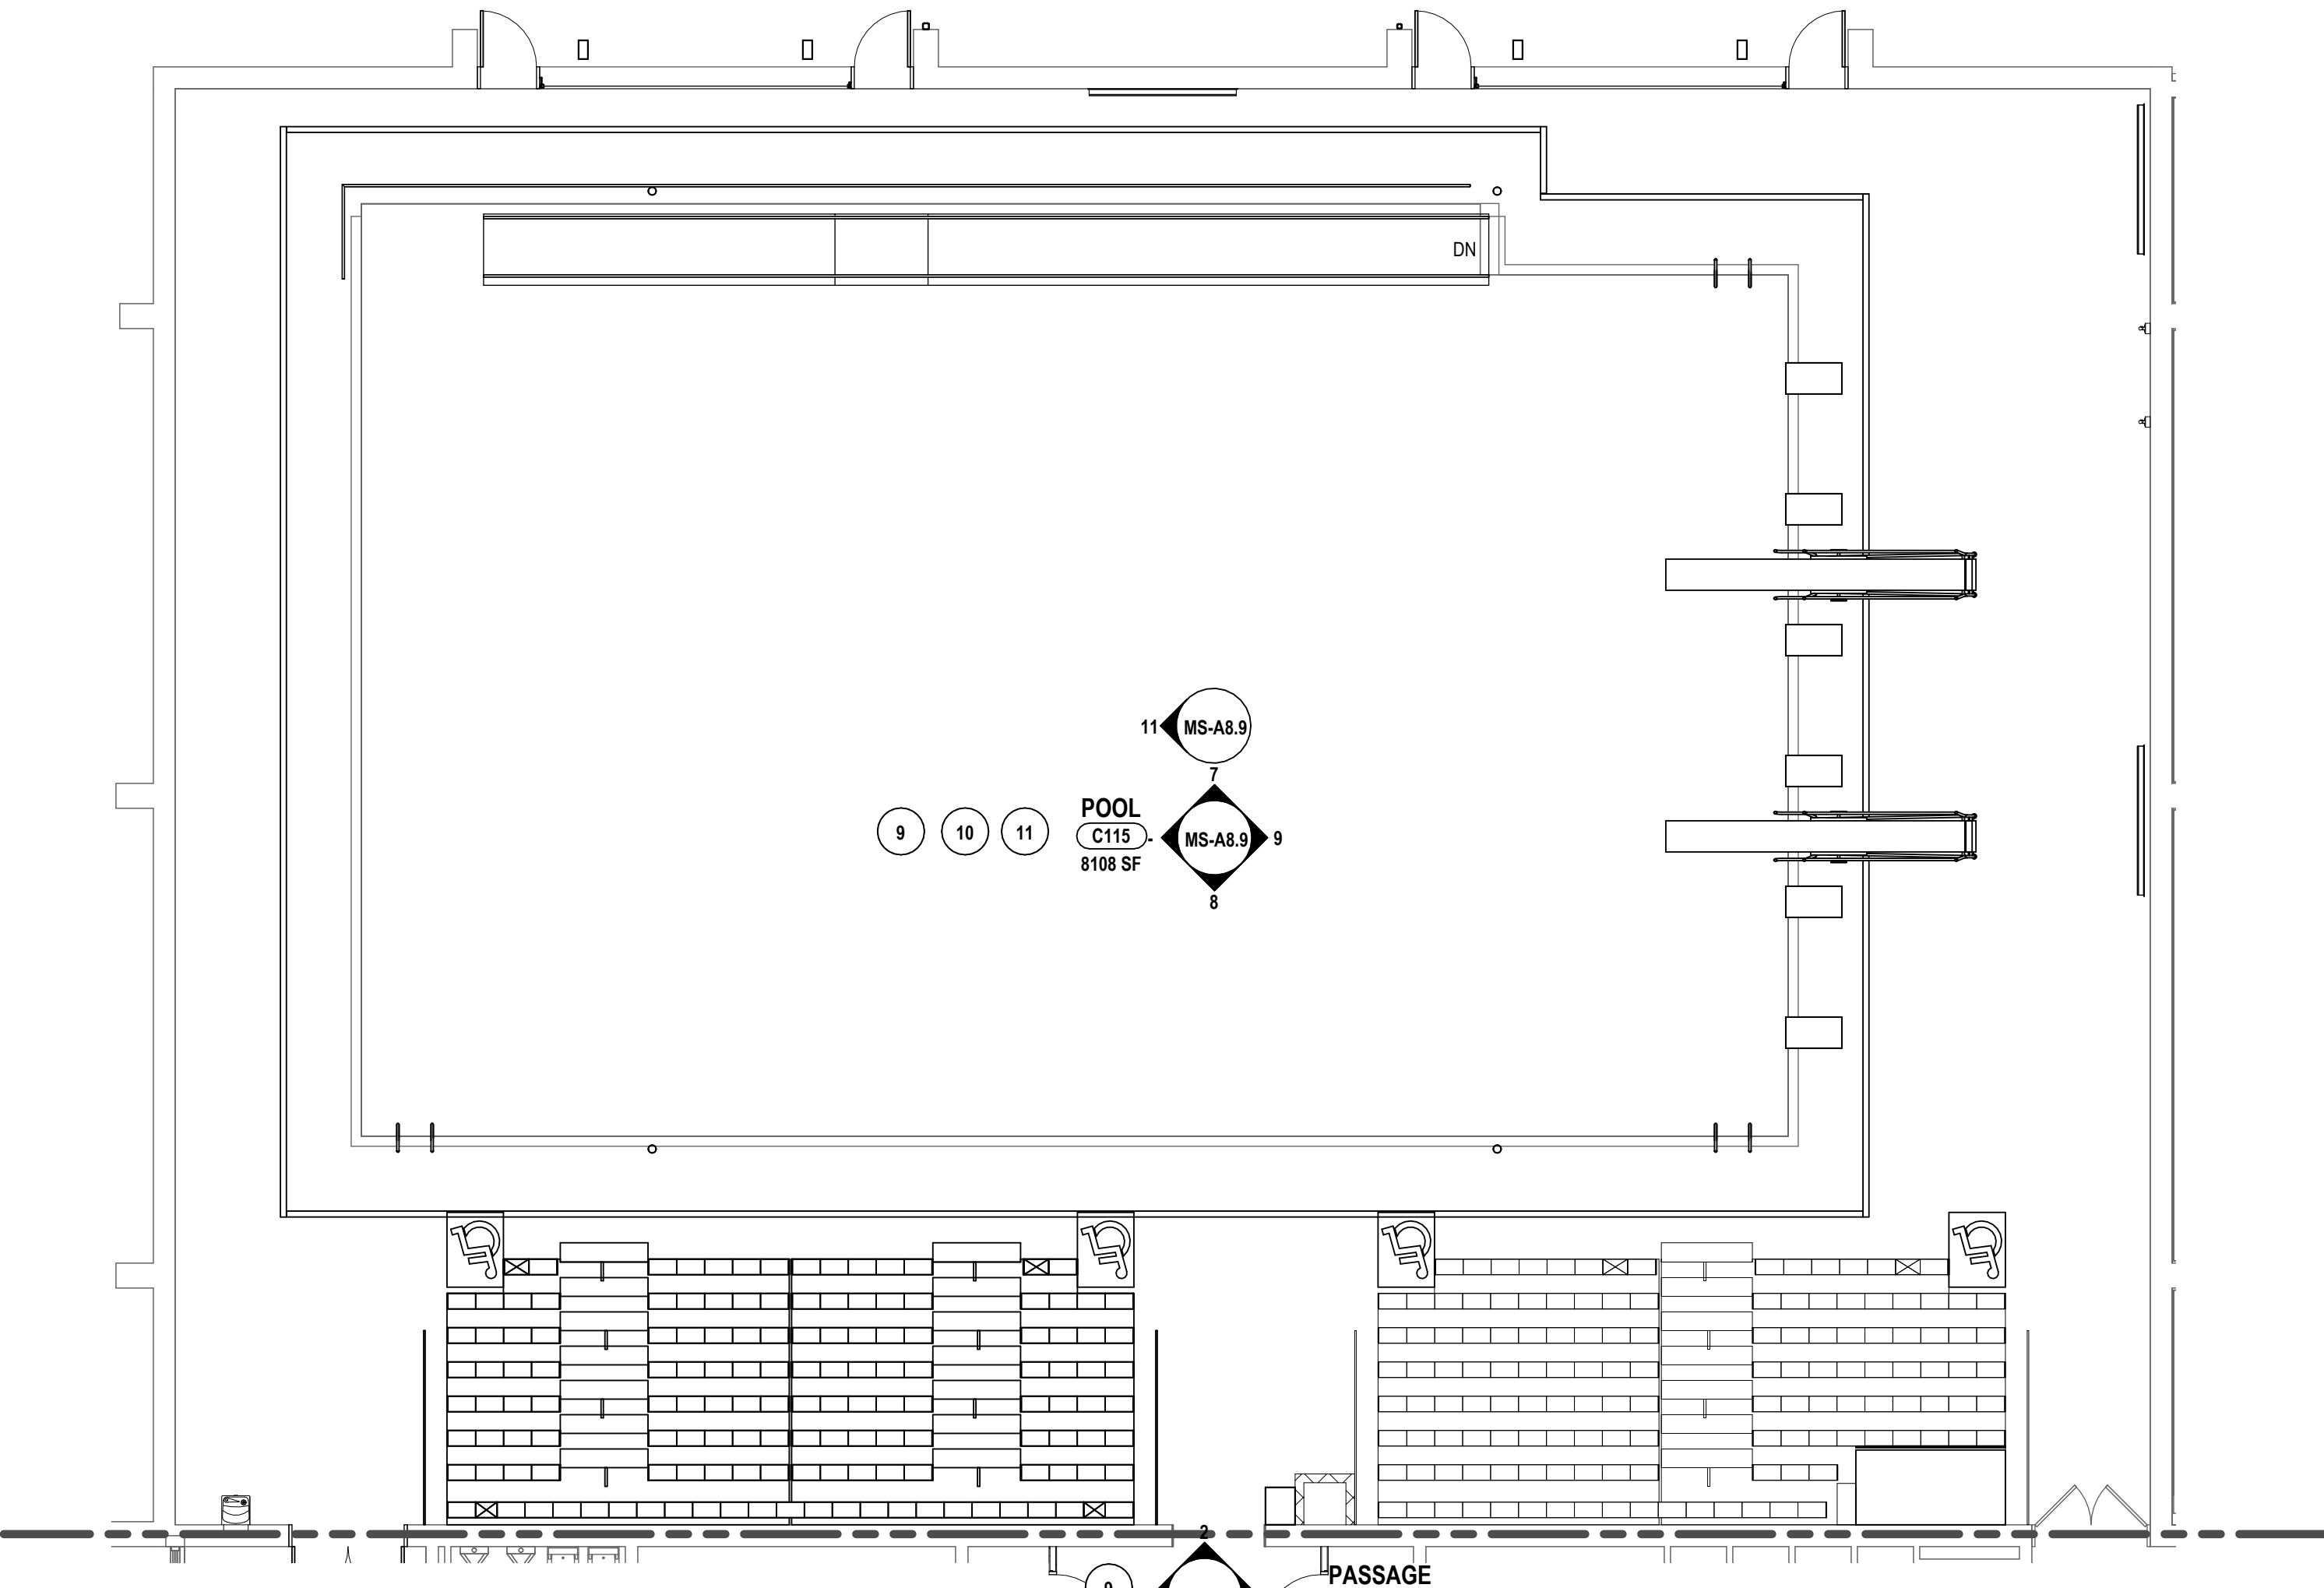


6 FIRST FLOOR WALL FINISH PLAN (2649.153) - AREA F  
1/8" = 1'-0"

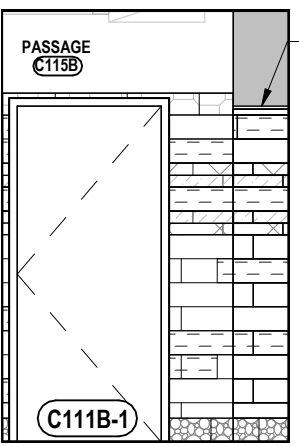


5 PASSAGE ELEVATION - WEST  
1/4" = 1'-0"

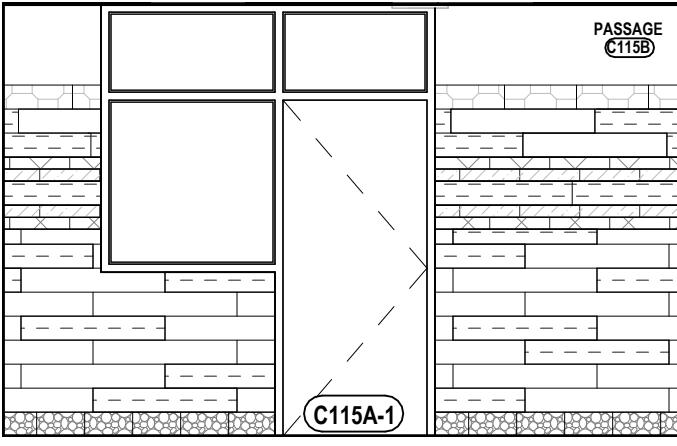


4 PASSAGE ELEVATION - SOUTH  
1/4" = 1'-0"

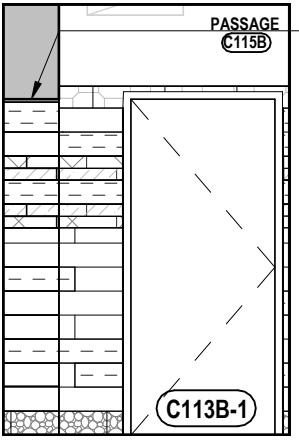


3 PASSAGE ELEVATION - EAST  
1/4" = 1'-0"

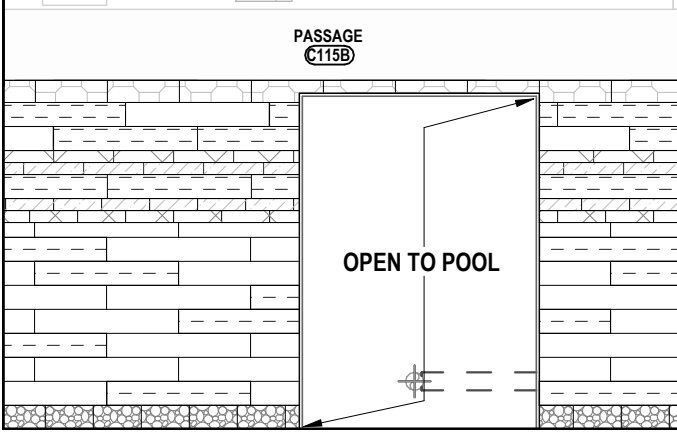

2 PASSAGE ELEVATION - NORTH  
1/4" = 1'-0"

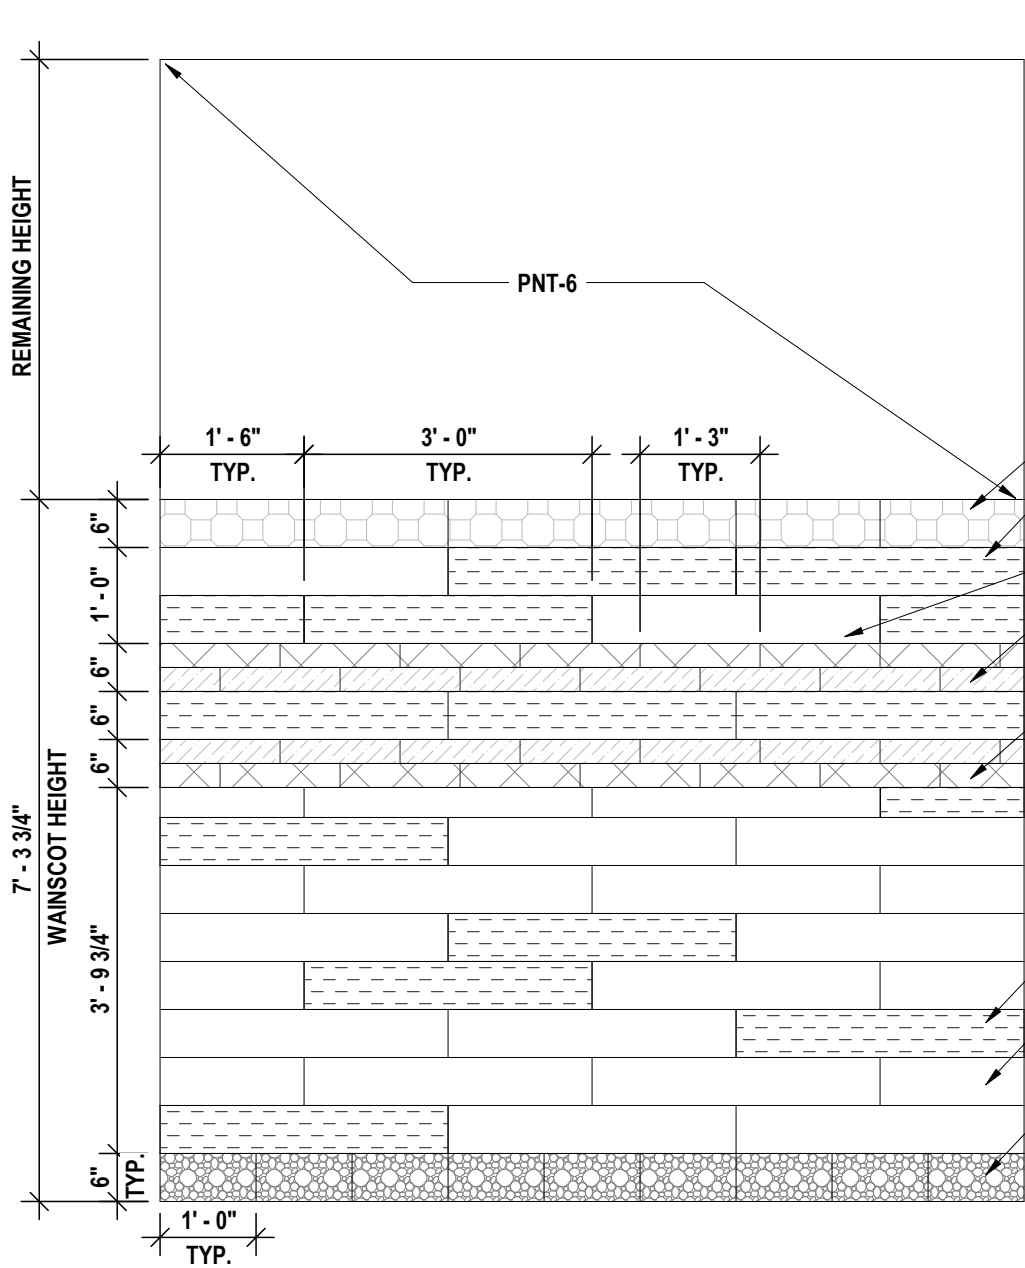

1 TYPICAL POOL WALL TILE INSTALLATION PATTERN  
1/2" = 1'-0"

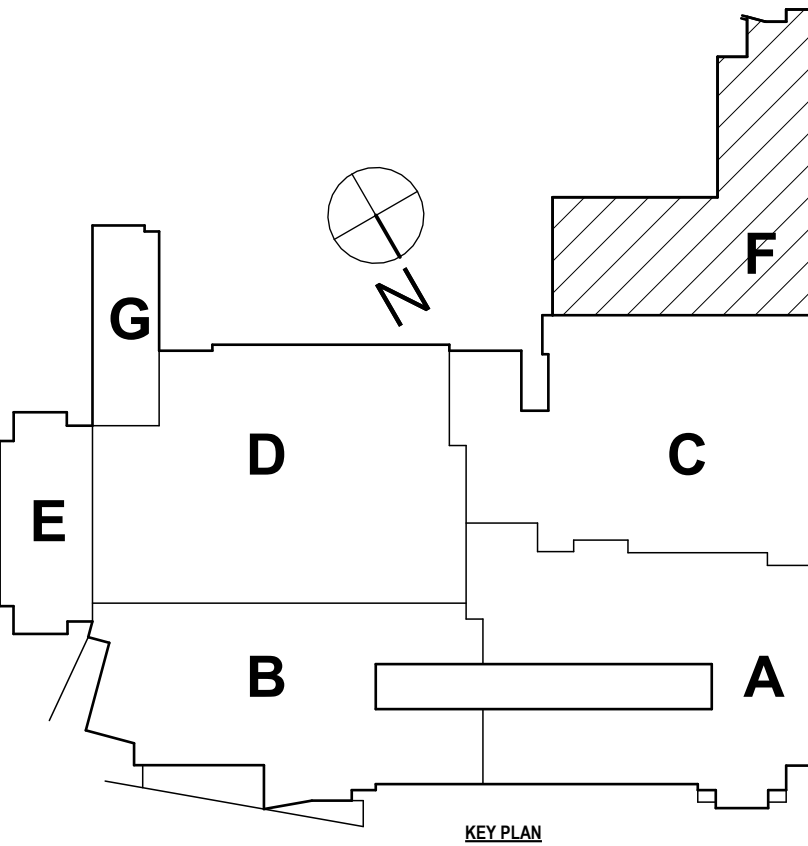

KEY PLAN

MS - FINISH KEY								
ABBR.	MATERIAL TYPE	MANUFACTURER	SERIES	SIZE	NUMBER	COLOR	SECTION #	REMARKS
ACOUSTIC CEILINGS								
ACB-1	PET FELT	ACOUFELT	INTERLACE - SOLACE	48" X 64" X 6"-12"D	MA15	MARINE	09 84 30	INSTRUMENTAL AND CHORAL MUSIC ROOMS
ACB-2	PET FELT	ACOUFELT	INTERLACE - SOLACE	48" X 52" X 6"-12"D	MA15	MARINE	09 84 30	CHORAL MUSIC ROOM
ACP-1	WOOD VENEER ACOUSTIC DIFFUSER	RPG ACOUSTICS	WAVEFORM MONORADIAL WAS SHOWN ON A2 & A8 DRAWINGS		-	CHERRY CLEAR COAT	09 84 16	CHORAL ROOM CEILING DIFFUSER PANELS
ACP-2	ACOUSTICAL CLOUD SYSTEM	TURF	FRAC TAL MODULAR CLOUD	36"L X 7.5"D	04, 26, 63	LIGHT GREY, FADED DENIM, SAFFLOWER	09 84 30	E103 CLASSROOM
ACP-3	MINERAL FIBER CEILING PANEL	ARMSTRONG COMMERCIAL CEILINGS	SOUNDSCAPES CANOPIES	48.5" X 75"	6259F01V01	WHITE	09 84 30	INSTRUMENTAL MUSIC ROOM
ACOUSTIC WALL PANELS								
AWP-1	RIGID FIBERGLASS WITH ACOUSTICALLY TRANSPARENT TEXTILE	KINETICS NOISE CONTROL / DUVALTEX	HARDSIDE - 2" THICK / MARIN 1300	VARIABLES	1149	BLACKTIP	09 84 30	INSTRUMENTAL MUSIC ROOM
AWP-2	RIGID FIBERGLASS WITH ACOUSTICALLY TRANSPARENT TEXTILE	KINETICS NOISE CONTROL / DUVALTEX	VERSATUNE - 4-1/8" THICK / MARIN 1300	VARIABLES	1148	GREY WHALE	09 84 30	INSTRUMENTAL MUSIC ROOM
AWP-3	RIGID FIBERGLASS WITH ACOUSTICALLY TRANSPARENT TEXTILE	KINETICS NOISE CONTROL / DUVALTEX	HARDSIDE - 2" THICK / MARIN 1300	VARIABLES	1155	SWELL	09 84 30	INSTRUMENTAL MUSIC ROOM
AWP-4	COPOLYMER ACOUSTIC DIFFUSER	KINETICS NOISE CONTROL	GEOMETRIC DIFFUSERS - OFFSET PYRAMID	24" X 48"	CUSTOM COLOR MATCH SW GEORGIAN BAY	09 84 16	CUSTOM COLOR MATCH SW GEORGIAN BAY	09 84 16
AWP-5	COPOLYMER ACOUSTIC DIFFUSER	KINETICS NOISE CONTROL	GEOMETRIC DIFFUSERS - OFFSET PYRAMID	24" X 24"	CUSTOM COLOR MATCH SW 6509	CUSTOM COLOR MATCH SW GEORGIAN BAY	09 84 16	INSTRUMENTAL MUSIC ROOM
AWP-6	PET FELT	ACOUFELT	FRAC TURE TILES 1-5	12" X 12"	MA15	MARINE	09 84 30	VOCAL MUSIC ROOM
AWP-7	PERFORATED METAL ACOUSTIC PANELS	KINETICS NOISE CONTROL	KNP-F	24" X 12"	RAL 7038	BTS GREY	09 84 30	POOL ACOUSTIC PANELS
AWP-8	PERFORATED METAL ACOUSTIC PANELS	KINETICS NOISE CONTROL	KNP-F	42" X 36"	RAL 7045	AVERTITT GREY	09 84 30	POOL ACOUSTIC PANELS
AWP-9	PERFORATED METAL ACOUSTIC PANELS	KINETICS NOISE CONTROL	KNP-F	24" X 36"	RAL 9004	BLACK	09 84 30	POOL ACOUSTIC PANELS
AWP-10	PERFORATED METAL ACOUSTIC PANELS	KINETICS NOISE CONTROL	KNP-F	24" X 36"	RAL 7045	AVERTITT GREY	09 84 30	POOL ACOUSTIC PANELS
BLEACHERS								
BL-1	PLASTIC BLEACHERS	INTERKAL	EXCELL SEAT MODULES	-	08	BLACK	12 66 13, 16	POOL
BL-2	PLASTIC BLEACHERS	INTERKAL	CONTOUR SEAT MODULES	-	08	BLACK	12 66 13	GYMNASIUM
CARPET TILE								
CPT-1	CARPET TILE	INTERFACE	OPEN AIR 418	19.69" X 19.69"	107044	NICKEL	09 68 13	GENERAL
CEILING SYSTEM								
ACT-1	ACOUSTICAL CEILING TILE	ARMSTRONG COMMERCIAL CEILINGS	ULTIMA HIGH NRC	24" x 24" x 7/8"	1941	WHITE	09 51 00	GENERAL ACT CEILINGS
ACT-2	CERAMIC & MINERAL FIBER CEILING PANEL	ARMSTRONG COMMERCIAL CEILINGS	CERAMAGUARD FINE FISSURED	24" x 24"	607	WHITE	09 51 00	LOCKER ROOM, TOILET ROOMS, & POOL OFFICE
AXT-1	EXTRUDED ALUMINUM PERIMETER TRIM	ARMSTRONG COMMERCIAL CEILINGS	AXIOM CLASSIC	6"H	AX68TR	WHITE	09 51 00	ART CLASSROOMS - CEILING CLOUD PERIMETER
CERAMIC TRIM								
CB-1	QUARRY TILE	DALTILE	QUARRY TEXTURES	5" X 6" ROUND TOP COVE BASE	0T03	ASHEN GRAY	09 30 00	KITCHEN / SERVERY
CB-2	PORCELAIN TILE COVE BASE	CROSSVILLE / TILE WHOLESALERS	NEST	6" X 12" - COVE BASE	AV363	BLISSFUL OLIVE	09 30 00	TOILET ROOMS
CB-3	PORCELAIN TILE COVE BASE	CROSSVILLE / TILE WHOLESALERS	MAIN STREET	6" X 12" - COVE BASE	AV215	BOUQTUE BLACK	09 30 00	GENERAL POOL DECK FLOOR
CB-4	PORCELAIN TILE BASE	CROSSVILLE / TILE WHOLESALERS	MAIN STREET - GET PLANKED	4" X 12" - STRAIGHT	AV215	BOUQTUE BLACK	09 30 00	CORRIDORS
CT-1	PORCELAIN TILE BULLNOSE TRIM	CROSSVILLE / TILE WHOLESALERS	NEST - BULLNOSE	6" X 18" - BULLNOSE	AV365	PEACEFUL OLIVE	09 30 00	POOL AND PASSAGE - MATCHING BULLNOSE TRIM
CT-2	PORCELAIN TILE BULLNOSE TRIM	CROSSVILLE / TILE WHOLESALERS	RETROACTIVE 2.0 - BULLNOSE	4" X 12" - BULLNOSE	RET04 - UPS	EMPRESS WHITE	09 30 00	TOILET ROOMS BULLNOSE BORDER
CONCRETE FLOORING								
CF-1	CONCRETE TOPPER	EUCLID CHEMICAL	LEVEL TOP POLISH	-	407CSG 50	STEEL GRAY	03 35 45	ART ROOMS / GYM MEZZANINE
FLOOR TILE								
FT-1	COLORBODY PORCELAIN MOSAIC TILE	DALTILE	KEYSTONES MOSAIC BLEND	2" X 2"	DK-21	WHEAT BLEND	09 30 00	TOILET ROOMS
FT-2	QUARRY TILE	DALTILE	QUARRY TEXTURES	8" X 8"	0T03	ASHEN GRAY	09 30 00	KITCHEN / SERVERY
FT-3	COLORBODY PORCELAIN MOSAIC TILE	DALTILE	KEYSTONES	2" X 2"	D617	ARCTIC WHITE	09 30 00	POOL DECK
FT-4	COLORBODY PORCELAIN MOSAIC TILE	DALTILE	KEYSTONES	2" X 2"	D182	SUEDE GREY	09 30 00	POOL DECK
FT-5	COLORBODY PORCELAIN MOSAIC TILE	DALTILE	KEYSTONES MOSAIC BLEND	2" X 2"	CUSTOM BLEND	65% ARCTIC WHITE, 17% LUMINARY GOLD, 17% CASTLEROCK	09 30 00	POOL DECK BORDER
FT-6	COLORBODY PORCELAIN MOSAIC TILE	DALTILE	KEYSTONES	1" X 1"	D617	ARCTIC WHITE	09 30 00	POOL BORDER GENERAL, RAMP
FT-7	COLORBODY PORCELAIN MOSAIC TILE	DALTILE	KEYSTONES	1" X 1"	D618	CASTLEROCK	09 30 00	POOL BORDER ACCENT, RAMP BORDER
FT-8	COLORBODY PORCELAIN MOSAIC TILE	DALTILE	KEYSTONES	1" X 1"	D311	BLACK	09 30 00	POOL DEPTH MARKERS & IN-POOL LANE MARKERS.
GROUT								
G-1	PREMIXED GROUT WITH EPOXY PERFORMANCE	LATICRETE	SPECTRALOCK ONE	-	85	ALMOND	09 30 00	TOILET ROOM WALLS
G-2	EPOXY GROUT	LATICRETE	SPECTRALOCK PRO PREMIUM	-	60	DUSTY GREY	09 30 00	TOILET ROOM FLOORS
G-3	PREMIXED GROUT WITH EPOXY PERFORMANCE	LATICRETE	SPECTRALOCK ONE	-	-	MATCH EXISTING CORRIDOR GROUT	09 30 00	CORRIDOR WALLS
G-4	EPOXY GROUT	LATICRETE	SPECTRALOCK PRO PREMIUM	-	35	MOCHA	09 30 00	KITCHEN / SERVERY FLOORS
G-5	PREMIXED GROUT WITH EPOXY PERFORMANCE	LATICRETE	SPECTRALOCK ONE	-	97	IRON	09 30 00	POOL WALLS
G-6	EPOXY GROUT	LATICRETE	SPECTRALOCK PRO PREMIUM	-	44	BRIGHT WHITE	09 30 00	POOL FLOOR
HIGH PRESSURE LAMINATE								
HPL-1	LAMINATE	WILSONART	STANDARD LAMINATE	-	TBD	TBD	12 36 00	CLASSROOM LAMINATE COUNTERTOPS - MATCH EXISTING HPL COUNTERTOPS
LOCKERS								
LK-1	CLASS A HDPE PLASTIC CUBBIES	SCRANTON PRODUCTS	DURALIFE HDPE CUBBIES - ORANGE PEEL TEXTURE	-	-	SANDCASTLE	10 51 26	POOL STORAGE CUBBIES
PAINT								
PNT-1	PAINT	SHERWIN WILLIAMS - COLOR MATCH BENJAMIN MOORE	-	-	CUSTOM COLOR MATCH - BM OC-33	CUSTOM COLOR - MATCH BM OPALINE	09 91 23	FIELD
PNT-2	PAINT	SHERWIN WILLIAMS	-	-	6249	STORM CLOUD	09 91 23	ACCENTS AND CORRIDOR SOFFITS
PNT-3	PAINT	SHERWIN WILLIAMS - COLOR MATCH BENJAMIN MOORE	-	-	CUSTOM COLOR MATCH - HC-168	CUSTOM COLOR - MATCH BM CHELSEA GRAY	09 91 23	HM DOOR FRAMES, WINDOW FRAMES, DOOR VISOR PANEL FRAMES, EXPOSED COLUMNS IN CORRIDORS
PNT-4	PAINT	SHERWIN WILLIAMS	-	-	7007	CELING BRIGHT WHITE	09 91 23	CNS SOFFITS & EXPOSED CEILINGS
PNT-5	PAINT	SHERWIN WILLIAMS	-	-	6509	GEORGIAN BAY	09 91 23	BAND & ART ROOM ACCENT
PNT-6	PAINT	SHERWIN WILLIAMS	-	-	7006	EXTRA WHITE	09 91 23	ART CLASSROOMS
POOL LINER								
MC-1	MARGITE	MARGITE	-	-	-	WHITE	13 11 00	POOL LINER
RESILIENT BASE								
RB-1	RUBBER BASE	ROPPE	700 SERIES	4"H	639	BEIGEWOOD	09 65 00	PTM
RB-2	RUBBER BASE	ROPPE	700 SERIES	4"H	667	GALACTIC	09 65 00	GENERAL
RESILIENT FLOORING								
RF-1	RUBBER FLOOR TILE	AMERICAN BILTTRITE	ABPURE - HAMMERED	20" X 20"	ABM-34	GLACIAR	09 65 00	BAND ROOM FIELD
RF-2	RUBBER FLOOR TILE	AMERICAN BILTTRITE	ABPURE - HAMMERED	20" X 20"	ABM-90	BABY BLUE	09 65 00	BAND ROOM ACCENT
RF-3	RUBBER FLOOR TILE	AMERICAN BILTTRITE	ABPURE - HAMMERED	20" X 20"	ABM-98	BLUE LAGOON	09 65 00	BAND ROOM ACCENT
SHOWER CURTAIN								
SHWC-1	VINYL SHOWER CURTAIN	INPRO	BRUSHSTROKE	-	-	DWELL	10 28 00	LOCKER ROOM ADA TOILET ROOMS
SOLID SURFACE								
SSM-1	SIMULATED STONE	CORIAN	GROUP 3	-	-	DEEP ANTHRACITE	12 36 00	TECH ROOM SINK COUNTERTOP
TERRAZZO BASE								
TZB-1	PRE-CAST EPOXY TERRAZZO BASE	TERRAZZO & MARBLE SUPPLY	TERROXY RESIN	4" H	TM#25-324	DARK GREY	09 66 23	CORRIDOR FIELD
TERRAZZO FLOORING								
TZ-1	EPOXY TERRAZZO	TERRAZZO & MARBLE SUPPLY	TERROXY RESIN	-	TM#25-324	DARK GREY	09 66 23	CORRIDOR BORDER
TZ-2	EPOXY TERRAZZO	TERRAZZO & MARBLE SUPPLY	TERROXY RESIN	-	TM#25-325	MEDIUM GREY	09 66 23	CORRIDOR ACCENT
TZ-3	EPOXY TERRAZZO	TERRAZZO & MARBLE SUPPLY	TERROXY RESIN	-	TM#25-328	LIGHT GREY	09 66 23	CORRIDOR ACCENT
TZ-4	EPOXY TERRAZZO	TERRAZZO & MARBLE SUPPLY	TERROXY RESIN	-	CUSTOM MATCH - BM 972 ALASKAN SKIES	10% FIREBEL MOTHER OF PEARL #1, 10% ENVIROCLEAR #1, 20% ITALIAN YELLOW VERONA #0, 60% CHINA WHITE #1.	09 66 23	CORRIDOR ALCOVES - MATCH EXISTING ALCOVES
TOILET PARTITIONS								
TP-1	HDPE PLASTIC TOILET PARTITIONS	SCRANTON PRODUCTS	HINY HIDERS	V.I.F.	-	BLACK ORANGE PEEL	10 21 13-17	TOILET ROOM PARTITIONS & LOCKER ROOM CHANGING STALLS
TRANSITION STRIPS								
TS-1	STAINLESS STEEL	SCHLUTER	JOLLY	AS REQ'D BY TILE THICKNESS	-	BRUSHED STAINLESS STEEL	09 30 00	EXPOSED EDGES OF TILE
TS-2	STAINLESS STEEL	SCHLUTER	QUADEC	AS REQ'D BY TILE THICKNESS	-	BRUSHED STAINLESS STEEL	09 30 00	OUTSIDE CORNERS OF TILE
TS-3	STAINLESS STEEL	SCHLUTER	RENO-U	AS REQ'D BY FLOORING THICKNESS AND ADA	-	BRUSHED STAINLESS STEEL	09 30 00	TILE TO LOWER HEIGHT FLOORING TRANSITIONS
TS-4	STAINLESS STEEL	SCHLUTER	ECK-E	AS REQ'D BY TILE THICKNESS	-	BRUSHED STAINLESS STEEL	09 30 00	CORNER GUARDS
TS-5	RUBBER	ROPPE	ADAPTORS AND TRANSITIONS	AS REQ'D BY FLOORING THICKNESS AND ADA	123	CHARCOAL	09 65 00	CARPET TO LOWER HEIGHT FLOORING TRANSITIONS
TS-6	ZINC DIVIDER STRIP	DOMUS	L-DIVIDER	AS REQ'D BY FLOORING THICKNESS AND ADA	-	ZINC	09 66 23	TERRAZZO FLOORING & CONCRETE TOPPER EDGE STRIP
TS-7	STAINLESS STEEL 316	PROFILITEC	SQUAREJOLLY	AS REQ'D BY TILE THICKNESS	-	POLISHED STAINLESS STEEL	09 30 00	OUTSIDE CORNERS AND EXPOSED EDGES OF TILE FOR POOL APPLICATIONS
WALL PADS								
WP-1	VINYL WALL PADS	DRAPER	ECOVISION	V.I.F.	-	BLACK	11 66 23	AUXILIARY GYM
WP-2	VINYL WALL PADS	DRAPER	ECOVISION	V.I.F.	-	BEIGE	11 66 23	AUXILIARY GYM ACCENT

MS - FINISH KEY								
ABBR.	MATERIAL TYPE	MANUFACTURER	SERIES	SIZE	NUMBER	COLOR	SECTION #	REMARKS
WALL TILE								
WT-1	PORCELAIN TILE	CROSSVILLE / TILE WHOLESALERS	RETROACTIVE 2.0	6" X 24"	RET04 - UPS	EMPRESS WHITE	09 30 00	TOILET ROOM FIELD
WT-2	PORCELAIN TILE	CROSSVILLE / TILE WHOLESALERS	NEST	6" X 36"	AV363	BLISSFUL OLIVE	09 30 00	TOILET ROOMS ACCENT
WT-3	PORCELAIN TILE	DALTILE	HARMONIST	8" X 12"	HM30	CELESTIA	09 30 00	CORRIDOR FIELD - CUSTOM FACTORY CUT, ALLOW 8-10 WEEKS FOR PRODUCTION
WT-4	PORCELAIN TILE	CROSSVILLE / TILE WHOLESALERS	MAIN STREET - GET PLANKED	4" X 12"	AV212	CAFE CARAMEL	09 30 00	CORRIDOR ACCENT - ALIGN TO EXISTING BAND
WT-5	GLAZED CERAMIC	FLORIDA TILE / TILE WHOLESALERS	EMOTIVE	3" X 6"	EMV3G	COY GREY - GLOSSY FINISH	09 30 00	CORRIDOR ACCENT
WT-6	PORCELAIN STONE	CROSSVILLE / TILE WHOLESALERS	NEST	6" X 36"	AV365	PEACEFUL OLIVE	09 30 00	POOL WALL
WT-7	PORCELAIN STONE	CROSSVILLE / TILE WHOLESALERS	NEST	6" X 36"	AV361	LEVITY OLIVE	09 30 00	POOL WALL
WT-8	PORCELAIN STONE	CROSSVILLE / TILE WHOLESALERS	NEST	3" X 15"	AV365	PEACEFUL OLIVE	09 30 00	POOL WALL
WT-9	PORCELAIN STONE	CROSSVILLE / TILE WHOLESALERS	NEST	3" X 15"	AV361	LEVITY OLIVE	09 30 00	POOL WALL
WINDOW TREATMENTS								
WS-1	POLYESTER COATED FIBERGLASS	DRAPER INC. / PFIFER	MANUAL FLEXSHADE / SHEERWEAVE SW7100	-	P02	WHITE	12 24 00	CLASSROOM WINDOWS
WOOD STAIN								
STM-1	WATER-BASED STAIN	MINWAX	-	-	-	PTM	06 41 00	CASEWORK & DOOR STAIN TO MATCH EXISTING.
STM-2	WATER-BASED GYM FLOOR FINISH	BONA	SUPERSPORT SERIES - DRIVE	-	-	CLEAR	09 64 30	GYM FLOOR

DESCRIPTION OF REVISION:  
ISSUED FOR BID

# 1

DATE: 1/10/2025

DRAWN BY: JR

CHECKED BY: MLR

DATE: 05/09/2025

PHASE: CD

IT IS A VIOLATION OF THE LAW FOR ANY PERSON TO MAKE UNAUTHORIZED ALTERATIONS OR ADDITIONS TO PLANS

DEVELOPED & LICENSED ARCHITECTS & SURVEYORS BUREAU

INTERIOR FINISH KEY

2025 MIDDLE SCHOOL PHASE III ALTERATIONS PROJECT

CORNING-PAINTED POST ASD

35 VICTORY HIGHWAY, PAINTED POST, NY 14870

MS-A9.1

PROJECT NO: 2649-133

57-10-00-01-0-02-0-044 - MIDDLE SCHOOL

HUNT ENGINEERS | ARCHITECTS | SURVEYORS


HORSEHEADS, NY 607-268-1000 ROQUESTER, NY 565-237-7669 TOWNANDA, PA 670-265-4668 BINGHAMTON, NY 607-738-8881 ALBANY, NY 607-738-8801

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NY CERTIFICATE NO. 001620 PA CERTIFICATE NO. TSC220131464-1





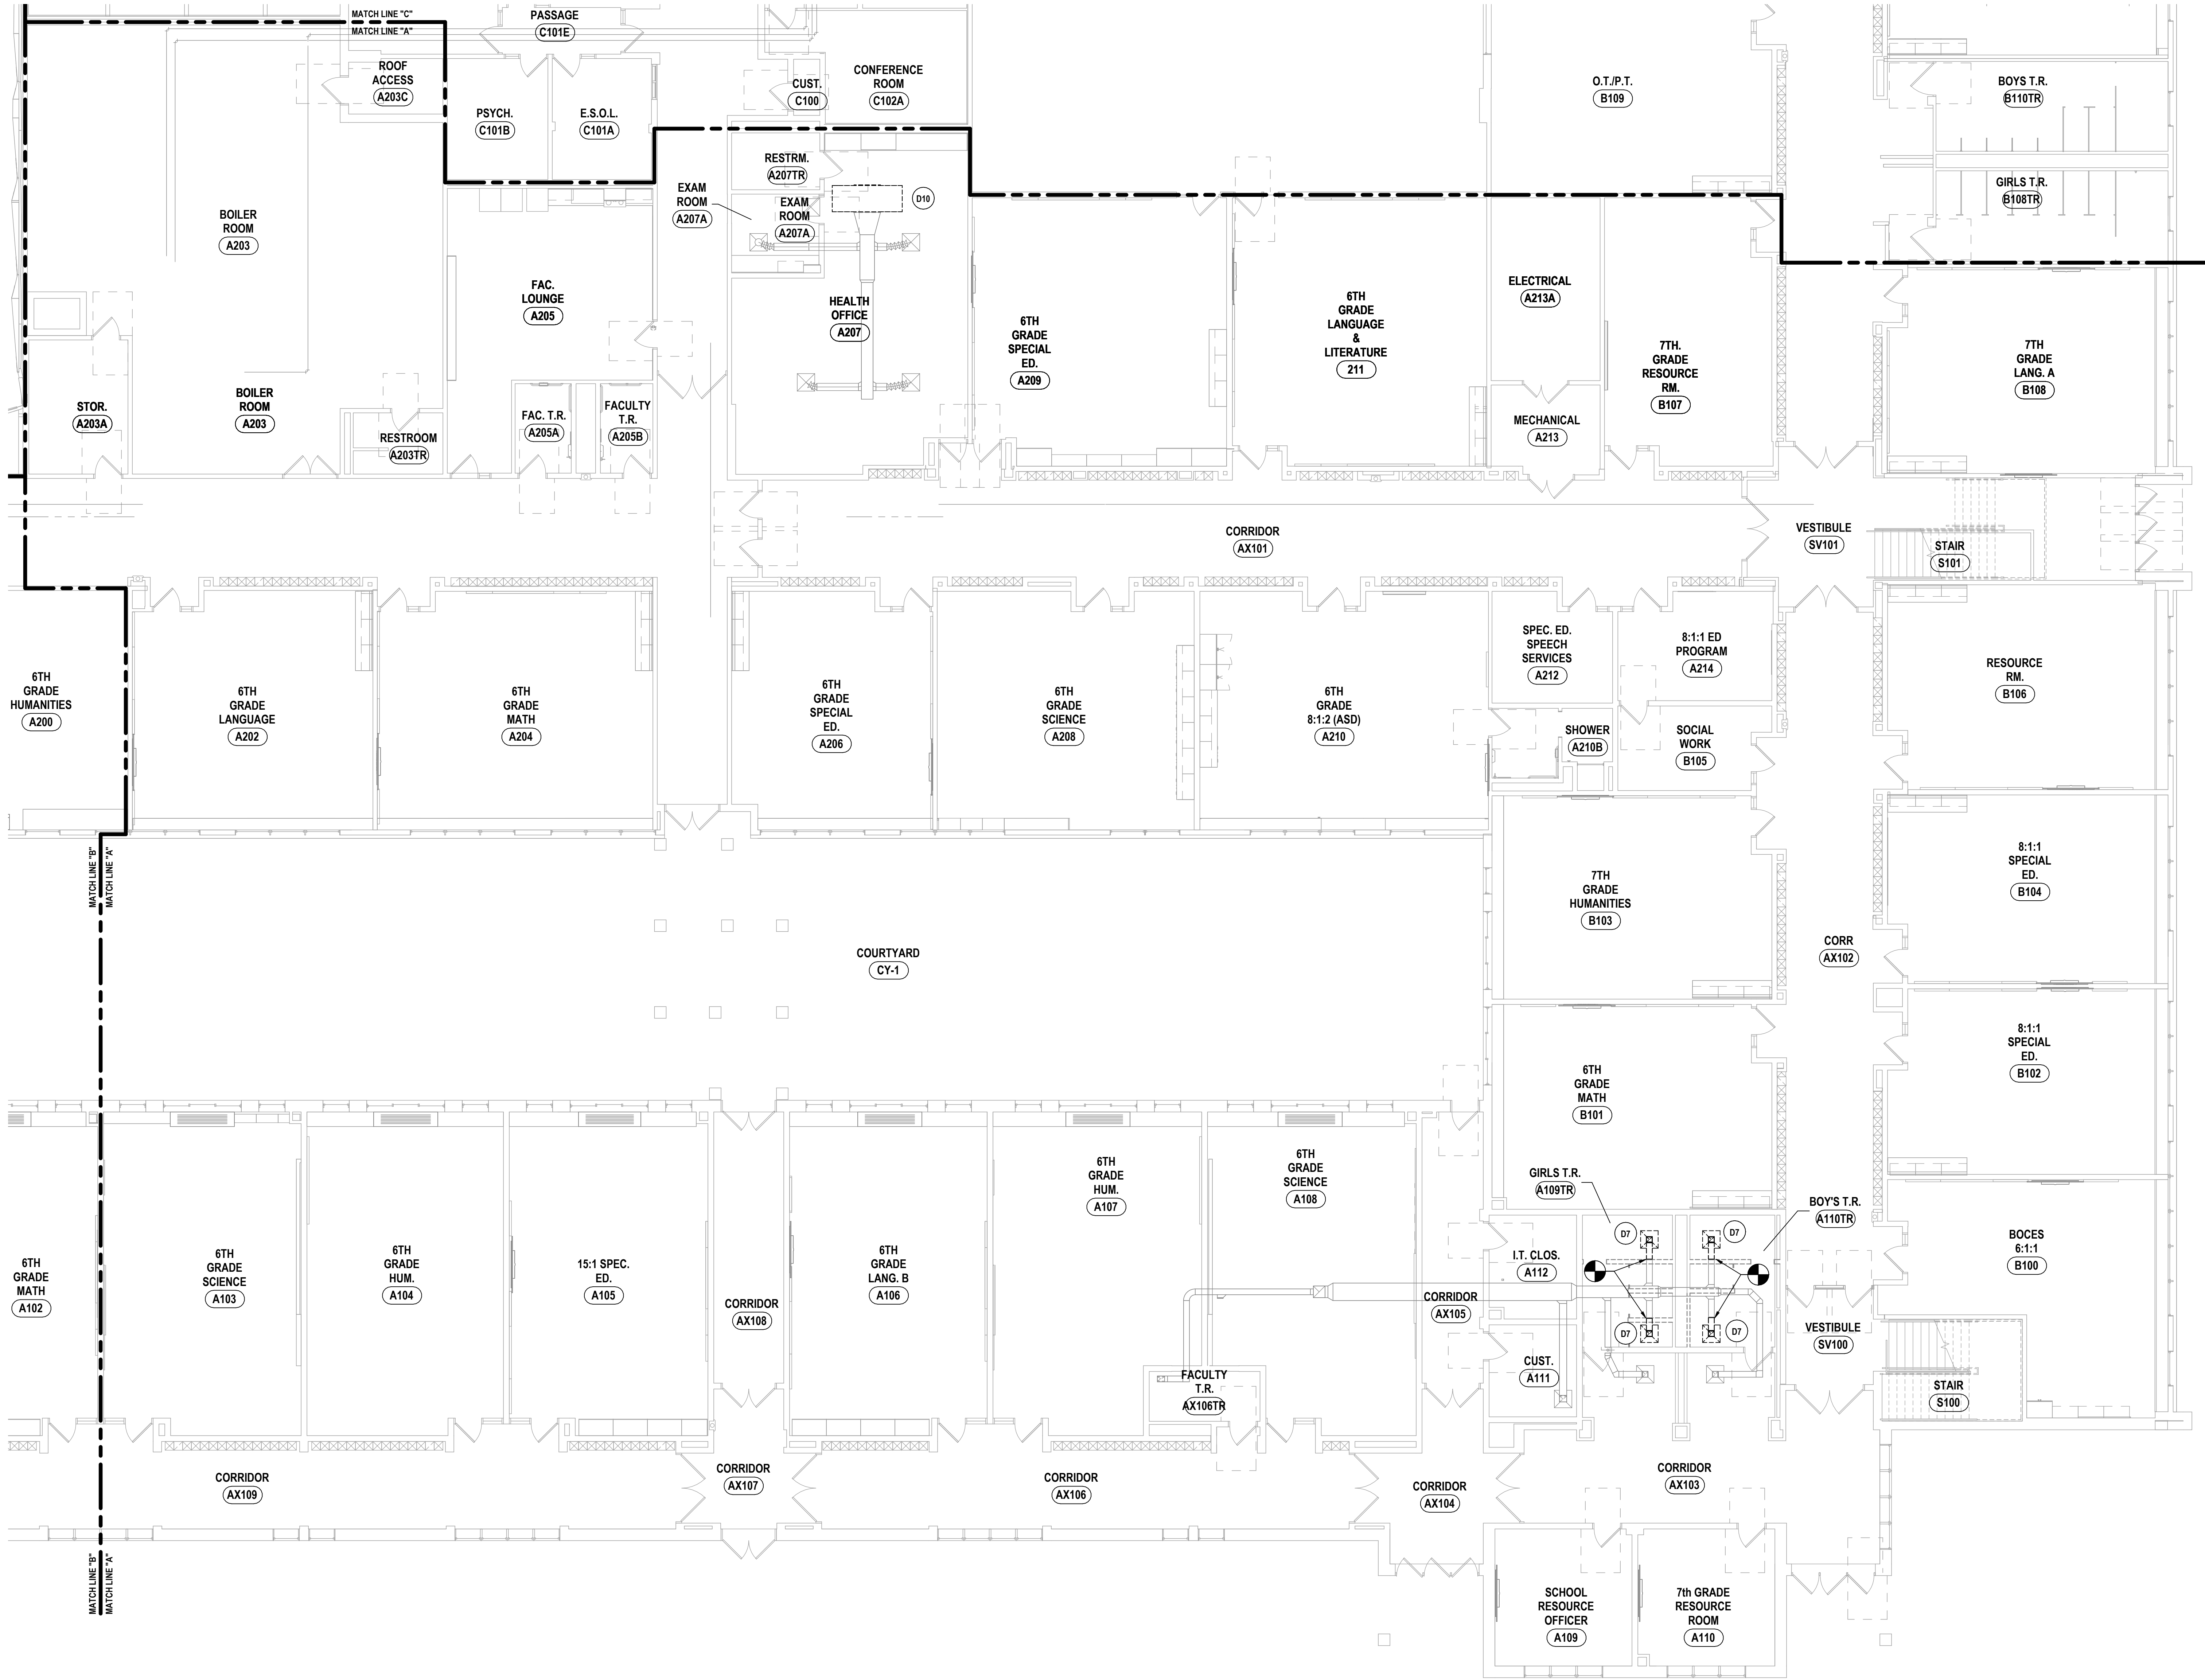


GENERAL NOTES - MECHANICAL

- A ALL WORK ON THIS DRAWING IS THE RESPONSIBILITY OF THE CONTRACTOR UNLESS CLEARLY INDICATED TO BE PART OF THE PRIME CONTRACT.
- B THIS DRAWING IS INTENDED TO SHOW THE GENERAL SCOPE OF ITEMS TO BE REMOVED. IT IS NOT INTENDED TO BE ALL INCLUSIVE. THE CONTRACTOR SHALL FIELD VERIFY ALL ITEMS TO BE REMOVED. ANY ITEM IN QUESTION SHOULD BE VERIFIED WITH THE ENGINEER PRIOR TO REMOVAL.
- C ALL ITEMS SCHEDULED FOR DEMOLITION ARE THE PROPERTY OF THE OWNER. THE CONTRACTOR SHALL PLACE WANTED EQUIPMENT IN AREA DESIGNATED, ON SITE BY THE OWNER. ANY ITEM THE OWNER WISHES NOT TO KEEP SHALL BE DISPOSED OF BY THE CONTRACTOR. THE CONTRACTOR WILL BE RESPONSIBLE FOR ALL CUTTING AND PATCHING UNLESS CLEARLY INDICATED TO BE PART OF ANOTHER PRIME CONTRACT. CONTRACTOR TO PATCH TO MATCH ALL EXISTING FINISHES RESULTING FROM DEMOLITION WORK UNLESS INDICATED TO BE PART OF ANOTHER PRIME CONTRACT.
- E THE CONTRACTOR SHALL REMOVE, PROTECT, REPLACE AND/OR REINSTALL ANY CEILING OR GRID DAMAGED OR REMOVED AS A RESULT OF WORK INDICATED ON THESE DRAWINGS.
- F REINSULATE ALL PORTIONS OF EXISTING HVAC SYSTEMS DISTURBED DURING INSTALLATION OF NEW SYSTEMS.
- G PRIOR TO CONSTRUCTION AND INSTALLATION OF NEW WORK, THE CONTRACTOR SHALL FIELD VERIFY ALL EXISTING CONDITIONS (FRAMING, ELECTRICAL, PLUMBING, HVAC, ETC.). NOTIFY ARCHITECT/ENGINEER OF ANY CONFLICTS THAT REQUIRE MODIFICATION TO NEW HVAC SYSTEM INSTALLATION.
- H COORDINATE ALL NEW ROOF, WALL, AND FLOOR PENETRATIONS WITH OTHER TRADES.
- I ALL WORK SHALL BE INSTALLED IN ACCORDANCE WITH 2020 NYS BUILDING CODE, 2020 NYS MECHANICAL CODE, 2020 NYS FUEL GAS CODE, & NFPA STANDARD 2961.

DEMOLITION NOTES

- D1 REMOVE DUCTWORK & ALL ASSOCIATED ACCESSORIES BACK TO POINTS INDICATED.
- D2 REMOVE HWIS & ALL ASSOCIATED ACCESSORIES IN THEIR ENTIRETY.
- D3 REMOVE HWISIR & ALL ASSOCIATED ACCESSORIES IN THEIR ENTIRETY BACK TO POINTS INDICATED.
- D4 REMOVE HWISIR BACK TO POINTS INDICATED AND CAP.
- D5 REMOVE DUST COLLECTOR, RECIRCULATION STYLER FILTER UNITS, AND ALL ASSOCIATED ACCESSORIES IN THEIR ENTIRETY.
- D6 DISCONNECT AND REMOVE COIL, DUCTWORK, AND ALL ASSOCIATED ACCESSORIES BACK TO POINTS INDICATED.
- D7 REMOVE CEILING MOUNTED DIFFUSER/REGISTER/GRILLE, DISCONNECT FROM DUCTWORK, RETAIN & PROTECT THE EXISTING REGISTERS, GRILLES & DIFFUSERS.
- D8 DISCONNECT AND REMOVE CABINET UNIT HEATER, CONTROLS, AND ALL ASSOCIATED ACCESSORIES. PREPARE HOT WATER SUPPLY AND RETURN FOR NEW CONNECTIONS.
- D9 PRIOR TO DEMOLITION, HAVE BALANCE DETERMINE EXISTING AIRFLOW. AFTER EXISTING AIRFLOW IS DETERMINED, REMOVE GRILLE AND DUCTWORK BACK TO POINTS INDICATED.
- D10 DISCONNECT & REMOVE HORIZONTAL UNIT VENTILATOR, DISCONNECT DUCTWORK, SUPPLY DUCTWORK TO REMAIN, DISCONNECT HOT WATER SUPPLY & RETURN, PIPING TO REMAIN.
- D11 REMOVE PUMP AND ALL ASSOCIATED ACCESSORIES.
- D12 REMOVE HWISIR IN ITS ENTIRETY, RETAIN COIL CONNECTIONS, CONTROL VALVES, AND ACCESSORIES FOR RECONNECTION.

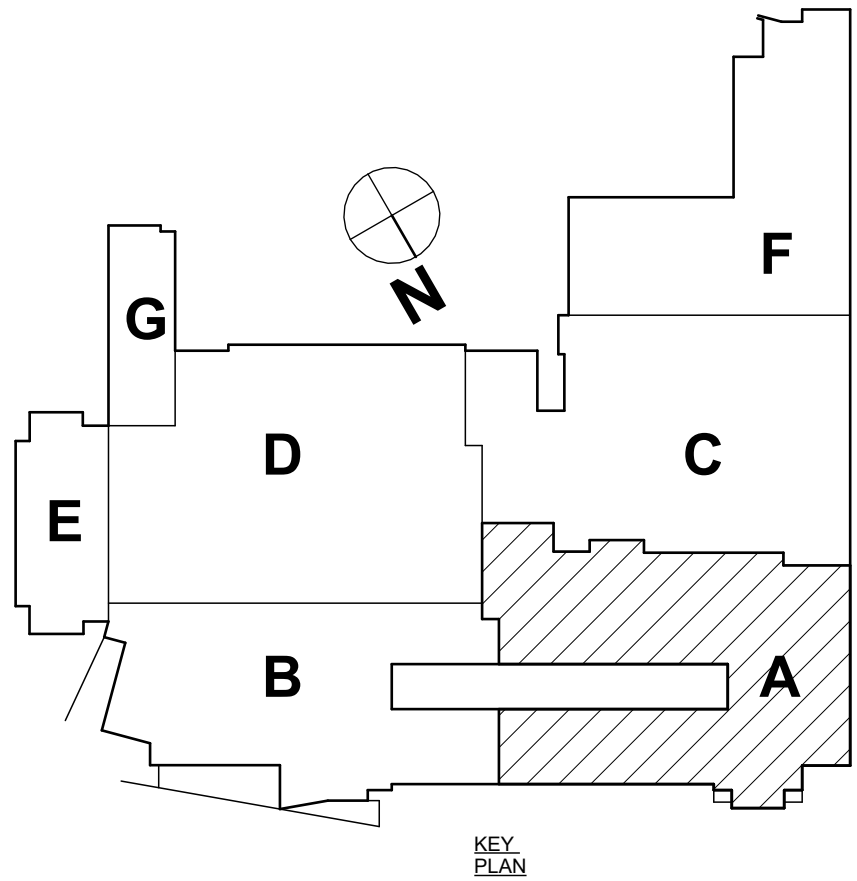

1 FIRST FLOOR HVAC DEMOLITION PLAN - AREA A  
1/8" = 1'-0"

HUNT ENGINEERS | ARCHITECTS | SURVEYORS  
HORSEHEADS, NY 607-263-1000 ROCHESTER, NY 585-537-7868 TOWNAND, PA 570-265-4606  
BINGHAMTON, NY 607-738-8881 ALBANY, NY 607-738-8881  
WWW.HUNTHEAS.COM  
NY CERTIFICATE NO. 0016220 PA CERTIFICATE NO. TSC22020131464-1

FIRST FLOOR HVAC DEMOLITION PLAN - AREA A  
2025 MIDDLE SCHOOL PHASE III ALTERATIONS PROJECT  
CORNING-PAINTED POST ASD  
35 VICTORY HIGHWAY, PAINTED POST, NY 14870

MS-H0.1  
PROJECT NO: 2649-133

SED #: 57-000-01-000444 - MIDDLE SCHOOL



REFER TO DWG. MS-H0.

D1 REMOVE DUCTWORK & ALL ASSOCIATED ACCESSORIES BACK TO POINTS INDICATED.

D2 REMOVE HWS & ALL ASSOCIATED ACCESSORIES IN THEIR ENTIRETY.

D3 REMOVE HWSR & ALL ASSOCIATED ACCESSORIES IN THEIR ENTIRETY BACK TO POINTS INDICATED.

D4 REMOVE HWSR BACK TO POINTS INDICATED AND CAP.

D5 REMOVE DUST COLLECTOR, REGRULATION TYLER FILTER UNITS AND ALL ASSOCIATED ACCESSORIES IN THEIR ENTIRETY.

D6 DISCONNECT AND REMOVE COIL, DUCTWORK, AND ALL ASSOCIATED ACCESSORIES BACK TO POINTS INDICATED.

D7 REMOVE CEILING MOUNTED DIFFUSER/REGISTER/GRILLE, DISCONNECT FROM DUCTWORK, AND PROTECT THE EXISTING REGISTERS, GRILLES & DIFFUSERS.

D8 DISCONNECT AND REMOVE CABINET UNIT, HEAT, CONTROLS, AND ALL ASSOCIATED ACCESSORIES. PREPARE HOT WATER SUPPLY & RETURN FOR NEW CONNECTIONS.

D9 PRIOR TO DEMOLITION, HAVE BALANCER DETERMINE EXISTING AIRFLOW. AFTER EXISTING AIRFLOW IS DETERMINED, REMOVE GRILLE AND DUCTWORK BACK TO POINTS INDICATED.

D10 DISCONNECT & REMOVE EXISTING HORIZONTAL VENT, RETURN, DISCONNECT DUCTWORK, SUPPLY DUCTWORK TO REMAIN. DISCONNECT HOT WATER SUPPLY & RETURN, PIPING TO REMAIN.

D11 REMOVE PUMP AND ALL ASSOCIATED ACCESSORIES.

D12 REMOVE HWSR IN ITS ENTIRETY, INCLUDING ALL CONNECTIONS, CONTROL VALVES, AND ACCESSORIES FOR RECONNECTION.



DRAWN BY:		KTG
CHECKED BY:		ENS
DATE:		05/09/2025
PHASE:		CD
#	DATE:	IT IS A VIOLATION OF THE LAW FOR ANY PERSON TO MAKE UNAUTHORIZED ALTERATIONS OR ADDITIONS TO PLANS
1	10/20/2025	
DESCRIPTION OF REVISION: ISSUED FOR BID		

**HUNT** ENGINEERS | ARCHITECTS | SURVEYORS  
HORSEHEADS, NY 607-338-1000 ROCHESTER, NY 585-327-7949 TOWANDA, PA 570-265-4888  
BINGHAMTON, NY 607-726-1000 ALBANY, NY 607-781-8881  
[WWW.HUNTCES.COM](http://WWW.HUNTCES.COM)  
NY CERTIFICATE NO. 0019220 PA CERTIFICATE NO. TSC2203131464-1

FIRST FLOOR HVAC DEMOLITION PLAN - AREA C

MS-H0.2

PROJECT NO: 2649-153

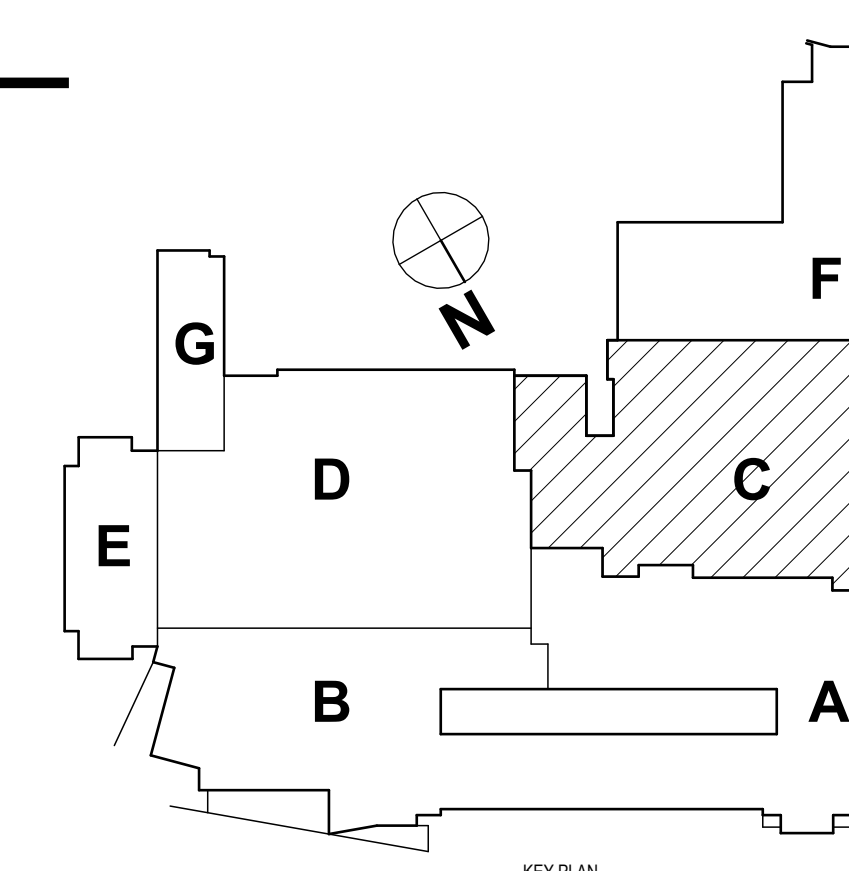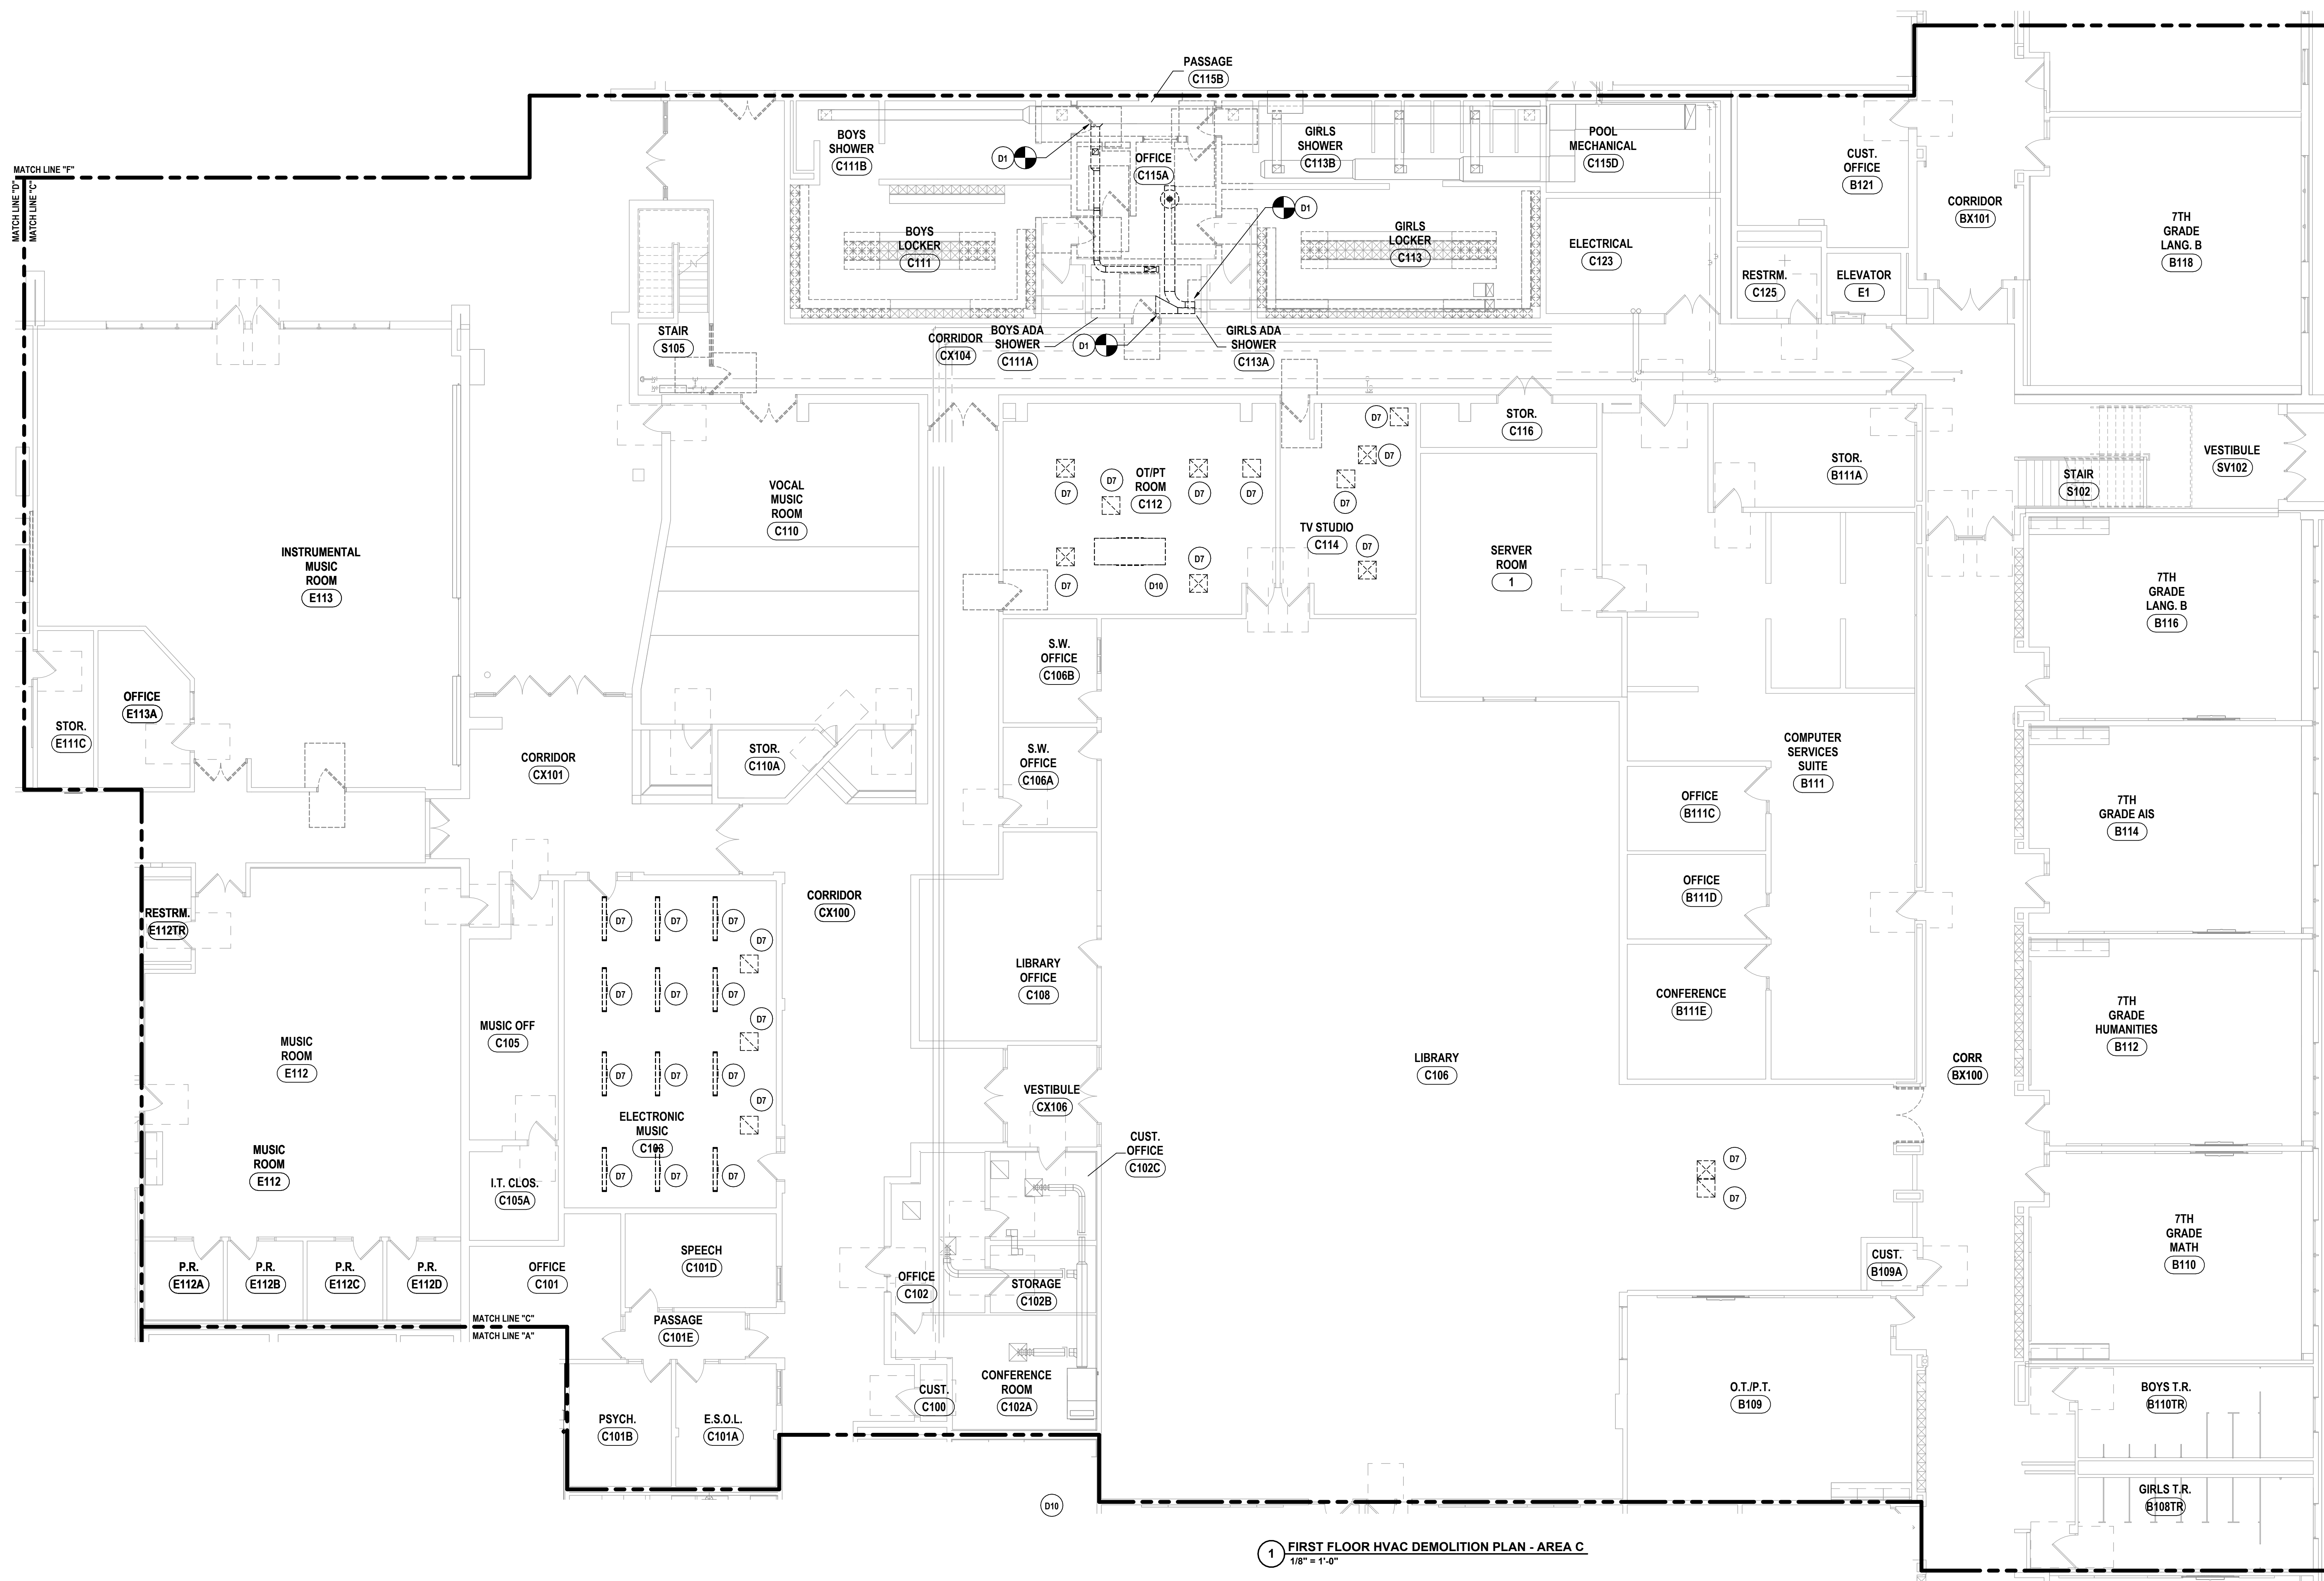

### KEY FINDINGS

GENERAL NOTES - MECHANICAL  
REFER TO MS-H0.1

DEMOLITION NOTES

- D1 REMOVE DUCTWORK & ALL ASSOCIATED ACCESSORIES BACK TO POINTS INDICATED.  
D2 REMOVE HWS & ALL ASSOCIATED ACCESSORIES IN THEIR ENTIRETY.  
D3 REMOVE HWSIR & ALL ASSOCIATED ACCESSORIES IN THEIR ENTIRETY BACK TO POINTS INDICATED.  
D4 REMOVE HWSIR BACK TO POINTS INDICATED AND CAP.  
D5 REMOVE DUST COLLECTOR, RECIRCULATION STYLER FILTER UNITS, AND ALL ASSOCIATED ACCESSORIES IN THEIR ENTIRETY.  
D6 DISCONNECT AND REMOVE COIL, DUCTWORK, AND ALL ASSOCIATED ACCESSORIES BACK TO POINTS INDICATED.  
D7 REMOVE CEILING MOUNTED DIFFUSER/REGISTER/GRILLE. DISCONNECT FROM DUCTWORK. RETAIN & PROTECT THE EXISTING REGISTERS, GRILLES & DIFFUSERS.  
D8 DISCONNECT AND REMOVE CABINET UNIT HEATER, CONTROLS, AND ALL ASSOCIATED ACCESSORIES. PREPARE HOT WATER SUPPLY AND RETURN FOR NEW CONNECTIONS.  
D9 PRIOR TO DEMOLITION, HAVE BALANCER DETERMINE EXISTING AIRFLOW. AFTER EXISTING AIRFLOW IS DETERMINED, REMOVE GRILLE AND DUCTWORK BACK TO POINTS INDICATED.  
D10 DISCONNECT & REMOVE HORIZONTAL UNIT VENTILATOR. DISCONNECT DUCTWORK. SUPPLY DUCTWORK TO REMAIN. DISCONNECT HOT WATER SUPPLY & RETURN, PIPING TO REMAIN.  
D11 REMOVE PUMP AND ALL ASSOCIATED ACCESSORIES.  
D12 REMOVE HWSIR IN ITS ENTIRETY. RETAIN COIL CONNECTIONS, CONTROL VALVES, AND ACCESSORIES FOR RECONNECTION.


DRAWN BY: KTK  
CHECKED BY: ENS  
DATE: 05/09/2025  
PHASE: CD

DESCRIPTION OF REVISION:  
# DATE: 1 10/20/2025  
ISSUED FOR BID


HUNT ENGINEERS | ARCHITECTS | SURVEYORS  
HORSEHEADS, NY 607-263-1000 ROCHESTER, NY 585-537-7849 TOWNAND, PA 670-265-4668  
BINGHAMTON, NY 607-738-8881 ALBANY, NY 607-738-8801  
WWW.HUNTEAS.COM  
NY CERTIFICATE NO. 001620 PA CERTIFICATE NO. TSC220313464-1

FIRST FLOOR HVAC DEMOLITION PLAN - AREA D  
2025 MIDDLE SCHOOL PHASE III ALTERATIONS PROJECT  
CORNING-PAINTED POST ASD  
35 VICTORY HIGHWAY, PAINTED POST, NY 14870


MS-H0.3  
PROJECT NO: 2649-133

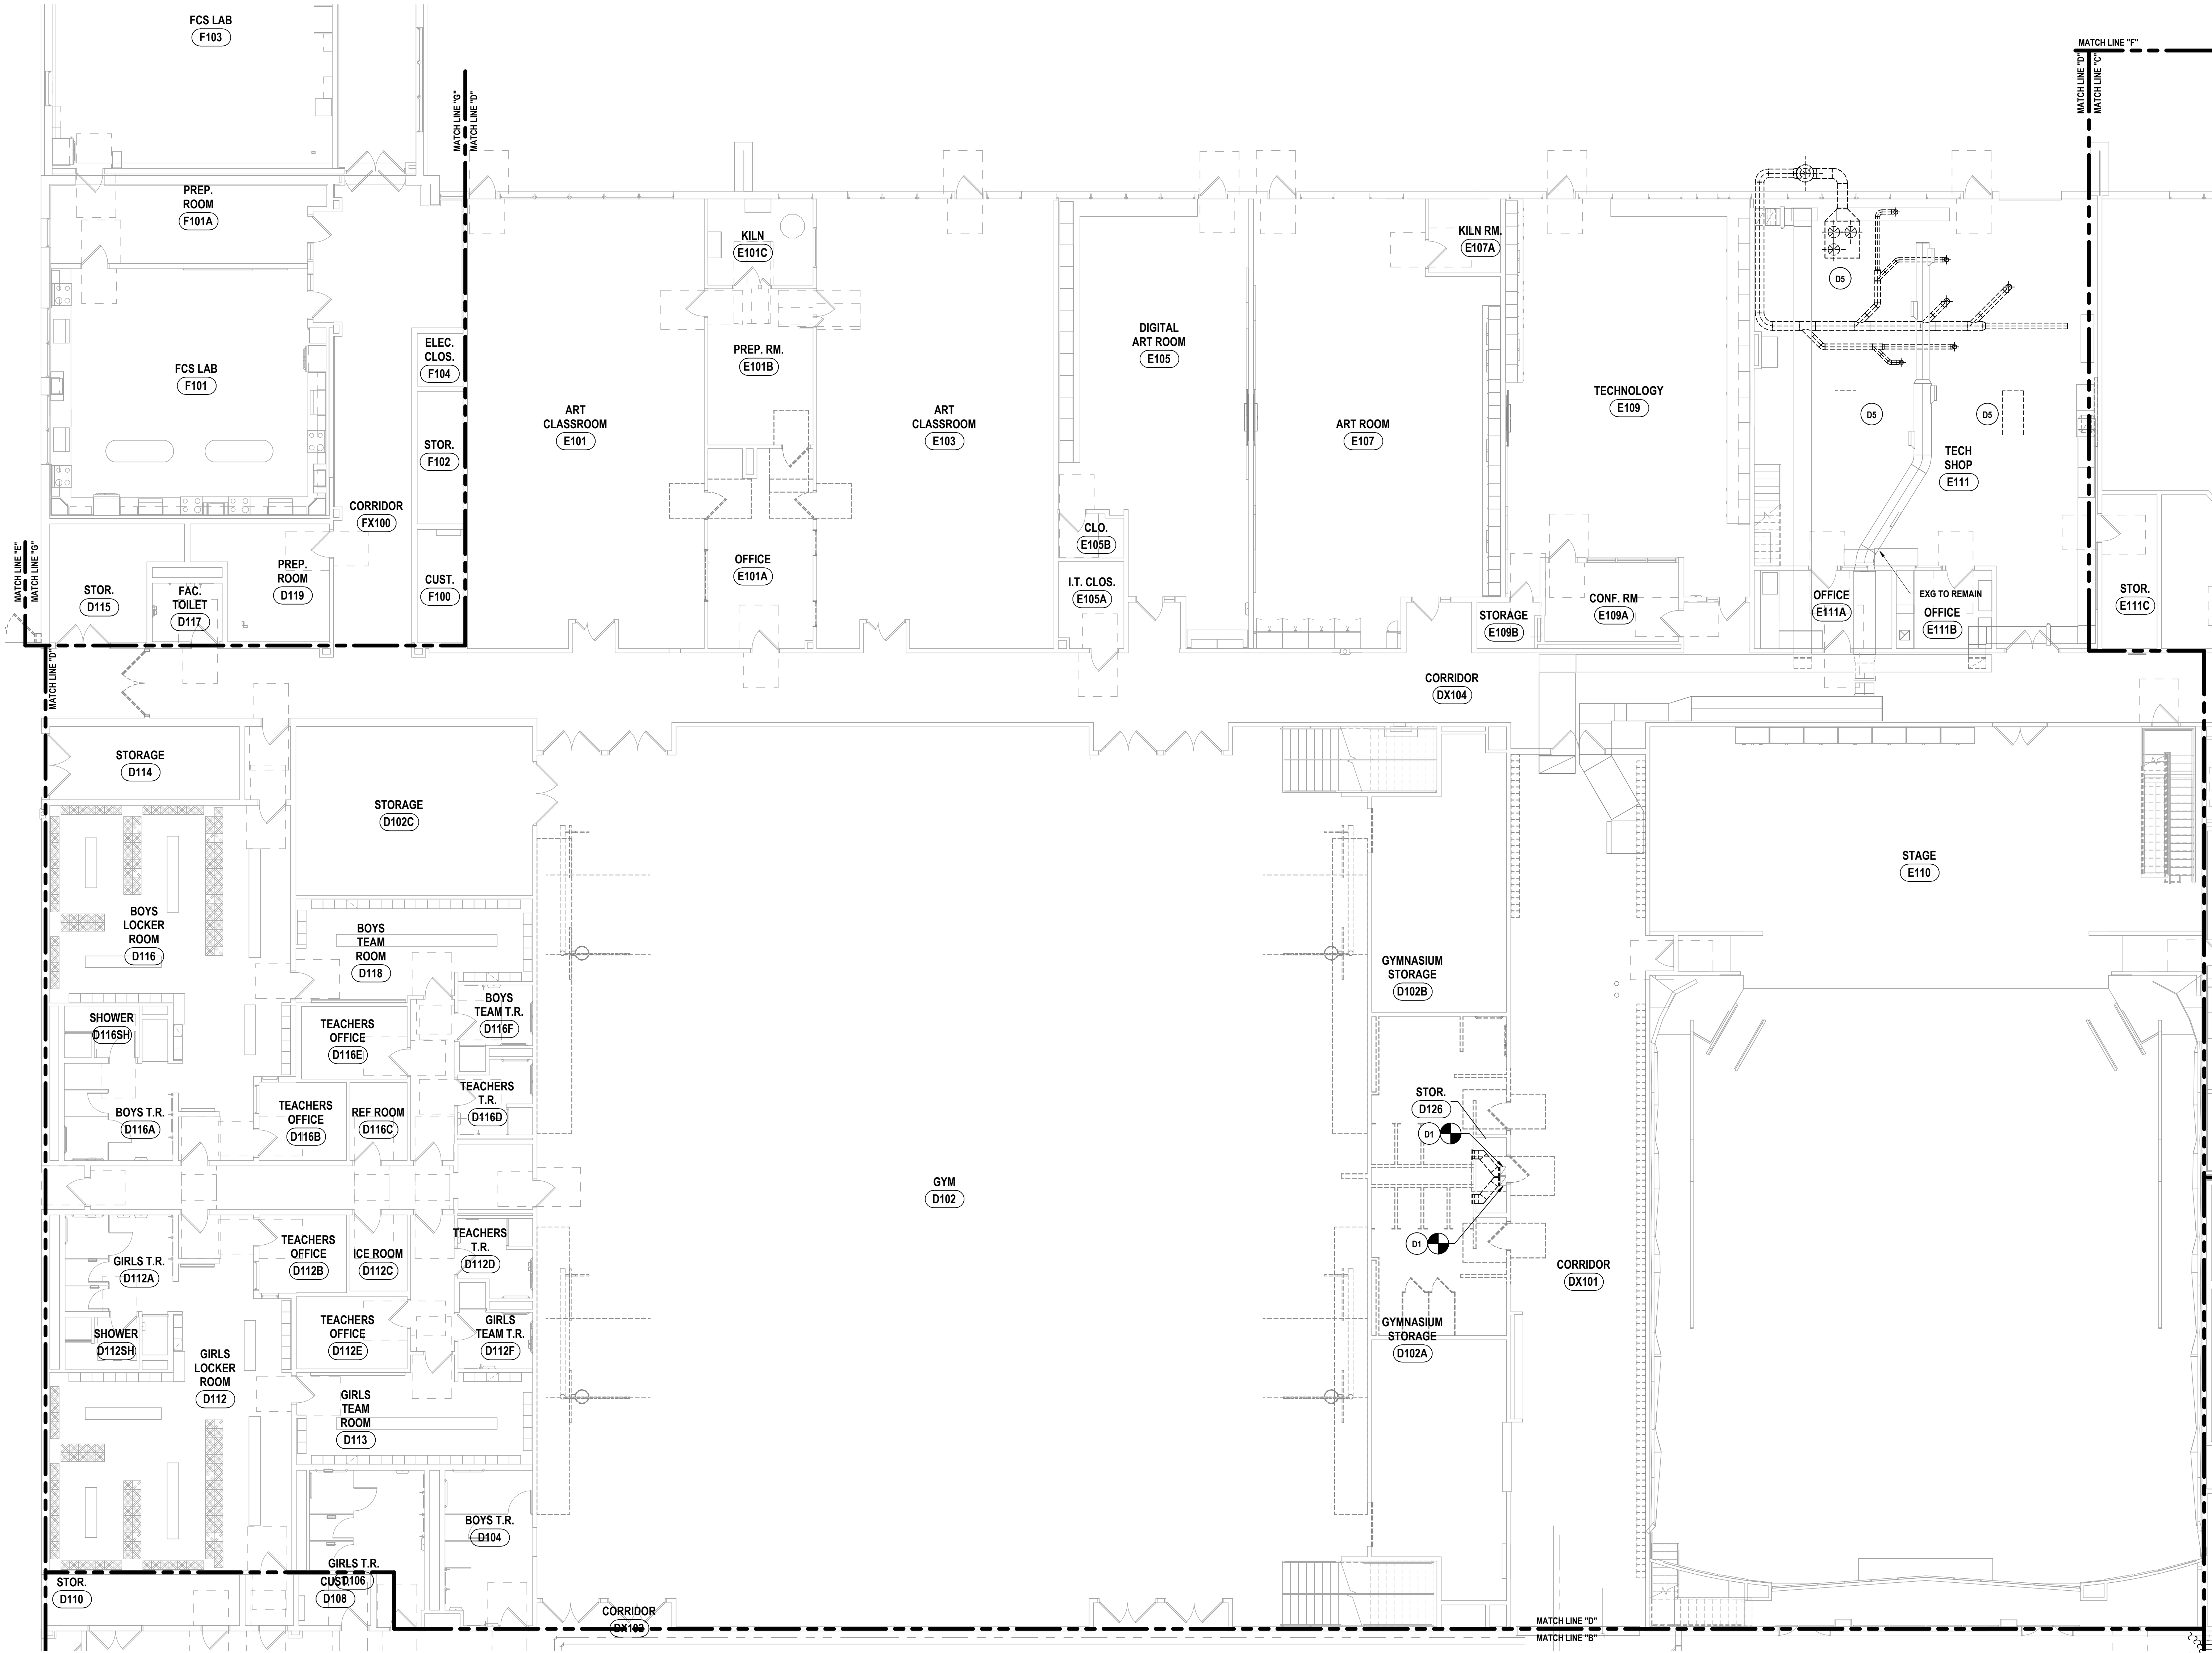



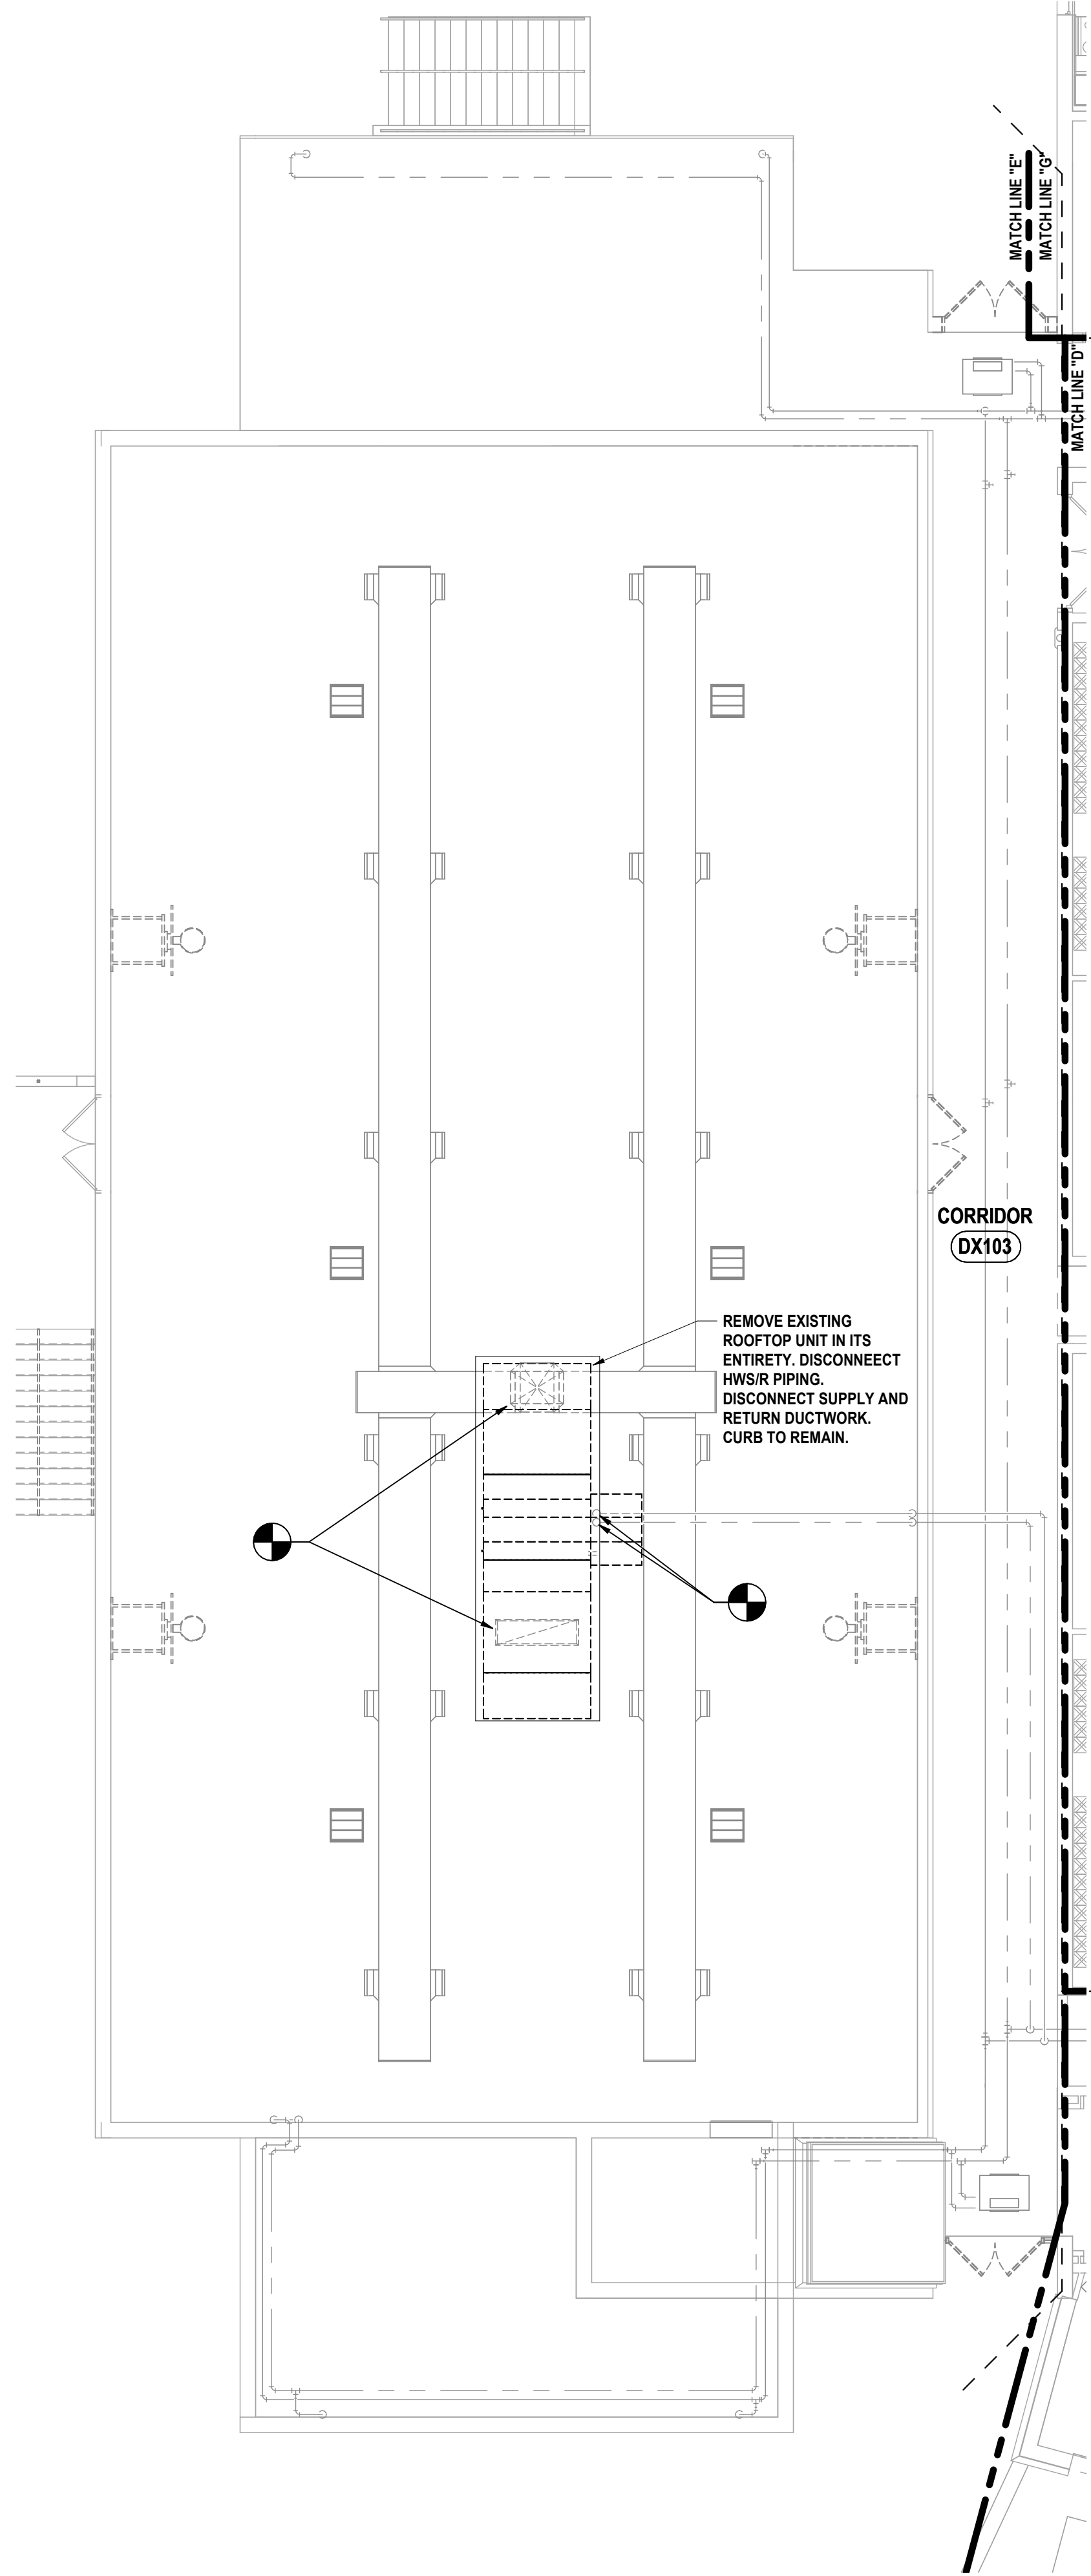

1 FIRST FLOOR HVAC DEMOLITION PLAN - AREA E  
1/8" = 1'-0"

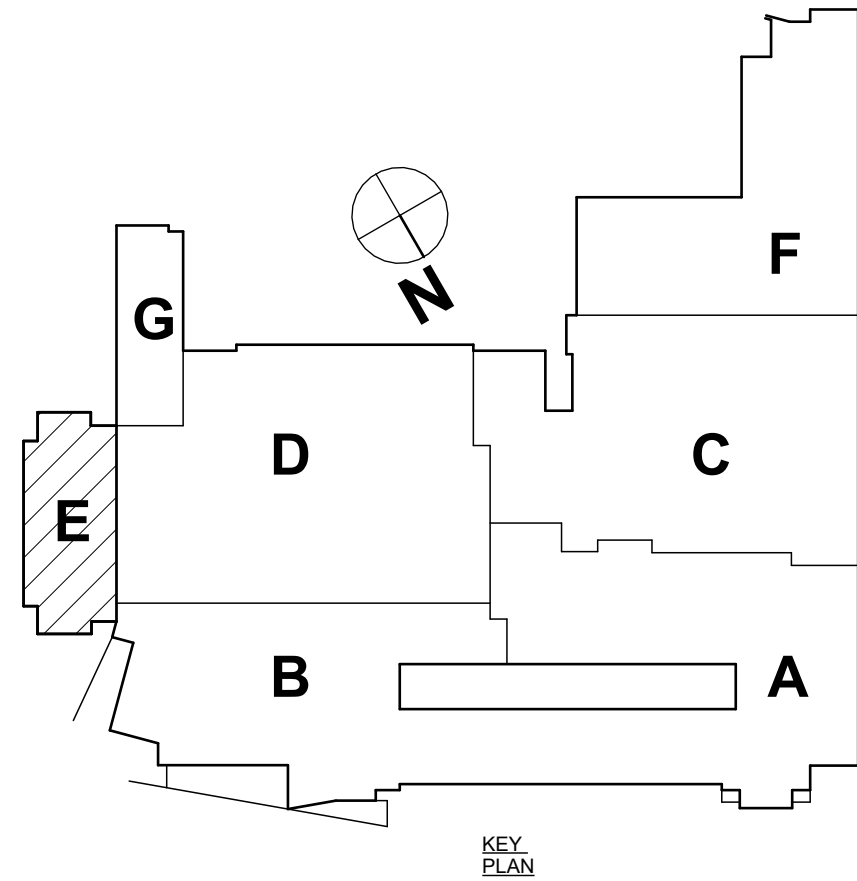

KEY  
PLAN

SED #: 57-16-00-41-5-024-044 - MIDDLE SCHOOL

FIRST FLOOR HVAC DEMOLITION PLAN - AREA E  
2025 MIDDLE SCHOOL PHASE III ALTERATIONS PROJECT  
CORNING-PAINTED POST ASD  
35 VICTORY HIGHWAY, PAINTED POST, NY 14870

MS-H0.4  
PROJECT NO: 2649-133

**HUNT** ENGINEERS | ARCHITECTS | SURVEYORS  
HORSEHEADS, NY 607-263-1000 ROCHESTER, NY 565-537-7549 TOWNANDA, PA 570-265-4666  
BINGHAMTON, NY 607-738-8881 ALBANY, NY 607-738-8801  
WWW.HUNTEAS.COM  
NY CERTIFICATE NO. 001620 PA CERTIFICATE NO. TSC220313464-1

#	DATE	DESCRIPTION OF REVISION:
1	11/03/2023	ISSUED FOR BID

IT IS A VIOLATION OF THE LAW FOR ANY PERSON TO MAKE UNAUTHORIZED ALTERATIONS OR ADDITIONS TO PLANS DRAWN BY A LICENSED ENGINEER OR ARCHITECT'S SEAL OR SIGNATURE.

DRAWN BY:	KMM
CHECKED BY:	ENS
DATE:	05/09/2025
PHASE:	CD

05/09/2025

REFER TO MS-H0.

- 1 CLEAN REGISTERS, GRILLES & DIFFUSERS THOROUGHLY BEFORE PLACEMENT IN NEW CEILING. EXTEND & RECONNECT DUCTWORK TO ACCOMMODATE NEW CEILING LAYOUT. MAINTAIN EXISTING VOLUMETRIC BALANCE DAMPERS.
- 2 PROVIDE BURIED HDPE PIPING IN LOCATION INDICATED TO SERVE GUTTER EVACUATION SYSTEM. SLOPE ALL BURIED PIPING AT 1/8" PER 1' SLOPE TO THE BASE OF THE PIPING RISER TO ALLOW DRAINAGE.
- 3 PLUMBING CONNECTION LOCATED AT BOTTOM OF DUCTWORK RISER TO DRAIN ENTRAINED MOISTURE. PROVIDE ACCESS IN CHASE FOR CLEANOUT. REFER TO DETAIL MS-H1-62. COORDINATE AS NECESSARY.
- 4 PROVIDE NEW GRILLE AS SCHEDULED. EXTEND AND RECONNECT DUCTWORK AND BALANCE GRILLE TO EXISTING AIRFLOW.
- 5 EXTEND & RECONNECT DUCTWORK & PIPING. INSULATE EXISTING DUCTWORK.

DRAWN BY:		KMM
CHECKED BY:		
DATE:		05/09/2025
PHASE:		CD
#	DATE:	IT IS A VIOLATION OF THE LAW FOR ANY PERSON TO MAKE UNAUTHORIZED ALTERATIONS OR ADDITIONS TO PLANS
1	10/20/2025	
DESCRIPTION OF REVISION: ISSUED FOR BID		



**HUNT** ENGINEERS | ARCHITECTS | SURVEYORS

HORSEHEADS, NY 607-358-1000 ROCHESTER, NY 585-327-7949 TOWNANDA, PA 470-205-4888  
BINGHAMTON, NY 607-788-8081 ALBANY, NY 607-798-9081

FIRST FLOOR HVAC PLAN - AREA A

## MS-H1.1

PROJECT NO: 2649-153

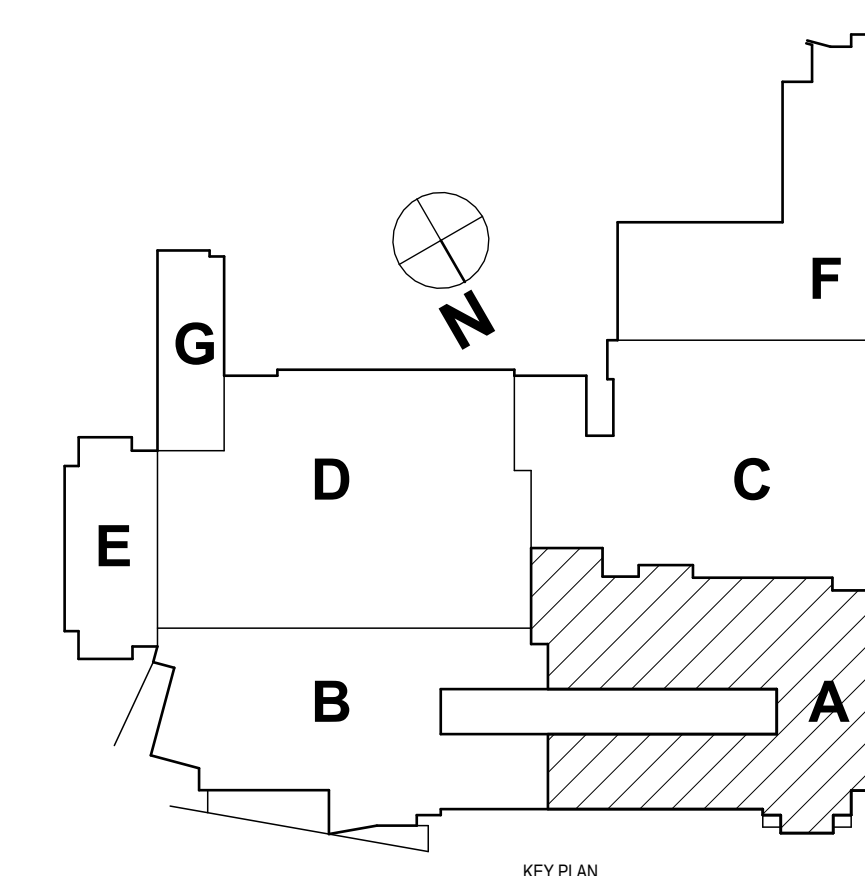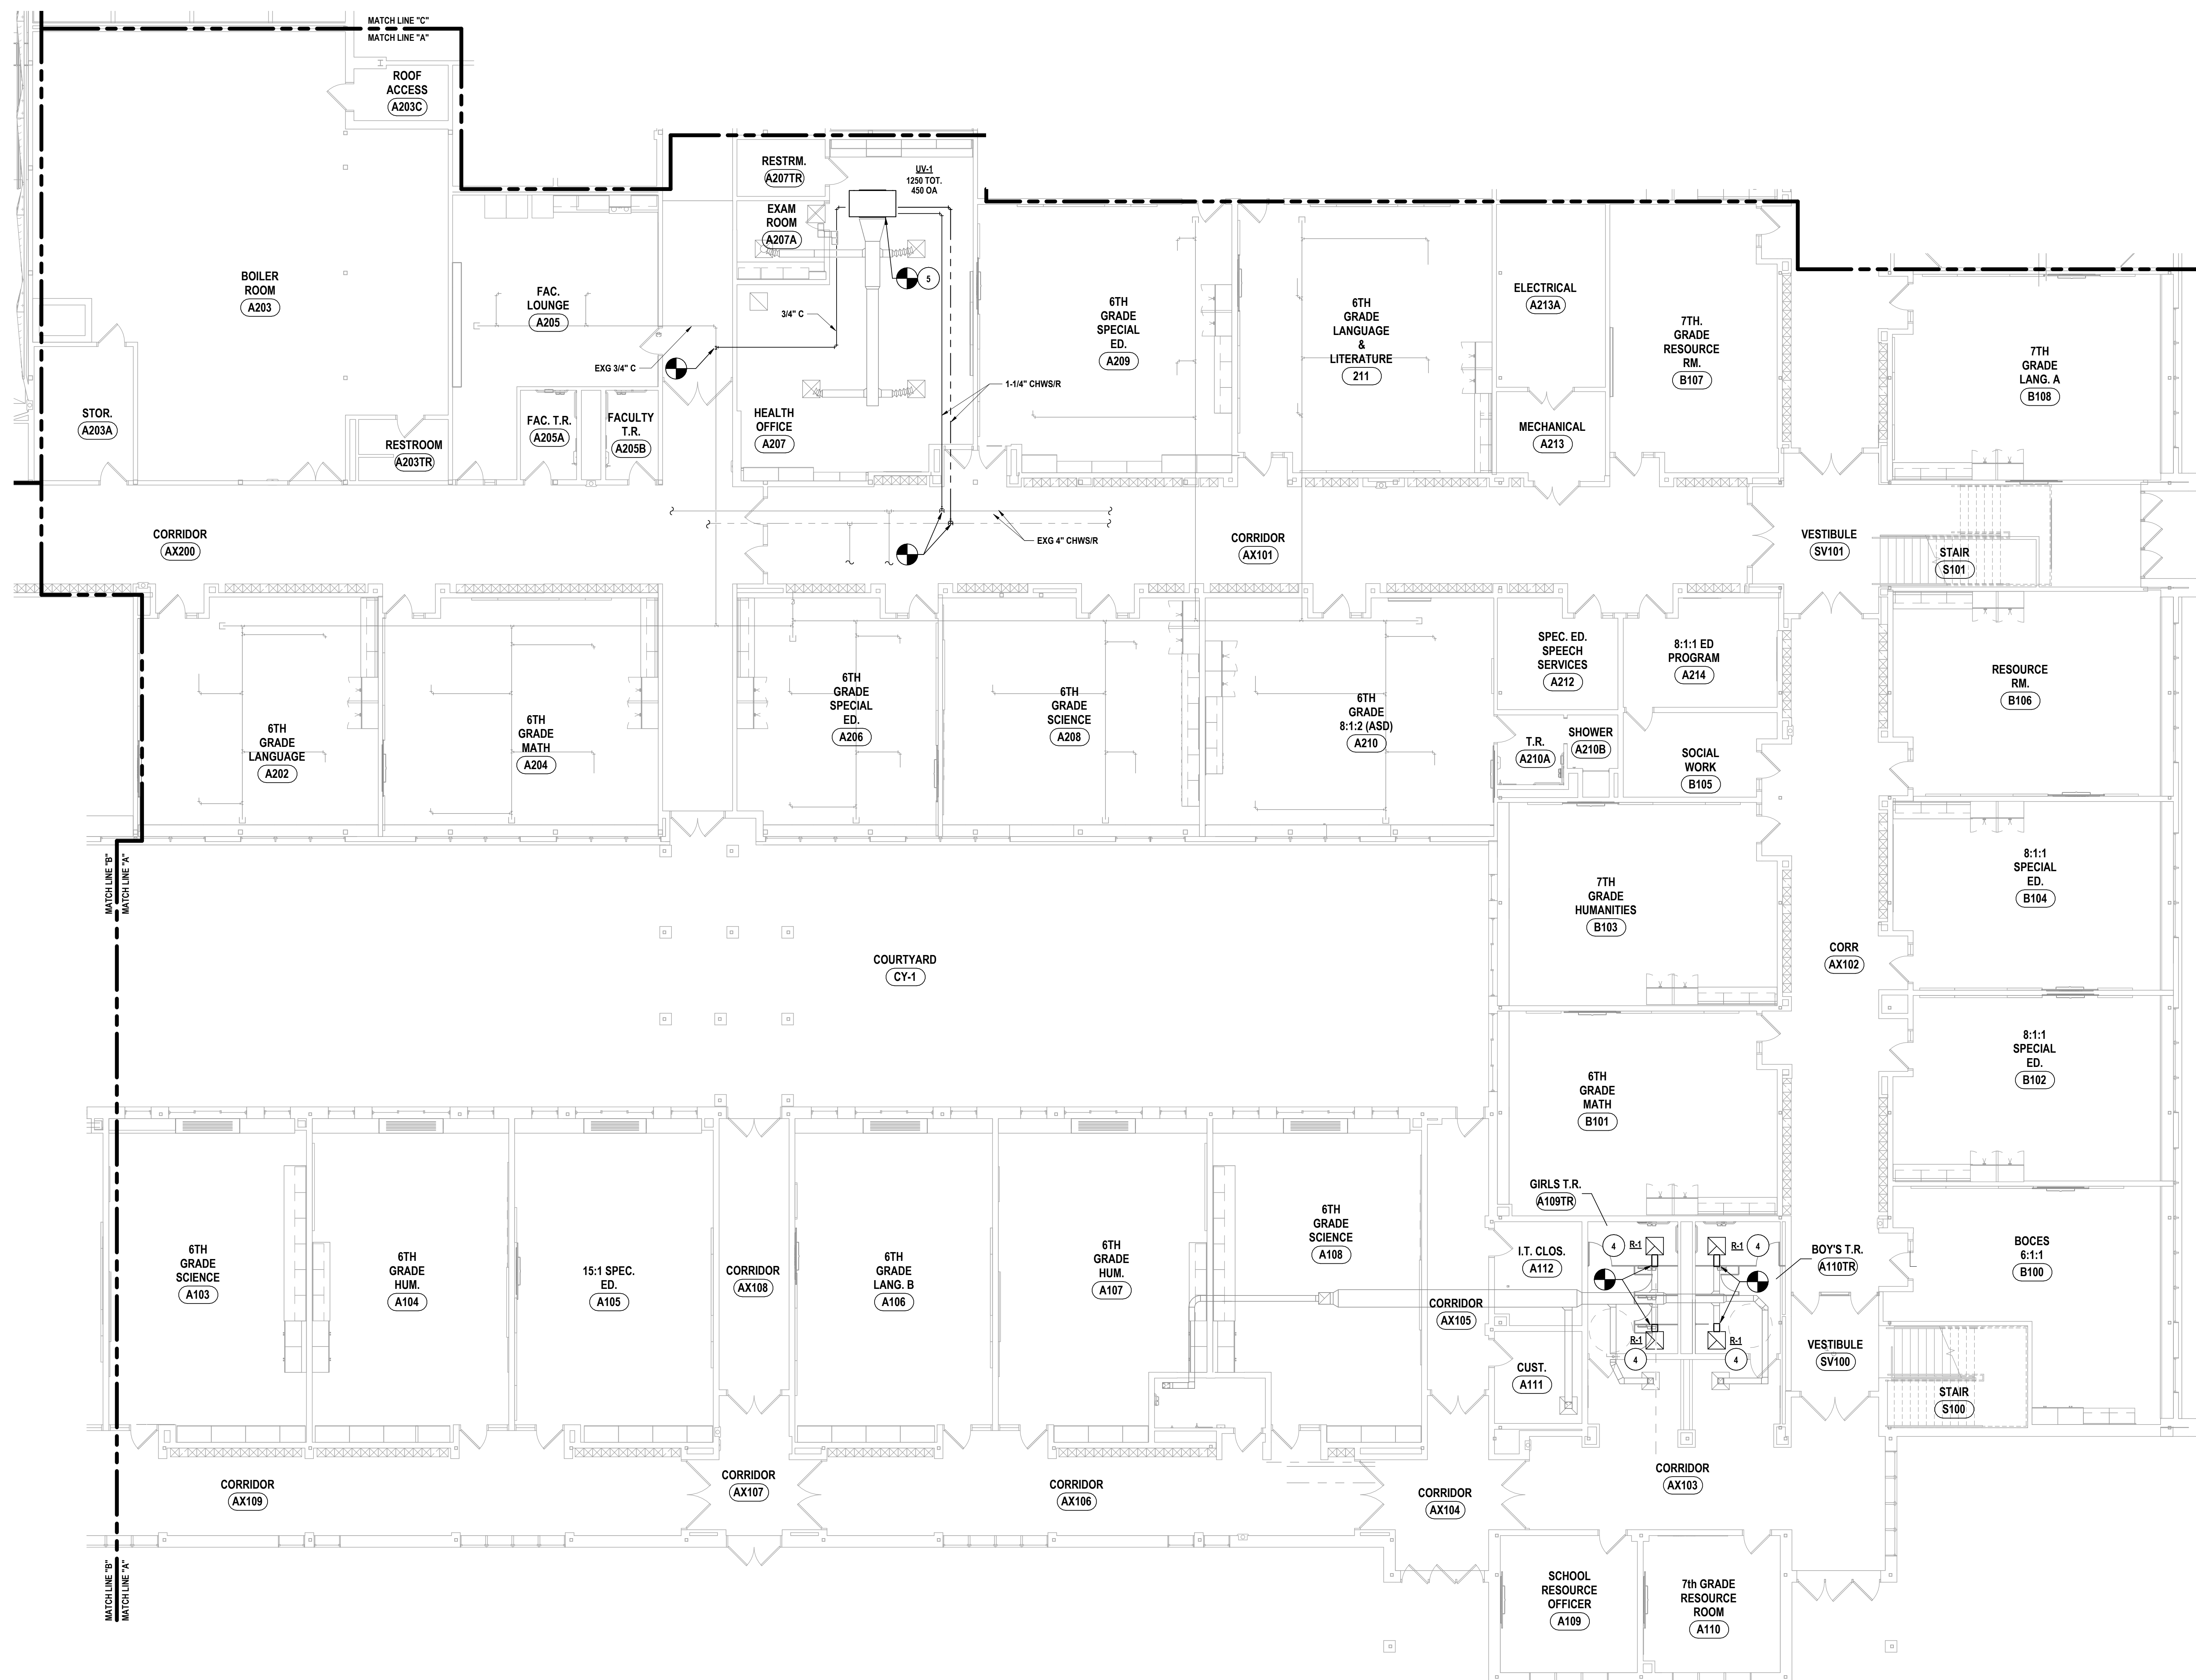


1 FIRST FLOOR HVAC PLAN - AREA A  
1/8" = 1'-0"




GENERAL NOTES - MECHANICAL  
REFER TO MS-H0.1

CONSTRUCTION NOTES - MECHANICAL

- CLEAN REGISTERS, GRILLES & DIFFUSERS THOROUGHLY BEFORE PLACEMENT IN NEW CEILING. EXTEND & RECONNECT DUCTWORK TO ACCOMMODATE NEW CEILING LAYOUT. MAINTAIN EXISTING VOLUMETRIC BALANCE DAMPERS.
- PROVIDE BURIED HDPE PIPING IN LOCATION INDICATED TO SERVE GUTTER EVACUATION SYSTEM. SLOPE ALL BURIED PIPING AT 1/8" PER 1' SLOPE TO THE BASE OF THE PIPING RISER TO ALLOW DRAINAGE.
- PLUMBING CONNECTION LOCATED AT BOTTOM OF DUCTWORK RISER TO DRAIN ENTRAINED MOISTURE. PROVIDE ACCESS IN CHASE FOR CLEANOUT. REFER TO DETAIL MS-H1.6.2. COORDINATE AS NECESSARY.
- PROVIDE NEW GRILLE AS SCHEDULED. EXTEND AND RECONNECT DUCTWORK AND BALANCE GRILLE TO EXISTING AIRFLOW.
- EXTEND & RECONNECT DUCTWORK & PIPING. INSULATE EXISTING DUCTWORK.

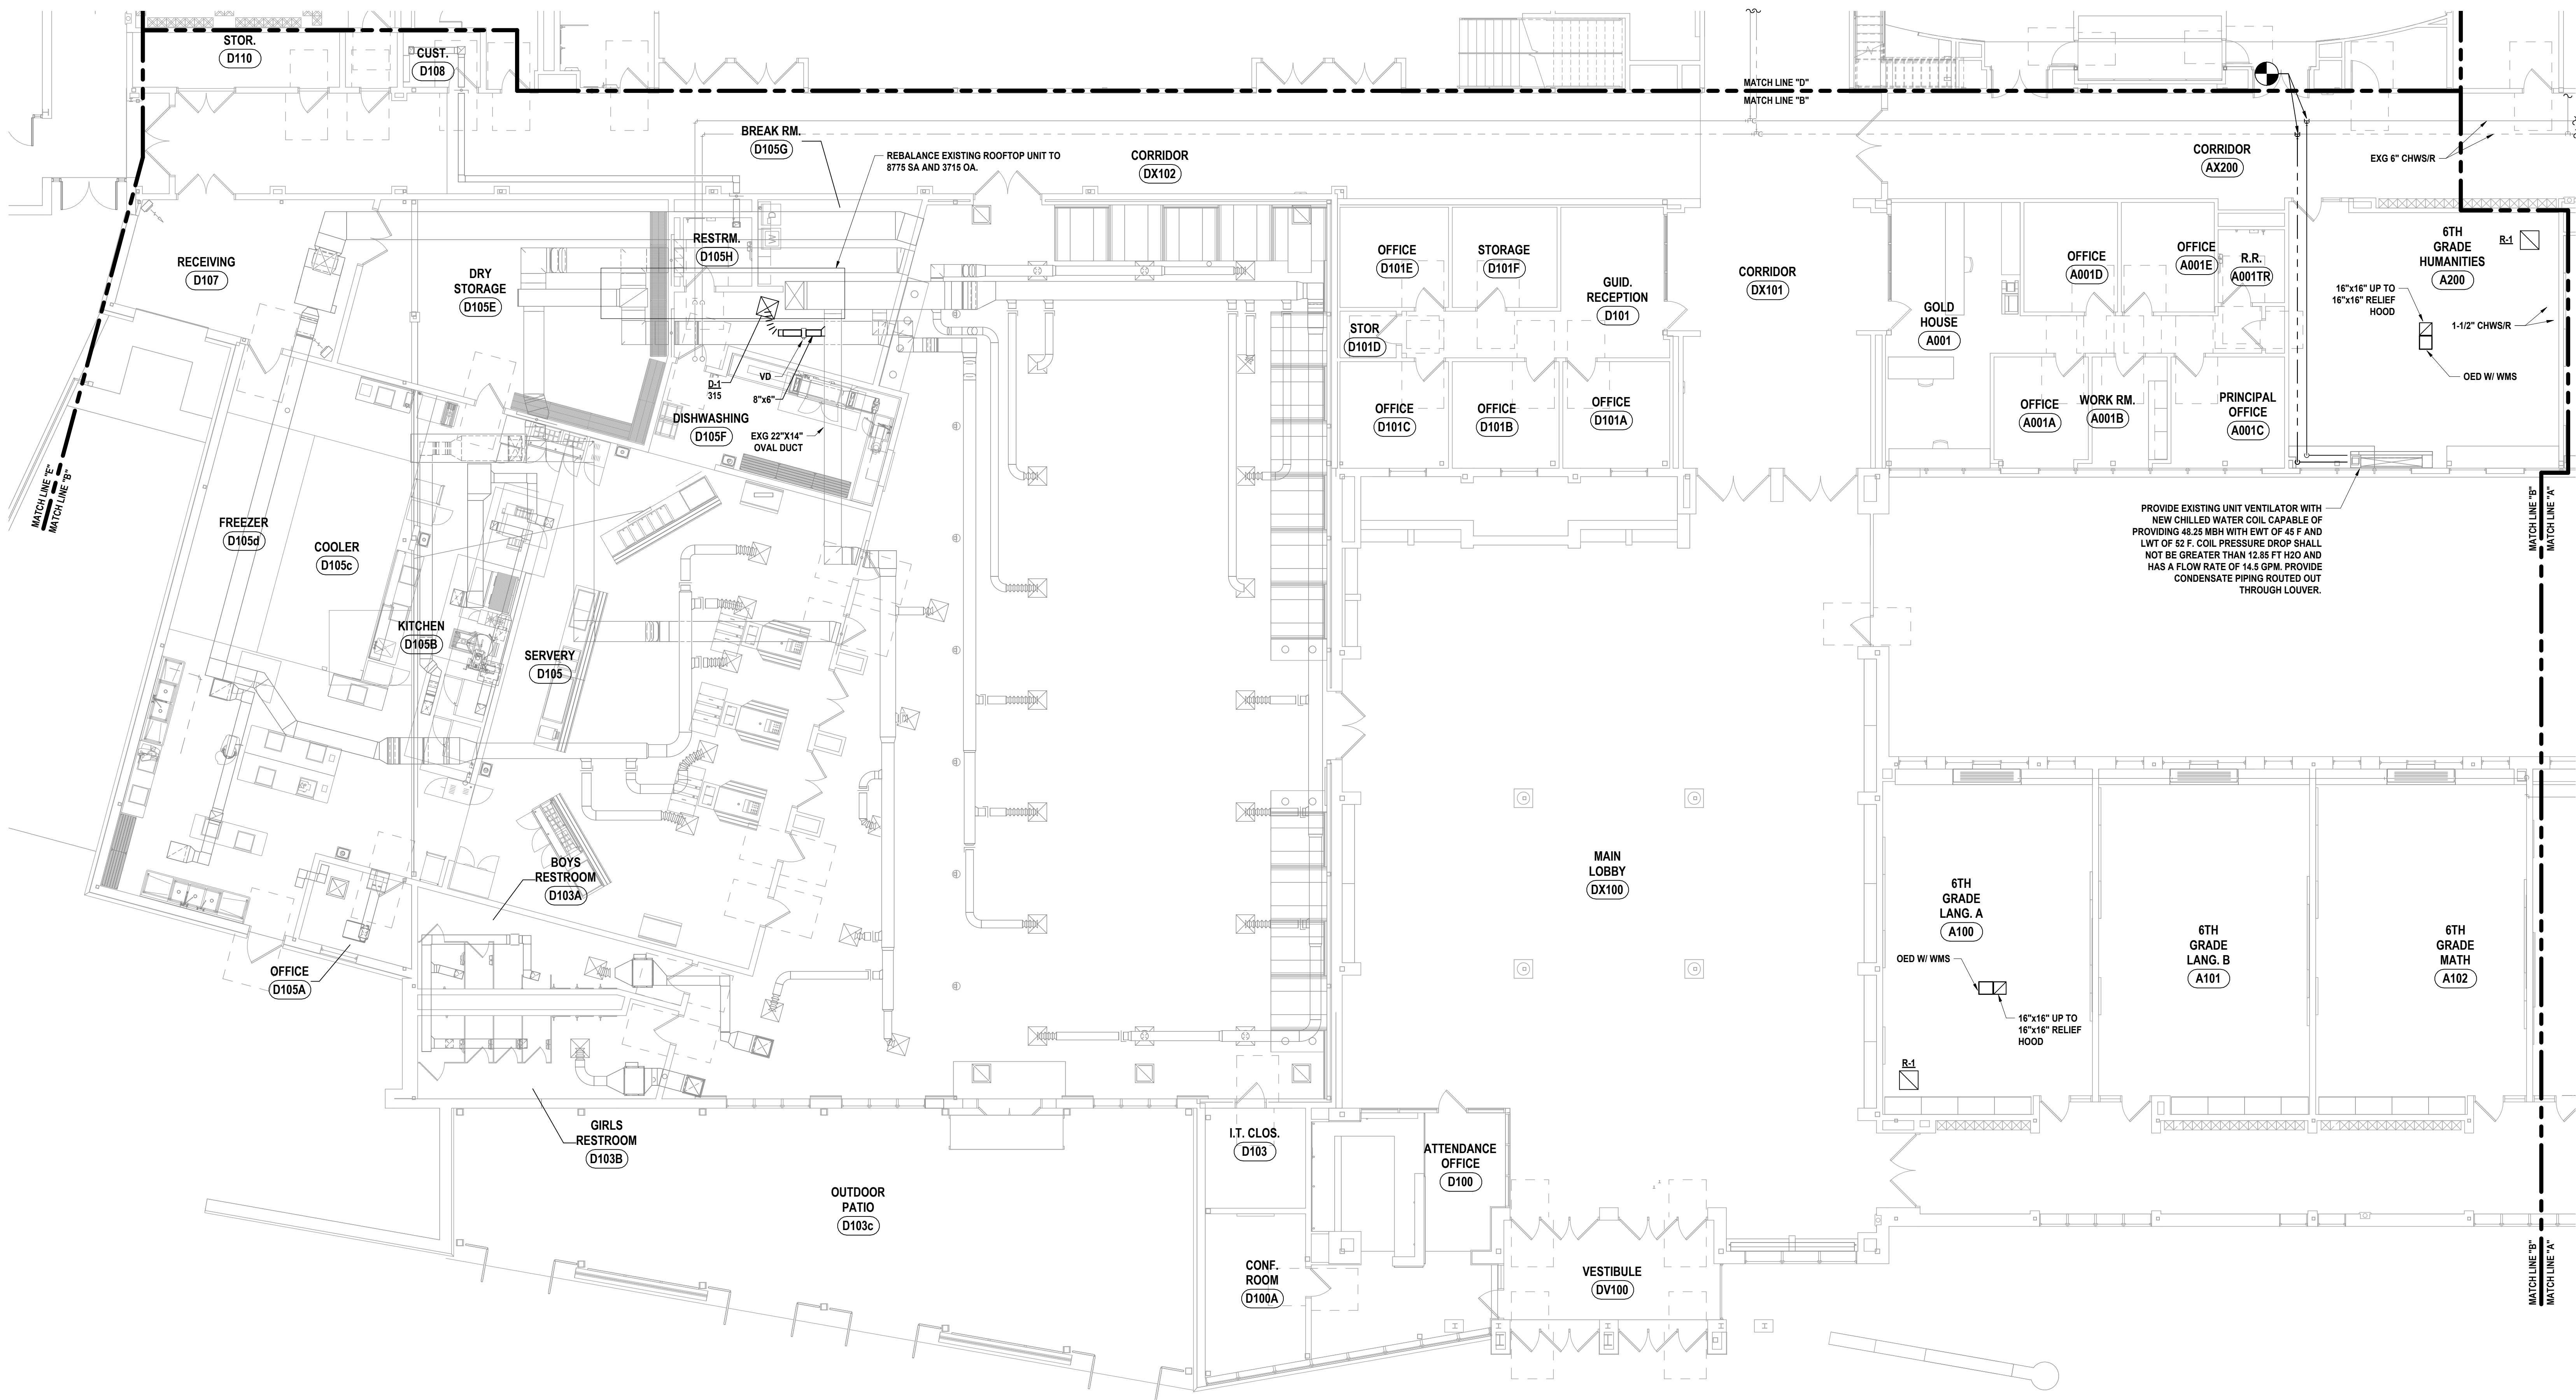

1 FIRST FLOOR HVAC PLAN - AREA B  
1/8" = 1'-0"

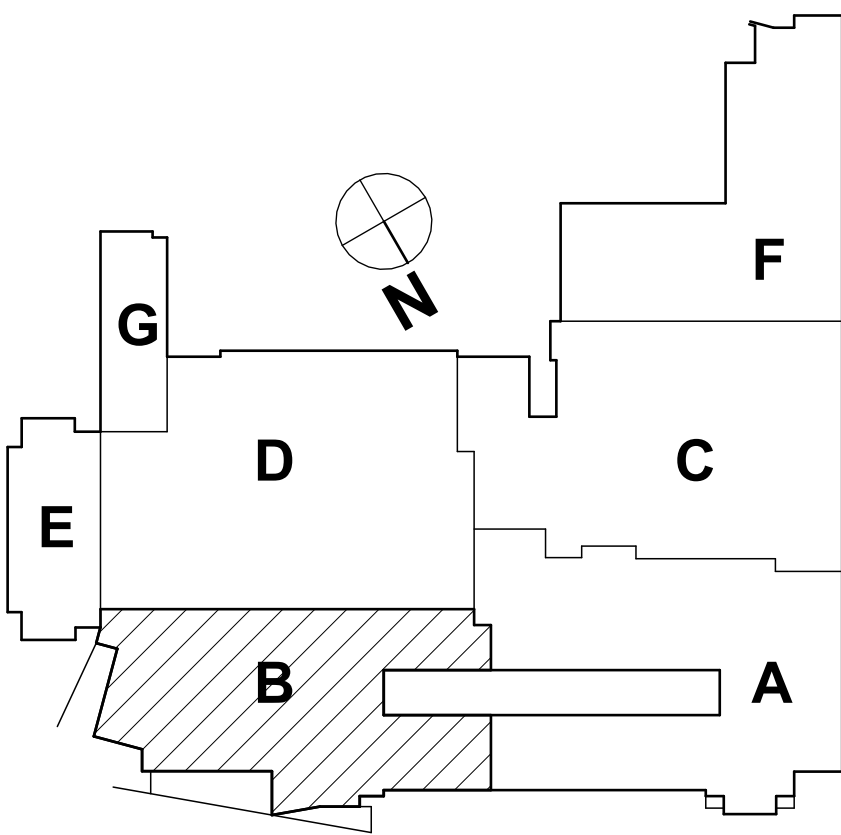

SED #: 57-000-01-000-044 - MIDDLE SCHOOL

FIRST FLOOR HVAC PLAN - AREA B  
2025 MIDDLE SCHOOL PHASE III ALTERATIONS PROJECT  
CORNING-PAINTED POST ASD  
35 VICTORY HIGHWAY, PAINTED POST, NY 14870

MS-H1.2  
PROJECT NO: 2649-153

HUNT ENGINEERS | ARCHITECTS | SURVEYORS  
HORSEHEADS, NY 607-263-1000 ROCHESTER, NY 585-537-7569 TOWNAND, PA 570-265-4606  
BINGHAMTON, NY 607-738-8881 ALBANY, NY 607-738-8801  
WWW.HUNTEAS.COM  
NY CERTIFICATE NO. 0016220 PA CERTIFICATE NO. TSC220313464-1

# DATE: 1 10/20/2025

DESCRIPTION OF REVISION:  
ISSUED FOR BID

DRAWN BY: KTK  
CHECKED BY: ENS

DATE: 05/09/2025



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11 IS A VIOLATION OF THE LAW FOR ANY PERSON TO MAKE UNAUTHORIZED ALTERATIONS OR ADDITIONS TO PLANS  
DRAWN & CHECKED: ENGINEERS, ARCHITECTS & SURVEYORS ONLY

GENERAL NOTES - MECHANICAL  
REFER TO MS-H0.1

CONSTRUCTION NOTES - MECHANICAL

- CLEAN REGISTERS, GRILLES & DIFFUSERS THOROUGHLY BEFORE PLACEMENT IN NEW CEILING. EXTEND & RECONNECT DUCTWORK TO ACCOMMODATE NEW CEILING LAYOUT. MAINTAIN EXISTING VOLUMETRIC BALANCE DAMPERS.
- PROVIDE BURIED HDPE PIPING IN LOCATION INDICATED TO SERVE GUTTER EVACUATION SYSTEM. SLOPE ALL BURIED PIPING AT 1/8" PER 1' SLOPE TO THE BASE OF THE PIPING RISER TO ALLOW DRAINAGE.
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- PROVIDE NEW GRILLE AS SCHEDULED. EXTEND AND RECONNECT DUCTWORK AND BALANCE GRILLE TO EXISTING AIRFLOW.
- EXTEND & RECONNECT DUCTWORK & PIPING. INSULATE EXISTING DUCTWORK.

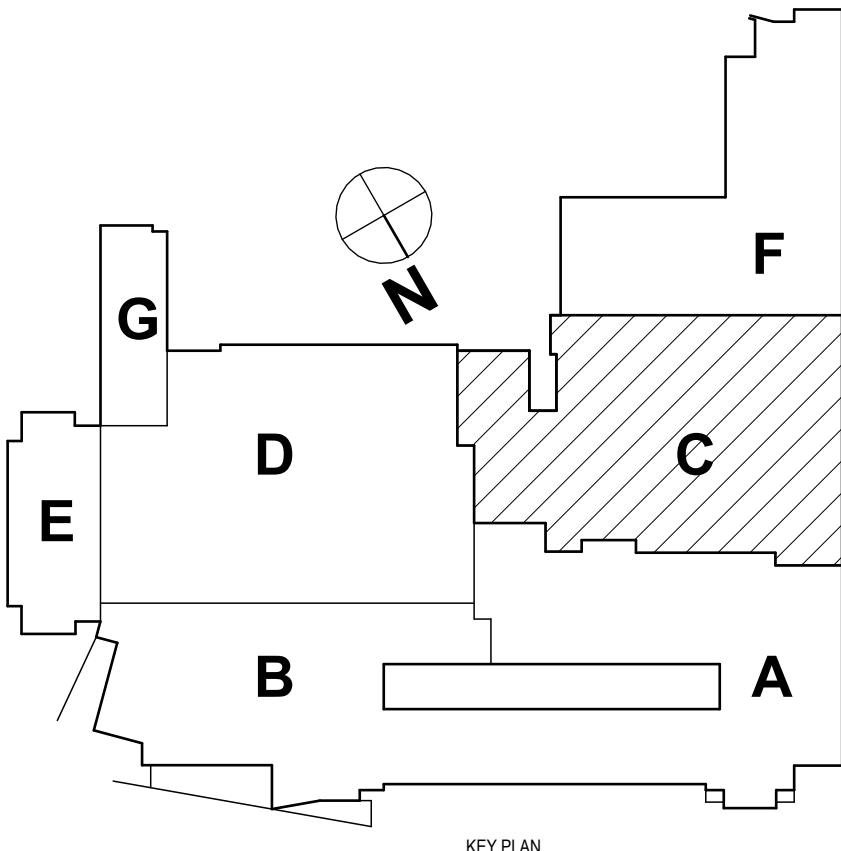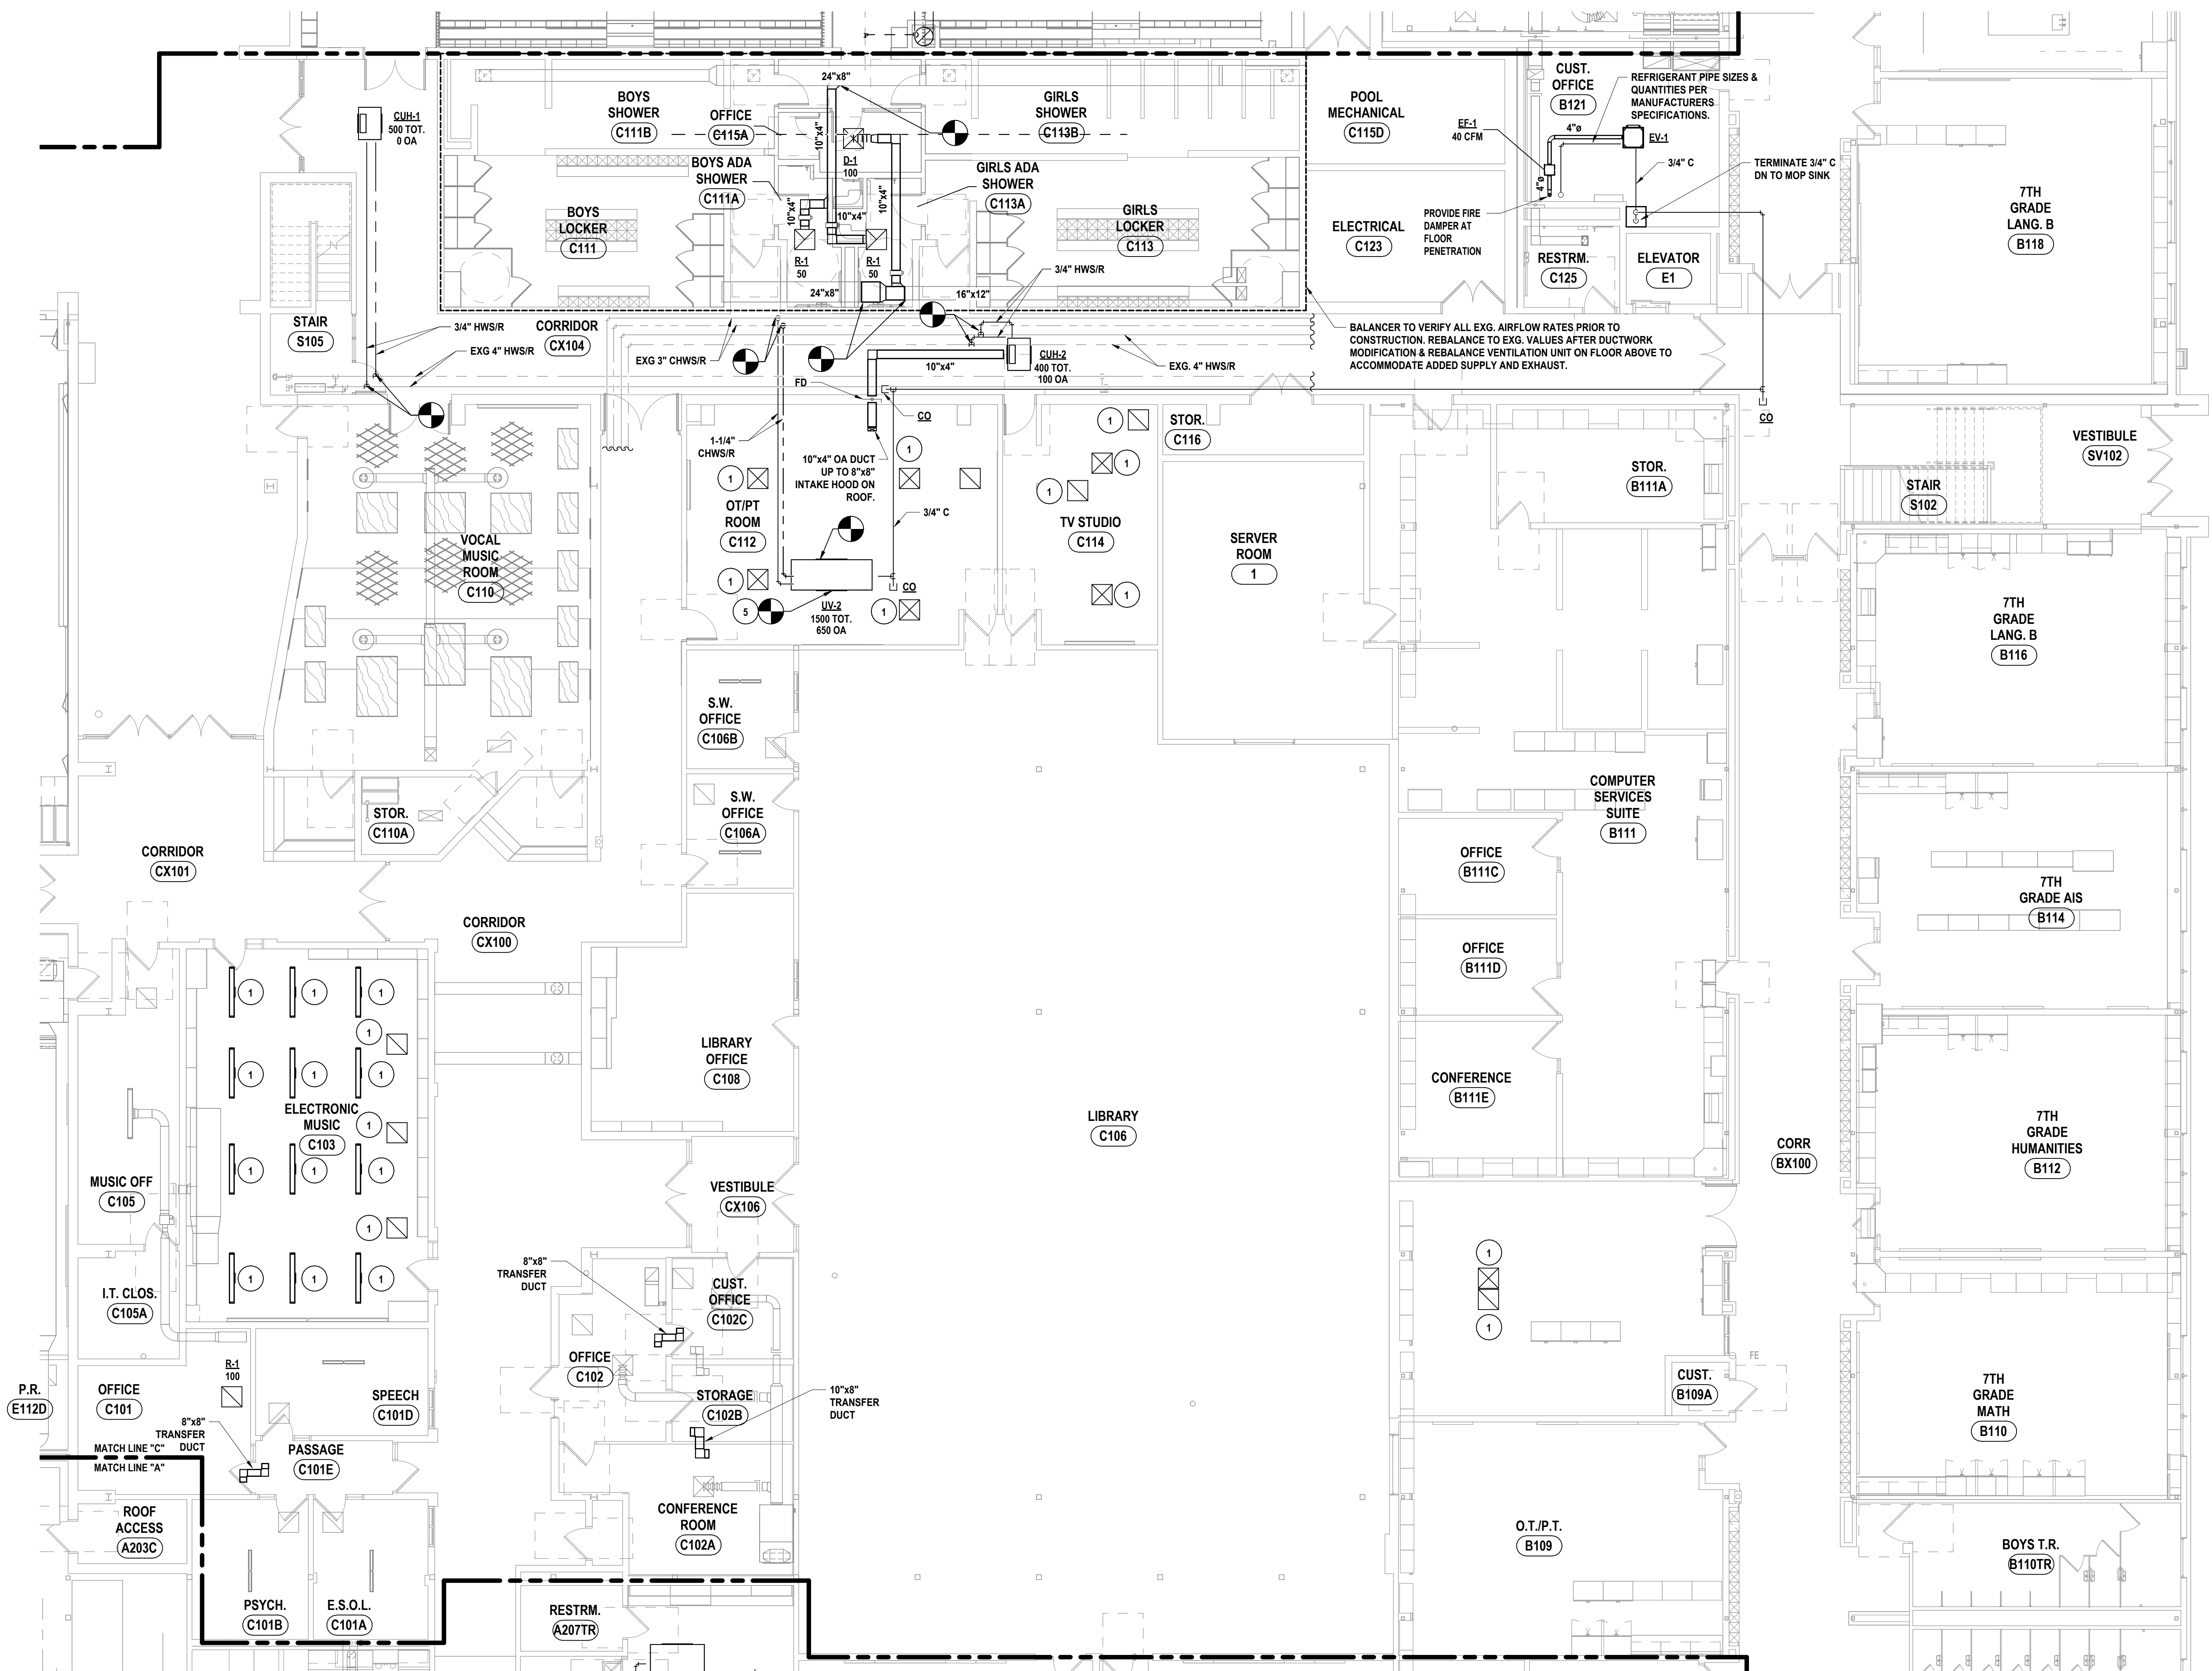

1 FIRST FLOOR HVAC PLAN - AREA C  
1/8" = 1'-0"

DRAWN BY: KTK  
CHECKED BY: ENS  
DATE: 05/09/2025  
PHASE: CD


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IT IS A VIOLATION OF THE LAW FOR ANY PERSON TO MAKE UNAUTHORIZED ALTERATIONS OR ADDITIONS TO PLANS  
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HUNT ENGINEERS | ARCHITECTS | SURVEYORS  
HORSEHEADS, NY 807-263-1000 ROCHESTER, NY 585-537-7868 TOWNAND, PA 570-265-4606  
BINGHAMTON, NY 607-798-8881 ALBANY, NY 607-798-8881  
WWW.HUNTEAS.COM  
NY CERTIFICATE NO. 001620 PA CERTIFICATE NO. TSC220313464-1

FIRST FLOOR HVAC PLAN - AREA C  
2025 MIDDLE SCHOOL PHASE III ALTERATIONS PROJECT  
CORNING-PAINTED POST ASD  
35 VICTORY HIGHWAY, PAINTED POST, NY 14870

MS-H1.3  
PROJECT NO: 2649-133



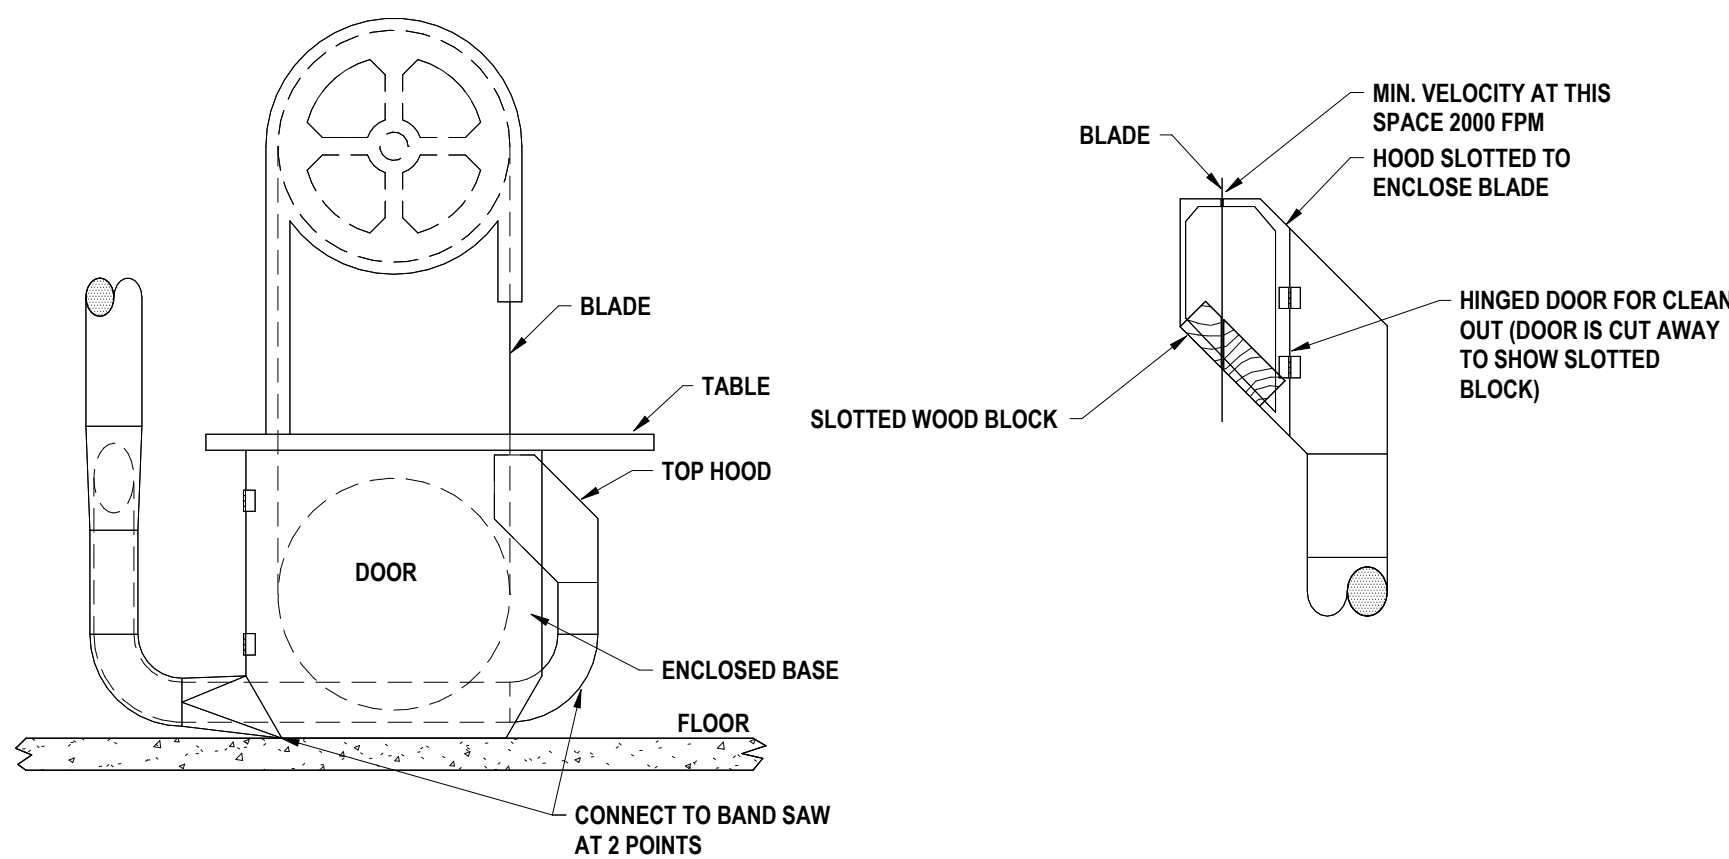


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## GENERAL NOTES - MECHANICAL

REFER TO MS-H-1

## CONSTRUCTION NOTES - MECHANICAL

- CLEAN REGISTERS, GRILLES & DIFFUSERS THOROUGHLY BEFORE PLACEMENT IN NEW CEILING. EXTEND & RECONNECT DUCTWORK TO ACCOMMODATE NEW CEILING LAYOUT. MAINTAIN EXISTING VOLUMETRIC BALANCE DAMPERS.
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- PROVIDE NEW GRILLE AS SCHEDULED. EXTEND AND RECONNECT DUCTWORK AND BALANCE GRILLE TO EXISTING AIRFLOW.
- EXTEND & RECONNECT DUCTWORK & PIPING. INSULATE EXISTING DUCTWORK.

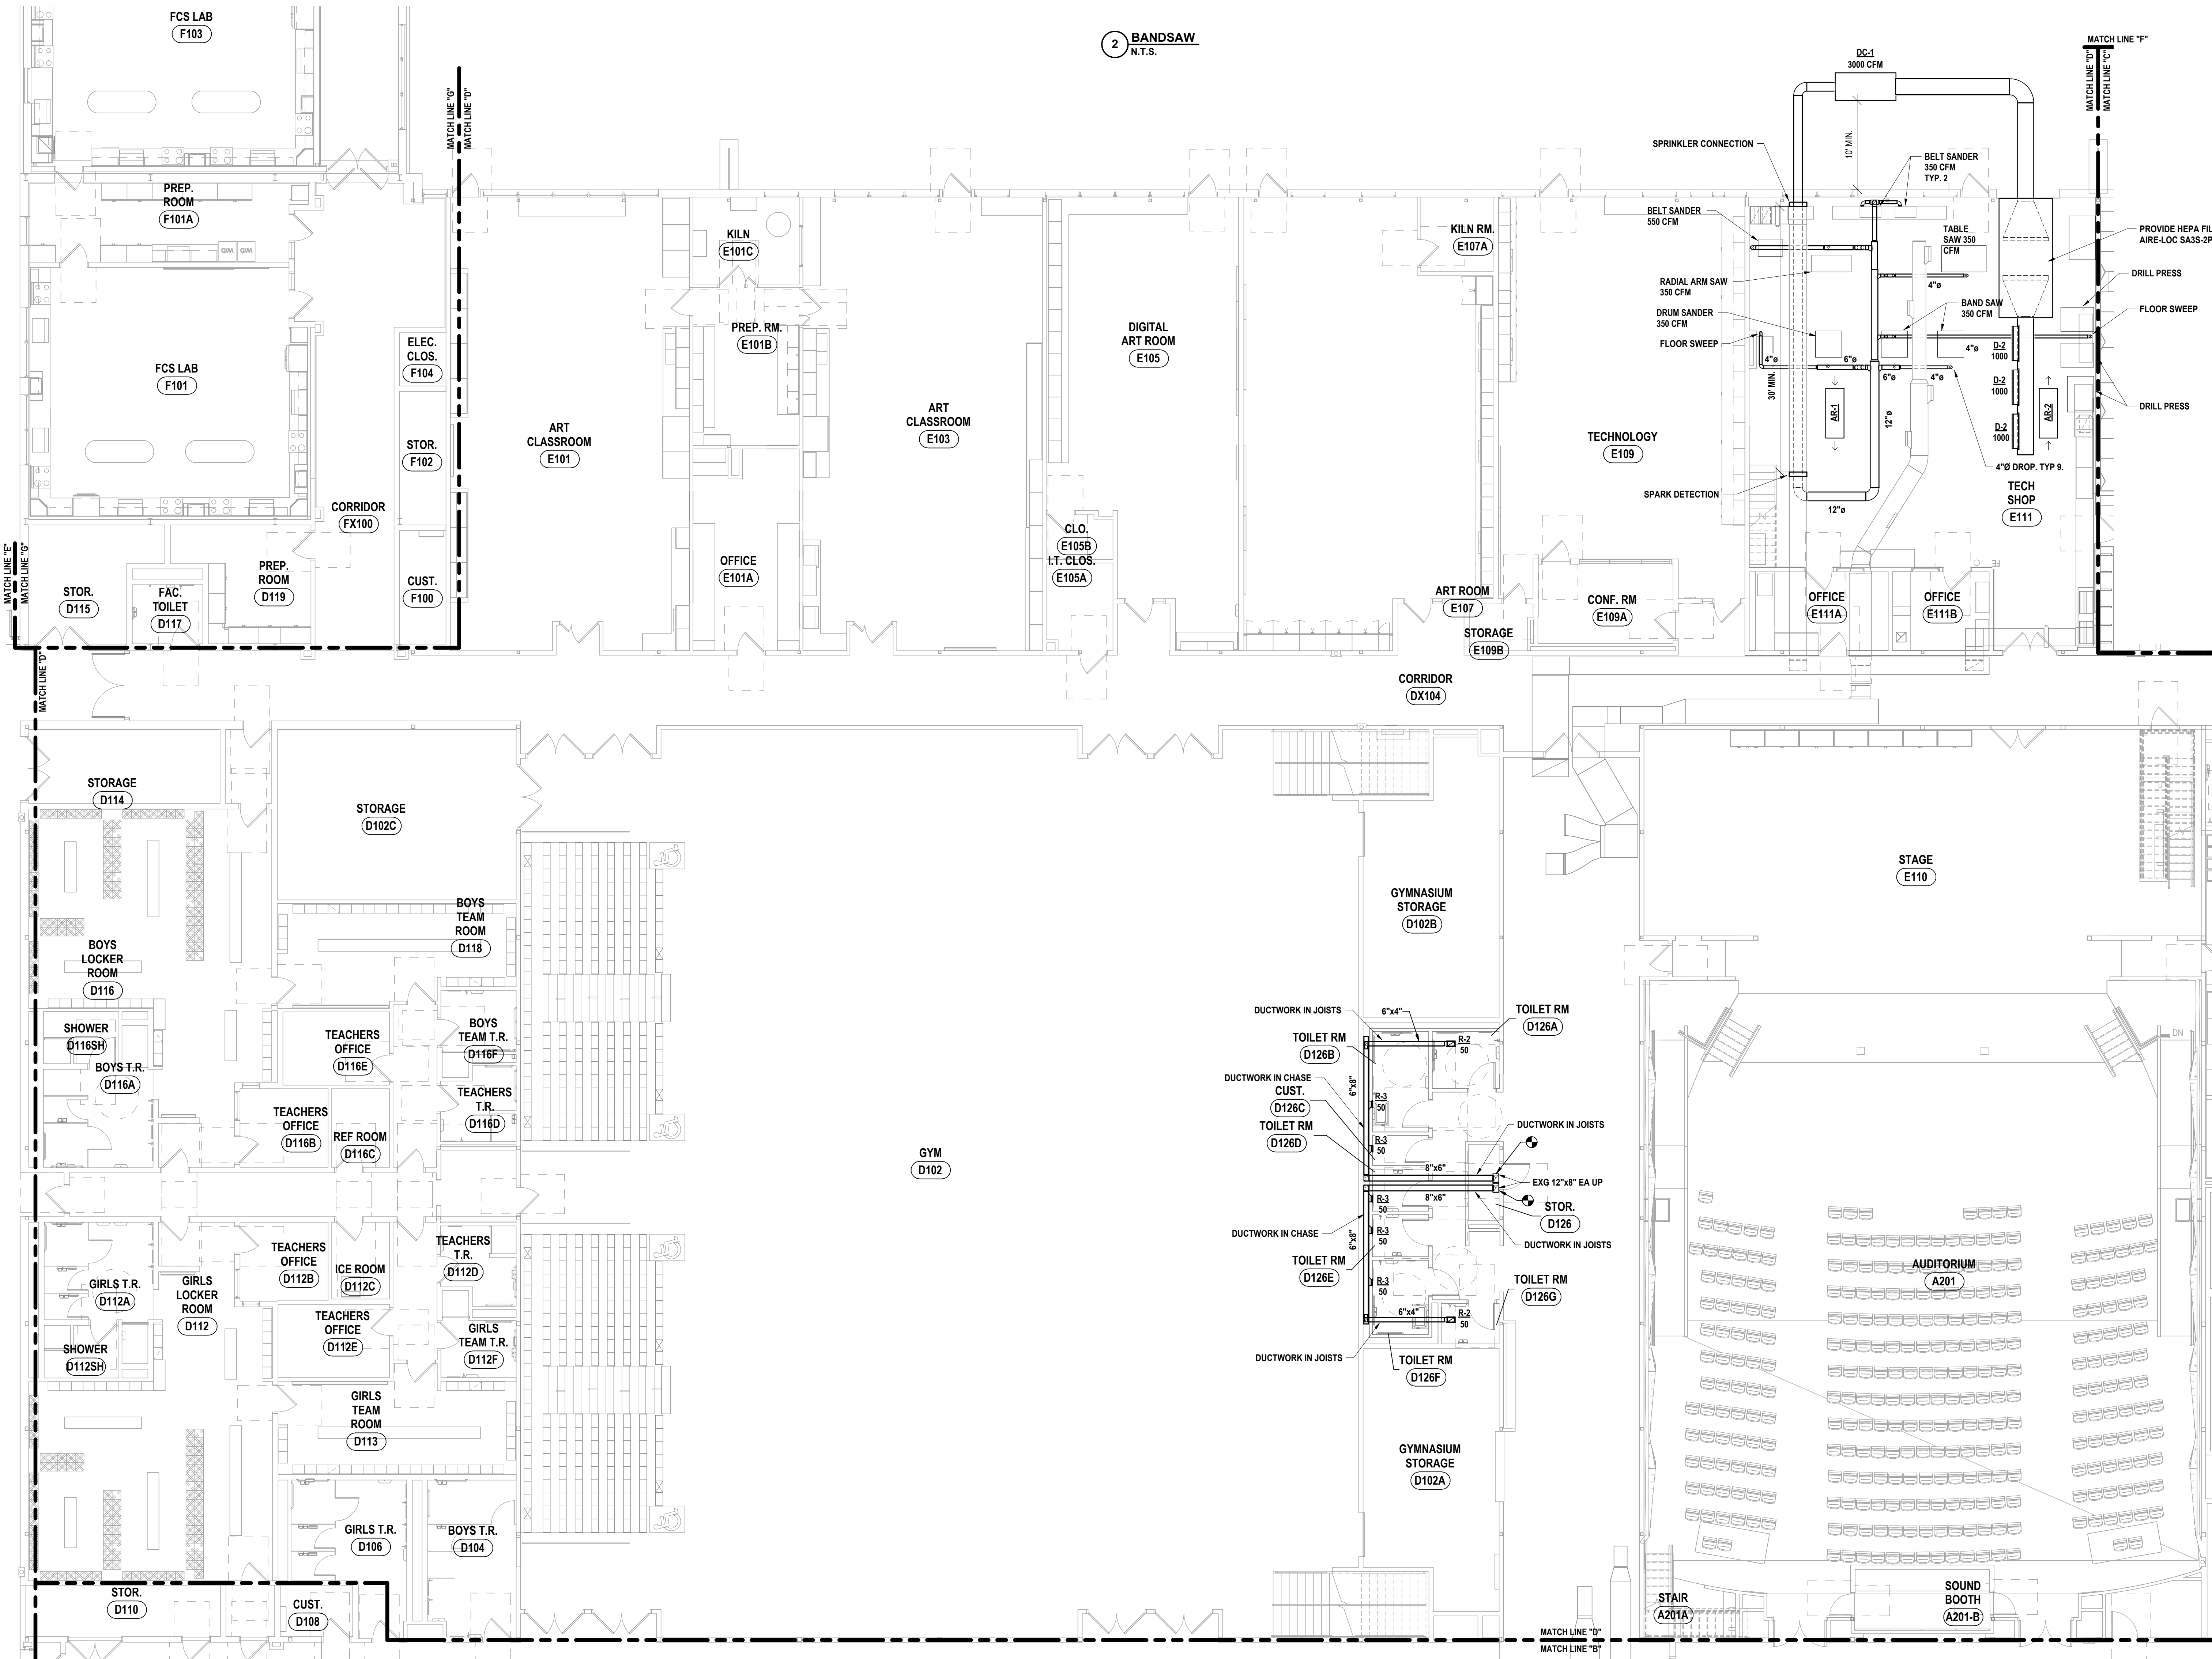


GENERAL NOTES - MECHANICAL


REFER TO MS-H0.1

CONSTRUCTION NOTES - MECHANICAL

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- EXTEND & RECONNECT DUCTWORK & PIPING. INSULATE EXISTING DUCTWORK.

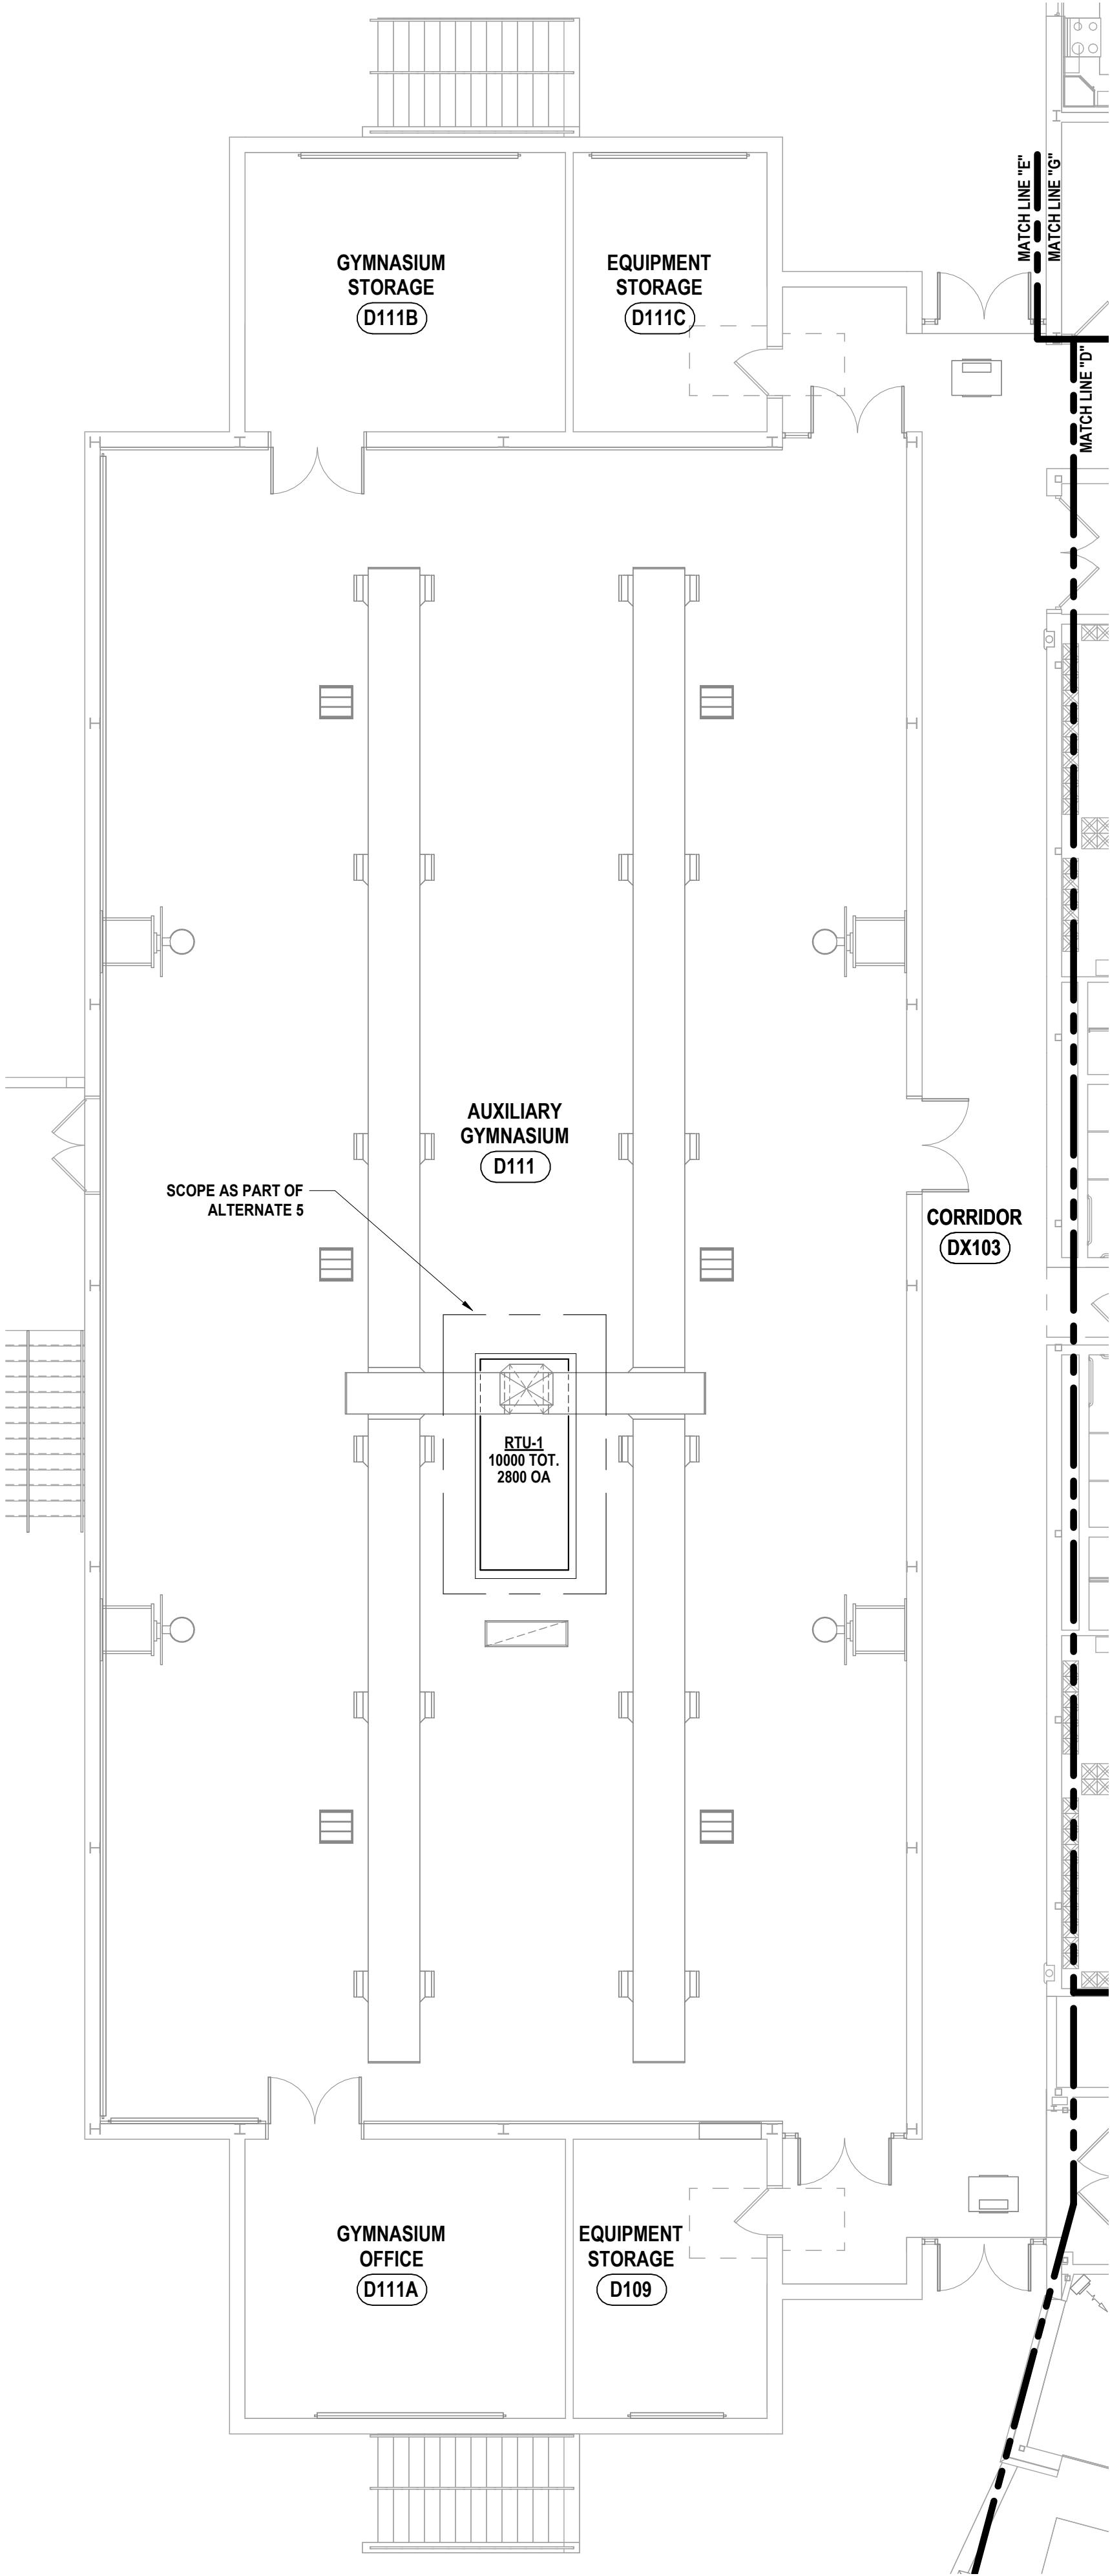

1 FIRST FLOOR HVAC PLAN - AREA E  
1/8" = 1'-0"

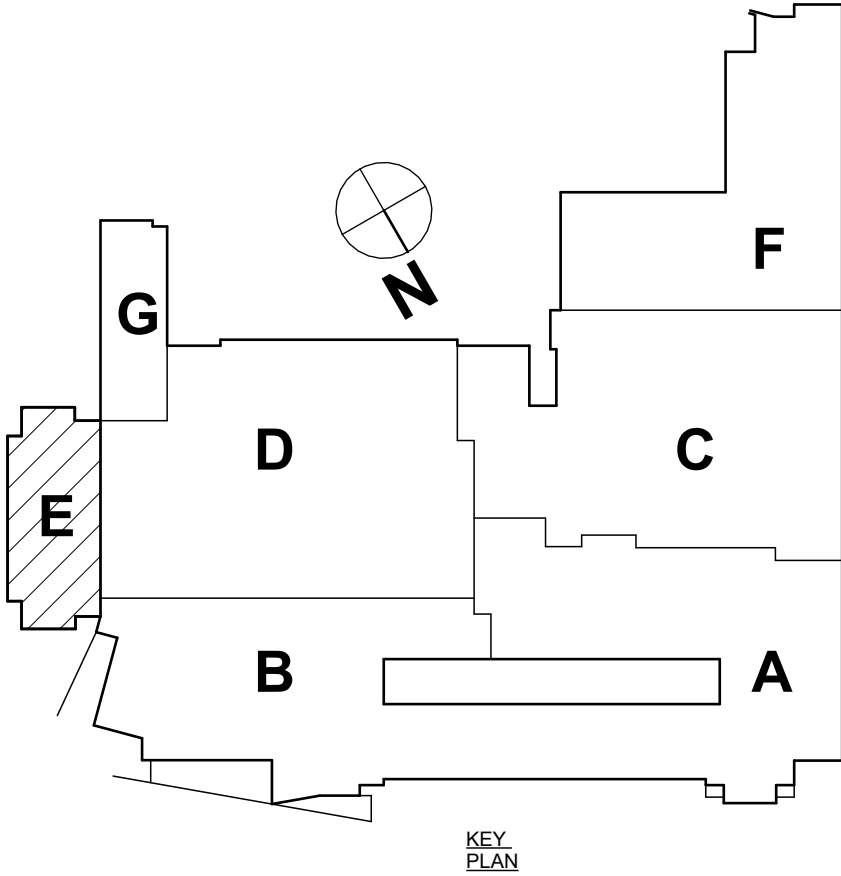

SED #: 57-1600-01-2-024-044 - MIDDLE SCHOOL

FIRST FLOOR HVAC PLAN - AREA E  
2025 MIDDLE SCHOOL PHASE III ALTERATIONS PROJECT  
CORNING-PAINTED POST ASD  
35 VICTORY HIGHWAY, PAINTED POST, NY 14870

MS-H1.5  
PROJECT NO: 2649-153

HUNT ENGINEERS | ARCHITECTS | SURVEYORS  
HORSEHEADS, NY 607-258-1000 ROCHESTER, NY 565-537-7649 TOWNANDA, PA 570-265-4666  
BINGHAMTON, NY 607-798-8881 ALBANY, NY 607-798-8881  
WWW.HUNTEAS.COM  
NY CERTIFICATE NO. 0016220 PA CERTIFICATE NO. TSC2220131464-1

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IT IS A VIOLATION OF THE LAW FOR ANY PERSON TO MAKE UNAUTHORIZED ALTERATIONS OR ADDITIONS TO PLANS DRAWN BY LICENSED ENGINEERS, ARCHITECTS, SURVEYORS OR BUILDERS.

DRAWN BY:	KMM
CHECKED BY:	ENS
DATE:	05/09/2025
PHASE:	CD

05/09/2025



GENERAL NOTES - MECHANICAL  
REFER TO MS-H0.1

CONSTRUCTION NOTES - MECHANICAL




- CLEAN REGISTERS, GRILLES & DIFFUSERS THOROUGHLY BEFORE PLACEMENT IN NEW CEILING. EXTEND & RECONNECT DUCTWORK TO ACCOMMODATE NEW CEILING LAYOUT. MAINTAIN EXISTING VOLUMETRIC BALANCE DAMPERS.
- PROVIDE BURIED HDPE PIPING IN LOCATION INDICATED TO SERVE GUTTER EVACUATION SYSTEM. SLOPE ALL BURIED PIPING AT 1/8" PER 1' SLOPE TO THE BASE OF THE PIPING RISER TO ALLOW DRAINAGE.
- PLUMBING CONNECTION LOCATED AT BOTTOM OF DUCTWORK RISER TO DRAIN ENTRAINED MOISTURE. PROVIDE ACCESS IN CHASE FOR CLEANOUT. REFER TO DETAIL MS-H1.6.2. COORDINATE AS NECESSARY.
- PROVIDE NEW GRILLE AS SCHEDULED. EXTEND AND RECONNECT DUCTWORK AND BALANCE GRILLE TO EXISTING AIRFLOW.
- EXTEND & RECONNECT DUCTWORK & PIPING. INSULATE EXISTING DUCTWORK.

DRAWN BY: KMM	
CHECKED BY: ENS	
DATE: 05/09/2025	
PHASE: CD	
DESCRIPTION OF REVISION: ISSUED FOR BID	
#	DATE
1	11/03/2025
IT IS A VIOLATION OF THE LAW FOR ANY PERSON TO MAKE UNAUTHORIZED ALTERATIONS OR ADDITIONS TO PLANS DRAWN BY LICENSED ARCHITECTS OR ENGINEERS. CONTRACT DOCUMENTS SHALL BE USED AS SHOWN.	

**HUNT** ENGINEERS | ARCHITECTS | SURVEYORS  
HORSEHEADS, NY 607-268-1000    ROSQUESTER, NY 565-537-7849    TONAWANDA, PA 570-265-4666  
BINGHAMTON, NY 607-798-8881    ALBANY, NY 607-798-8881    WWW.HUNTEAS.COM  
NY CERTIFICATE NO. 0016220    PA CERTIFICATE NO. TSC2220131464-1

FIRST FLOOR HVAC PLAN - AREA F  
2025 MIDDLE SCHOOL PHASE III ALTERATIONS PROJECT  
CORNING-PAINTED POST ASD  
35 VICTORY HIGHWAY, PAINTED POST, NY 14870


MS-H1.6  
PROJECT NO: 2649-153

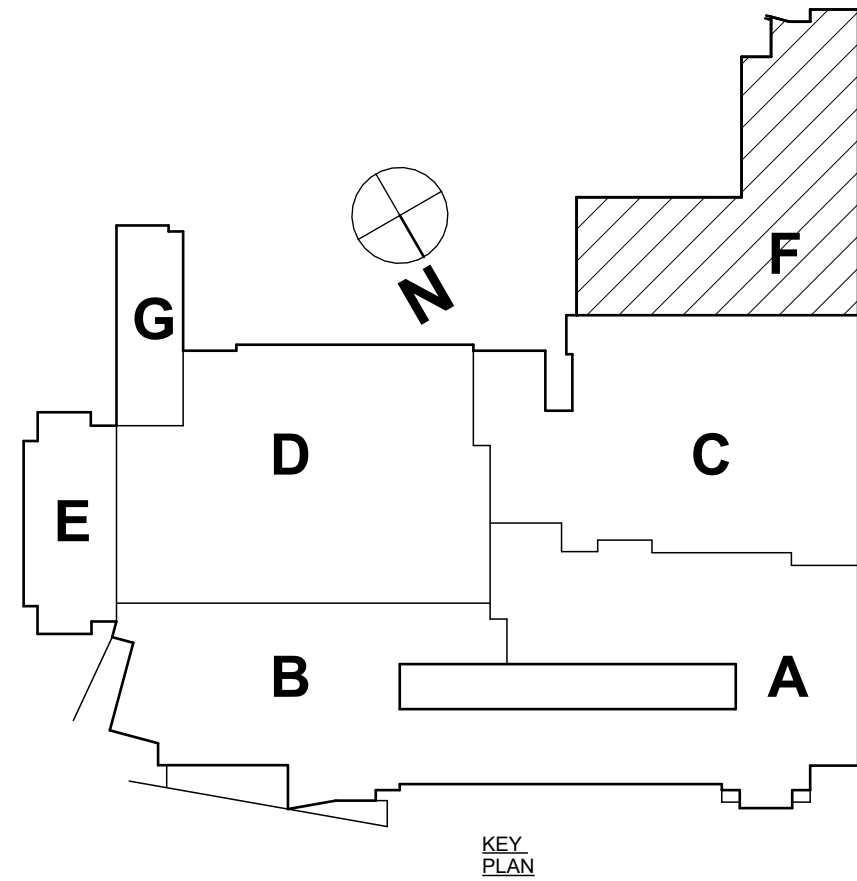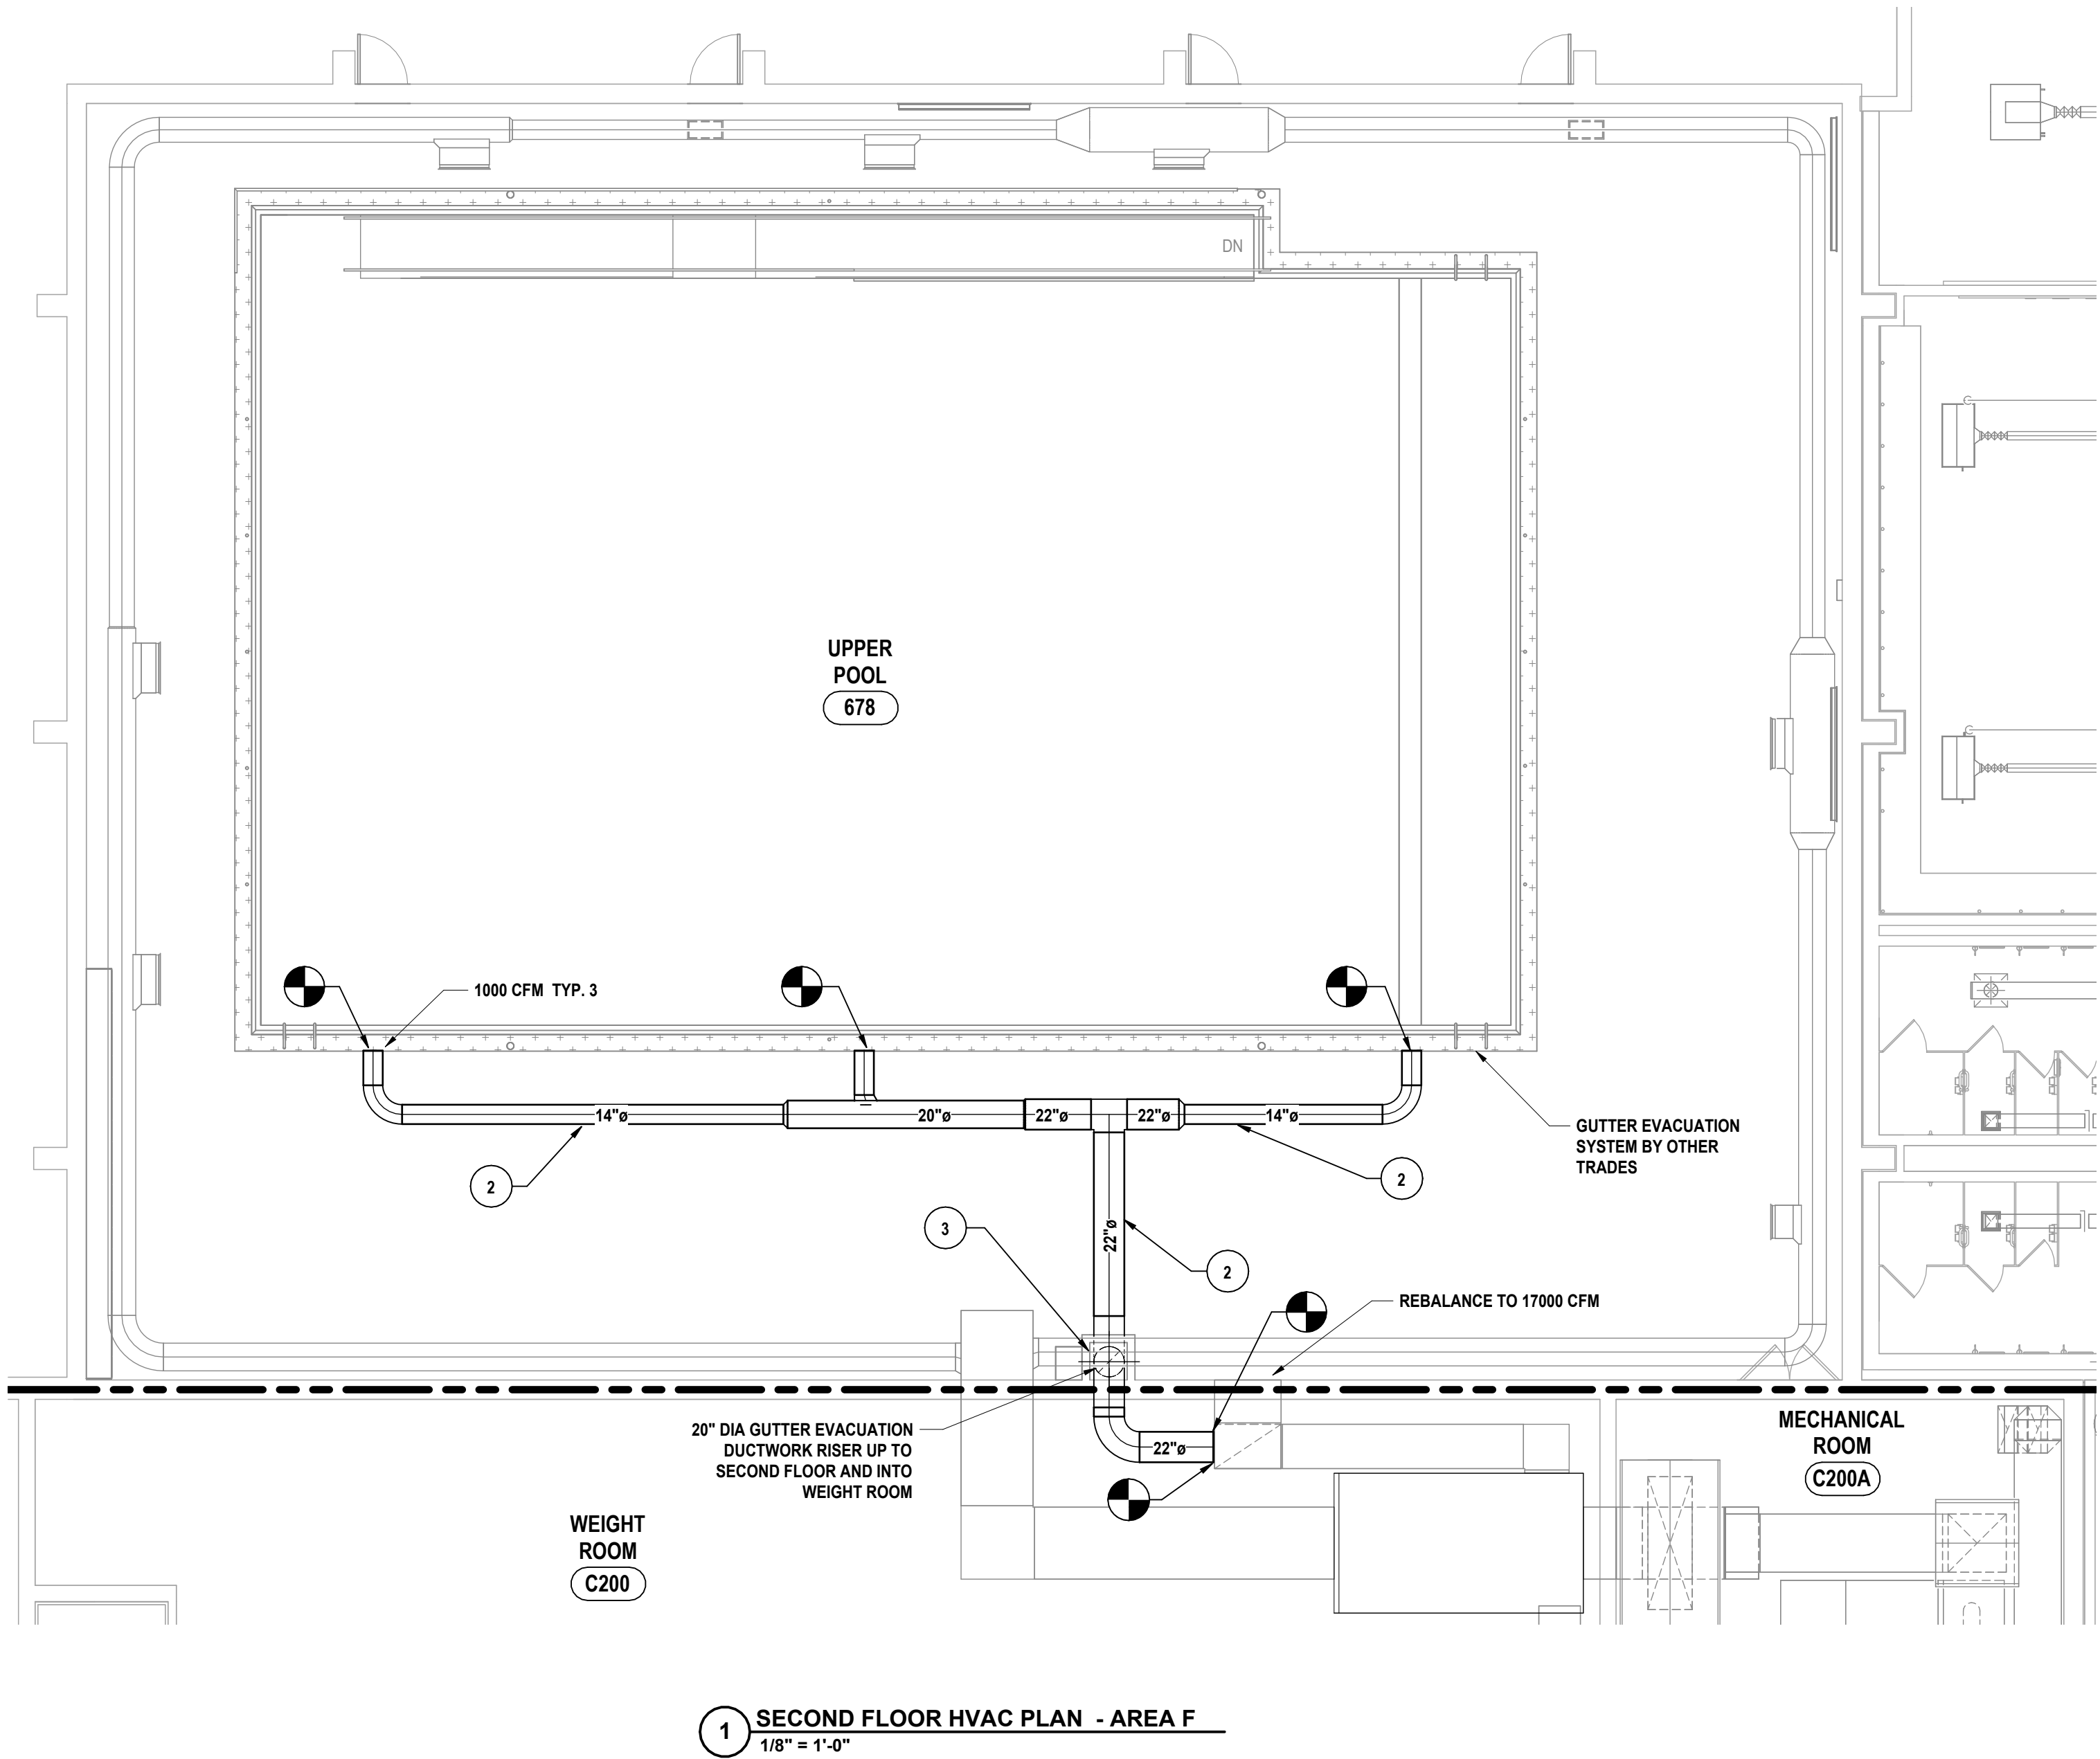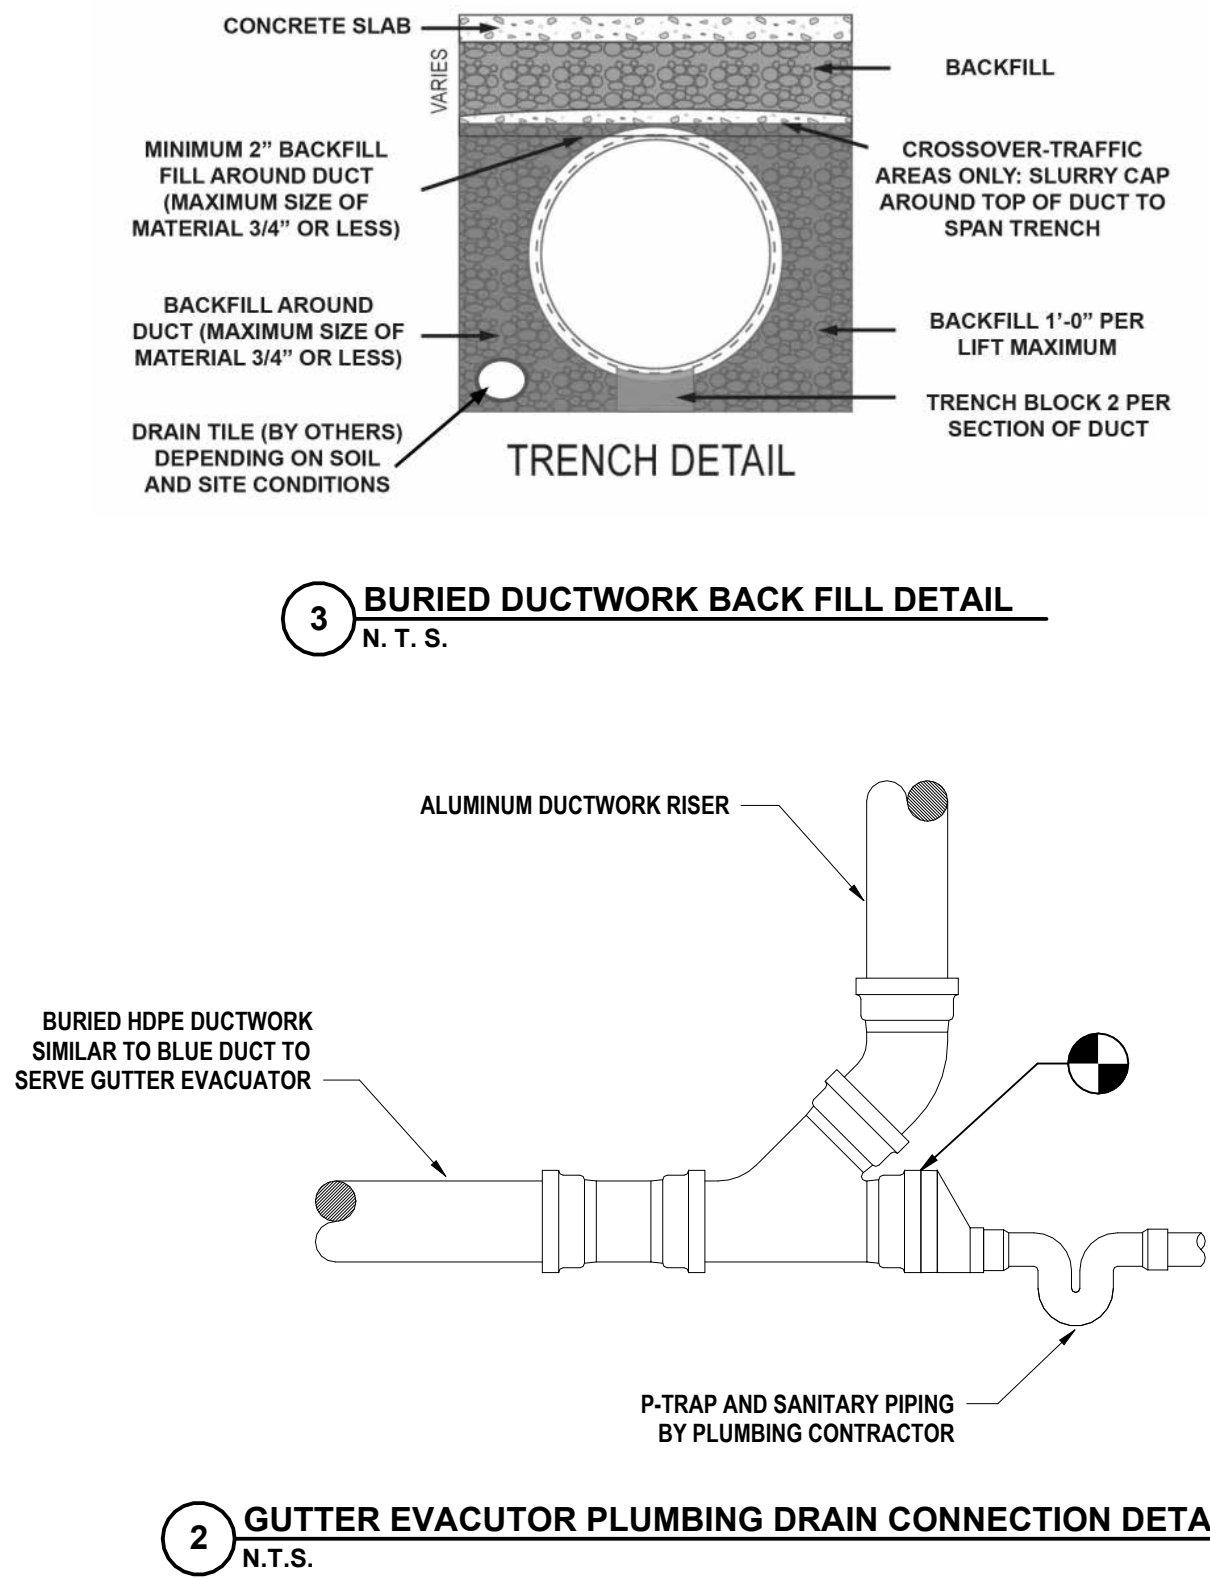

SED #: 57-1600-41-502444 - MIDDLE SCHOOL



1 SECOND FLOOR HVAC PLAN - AREA C  
1/8" = 1'-0"

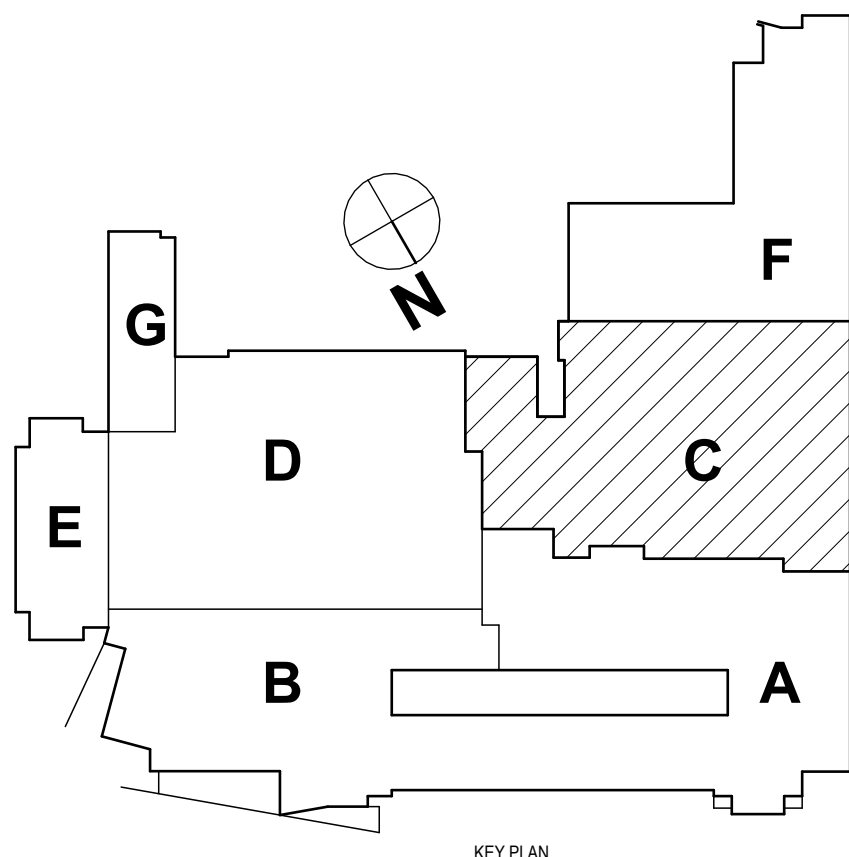

#### GENERAL NOTES - MECHANICAL

REFER TO MS-H0.1

#### CONSTRUCTION NOTES - MECHANICAL

- CLEAN REGISTERS, GRILLES & DIFFUSERS THOROUGHLY BEFORE PLACEMENT IN NEW CEILING. EXTEND & RECONNECT DUCTWORK TO ACCOMMODATE NEW CEILING LAYOUT. MAINTAIN EXISTING VOLUMETRIC BALANCE DAMPERS.
- PROVIDE BURIED HDPE PIPING IN LOCATION INDICATED TO SERVE GUTTER EVACUATION SYSTEM. SLOPE ALL BURIED PIPING AT 1/8" PER 1' SLOPE TO THE BASE OF THE PIPING RISER TO ALLOW DRAINAGE.
- PLUMBING CONNECTION LOCATED AT BOTTOM OF DUCTWORK RISER TO DRAIN ENTRAINED MOISTURE. PROVIDE ACCESS IN CHASE FOR CLEANOUT. REFER TO DETAIL MS-H1.6.2. COORDINATE AS NECESSARY.
- PROVIDE NEW GRILLE AS SCHEDULED. EXTEND AND RECONNECT DUCTWORK AND BALANCE GRILLE TO EXISTING AIRFLOW.
- EXTEND & RECONNECT DUCTWORK & PIPING. INSULATE EXISTING DUCTWORK.

SED #: 57-16-00-01-2-024-044 - MIDDLE SCHOOL

SECOND FLOOR HVAC PLAN - AREA C  
2025 MIDDLE SCHOOL PHASE III ALTERATIONS PROJECT  
CORNING-PAINTED POST ASD  
35 VICTORY HIGHWAY, PAINTED POST, NY 14870

MS-H1.7

PROJECT NO: 2649-153

**HUNT** ENGINEERS | ARCHITECTS | SURVEYORS

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NY CERTIFICATE NO. 0016220 PA CERTIFICATE NO. TSC2220313/464-1

# DATE: 1 10/20/2025

DESCRIPTION OF REVISION:  
ISSUED FOR BID

DRAWN BY: KTK  
CHECKED BY: ENS  
DATE: 05/09/2025  
PHASE: CD

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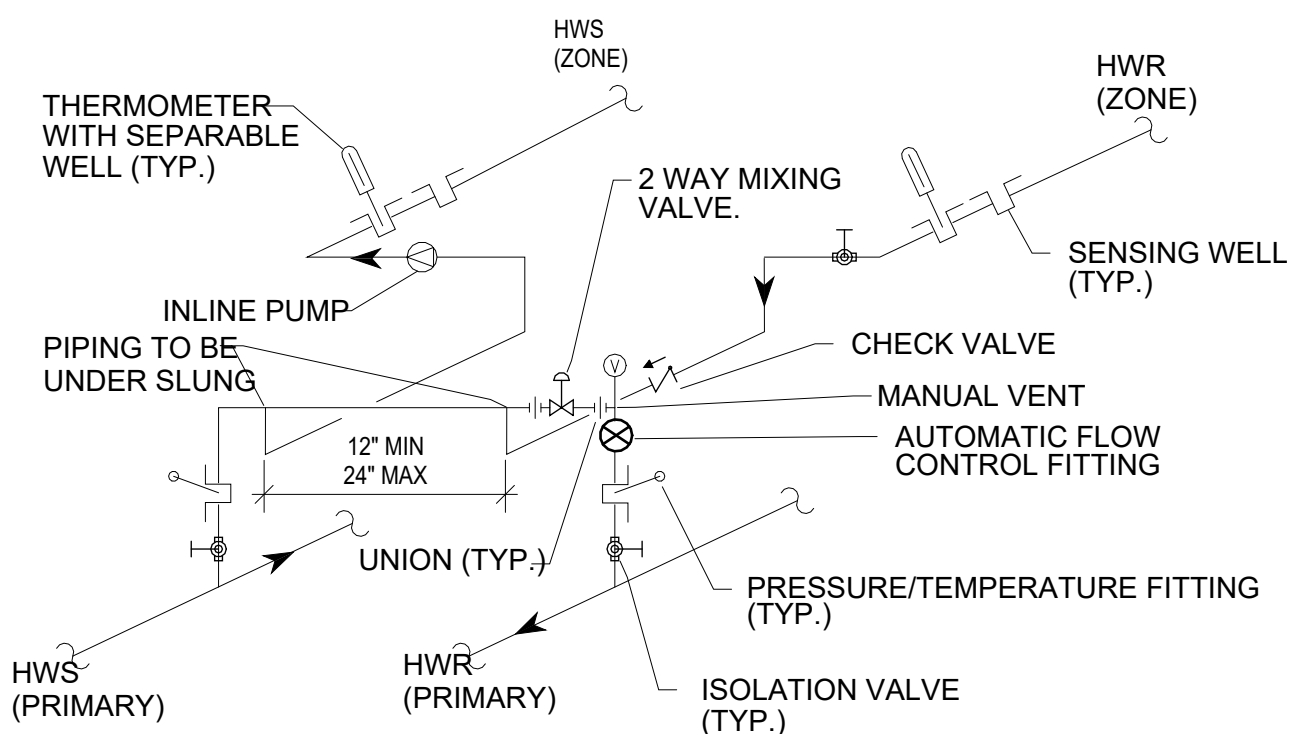


GENERAL NOTES - MECHANICAL


REFER TO MS-H1.1

DEMOLITION NOTES


- D1 REMOVE DUCTWORK & ALL ASSOCIATED ACCESSORIES BACK TO POINTS INDICATED.  
D2 REMOVE HWS & ALL ASSOCIATED ACCESSORIES IN THEIR ENTIRETY.  
D3 REMOVE HWSIR & ALL ASSOCIATED ACCESSORIES IN THEIR ENTIRETY BACK TO POINTS INDICATED.  
D4 REMOVE HWSIR BACK TO POINTS INDICATED AND CAP.  
D5 REMOVE DUST COLLECTOR, RECIRCULATION STYLER FILTER UNITS, AND ALL ASSOCIATED ACCESSORIES IN THEIR ENTIRETY.  
D6 DISCONNECT AND REMOVE COIL, DUCTWORK, AND ALL ASSOCIATED ACCESSORIES BACK TO POINTS INDICATED.  
D7 REMOVE CEILING MOUNTED DIFFUSER/REGISTER/GRILLE. DISCONNECT FROM DUCTWORK. RETAIN & PROTECT THE EXISTING REGISTERS, GRILLES & DIFFUSERS.  
D8 DISCONNECT AND REMOVE CABINET UNIT HEATER, CONTROLS, AND ALL ASSOCIATED ACCESSORIES. PREPARE HOT WATER SUPPLY AND RETURN FOR NEW CONNECTIONS.  
D9 PRIOR TO DEMOLITION, HAVE BALANCER DETERMINE EXISTING AIRFLOW. AFTER EXISTING AIRFLOW IS DETERMINED, REMOVE GRILLE AND DUCTWORK BACK TO POINTS INDICATED.  
D10 DISCONNECT & REMOVE HORIZONTAL UNIT VENTILATOR. DISCONNECT DUCTWORK. SUPPLY DUCTWORK TO REMAIN. DISCONNECT HOT WATER SUPPLY & RETURN, PIPING TO REMAIN.  
D11 REMOVE PUMP AND ALL ASSOCIATED ACCESSORIES.  
D12 REMOVE HWSIR IN ITS ENTIRETY. RETAIN COIL CONNECTIONS, CONTROL VALVES, AND ACCESSORIES FOR RECONNECTION.




6 TYPICAL PRIMARY/ SECONDARY HOT WATER PIPING SCHEMATIC  
N.T.S.

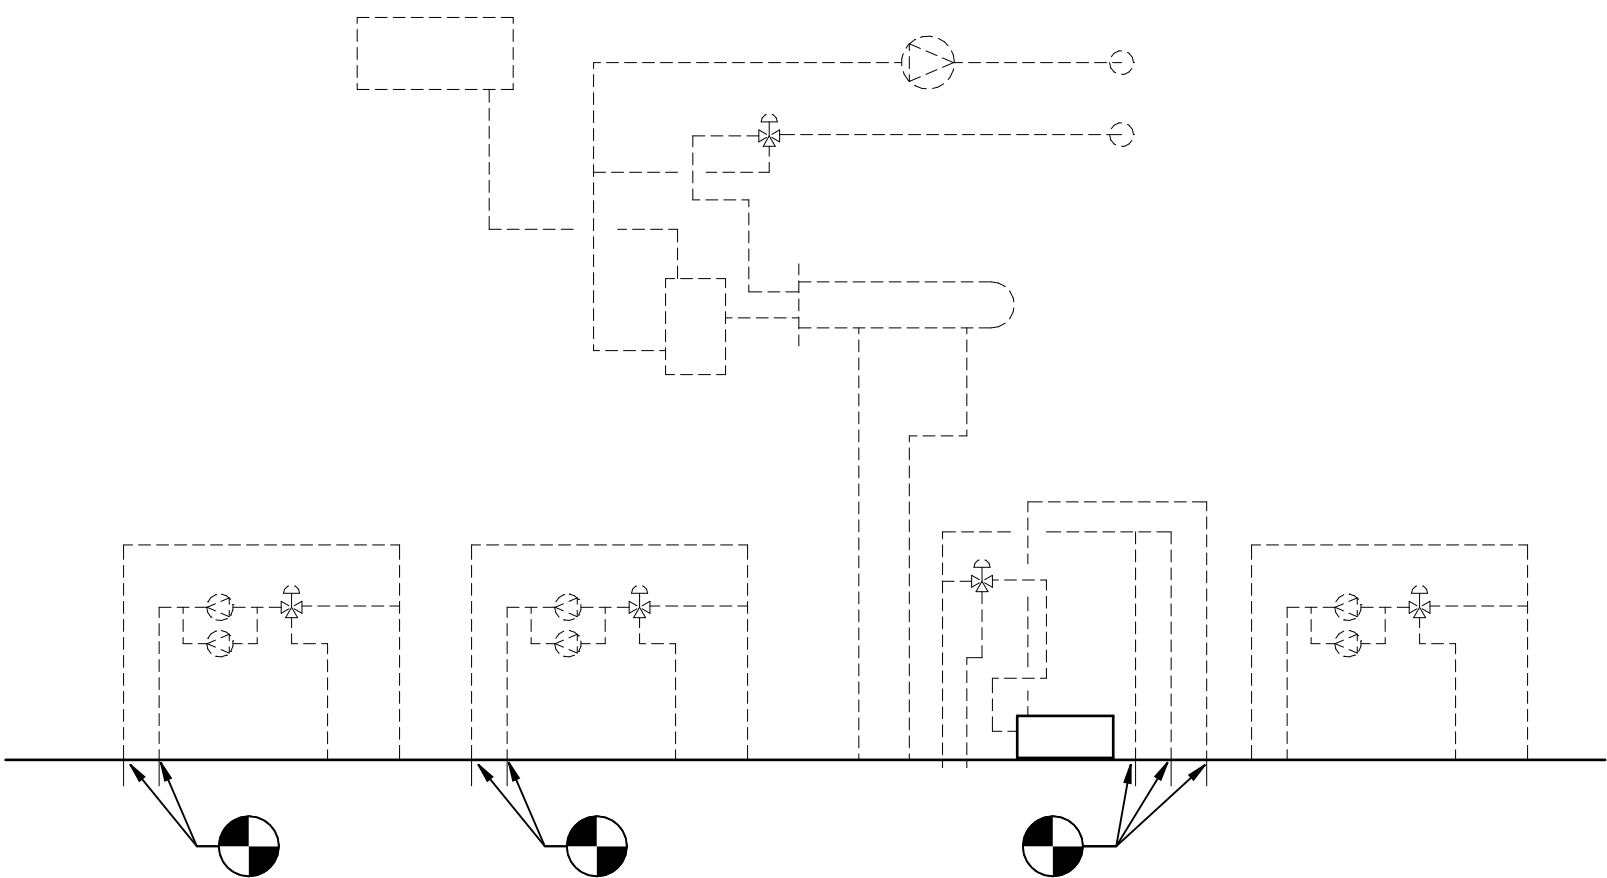


5 MECHANICAL ELEVATION DEMOLITION.  
1/8" = 1'-0"

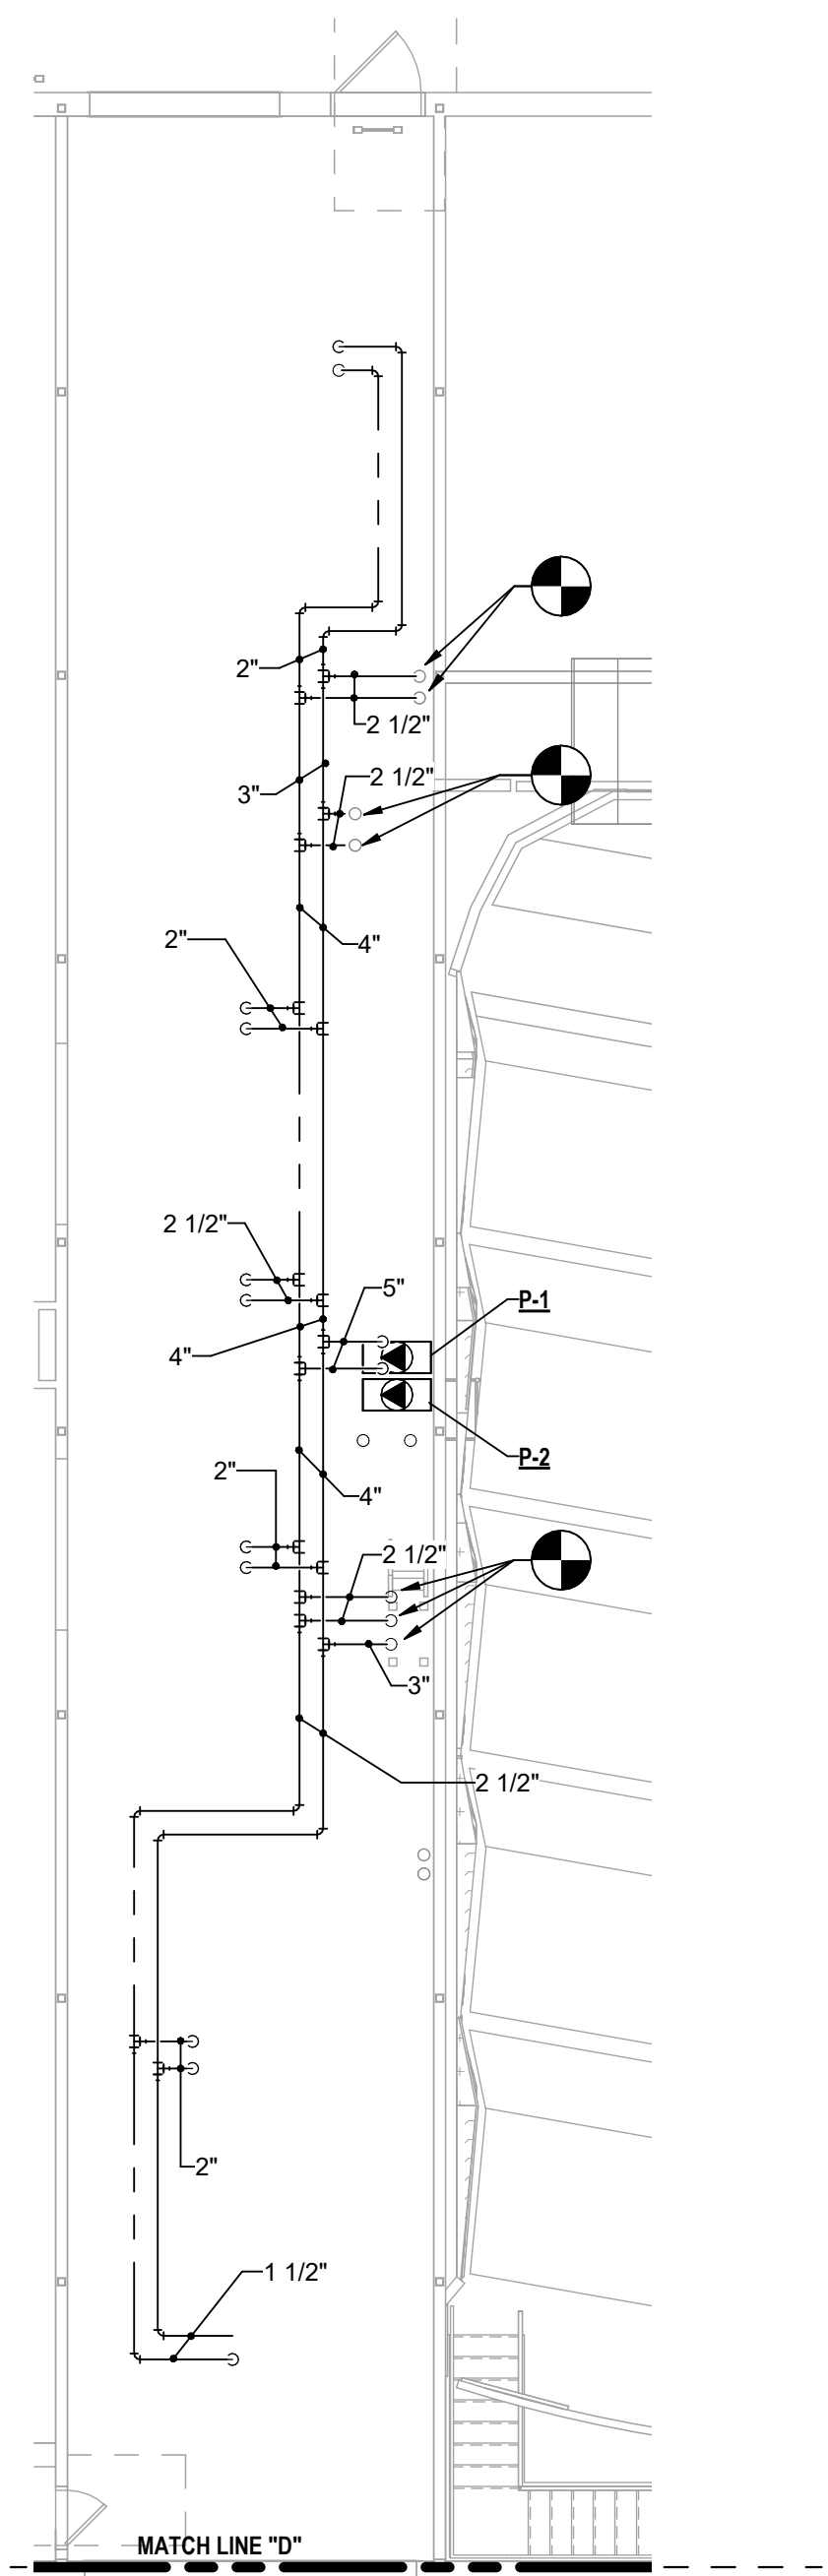


4 SECOND ROOM PIPING PLAN - AREA D  
1/8" = 1'-0"

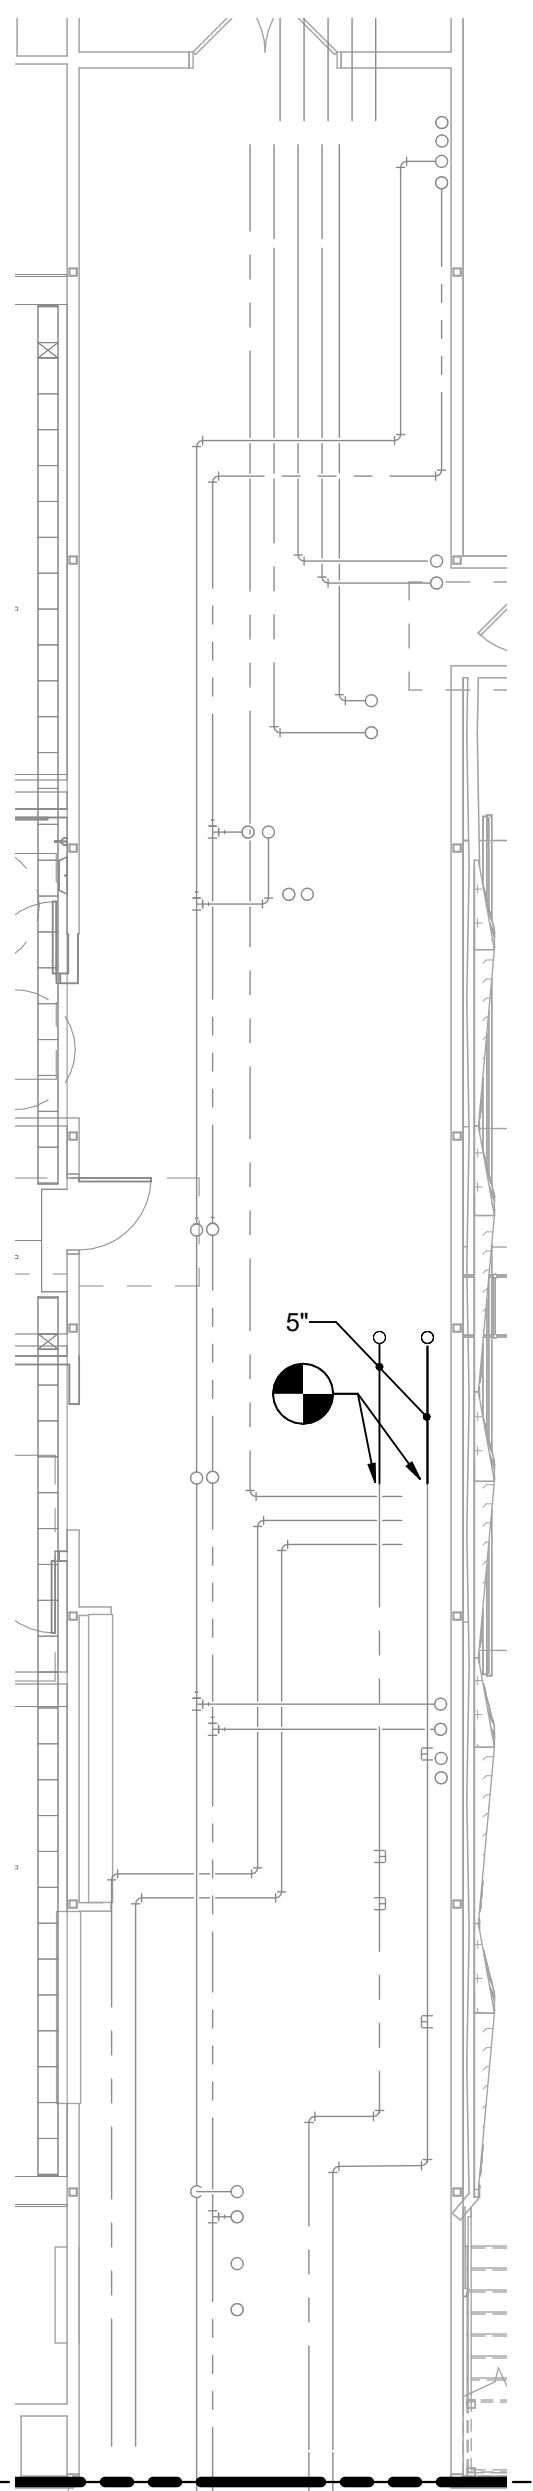


3 PARTIAL FIRST FLOOR PIPING PLAN - AREA D  
1/8" = 1'-0"

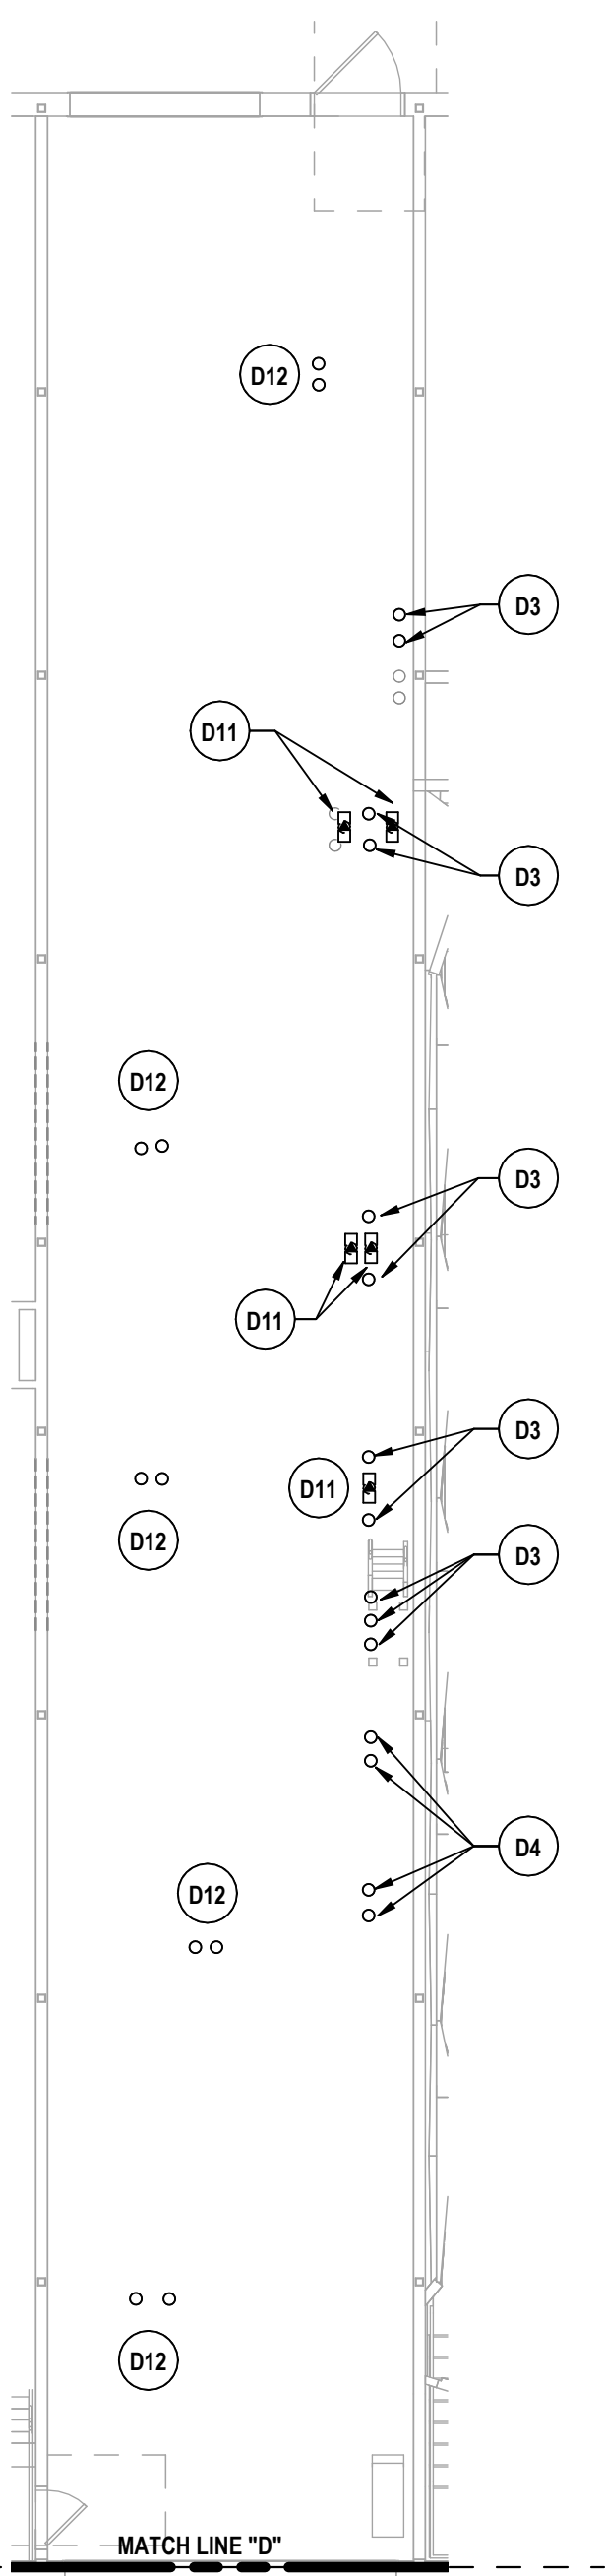

2 SECOND FLOOR HVAC DEMOLITION PLAN - AREA D  
1/8" = 1'-0"

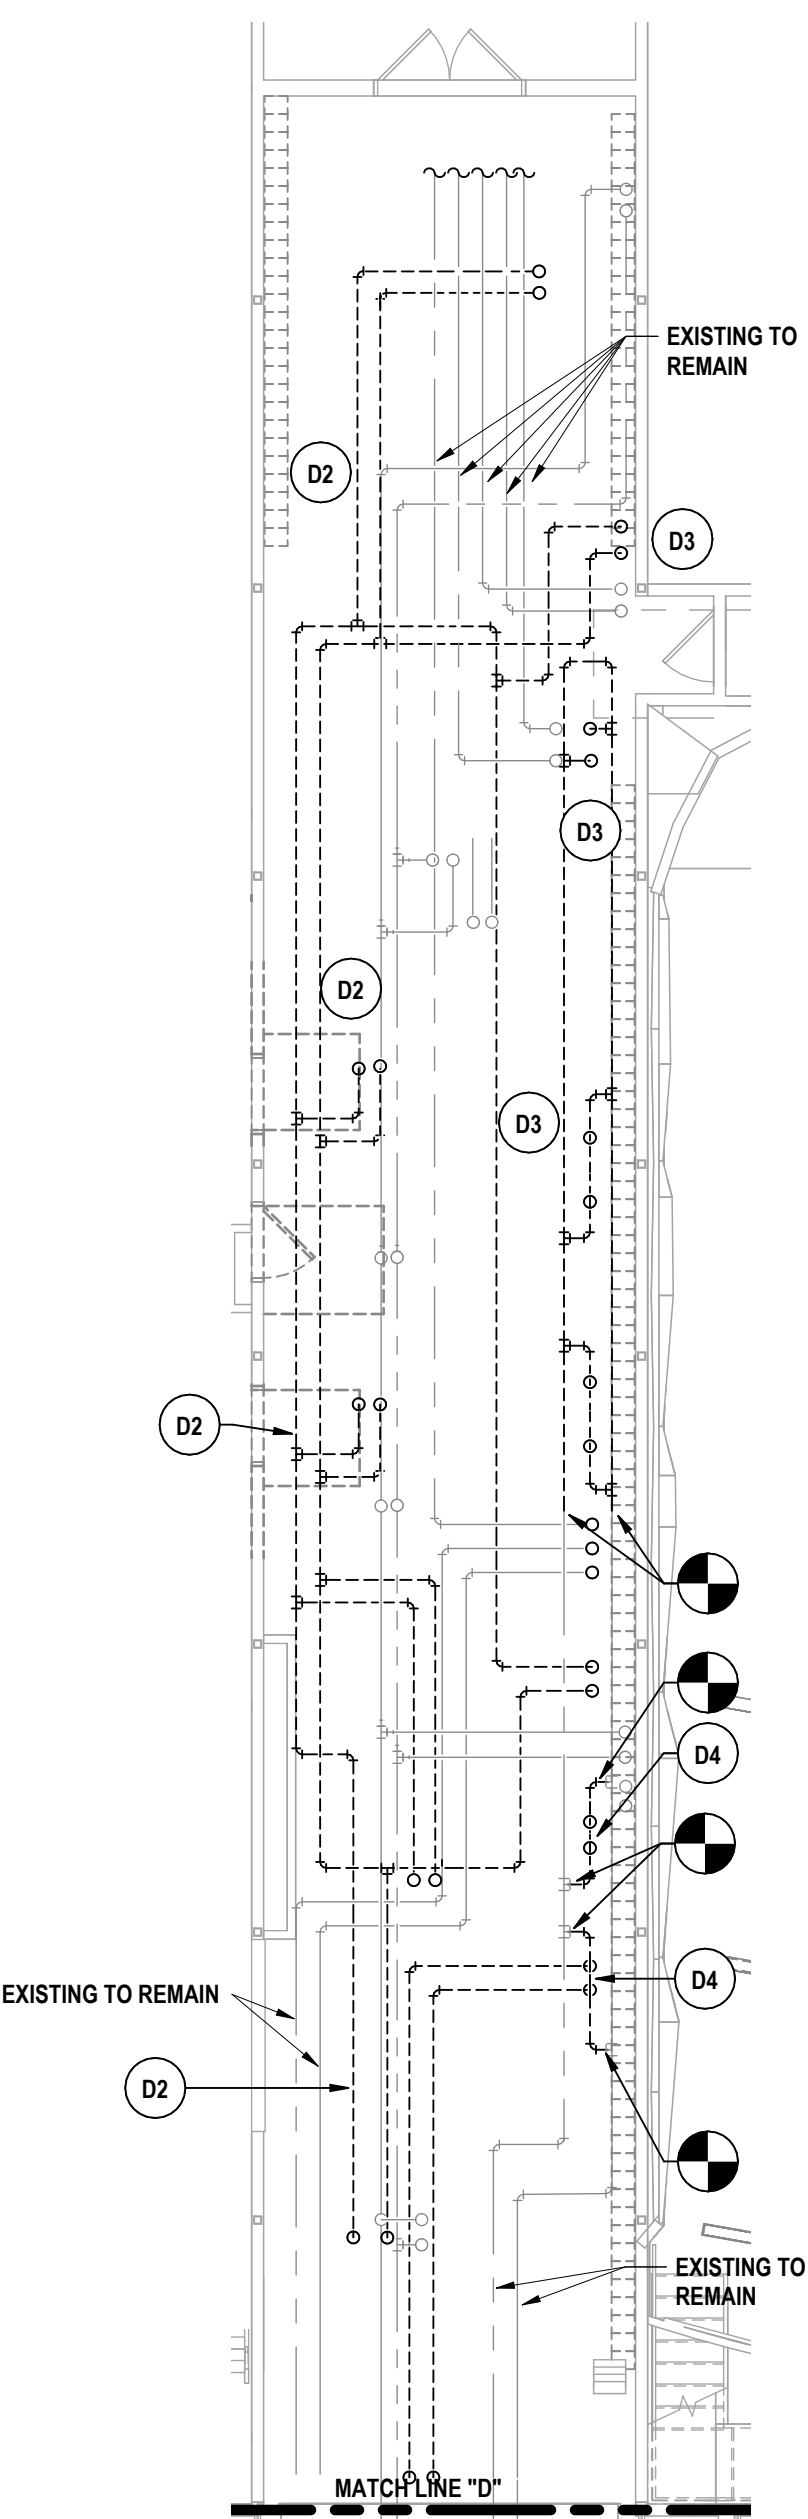

1 FIRST FLOOR HVAC DEMOLITION PLAN - AREA D  
1/8" = 1'-0"

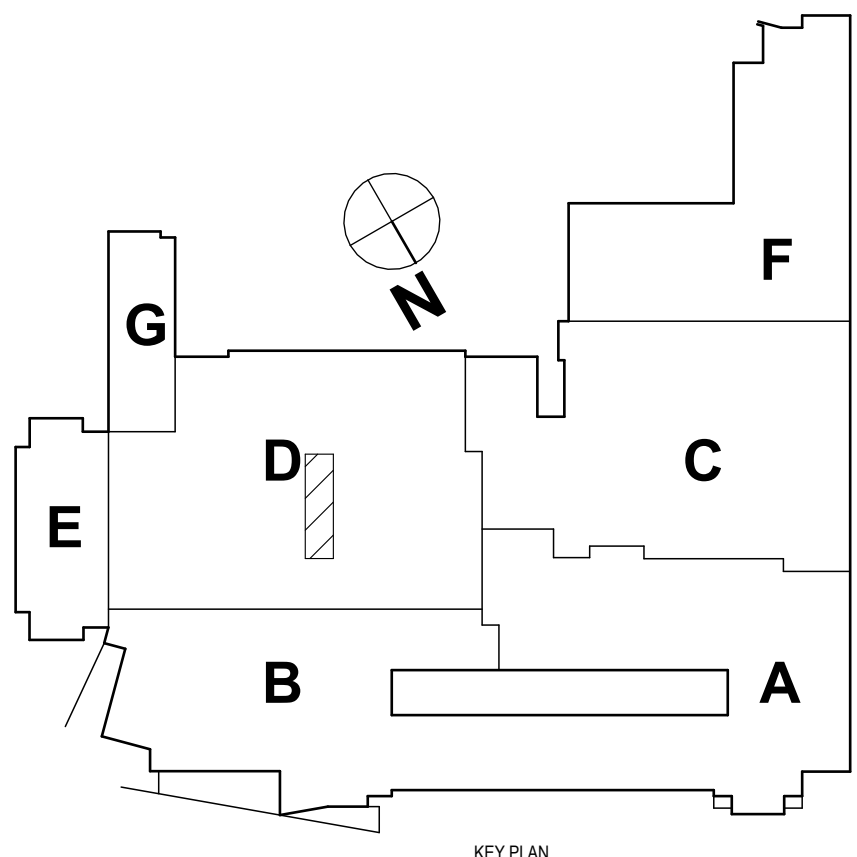

SED #: 57-000-01-000-044 - MIDDLE SCHOOL

PARTIAL MECHANICAL ROOM PIPING PLANS

2025 MIDDLE SCHOOL PHASE III ALTERATIONS PROJECT

CORNING-PAINTED POST ASD

35 VICTORY HIGHWAY, PAINTED POST, NY 14870

HUNT ENGINEERS | ARCHITECTS | SURVEYORS

HORSEHEADS, NY 607-263-1000 ROCHESTER, NY 565-537-7668 TOWNANDA, PA 570-265-4666

BINGHAMTON, NY 607-798-8881 ALBANY, NY 607-798-8801

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NY CERTIFICATE NO. 0016220 PA CERTIFICATE NO. TSC220313464-1

DESCRIPTION OF REVISION:  
ISSUED FOR BID

# DATE:  
1 10/20/2025

PHASE:  
CD

CHECKED BY:  
ENS

DATE:  
05/09/2025

DRAWN BY:  
KTK


DATE:  
05/09/2025

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IT IS A VIOLATION OF THE LAW FOR ANY PERSON TO MAKE UNAUTHORIZED ALTERATIONS OR ADDITIONS TO PLANS  
DRAWN & LOCATED, ENGINEERED, ARCHITECTED & SURVEYED BY DATE:





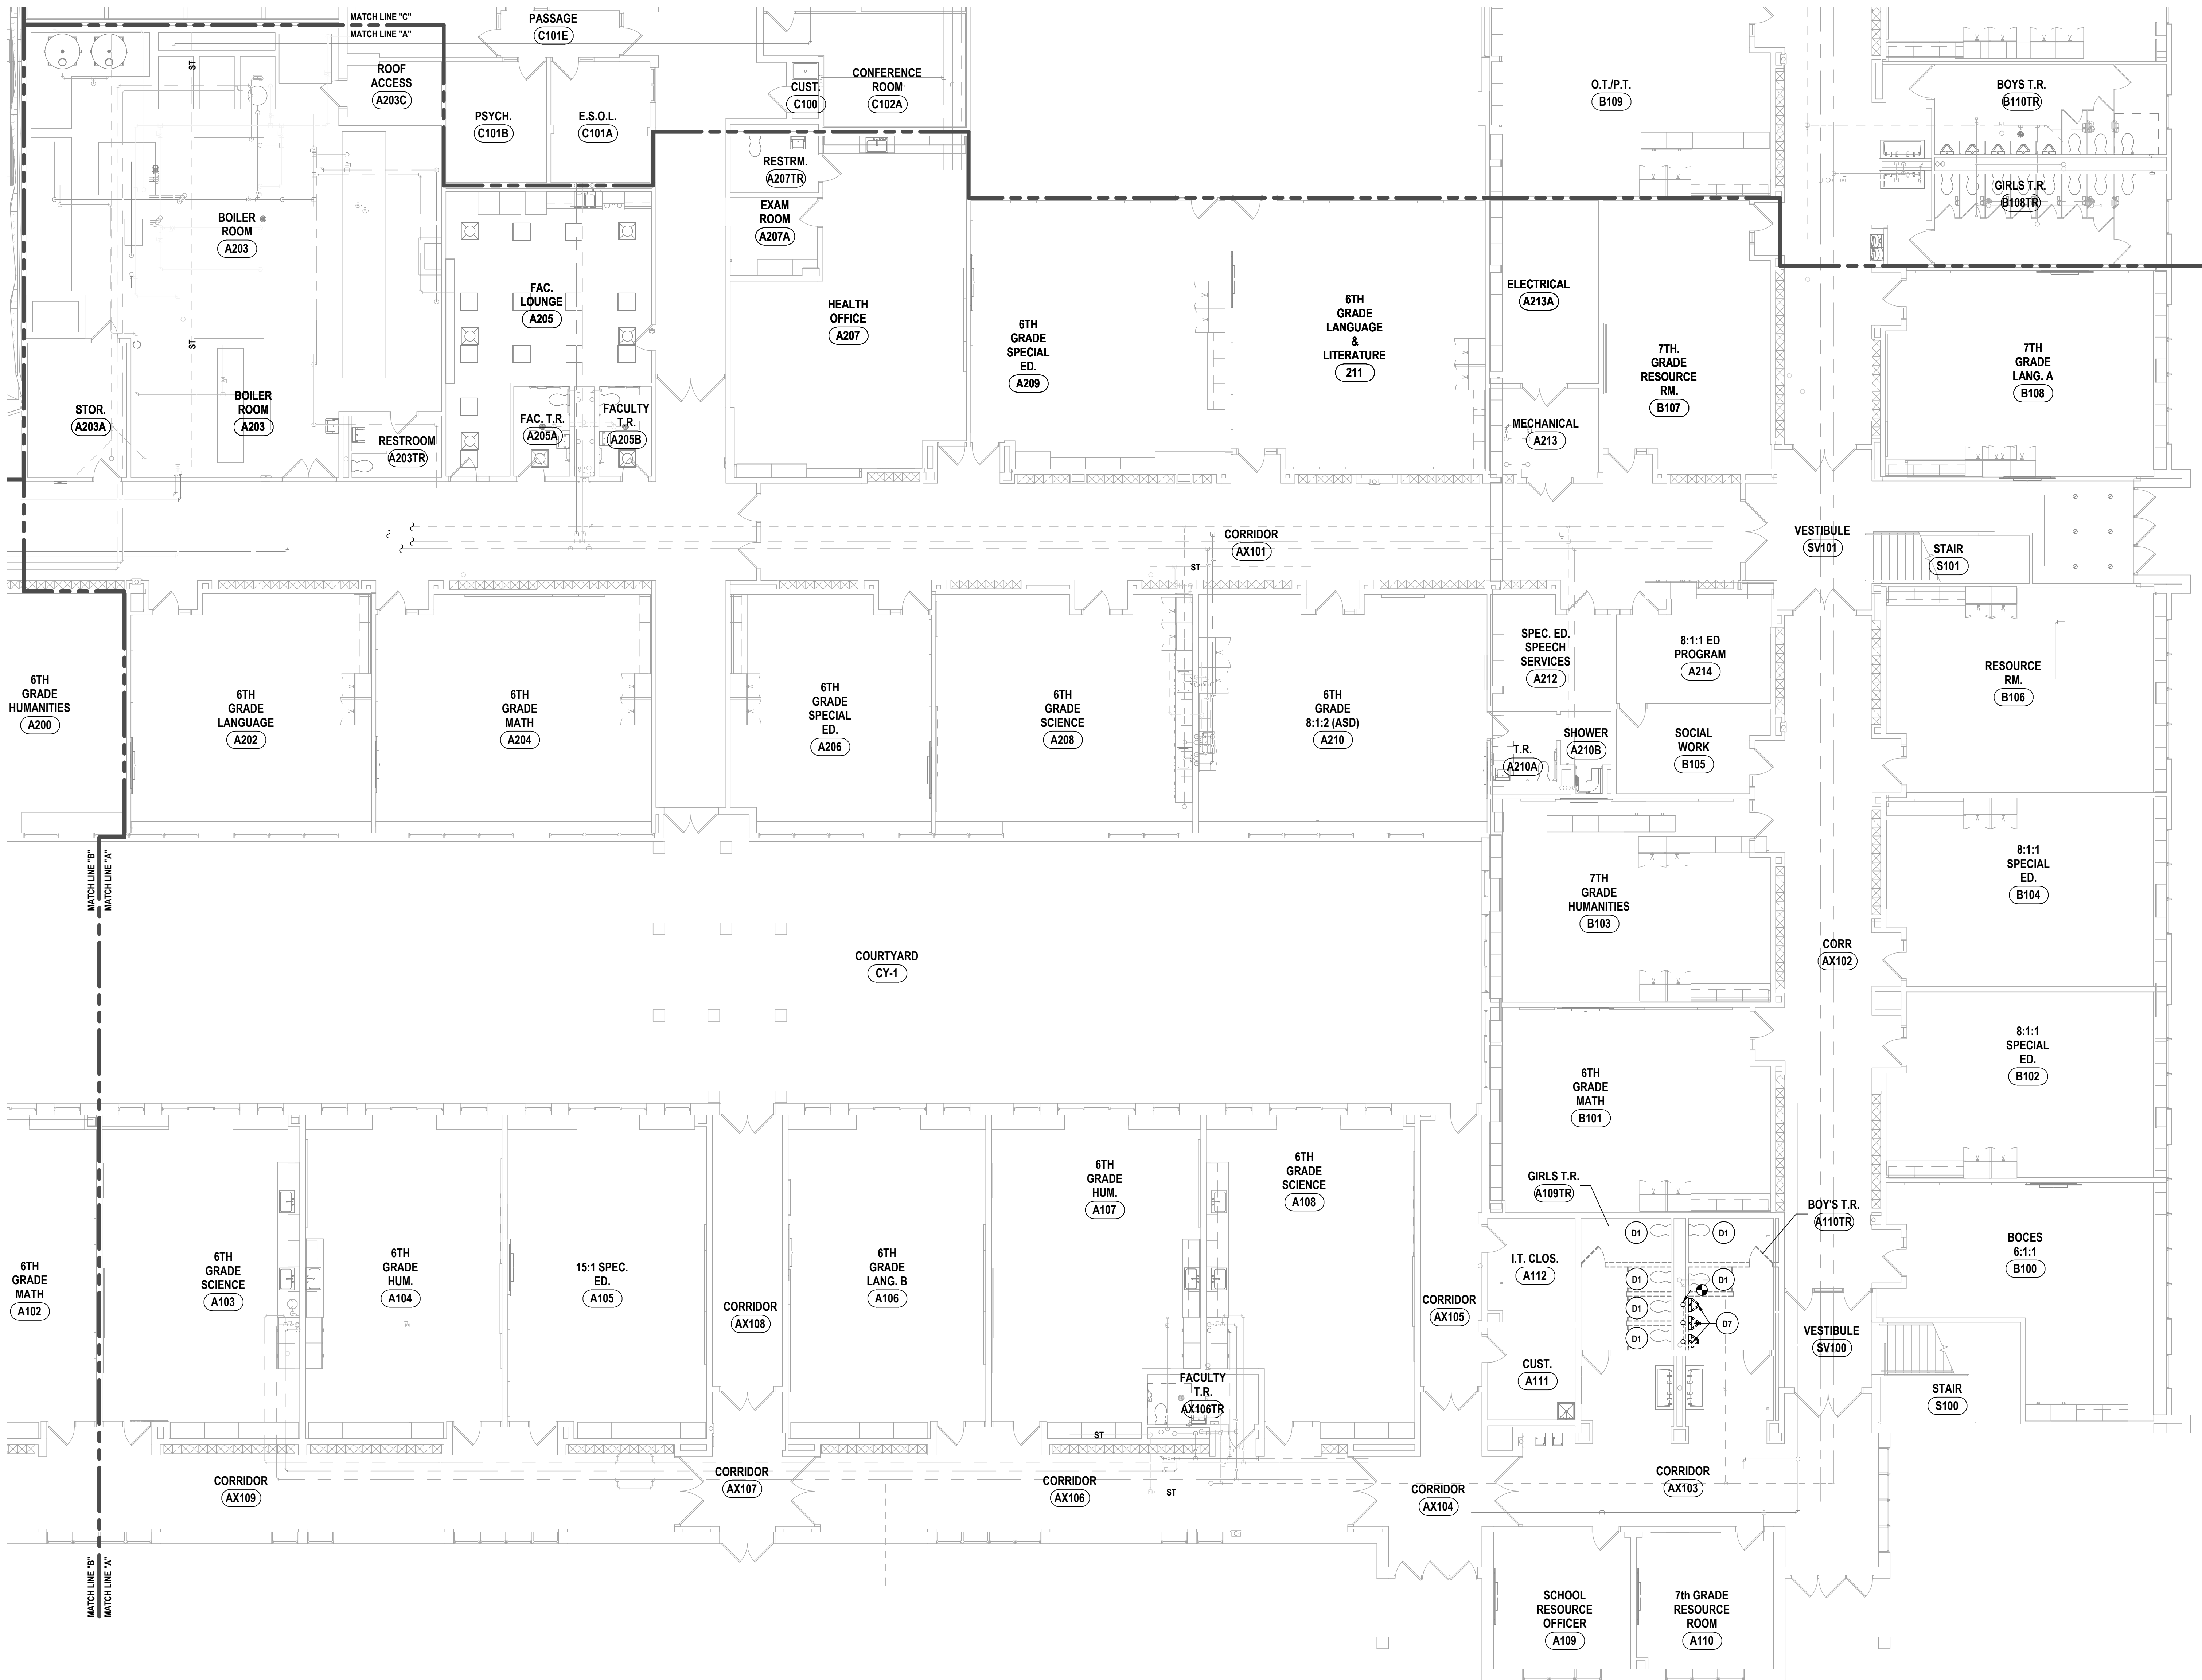


1 FIRST FLOOR PLUMBING DEMOLITION PLAN - AREA A  
1/8" = 1'-0"

GENERAL NOTES - PLUMBING

- A ALL WORK ON THIS DRAWING IS THE RESPONSIBILITY OF THE CONTRACTOR UNLESS CLEARLY INDICATED TO BE PART OF ANOTHER PRIME CONTRACT.
- B THIS DRAWING IS INTENDED TO SHOW THE GENERAL SCOPE OF ITEMS TO BE REMOVED. IT IS NOT INTENDED TO BE ALL INCLUSIVE. THE CONTRACTOR SHALL FIELD VERIFY ALL ITEMS TO BE REMOVED. ANY ITEM IN QUESTION SHOULD BE VERIFIED WITH ENGINEER PRIOR TO REMOVAL.
- C ALL ITEMS SCHEDULED FOR DEMOLITION ARE THE PROPERTY OF THE OWNER. THE CONTRACTOR SHALL PLACE WANTED EQUIPMENT IN AREA DESIGNATED ON SITE BY OWNER. ANY ITEM THE OWNER WISHES NOT TO KEEP SHALL BE DISPOSED OF BY THE CONTRACTOR.
- D THE CONTRACTOR SHALL REMOVE, PROTECT, REPLACE AND/OR REINSTALL ANY CEILING OR GRID DAMAGED OR REMOVED AS A RESULT OF WORK IN AREAS WHERE CEILING ARE NOT SCHEDULED TO BE REPLACED.
- E THE CONTRACTOR SHALL FIELD VERIFY ALL EXISTING CONDITIONS (FRAMING, ELECTRICAL, PLUMBING, HVAC, ETC) PRIOR TO CONSTRUCTION AND INSTALLATION OF NEW WORK. NOTIFY ARCHITECT/ENGINEER OF ANY CONFLICTS THAT REQUIRE MODIFICATION TO NEW PLUMBING SYSTEM INSTALLATION.
- F CONTRACTOR TO REINSULATE ALL PORTIONS OF EXISTING PLUMBING SYSTEM DISTURBED DURING INSTALLATION OF NEW PIPING.
- G CONTRACTOR WILL BE RESPONSIBLE FOR ALL NEW FLOOR OPENINGS, EXCAVATIONS OF EXISTING SUBSTRATES AND WALL PENETRATIONS TO INSTALL NEW PIPING. UNLESS OTHERWISE NOTED, ALL PIPE PENETRATIONS THROUGH WALLS AND FLOORS WILL BE SEALED WITH FIRE-STOPPING.
- H THE CONTRACTOR IS RESPONSIBLE FOR INSTALLATION AND CONNECTION OF ALL PIPING WITHIN BUILDING TO EXTERIOR FACE OF BUILDING.
- I CONTRACTOR WILL BE RESPONSIBLE FOR PATCHING AND SEALING OF ALL DISTURBED SUBSTRATE, WALLS AND CEILING TO EXISTING FINISHES UNLESS OTHERWISE NOTED.
- J CONTRACTOR TO COORDINATE ALL NEW ROOF PENETRATIONS.
- K INVERT DIMENSION IS TO BOTTOM OF PIPE.
- L CONTRACTOR TO PROVIDE WATER HAMMER ARRESTORS ON ALL NEW PLUMBING FIXTURES. REFER TO SPECIFICATION SECTION 22 10 05.
- M PROVIDE 3M METAL COLLAR ASSEMBLY MODEL ULTRA RC OR SIMILAR WHERE NON-METALLIC PIPE PENETRATES FIRE RATED WALLS.
- O CONTRACTOR TO PROVIDE ADA COMPLIANT VINYL PIPE COVER ON EXPOSED COLD WATER, HOT WATER AND SANITARY PIPING BELOW ADA LAVATORY/SINK. SANITARY PIPE COVER SHALL BE INSTALLED UP TO BOTTOM OF FIXTURE.
- P CONTRACTOR TO PROVIDE IDENTIFICATION TO PLUMBING PIPING AND TAGS TO PLUMBING VALVES. REFER TO SPECIFICATION SECTION 22 05 53.
- Q ALL PLUMBING FIXTURES SHALL BE PROVIDED WITH P-TRAP.
- R ALL BURIED SANITARY PIPING SHALL BE A MINIMUM OF 2 INCH. ALL BURIED VENT PIPING FOR FLOOR DRAIN OR FLOOR SINK SHALL BE 2 INCH. ALL ABOVE GRADE VENT PIPING FOR FLOOR DRAIN OR FLOOR SINK SHALL BE 1-1/2 INCH.
- S ALL COLD WATER, HOT WATER AND GAS PIPING SHALL BE PROVIDED WITH SHUTOFF BALL VALVES ON BRANCH PIPING.
- V CONTRACTOR TO VERIFY THAT EXISTING AND NEW CASEWORK ACCOMMODATES DIMENSIONS REQUIRED FOR SINK OPENING AND IS ADEQUATE FOR FINAL FIXTURE INSTALLATION.
- W ALL PIPING TO BE ROUTED AS HIGH AND AS TIGHT TO STEEL STRUCTURE AS POSSIBLE.
- X PROVIDE INSULATION TO STORM PIPING IN ITS ENTIRETY FROM ROOF DRAIN, ENTIRE LENGTH OF FIRST HORIZONTAL STORM PIPING RUN TO FIRST VERTICAL DROP.
- Y THESE DRAWING ARE INTENDED TO SHOW THE GENERAL SCOPE OF NEW WORK, IT IS NOT INTENDED TO BE ALL INCLUSIVE. ANY ITEM IN QUESTION SHOULD BE REVIEWED WITH ENGINEER.
- Z PVC PIPING USED FOR EITHER ABOVE GRADE SANITARY OR STORM PIPING IS NOT ALLOWED TO BE INSTALLED IN PLACES OF ASSEMBLY, PLENUM SPACES, EXIT DISCHARGE CORRIDORS OR STAIRS. USE CAST IRON OR COPPER PIPING IN THESE LOCATIONS.

# DEMOLITION NOTES - PLUMBING

- D1 DISCONNECT AND REMOVE WATER CLOSET AND ALL ASSOCIATED ACCESSORIES IN ITS ENTIRETY. DISCONNECT AND REMOVE COLD WATER, SANITARY AND VENT PIPING AND ALL ASSOCIATED ACCESSORIES. PREPARE FOR RECONNECTION IN NEW WORK.
- D2 DISCONNECT AND REMOVE LAVATORY AND ALL ASSOCIATED ACCESSORIES IN ITS ENTIRETY. DISCONNECT AND REMOVE COLD WATER, HOT WATER, SANITARY AND VENT PIPING AND ALL ASSOCIATED ACCESSORIES. PREPARE FOR RECONNECTION IN NEW WORK.
- D3 DISCONNECT AND REMOVE HAND SINK AND ALL ASSOCIATED ACCESSORIES IN ITS ENTIRETY. DISCONNECT AND REMOVE COLD WATER, HOT WATER, SANITARY AND VENT PIPING AND ALL ASSOCIATED ACCESSORIES. PREPARE FOR RECONNECTION IN NEW WORK.
- D4 DISCONNECT AND REMOVE SINK AND ALL ASSOCIATED ACCESSORIES IN ITS ENTIRETY. DISCONNECT AND REMOVE COLD WATER, HOT WATER, SANITARY AND VENT PIPING AND ALL ASSOCIATED ACCESSORIES. PREPARE FOR RECONNECTION IN NEW WORK.
- D5 DISCONNECT AND REMOVE DRINKING FOUNTAIN AND ALL ASSOCIATED ACCESSORIES IN ITS ENTIRETY. DISCONNECT AND REMOVE COLD WATER, SANITARY AND VENT PIPING AND ALL ASSOCIATED ACCESSORIES. PREPARE FOR RECONNECTION IN NEW WORK.
- D6 DISCONNECT AND REMOVE URINAL AND ALL ASSOCIATED ACCESSORIES IN ITS ENTIRETY. DISCONNECT AND REMOVE COLD WATER, SANITARY AND VENT PIPING AND ALL ASSOCIATED ACCESSORIES. PREPARE FOR RECONNECTION IN NEW WORK.
- D7 DISCONNECT AND REMOVE (3) URINALS AND CARRIERS AND ALL ASSOCIATED ACCESSORIES IN ITS ENTIRETY. RETAIN FOR RECONNECTION IN NEW WORK.
- D8 DISCONNECT AND REMOVE FLOOR DRAIN AND ALL ASSOCIATED ACCESSORIES IN ITS ENTIRETY. DISCONNECT AND REMOVE SANITARY PIPING AND ALL ASSOCIATED ACCESSORIES IN ITS ENTIRETY. PREPARE FOR RECONNECTION IN NEW WORK.

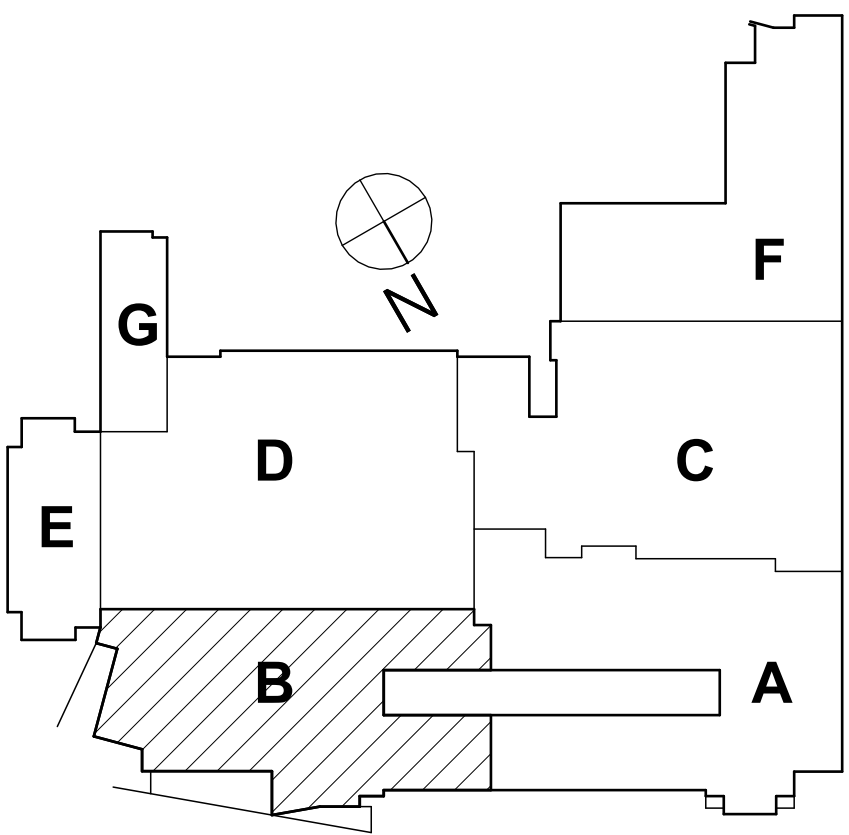

SED #: 57-000-01-000-044 - MIDDLE SCHOOL

FIRST FLOOR DEMOLITION PLAN - AREA A  
2025 MIDDLE SCHOOL PHASE III ALTERATIONS PROJECT  
CORNING-PAINTED POST ASD  
35 VICTORY HIGHWAY, PAINTED POST, NY 14870

MS-P0.1  
PROJECT NO: 2649-133

HUNT ENGINEERS | ARCHITECTS | SURVEYORS  
HORSEHEADS, NY 607-268-1000 ROCHESTER, NY 585-637-7668 TOWNAND, PA 570-265-4666  
BINGHAMTON, NY 607-738-8881 ALBANY, NY 607-738-8881  
WWW.HUNTEAS.COM  
NY CERTIFICATE NO. 0016220 PA CERTIFICATE NO. TSC220013464-1

# DATE: 1 10/20/2025

DESCRIPTION OF REVISION:  
ISSUED FOR BID

DRAWN BY: CJH  
CHECKED BY: JDB  
DATE: 05/09/2025  
PHASE: CD

THIS IS A VIOLATION OF THE LAW FOR ANY PERSON TO MAKE UNAUTHORIZED ALTERATIONS OR ADDITIONS TO PLANS  
DRAWING IS LOCKED. ENGINEER'S SIGNATURE REQUIRED.


05/09/2025

GENERAL NOTES - PLUMBING


REFER TO GENERAL NOTES ON SHEET MS-P0.1

DEMOLITION NOTES - PLUMBING

- D1 DISCONNECT AND REMOVE WATER CLOSET AND ALL ASSOCIATED ACCESSORIES IN ITS ENTIRETY. DISCONNECT AND REMOVE COLD WATER, SANITARY AND VENT PIPING AND ALL ASSOCIATED ACCESSORIES. PREPARE FOR RECONNECTION IN NEW WORK.
- D2 DISCONNECT AND REMOVE LAVATORY AND ALL ASSOCIATED ACCESSORIES IN ITS ENTIRETY. DISCONNECT AND REMOVE COLD WATER, HOT WATER, SANITARY AND VENT PIPING AND ALL ASSOCIATED ACCESSORIES. PREPARE FOR RECONNECTION IN NEW WORK
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- D7 DISCONNECT AND REMOVE (3) URINALS AND CARRIERS AND ALL ASSOCIATED ACCESSORIES IN ITS ENTIRETY. RETAIN FOR RECONNECTION IN NEW WORK.
- D8 DISCONNECT AND REMOVE FLOOR DRAIN AND ALL ASSOCIATED ACCESSORIES IN ITS ENTIRETY. BACK TO POINT INDICATED. DISCONNECT AND REMOVE SANITARY PIPING AND ALL ASSOCIATED ACCESSORIES IN ITS ENTIRETY. PREPARE FOR RECONNECTION IN NEW WORK.

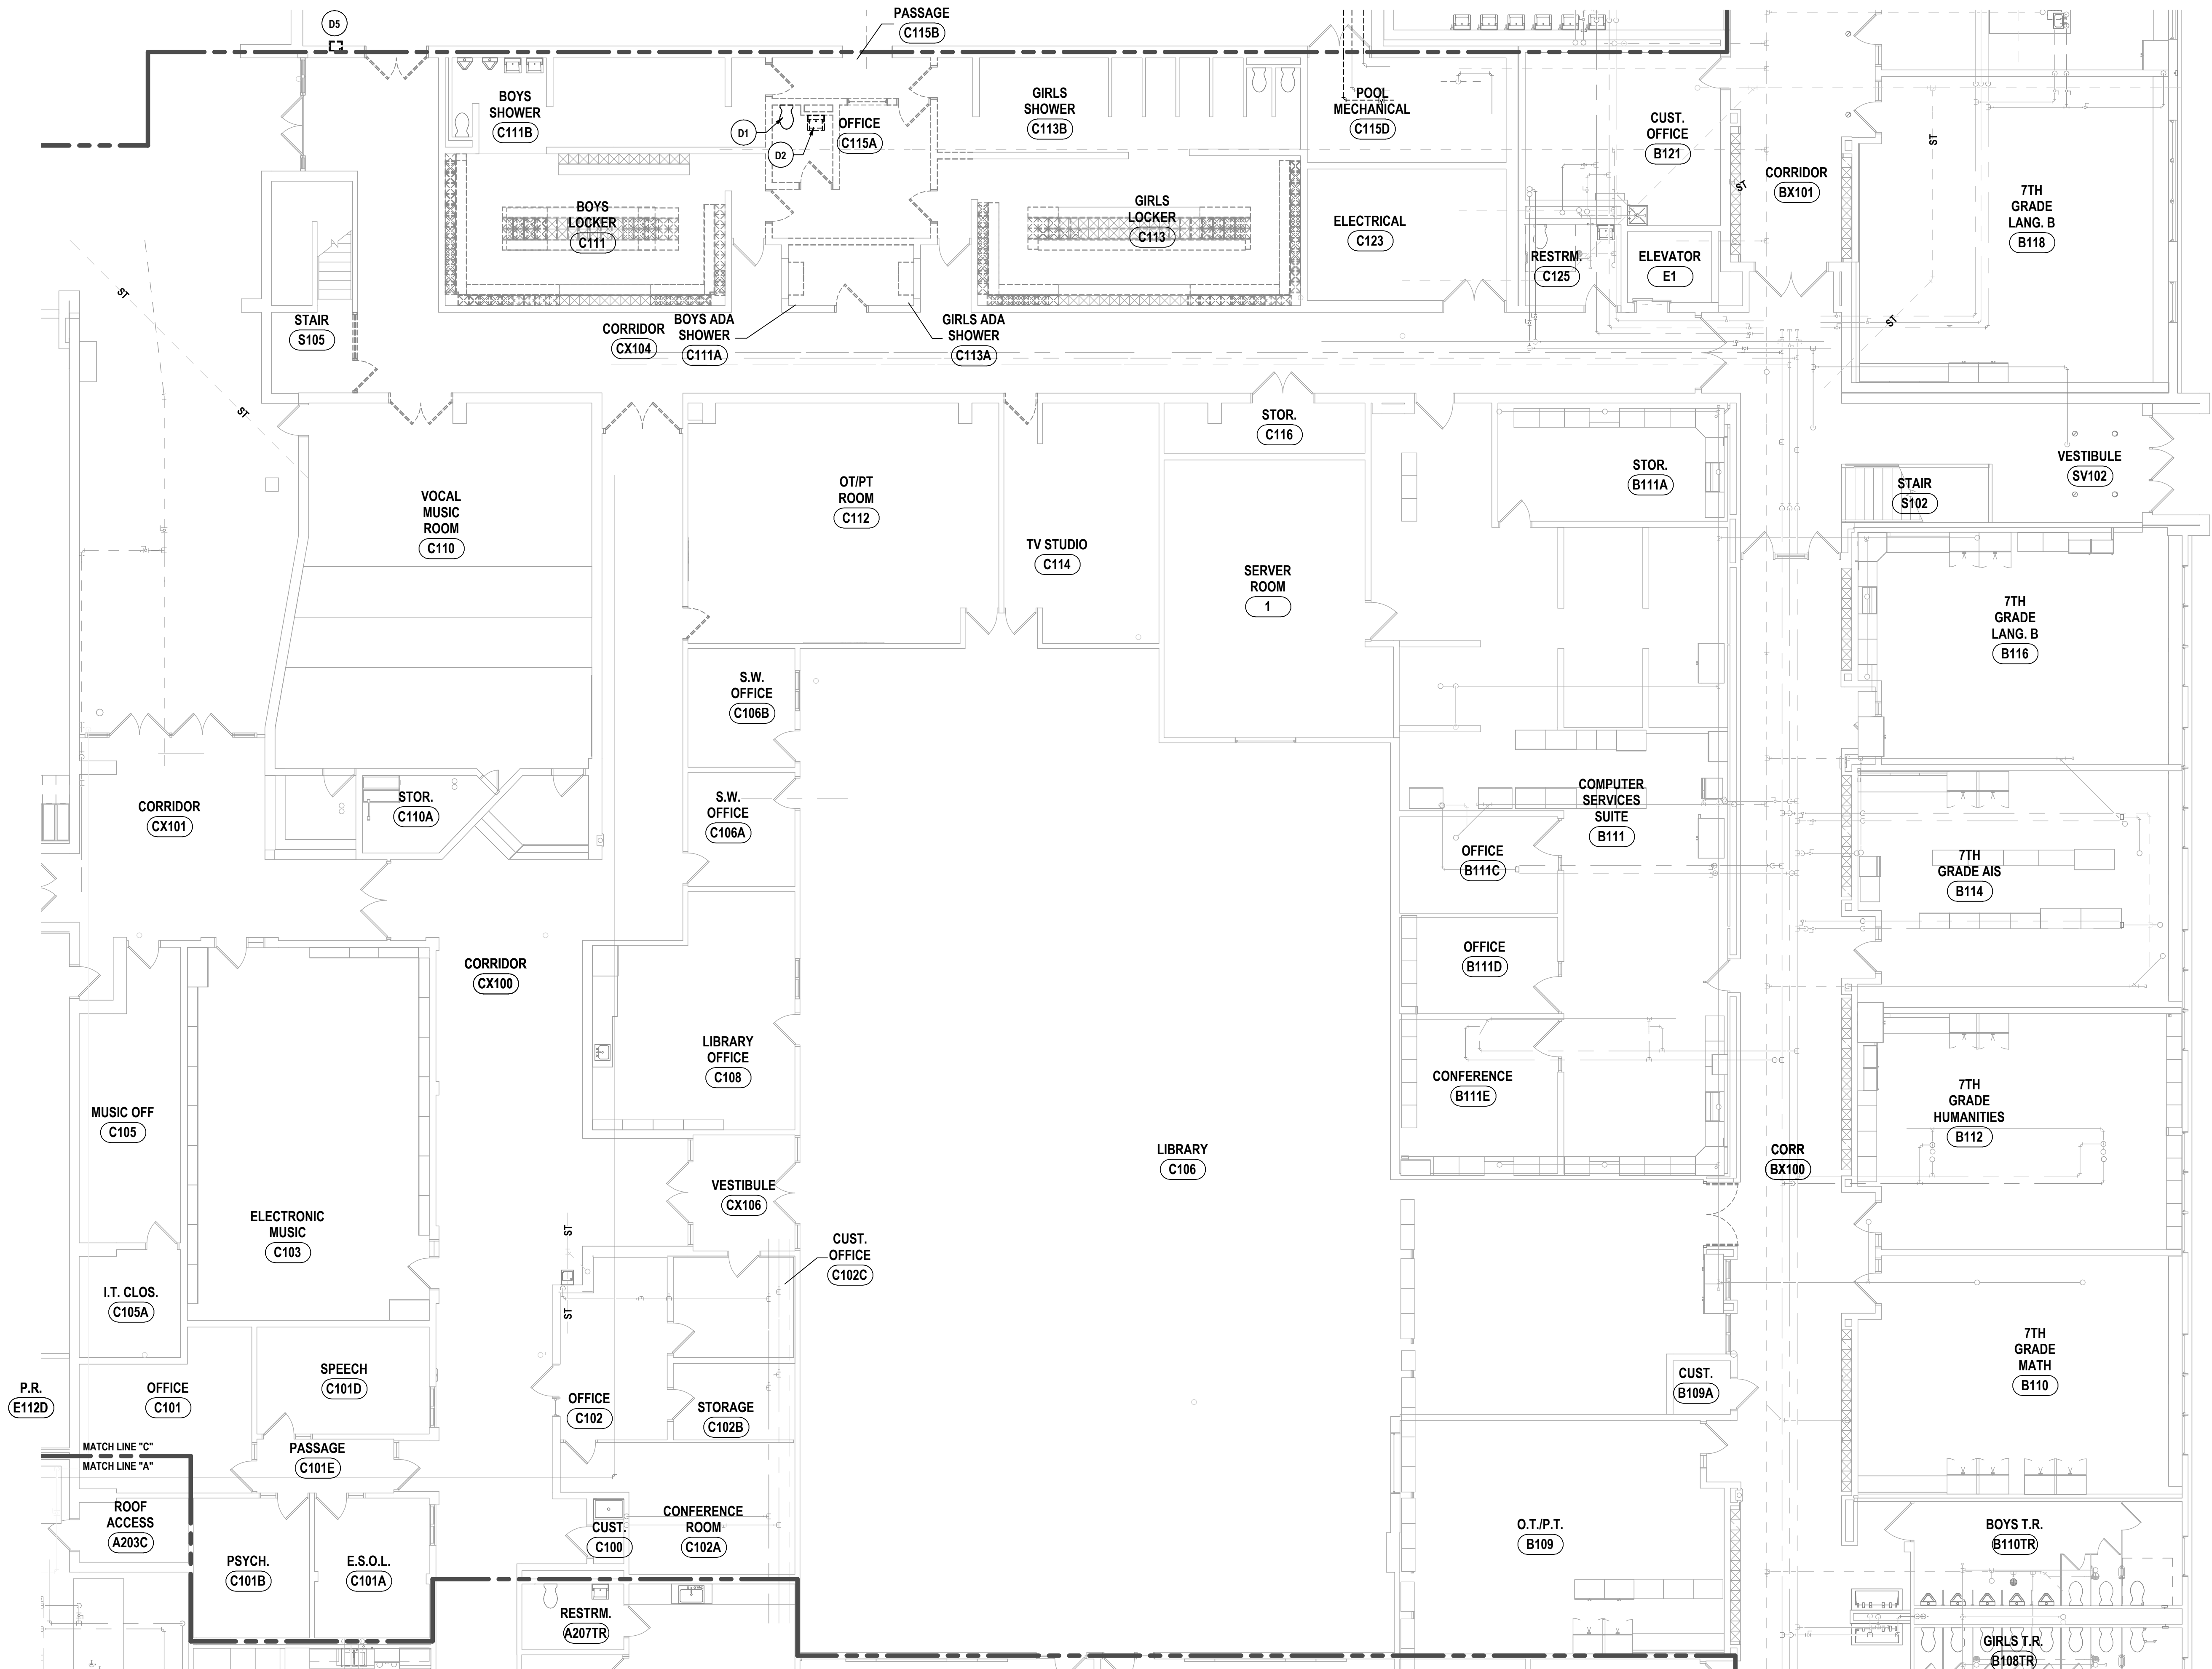

1 FIRST FLOOR PLUMBING DEMOLITION PLAN - AREA C  
1/8" = 1'-0"

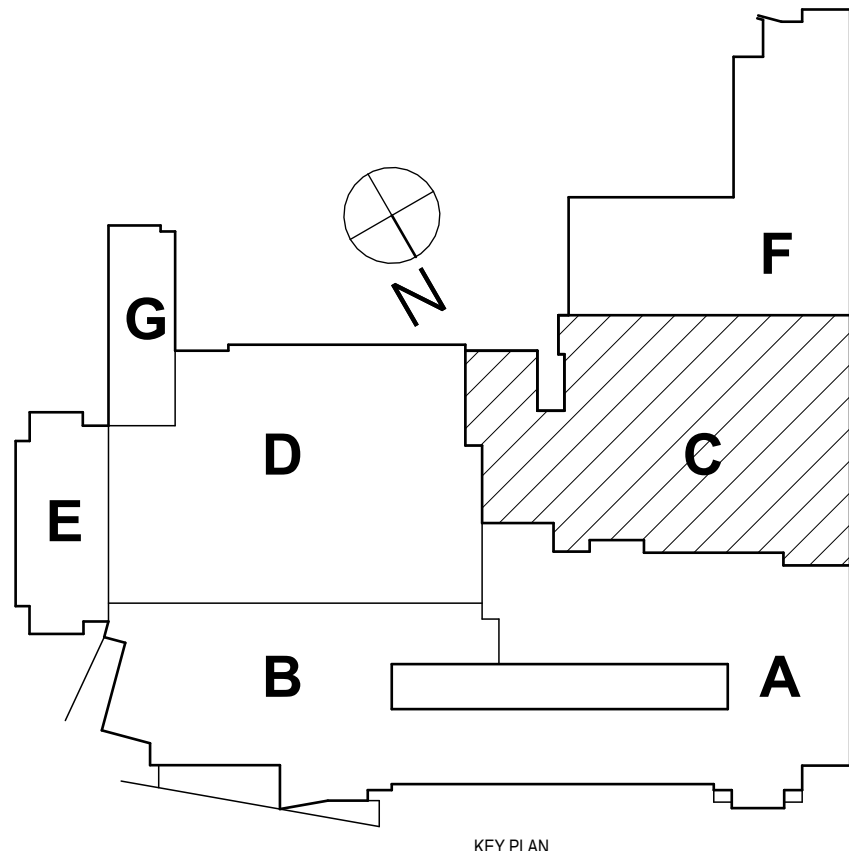

SED #: 57-000-01-000-044 - MIDDLE SCHOOL

FIRST FLOOR DEMOLITION PLAN - AREA C

2025 MIDDLE SCHOOL PHASE III ALTERATIONS PROJECT

CORNING-PAINTED POST ASD

35 VICTORY HIGHWAY, PAINTED POST, NY 14870

**HUNT** ENGINEERS | ARCHITECTS | SURVEYORS

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BINGHAMTON, NY 607-738-8881 ALBANY, NY 607-738-8801

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NY CERTIFICATE NO. 0016220 PA CERTIFICATE NO. TSC220013/464-1

# DATE: 1 10/20/2025

DESCRIPTION OF REVISION:  
ISSUED FOR BID

DRAWN BY: CJH  
CHECKED BY: JDA  
DATE: 05/09/2025

PHASE: CD

Copy: 1/23/2025

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DRAWN / CHECKED / ENGINEERED / ARCHITECT'S SEAL



MS-P0.2  
PROJECT NO: 2649-133



GENERAL NOTES - PLUMBING  
REFER TO GENERAL NOTES ON SHEET MS-P0.1

DEMOLITION NOTES - PLUMBING

- D1 DISCONNECT AND REMOVE WATER CLOSET AND ALL ASSOCIATED ACCESSORIES IN ITS ENTIRETY. DISCONNECT AND REMOVE COLD WATER, SANITARY AND VENT PIPING AND ALL ASSOCIATED ACCESSORIES. PREPARE FOR RECONNECTION IN NEW WORK.
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- D5 DISCONNECT AND REMOVE DRINKING FOUNTAIN AND ALL ASSOCIATED ACCESSORIES IN ITS ENTIRETY. DISCONNECT AND REMOVE COLD WATER, HOT WATER, SANITARY AND VENT PIPING AND ALL ASSOCIATED ACCESSORIES. PREPARE FOR RECONNECTION IN NEW WORK.
- D6 DISCONNECT AND REMOVE URINAL AND ALL ASSOCIATED ACCESSORIES IN ITS ENTIRETY. DISCONNECT AND REMOVE COLD WATER, SANITARY AND VENT PIPING AND ALL ASSOCIATED ACCESSORIES. PREPARE FOR RECONNECTION IN NEW WORK.
- D7 DISCONNECT AND REMOVE (2) URINALS AND CARRIERS AND ALL ASSOCIATED ACCESSORIES IN ITS ENTIRETY. RETAIN FOR RECONNECTION IN NEW WORK.
- D8 DISCONNECT AND REMOVE FLOOR DRAIN AND ALL ASSOCIATED ACCESSORIES IN ITS ENTIRETY. DISCONNECT AND REMOVE COLD WATER, SANITARY AND VENT PIPING AND ALL ASSOCIATED ACCESSORIES IN ITS ENTIRETY. PREPARE FOR RECONNECTION IN NEW WORK.

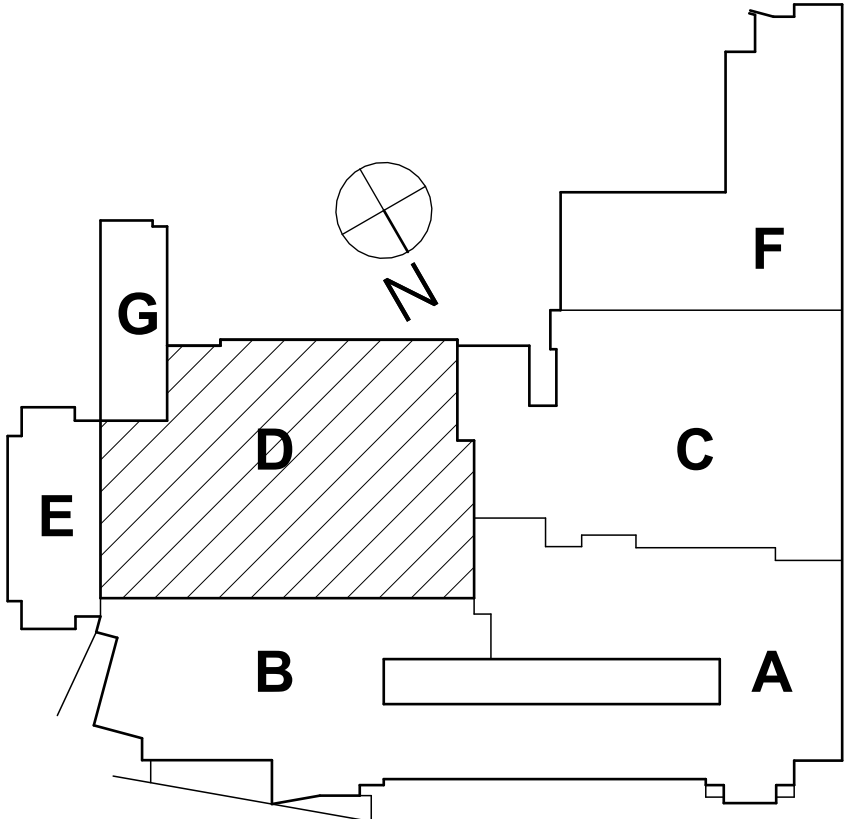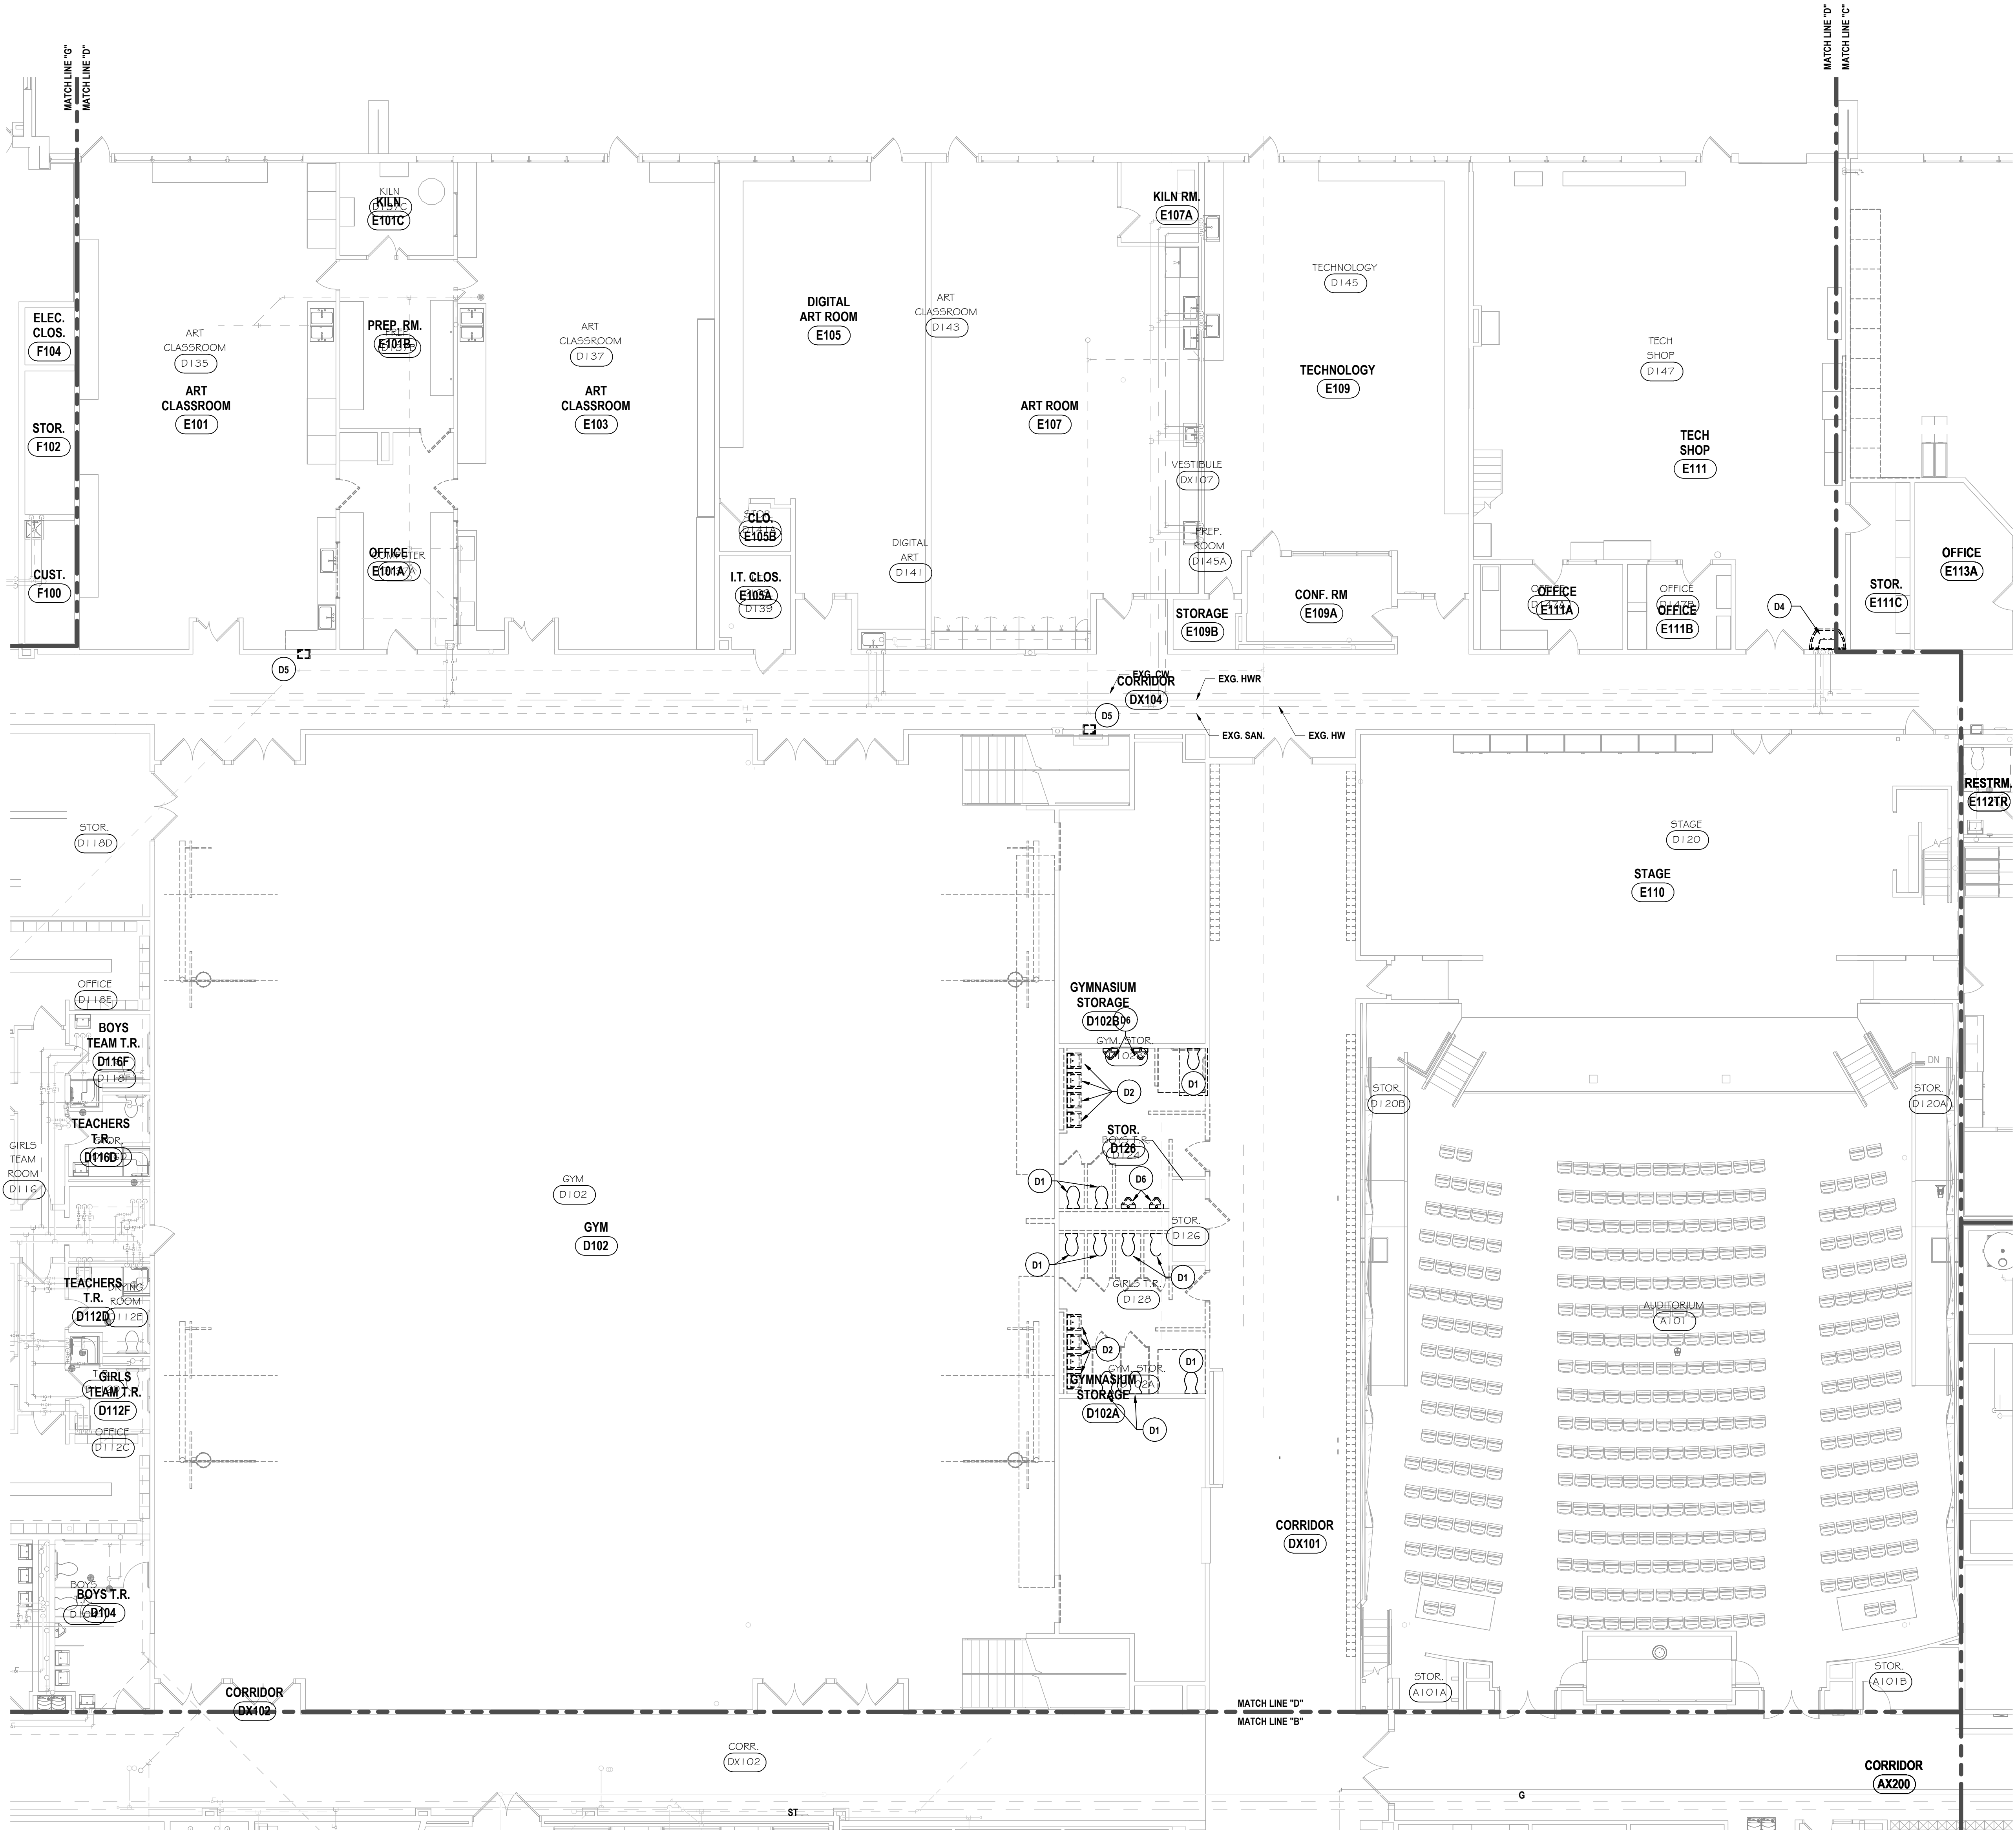

1 FIRST FLOOR PLUMBING DEMOLITION PLAN - AREA D  
1/8" = 1'-0"

**HUNT** ENGINEERS | ARCHITECTS | SURVEYORS  
HORSEHEADS, NY 607-253-1000 ROCHESTER, NY 585-337-7500 TOWANDA, PA 570-265-4606  
BINGHAMTON, NY 607-738-8881 ALBANY, NY 607-738-8801  
WWW.HUNTEAS.COM  
NY CERTIFICATE NO. 001620 PA CERTIFICATE NO. TSC220313464-1

FIRST FLOOR DEMOLITION PLAN - AREA D  
2025 MIDDLE SCHOOL PHASE III ALTERATIONS PROJECT  
CORNING-PAINTED POST ASD  
35 VICTORY HIGHWAY, PAINTED POST, NY 14870


MS-P0.3  
PROJECT NO: 2649-133

SED #: 57-000-01-002444 - MIDDLE SCHOOL

REFER TO GENERAL NOTES ON SHEET MS-P0.1


- 01 DISCONNECT AND REMOVE WATER CLOSET AND ALL ASSOCIATED ACCESSORIES IN ITS ENTIRETY. DISCONNECT AND REMOVE COLD WATER, SANITARY AND VENT PIPING AND ALL ASSOCIATED ACCESSORIES. PREPARE FOR RECONNECTION IN NEW WORK.
- 02 DISCONNECT AND REMOVE LAVATORY AND ALL ASSOCIATED ACCESSORIES IN ITS ENTIRETY. DISCONNECT AND REMOVE COLD WATER, HOT WATER, SANITARY AND VENT PIPING AND ALL ASSOCIATED ACCESSORIES. PREPARE FOR RECONNECTION IN NEW WORK.
- 03 DISCONNECT AND REMOVE HAND SINK AND ALL ASSOCIATED ACCESSORIES IN ITS ENTIRETY. DISCONNECT AND REMOVE COLD WATER, HOT WATER, SANITARY AND VENT PIPING AND ALL ASSOCIATED ACCESSORIES. PREPARE FOR RECONNECTION IN NEW WORK.
- 04 DISCONNECT AND REMOVE SINK AND ALL ASSOCIATED ACCESSORIES IN ITS ENTIRETY. DISCONNECT AND REMOVE COLD WATER, HOT WATER, SANITARY AND VENT PIPING AND ALL ASSOCIATED ACCESSORIES. PREPARE FOR RECONNECTION IN NEW WORK.
- 05 DISCONNECT AND REMOVE DRINKING FOUNTAIN AND ALL ASSOCIATED ACCESSORIES IN ITS ENTIRETY. DISCONNECT AND REMOVE COLD WATER, SANITARY AND VENT PIPING AND ALL ASSOCIATED ACCESSORIES. PREPARE FOR RECONNECTION IN NEW WORK.
- 06 DISCONNECT AND REMOVE URINAL, AND ALL ASSOCIATED ACCESSORIES IN ITS ENTIRETY. DISCONNECT AND REMOVE COLD WATER, SANITARY AND VENT PIPING AND ALL ASSOCIATED ACCESSORIES. PREPARE FOR RECONNECTION IN NEW WORK.
- 07 DISCONNECT AND REMOVE (1) URINALS AND CARRIERS AND ALL ASSOCIATED ACCESSORIES IN ITS ENTIRETY. RETAIN FOR RECONNECTION IN NEW WORK.
- 08 DISCONNECT AND REMOVE FLOOR DRAIN AND ALL ASSOCIATED ACCESSORIES IN ITS ENTIRETY. BACK TO POINT INDICATED. DISCONNECT AND REMOVE SANITARY PIPING AND ALL ASSOCIATED ACCESSORIES IN ITS ENTIRETY. PREPARE FOR RECONNECTION IN NEW WORK.

#	DATE:	DESCRIPTION OF REVISION: ISSUED FOR BIR
1	10/20/2025	
THIS IS A VIOLATION OF THE CITY OF LOS ANGELES TO NAME UNLICENSED PERSONS OR ASSOCIATES TO PLANS DRAWING LICENSED ENGINEERS, ARCHITECTS OR SURVEYORS'S SEAL.		
DRAWN BY: CJH CHECKED BY: JWG DATE: 05/09/2025 PHASE: CD		

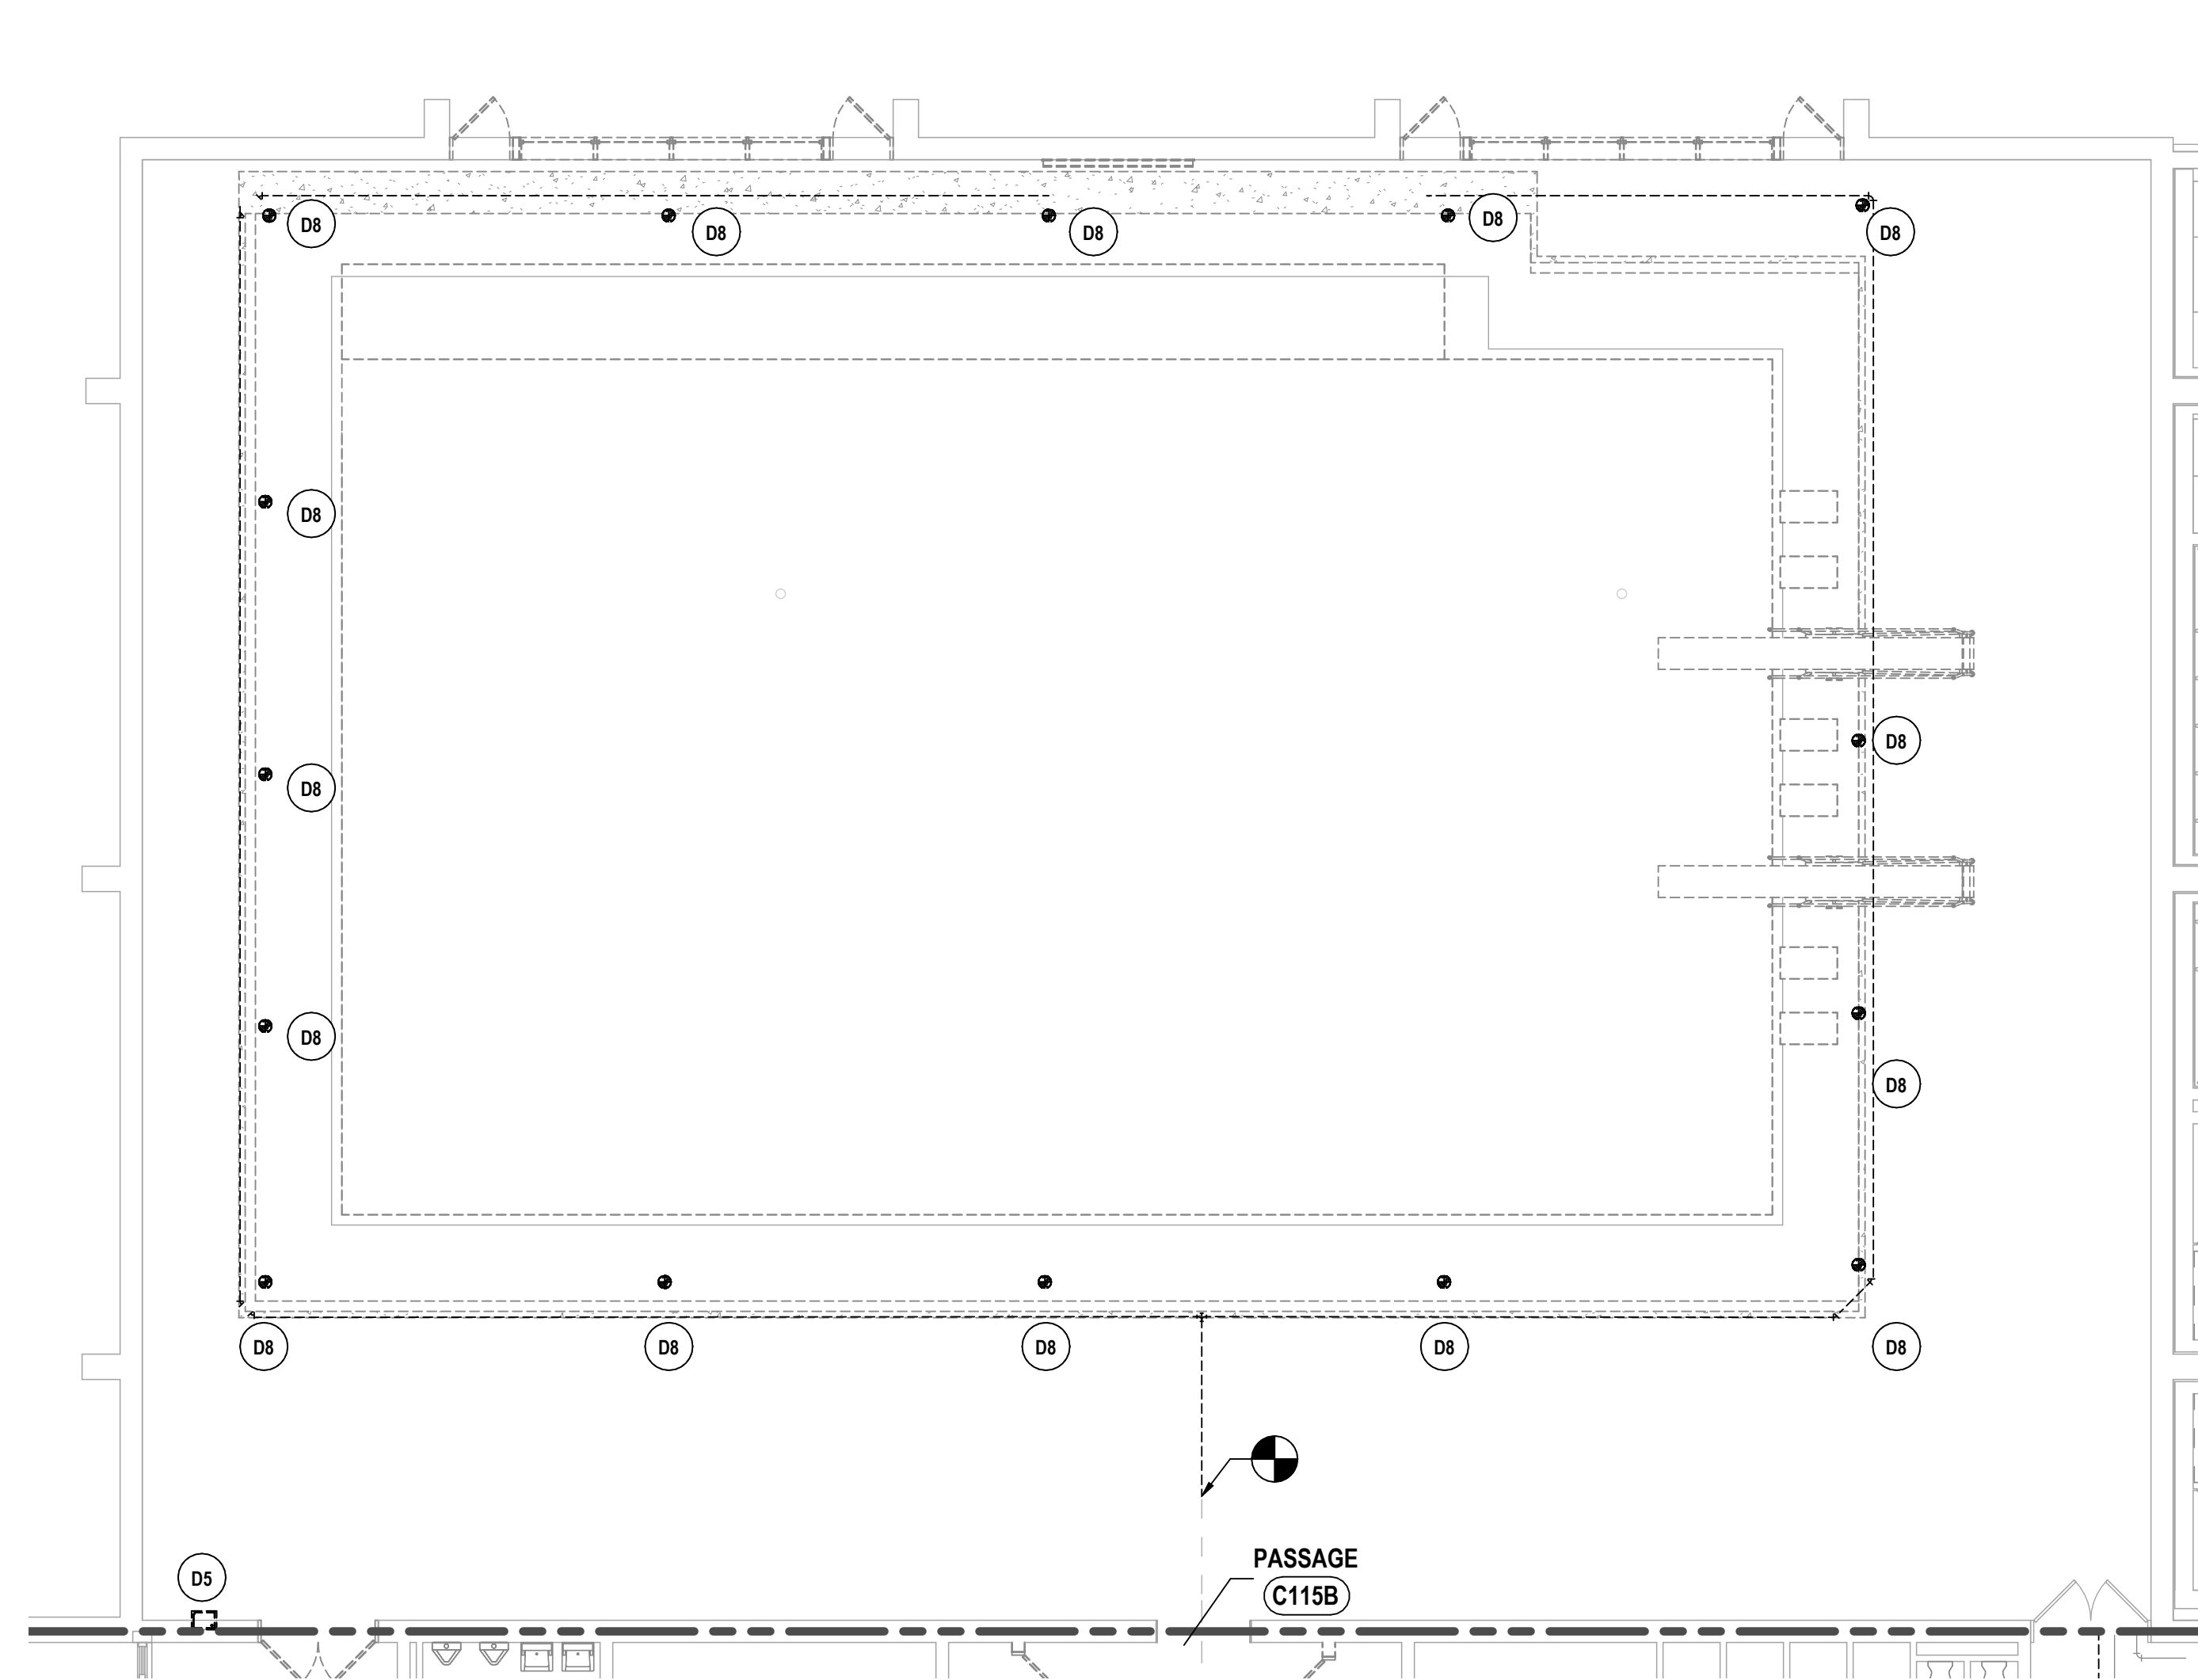

**2 FIRST FLOOR PLUMBING DEMOLITION PLAN - AREA F**  
1/8" = 1'-0"

**1 FIRST FLOOR PLUMBING DEMOLITION PLAN - AREA E**  
1/8" = 1'-0"

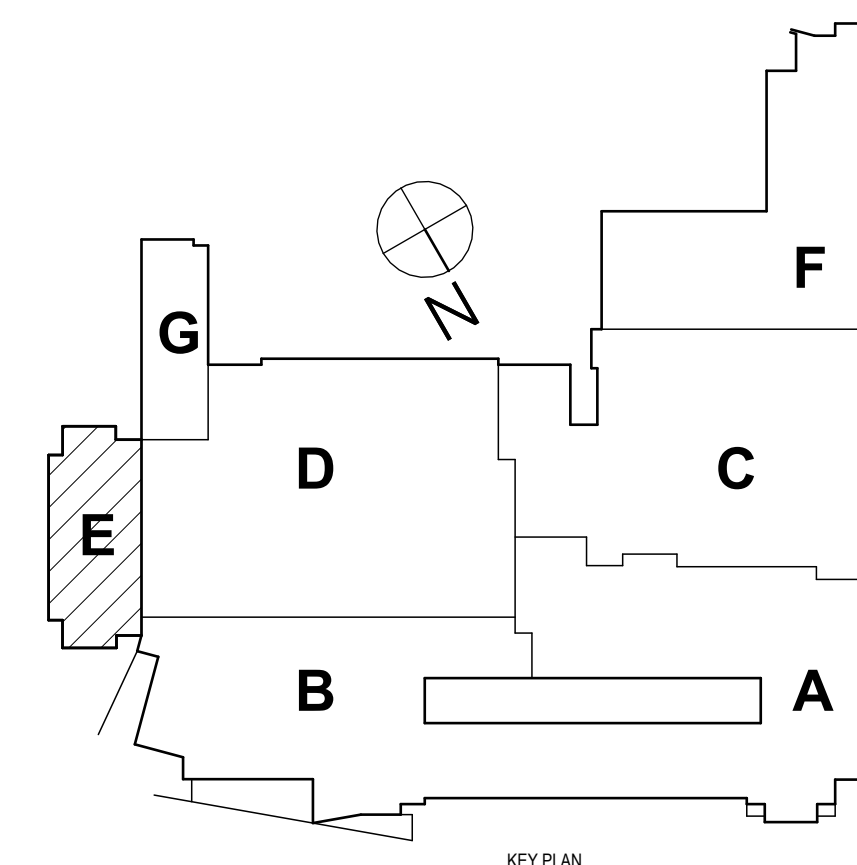

344 • MIDDLE SCHOOL

FIRST FLOOR DEMOLITION PLANS - AREA E AND F

2025 MIDDLE SCHOOL PHASE III ALTERATIONS PROJECT  
CORNING-PAINTED POST ASD


35 VICTORY HIGHWAY, PAINTED POST, NY 14870

MS-P0.4


PROJECT NO: 2649-153

SED #: 57-10-00-01-0-024-044 - MIDDLE SCHOOL



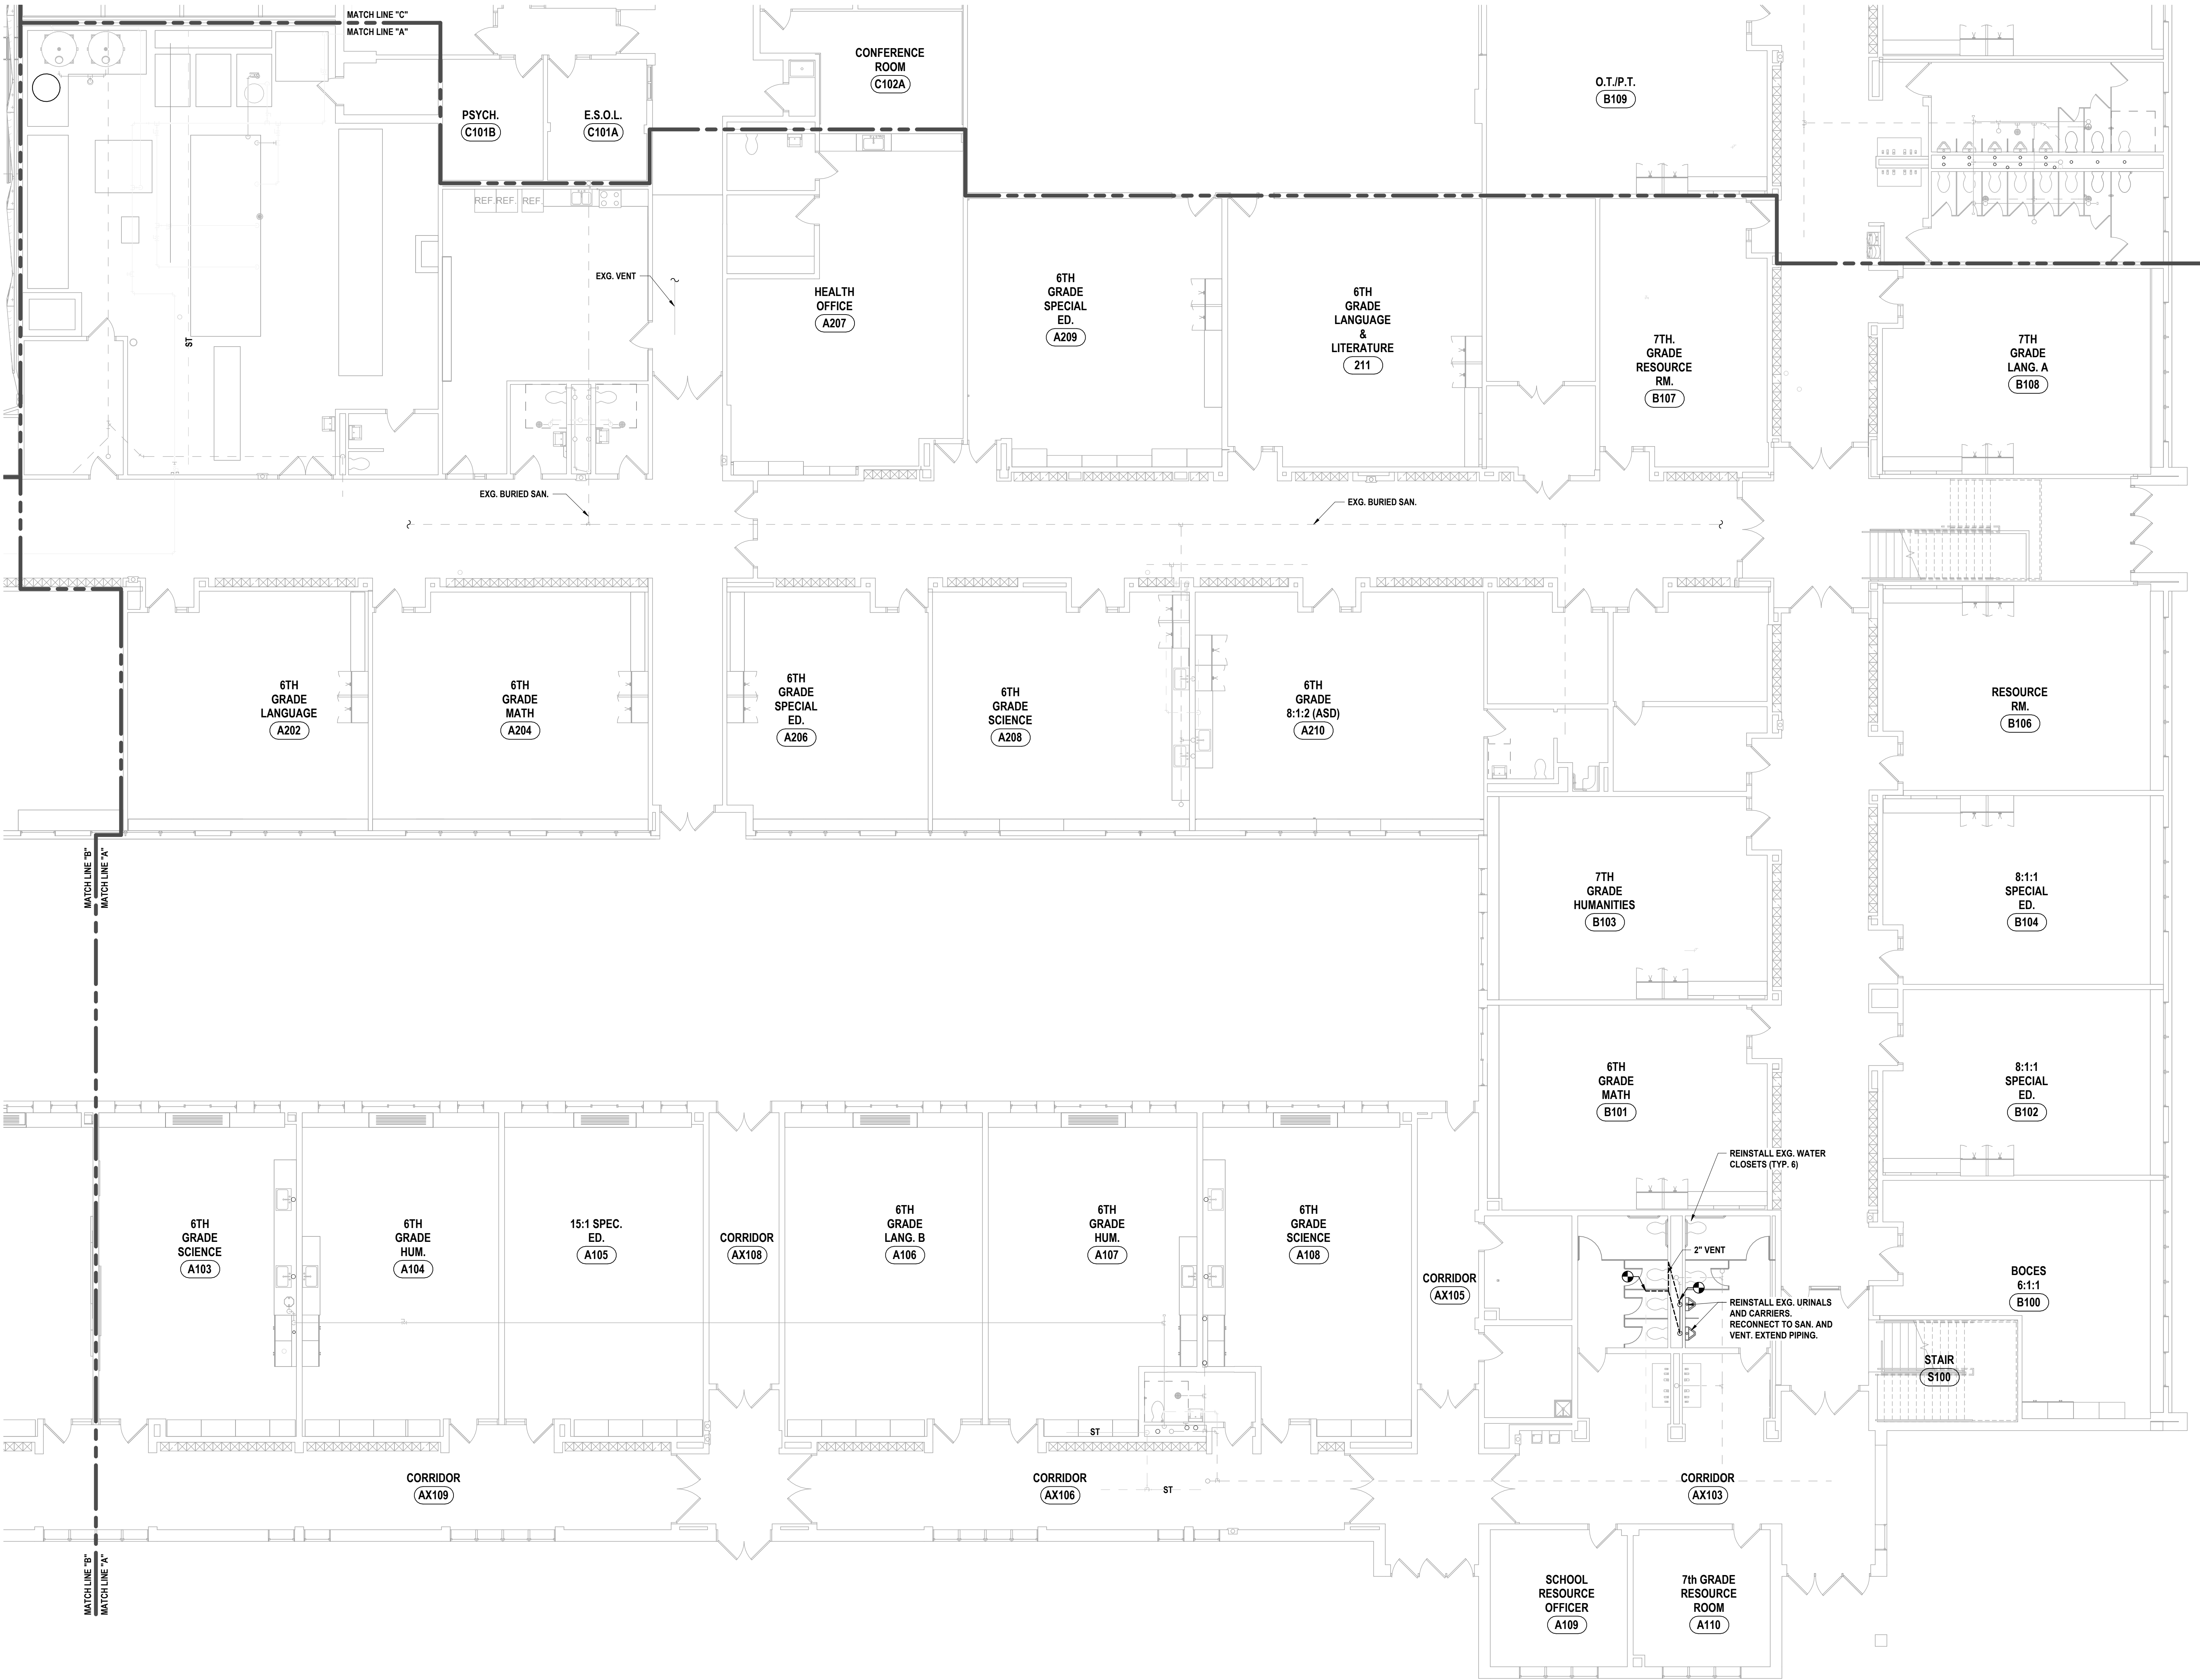

1 FIRST FLOOR SANITARY PLAN - AREA A  
1/8" = 1'-0"

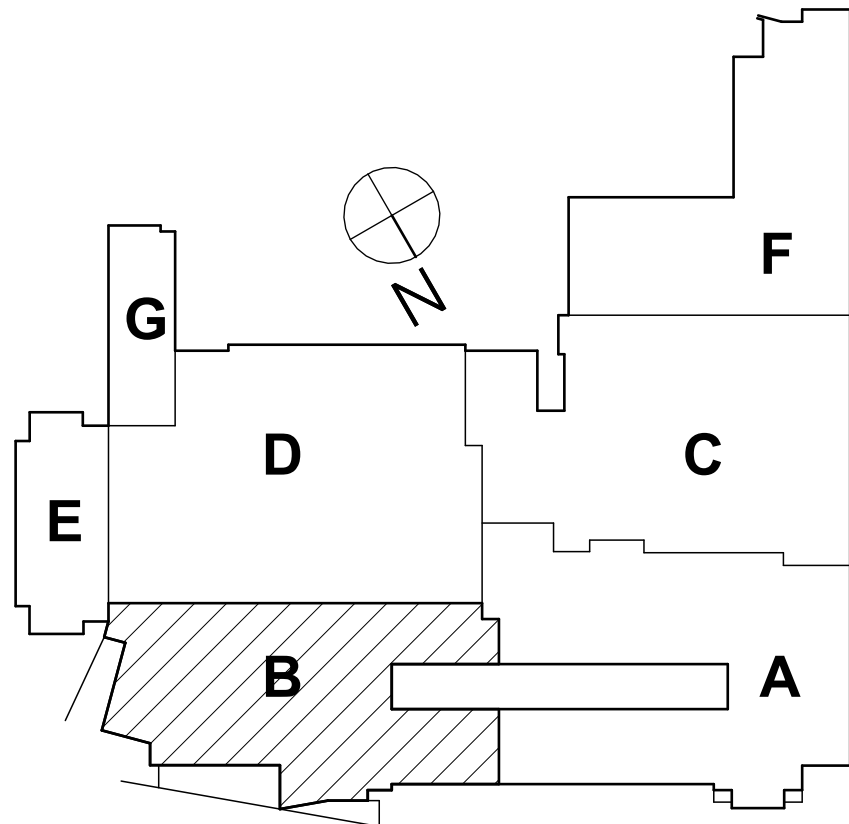

SED #: 57-16-00-41-2024-444 - MIDDLE SCHOOL

FIRST FLOOR SANITARY PLAN - AREA A

2025 MIDDLE SCHOOL PHASE III ALTERATIONS PROJECT  
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35 VICTORY HIGHWAY, PAINTED POST, NY 14870

MS-P1.1

PROJECT NO: 2649-153

HUNT ENGINEERS | ARCHITECTS | SURVEYORS

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NY CERTIFICATE NO. 0018220 PA CERTIFICATE NO. TSC220313/464-1

# DATE: 1 10/20/2025

DESCRIPTION OF REVISION:  
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PHASE: CD

CHECKED BY: JDC


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05/09/2025


05/09/2025

05/09/2025

IT IS A VIOLATION OF THE LAW FOR ANY PERSON TO MAKE UNAUTHORIZED ALTERATIONS OR ADDITIONS TO PLANS  
DRAWN BY LICENSED ARCHITECTS OR ENGINEERS

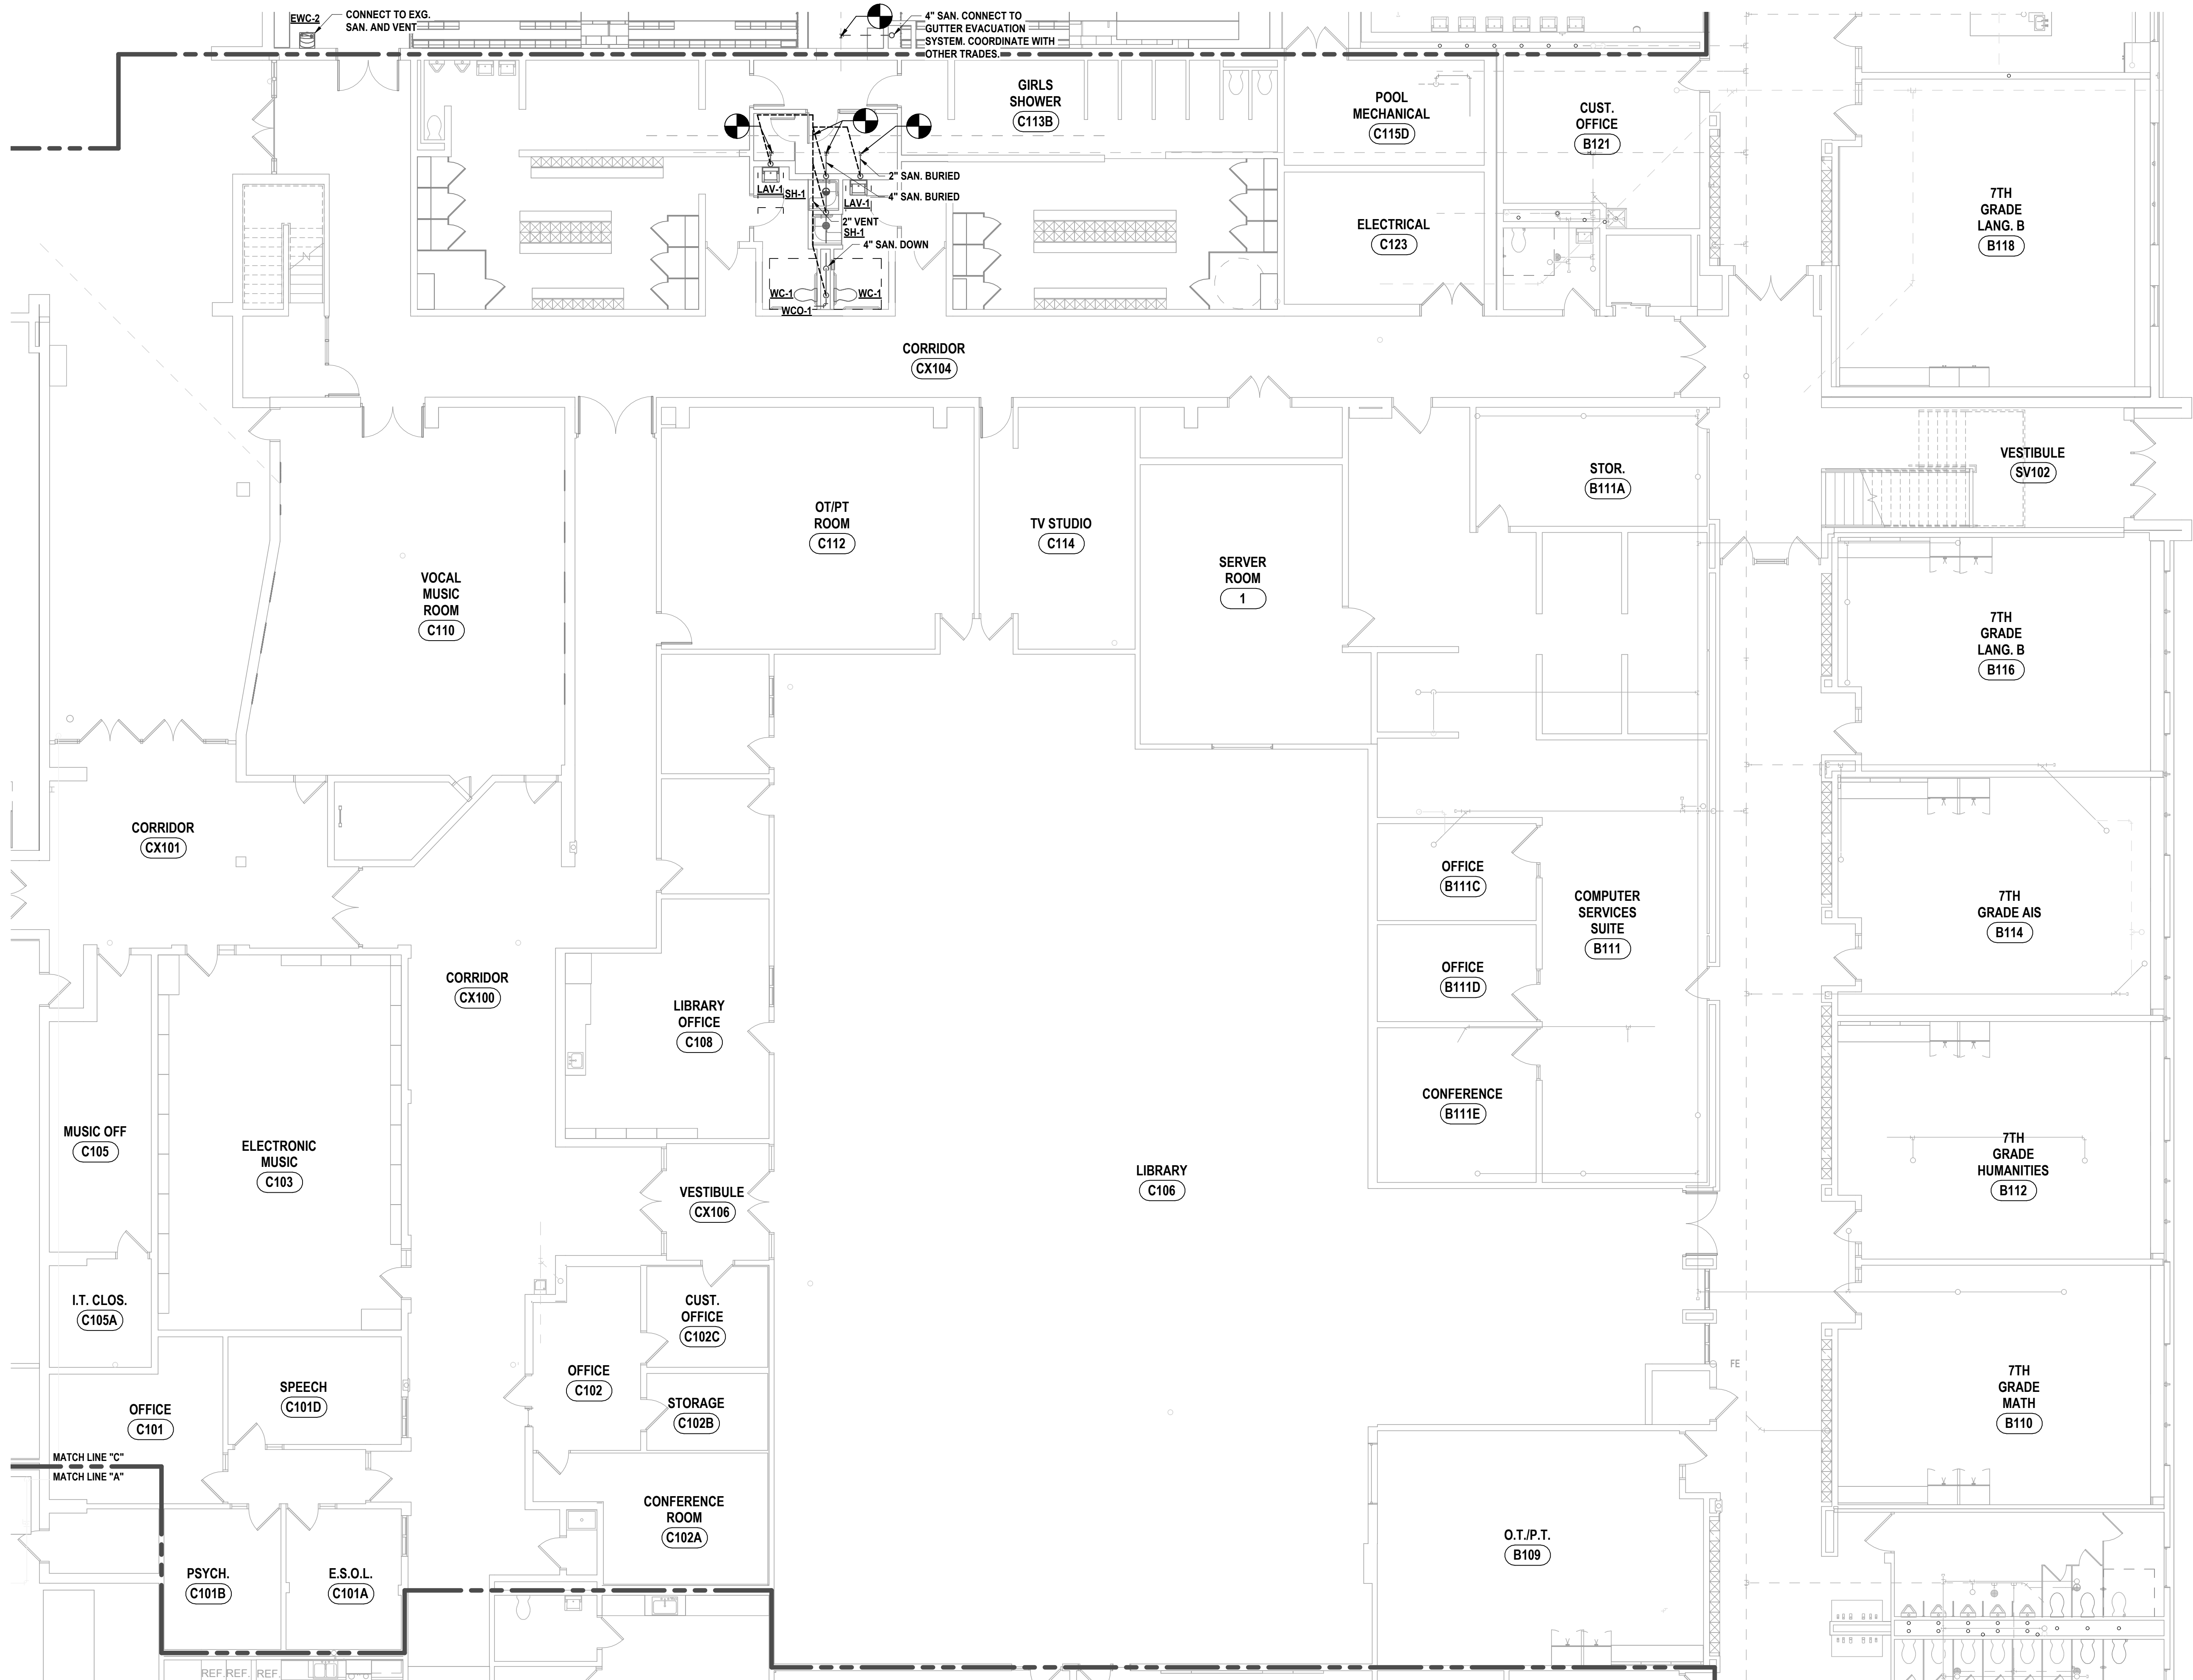

1 FIRST FLOOR SANITARY PLAN - AREA C  
1/8" = 1'-0"

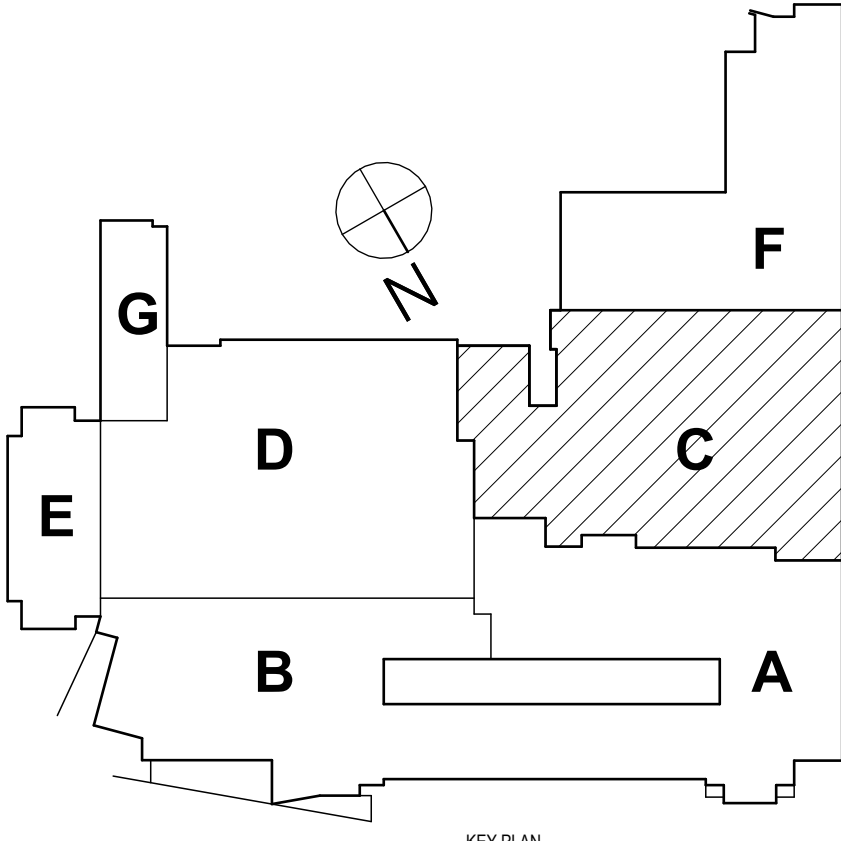

SED #: 57-000-01-000-004 - MIDDLE SCHOOL

FIRST FLOOR SANITARY PLAN - AREA C  
2025 MIDDLE SCHOOL PHASE III ALTERATIONS PROJECT  
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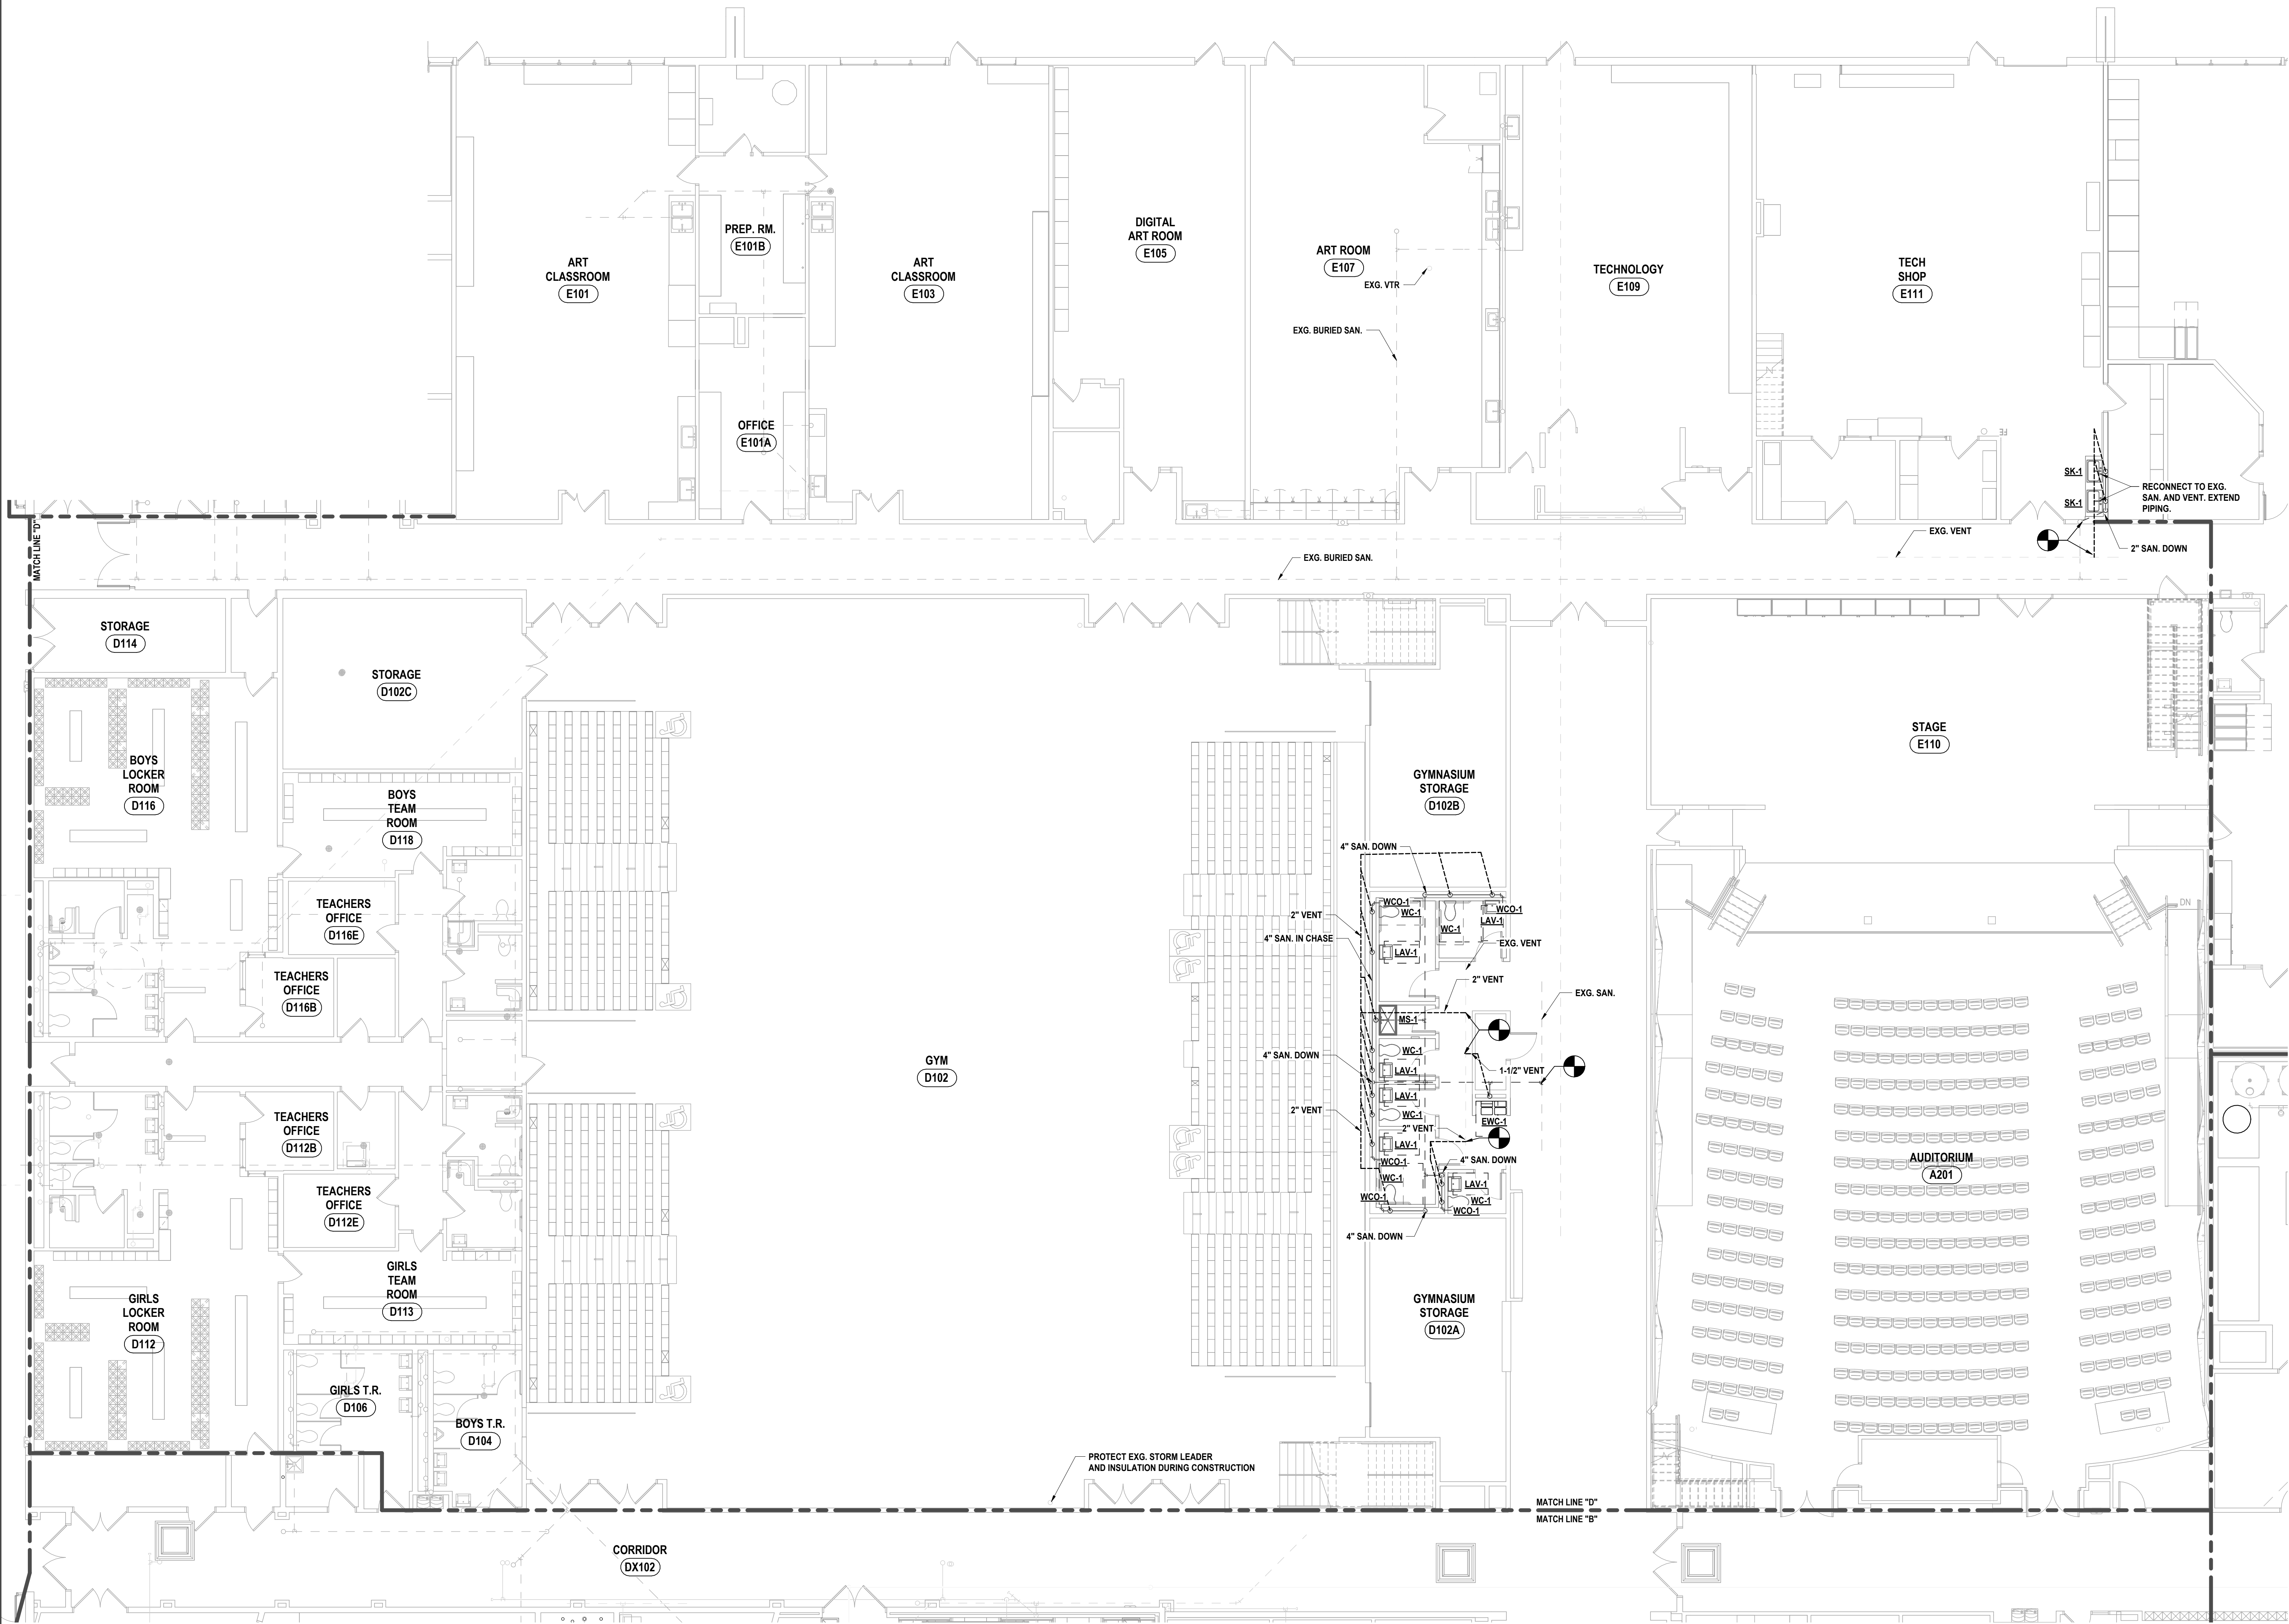
MS-P1.2  
PROJECT NO: 2649-133

DRAWN BY: CJH	
CHECKED BY: JDO	
DATE: 05/09/2025	
PHASE: CD	
DESCRIPTION OF REVISION: ISSUED FOR BID	
#	DATE
1	10/20/2025


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DRAWN & LOCATED, ENGINEERED, DESIGNED & SURVEYED BY DATE:

HUNT ENGINEERS | ARCHITECTS | SURVEYORS  
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1 FIRST FLOOR SANITARY PLAN - AREA D  
1/8" = 1'-0"



SED #: 57-16-00-41-2024-444 - MIDDLE SCHOOL

FIRST FLOOR SANITARY PLAN - AREA D

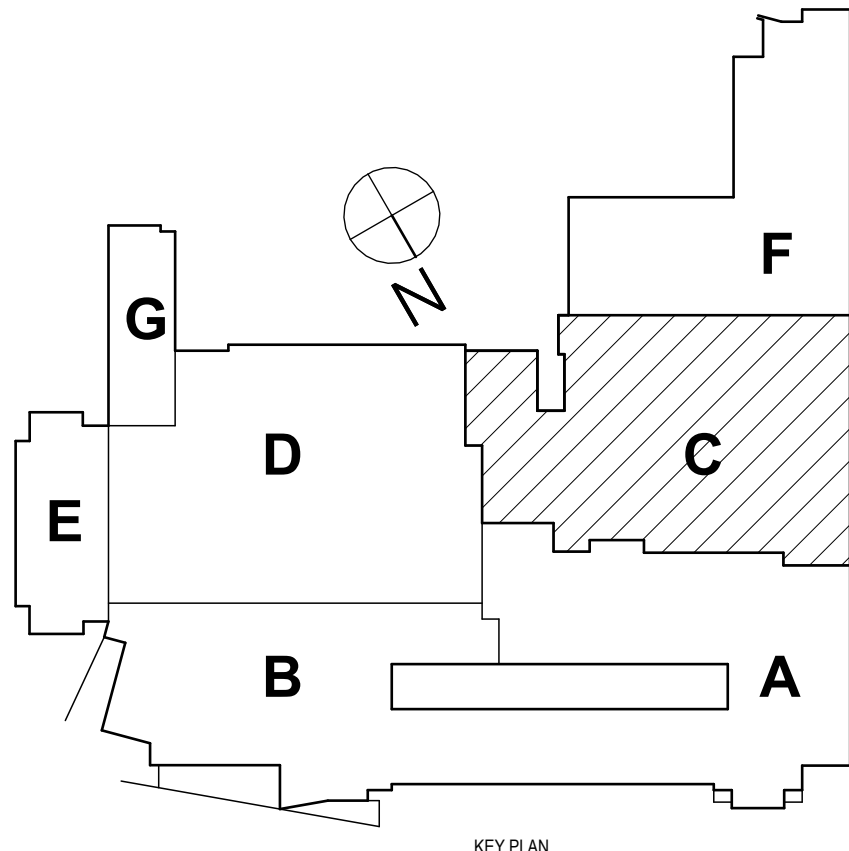2025 MIDDLE SCHOOL PHASE III ALTERATIONS PROJECT

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MS-P1.3

PROJECT NO: 2649-133

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DATE: 05/09/2025

PHASE: CP

ISSUED FOR BID

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DRAWN BY: C.J. HUNT  
CHECKED BY: J. DOUGLAS  
DATE: 05/09/2025  
PHASE: CP


GENERAL NOTES - PLUMBING  
REFER TO GENERAL NOTES ON SHEET MS-P0.1

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PHASE: CD	
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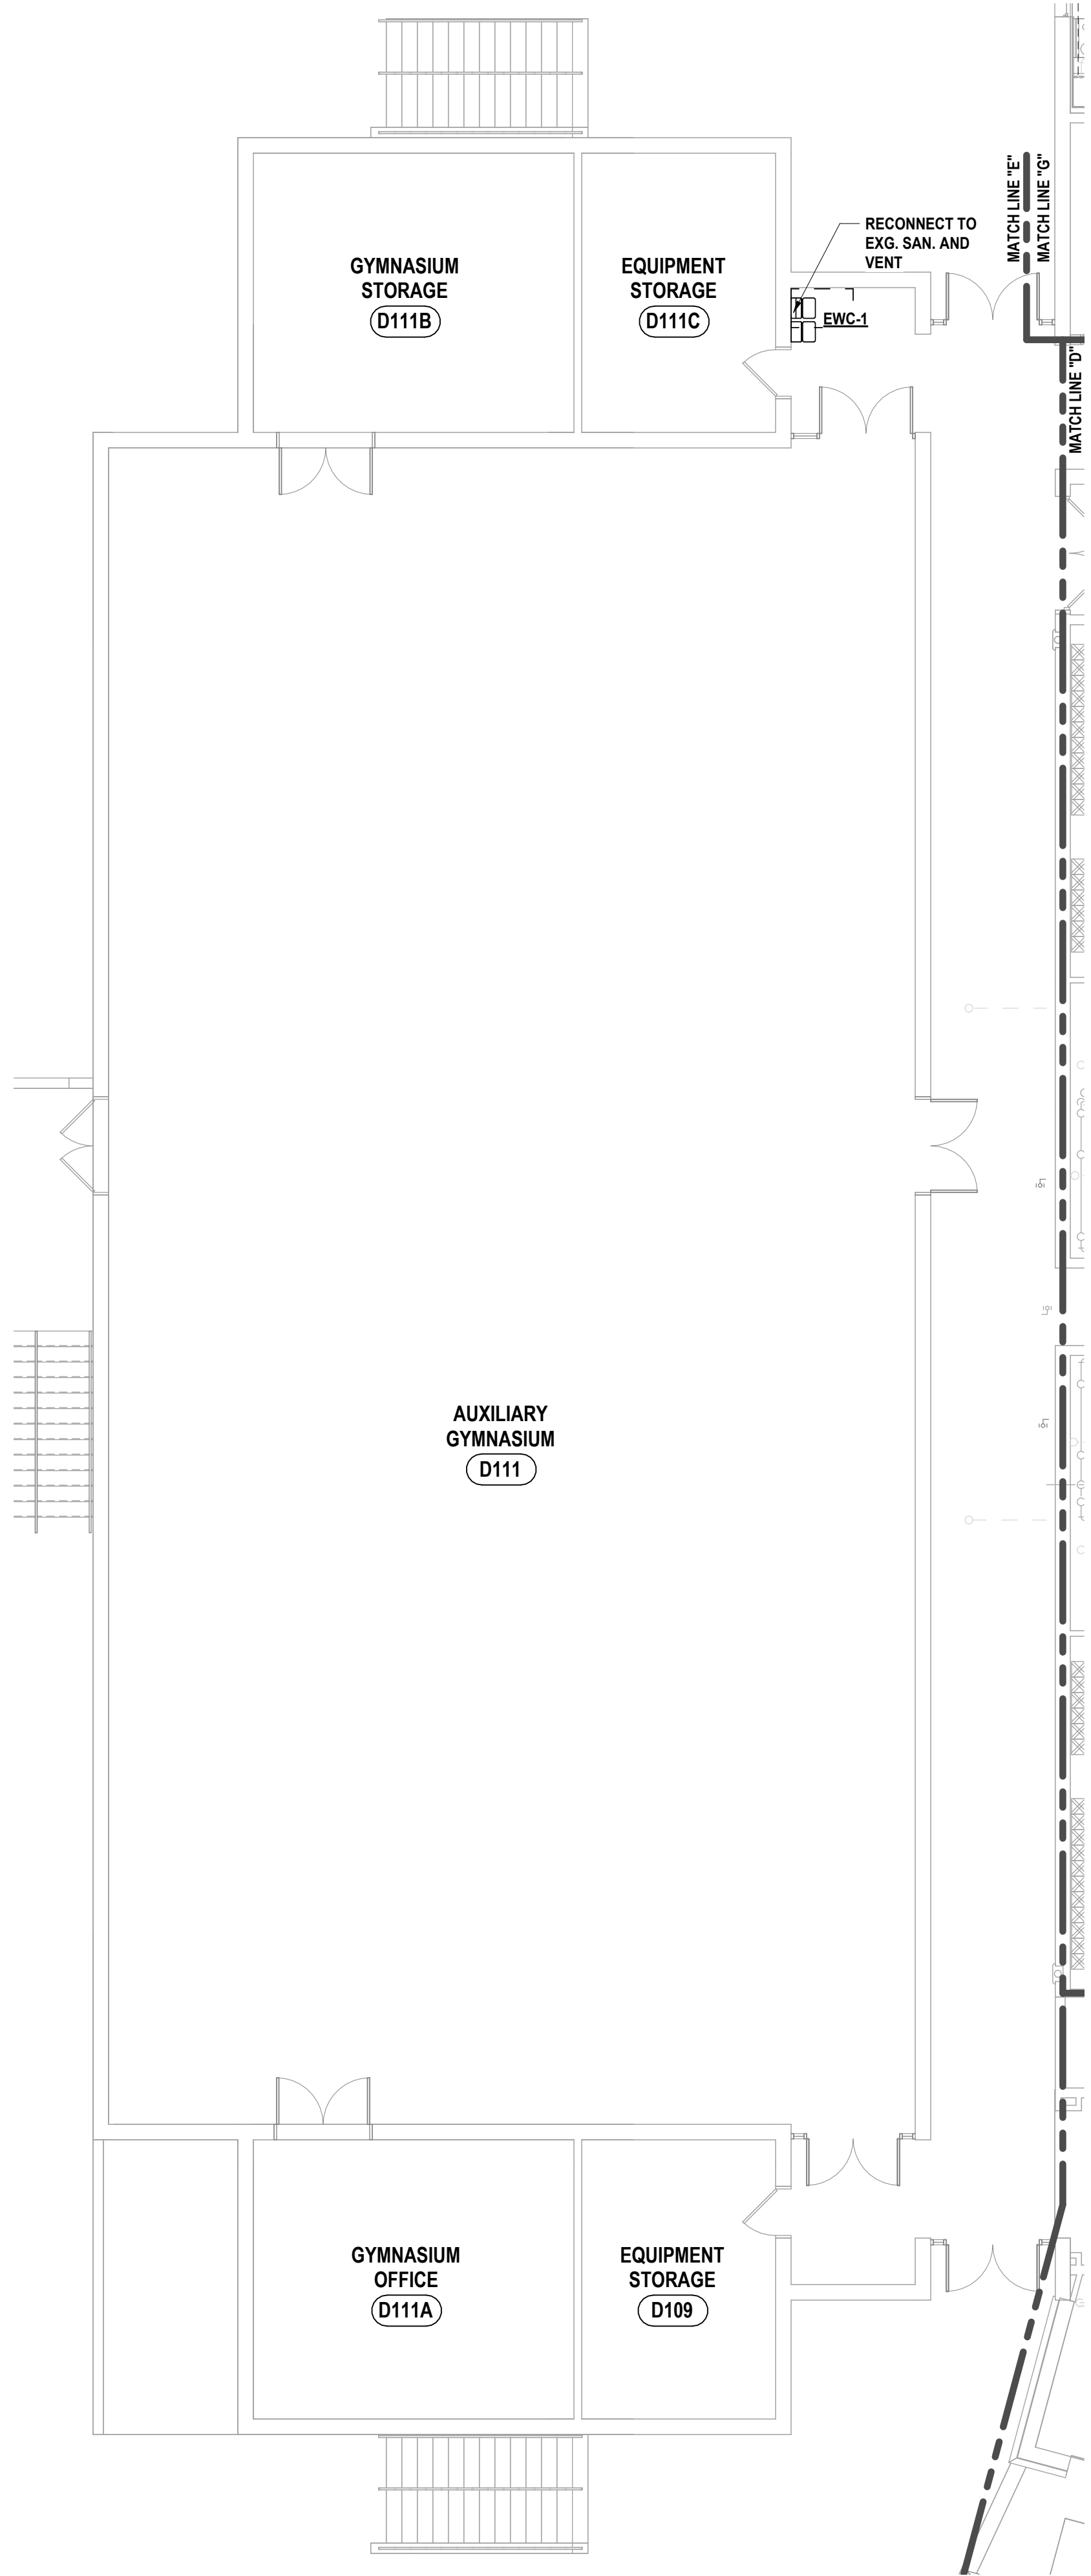
**HUNT** ENGINEERS | ARCHITECTS | SURVEYORS  
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BINGHAMTON, NY 607-798-8881    ALBANY, NY 607-798-8881    WWW.HUNTEAS.COM  
NY CERTIFICATE NO. 0016220    PA CERTIFICATE NO. TSC222013464-1

FIRST FLOOR SANITARY PLAN - AREA E AND F  
2025 MIDDLE SCHOOL PHASE III ALTERATIONS PROJECT  
CORNING-PAINTED POST ASD  
35 VICTORY HIGHWAY, PAINTED POST, NY 14870


**MS-P1.4**  
PROJECT NO: 2649-133

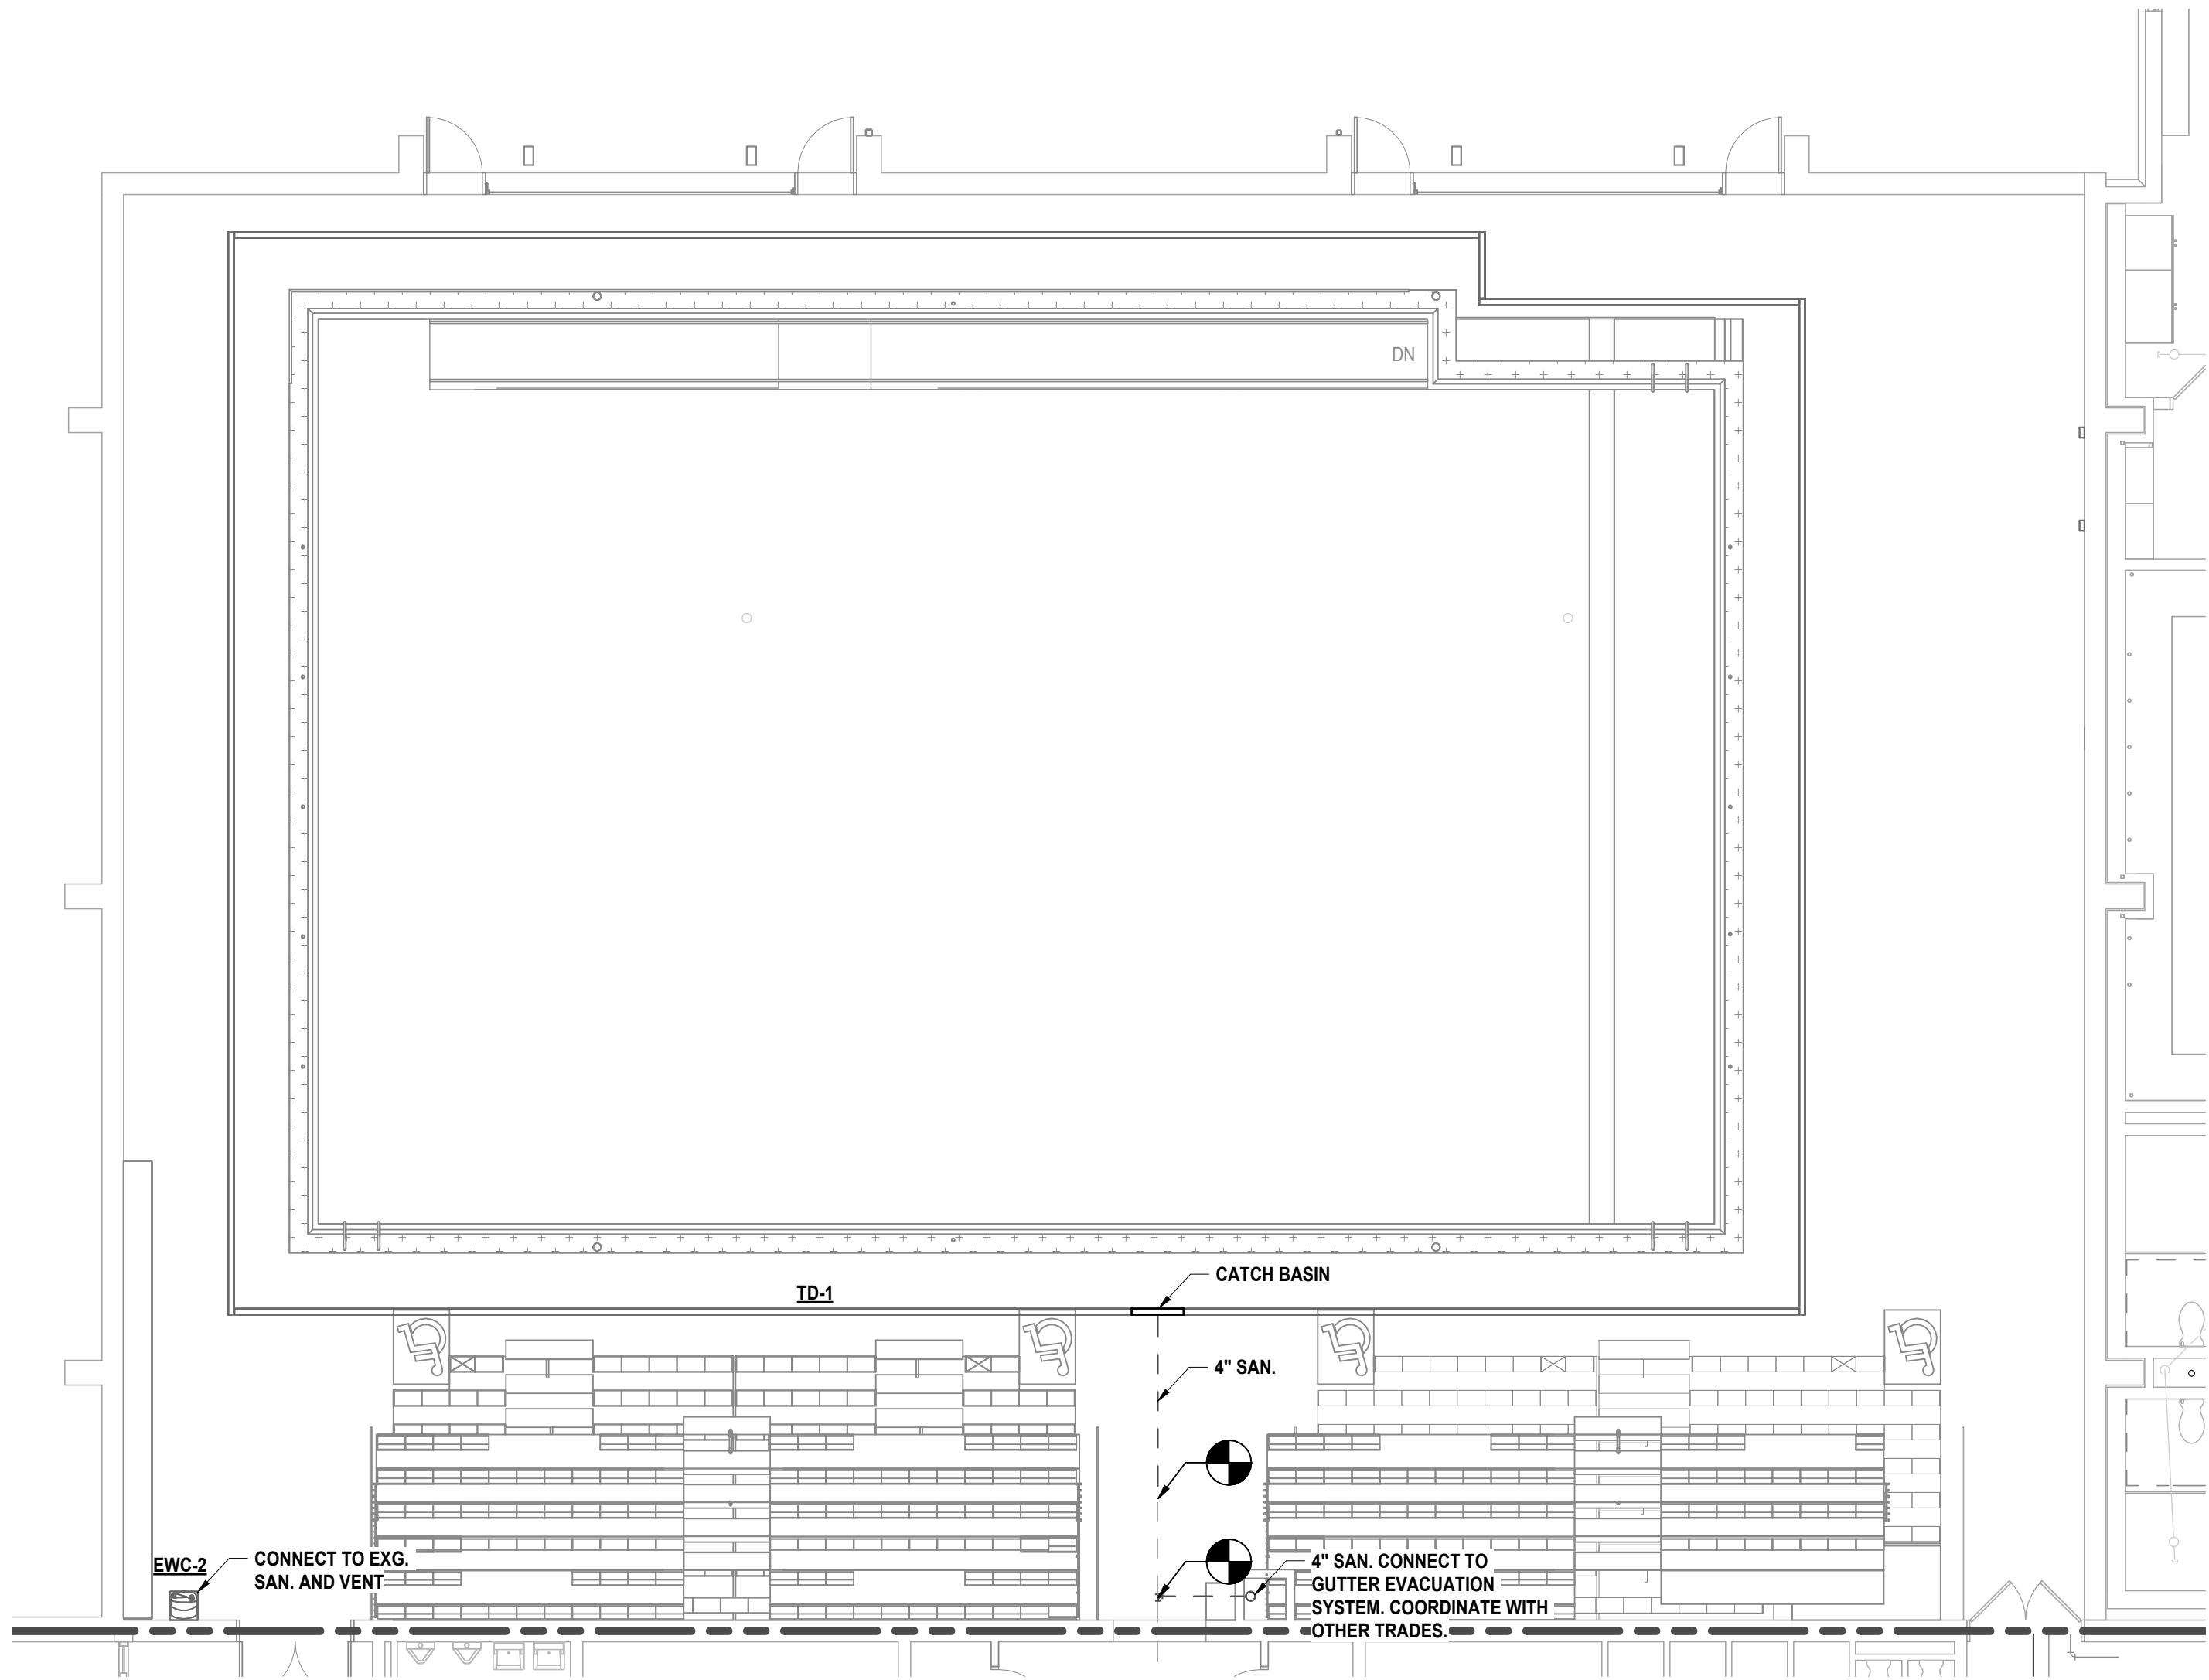

2 FIRST FLOOR SANITARY PLAN - AREA F  
1/8" = 1'-0"





1 FIRST FLOOR SANITARY PLAN - AREA E  
1/8" = 1'-0"

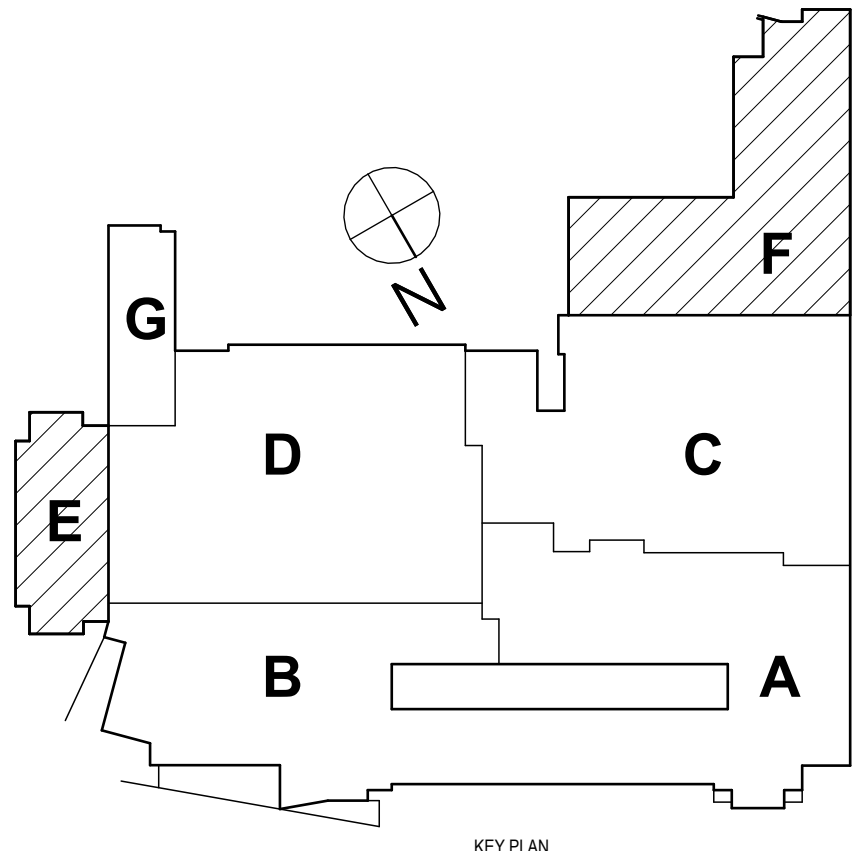

SED #: 571600-01-5024-044 - MIDDLE SCHOOL



GENERAL NOTES - PLUMBING  
REFER TO GENERAL NOTES ON SHEET MS-P0.1

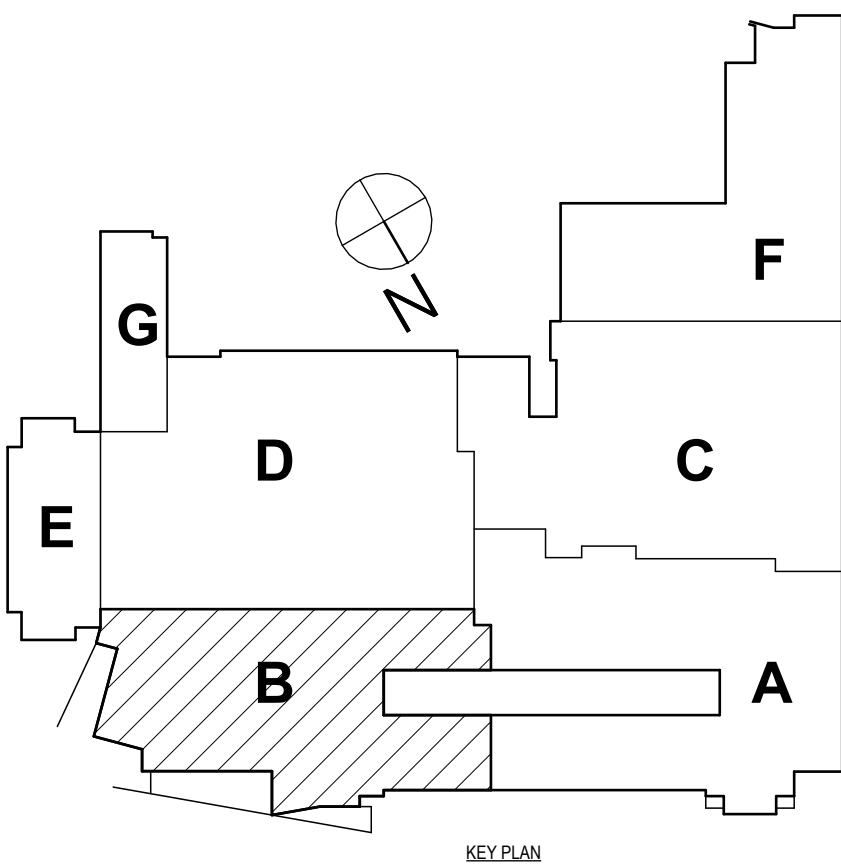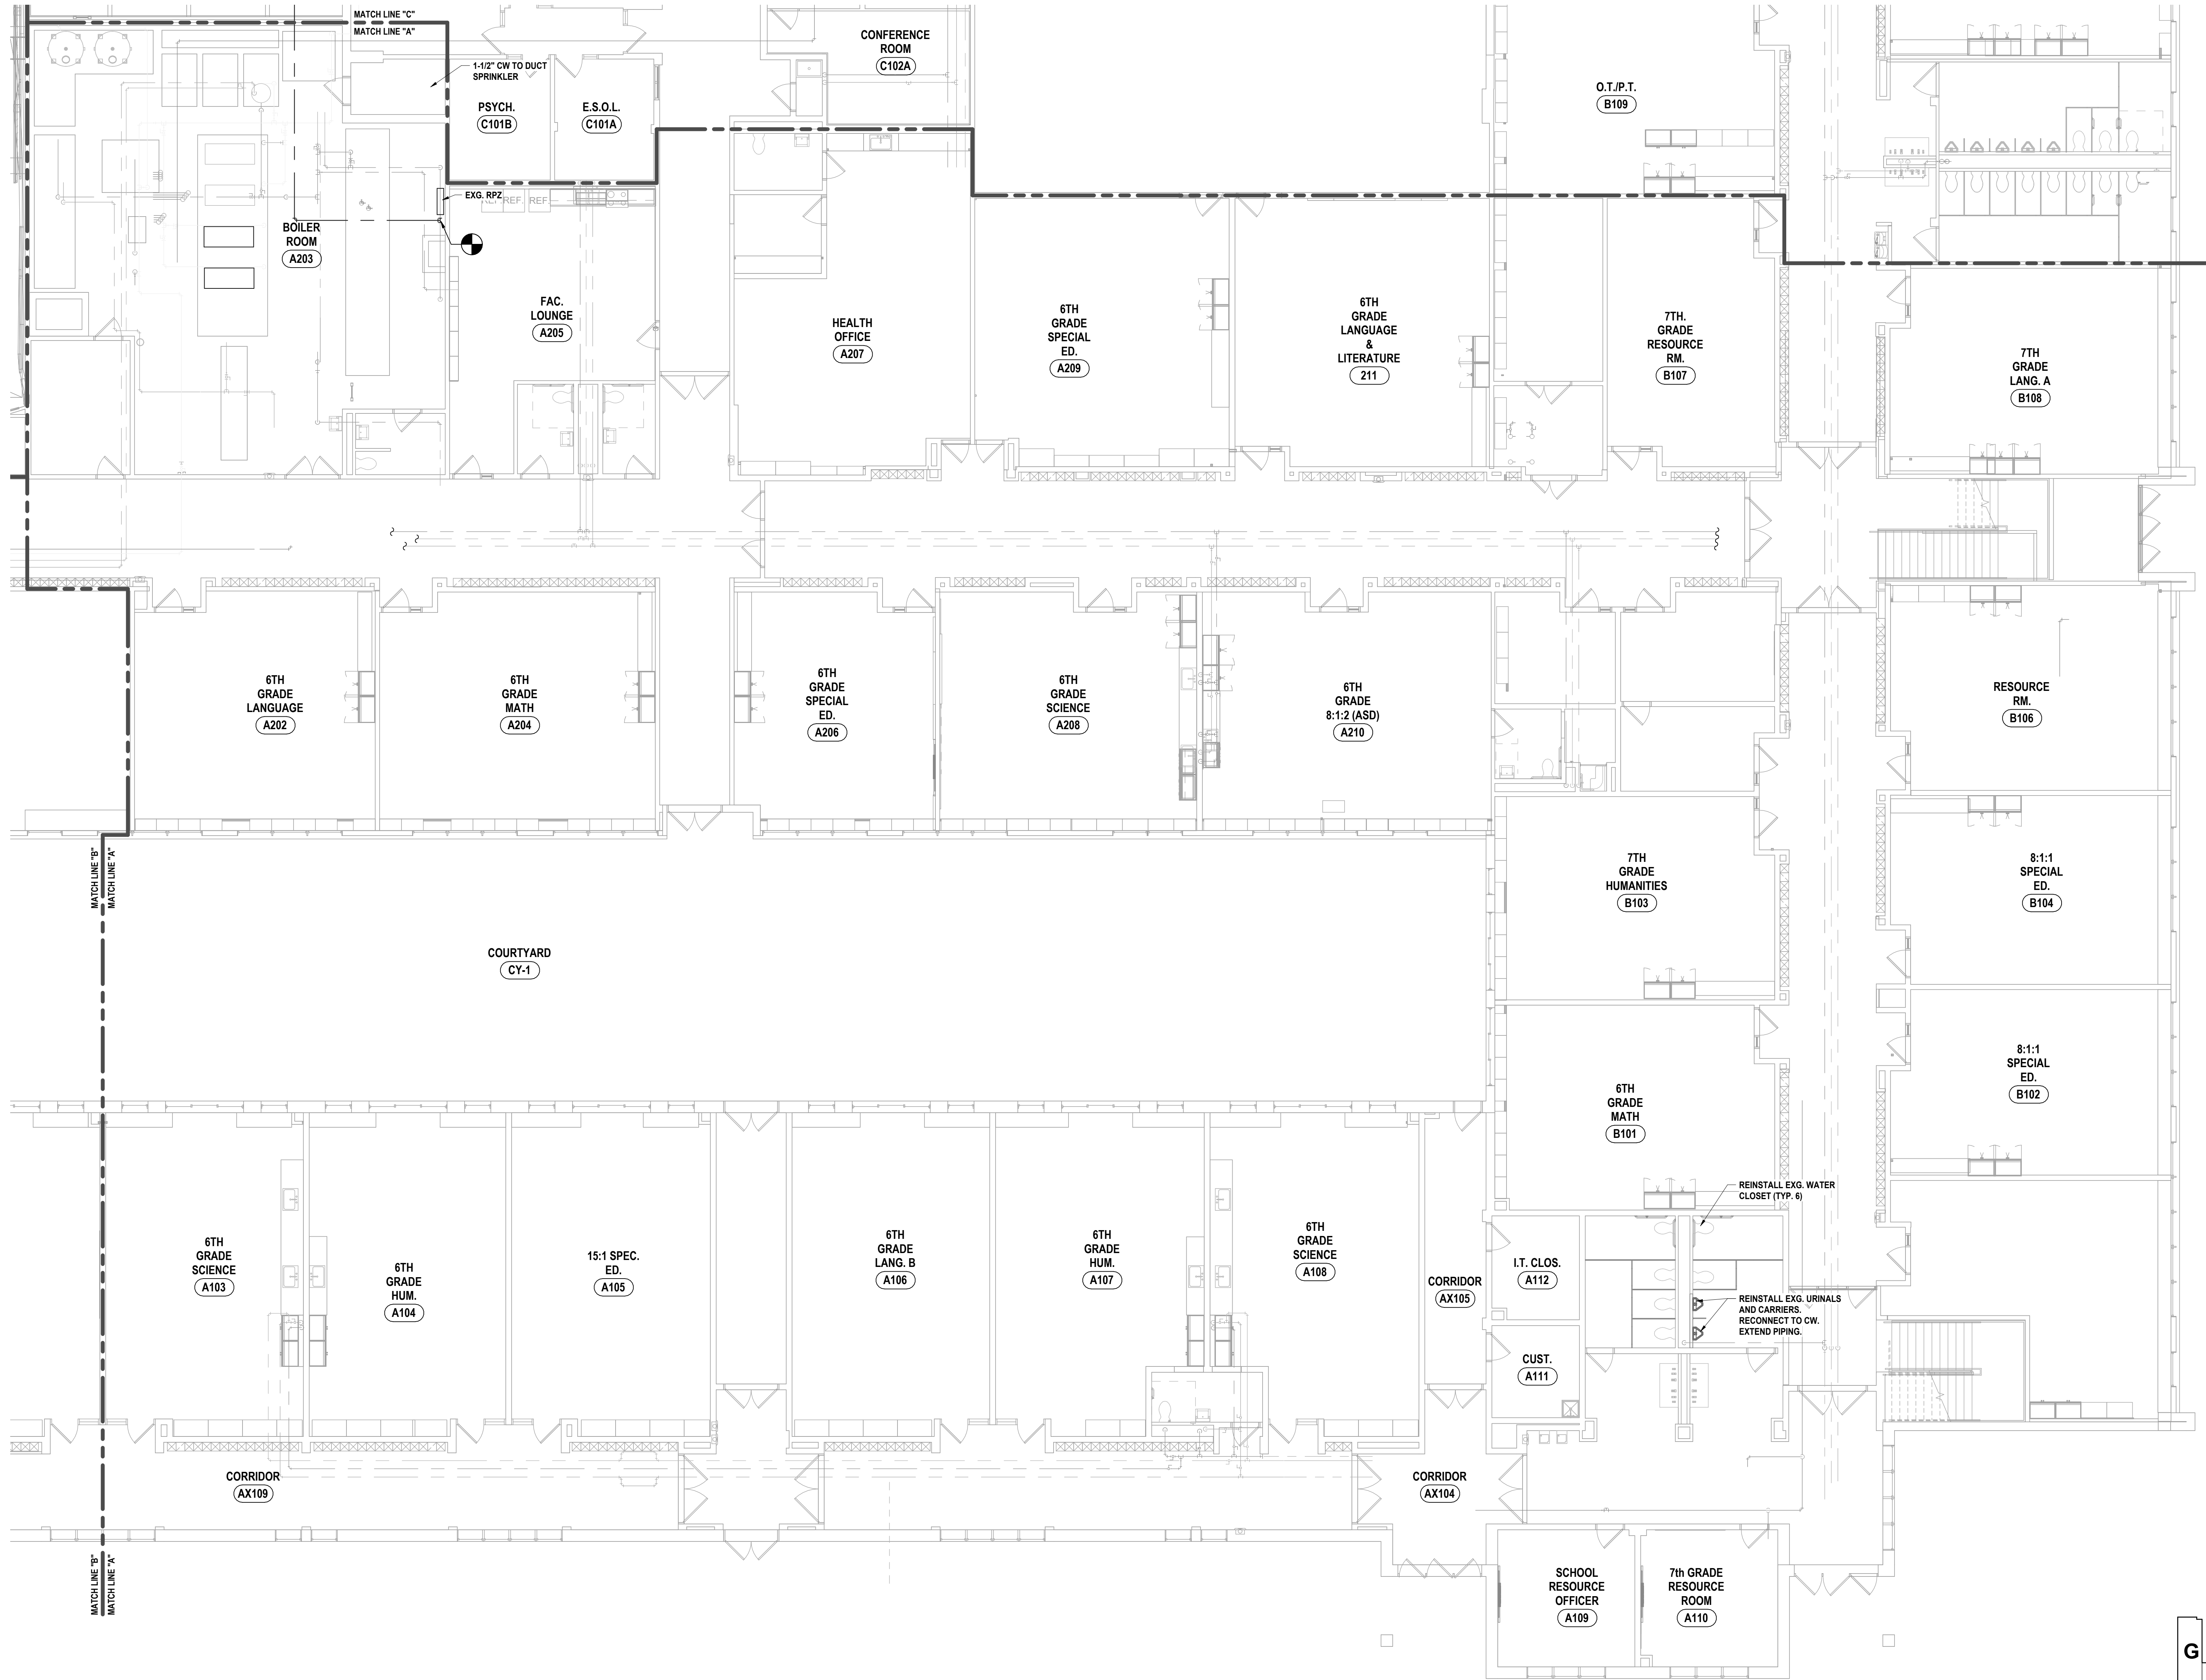

1 FIRST FLOOR DOMESTIC PLAN - AREA A  
1/8" = 1'-0"

SED #: 57-16-00-41-4024-444 - MIDDLE SCHOOL

FIRST FLOOR DOMESTIC PLAN - AREA A  
2025 MIDDLE SCHOOL PHASE III ALTERATIONS PROJECT  
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MS-P2.1  
PROJECT NO: 2649-133

HUNT ENGINEERS | ARCHITECTS | SURVEYORS

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BINGHAMTON, NY 607-738-8881 ALBANY, NY 607-738-8801  
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NY CERTIFICATE NO. 001820 PA CERTIFICATE NO. TSC220313464-1

#	DATE:	1	10/20/2025	DESCRIPTION OF REVISION: ISSUED FOR BID	DRAWN BY: CJH CHECKED BY: JDB DATE: 05/09/2025 PHASE: CP	COPY # 1/1

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DRAWN & LOCATED, DIMENSIONED, TOLERANCED & NOTED BY SURVEYOR'S SEAL.

REFER TO GENERAL NOTES ON SHEET MS-P0.1

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PHASE:	CD	


**ENGINEERS | ARCHITECTS | SURVEYORS**

603-558-1000 ROCHESTER, NY 585-327-7949 TOWANDA, PA 267-4688  
BINGHAMTON, NY 607-789-5081 ALBANY, NY 518-788-1081  
ROCHESTER, NY 607-789-5081 ALBANY, NY 518-788-1081  
NY CERTIFICATE NO. 0018220 PA CERTIFICATE NO. TSC2202013464-1


2025 MIDDLE SCHOOL PHASE III ALTERATIONS PROJECT  
CORNING-PAINTED POST ASD  
35 VICTORY HIGHWAY, PAINTED POST, NY 14870

**MS-P2.2**

PROJECT NO: 2649-153

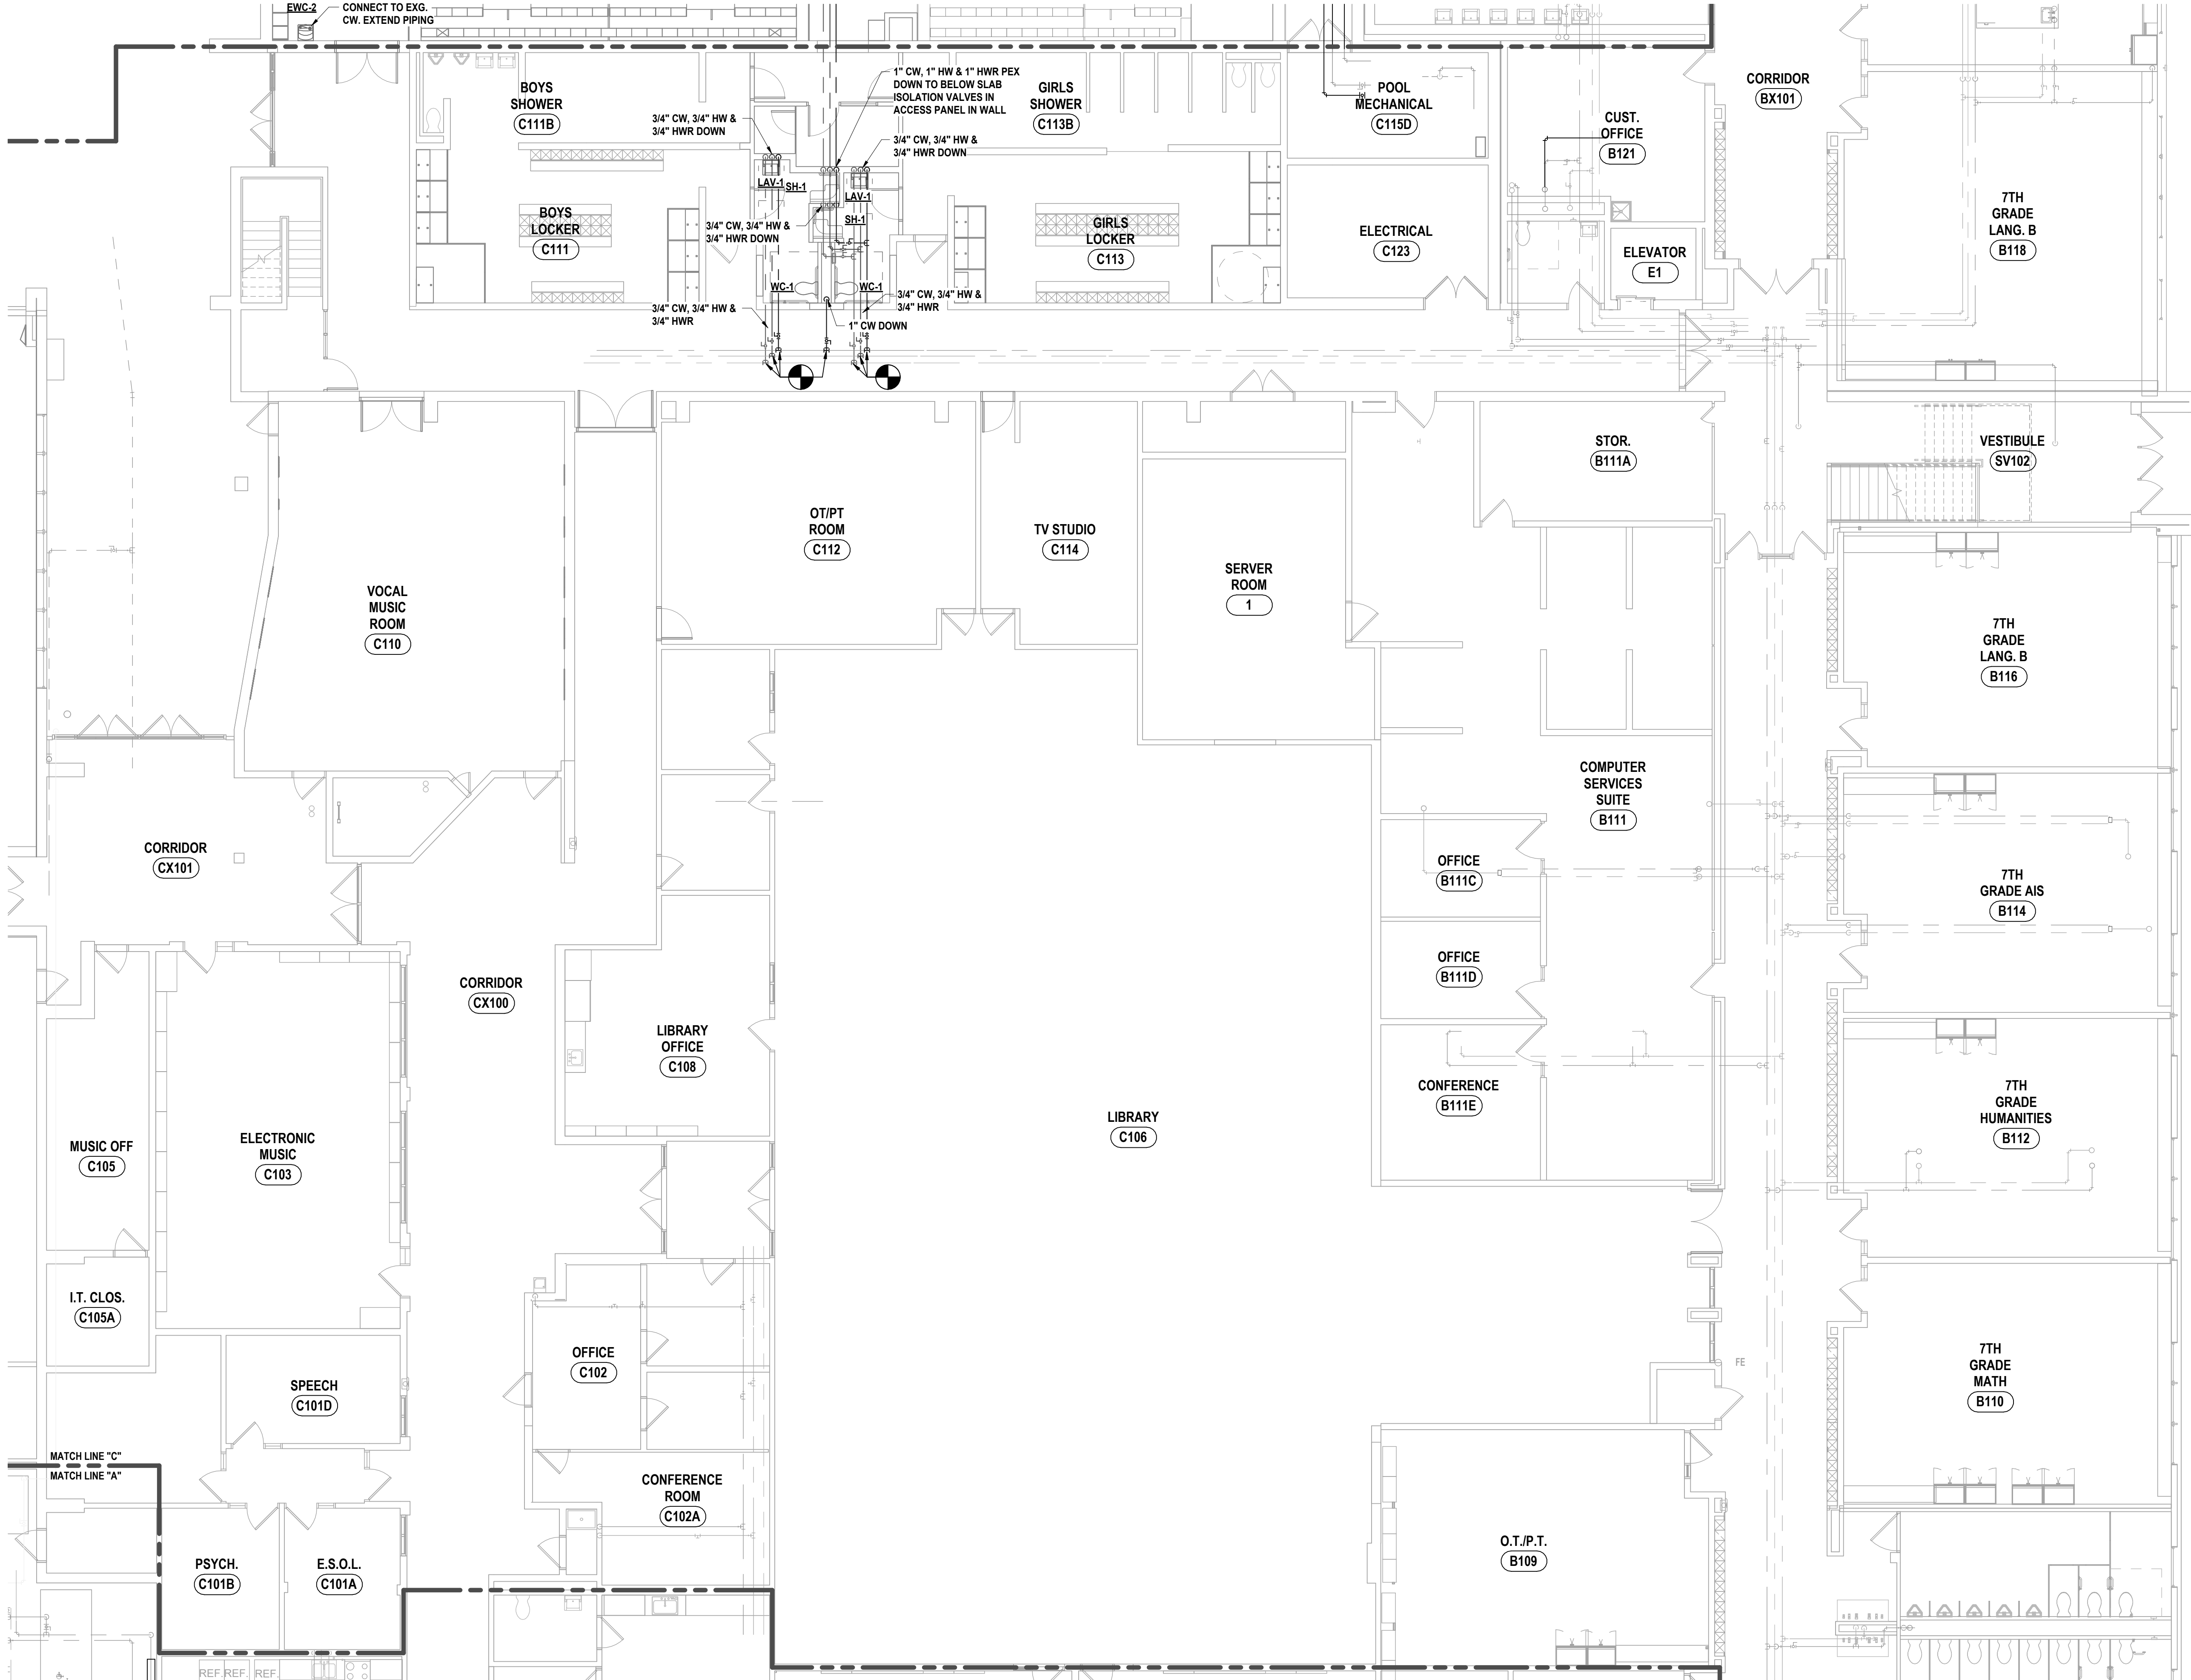

**1 FIRST FLOOR DOMESTIC PLAN - AREA C**  
1/8" = 1'-0"

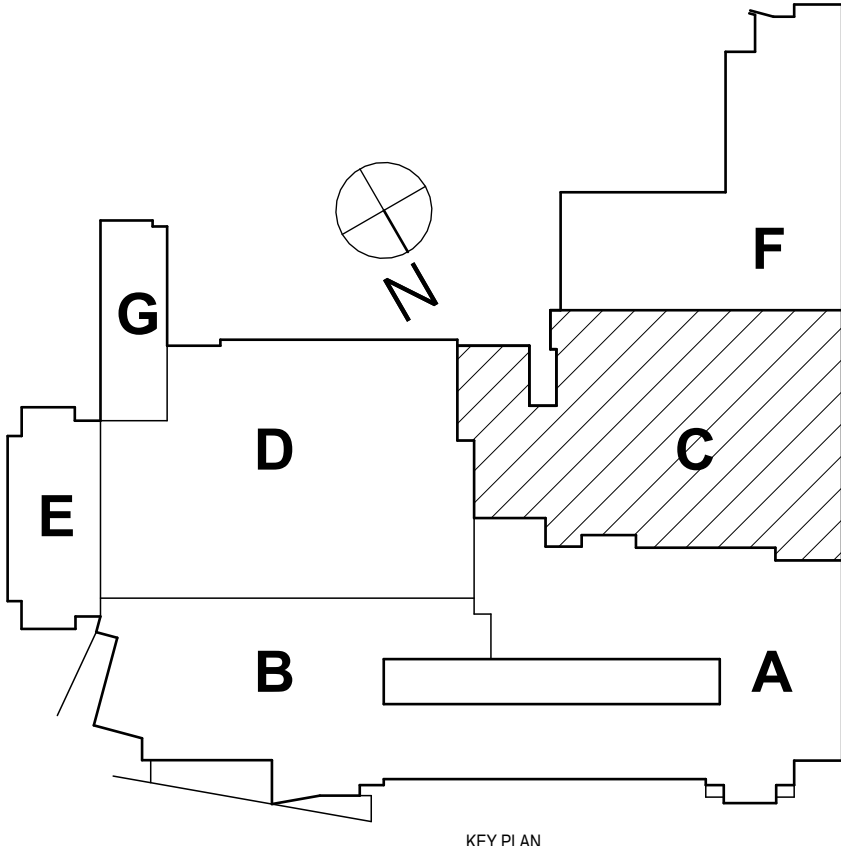

SED #: 57-10-00-01-0-024-044 - MIDDLE SCHOOL





GENERAL NOTES - PLUMBING  
REFER TO GENERAL NOTES ON SHEET MS-P0.1

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PHASE:		CD	
#	DATE:	DESCRIPTION OF REVISION:	
1	10/20/2025	ISSUED FOR BID	
			IT IS A VIOLATION OF THE LAW FOR ANY PERSON TO MAKE UNAUTHORIZED ALTERATIONS OR ADDITIONS TO PLANS DRAWN & LOCATED, DIMENSIONED, TOLERANCED & NOTED BY DATE.
			BEING A LICENSED ENGINEER, ARCHITECT OR SURVEYOR'S SEAL.

**HUNT** ENGINEERS | ARCHITECTS | SURVEYORS  
HORSEHEADS, NY 807-263-1000    ROCKY HILLS, CT 860-337-7868    TOWANDA, PA 570-265-4666  
BINGHAMTON, NY 807-738-8881    ALBANY, NY 807-738-8801    WWW.HUNTEAS.COM  
NY CERTIFICATE NO. 0016220    PA CERTIFICATE NO. TSC220313464-1

FIRST FLOOR DOMESTIC PLAN - AREA D  
2025 MIDDLE SCHOOL PHASE III ALTERATIONS PROJECT  
CORNING-PAINTED POST ASD  
35 VICTORY HIGHWAY, PAINTED POST, NY 14870

**MS-P2.3**  
PROJECT NO: 2649-133

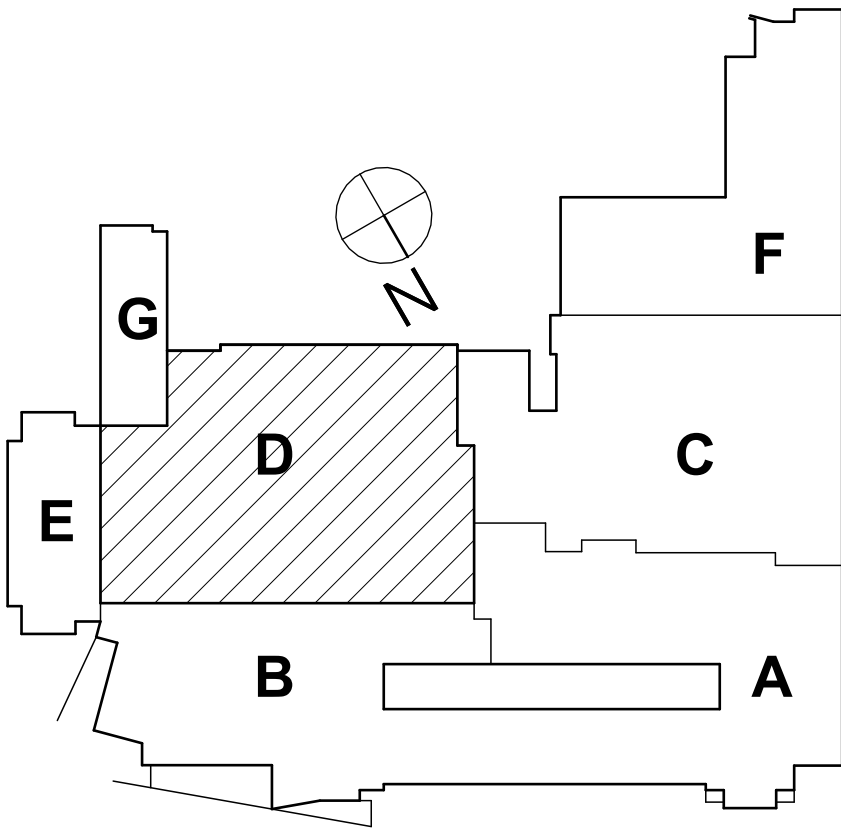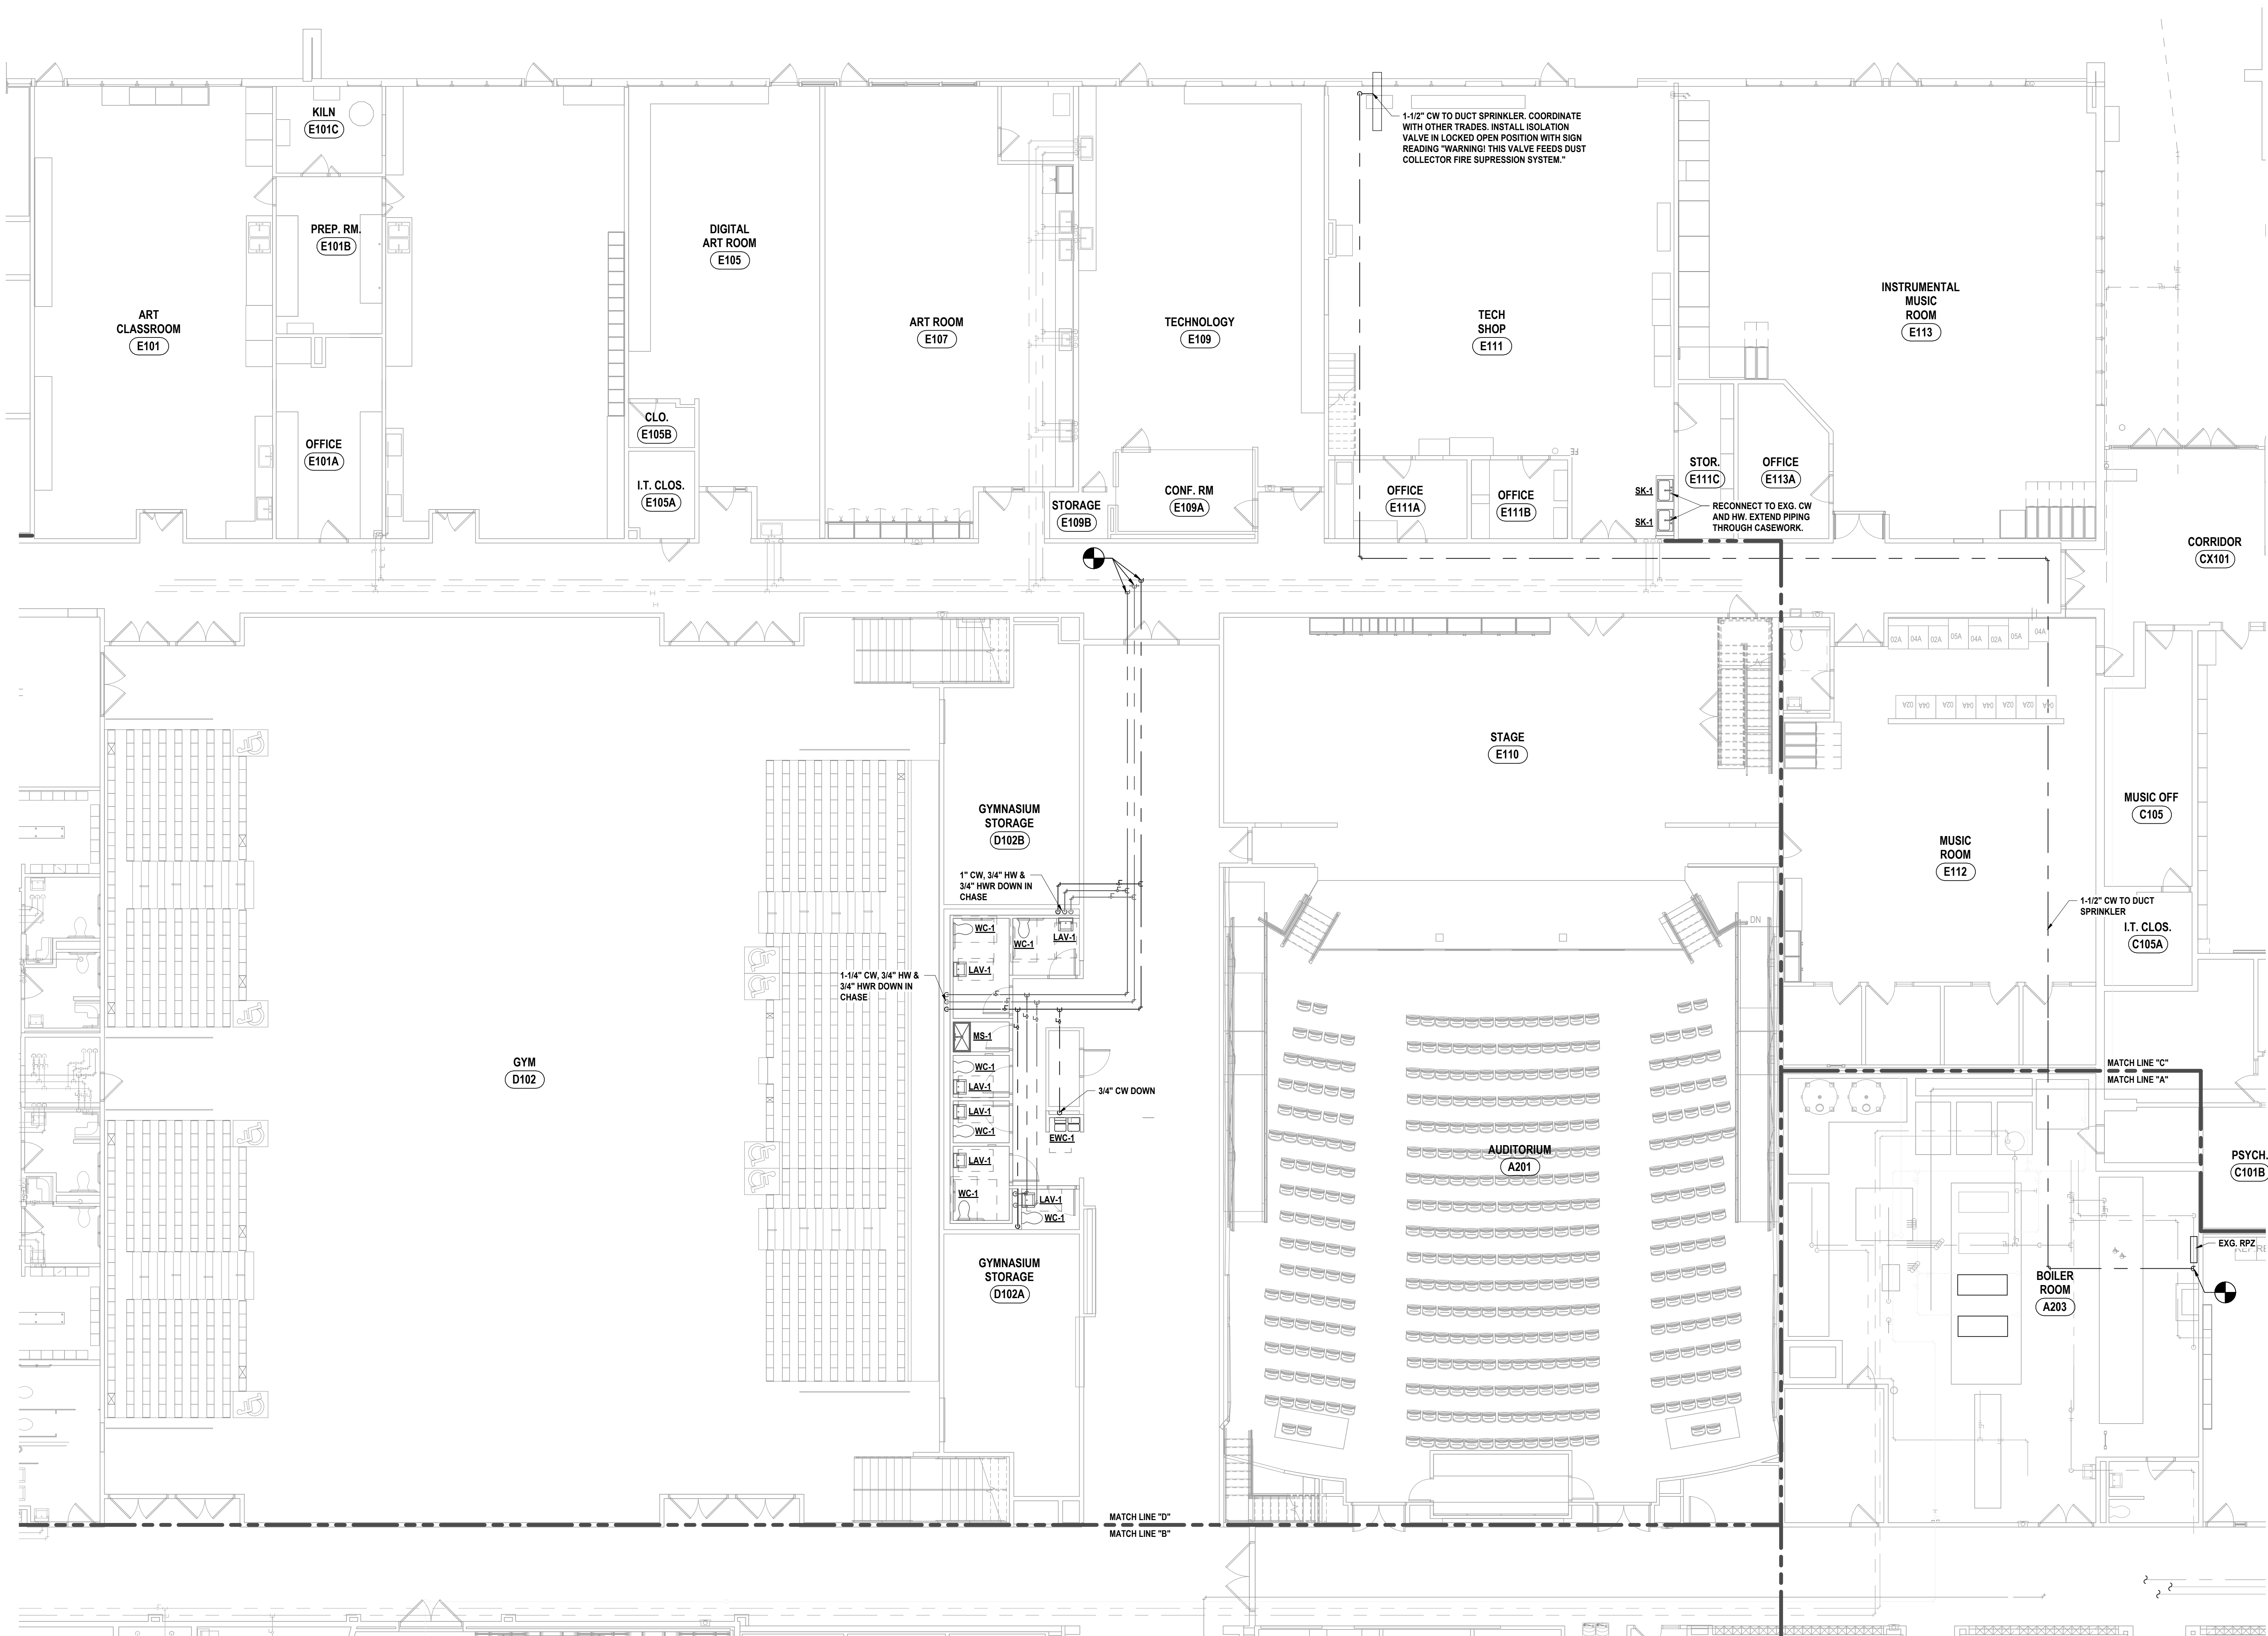

1 FIRST FLOOR DOMESTIC PLAN - AREA D  
1/8" = 1'-0"

GENERAL NOTES - PLUMBING

REFER TO GENERAL NOTES ON SHEET MS-P0.1

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CHECKED BY:	JDB
DATE:	05/09/2025
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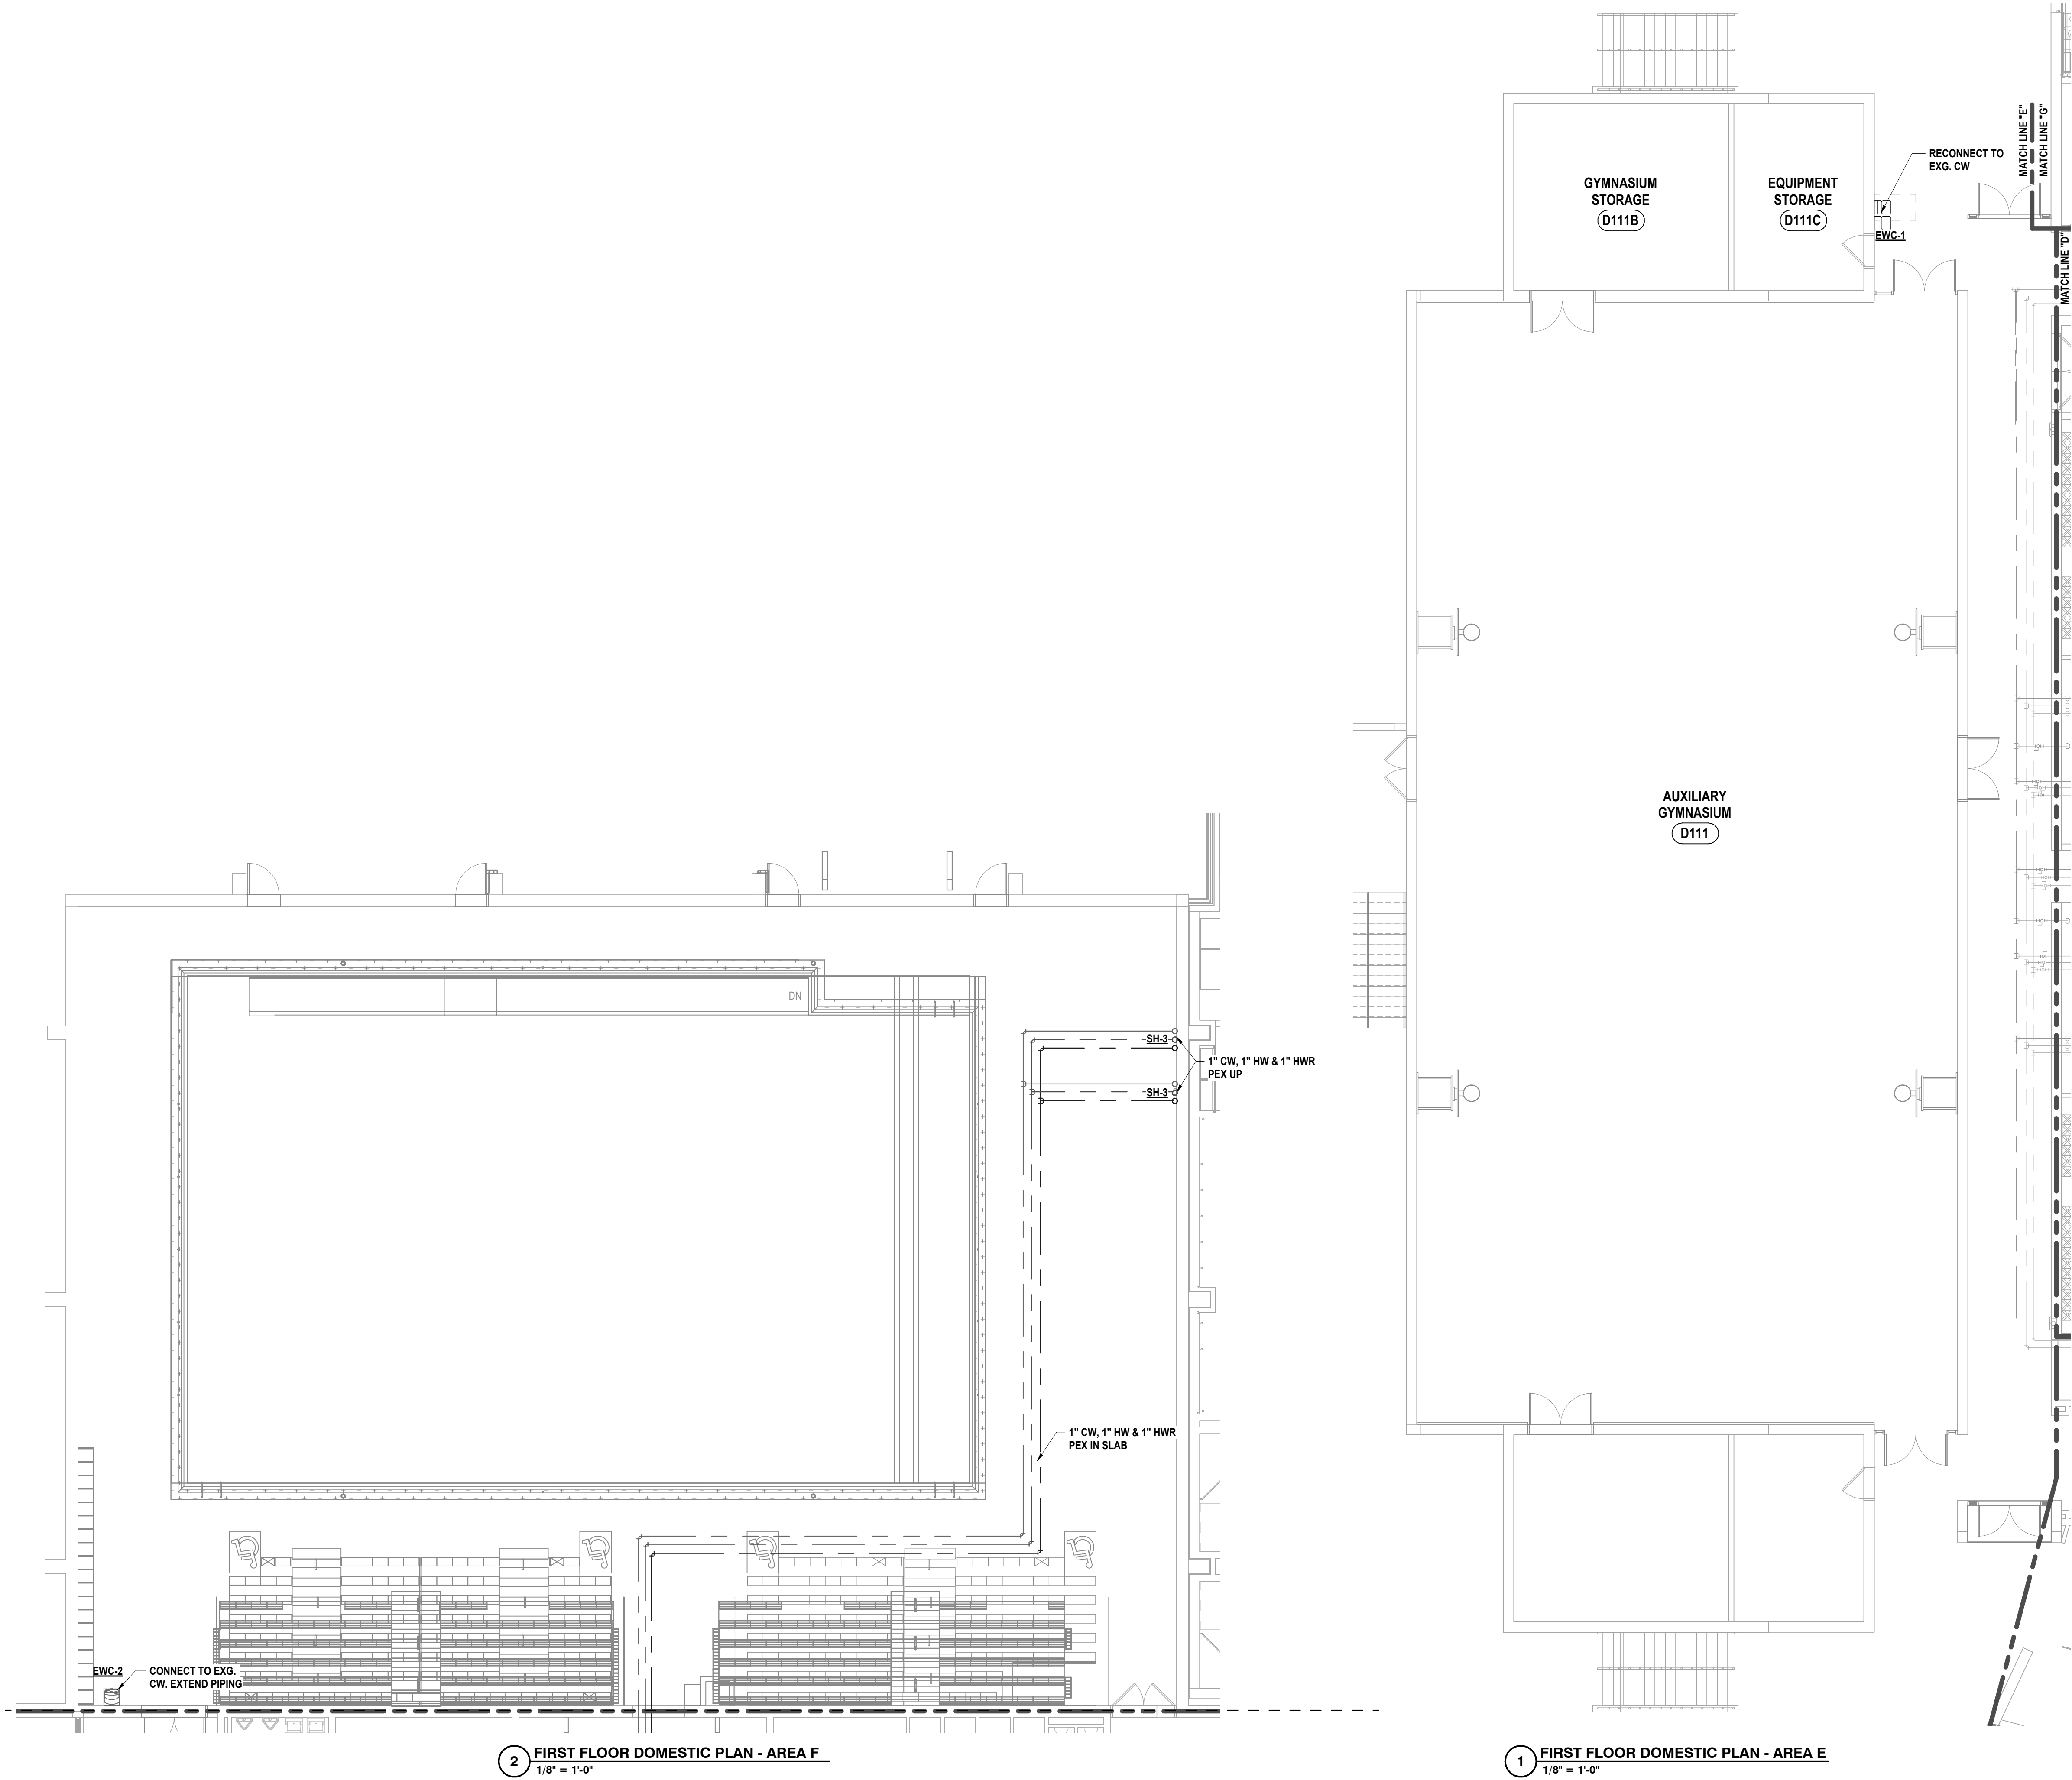
#	DATE:	DESCRIPTION OF REVISION:
1	10/20/2025	ISSUED FOR BID

IT IS A VIOLATION OF THE LAW FOR ANY PERSON TO MAKE UNAUTHORIZED ALTERATIONS OR ADDITIONS TO PLANS DRAWN BY A LICENSED ENGINEER OR ARCHITECT'S SURVEYOR'S SEAL.

**HUNT** ENGINEERS | ARCHITECTS | SURVEYORS  
HORSEHEADS, NY 607-258-1000    ROCHESTER, NY 585-537-7549    TOWNANDA, PA 570-265-4666  
BINGHAMTON, NY 607-798-8881    ALBANY, NY 607-798-8881  
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NY CERTIFICATE NO. 0016220    PA CERTIFICATE NO. TSC2220313/464-1

FIRST FLOOR DOMESTIC PLAN - AREA E AND F  
2025 MIDDLE SCHOOL PHASE III ALTERATIONS PROJECT  
CORNING-PAINTED POST ASD  
35 VICTORY HIGHWAY, PAINTED POST, NY 14870

**MS-P2.4**  
PROJECT NO: 2649-133





PLUMBING FIXTURE SCHEDULE				
NO.	TYPE	MFG./MODEL	TRIM	REMARKS
WC-1	WATER CLOSET, WALL MOUNT, ADA COMPLIANT, COLOR: WHITE	AMERICAN STANDARD 2257.101, 1.28 GPF 1-1/2 INCH TOP SPUD	FLUSH VALVE: SENSORED (ELECTRIC) SLOAN ROYAL OPTIMA 111-1.28 ESS-TMO, 1.28 GPF, WITH TRUE MECHANICAL OVERRIDE FLUSH BUTTON	ELONGATED BOWL. PROVIDE ELONGATED SEAT SIMILAR TO BENEKE 527-SS, FLOOR MOUNTED CARRIER. SEE 'A' DRAWINGS FOR MOUNTING HEIGHT. NOTE A.
LAV-1	LAVATORY, WALL MOUNT, ADA COMPLIANT, COLOR: WHITE	AMERICAN STANDARD 0355.012 (3 HOLES ON 2" CENTERS)	FAUCET: SENSORED (ELECTRIC) SLOAN ETF-000, 0.50 GPM	PROVIDE INFRARED FAUCET WITH 4 INCH COVER PLATE SIMILAR TO CHICAGO FAUCET MODEL 240.837.21.1, OFFSET GRID DRAIN, P-TRAP, LEAD FREE SUPPLIES, LEAD FREE STOPS. ESCUTCHEON PLATES AND PIPE COVERS. SEE 'A' DRAWINGS FOR MOUNTING HEIGHT. NOTE A, B, C.
SH-1	SHOWER, ADA COMPLIANT, RECESSED WALL MOUNT, (VALVE LEFT, SEAT RIGHT)	BRADLEY HN200-TMV-VR / SL, 1.50 GPM		PROVIDE SHOWER WITH STAINLESS STEEL WALL PANEL WITH RECESSED SOAP DISH, WALL SHOWERHEAD AND HAND HELD SHOWER SPRAY ASSEMBLY, DIVERTER VALVE, THERMOSTATIC MIXING VALVE, GRAB BAR, PHENOLIC SEAT, CURTAIN, ROD AND HANGERS.
SH-2	SHOWER, ADA COMPLIANT, RECESSED WALL MOUNT, (VALVE RIGHT, SEAT LEFT)	BRADLEY HN200-TMV-VL / SR, 1.50 GPM		PROVIDE SHOWER WITH STAINLESS STEEL WALL PANEL WITH RECESSED SOAP DISH, WALL SHOWERHEAD AND HAND HELD SHOWER SPRAY ASSEMBLY, DIVERTER VALVE, THERMOSTATIC MIXING VALVE, GRAB BAR, PHENOLIC SEAT, CURTAIN, ROD AND HANGERS.
SH-3	SHOWER, INDIVIDUAL WALL MOUNT	BRADLEY WS-1X, SINGLE TEMPERATURE VALVE		PROVIDE SHOWER WITH STAINLESS STEEL WALL PANEL WITH VERTICAL SHROUD FROM FLOOR TO FIXTURE, WALL SHOWERHEAD AND, DIVERTER VALVE, THERMOSTATIC MIXING VALVE. UNIT TO BE 6" STANDARD HEIGHT.
SK-1	SINK, DOUBLE, ADA COMPLIANT, 5-1/2" DEEP, COUNTERTOP MOUNT	JUST DL-ADA-1933-A-GR (2 HOLES ON 4" CENTERS)	FAUCET: MANUAL CHICAGO 786-0NHEMBCP, 2.20 GPM, (8" O.C. HOLES) STRAINER: JUST J-SS	PROVIDE 4" WRISTBLADE HANDLES, OFFSET GRID DRAIN, P-TRAP, LEAD FREE SUPPLIES, LEAD FREE STOPS & ESCUTCHEON PLATES. NOTE H.
EW-1	ELECTRIC WATER COOLER, TWO STATION WITH SINGLE STATION BOTTLE FILLER, ADA COMPLIANT, WALL MOUNT	ELKAY LZ2SLWSSP (WITH FILTER) (BOTTLE FILLER ON LOWER UNIT)		PROVIDE LEAD FREE DESIGN, STAINLESS STEEL PANELS WITH FLEXI-GUARD BUBBLER, DIELECTRIC COUPLING, PLASTIC P-TRAP, LEAD FREE SUPPLY, LEAD FREE STOP, CANE APRON FOR UPPER UNIT SIMILAR TO ELKAY MODEL LKAPREZL. SEE 'A' DRAWINGS FOR MOUNTING HEIGHT. NOTE A, I.
EW-2	ELECTRIC WATER COOLER, SINGLE STATION WITH BOTTLE FILLER, ADA COMPLIANT, WALL MOUNT	ELKAY LZ2SWSSK (WITH FILTER)		PROVIDE LEAD FREE DESIGN, STAINLESS STEEL PANELS WITH FLEXI-GUARD BUBBLER. DIELECTRIC COUPLING, PLASTIC P-TRAP, LEAD FREE SUPPLY, LEAD FREE STOP. SEE 'A' DRAWINGS FOR MOUNTING HEIGHT. NOTE A, I.
CO-1	CLEANOUT, FLOOR	ZURN Z1400	ADJUSTABLE TOP	PROVIDE POLISHED BRONZE TOP REFER TO PLAN FOR PIPE SIZE. NOTE D.
CO-2	CLEANOUT, INLINE	ZURN Z1449		REFER TO PLAN FOR PIPE SIZE.
WCO-1	WALL CLEANOUT	ZURN Z1446		PROVIDE ACCESS COVER.
TD-1	TRENCH DRAIN, RADIUS BOTTOM	ABT, INC. PD-2335 (SLOPING)	SERIES 2900 CATCH BASIN, 21" DEPTH, WITH 2616.504 LONGITUDINAL THERMOPLASTIC GRATE, GRAY	GRATE: 2338 THERMOPLASTIC GRATE, GRAY, NOTE J.


- NOTES:
- A. REFER TO PLUMBING FIXTURE ELECTRICAL REQUIREMENTS SCHEDULE.
- B. PROVIDE LOW LEAD CONTENT THERMOSTATIC MIXING VALVE SIMILAR TO CHICAGO FAUCET MODEL 122-ABNF (SERVES MAXIMUM 8 FAUCETS).
- C. PROVIDE CONCEALED ARM FIXTURE SUPPORT FOR NEW LAVATORY WITH UPRIGHT WELDED FEET AND ADJUSTABLE HEADERS, INSTALLED WITHIN WALL / CHASE.
- D. VERIFY LOCATION OF FLOOR DRAIN / FLOOR SINK / FLOOR CLEANOUT APPLY CORRECT APPLICATION, RECESSED FOR TILE, RECESSED FOR TERRAZZO.
- E. PROVIDE TRAP PRIMER VALVE SIMILAR TO PRECISION PLUMBING PRODUCT MODEL P2-500 FOR SINGLE FLOOR DRAIN OR FLOOR SINK APPLICATION OR MODEL P1-500 FOR MULTIPLE DRAIN OR FLOOR SINK APPLICATION. PROVIDE 1/2 INCH COPPER PIPING WITH DEBRIS LOOP FROM NEAREST ACTIVE 1-1/2 INCH OR LESS ACCESSIBLE COLD WATER PIPING ADDITTE TO VALVE IN CEILING SPACE. PROVIDE 1/2 INCH COPPER PIPING FROM VALVE DOWN AND CONNECT TO FLOOR DRAIN OR FLOOR SINK. INSTALL PIPING AND VALVE PER MANUFACTURERS INSTALLATION INSTRUCTIONS.
- F. PROVIDE NATURAL GAS SOLENOID VALVE, SV-1. ELECTRICAL CONTRACTOR TO WIRE.
- G. PROVIDE NEUTRALIZATION TANK BELOW SINK SIMILAR TO IPEX MODEL NEUTRATANK 5 GALLON RECTANGULAR TANK WITH LIMESTONES.
- H. PROVIDE SOLIDS INTERCEPTOR SIMILAR TO J.R. SMITH 8730 WITH 1-1/2" CONNECTION SUSPENDED BENEATH ART ROOM SINK.
- I. PROVIDE ONE PACKAGE OF 3-PACK REPLACEMENT FILTERS SIMILAR TO ELKAY MODEL 51300C\_3PK (THREE) TO OWNER FOR FUTURE USE.
- J. PLUMBING CONTRACTOR TO EXCAVATE AND PREPARE AREA, MIX AND APPLY FORM RELEASE PRODUCT, ASSEMBLE RAILS, LEGS, FORMS, CLAMPS AND PLACE COMPLETED DRAINMENTS AT REQUIRED LOCATIONS. PLUMBING CONTRACTOR TO PROVIDE CONCRETE ANCHORING SLAB WALL TO WALL AND END TO END IN BOTTOM OF EXCAVATION. TRENCH DRAIN U-LESS WITH MINIMUM OF 2 INCHES OF CONCRETE. COORDINATE FINISHED FLOOR CONCRETE POUR. PLUMBING CONTRACTOR TO REMOVE ALL MATERIAL FROM TRENCH DRAINS AFTER FINISHED FLOOR CONCRETE HAS DRIED AND INSTALL ALL GRATES. ALL TRENCH DRAIN WORK SHALL BE INSTALLED PER TRENCH DRAIN MANUFACTURERS INSTALLATION INSTRUCTIONS.

PLUMBING FIXTURE ELECTRICAL REQUIREMENTS SCHEDULE												
NO.	TYPE	ELECTRICAL COMPONENT	VOLTS	PHASE	FULL LOAD AMPS	MINIMUM CIRCUIT AMPACITY	MAXIMUM OVER-CURRENT PROTECTION	POWER	RPM	GPM	HEAD FEET	REMARKS
WC-1	WATER CLOSET, ADA, WALL MOUNT WATER CLOSET, WALL MOUNT	FLUSHOMETER TRANSFORMER	120 OR 240	SINGLE	50 VA	NA	NA	NA	NA	NA	NA	NOTE A, D.
LAV-1	LAVATORY, ADA, WALL MOUNT	FAUCET TRANSFORMER	120	SINGLE	2.0	300 MA	NA	NA	NA	NA	NA	NOTE B, D.
EW-1	ELECTRIC WATER COOLER, TWO STATION WITH SINGLE STATION BOTTLE FILLER, ADA, WALL MOUNT	OPERATING SYSTEM	115	SINGLE	5.0	NA	NA	370 WATTS	NA	NA	NA	NOTE D, E.

- NOTES:
- A. PROVIDE PER MANUFACTURE, SOLENOID OPERATOR - 24V AC, 60 HZ, TRANSFORMER - SIMILAR TO SLOAN VALVE MODEL EL-154 (120 V), (ONE TRANSFORMER SERVES MAXIMUM 10 WATER CLOSETS/URINALS). TRANSFORMER INSTALLATION AND POWER BY ELECTRICAL CONTRACTOR, LOW VOLTAGE CONTROL WIRING BY PLUMBING CONTRACTOR.
- B. PROVIDE TRANSFORMER - SIMILAR TO CHICAGO FAUCET MODEL 243.260.00.1 (HARD WIRED), (ONE TRANSFORMER SERVES MAXIMUM OF 8 FAUCETS). TRANSFORMER INSTALLATION AND POWER BY ELECTRICAL CONTRACTOR, LOW VOLTAGE CONTROL WIRING BY PLUMBING CONTRACTOR.
- C. COORDINATE WIRING OF PUMP THRU AQUASTAT WITH ELECTRICAL CONTRACTOR.
- D. COORDINATE POWER WITH ELECTRICAL CONTRACTOR.
- E. ELECTRICAL CONTRACTOR TO PROVIDE RECEPTACLE. COORDINATE LOCATION WITH ELECTRICAL CONTRACTOR.


FIXTURE PIPE SIZES SCHEDULE				
	COLD WATER	HOT WATER	SANITARY	VENT
WC	1"	.....	4"	2"
LAV	1/2"	1/2"	1-1/2"	1-1/2"
SK	1/2"	1/2"	1-1/2"	1-1/2"
SH	1/2"	1/2"	3"	2"
EW	1/2"	.....	1-1/2"	1-1/2"

- NOTES:
- A. IF FIXTURE NUMBER IS NOT SPECIFICALLY STATED, PIPE SIZES PERTAIN TO ALL LISTINGS OF FIXTURE TYPE.

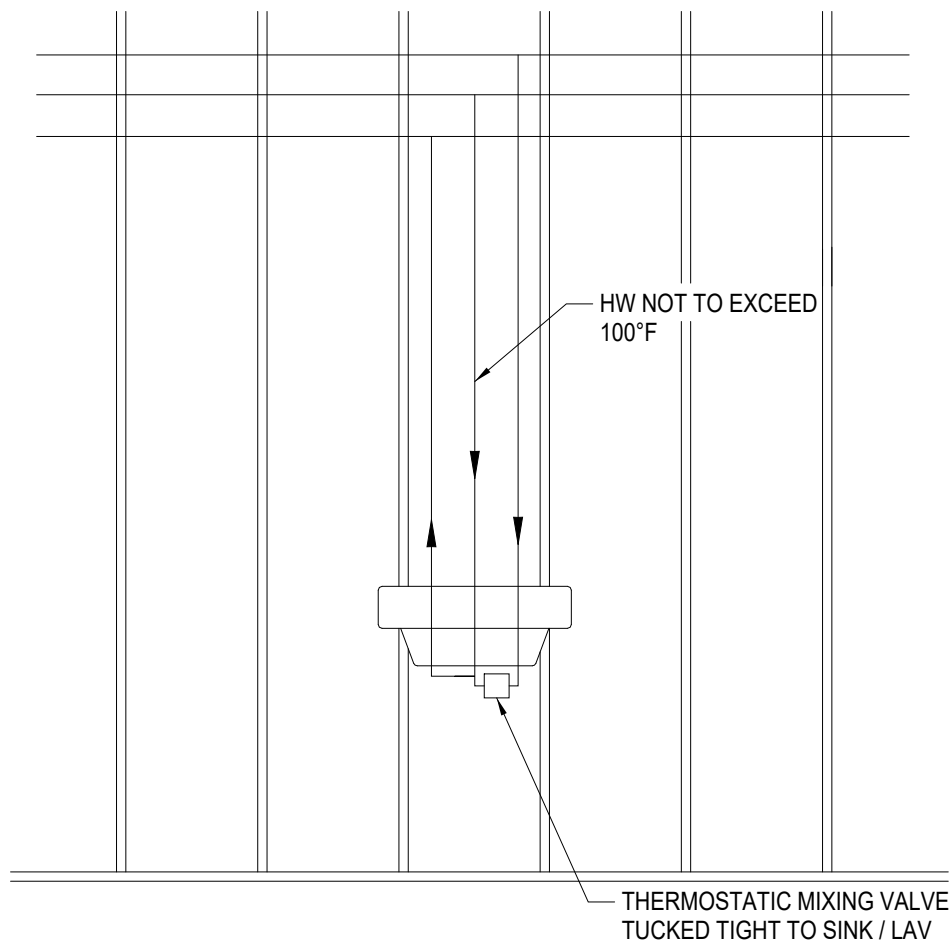


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FIXTURE DOMESTIC CONNECTION DETAIL

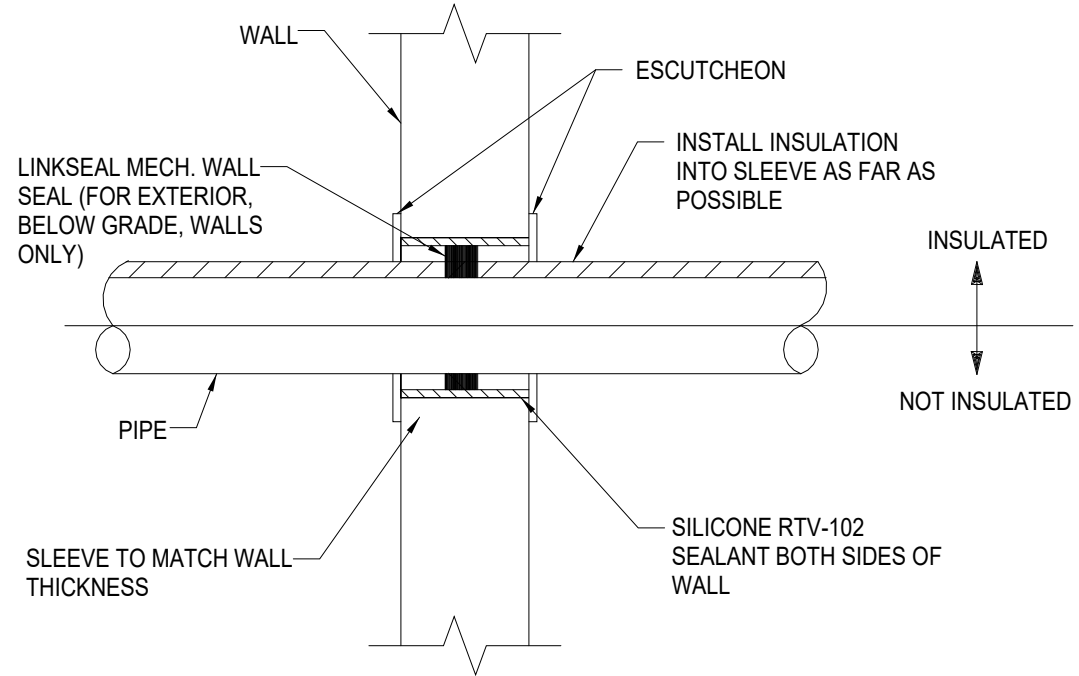


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TYPICAL PIPE THROUGH WALL DETAIL




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TYPICAL PIPE THROUGH FLOOR/SLAB DETAIL

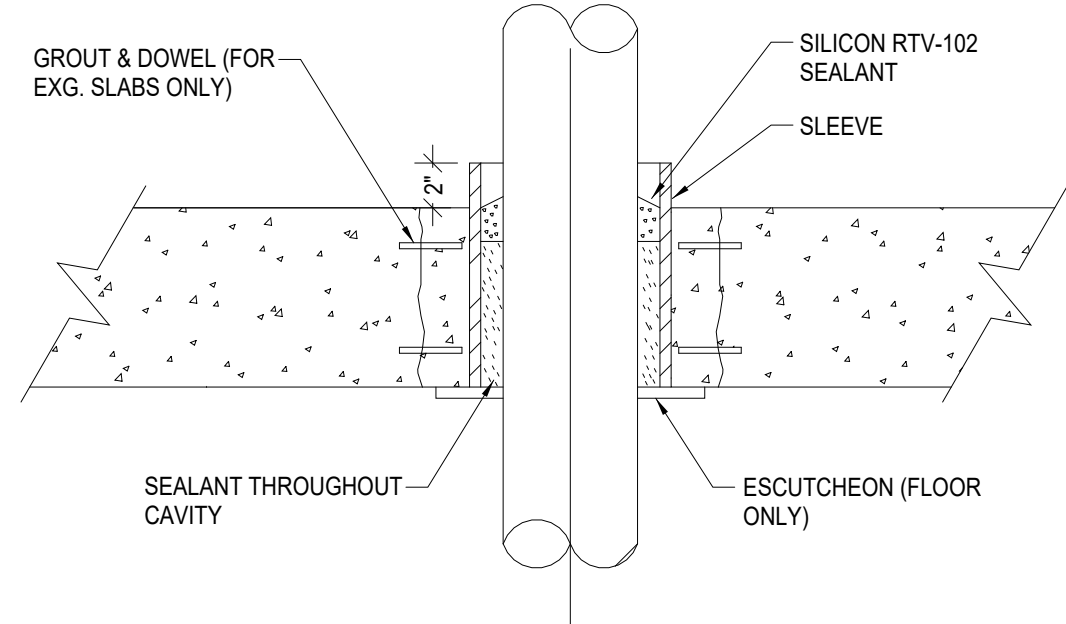


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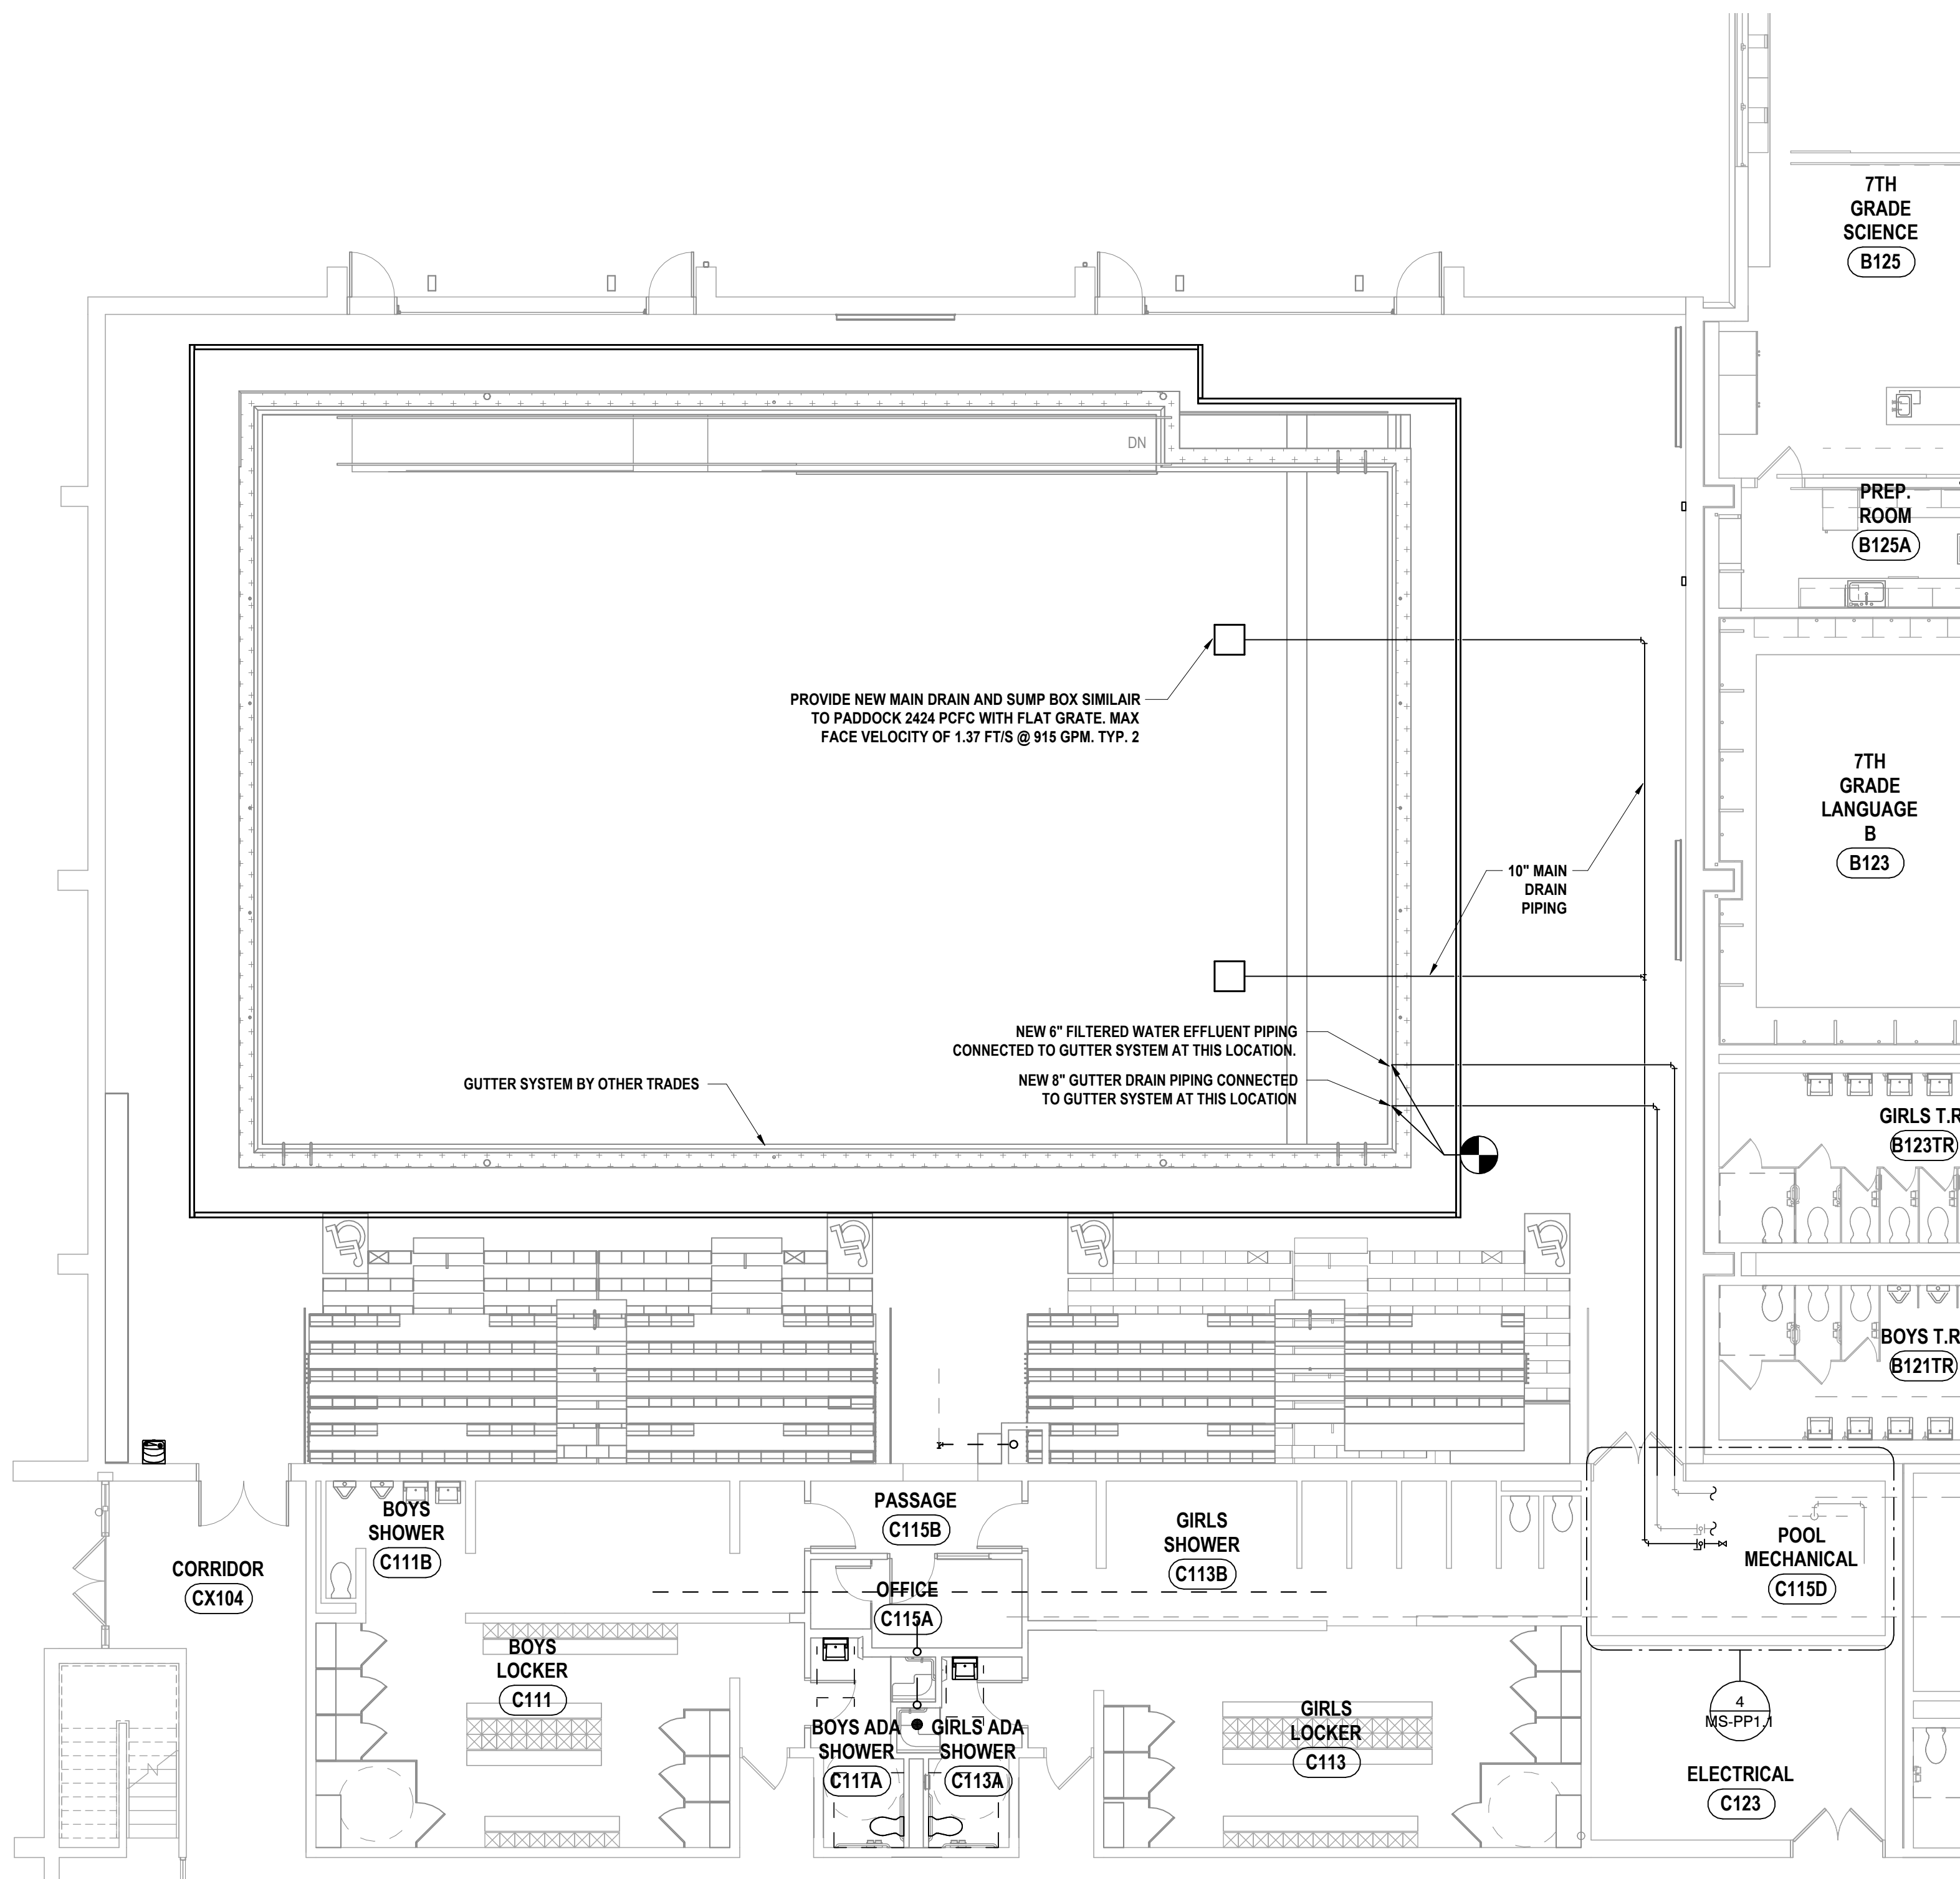
TYPICAL PIPE HANGER AND SHIELD DETAIL

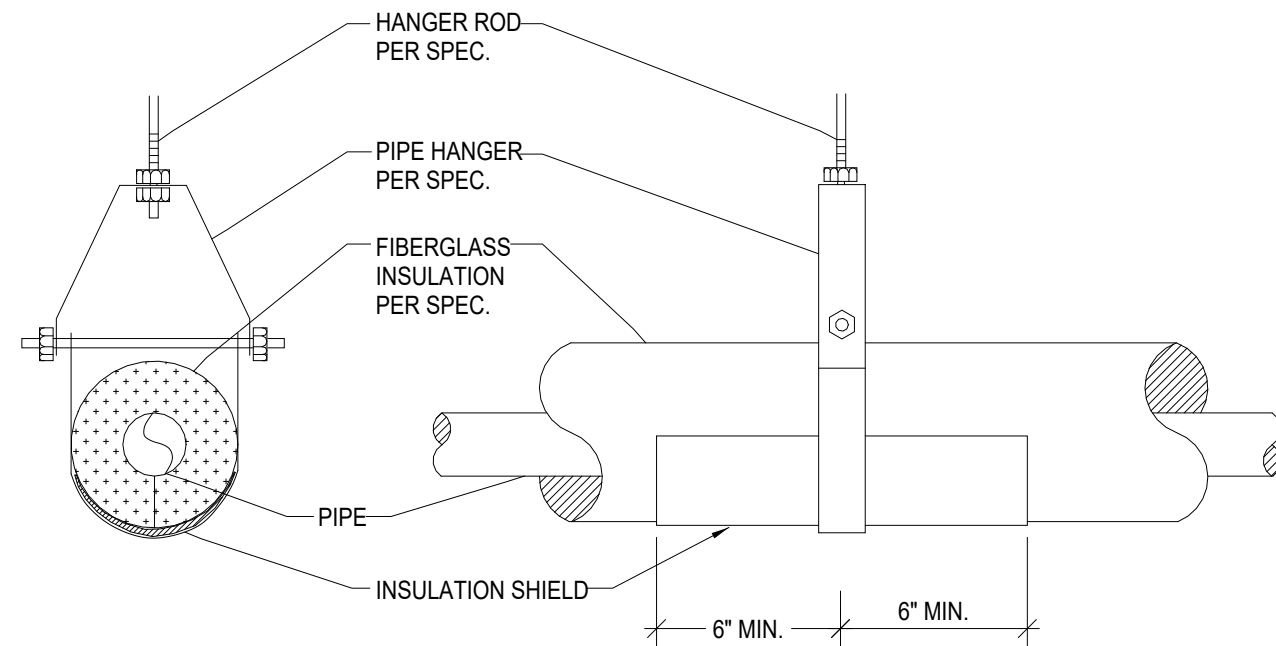


4 FIRST FLOOR NEW WORK PLAN - POOL FILTER ROOM  
1/4" = 1'-0"

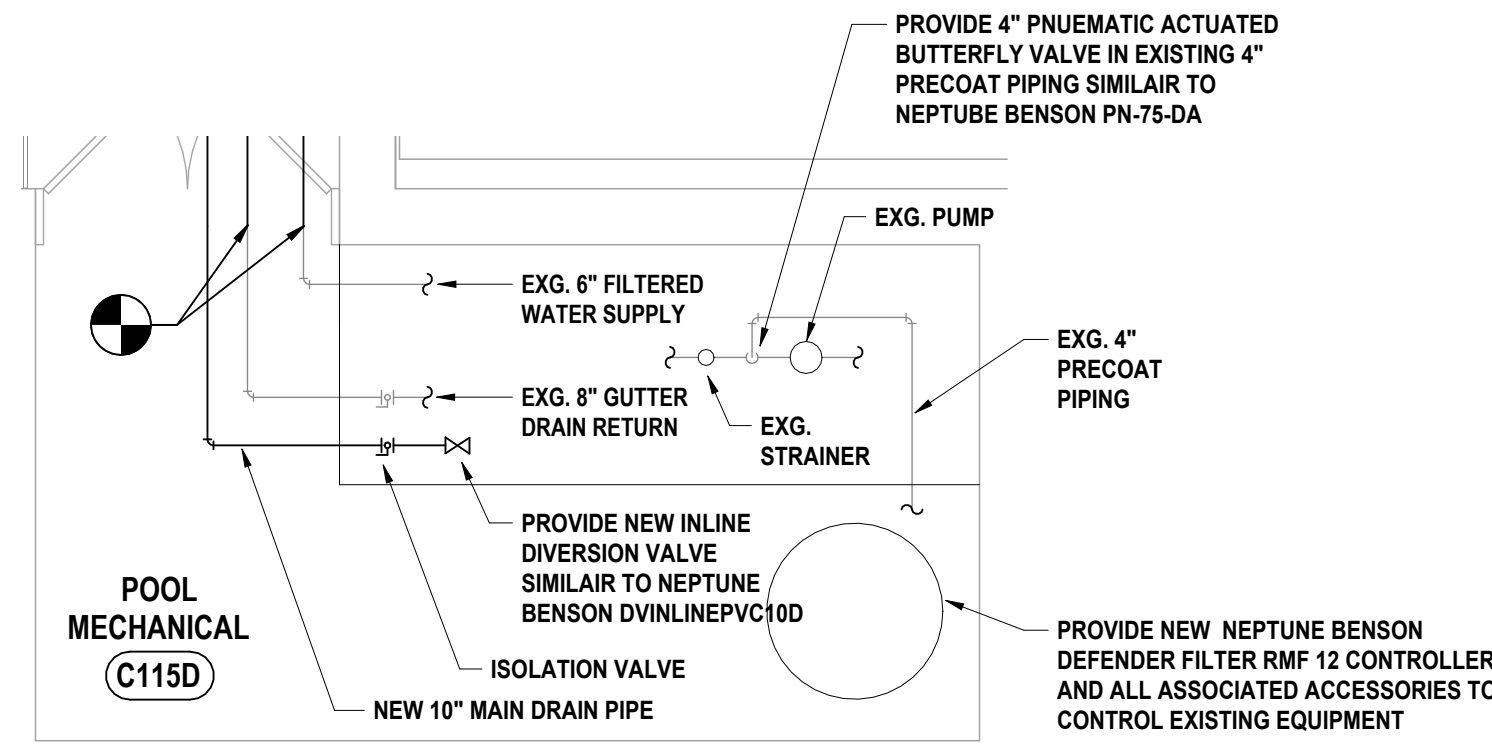

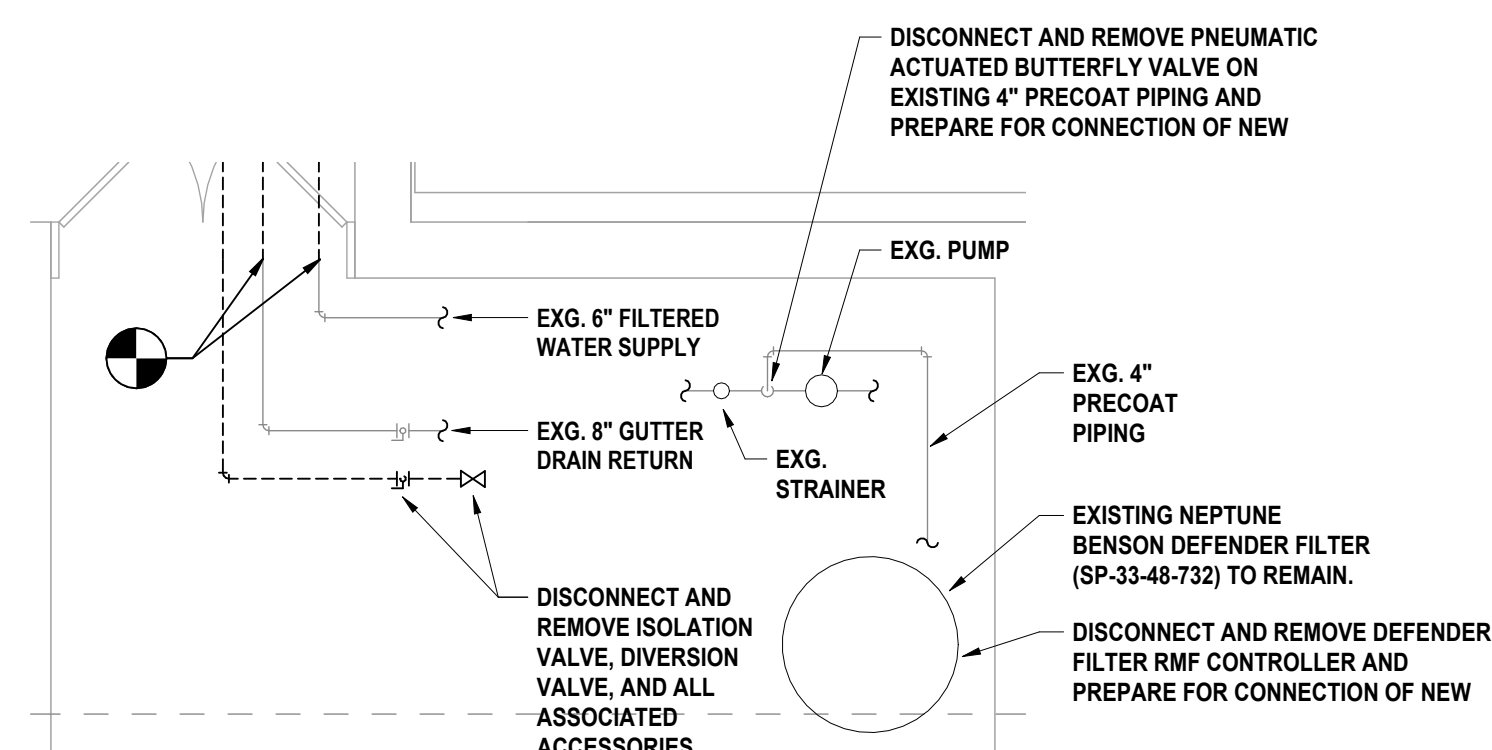
3 FIRST FLOOR DEMOLITION PLAN - POOL FILTER ROOM  
1/4" = 1'-0"



2 FIRST FLOOR NEW WORK PLAN - POOL  
1/8" = 1'-0"

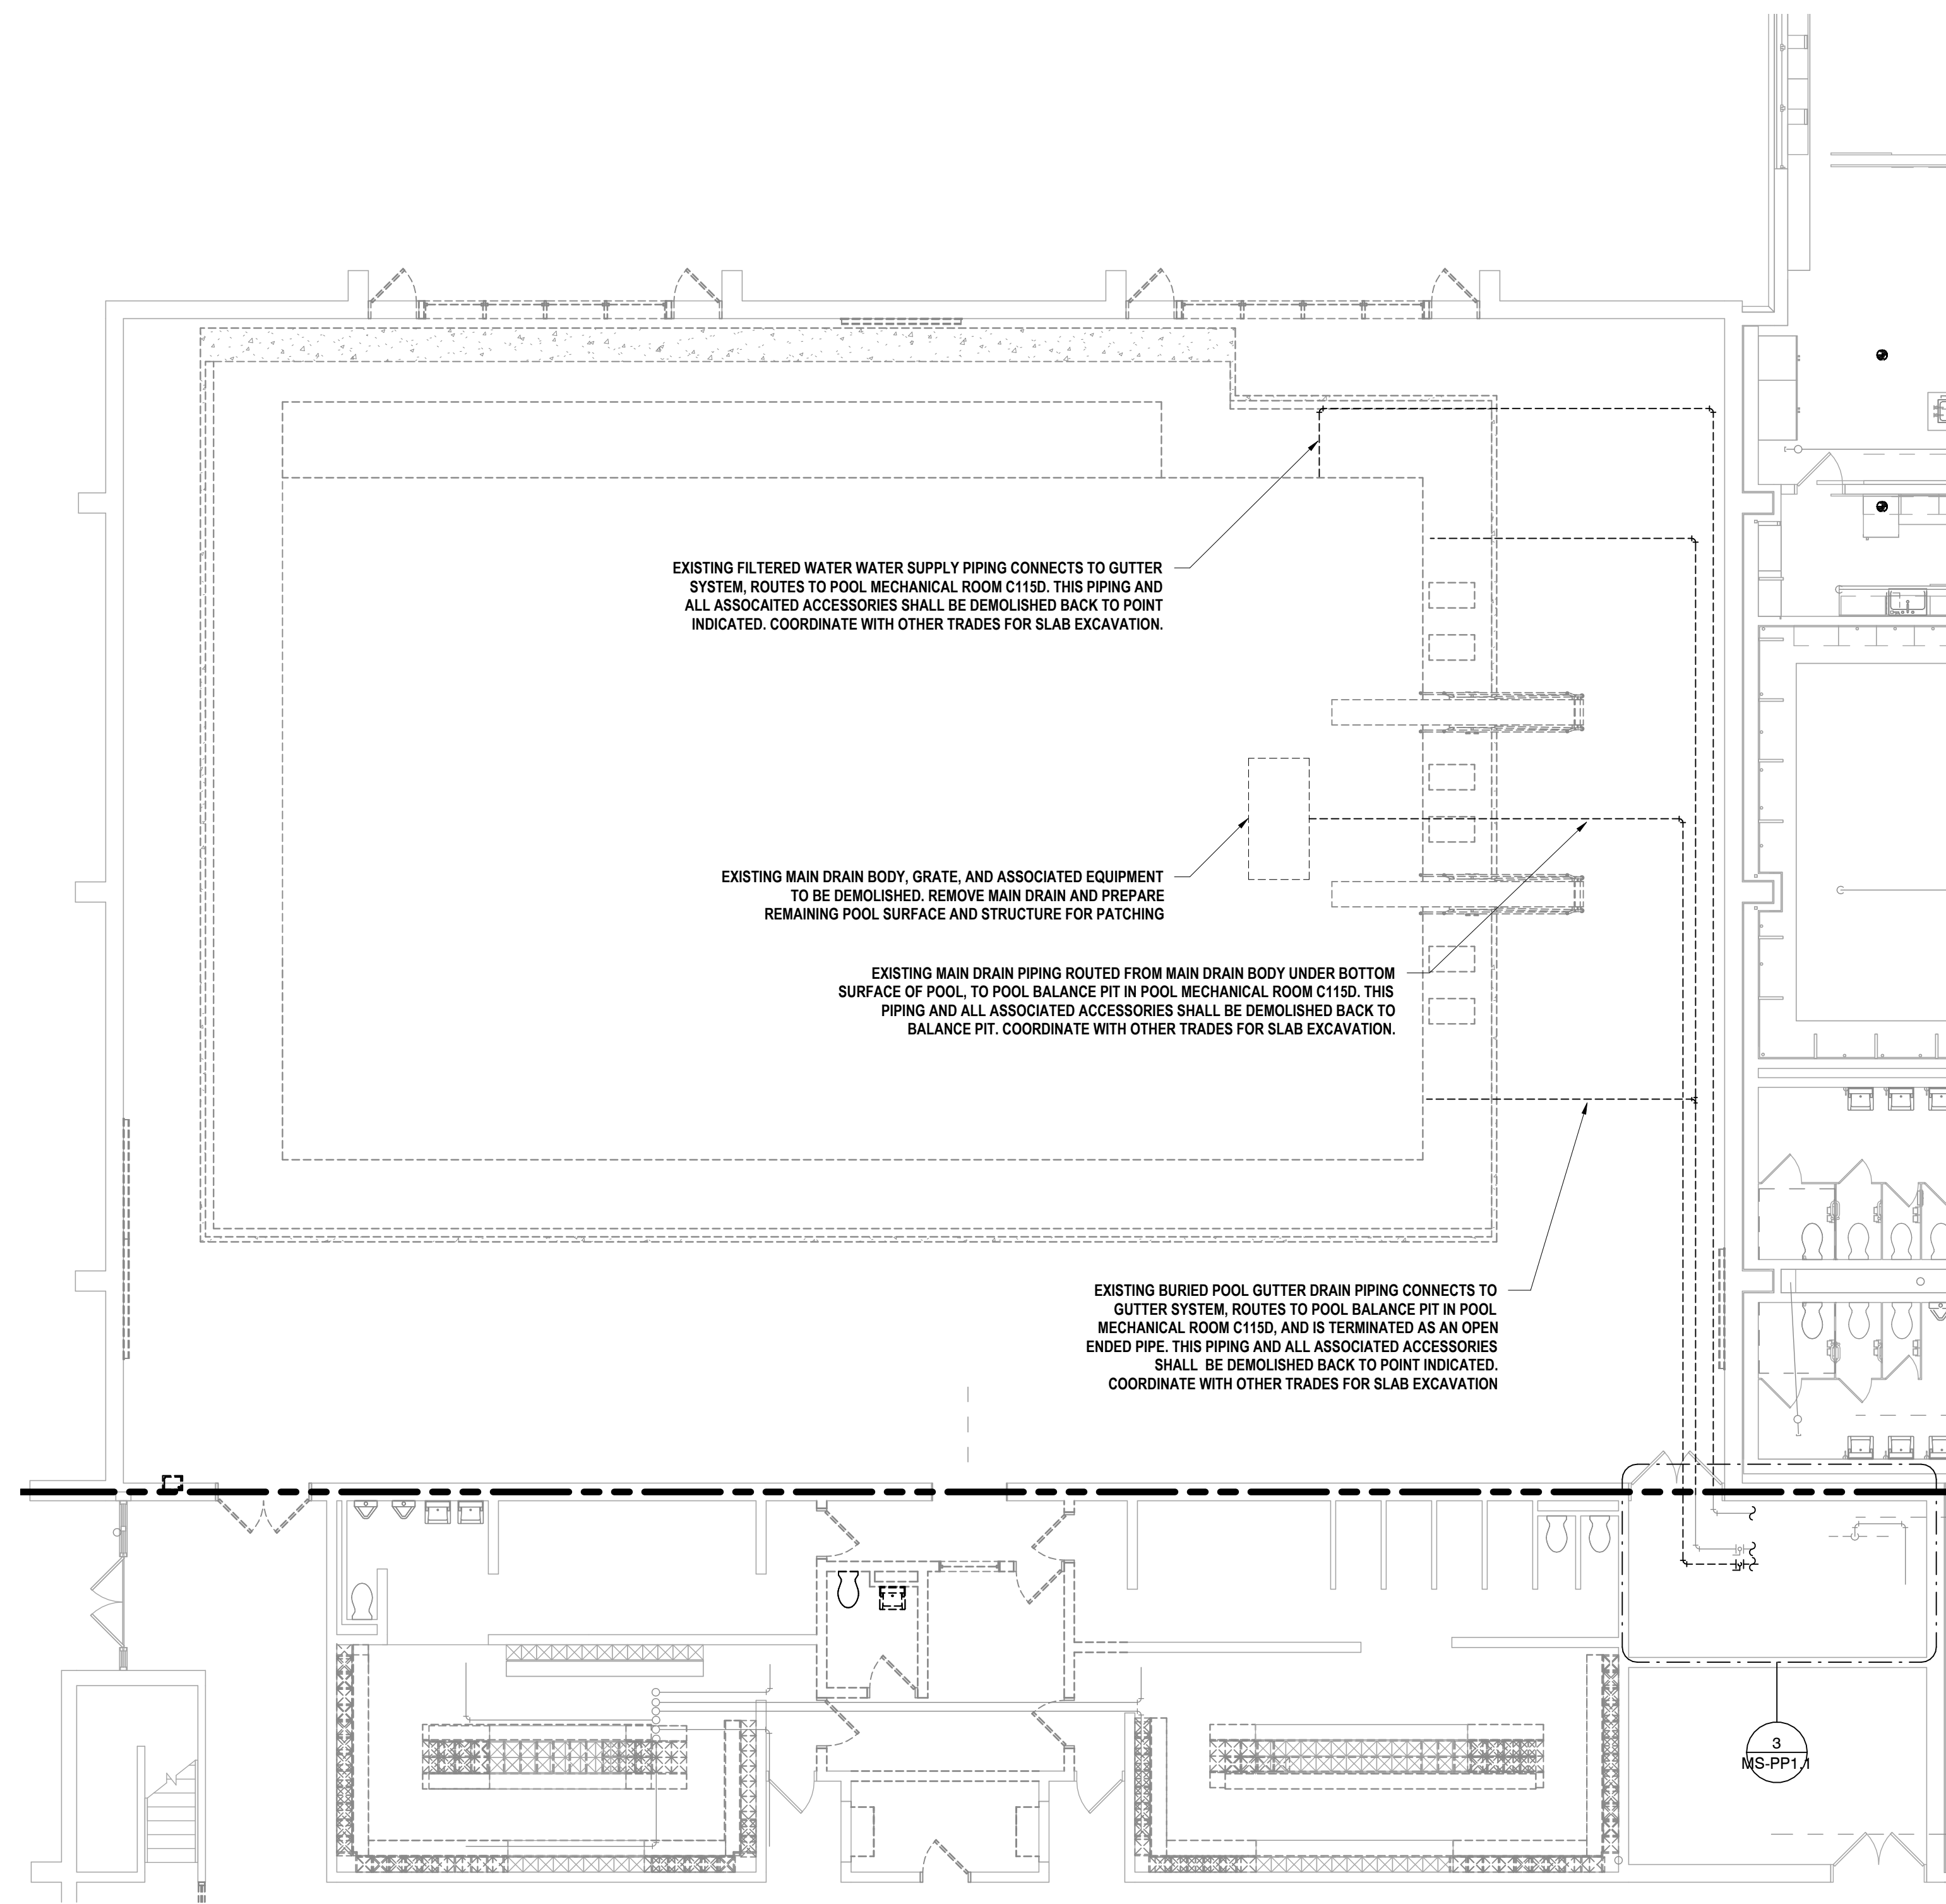

1 FIRST FLOOR DEMOLITION PLAN - POOL  
1/8" = 1'-0"

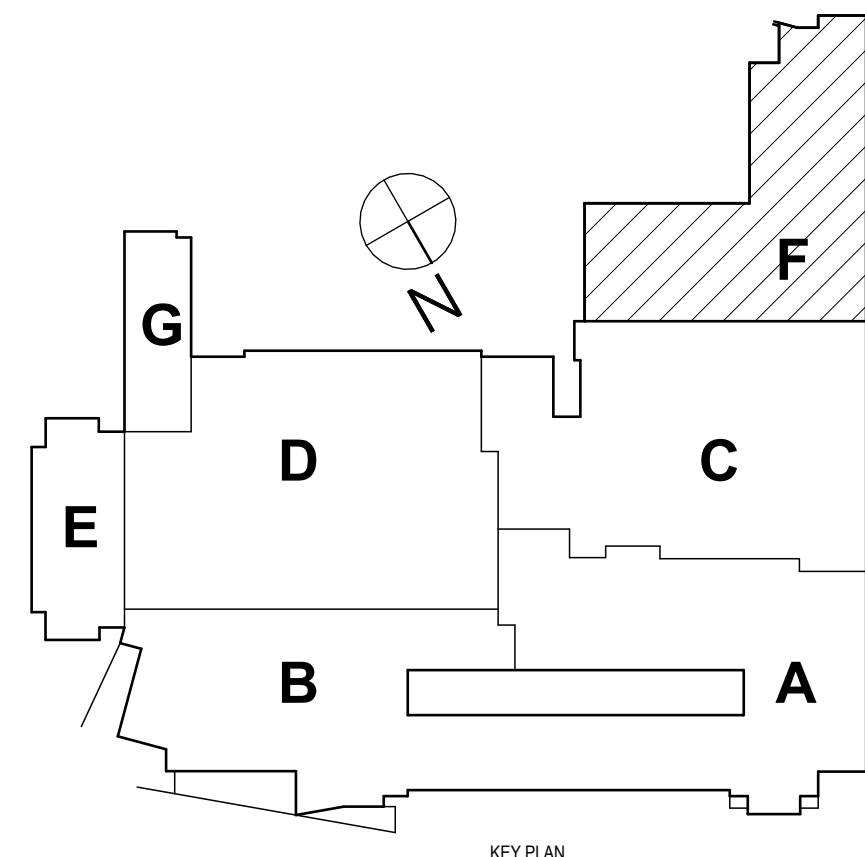

SED #: 571630-01-5024-044 - MIDDLE SCHOOL

POOL PIPING PLANS

2025 MIDDLE SCHOOL PHASE III ALTERATIONS PROJECT

CORNING-PAINTED POST ASD

35 VICTORY HIGHWAY, PAINTED POST, NY 14870

MS-PP1.1  
PROJECT NO: 2649-133

HUNT ENGINEERS | ARCHITECTS | SURVEYORS

HORSEHEADS, NY 807-265-1000 ROCHESTER, NY 585-537-7849 TOWNHALL, PA 670-265-4668  
BINGHAMTON, NY 607-798-8881 ALBANY, NY 607-798-8881  
WWW.HUNTEAS.COM

NY CERTIFICATE NO. 0019220 PA CERTIFICATE NO. TSC220313464-1

DESCRIPTION OF REVISION:  
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# DATE:  
1 10/20/2025

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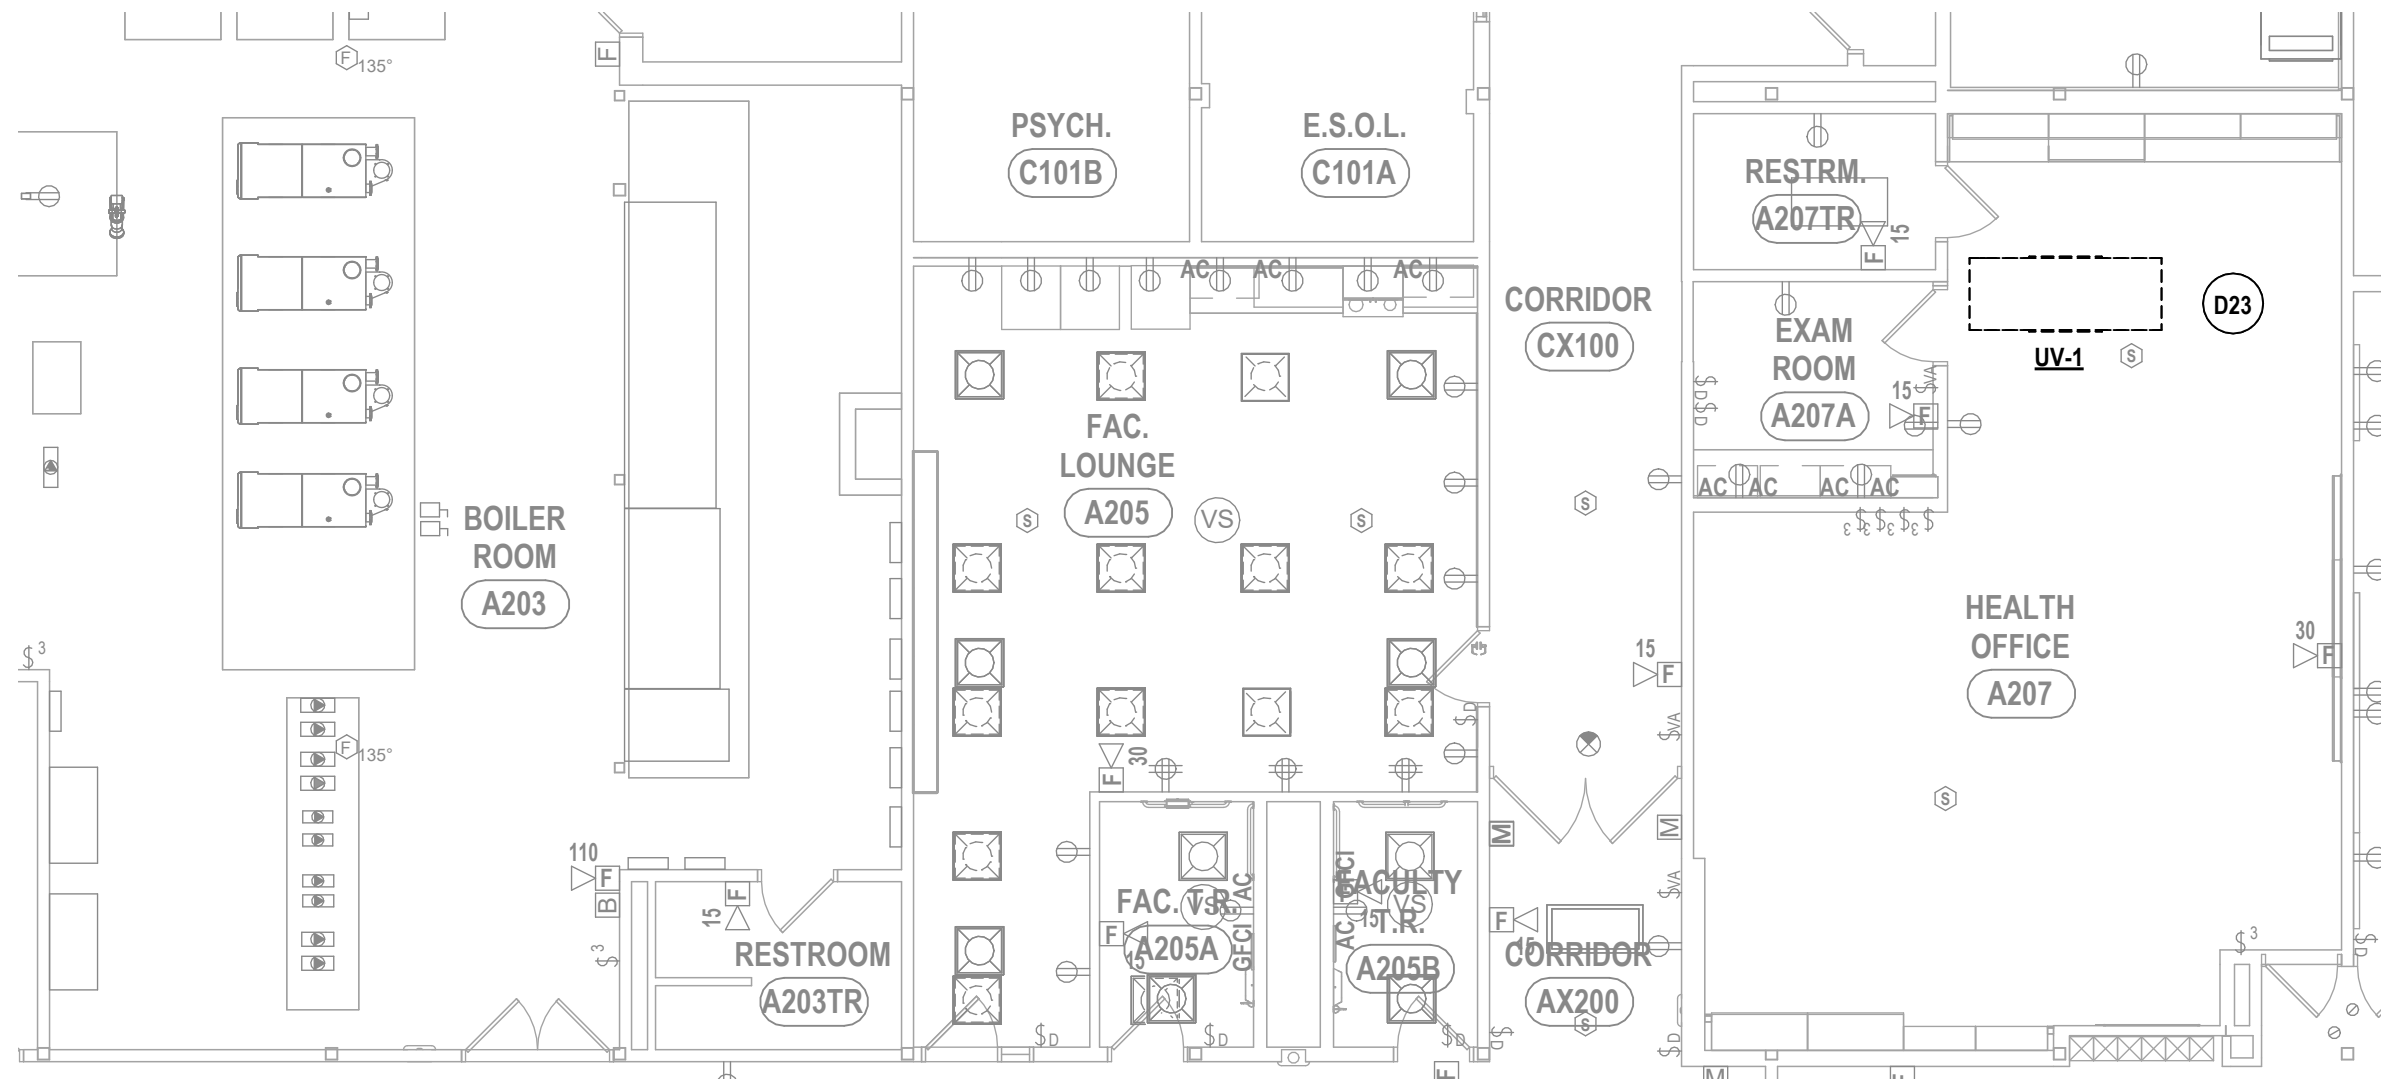
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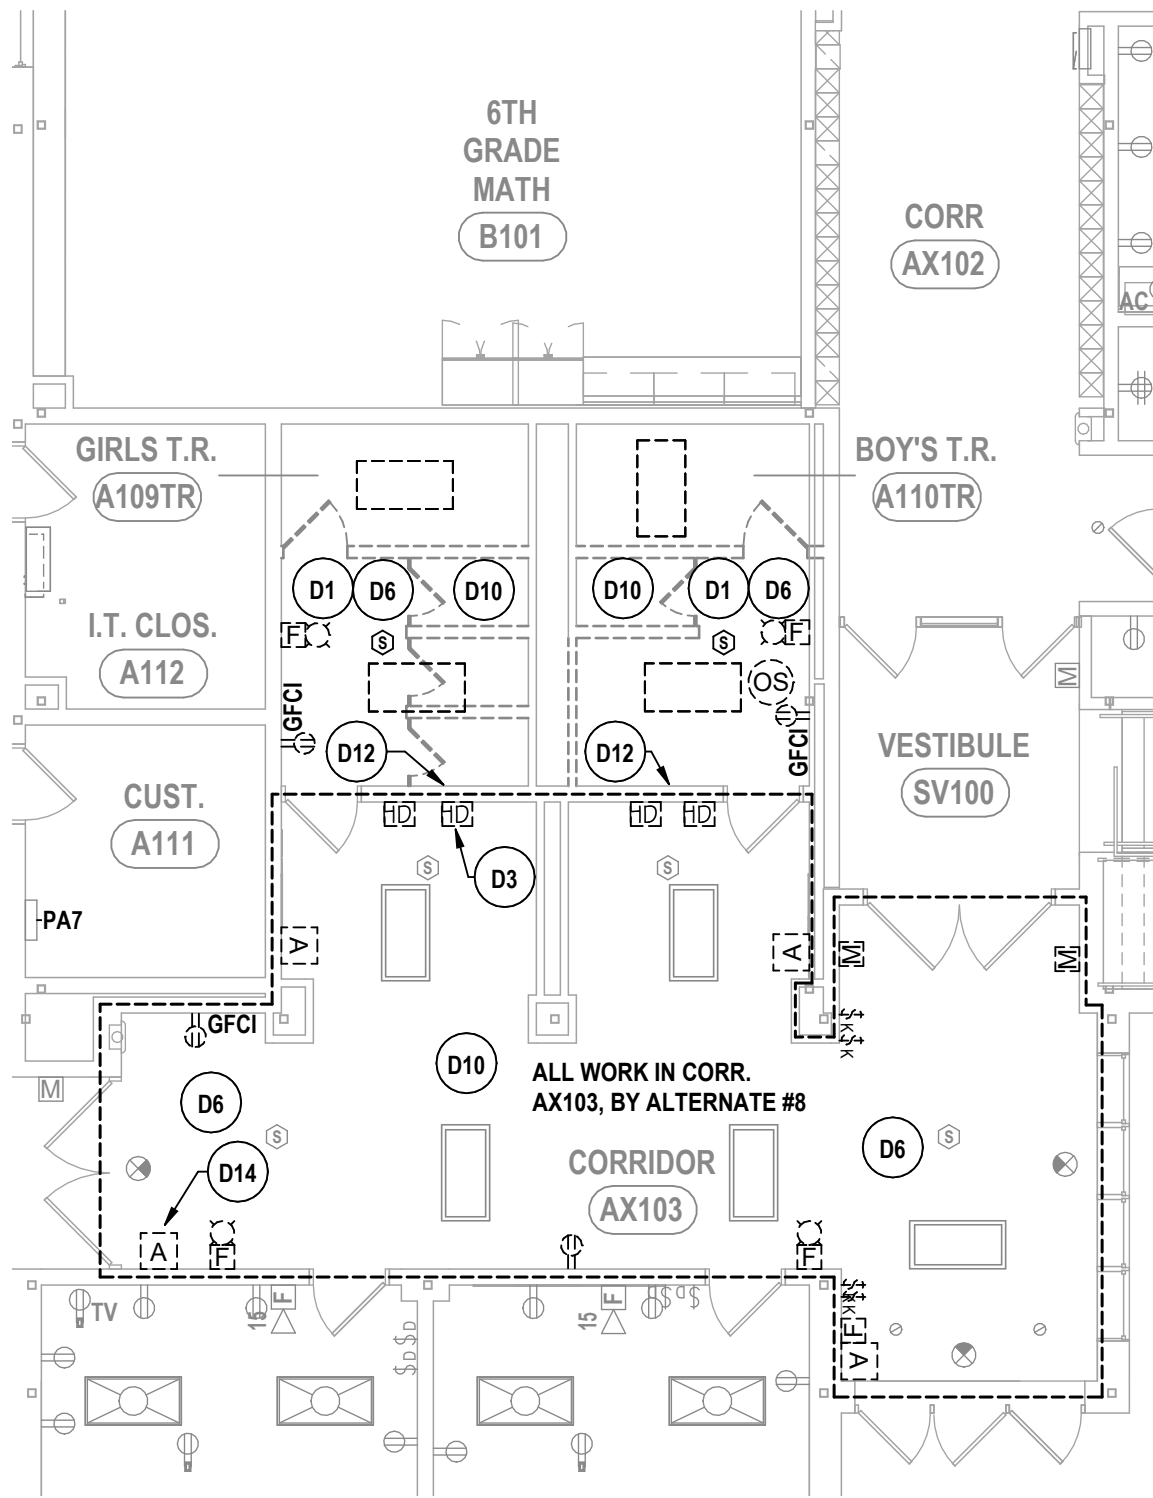
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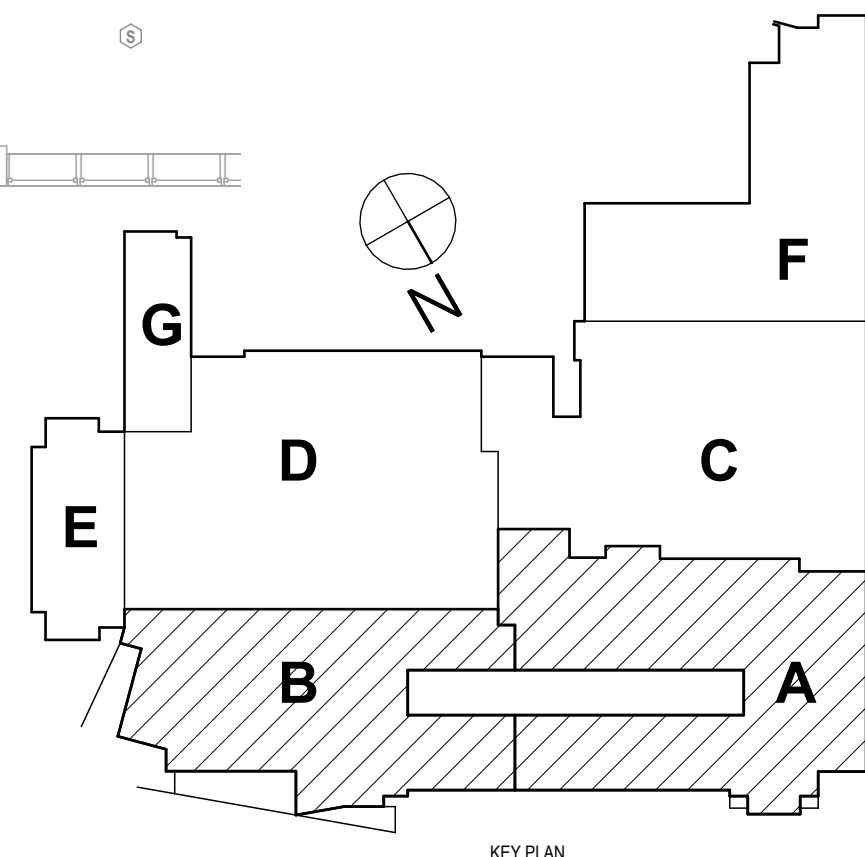
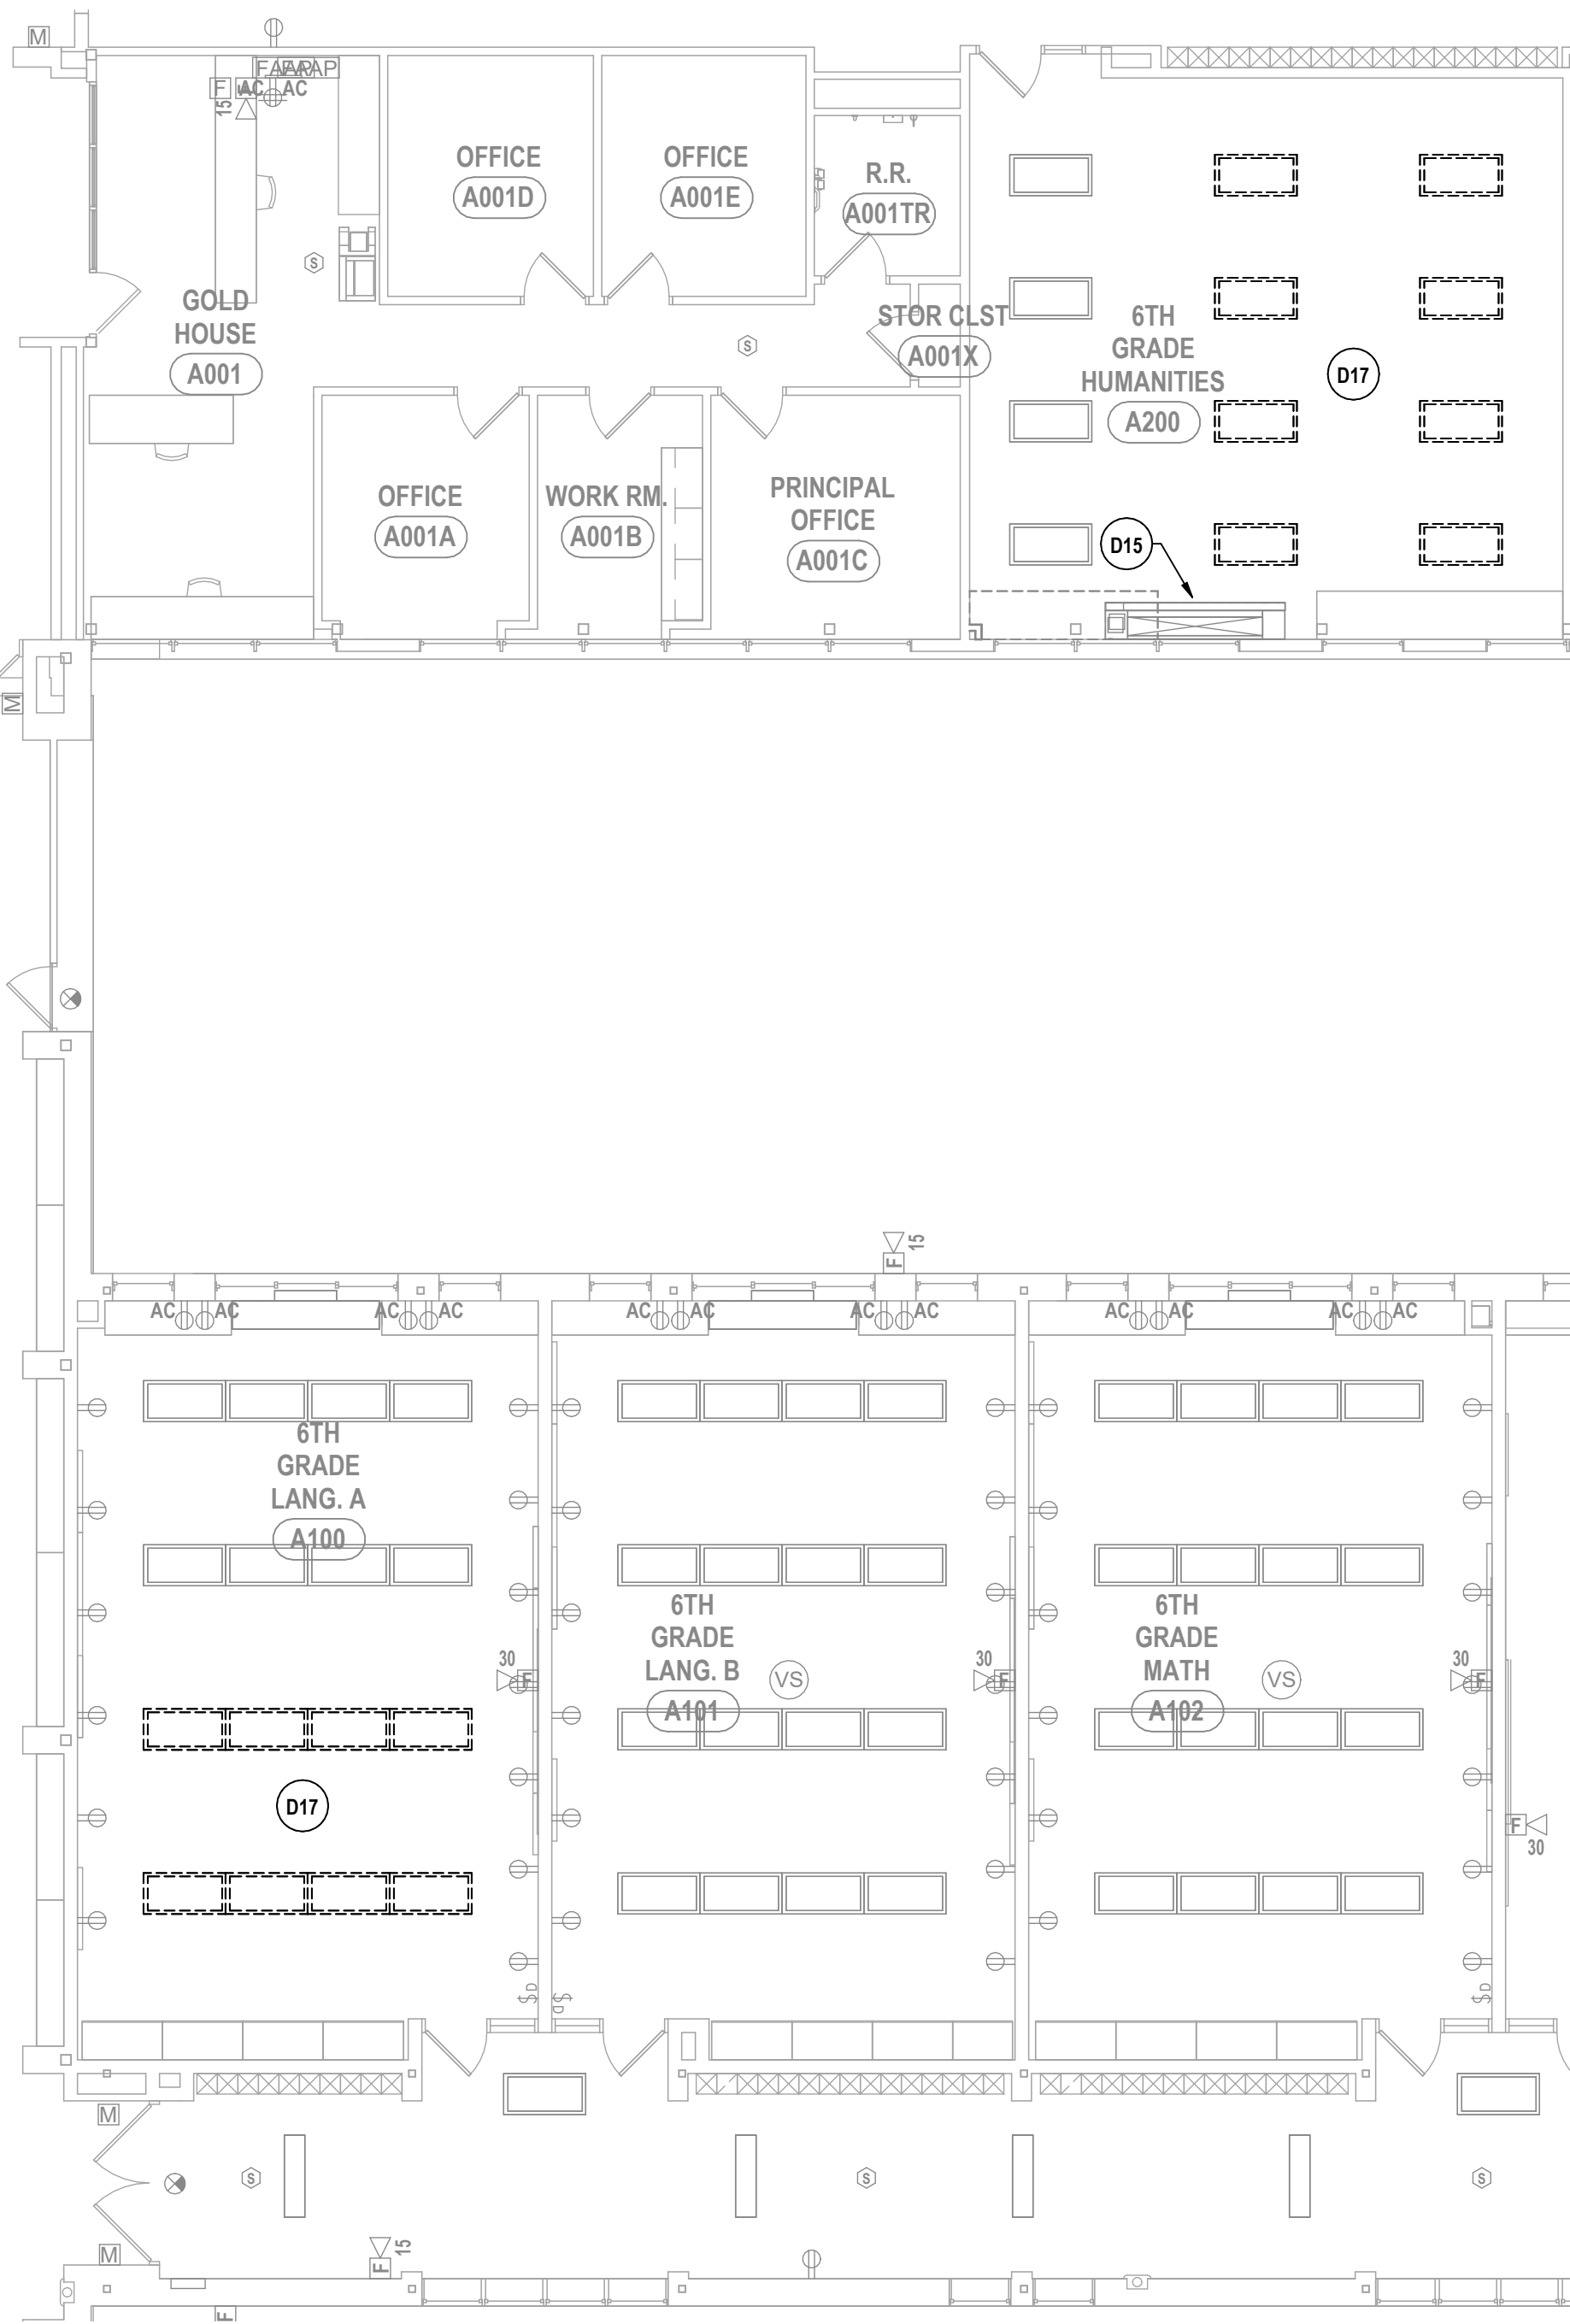
3 FIRST FLOOR ELECTRICAL DEMOLITION PLAN - PARTIAL AREA A  
1/8" = 1'-0"



1 FIRST FLOOR ELECTRICAL DEMOLITION PLAN - PARTIAL AREA A  
1/8" = 1'-0"



2 FIRST FLOOR ELECTRICAL DEMOLITION PLAN - AREA B  
1/8" = 1'-0"



## GENERAL NOTES - ELECTRICAL

- CONTRACTOR IS RESPONSIBLE FOR ALL WORK ON THIS DRAWING UNLESS CLEARLY INDICATED TO BE PART OF ANOTHER PRIME CONTRACT.
- CONTRACTOR SHALL VERIFY EXISTING CONDITIONS PRIOR TO CONSTRUCTION AND INSTALLATION AND NOTIFY ENGINEER/ARCHITECT OF CONFLICTS AND CONDITIONS WHICH INTERFERE WITH INSTALLATION AS SET FORTH IN CONTRACT DOCUMENTS.
- CONTRACTOR IS RESPONSIBLE FOR ALL NEW WALL OPENINGS, EXCAVATIONS, AND PENETRATIONS, UNLESS SPECIFICALLY NOTED. UPON COMPLETION, ALL PENETRATIONS TO BE SEALED TO MAINTAIN FIRE RATING AS SPECIFIED ON ARCHITECTURAL DRAWINGS.
- CONTRACTOR IS RESPONSIBLE FOR ALL CUTTING AND PATCHING UNLESS CLEARLY INDICATED AS PART OF ANOTHER PRIME CONTRACT.
- MINIMUM CONDUIT SIZE USED ON THIS PROJECT SHALL BE 3/4" UNLESS OTHERWISE NOTED.
- MINIMUM WIRE SIZE USED ON THIS PROJECT SHALL BE #12 THINWALL UNLESS OTHERWISE NOTED.
- ALL CABLING INSTALLATIONS AND TERMINATIONS TO ADHERE TO CURRENT NEC CODES AND RELATED ANS/IEEE STANDARDS.
- DURING DEMOLITION OF EXISTING CABLING, ANY DAMAGE TO FUNCTIONING CABLING SYSTEM IS THE RESPONSIBILITY OF AND WILL BE REPAIRED BY THE CONTRACTOR.
- CONTRACTOR SHALL BE AWARE OF THE PRESENCE OF EXISTING ASBESTOS CONTAINING MATERIAL SCHEDULED TO REMAIN IN PLACE WITHIN THE PROJECT SCOPE. ANY WORK REQUIRED THAT HAS THE POTENTIAL TO DISTURB HAZARDOUS MATERIALS SHALL BE COORDINATED DIRECTLY WITH THE OWNER.
- ALL ELECTRICAL DEVICES, MATERIALS, AND PACKAGED EQUIPMENT SHALL BE LISTED AND LABELED BY UNDERWRITERS LABORATORIES (UL).
- NEW CIRCUIT BREAKER(S) THAT ARE TO BE ADDED TO EXISTING PANELBOARD(S) SHALL BE LISTED, LABELED FOR USE WITH THE EXISTING PANELBOARD(S).
- THE SHORT-CIRCUIT RATINGS OF ALL PROTECTIVE DEVICES SHALL BE EQUAL TO OR EXCEED THE AVAILABLE SHORT-CIRCUIT CURRENT.
- ALL WORK TO CONFORM TO CURRENT NEC AND ALL APPLICABLE CODES.
- CONTRACTOR TO NOTIFY ELECTRICAL ENGINEER FOR INSPECTION OF ALL INSTALLATIONS BEFORE BEING BURIED OR COVERED.
- ALL ELECTRICAL DEVICES AND EQUIPMENT SCHEDULED FOR REMOVAL ARE CONSIDERED PROPERTY OF THE OWNER. ELECTRICAL DEVICES AND EQUIPMENT SHALL BE PLACED IN AN AREA DESIGNATED BY THE OWNER. ANY DEVICE OR EQUIPMENT THE OWNER WISHES NOT TO KEEP SHALL BE DISPOSED OF BY THE CONTRACTOR.
- CONTRACTOR IS RESPONSIBLE FOR DISCONNECTING POWER TO ANY EQUIPMENT SCHEDULED TO BE REMOVED OR REPLACED. COORDINATE WORK WITH OTHER PRIME CONTRACTORS AND DRAWINGS.
- CONTRACTOR IS RESPONSIBLE FOR PROVIDING POWER TO ANY EQUIPMENT SCHEDULED TO BE NEWLY INSTALLED. COORDINATE WORK WITH OTHER PRIME CONTRACTORS AND DRAWINGS.
- CONTRACTOR IS RESPONSIBLE FOR COORDINATING ALL CONDUIT LOCATIONS IN FIREWALLS. A MAXIMUM OF ONE PIECE OF CONDUIT IS ALLOWED IN A NON-REINFORCED CORE. NO CONDUIT SHALL BE PLACED IN A VERTICALLY REINFORCED CORE IN A FIREWALL.
- ALL NEW ELECTRICAL DEVICES SUCH AS, BUT NOT LIMITED TO, FIRE ALARM DEVICES, SMOKE DETECTORS, LIGHT FIXTURES, EXIT SIGNS, OCCUPANCY/VACANCY SENSORS, AND NON-KEYED SWITCHES ARE REQUIRED TO HAVE IMPACT PROTECTION THROUGH MEANS OF IMPACT RESISTANT COVERS, WIRE GUARDS, OR LOCKABLE ENCLOSURES IN LOCKER ROOMS, GYMNASIUMS, WEIGHT ROOMS, FITNESS CENTERS, AND WRESTLING ROOMS.

## DEMOLITION NOTES - ELECTRICAL

- EXISTING CEILING IN THIS SPACE SHALL BE REPLACED WITH NEW. DISCONNECT & APPROPRIATELY STORE ALL EXISTING CEILING-MOUNTED ELECTRICAL DEVICES, FIXTURES, AND EQUIPMENT FOR REUSE / REINSTALLATION IF ENTIRETY OF GRID IS BEING REPLACED NOT IN-KIND. IDENTIFY & SECURE BRANCH CIRCUITRY FOR REUSE. IF GRID/TILES ARE REPLACED IN-KIND MOUNT FIXTURES TEMPORARILY ABOVE CEILING TO NOT IMPERE WORKS IN OTHER TRADES.
- TOILET ROOM SHALL BE COMPLETELY RENOVATED. DISCONNECT & REMOVE ALL ELECTRICAL DEVICES, FIXTURES, AND EQUIPMENT FROM THE EXTENTS OF THE SPACE. LEAVE EXISTING LIGHTING HOMERUNS IN SPACE TO RECONNECT FIXTURES TOO. ALL ASSOCIATED ENLIGHTENED DRIVERS AND SENSORS TO BE SECURED FOR RE-USE.
- DISCONNECT AND REMOVE EXISTING (4) HAND DRYERS. IDENTIFY AND SECURE EXISTING BRANCH CIRCUITS FOR REUSE. HAND DRYERS ARE CIRCUITED TO PANEL PA7. SECURE HAND DRYERS FOR RE-INSTALLATION ONCE WORK BY OTHER TRADES HAS BEEN COMPLETED.
- ALL WORK BY ALTERNATE 2. BLEACHERS SHALL BE REPLACED WITH NEW. DISCONNECT AND REMOVE ALL ASSOCIATED CIRCUITRY AND DEVICES BACK TO SOURCE.
- DISCONNECT AND REMOVE EXISTING SCOREBOARD AND SHOT CLOCK. EXISTING RECEPTACLE POWERING EQUIPMENT TO REMAIN. ONCE REMOVED, SECURE AND TURN OVER EQUIPMENT TO OWNER FOR RE-USE.
- WALL TILING TO BE REPLACED. DISCONNECT AND REMOVE WALL MOUNTED ELECTRICAL DEVICES AND EQUIPMENT WITHIN THE EXTENTS OF THE CORRIDOR. RECEPTACLES AND SWITCHES ARE TO BE REPLACED WITH NEW DEVICES AND COVER PLATES. IDENTIFY AND SECURE CIRCUITRY FOR REUSE.
- DISCONNECT AND REMOVE EXISTING LIGHT FIXTURES IN THIS SPACE. REMOVE ALL RELATED CIRCUITRY BACK TO SOURCE INCLUDING ALL WIRE, BOXES, RACEWAYS, CONDUIT, HANGERS, AND SUPPORTS. SECURE ALL ASSOCIATED ENLIGHTENED CONTROL DEVICES IN THIS SPACE FOR RE-USE. TURN OVER FIXTURES TO OWNER FOR ATTIC STOCK.
- DRINKING FOUNTAIN IN THIS LOCATION TO BE REMOVED. REMOVE CIRCUITRY BACK TO SOURCE.
- DRINKING FOUNTAIN IN THIS LOCATION TO BE REPLACED. SECURE CIRCUITRY FOR RE-USE.
- DISCONNECT AND REMOVE FIRE ALARM DEVICES IN THIS AREA AS SHOWN. TURN OVER TO OWNER FOR ATTIC STOCK. DEVICE TYPES TO BE UPDATED. REFER TO SPECIFICATION 28 46 21 16 FOR MORE INFORMATION.
- DISCONNECT AND REMOVE ALL ASSOCIATED CIRCUITRY AND DEVICES PERTAINING TO THE OUTDOOR DUST COLLECTOR BACK TO SOURCE PD4B.
- DISCONNECT AND REMOVE ALL ASSOCIATED EQUIPMENT, CIRCUITRY AND CABLING COMPLETELY PERTAINING TO FIRE SHUTTER BACK TO SOURCE.
- CORRIDOR DOOR TO BE REPLACED. DISCONNECT AND SECURE ANY EXISTING CEILING FIXTURES/DEVICES THAT IMPERE WORK BY OTHER TRADES. IDENTIFY AND SECURE EXISTING BRANCH CIRCUITS FOR REUSE. COORDINATE WITH OTHERS PRIOR TO STARTING WORK.
- TYPICAL, REMOVE EXISTING IN WALL BOX AND ASSOCIATED CONDUIT. COORDINATE PATCHING WITH OTHER TRADES PRIOR TO STARTING WORK.
- DISCONNECT EXISTING FEED FROM MECHANICAL UNIT. IDENTIFY AND SECURE EXISTING BRANCH CIRCUITS FOR REUSE. RECONNECT EXISTING CIRCUITRY ONCE WORK BY OTHER TRADES IS COMPLETE. COORDINATE WITH OTHERS BEFORE STARTING WORK.
- DISCONNECT AND REMOVE EXISTING FEED TO THE AIRBOSS UNITS. UNITS LABELED DC-1, AND DC-2. IDENTIFY AND SECURE EXISTING BRANCH CIRCUITS FOR REUSE.
- EXISTING CEILING DEVICES TO BE TEMPORARILY REMOVED/RELOCATED WHILE HVAC WORK IS BEING COMPLETED IN THIS SPACE. SECURE EXISTING CIRCUITRY FOR RE-USE IF REQUIRED. RE-INSTALL DEVICES IN EXISTING LOCATIONS ONCE WORK IS COMPLETED BY OTHER TRADES. COORDINATE WITH OTHER TRADES PRIOR TO STARTING WORK/RE-INSTALLATION.
- SOFFIT LIGHT TO BE REMOVED. DISCONNECT AND SECURE EXISTING CIRCUITRY FOR RE-USE.
- DISCONNECT EXISTING FEED FROM MECHANICAL PUMP. REMOVE ALL CIRCUITRY AND ACCESSORIES BACK TO SOURCE.
- DISCONNECT AND REMOVE ALL DEVICES, EQUIPMENT AND CABLING COMPLETELY ASSOCIATED WITH THE POOL LIGHTING BACK TO SOURCE. THIS INCLUDES THE PENDANT AND WALL MOUNTED FIXTURES IN SPACE.
- DISCONNECT AND REMOVE ASSOCIATED CIRCUITRY TO KITCHEN EQUIPMENT SCHEDULED TO BE REMOVED. DEMOLISHED RECEPTACLES TO HAVE CIRCUITRY DEMOLISHED BACK TO SOURCE. EXISTING LOAD CENTERS TO BE REMOVED BACK TO SOURCE. EXISTING CONDUITS IN FLOOR TO REMAIN, AND PREPARED FOR RE-USE.
- CEILINGS TO BE REMOVED AND REPLACED WITH NEW IN THIS SPACE. DISCONNECT AND SECURE ALL LIGHT FIXTURES AND ASSOCIATED WIRING FOR RE-USE. NOTE THE AMOUNT OF ENLIGHTENED ACCESSORIES IN THIS SPACE AND SECURE THEM FOR RE-USE IN THE WAY IN WHICH THEY WERE USED IN THE EXISTING CIRCUIT. DISCONNECT AND REMOVE ALL OTHER CEILING DEVICES/CIRCUITRY AND SECURE THEM FOR RE-USE. EXISTING TRACK LIGHTING TO NOT REMAIN. SECURE HOMERUN FOR RE-USE.
- DISCONNECT EXISTING FEED FROM MECHANICAL UNIT. REMOVE ALL WIRE, CONDUIT, RACEWAY, BOXES, AND SUPPORTS COMPLETE BACK TO SOURCE. COORDINATE WITH OTHERS BEFORE STARTING WORK.

SED # 57-000-01-000-004-MIDDLE SCHOOL

FIRST FLOOR DEMOLITION PLAN - AREA A AND B

2025 MIDDLE SCHOOL PHASE III ALTERATIONS PROJECT

CORNING-PAINTED POST ASD

35 VICTORY HIGHWAY, PAINTED POST, NY 14570

MS-E0.1  
PROJECT NO: 2649-133

HUNT ENGINEERS | ARCHITECTS | SURVEYORS

HORSEHEADS, NY 607-263-0000 ROCHESTER, NY 585-337-7600 TOWNAND, PA 570-265-4600  
BINGHAMTON, NY 607-798-8881 ALBANY, NY 607-798-8801

WWW.HUNTEAS.COM  
NY CERTIFICATE NO. 0016220 PA CERTIFICATE NO. TSC2200131464-1

DESCRIPTION OF REVISION:  
ISSUED FOR BID

# DATE:  
1 10/20/2025

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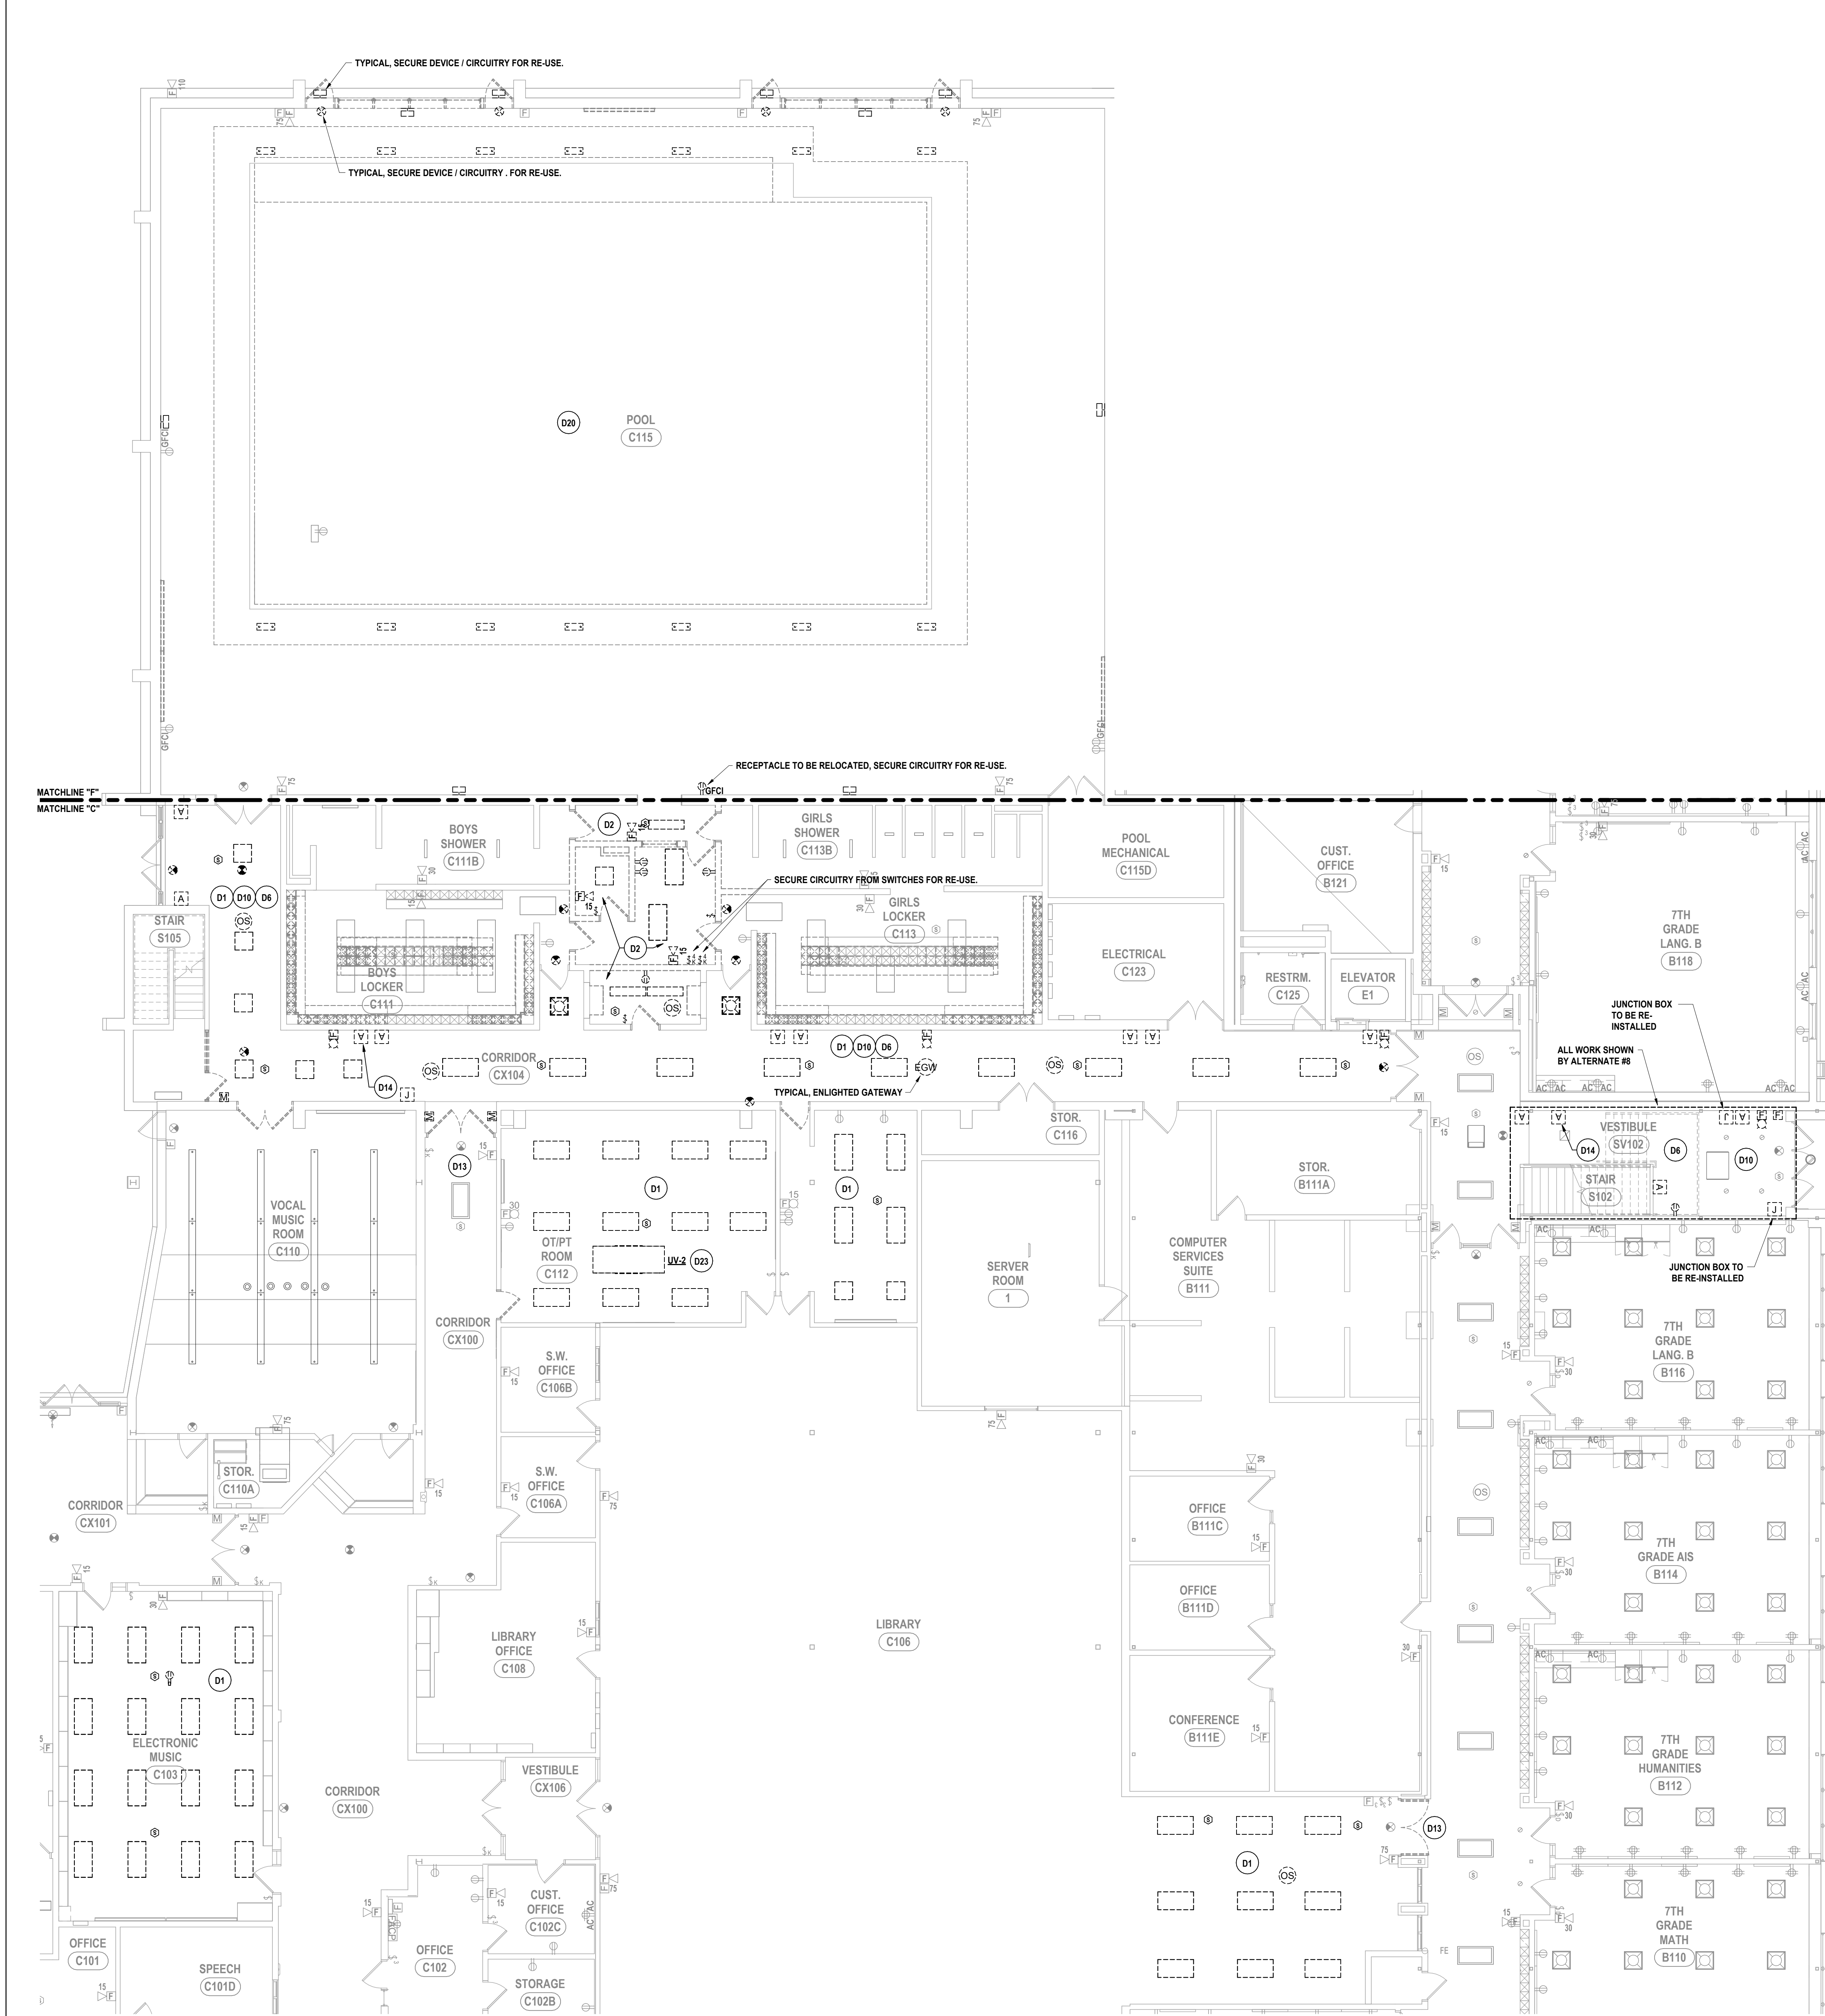
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05/09/2025

PROJECT NO:  
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THIS IS A VIOLATION OF THE LAW FOR ANY PERSON TO MAKE UNAUTHORIZED ALTERATIONS OR ADDITIONS TO PLANS  
DRAWN BY LICENSED ENGINEERS, ARCHITECTS, SURVEYORS OR PROFESSIONAL DESIGNERS








GENERAL NOTES - ELECTRICAL


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CONSTRUCTION NOTES - POWER


- P1 RECONNECT/RE-INSTALL EXISTING HAND DRYERS TO PREVIOUSLY SECURED CIRCUITRY. COORDINATE WITH OTHERS PRIOR TO STARTING WORK.
- P2 PROVIDE 120V TO 4X4 JUNCTION BOX ABOVE CEILING IN THIS LOCATION TO SERVE POWERED WATER CLOSETS, URINALS, AND LAVATORIES FOR THIS SET OF BATHROOMS.
- P3 ALL WORK BY ALTERNATE #6. E.G. TO PROVIDE 4"X4" RECESSED DECK PLATE FOR IN DECK TIMING SYSTEM. COORDINATE TRENCHING FROM JUNCTION BOX LOCATIONS TO MEDIA DECK WITH G.C. PROVIDE (2) 1" CONDUIT TO EACH JUNCTION BOX. ALL EXPOSED CONDUIT RUNS TO BE RMC.
- P4 ALL WORK BY ALTERNATE #2. PROVIDE POWER TO NEW MOTORIZED BLEACHERS. EACH BANK MOTOR TO BE 288V 3PH 1/2HP. CIRCUIT THE 6 BLEACHER BANKS TOGETHER TO PANEL PD18 USING (3)#10, (1)-10G, IN 1" C. PROVIDE 20A/3P BREAKER IN PANEL. PROVIDE EACH BANK WITH THEIR OWN NON-FUSIBLE SAFETY SWITCH.
- P5 PROVIDE POWER TO 3/4HP MOTORIZED BACKSTOP. CIRCUIT TO PANEL PD18 USING (2)#8AWG, (1)-#10G IN 1" C. BACKSTOP TO BE CONTROLLED USING KEYED SWITCH. SEE APPROXIMATE LOCATION ON PLAN. TO BE (2) - 3 GANG KEY SWITCH SETS. SWITCHES TO BE APPROX. 5' AFF. COORDINATE FINAL LOCATION WITH ARCHITECT / OWNER PRIOR TO INSTALLATION.
- P6 PROVIDE MULTI-SPORT INDOOR SCOREBOARD AND SHOT CLOCK IN THIS APPROXIMATE LOCATION. CONNECT SCOREBOARD AND SHOT CLOCK TO EXISTING 20A RECEPTACLE. COORDINATE ALL FINAL LOCATIONS AND MOUNTING HEIGHTS WITH OWNER AND OTHER TRADES PRIOR TO ROUGH-IN. COORDINATE ALL WORK WITH RELATED TRADES AND DRAWINGS / SPECIFICATIONS. ALSO REFER TO SPECIFICATIONS SECTION 26 06 05 FOR MORE INFORMATION AND ADDITIONAL REQUIREMENTS RELATED TO MULTI-SPORT INDOOR SCOREBOARDS.
- P7 NEW DUST COLLECTOR WITH CONTROL PANEL TO BE INSTALLED. PROVIDE CONNECTION TO CONTROL PANEL ON UNIT USING (3)#8, (1)-10G, IN 1" C. CIRCUIT TO PANEL PD48. PROVIDE 80A/3P BREAKER.
- P8 ALL WORK BY ALTERNATE #6. PROVIDE (1) DUPLEX RECEPTACLE ON WALL AS SHOWN FOR THE SCOREBOARD. COORDINATE LOCATION OF RECEPTACLE AFTER ROUGH IN OF SCOREBOARD. CIRCUIT TO 20A/1P BREAKER IN PANEL SBP-1A USING (2)#8, (1)-10G, IN 1" RIGID CONDUIT.
- P9 TYPICAL. PROVIDE NEW CORD REELS. EACH CORD REEL TO BE CENTERED OVER THEIR OWN RESPECTIVE WORKTABLE. RECEPTACLES TO BE NEMA 5-20R.
- P10 PROVIDE POWER TO NEW DRINKING FOUNTAIN FROM GFCI RECEPTACLE IN THIS LOCATION. PLACE OUTLET WITHIN THE EXTENTS OF THE SHROUD OF THE DRINKING FOUNTAIN.
- P11 PROVIDE POWER TO MECHANICAL UNIT(S) IN SPACE. REFER TO MECHANICAL CONTROL SCHEDULE ON MS-E3.1.
- P12 ALL WORK BY ALTERNATE #6. PROVIDE (1) QUAD RECEPTACLE AND (1) DUPLEX RECEPTACLE ON PROPOSED MEDIA DECK. PROVIDE DEDICATED CIRCUITS FOR EACH BACK TO PANEL SBPIA, USING (2)#12, (1)-#12G, IN 3/4" C.
- P13 UPON COMPLETION OF WALL TILING, RE-INSTALL ELECTRICAL DEVICES IN EXISTING LOCATIONS. CONNECT TO SECURED BRANCH CIRCUITRY. COORDINATE WITH OTHER TRADES PRIOR TO STARTING WORK.
- P14 PROVIDE POWER TO SWIMSUIT WATER EXTRACTOR. CIRCUIT TO PANEL SBPIA USING (2)-#12, (1)-12G, IN 3/4" C. UTILIZE SPARE 20A/1P BREAKER.
- P15 CONNECT NEW AIR BOSS UNITS, AR-1 AND AR-2, TO PREVIOUSLY SECURED CIRCUITRY/ACCESSORIES IN SPACE. MODIFY / EXTEND CIRCUITRY AS NEEDED.
- P16 RELOCATE EXISTING CONTROLS FOR THE MAIN COURT HOOPS TO THE SAME LOCATION IN WHICH THE KEY SWITCHES ARE BEING INSTALLED FOR THE NEW BACKSTOP MOTORS. MODIFY / EXTEND CIRCUITRY AS NEEDED. TO EXTEND CIRCUITRY, USE WIRE MATCHING EXISTING CONDITIONS.
- P17 PROVIDE POWER TO HEIGHT ADJUSTER FOR EACH HOOP IN THIS SPACE. CIRCUIT TOGETHER TO PANEL W1 USING (2)#8AWG, (1)-#10G IN 1" C. UTILIZE SPARE 20A/1P BREAKER IN SPACE. TO BE CONTROLLED USING KEYED SWITCH. SEE APPROXIMATE LOCATION ON PLAN.
- P18 OUTLET TO BE SURFACE MOUNTED. RACEWAY COLOR TO MATCH EXISTING WALL COLOR. CONDUIT TO BE RAN ABOVE CEILING FROM PANEL PK1.

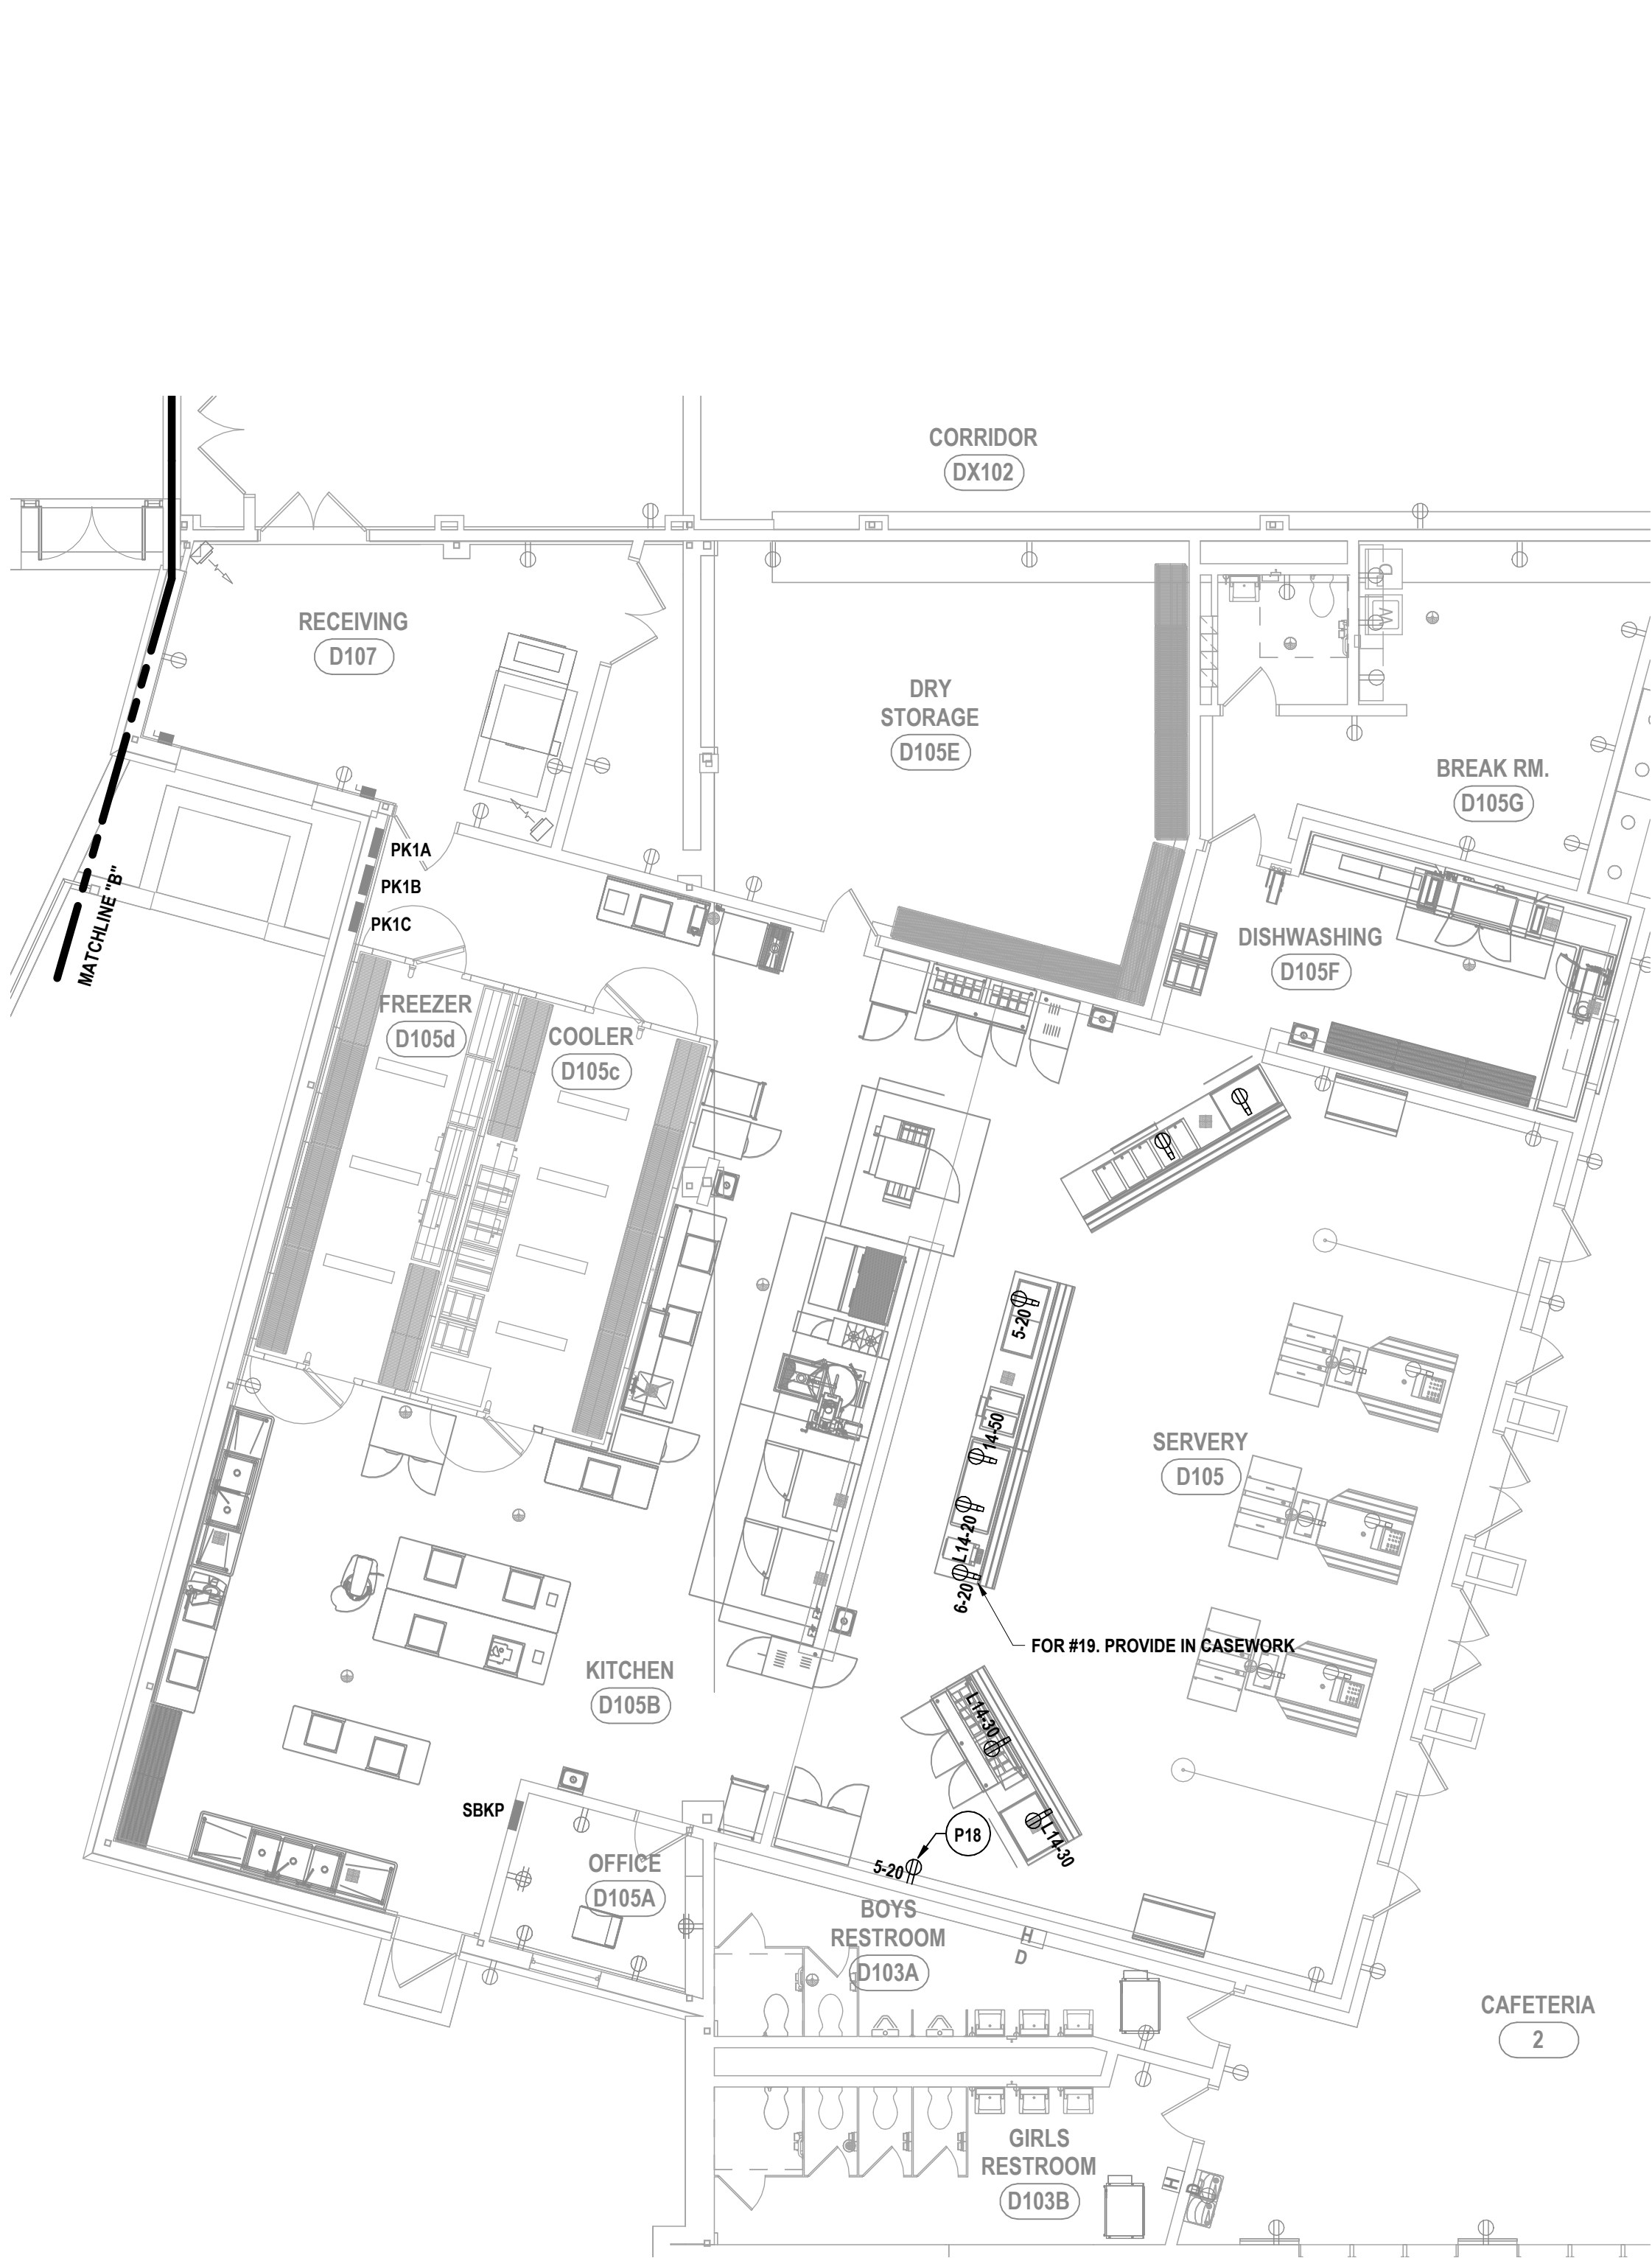


2 FIRST FLOOR POWER PLAN - AREA B  
1/8" = 1'-0"

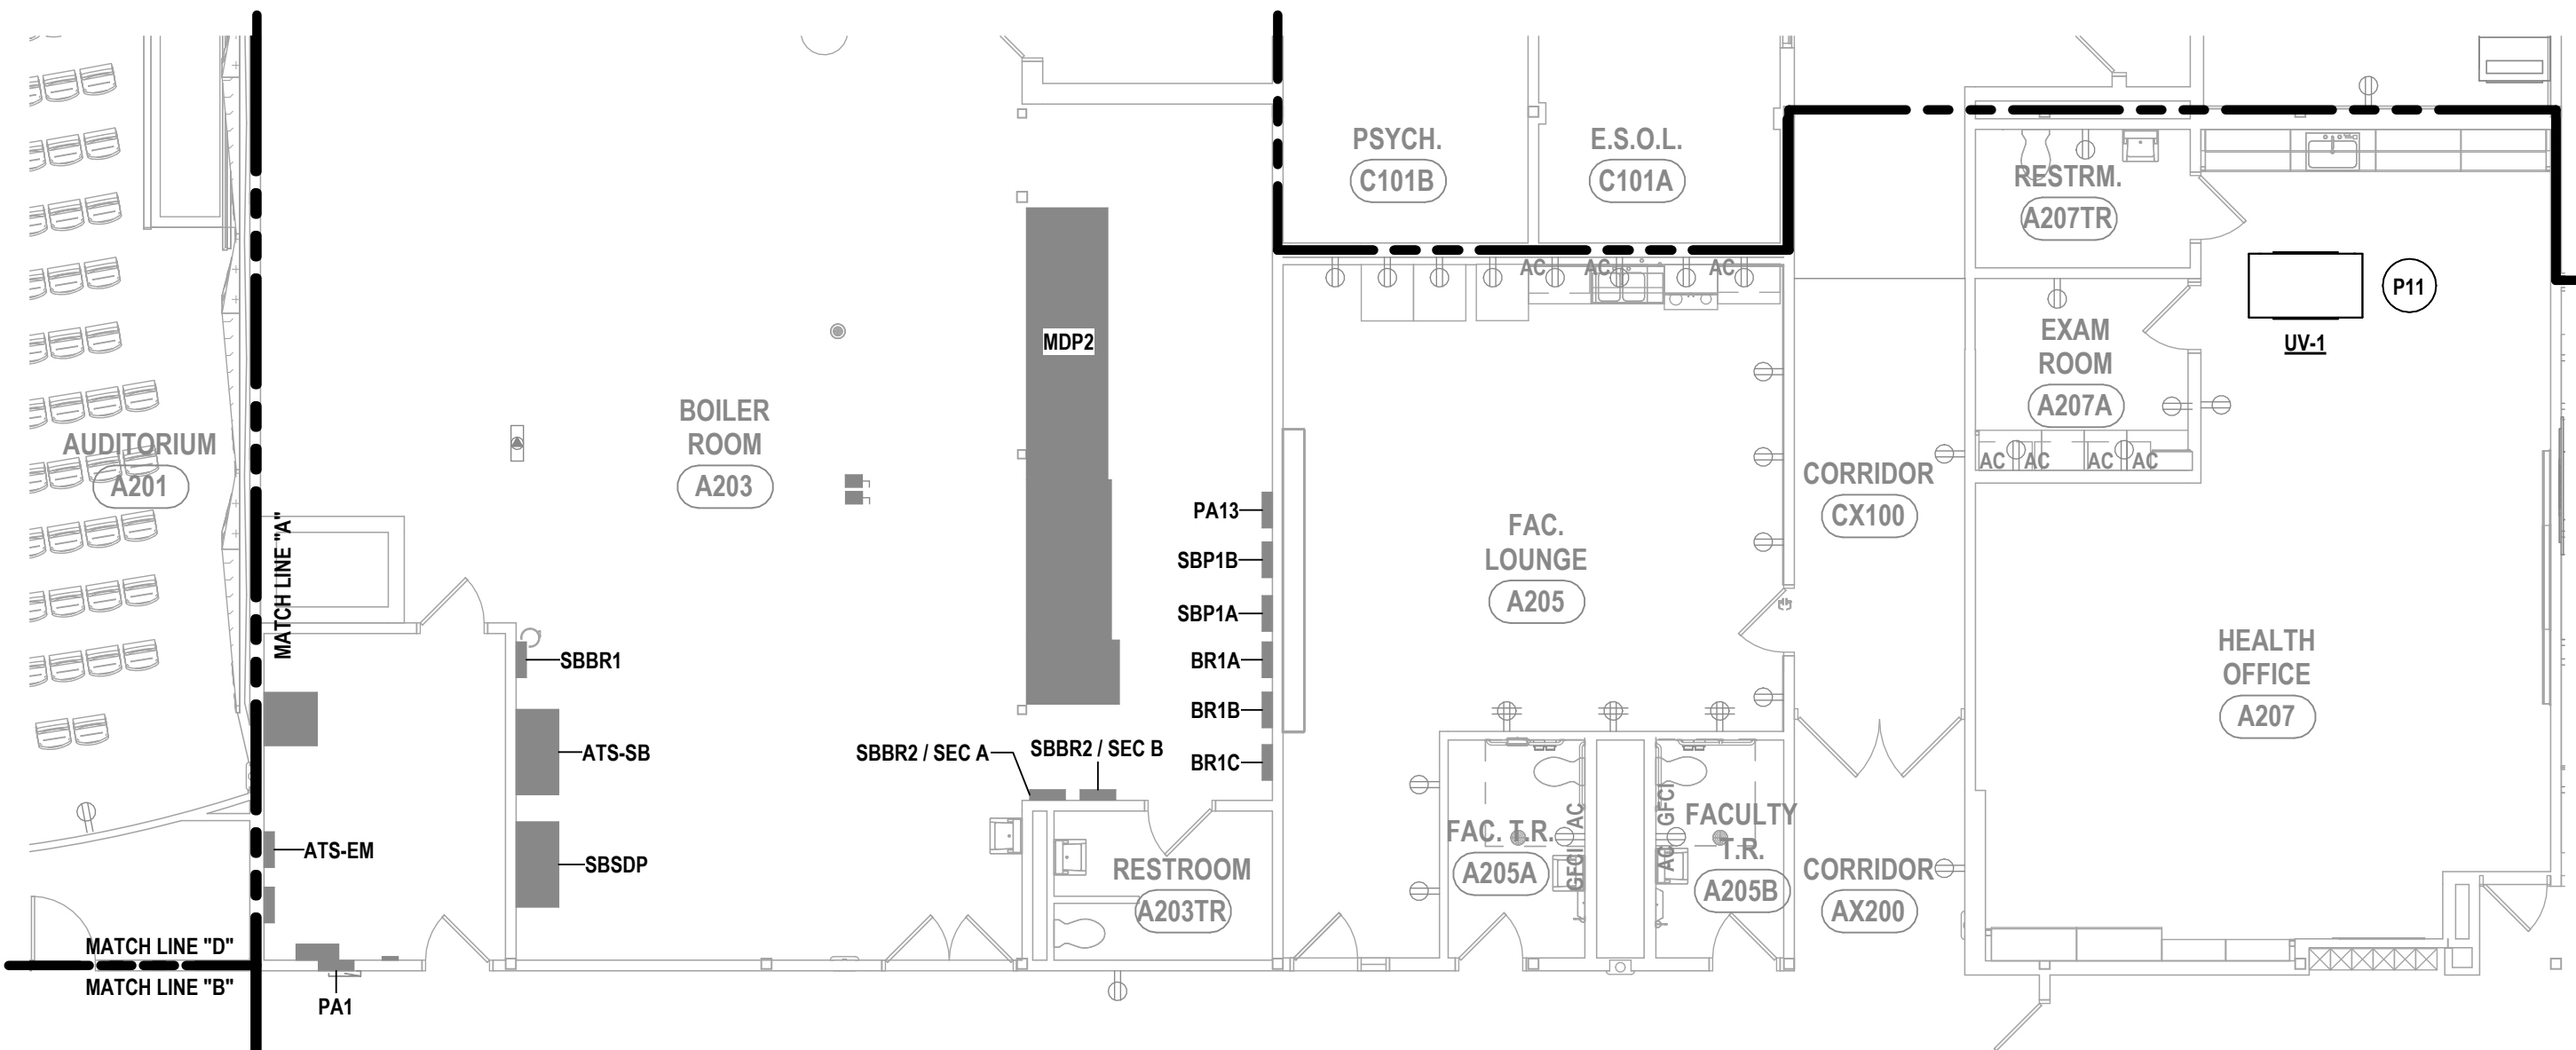

3 FIRST FLOOR POWER PLAN - PARTIAL AREA A  
1/8" = 1'-0"

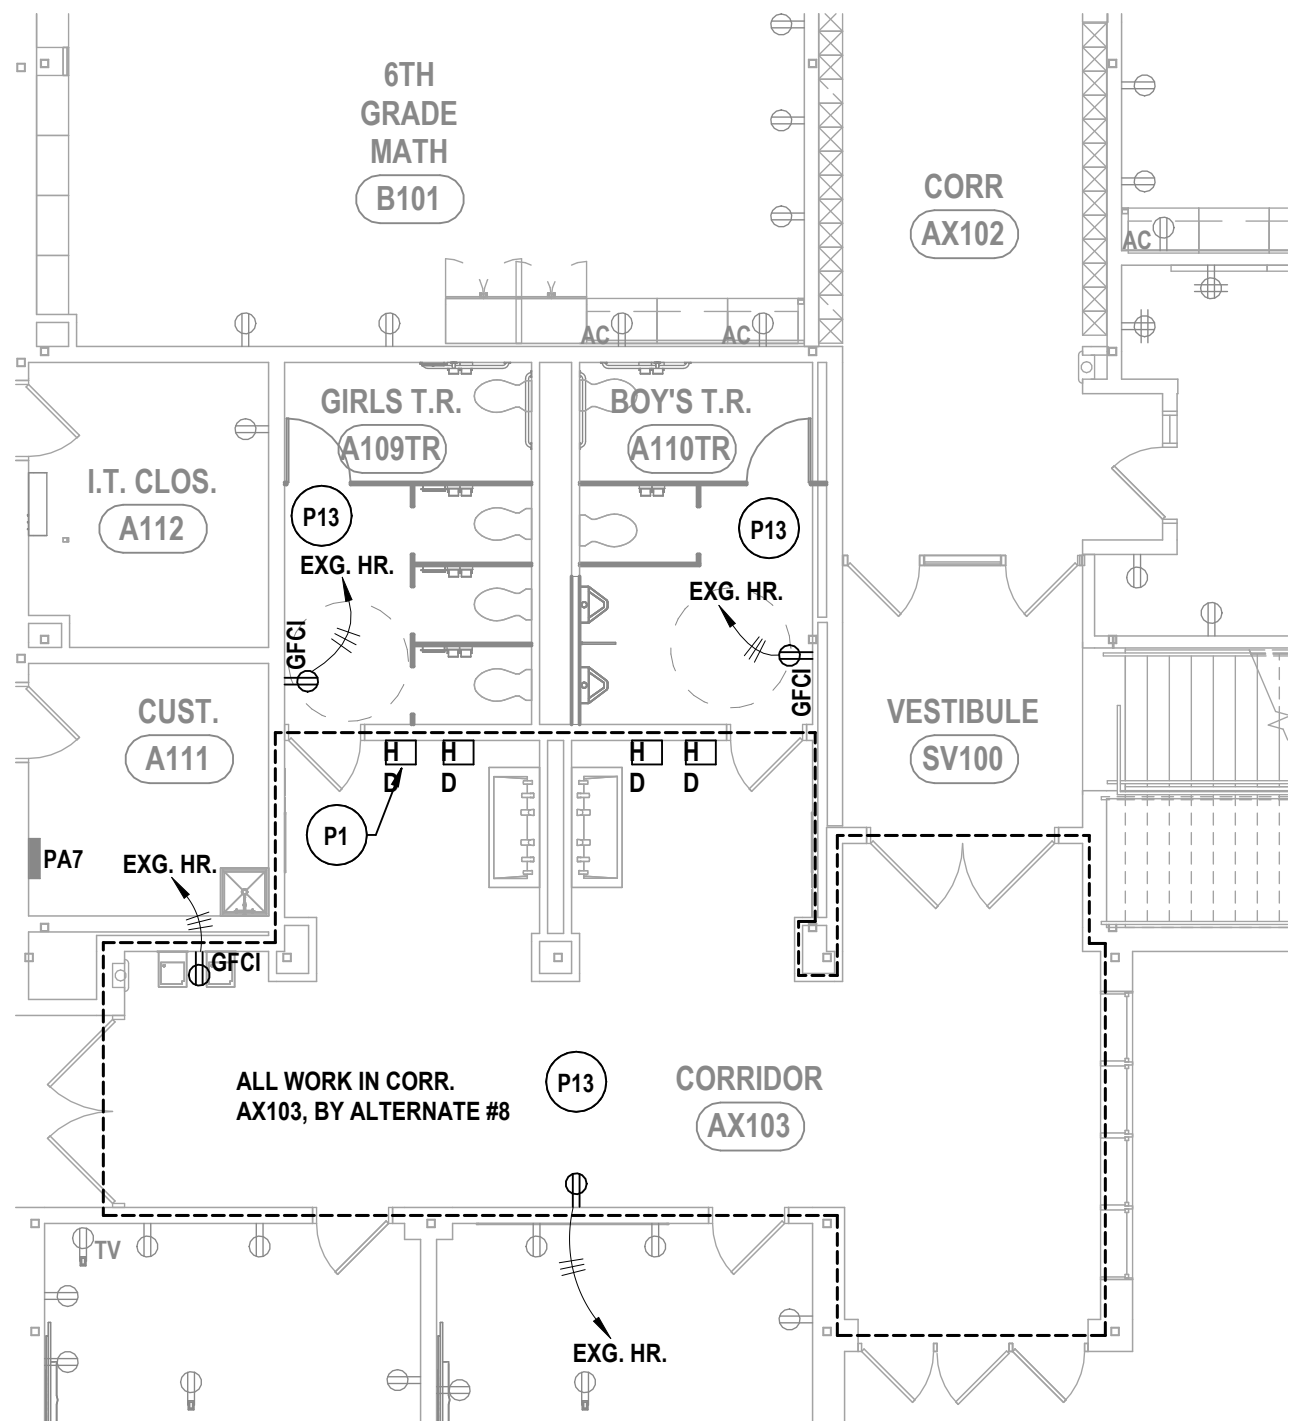

1 FIRST FLOOR POWER PLAN - PARTAIL AREA A  
1/8" = 1'-0"

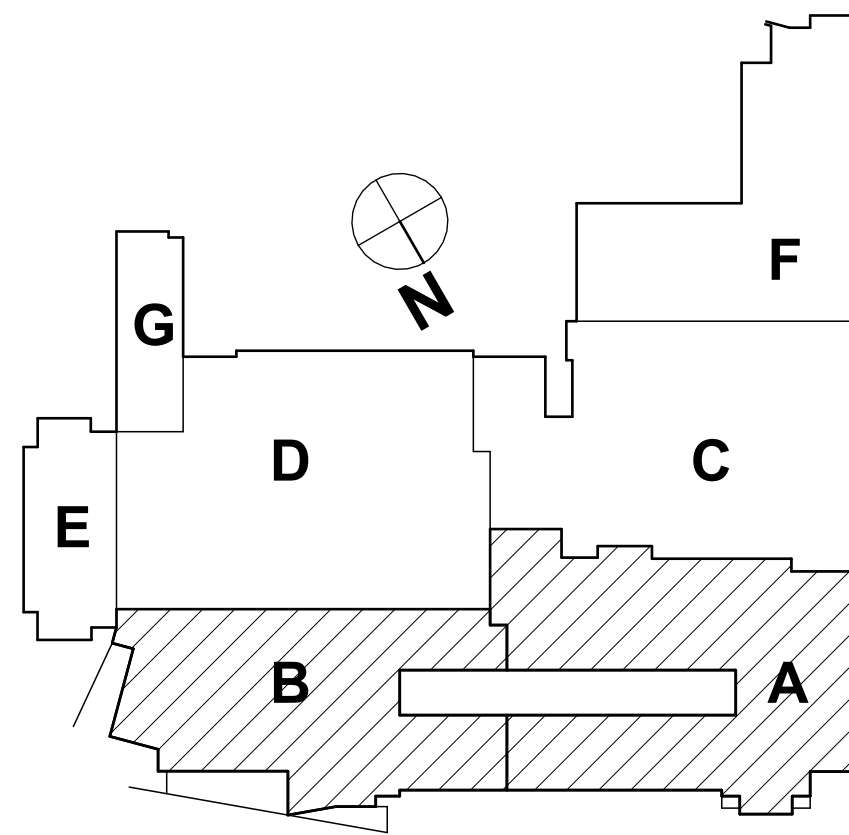

SHEET # 57-16-00-01-020-044 - MIDDLE SCHOOL

FIRST FLOOR POWER PLAN - AREA A AND B

2025 MIDDLE SCHOOL PHASE III ALTERATIONS PROJECT

CORNING-PAINTED POST ASD

35 VICTORY HIGHWAY, PAINTED POST, NY 14870

MS-E1.1

PROJECT NO: 2649-133

HUNT ENGINEERS | ARCHITECTS | SURVEYORS

HORSEHEADS, NY 607-263-1000 ROCHESTER, NY 585-337-7668 TOWNHALL, PA 470-265-4668

BINGHAMTON, NY 607-798-8881 ALBANY, NY 607-798-8881

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NY CERTIFICATE NO. 0016220 PA CERTIFICATE NO. TSC220313464-1

DESCRIPTION OF REVISION:

ISSUED FOR BID

# DATE:

1 10/20/2025

PHASE:

CD

CHECKED BY:

TAWO

DRAWN BY:

MDR

DATE:

05/09/2025


PROJECT NO:

2649-133

THIS IS A NOTATION OF THE LAW FOR ANY PERSON TO MAKE UNAUTHORIZED ALTERATIONS TO PLANS

OR ANY PART THEREOF WITHOUT THE WRITTEN CONSENT OF HUNT ENGINEERS, ARCHITECTS & SURVEYORS, P.C.




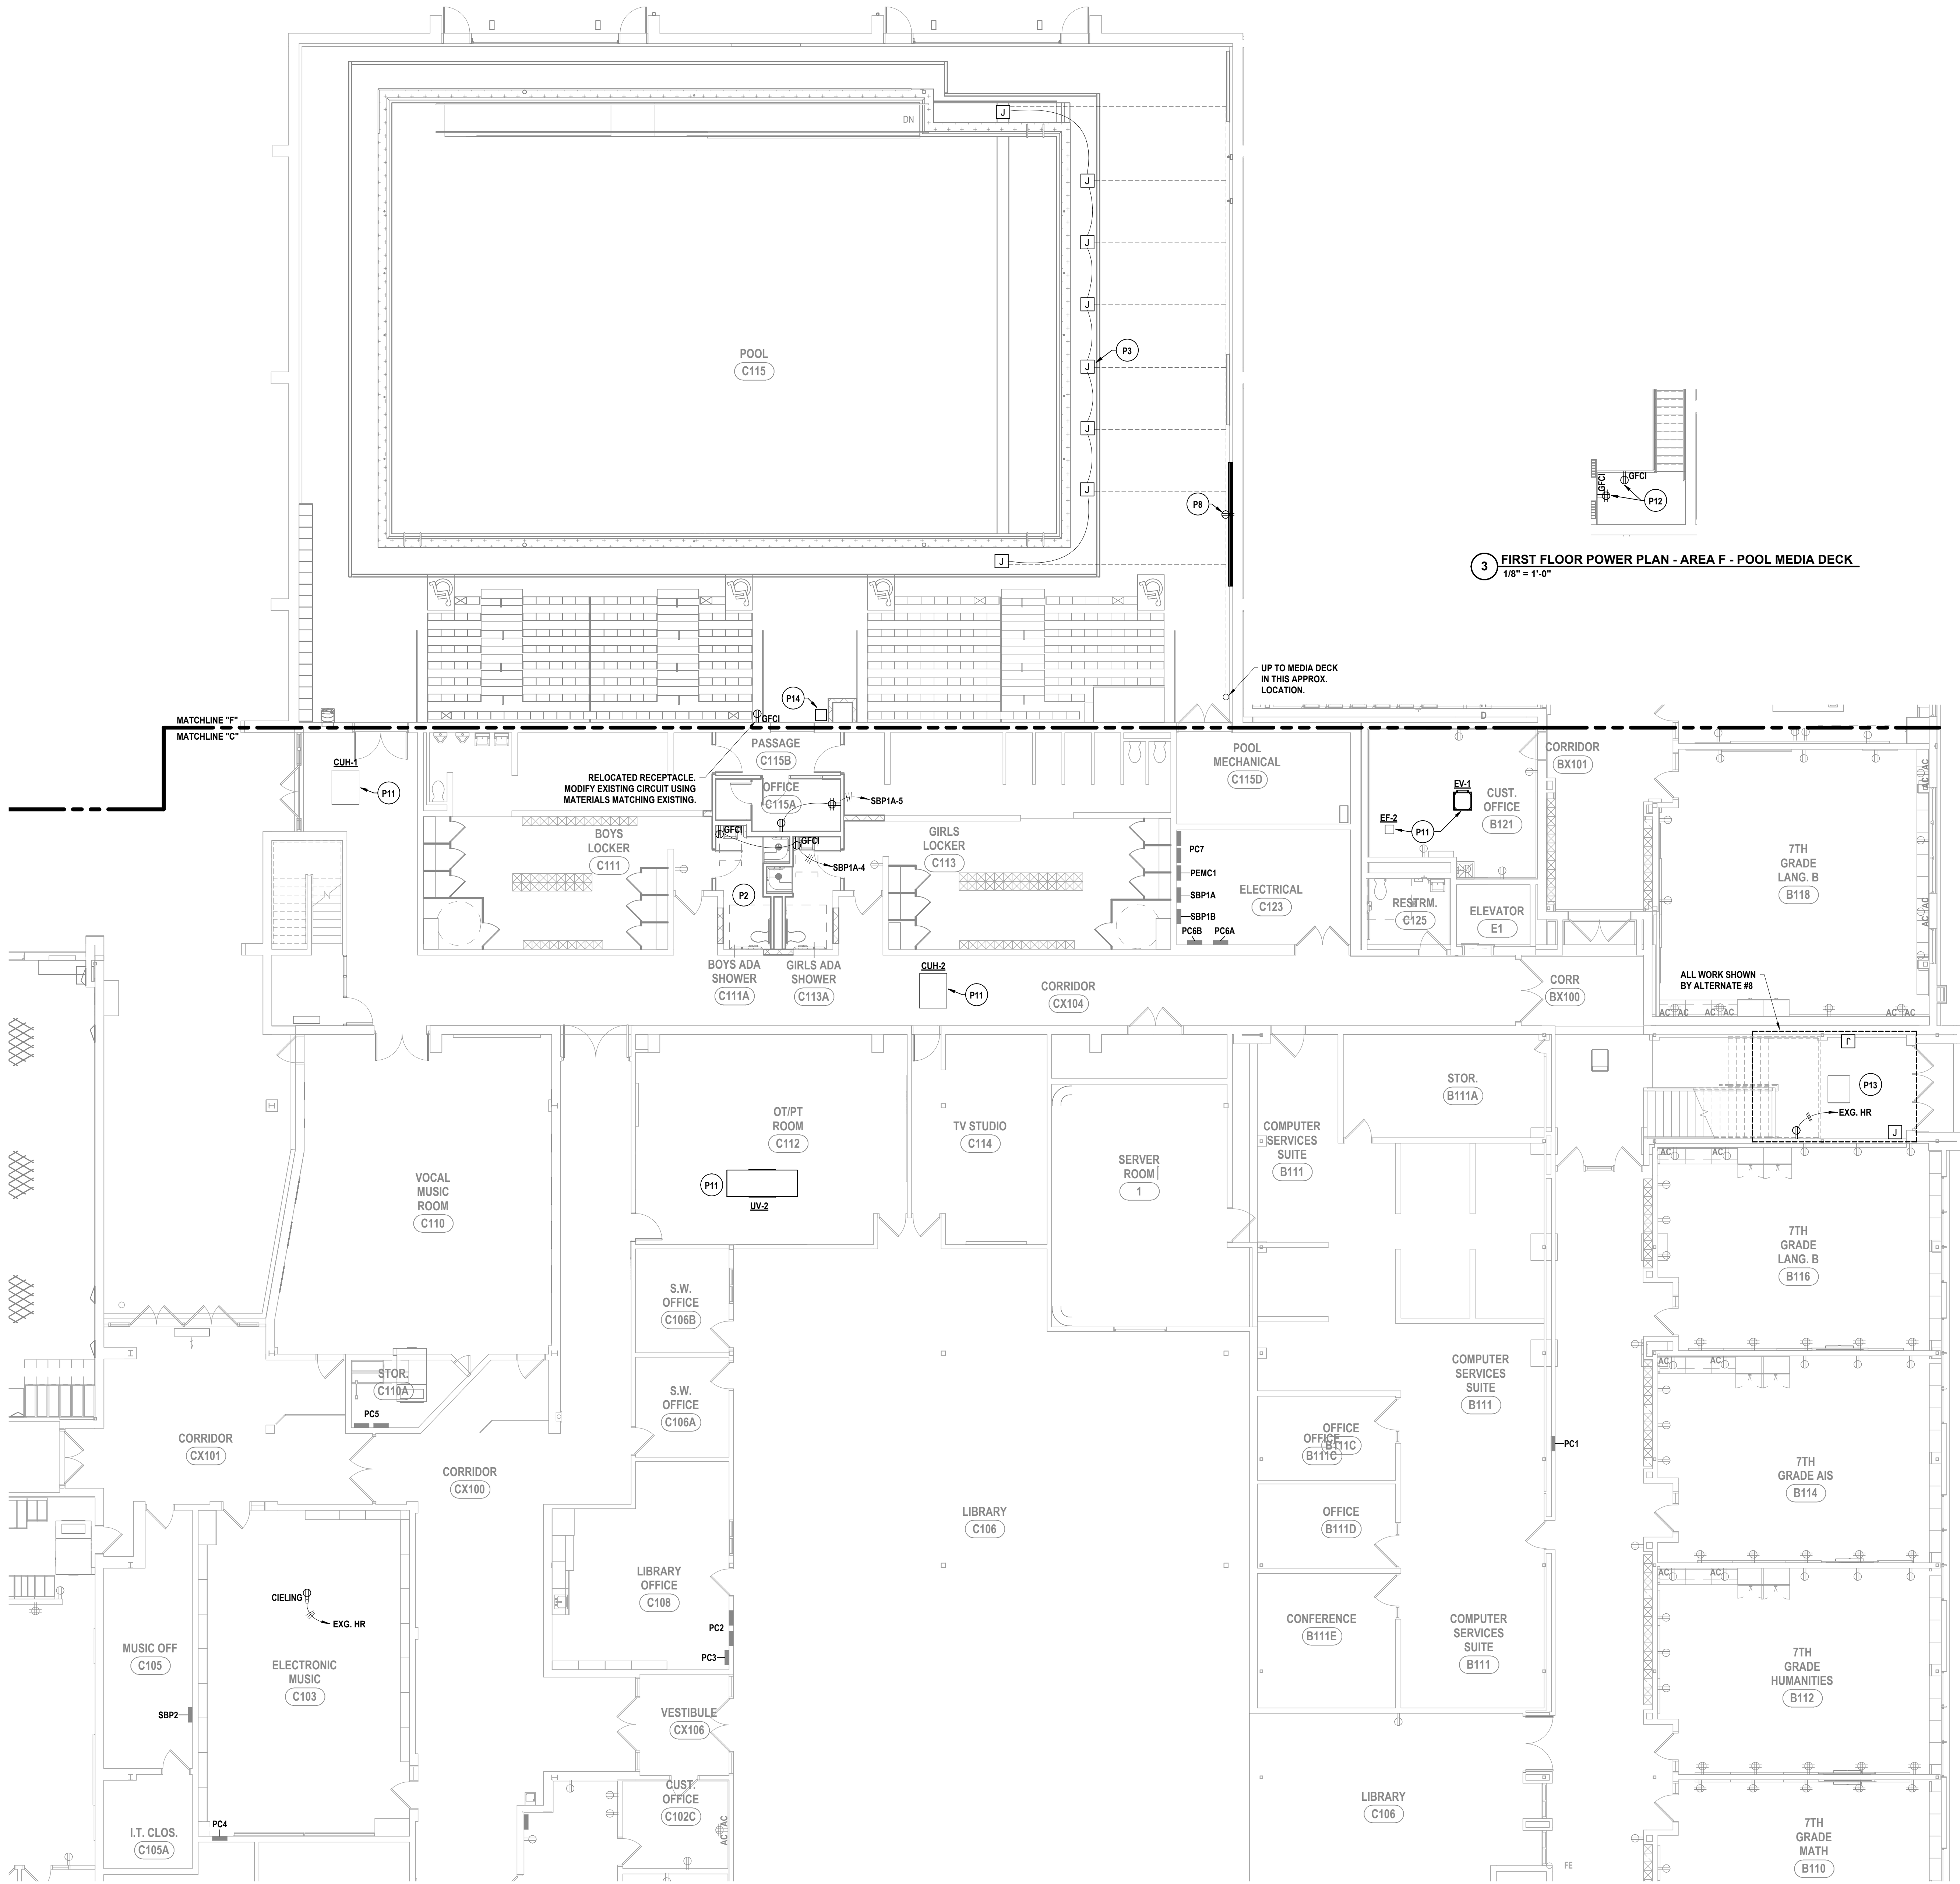

1 FIRST FLOOR POWER PLAN - AREA C AND F  
1/8" = 1'-0"

3 FIRST FLOOR POWER PLAN - AREA F - POOL MEDIA DECK  
1/8" = 1'-0"

2 SECOND FLOOR ELECTRICAL POWER PLAN - STAIR S202  
1/8" = 1'-0"

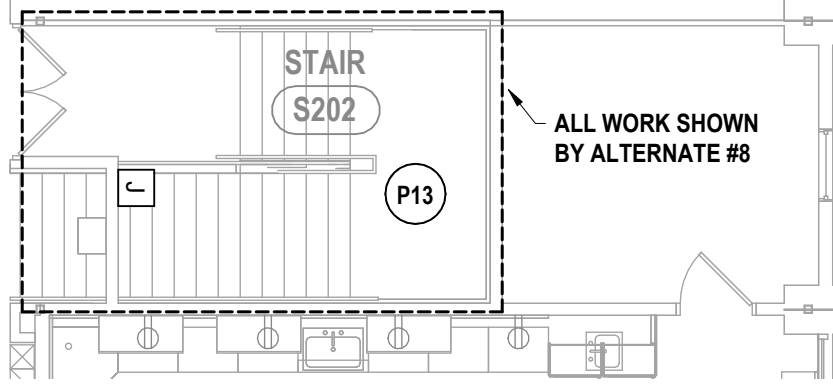

## GENERAL NOTES - ELECTRICAL

REFER TO SHEET MS-E0.1

## CONSTRUCTION NOTES - POWER

- P1 RECONNECT/RE-INSTALL EXISTING HAND DRYERS TO PREVIOUSLY SECURED CIRCUITRY. COORDINATE WITH OTHERS PRIOR TO STARTING WORK.
- P2 PROVIDE 120V TO 4XX JUNCTION BOX ABOVE CEILING IN THIS LOCATION TO SERVE POWERED WATER CLOSETS, URINALS, AND LAVATORIES FOR THIS SET OF BATHROOMS.
- P3 ALL WORK BY ALTERNATE #8. E.C. TO PROVIDE 4"X4" RECESSED DECK PLATE FOR IN DECK TILING SYSTEM. COORDINATE TRENCHING FROM JUNCTION BOX LOCATIONS TO MEDIA DECK WITH G.C. PROVIDE (2) 1" CONDUIT TO EACH JUNCTION BOX. ALL EXPOSED CONDUIT RUNS TO BE RMC.
- P4 ALL WORK BY ALTERNATE #2. PROVIDE POWER TO NEW MOTORIZED BLEACHERS. EACH BANK MOTOR TO BE 208V 3PH 1/2HP. CIRCUIT THE 6 BLEACHER BANKS TOGETHER TO PANEL PD18. USING (3)-#10, (1)-1/2", IN 1" C. PROVIDE 20A/3P BREAKER IN PANEL. PROVIDE EACH BANK WITH THEIR OWN NON-FUSIBLE SAFETY SWITCH.
- P5 PROVIDE POWER TO 3/4HP MOTORIZED BACKSTOP. CIRCUIT TO PANEL PD18 USING (2)-#8AWG, (1)-#10G IN 1" C. BACKSTOP TO BE CONTROLLED USING KEYED SWITCH. SEE APPROXIMATE LOCATION ON PLAN. TO BE (2) - 3 GANG KEY SWITCH SETS. SWITCHES TO BE APPROX. 5' AFF. COORDINATE FINAL LOCATION WITH ARCHITECT / OWNER PRIOR TO INSTALLATION.
- P6 PROVIDE MULTI-SPORT INDOOR SCOREBOARD AND SHOT CLOCK IN THIS APPROXIMATE LOCATION. CONNECT SCOREBOARD AND SHOT CLOCK TO EXISTING 20A RECEPTACLE. COORDINATE ALL FINAL LOCATIONS AND MOUNTING HEIGHTS WITH OWNER AND OTHER TRADES PRIOR TO ROUGH-IN. COORDINATE ALL WORK WITH RELATED TRADES AND DRAWINGS / SPECIFICATIONS. ALSO REFER TO SPECIFICATIONS SECTION 26 05 05 FOR MORE INFORMATION AND ADDITIONAL REQUIREMENTS RELATED TO MULTI-SPORT INDOOR SCOREBOARDS.
- P7 NEW DUST COLLECTOR WITH CONTROL PANEL TO BE INSTALLED. PROVIDE CONNECTION TO CONTROL PANEL ON UNIT USING (3)-#8, (1)-1/2", IN 1" C. CIRCUIT TO PANEL PD48. PROVIDE 80A/3P BREAKER.
- P8 ALL WORK BY ALTERNATE #8. PROVIDE (1) DUPLEX RECEPTACLE ON WALL AS SHOWN FOR THE SCOREBOARD. COORDINATE LOCATION OF RECEPTACLE AFTER ROUGH IN OF SCOREBOARD. CIRCUIT TO 20A/1P BREAKER IN PANEL SBP-1A USING (2)-#8, (1)-1/2", IN 1" RIGID CONDUIT.
- P9 TYPICAL PROVIDE NEW CORD REELS. EACH CORD REEL TO BE CENTERED OVER THEIR OWN RESPECTIVE WORKTABLE. RECEPTABLES TO BE NEMA 5-20R.
- P10 PROVIDE POWER TO NEW DRINKING FOUNTAIN FROM GFCI RECEPTACLE IN THIS LOCATION. PLACE OUTLET WITHIN THE EXTENTS OF THE SHROUD OF THE DRINKING FOUNTAIN.
- P11 PROVIDE POWER TO MECHANICAL UNIT(S) IN SPACE. REFER TO MECHANICAL CONTROL SCHEDULE ON MS-E3.1.
- P12 ALL WORK BY ALTERNATE #8. PROVIDE (1) QUAD RECEPTACLE AND (1) DUPLEX RECEPTACLE ON PROPOSED MEDIA DECK. PROVIDE DEDICATED CIRCUITS FOR EACH BACK TO PANEL SBP1A, USING (2)-#12, (1)-#12G, IN 3/4" C.
- P13 UPON COMPLETION OF WALL TILING, RE-INSTALL ELECTRICAL DEVICES IN EXISTING LOCATIONS. CONNECT TO SECURED BRANCH CIRCUITRY. COORDINATE WITH OTHER TRADES PRIOR TO STARTING WORK.
- P14 PROVIDE POWER TO SWIMSUIT WATER EXTRACTOR. CIRCUIT TO PANEL SBP1A USING (2)-#12, (1)-1/2", IN 3/4" C. UTILIZE SPARE 20A/1P BREAKER.
- P15 CONNECT NEW AIR BOSS UNITS, AR-1 AND AR-2, TO PREVIOUSLY SECURED CIRCUITRY/ACCESSORIES IN SPACE. MODIFY / EXTEND CIRCUITRY AS NEEDED.
- P16 RELOCATE EXISTING CONTROLS FOR THE MAIN COURT HOOPS TO THE SAME LOCATION IN WHICH THE KEY SWITCHES ARE BEING INSTALLED FOR THE NEW BACKSTOP MOTORS. MODIFY / EXTEND CIRCUITRY AS NEEDED. TO EXTEND CIRCUITRY, USE WIRE MATCHING EXISTING CONDITIONS.
- P17 PROVIDE POWER TO HEIGHT ADJUSTER FOR EACH HOOP IN THIS SPACE. CIRCUIT TOGETHER TO PANEL W1 USING (2)-#8AWG, (1)-#10G IN 1" C. UTILIZE SPARE 20A/1P BREAKER IN SPACE. TO BE CONTROLLED USING KEYED SWITCH. SEE APPROXIMATE LOCATION ON PLAN.
- P18 OUTLET TO BE SURFACE MOUNTED. RACEWAY COLOR TO MATCH EXISTING WALL COLOR. CONDUIT TO BE RAN ABOVE CEILING FROM PANEL PK1.

SED # 57-1600-01-020444 - MIDDLE SCHOOL

FIRST FLOOR POWER PLAN - AREA C AND F

2025 MIDDLE SCHOOL PHASE III ALTERATIONS PROJECT

CORNING-PAINTED POST ASD

35 VICTORY HIGHWAY, PAINTED POST, NY 14870

HUNT

ENGINEERS | ARCHITECTS | SURVEYORS

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BINGHAMTON, NY 607-738-8881 ALBANY, NY 607-738-8801

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NY CERTIFICATE NO. 0016220 PA CERTIFICATE NO. TSC2200131464-1

DRAWN BY: MDR  
CHECKED BY: TAWO  
DATE: 05/09/2025  
PHASE: CD

# DATE: 1 10/20/2025

DESCRIPTION OF REVISION:  
ISSUED FOR BID

THIS IS A VIOLATION OF THE LAW FOR ANY PERSON TO MAKE UNAUTHORIZED ALTERATION OR ADDITIONS TO PLANS  
DRAWING AT LOCATIONS, ENGINEERS, ARCHITECTS, SURVEYORS, DATE:

PROJECT NO: 2649-133

MS-E1.2

GENERAL NOTES - ELECTRICAL  
REFER TO SHEET MS-E0.1

CONSTRUCTION NOTES - POWER

- P1 RECONNECT/RE-INSTALL EXISTING HAND DRYERS TO PREVIOUSLY SECURED CIRCUITRY. COORDINATE WITH OTHERS PRIOR TO STARTING WORK.
- P2 PROVIDE 120V TO 4X4 JUNCTION BOX ABOVE CEILING IN THIS LOCATION TO SERVE POWERED WATER CLOSETS, URINALS, AND LAVATORIES FOR THIS SET OF BATHROOMS.
- P3 ALL WORK BY ALTERNATE #6. E.G. TO PROVIDE 4"x4" RECESSED DECK PLATE FOR IN DECK TIMING SYSTEM. COORDINATE TRENCHING FROM JUNCTION BOX LOCATIONS TO MEDIA DECK WITH G.C. PROVIDE (2) 1" CONDUIT TO EACH JUNCTION BOX. ALL EXPOSED CONDUIT RUNS TO BE RMC.
- P4 ALL WORK BY ALTERNATE #2. PROVIDE POWER TO NEW MOTORIZED BLEACHERS. EACH BANK MOTOR TO BE 288V 3PH 12HP. CIRCUIT THE 6 BLEACHER BANKS TOGETHER TO PANEL PD18 USING (2)#10, (1)-100, IN 1". PROVIDE 20A/3P BREAKER IN PANEL. PROVIDE EACH BANK WITH THEIR OWN NON-FUSIBLE SAFETY SWITCH.
- P5 PROVIDE POWER TO 3/4HP MOTORIZED BACKSTOP. CIRCUIT TO PANEL PD18 USING (2)#8AWG, (1)-#10G IN 1". BACKSTOP TO BE CONTROLLED USING KEYED SWITCH. SEE APPROXIMATE LOCATION ON PLAN. TO BE (2) - 3 GANG KEY SWITCH SETS. SWITCHES TO BE APPROX. 5' AFF. COORDINATE FINAL LOCATION WITH ARCHITECT / OWNER PRIOR TO INSTALLATION.
- P6 PROVIDE MULTI-SPORT INDOOR SCOREBOARD AND SHOT CLOCK IN THIS APPROXIMATE LOCATION. CONNECT SCOREBOARD AND SHOT CLOCK TO EXISTING 20A RECEPTACLE. COORDINATE ALL FINAL LOCATIONS AND MOUNTING HEIGHTS WITH OWNER AND OTHER TRADES PRIOR TO ROUGH-IN. COORDINATE ALL WORK WITH RELATED TRADES AND DRAWINGS / SPECIFICATIONS. ALSO REFER TO SPECIFICATIONS SECTION 26 06 05 FOR MORE INFORMATION AND ADDITIONAL REQUIREMENTS RELATED TO MULTI-SPORT INDOOR SCOREBOARDS.
- P7 NEW DUST COLLECTOR WITH CONTROL. PANEL TO BE INSTALLED. PROVIDE CONNECTION TO CONTROL PANEL ON UNIT USING (3)-#6, (1)-100, IN 1". CIRCUIT TO PANEL PD4B. PROVIDE 80A/3P BREAKER.
- P8 ALL WORK BY ALTERNATE #6. PROVIDE (1) DUPLEX RECEPTACLE ON WALL AS SHOWN FOR THE SCOREBOARD. COORDINATE LOCATION OF RECEPTACLE AFTER ROUGH IN OF SCOREBOARD. CIRCUIT TO 20A/1P BREAKER IN PANEL SBP-1A USING (2)-#8, (1)-100, IN 1" RIGID CONDUIT.
- P9 TYPICAL. PROVIDE NEW CORD REELS. EACH CORD REEL TO BE CENTERED OVER THEIR OWN RESPECTIVE WORKTABLE. RECEPTACLES TO BE NEMA 5-20R.
- P10 PROVIDE POWER TO NEW DRINKING FOUNTAIN FROM GFCI RECEPTACLE IN THIS LOCATION. PLACE OUTLET WITHIN THE EXTENTS OF THE SHROUD OF THE DRINKING FOUNTAIN.
- P11 PROVIDE POWER TO MECHANICAL UNIT(S) IN SPACE. REFER TO MECHANICAL CONTROL SCHEDULE ON MS-E0.1.
- P12 ALL WORK BY ALTERNATE #6. PROVIDE (1) QUAD RECEPTACLE AND (1) DUPLEX RECEPTACLE ON PROPOSED MEDIA DECK. PROVIDE DEDICATED CIRCUITS FOR EACH BACK TO PANEL SBP1A. USING (2)-#12, (1)-#10G, IN 3/4".
- P13 UPON COMPLETION OF WALL TILING, RE-INSTALL ELECTRICAL DEVICES IN EXISTING LOCATIONS. CONNECT TO SECURED BRANCH CIRCUITRY. COORDINATE WITH OTHER TRADES PRIOR TO STARTING WORK.
- P14 PROVIDE POWER TO SWIMSUIT WATER EXTRACTOR. CIRCUIT TO PANEL SBP1A USING (2)-#12, (1)-120, IN 3/4". UTILIZE SPARE 20A/1P BREAKER.
- P15 CONNECT NEW AIR BOSS UNITS, AR-1 AND AR-2, TO PREVIOUSLY SECURED CIRCUITRY/ACCESSORIES IN SPACE. MODIFY / EXTEND CIRCUITRY AS NEEDED.
- P16 RELOCATE EXISTING CONTROLS FOR THE MAIN COURT HOOPS TO THE SAME LOCATION IN WHICH THE KEY SWITCHES ARE BEING INSTALLED FOR THE NEW BACKSTOP MOTORS. MODIFY / EXTEND CIRCUITRY AS NEEDED. TO EXTEND CIRCUITRY, USE WIRE MATCHING EXISTING CONDITIONS.
- P17 PROVIDE POWER TO HEIGHT ADJUSTER FOR EACH HOOP IN THIS SPACE. CIRCUIT TOGETHER TO PANEL W1 USING (2)-#8AWG, (1)-#10G IN 1". UTILIZE SPARE 20A/1P BREAKER IN SPACE. TO BE CONTROLLED USING KEYED SWITCH. SEE APPROXIMATE LOCATION ON PLAN.
- P18 OUTLET TO BE SURFACE MOUNTED. RACEWAY COLOR TO MATCH EXISTING WALL COLOR. CONDUIT TO BE RAN ABOVE CEILING FROM PANEL PK1.

DRAWN BY: MDR  
CHECKED BY: TAWO  
DATE: 05/09/2025  
PHASE: CP

DESCRIPTION OF REVISION:  
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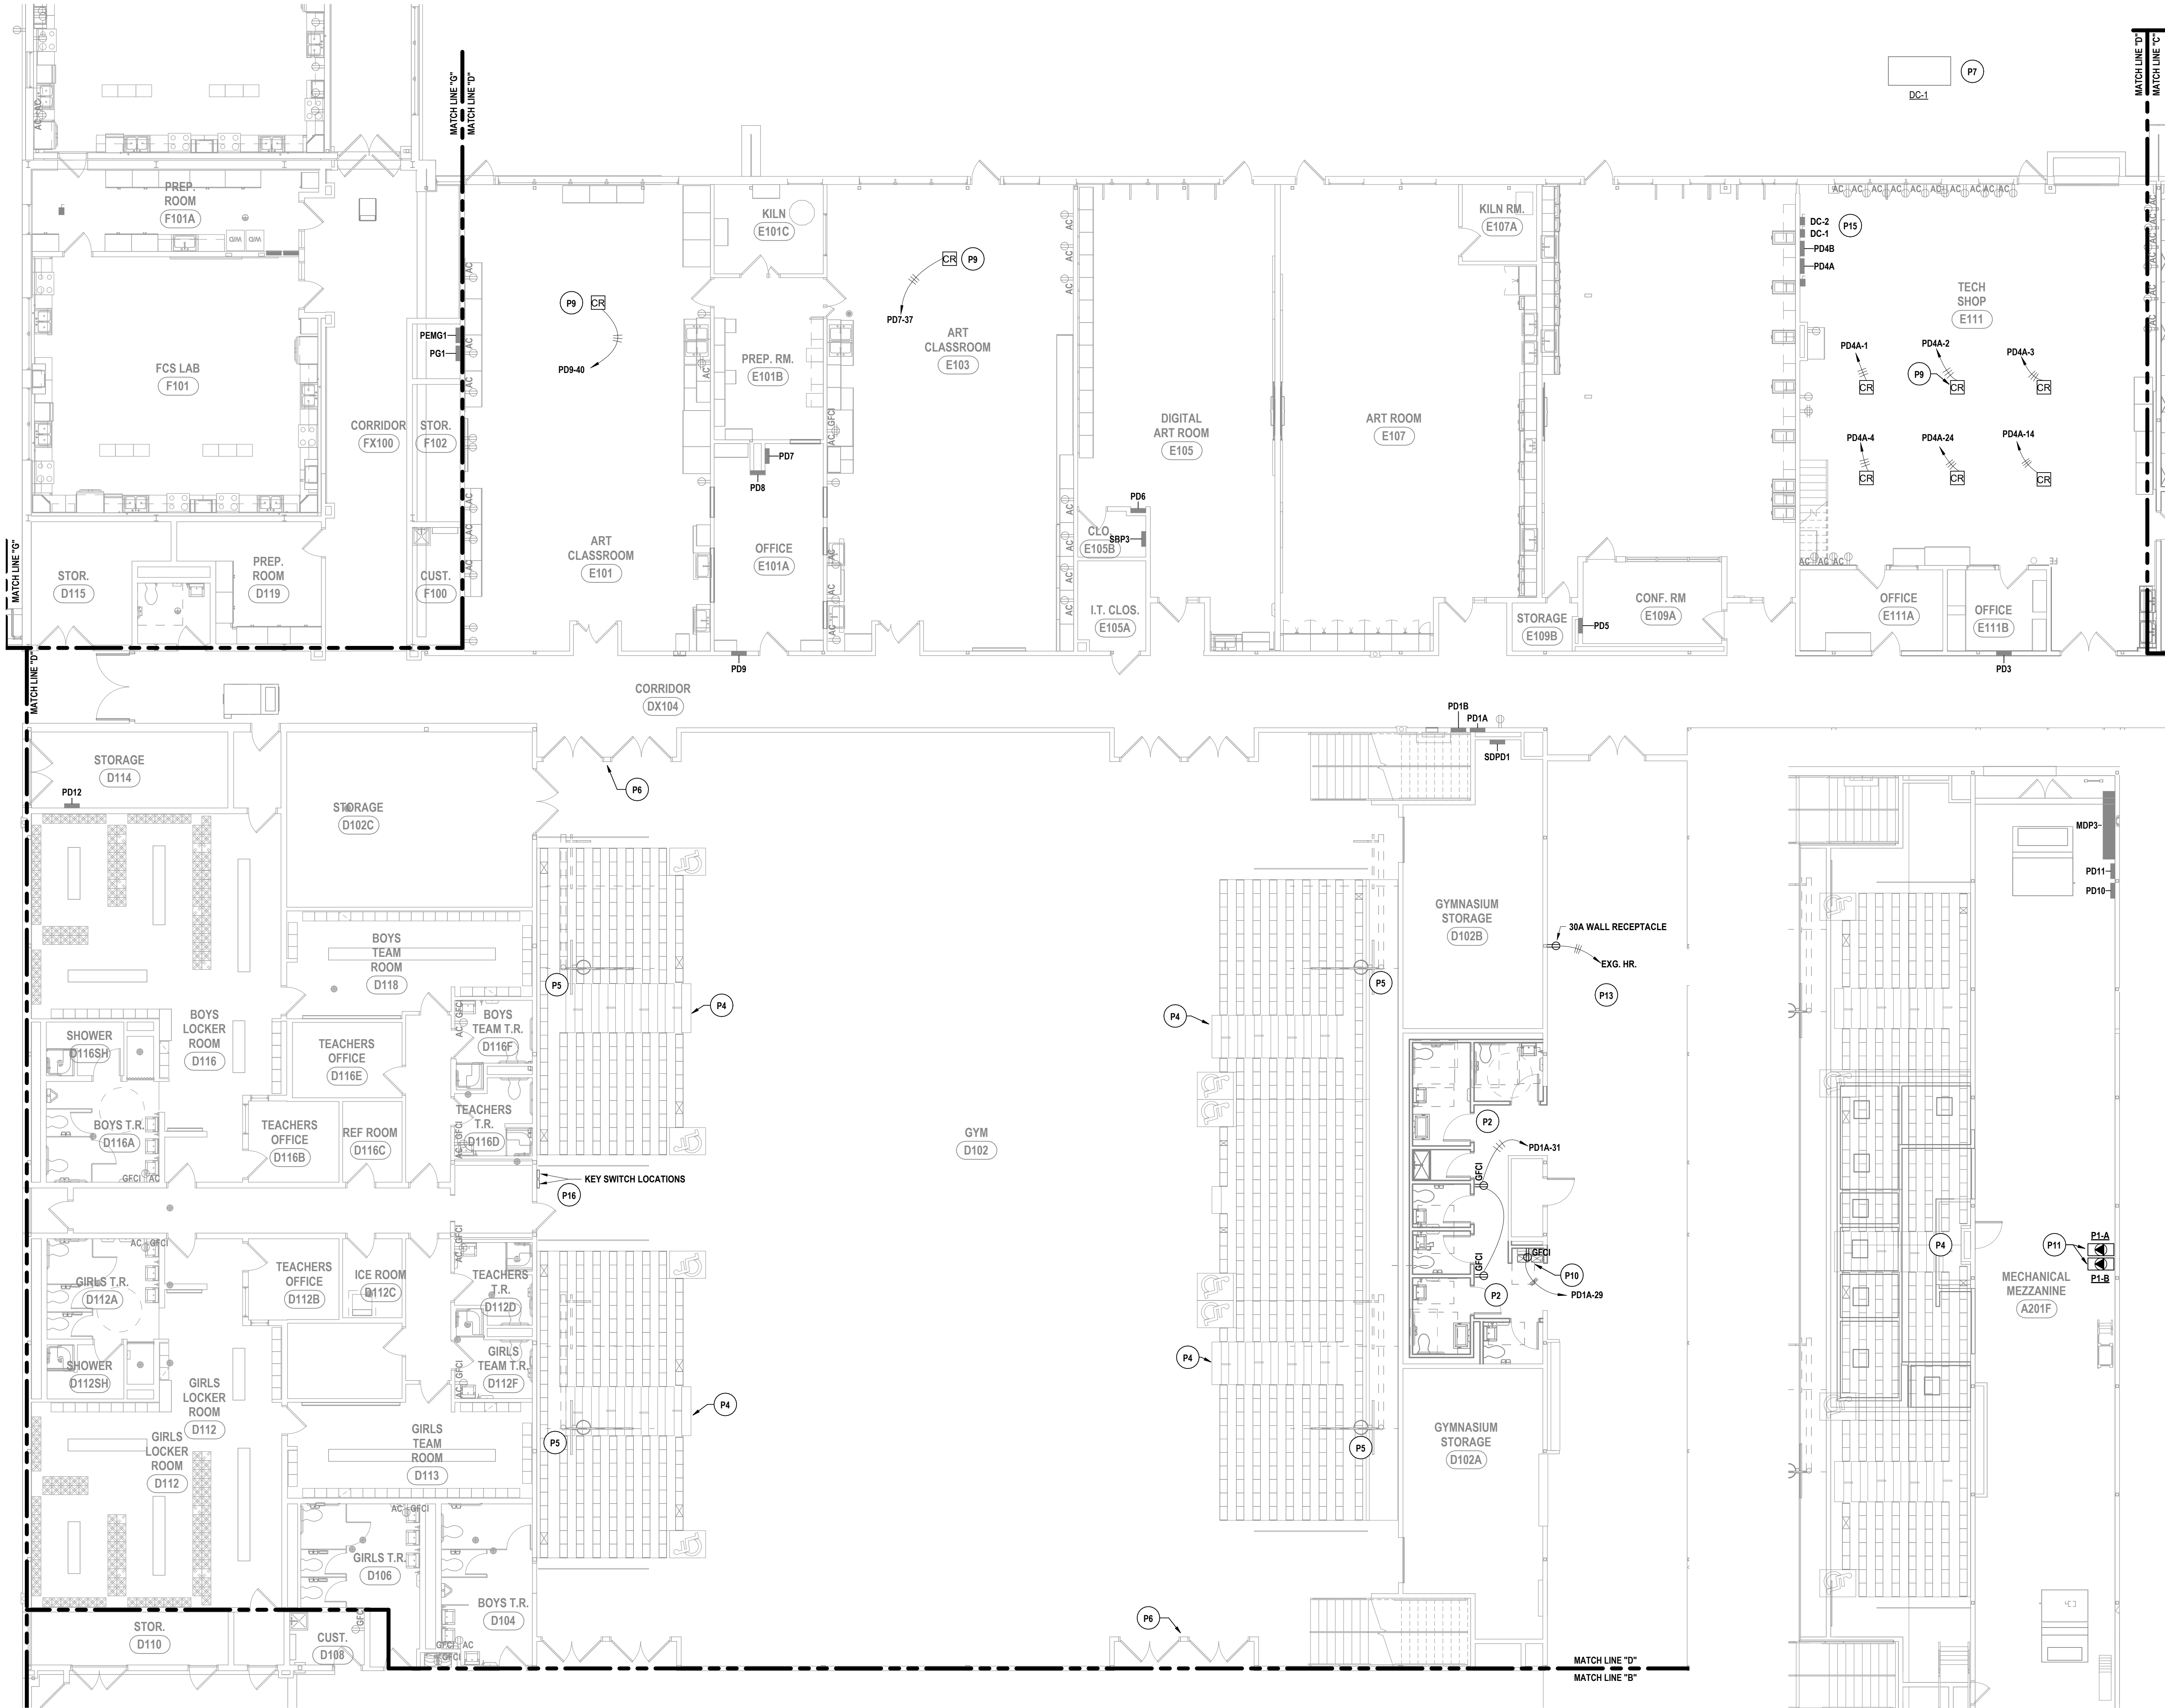
# DATE: 1 10/20/2025

IT IS A VIOLATION OF THE LAW FOR ANY PERSON TO MAKE UNAUTHORIZED ALTERATIONS OR ADDITIONS TO PLANS  
DRAWN & LOCATED: ENGINEERS, ARCHITECTS & SURVEYORS BUREAU

HUNT ENGINEERS | ARCHITECTS | SURVEYORS  
HORSEHEADS, NY 607-263-1000 ROCHESTER, NY 585-537-7868 TOWNANDRA, PA 570-265-4668  
BINGHAMTON, NY 607-738-8881 ALBANY, NY 607-738-8801  
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NY CERTIFICATE NO. 0016220 PA CERTIFICATE NO. TSC220013464-1


FIRST FLOOR POWER PLAN - AREA D  
2025 MIDDLE SCHOOL PHASE III ALTERATIONS PROJECT  
CORNING-PAINTED POST ASD  
35 VICTORY HIGHWAY, PAINTED POST, NY 14870

MS-E1.3  
PROJECT NO: 2649-133



1 FIRST FLOOR POWER PLAN - AREA D  
1/8" = 1'-0"

2 SECOND FLOOR POWER PLAN - BLEACHERS / MEZZ.  
1/8" = 1'-0"

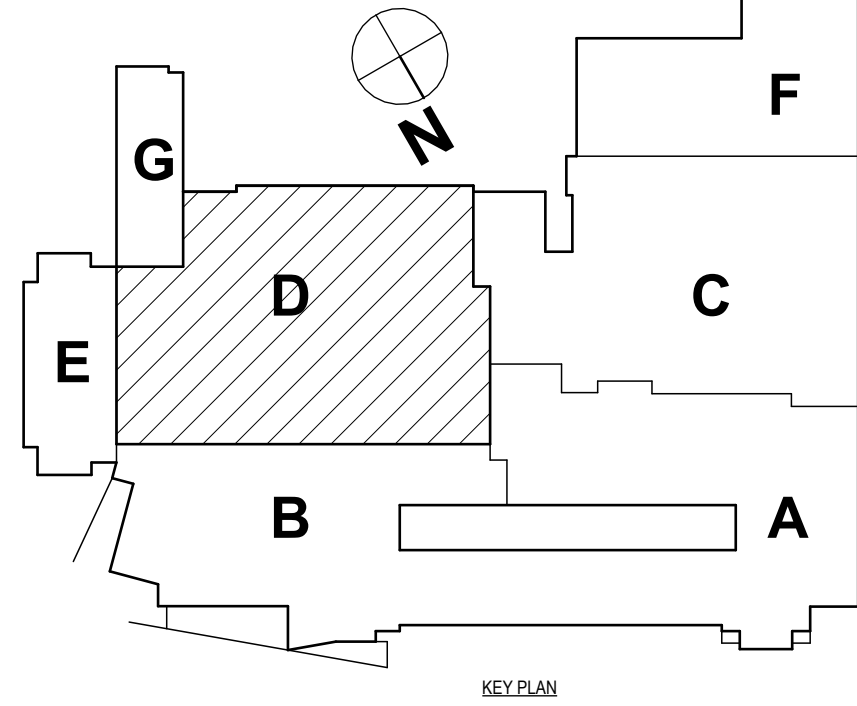

SED #: 57-000-01-000-044 - MIDDLE SCHOOL




REFER TO SHEET MS-E0.

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33.5 VICTORY HIGHWAY. PAINTED POST. NY 14870

PROJECT NO: 2649-153

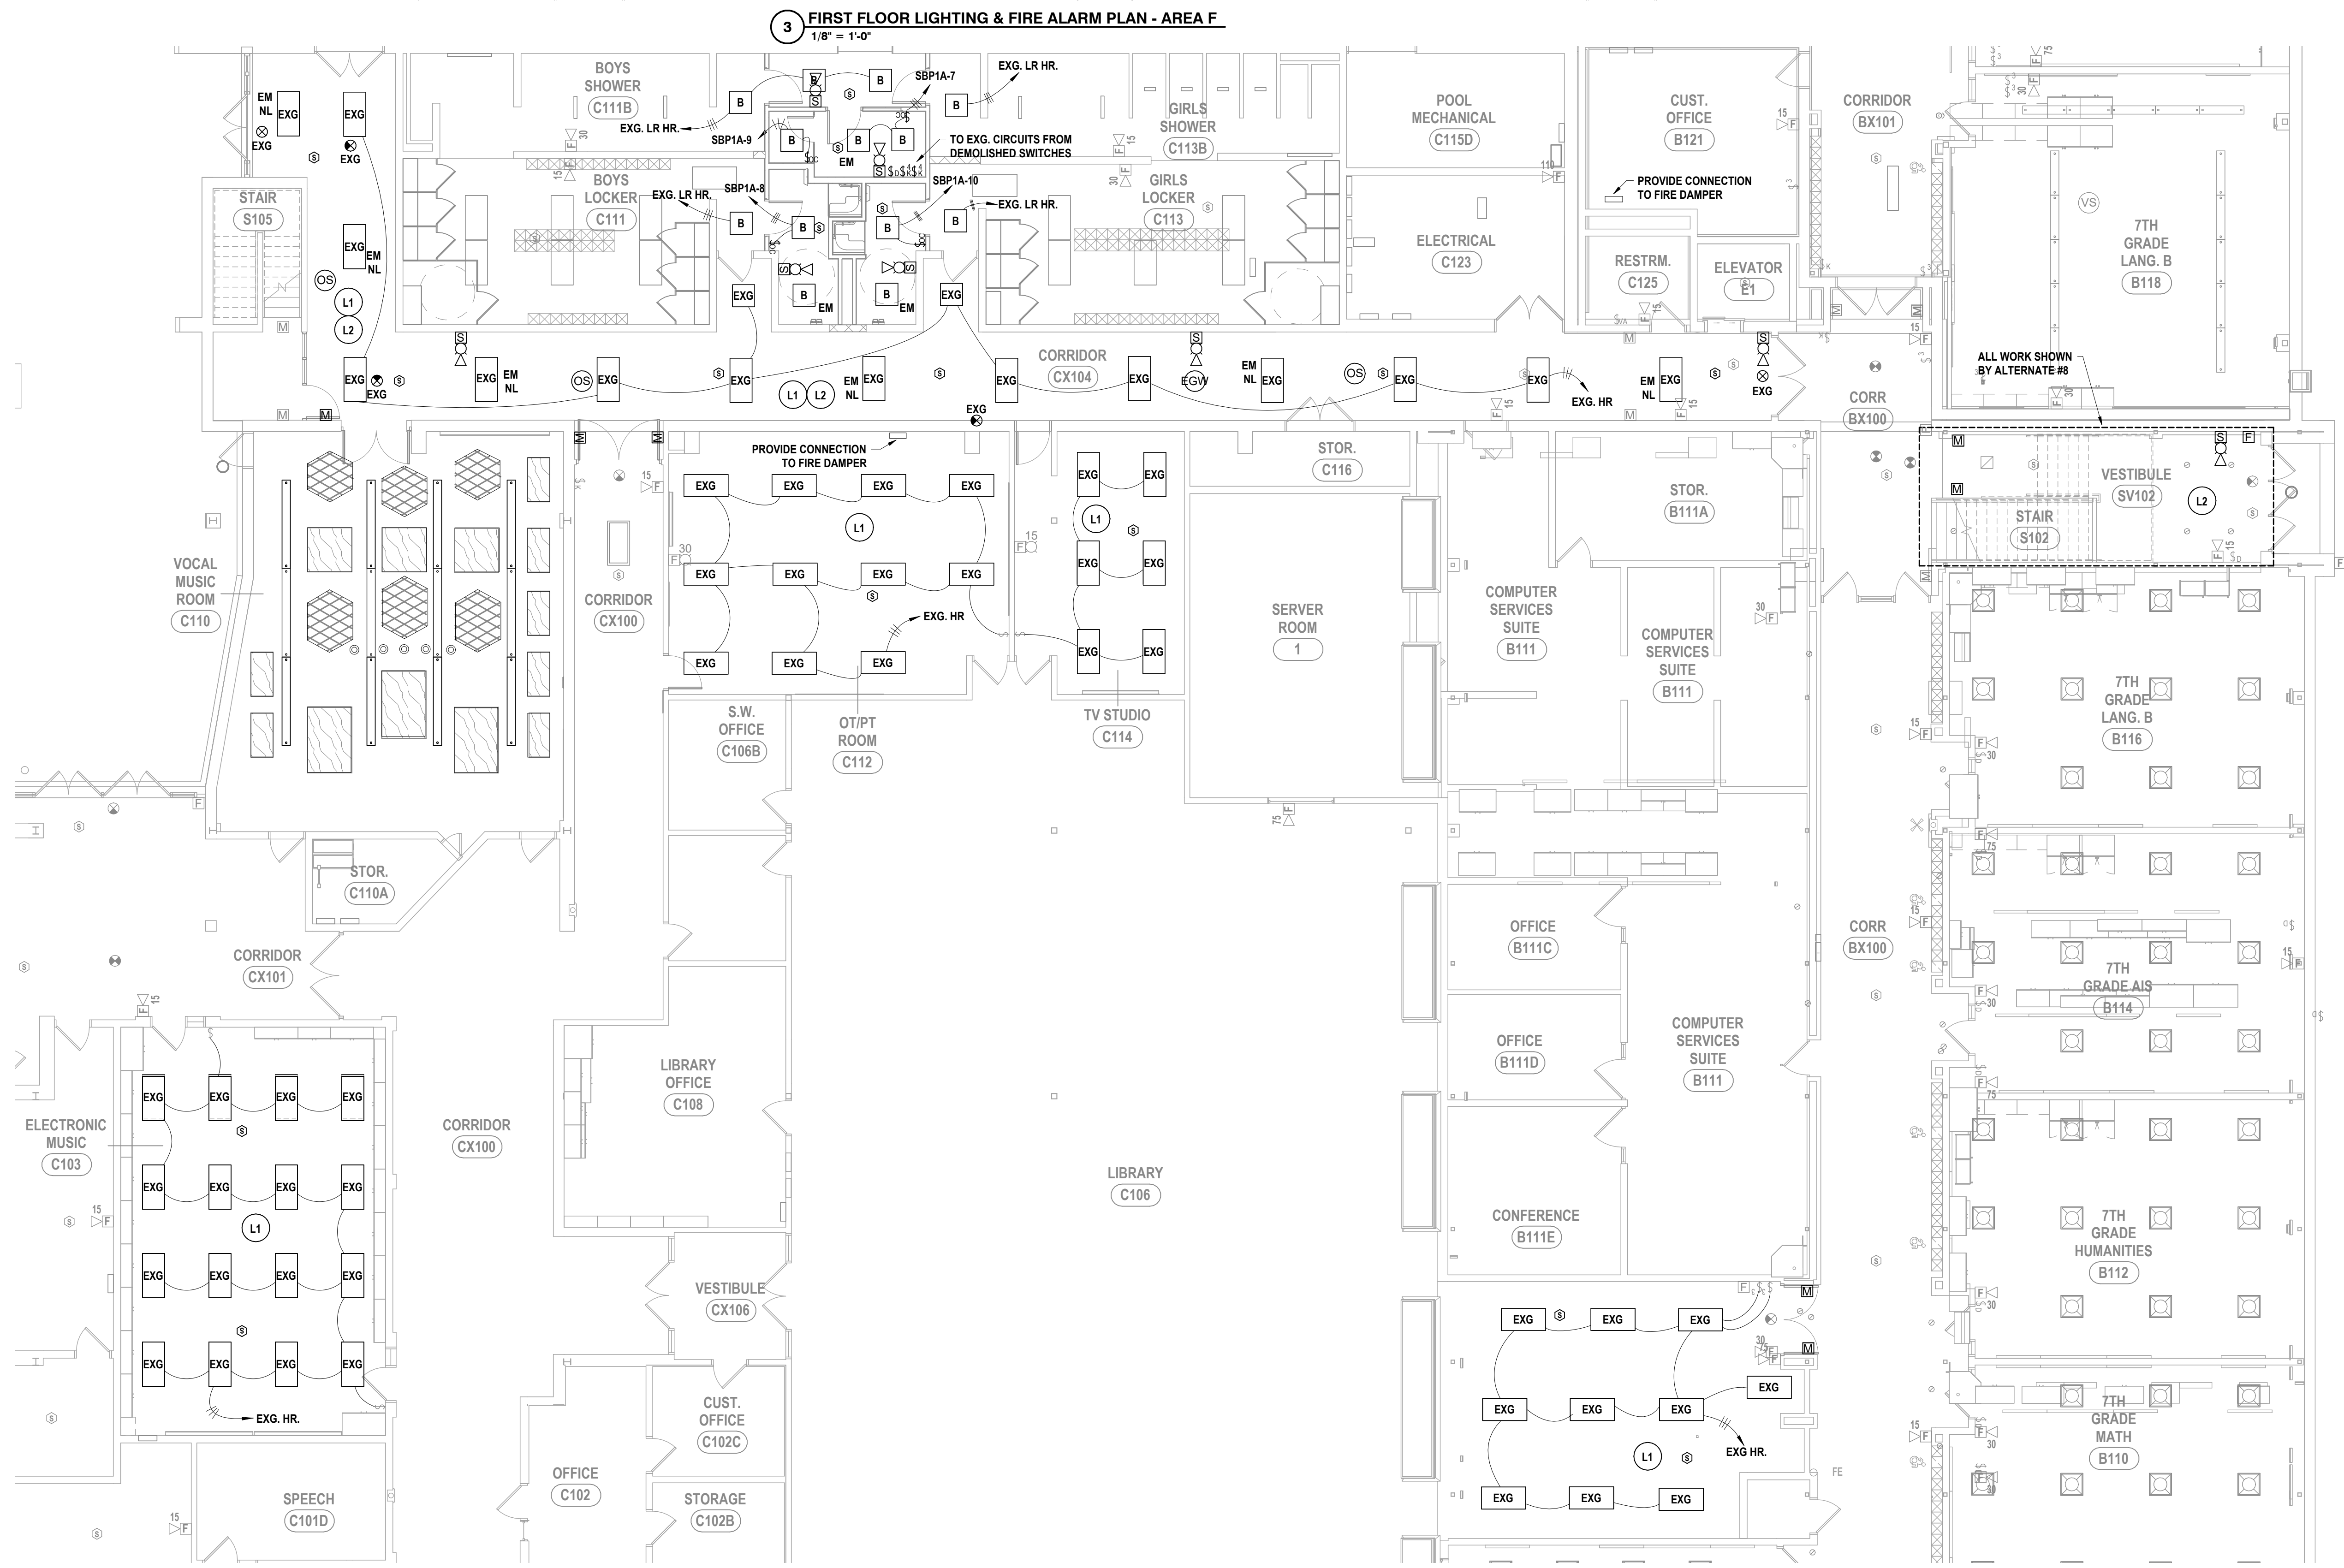


1 FIRST FLOOR LIGHTING & FIRE ALARM PLAN - AREA C  
1/8" = 1'-0"

### GENERAL NOTES - ELECTRICAL


REFER TO SHEET MS-E0.1

**CONSTRUCTION NOTES - LIGHTING & FIRE ALARM**


- L1 REINSTALL ALL EXISTING CEILING-MOUNTED ELECTRICAL DEVICES, FIXTURES, AND EQUIPMENT INTO NEW CEILING SYSTEM. CONNECT TO EXISTING BRANCH CIRCUITRY AND SWITCHING. MODIFY / EXTEND CIRCUITRY AS NEEDED.
- L2 UPON COMPLETION OF WALL TILING, RE-INSTALL ELECTRICAL DEVICES AND FIRE ALARM NOTIFICATION DEVICES IN EXISTING LOCATIONS. CONNECT TO PREVIOUSLY SECURED CIRCUITRY.
- L3 PROVIDE FIRE ALARM CONNECTION TO NEW SPARK ARRESTOR FOR THE DUST COLLECTION SYSTEM LOCATED IN CEILING DUCT. REFER TO E3.1 AND H.4 FOR MORE INFORMATION.
- L4 PROVIDE RECESS KIT IN ORDER TO RE-USE PREVIOUSLY SECURED LIGHTS IN NEW ACT CEILING. RECONNECT TO PREVIOUSLY SECURED CIRCUITRY. ENLIGHTENED DEVICES THAT WERE PREVIOUSLY SECURED FOR THE EXISTING CIRCUIT TO BE RE-INSTALLED. SEE DETAIL 1 AND 2 ON E3.2.
- L5 PROVIDE NEW CIRCUITRY FOR LIGHTING IN THIS SPACE. FROM PREVIOUSLY SALVAGED ENLIGHTENED DEVICES, PROVIDE AN DRIVER AND MICRO SENSOR PER EVERY GROUP OF SLB AND SLA FIXTURES AS SHOWN IN DRAWINGS. MICROSENSORS FOR BOTH GROUPINGS OF FIXTURES TO BE PLACED WITHIN THE EXTENTS OF THE ACT CLOUD. THESE FIXTURES TO BE CONNECTED TO PREVIOUSLY SECURED POWER LIGHTING HOME RUN AND COMMISSIONED TO EXISTING SWITCH IN SPACE. SEE DETAIL 1 AND 2 ON E3.2 FOR MORE INFORMATION.

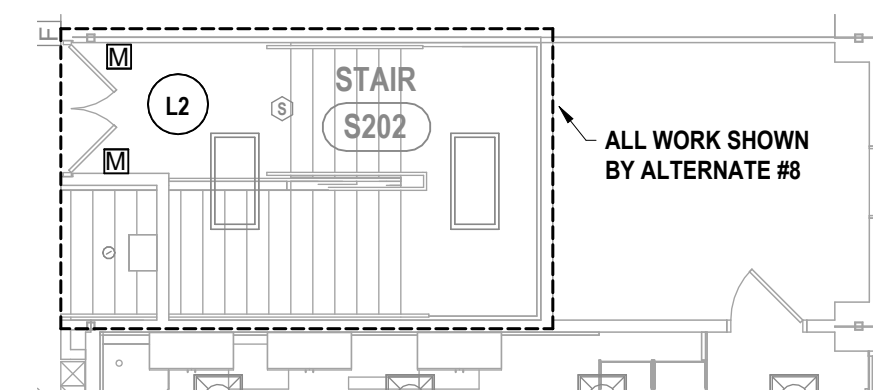

**4 SECOND FLOOR ELECTRICAL LIGHTING & FIRE ALARM PLAN - STAIR S202**  
1/8" = 1'-0"

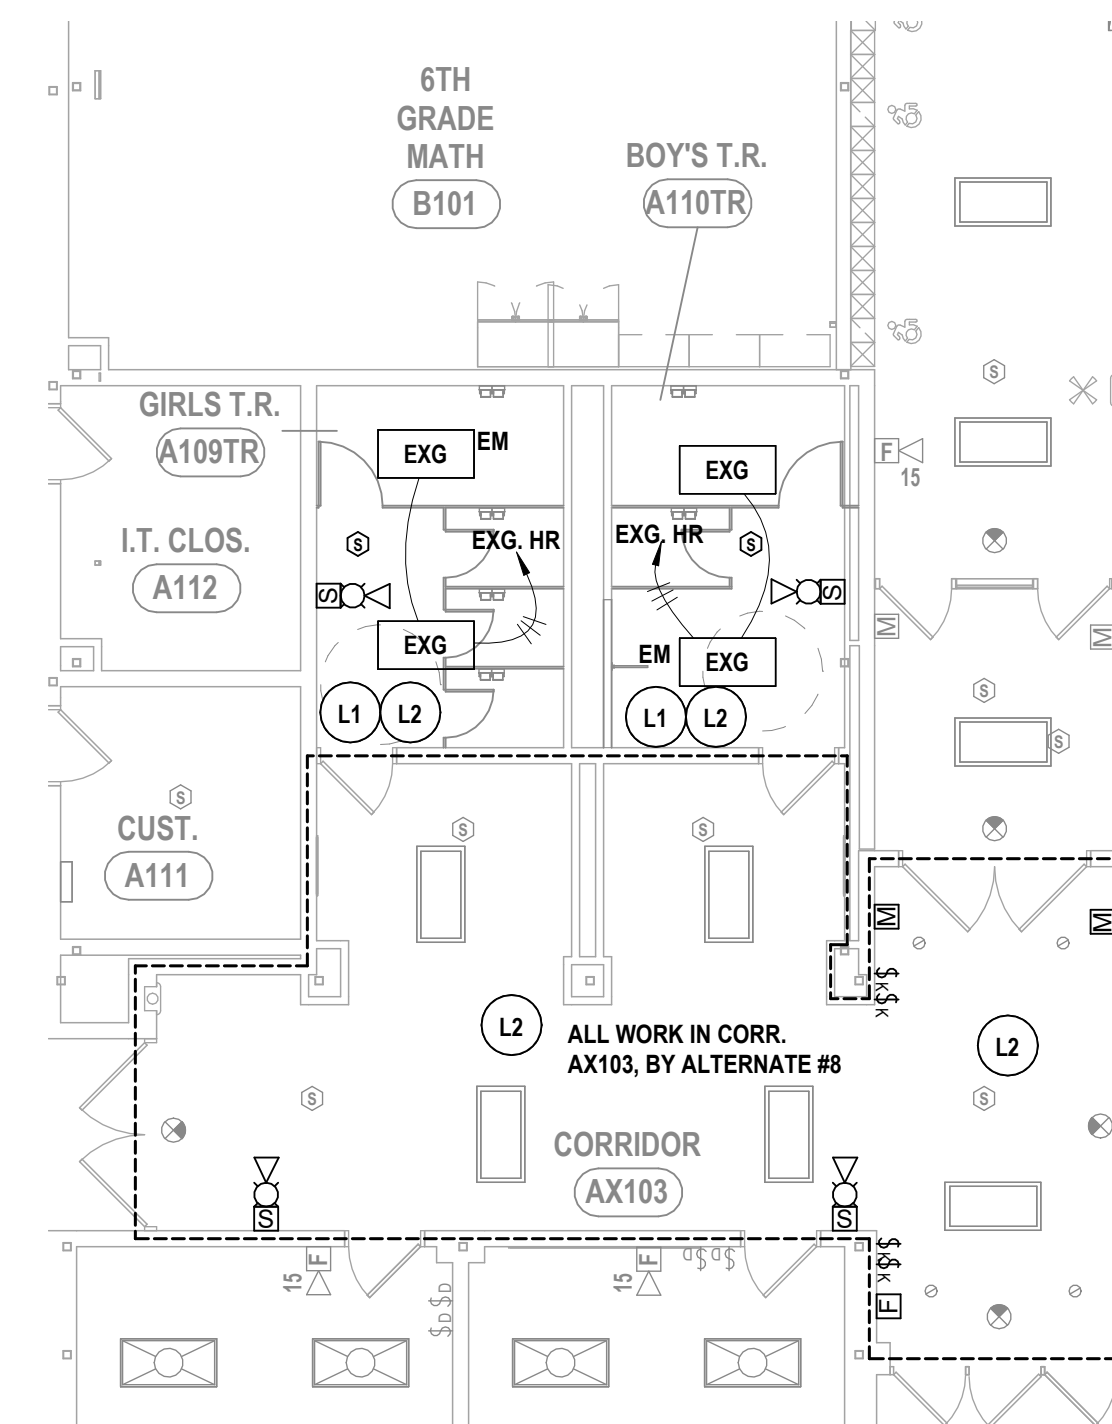

2 FIRST FLOOR LIGHTING & FIRE ALARM PLAN - AREA A Copy 1  
1/8" = 1'-0"

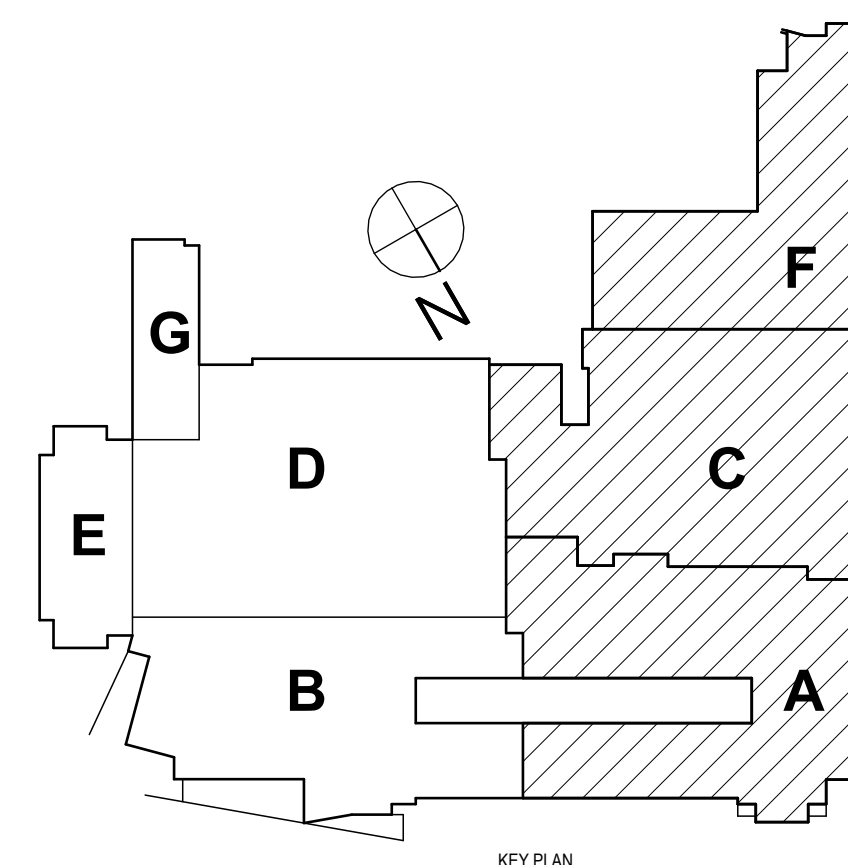

#	DATE:	11/02/2025	DESCRIPTION OF REVISION: ISSUED FOR BID		
DRAWN BY:					MDB
CHECKED BY:					TAWC
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PHASE:					CD
					"IT IS A VIOLATION OF THE LAW FOR ANY PERSON TO MAKE UNAUTHORIZED ALTERATIONS TO PLANS"



REFER TO SHEET MS-E0.1


REINSTATE ALL EXISTING CEILING-MOUNTED ELECTRICAL DEVICES, FIXTURES, AND EQUIPMENT IN NEW CEILING SYSTEM. CONNECT TO EXISTING BRANCH CIRCUITRY AND SWITCHING. MODIFY / EXTEND CIRCUITRY AS NEEDED.

UPON COMPLETION OF WALL TILING, RE-INSTALL ELECTRICAL DEVICES AND FIRE ALARM NOTIFICATION DEVICES IN EXISTING LOCATIONS. CONNECT TO PREVIOUSLY SECURED CIRCUITRY.

REMOVE EXISTING CONNECTION TO NEW SPOKES ARRESTOR FOR THE JUST OCEAN COLLECTION SYSTEM. LOCATE IN CEILING DUCT. REFER TO E-1 AND W-4 FOR MORE INFORMATION.

PROVIDE RECESS KIT IN ORDER TO RE-USE PREVIOUSLY SECURED LIGHTS IN NEW C.E. CEILING. RECONNECT TO PREVIOUSLY SECURED CIRCUITRY. ENLIGHTENED DEVICES THAT WERE PREVIOUSLY SECURED TO THE EXISTING CIRCUIT TO BE RE-INSTALLED. SEE DETAIL 1 AND 2 ON E-3.2.

PROVIDE NEW CIRCUITRY FOR LIGHTING IN THIS SPACE. FROM PREVIOUSLY SALVAGED ENLIGHTENED DEVICES. PROVIDE AN DRIVER AND MICRO SENSOR PER EVERY GROUP OF 8.1L AND 5.1L FIXTURES AS SHOWN ON DRAWINGS. MICROSENSORS FOR BOTH GROUPINGS OF FIXTURES TO BE PLACED WITHIN THE EXTENTS OF THE ACT CLOUD. THESE FIXTURES TO BE CONNECTED TO PREVIOUSLY SECURED ROOM LIGHTING HOME RUN AND COMMUNISHION TO FIGHTING SWITCH IN SPACE. SEE DETAIL 1 AND 2 ON E-3.2 FOR MORE INFORMATION.

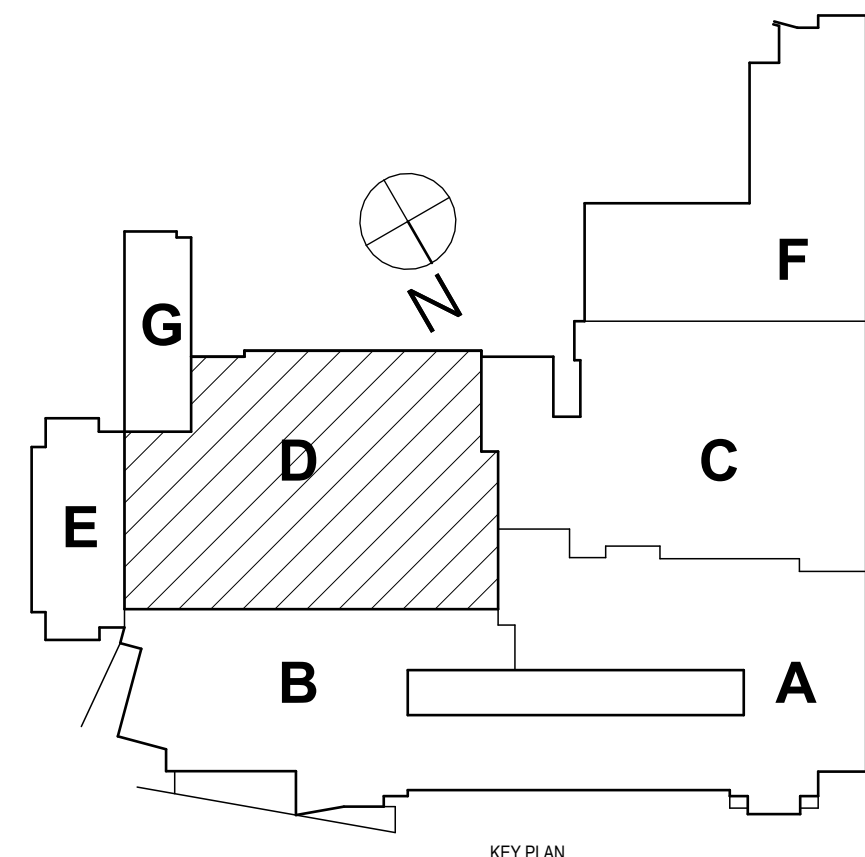

1 FIRST FLOOR LIGHTING & FIRE ALARM PLAN - AREA D - CORRIDOR DX103  
1/8" = 1'-0"

FIRST FLOOR LIGHTING & FIRE ALARM PLAN - AREA D  
2025 MIDDLE SCHOOL PHASE III ALTERATIONS PROJECT  
CORNING-PAINTED POST ASD

## MS-E2.2

PROJECT NO: 2649-153

**HUNT**  
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BINGHAMTON, NY 607-798-8081 ALBANY, NY 607-798-8081  
WWW.HUNT-EAS.COM  
NY CERTIFICATE NO. 0018220 PA CERTIFICATE NO. TSC2203131464-1

DRAWN BY:		MDB	
CHECKED BY:		TAWC	
DATE:		05/09/2025	
PHASE:		CD	
#	DATE:	DESCRIPTION OF REVISION: ISSUED FOR BID	IT IS A VIOLATION OF THE LAW FOR ANY PERSON TO MAKE UNAUTHORIZED ALTERATIONS OR ADDITIONS TO PLANS.
1	10/20/2025		

MECHANICAL EQUIPMENT CONNECTION AND CONTROL SCHEDULE																												
EQUIPMENT						SUPPLY			CONTROL DEVICES MOUNTED IN ROOMS AS SCHEDULED AND AS SHOWN ON PLANS (AU = AT UNIT)																			
IDENTIFICATION / TAG	DESCRIPTION	LOCATION (ROOM #)	HORSEPOWER / KILOWATTS / FLA / MCA	PHASE	VOLTAGE	PANEL OR CONTROL CENTER	CIRCUIT BREAKER	WIRE SIZE	REFERENCE NOTES	DISCONNECT SWITCH (FURNISHED & INSTALLED BY E.C.)	DISCONNECT SWITCH (FURNISHED BY H.C. & INSTALLED BY E.C.)	PRE-WIRED FACTORY MOUNTED DISCONNECT SWITCH (BY MFR.)	MANUAL MOTOR STARTER (FURNISHED & INSTALLED BY E.C.)	MAGNETIC STARTER (FURNISHED & INSTALLED BY E.C.)	COMBINATION STARTER (FURNISHED & INSTALLED BY E.C.)	VARIABLE SPEED DRIVE (FURNISHED & INSTALLED BY E.C.)	VFD PACKAGE (FURNISHED & INSTALLED BY H.C. CONNECTED BY E.C.)	VFD WITH CHOKE (FURNISHED BY H.C. & INSTALLED BY E.C.)	PACKAGED CONTROL UNIT	SINGLE POINT CONNECTION	FAN SHUTDOWN UPON FACP ACTIVATION (X<1000CFM)	DUCT SMOKE DETECTOR IN RETURN DUCT (X<2000CFM)	BOILER SHUTDOWN SAFETY SWITCH	LINE VOLTAGE THERMOSTAT (FURNISHED BY H.C. & INSTALLED BY E.C.)	FACTORY MOUNTED STARTER & DISCONNECT (BY MFR.)	F/A CONNECTION FOR SPARK DETECTOR	PROVIDE 20AMP, 120V GFCI RECEPTACLE IN WEATHERPROOF ENCLOSURE AT UNIT	
DC-1	OUSIDE DUST COLLECTOR	TECH. E111	10 HP	3	208V	PD4B	80A/3P	(3)#8, (1)#8G IN 1" C				X					X											
CUH-1	CABINET UNIT HEATER	CR. CX104	2.75 MCA	1	120V	PC7B/52	20A/1P	(2)#12, (1)#12G IN 3/4" C	A				X															
CUH-2	CABINET UNIT HEATER	CR. CX104	2.75 MCA	1	120V	PC7B/54	20A/1P	(2)#12, (1)#12G IN 3/4" C	A				X															
EF-2	EXHAUST FAN	OFF. B121	1/4 HP	1	120V	PC7B/77	20A/1P	(2)#12, (1)#12G IN 3/4" C	A				X															
ACCU-1	AIR COOLED CONDENSING UNIT	ROOF	16 MCA	1	208V	PC9A/B	25A/2P	(2)#10, (1)#10G IN 3/4" C	B			X																
EV-1	EVAPORATOR	OFF. B121	1 MCA	1	208V	PC7B/82	20A/2P	(2)#12, (1)#12G IN 3/4" C					X															
P-1A+B	PUMP	MECH. A201F	10 HP	3	208V	MDP-3	80A/3P	(3)#8, (1)#8G IN 1" C		X								X										
UV-1	UNIT VENTILATOR	A207	12 MCA	1	120V	PA13	20A/1P	(2)#12, (1)#12G IN 3/4" C																				
UV-2	UNIT VENTILATOR	C112	12 MCA	1	120V	PC7B/84	20A/1P	(2)#12, (1)#12G IN 3/4" C																				
RTU-1	ROOF TOP UNIT	ROOF	177 MCA	3	208V	MDP-2	225A/3P	(3)#250, (1)#4G IN 3" C	C				X															

NOTE: ALL DEVICES / EQUIPMENT / HARDWARE SHALL BE SUITABLE FOR USE IN THE ENVIRONMENT INDICATED. SEE SPECIFICATIONS FOR FURTHER INFORMATION.

MECHANICAL EQUIPMENT CONNECTION AND CONTROL SCHEDULE REFERENCE NOTES:

- A. SPARE 20A/1P BREAKERS ALREADY EXIST IN PANEL SPACE.  
B. PC9A/B LOCATED IN STORAGE B221 ON SECOND FLOOR AREA C.  
C. ALL ASSOCIATED WORK BY ALTERNATE #5.

Branch Panel: SBP1A															
Location: ELECTRICAL C123 Supply From: MDP-1 Mounting: Surface Enclosure: Type 1						Volts: 120/208 Wye Phases: 3 Wires: 4				A.I.C. Rating: 10KAIC Mains Type: MLO Mains Rating: 400 A					
CKT	Circuit Description	Trip	Poles	A	B	C	Poles	Trip	Circuit Description	CKT					
1	LTS B107 (EXG LOAD)	20 A	1				1	20 A	LTS B107A (EXG LOAD)	2					
3	LTS B 107C B107D (EXG LOAD)	20 A	1				1	20 A	LOCKER ROOM TR RECEPTS.	4					
5	LOCKER RM OFFICE RECEPTS.	20 A	1				1	20 A	LTS B107B B107E REC B107 (EXG)	6					
7	LOCKER ROOM OFFICE LIGHTS	20 A	1				1	20 A	GIRLS LOCKER ROOM TR LIGHTS	8					
9	SWIMSUIT DRYER	20 A	1				1	20 A	BOYS LOCKER ROOM TR LIGHTS	10					
11	MEDIA DECK DUPLEX RECEPT.	20 A	1				1	20 A	MEDIA DECK QUAD RECEPT.	12					
13	ALTERNATE #6 SCOREBOARD RECEPTACLE	20 A	1				1	20 A	SPARE (EXG)	14					
15	REC PRINTER B107 (EXG LOAD)	20 A	1				1	20 A	REC COPIER B107 (EXG LOAD)	16					
17	CRV-1 (EXG LOAD)	100 A	3				3	15 A	ACCU-1 (EXG LOAD)	18					
19	--	--	--				--	--	--	20					
21	--	--	--				--	--	--	22					
23	SHUNT TRIP (EXG LOAD)	--	1				3	15 A	ACCU-3 (EXG LOAD)	24					
25	CRV-3 (EXG LOAD)	100 A	3				--	--	--	26					
27	--	--	--				--	--	--	28					
29	--	--	--				1	20 A	REC GFCI ROOF (EXG LOAD)	30					
31	SHUNT TRIP (EXG LOAD)	--	1				--	--	BLANK	32					
33	DOOR LATCH POWER (EXG LOAD)	20 A	1				1	--	BLANK	34					
35	BLANK	--	1				1	--	BLANK	36					
37	BLANK	--	1				1	--	BLANK	38					
39	BLANK	--	1				1	--	BLANK	40					
41	BLANK	--	1				--	--	BLANK	42					
Notes:															

Branch Panel: PD4A										
Location: TECH SHOP E111 Supply From: SDPD1 Mounting: Surface Enclosure: Type 1					Volts: 120/208 Wye Phases: 3 Wires: 4			A.I.C. Rating: 10KAIC Mains Type: MLO Mains Rating: 225 A		
CKT	Circuit Description	Trip	Poles	A	B	C	Poles	Trip	Circuit Description	CKT
1	CORD REEL	20 A	1				1	20 A	CORD REEL	2
3	CORD REEL	20 A	1				1	20 A	CORD REEL	4
5	COMPRESSOR OUTLET (EXG)	20 A	1				1	20 A	EXG. LOAD	6
7	MITER BOX (EXG)	20 A	1				3	20 A	EXG. LOAD	8
9	POWERMATIC BANDSAW (EXG)	20 A	1				--	--	--	10
11	BAND SAW (EXG)	20 A	1				--	--	--	12
13	SPARE (EXG0	30 A	3				1	20 A	CORD REEL	14
15	--	--	--				2	20 A	TABLE SAW (EXG)	16
17	--	--	--				--	--	--	18
19	SPARE (EXG)	30 A	3				1	20 A	SCROLL SAW (EXG)	20
21	--	--	--				1	20 A	BAND SAW (EXG)	22
23	--	--	--				1	20 A	CORD REEL	24
25	JOINTER (EXG)	30 A	3				3	20 A	PLANER (EXG)	26
27	--	--	--				--	--	--	28
29	--	--	--				--	--	--	30
31	JOINTER (EXG)	30 A	3				3	20 A	JIG SAW (EXG)	32
33	--	--	--				--	--	--	34
35	--	--	--				--	--	--	36
37	DC-1	15 A	3				3	20 A	DC-2	38
39	--	--	--				--	--	--	40
41	--	--	--				--	--	--	42
Notes:										


Panel: PD1A												
Location: CORRIDOR DX104 Supply From: SDPD1 Mounting: Recessed Enclosure: Type 1						Volts: 120/208 Wye Phases: 3 Wires: 4			A.I.C. Rating: 10KAIC Mains Type: MLO Mains Rating: 225 A			
CKT	Circuit Description	Trip	Poles	A	B	C	Poles	Trip	Circuit Description	CKT		
1	BLEACHERS (EXISTING LOAD)	20 A	2				1	20 A	EXISTING LOAD	2		
3	--	--	--				1	20 A	EXISTING LOAD	4		
5	EXISTING LOAD	20 A	1				1	20 A	EXISTING LOAD	6		
7	EXISTING LOAD	20 A	1				1	20 A	EXISTING LOAD	8		
9	EXISTING LOAD	20 A	1				1	20 A	TR. D126A/B LIGHTING	10		
11	EXISTING LOAD	20 A	1				1	20 A	EXISTING LOAD	12		
13	LIGHTS D145 (EXISTING LOAD)	20 A	1				1	20 A	TR. D126C/D LIGHTING	14		
15	EXISTING LOAD	20 A	1				1	20 A	LIGHTS D143 (EXG LOAD)	16		
17	EXISTING LOAD	20 A	1				1	20 A	SPARE (EXG LOAD)	18		
19	HALL RECEPTACLE / VENDING MACHINE RECEPTACLE (EXG...	20 A	1				1	20 A	SPARE (EXG LOAD)	20		
21	EXISTING LOAD	20 A	1				1	20 A	OUTSIDE LIGHTS (EXISTING LOAD)	22		
23	EXISTING LOAD	20 A	1				1	20 A	OUTSIDE LIGHTS (EXISTING LOAD)	24		
25	EXISTING LOAD	20 A	1				1	20 A	EXISTING LOAD	26		
27	EXISTING LOAD	20 A	1				1	20 A	EXISTING LOAD	28		
29	DRINKING FOUNTAIN GFCI	20 A	1				1	20 A	EXISTING LOAD	30		
31	BATHROOM GFCI RECEPTS.	20 A	1				1	20 A	EXISTING LOAD	32		
33	TR. D126E LIGHTING	20 A	1				1	20 A	EXISTING LOAD	34		
35	TR. D126F/G LIGHTING	20 A	1				1	20 A	EXISTING LOAD	36		
37	EXISTING LOAD	20 A	3				3	20 A	EXISTING LOAD	38		
39	--	--	--				--	--	--	40		
41	--	--	--				--	--	--	42		
Notes:												


Branch Panel: PD7										
Location: OFFICE E101A Supply From: SDPD1 Mounting: Recessed Enclosure: Type 1						Volts: 120/208 Wye Phases: 3 Wires: 4			A.I.C. Rating: 10KAIC Mains Type: MLO Mains Rating: 150 A	
CKT	Circuit Description	Trip	Poles	A	B	C	Poles	Trip	Circuit Description	CKT
1	(EXG LOAD)	20 A	1				1	20 A	DAY PANEL (EXG LOAD)	2
3	(EXG LOAD)	20 A	1				1	20 A	(EXG LOAD)	4
5	(EXG LOAD)	20 A	1				1	20 A	(EXG LOAD)	6
7	(EXG LOAD)	20 A	1				1	20 A	D137A LIGHTS	8
9	(EXG LOAD)	20 A	1				1	20 A	D137A RECEPTACLE	10
11	D137 RECEPTACLE (EXG LOAD)	20 A	1				1	20 A	(EXG LOAD)	12
13	BLANK	--	1				3	90 A	AHU-1 RETURN FAN (EXG LOAD)	14
15	(EXG LOAD)	20 A	1				--	--	--	16
17	KILN EXHAUST (EXG LOAD)	20 A	1				--	--	--	18
19	AHU-4 (EXG LOAD)	50 A	3				3	40 A	AHU-1 SUPPLY FAN (EXG LOAD)	20
21	--	--	--				--	--	--	22
23	--	--	--				--	--	--	24
25	BLANK	--	1				3	60 A	(EXG LOAD)	26
27	KILN (EXG LOAD)	50 A	2				--	--	--	28
29	--	--	--				--	--	--	30
31	D137 RECEPT RACEWAY (EXG)	20 A	1				1	20 A	D137B RECEPT. (EXG LOAD)	32
33	AC D135 (EXG LOAD)	20 A	2				1	20 A	D137B RECEPT. (EXG LOAD)	34
35	--	--	--				1	20 A	D135 CORD REEL (EXG LOAD)	36
37	E103 CORD REEL	20 A	1				1	20 A	SPARE (EXG)	38
39	UNDERCABINET LIGHTING	20 A	1				1	20 A	SPARE (EXG)	40
41	SPARE (EXG)	20 A	1				1	20 A	SPARE (EXG)	42
Notes: PROVIDE NEW 20A/2P BREAKER FOR LOAD ON SPACE 33-35										

LIGHT FIXTURE SCHEDULE											
TYPE	DESCRIPTION	SIZE	MOUNTING	VOLTAGE	LUMENS	LED COLOR TEMP	LOAD EA. (WATTS)	MANUFACTURER/CATALOG NO.	FINISH	REMARKS	NOTES
A	RECESSED TROFFER	2X4	RECESSED	UNIV	4581	3000-5000K CCT	34W	ILP #VOLA24-49L-U-40-SR	-	-	1
B	RECESSED FLAT PANEL	2X2	RECESSED	UNIV	3000	3500-5000K CCT	32W	SIGNIFY #2FP230L840-2-DS-UNV-DIM	-	-	-
C	EXTERIOR RECESSED CAN	8"	RECESSED	UNIV	2500	2700-5000K CCT	33W	LITELINE #RA56-33-P-W-WH-WH-NC	-	SET TO 4000K	-
D	EXTERIOR LINEAR	3"	SURFACE	UNIV	975	4000K	33W	PRUDENTIAL #WETBP303-LIN-FLSH-LED4-SQ-4-WETTMW-8TW-SC-UNV-WMU-SUR-OM01	-	-	2
E	RECESSED TROFFER	2X2	RECESSED	UNIV	4581	3000-5000K CCT	34W	ILP #VOLA22-49L-U-40-SR	-	-	-
F	PENDANT UP/DOWN LIGHT	2'	SURFACE	UNIV	64000	5000K	435W	LUX #WAVEP-2-850-U10-WSA2-DEF2	-	-	-
LIGHT FIXTURE SCHEDULE NOTES:											
1. SET DEFAULT SETTINGS TO MATCH EXISTING											
2. PROVIDE PHOTOCELL CONTROL											




DRAWN BY:		MOB
CHECKED BY:		TAWC
DATE:		05/09/2025
PHASE:		CD
#	DATE:	DESCRIPTION OF REVISION:
1	10/02/2025	ISSUED FOR BID
IT IS A VIOLATION OF THE LAW FOR ANY PERSON TO MAKE UNAUTHORIZED ALTERATIONS OR ADDITIONS TO PLANS BEARING A LICENSED ENGINEER, ARCHITECT OR SURVEYOR'S SEAL.		

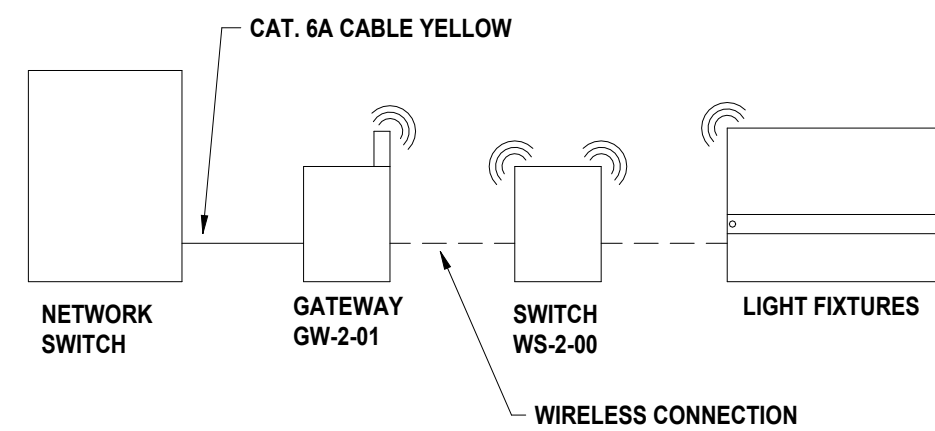

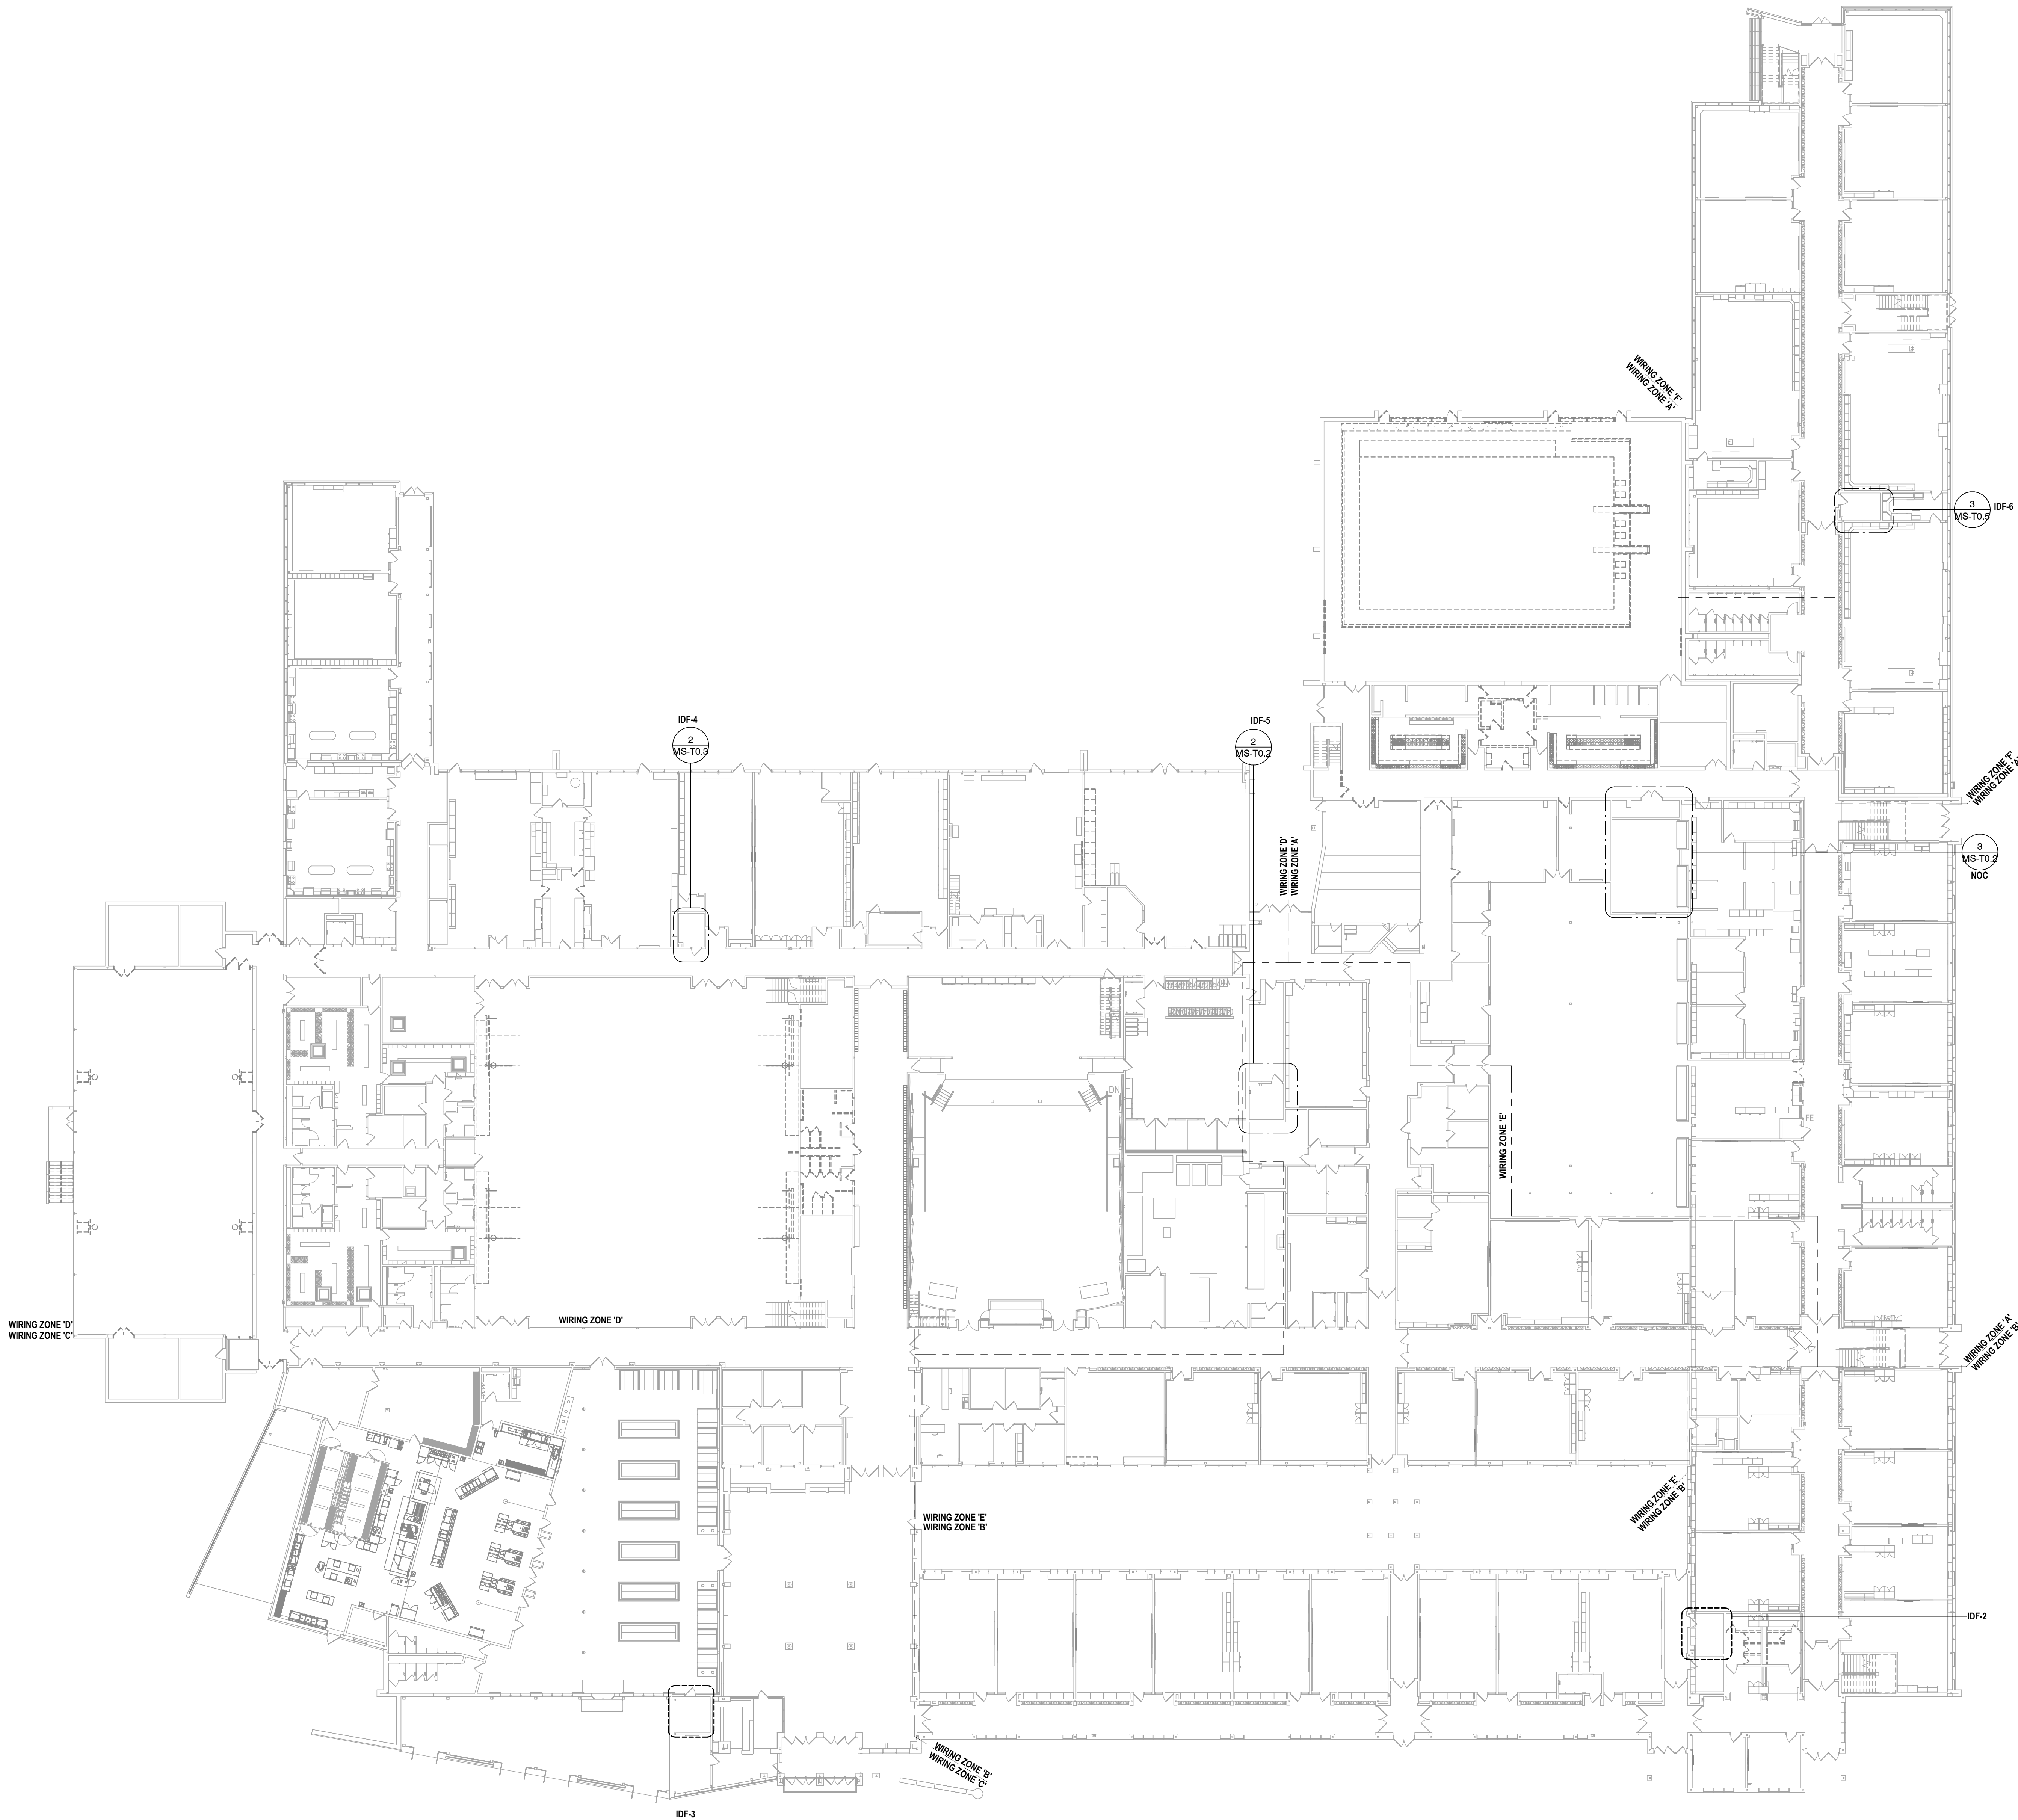

- GENERAL NOTES**
- A ALL CABLING INSTALLATION AND TERMINATION TO ADHERE TO CURRENT NEC CODES AND RELATED ANSI/TIA/EIA STANDARDS.
  - B DURING INSTALLATION OF CABLING, ANY DAMAGE TO ANY FUNCTIONING CABLING SYSTEM IS THE RESPONSIBILITY OF, AND WILL, BE REPAIRED BY THE CONTRACTOR.
  - C WHEN INSTALLING CEILING MOUNTED DEVICES, ADJUST LOCATION TO AVOID OTHER CEILING MOUNTED DEVICES SUCH AS EXIT SIGNS, ECT.
  - D ALL DATA CABLING SHALL BE PLENUM RATED PER SPECIFICATIONS.
  - E OWNER TO APPROVE FINAL LOCATION AND VIEW OF ALL CAMERAS.
  - F ALL ELECTRONIC AND NETWORKING SERVICES NEED TO BE COORDINATED WITH OWNER PRIOR TO REMOVAL AND DISCONNECTION.
  - G ALL CEILING MOUNTED DEVICES TO BE SUPPORTED BY STRUCTURE ABOVE. DO NOT USE CEILING GRID AS SOLE SUPPORT MECHANISM.

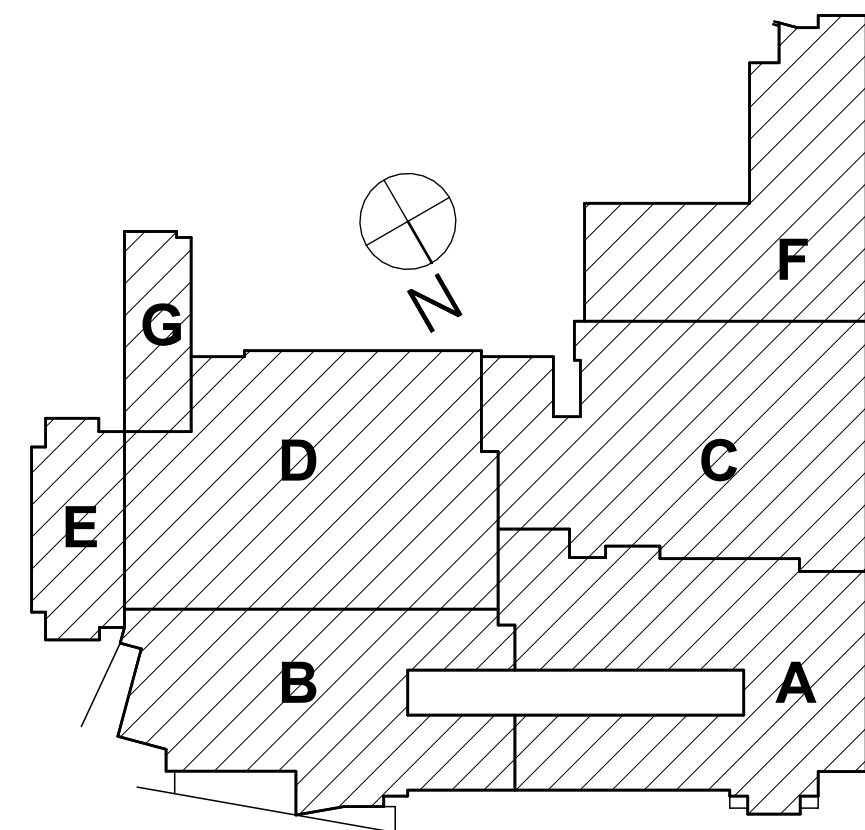

1 FIRST FLOOR TECHNOLOGY DEMO KEY PLAN  
3/64" = 1'-0"

SED #: 57-000-01-000-004 - MIDDLE SCHOOL

FIRST FLOOR TECHNOLOGY DEMO KEY PLAN  
2025 MIDDLE SCHOOL PHASE III ALTERATIONS PROJECT  
CORNING-PAINTED POST ASD  
35 VICTORY HIGHWAY, PAINTED POST, NY 14870

MS-T0.1  
PROJECT NO: 2649-133

**HUNT** ENGINEERS | ARCHITECTS | SURVEYORS  
HORSEHEADS, NY 607-253-1000 ROCHESTER, NY 585-537-7500 TONAWANDA, PA 570-265-4606  
BINGHAMTON, NY 607-798-8881 ALBANY, NY 607-798-8881  
WWW.HUNTEAS.COM  
NY CERTIFICATE NO. 0016220 PA CERTIFICATE NO. TSC220013/464-1


#	DATE	DESCRIPTION OF REVISION:
1	11/03/2023	ISSUED FOR BID

IT IS A VIOLATION OF THE LAW FOR ANY PERSON TO MAKE UNAUTHORIZED ALTERATIONS OR ADDITIONS TO PLANS  
DRAWN & LOCATED, DIMENSIONED, MANUFACTURED & SUBMITTED BY DATE:

DRAWN BY:	LAD
CHECKED BY:	CSH
DATE:	05/09/2023
PHASE:	CD

05/09/2023



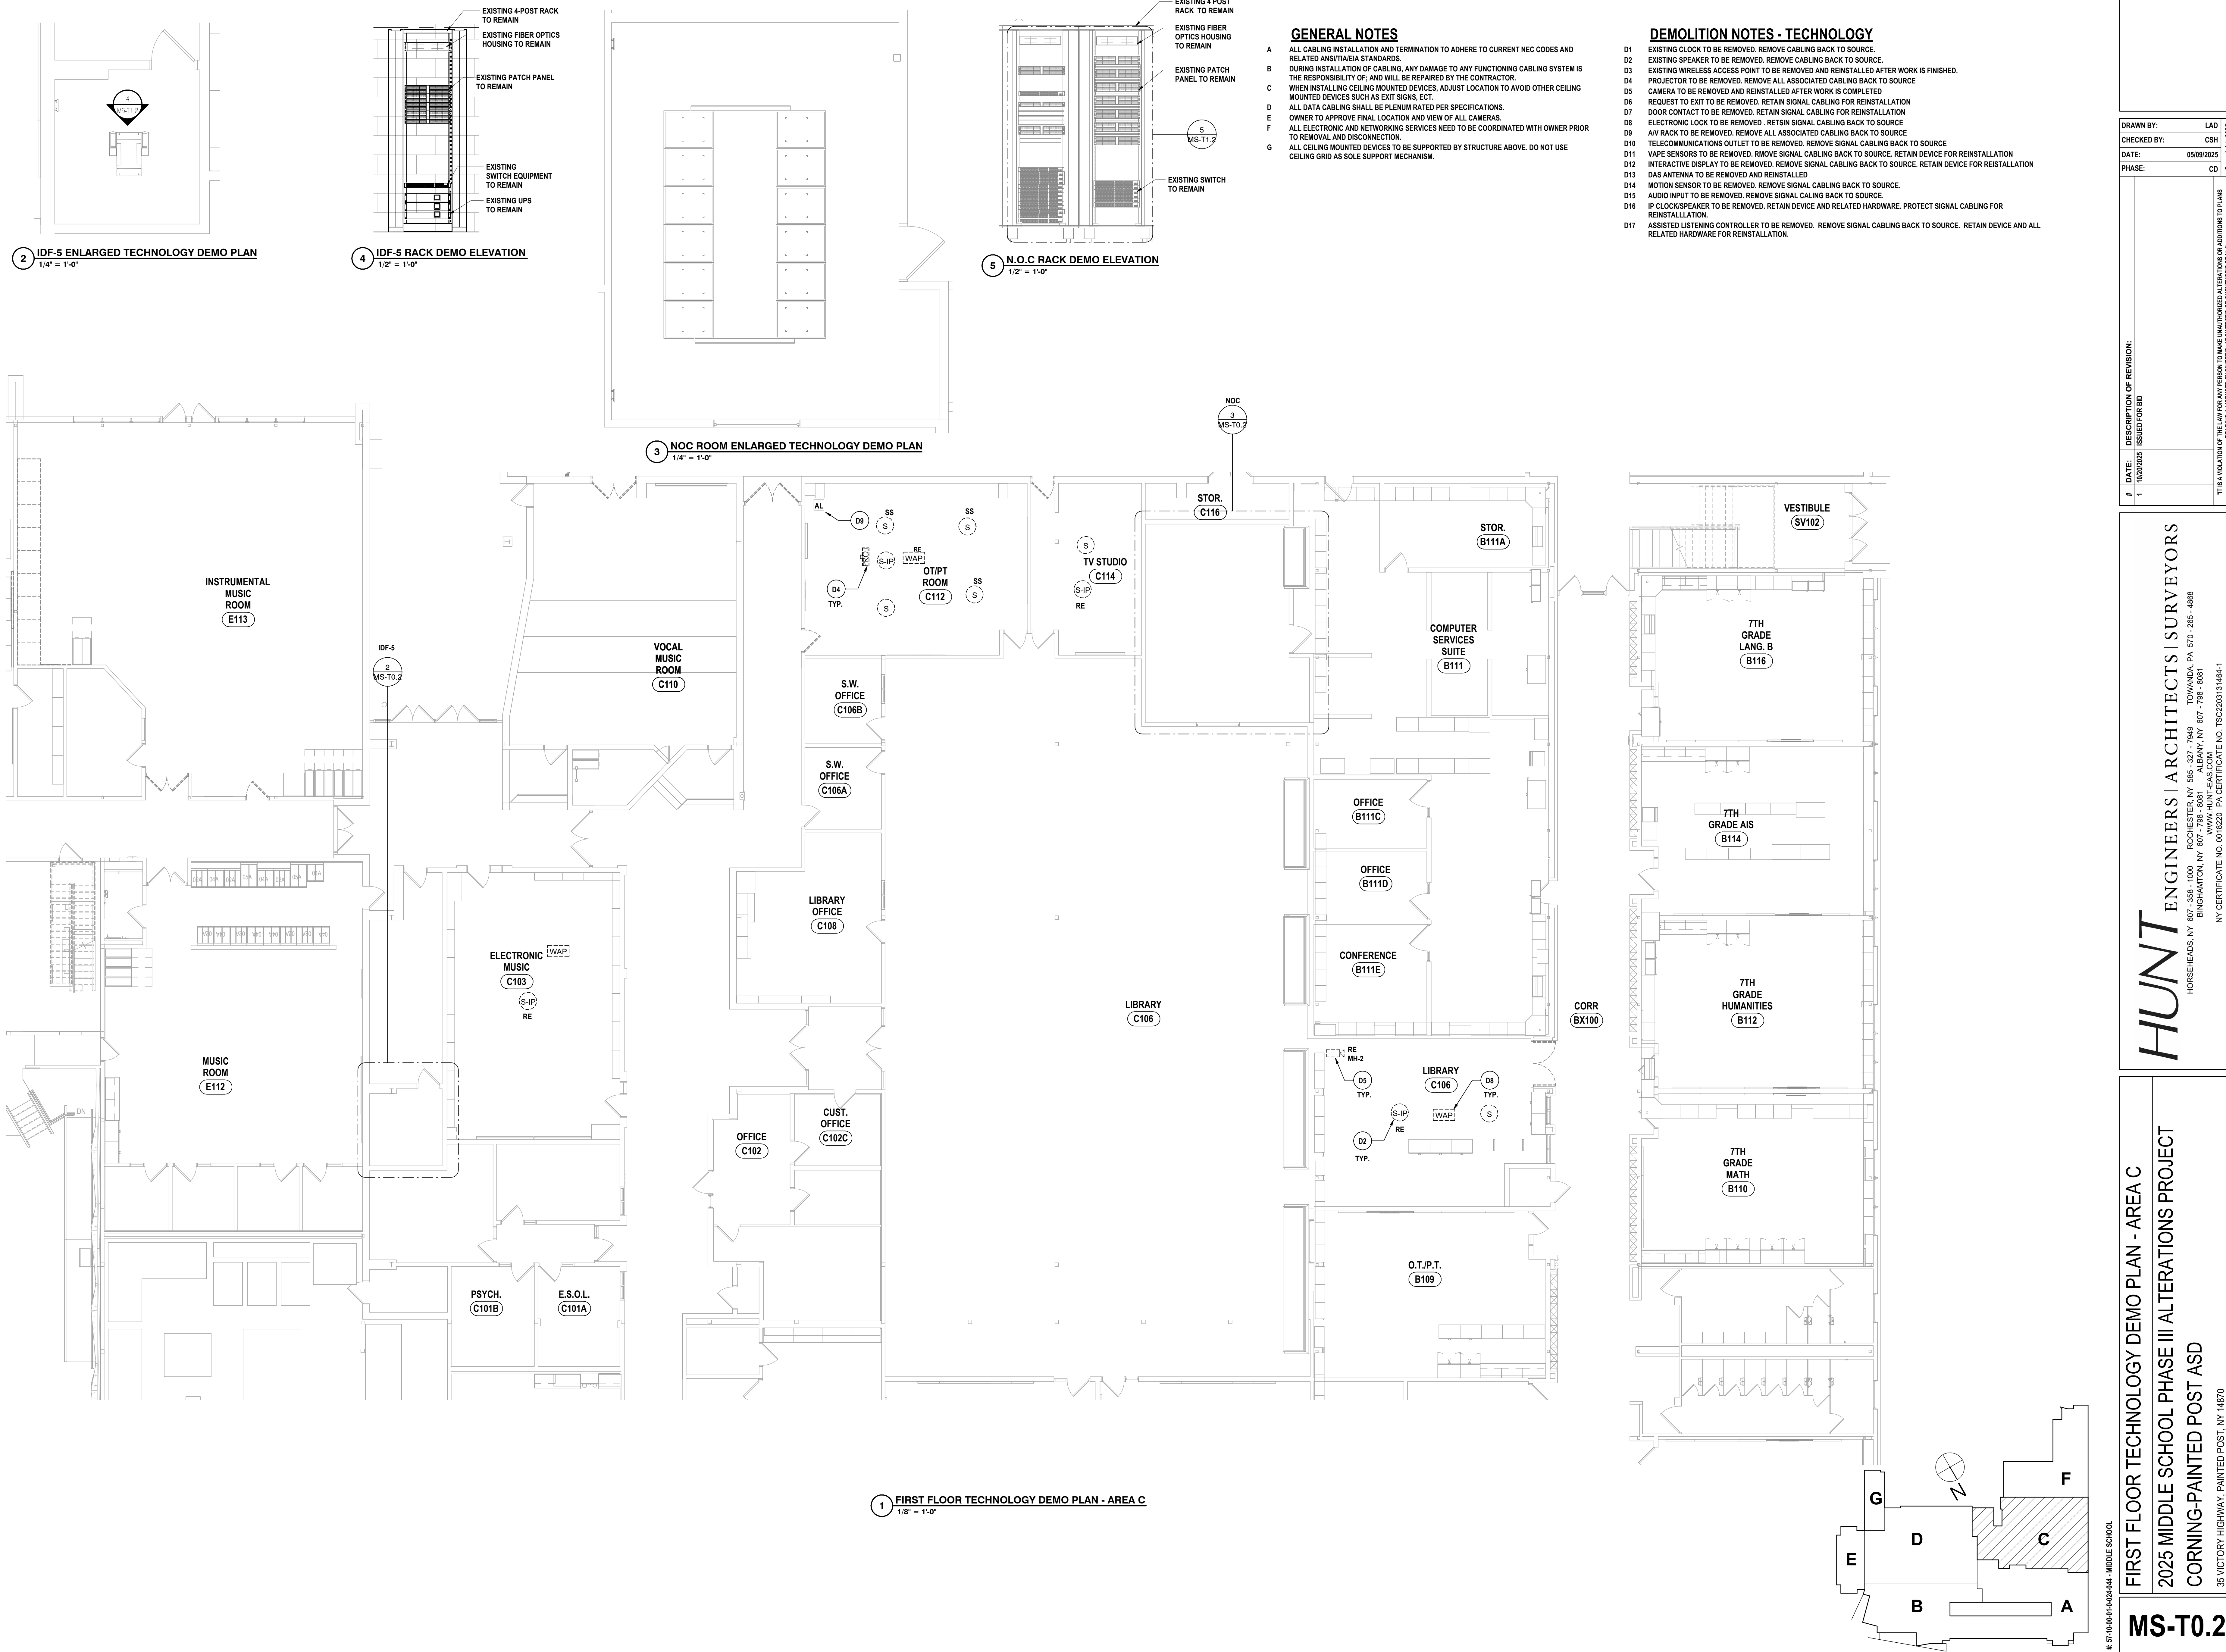

SED # 57-000-01-000-004 - MIDDLE SCHOOL

FIRST FLOOR TECHNOLOGY DEMO PLAN - AREA C

2025 MIDDLE SCHOOL PHASE III ALTERATIONS PROJECT

CORNING-PAINTED POST ASD

35 VICTORY HIGHWAY, PAINTED POST, NY 14870

**HUNT** ENGINEERS | ARCHITECTS | SURVEYORS

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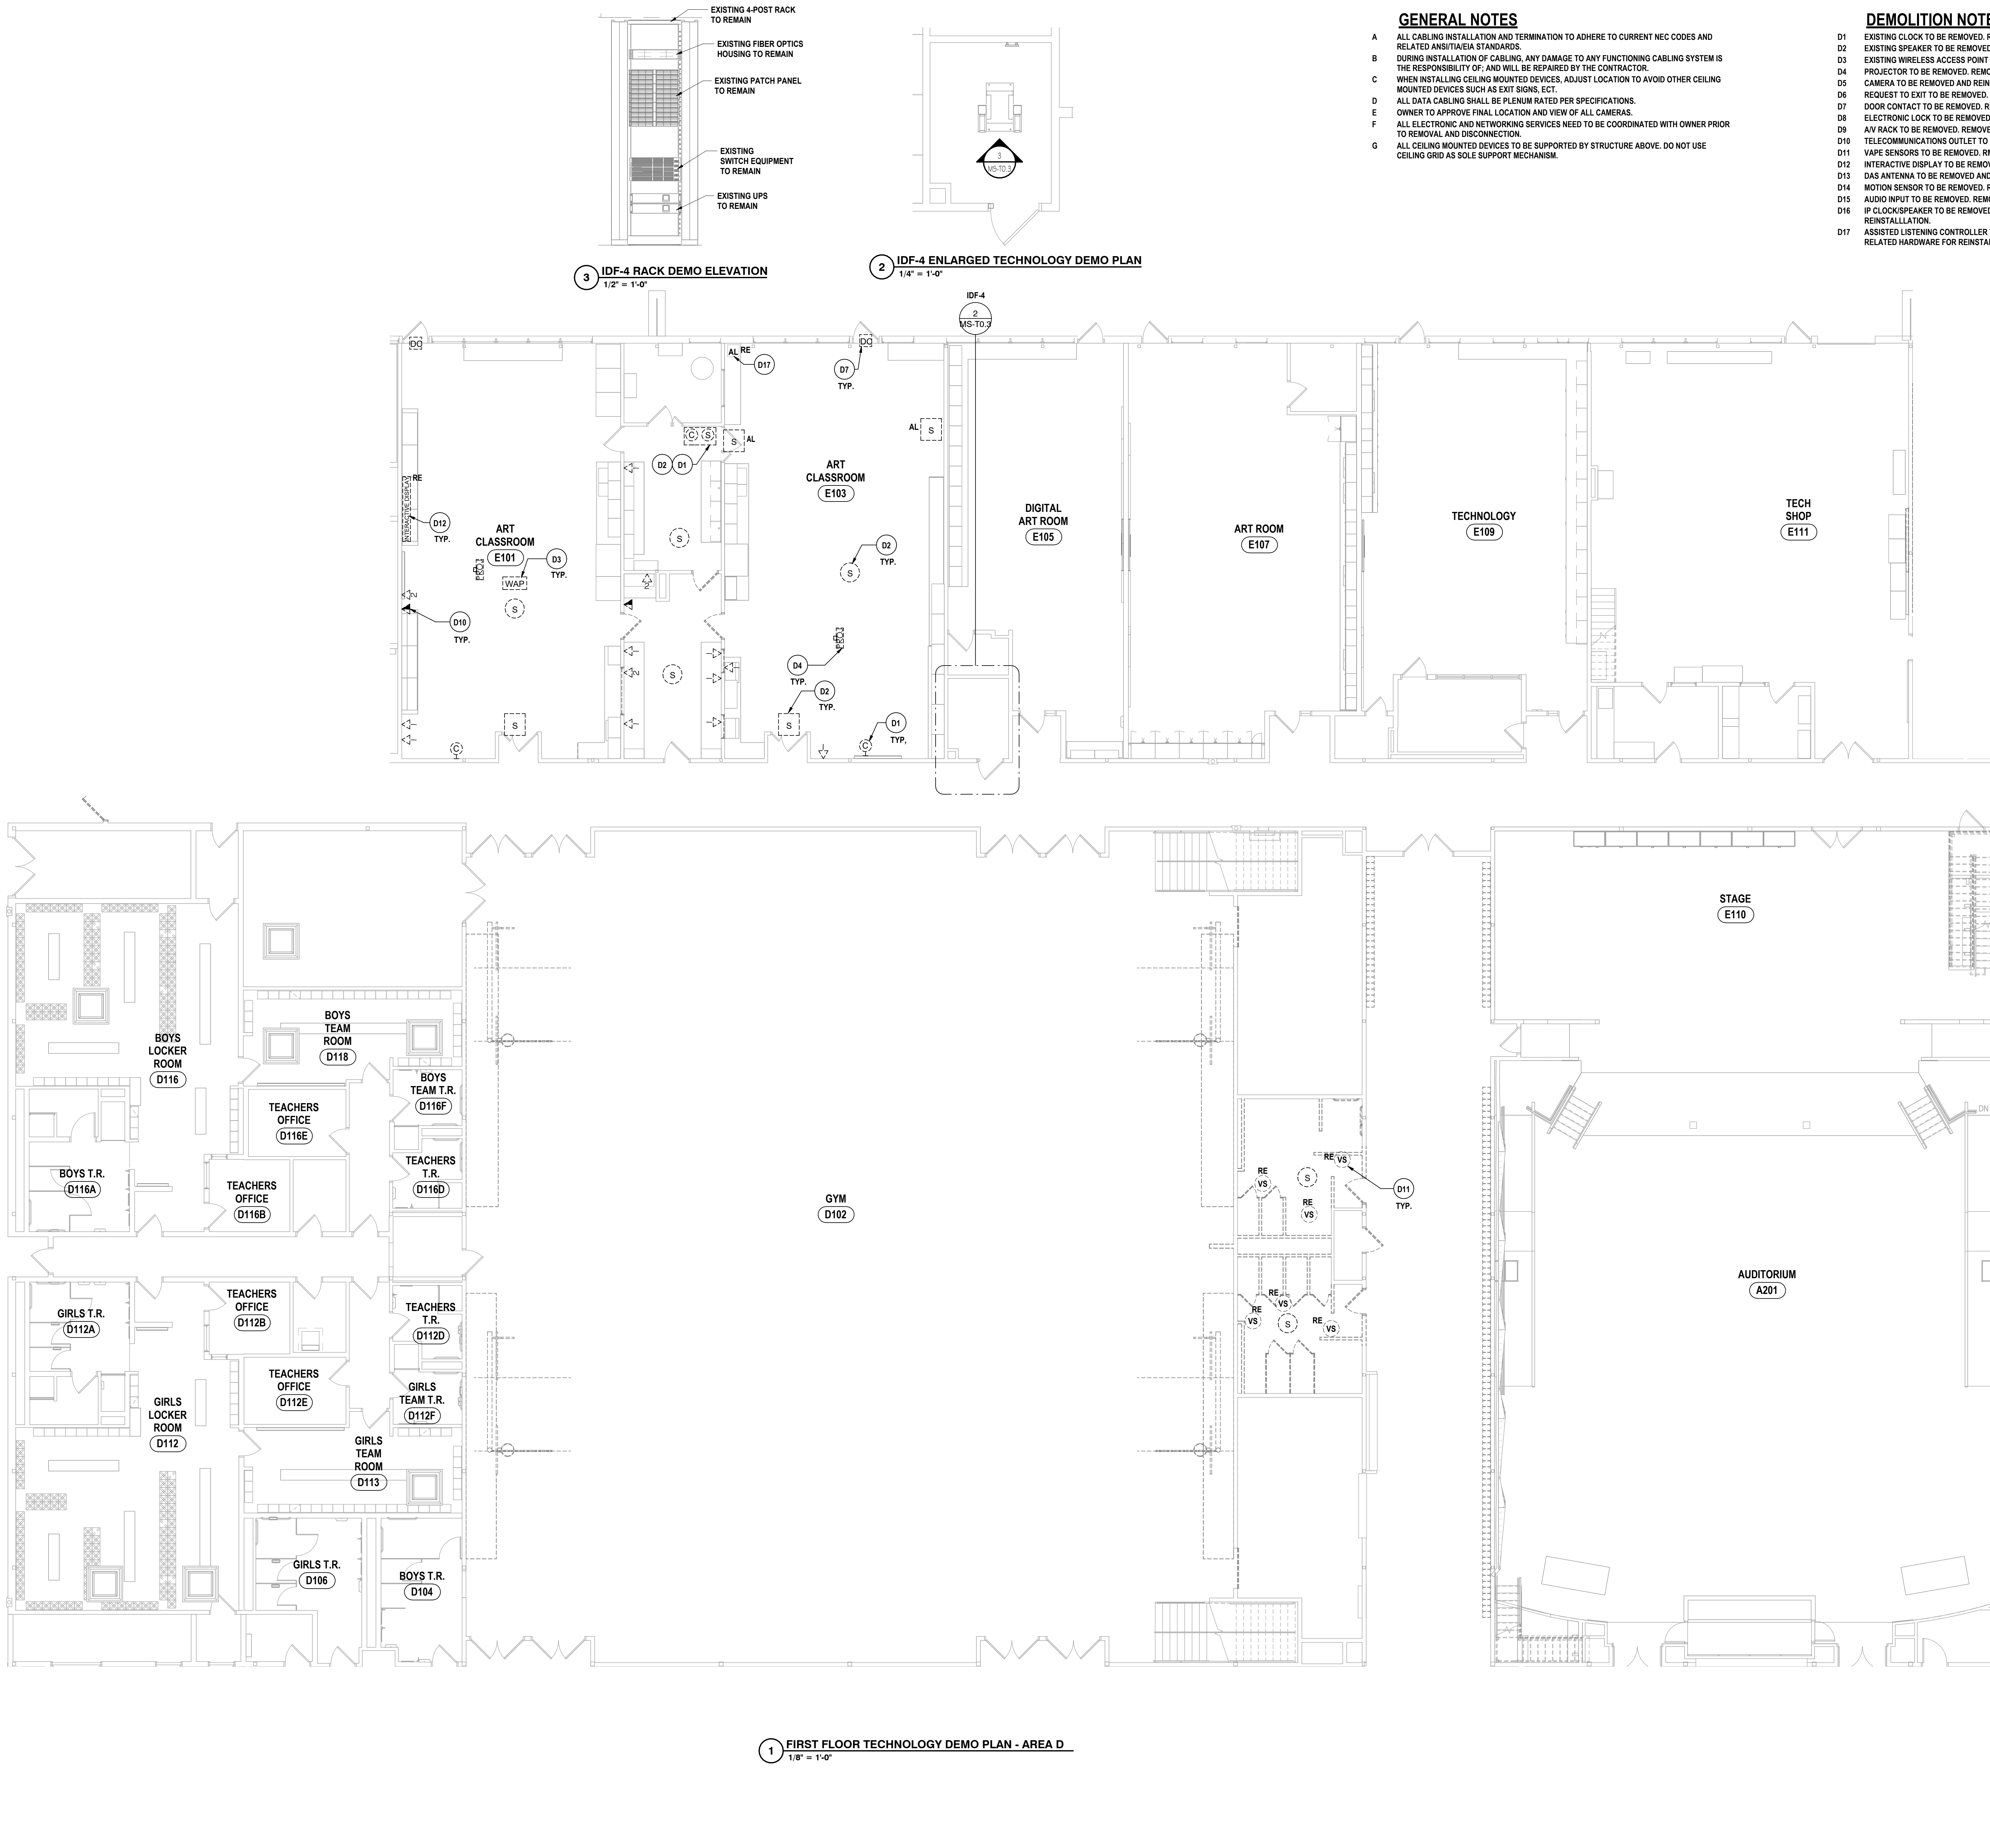
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PHASE: CD

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IT IS A VIOLATION OF THE LAW FOR ANY PERSON TO MAKE UNAUTHORIZED ALTERATIONS OR ADDITIONS TO PLANS  
DRAWING IS LOCKED. UNAUTHORIZED CHANGES WILL BE REJECTED.

PROJECT NO: 2649-133

MS-T0.2



1 FIRST FLOOR TECHNOLOGY DEMO PLAN - AREA D  
1/8" = 1'-0"

3 IDF-4 RACK DEMO ELEVATION  
1/2" = 1'-0"

2 IDF-4 ENLARGED TECHNOLOGY DEMO PLAN  
1/4" = 1'-0"

GENERAL NOTES

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- F ALL ELECTRONIC AND NETWORKING SERVICES NEED TO BE COORDINATED WITH OWNER PRIOR TO REMOVAL AND DISCONNECTION.
- G ALL CEILING MOUNTED DEVICES TO BE SUPPORTED BY STRUCTURE ABOVE. DO NOT USE CEILING GRID AS SOLE SUPPORT MECHANISM.

DEMOLITION NOTES - TECHNOLOGY

- D1 EXISTING CLOCK TO BE REMOVED. REMOVE CABLING BACK TO SOURCE.
- D2 EXISTING SPEAKER TO BE REMOVED. REMOVE CABLING BACK TO SOURCE.
- D3 EXISTING WIRELESS ACCESS POINT TO BE REMOVED AND REINSTALLED AFTER WORK IS FINISHED.
- D4 PROJECTOR TO BE REMOVED. REMOVE ALL ASSOCIATED CABLING BACK TO SOURCE.
- D5 CAMERA TO BE REMOVED AND REINSTALLED AFTER WORK IS COMPLETED.
- D6 REQUEST TO EXIT TO BE REMOVED. RETAIN SIGNAL CABLING FOR REINSTALLATION.
- D7 DOOR CONTACT TO BE REMOVED. RETAIN SIGNAL CABLING FOR REINSTALLATION.
- D8 ELECTRONIC LOCK TO BE REMOVED. RETAIN SIGNAL CABLING BACK TO SOURCE.
- D9 AV RACK TO BE REMOVED. REMOVE ALL ASSOCIATED CABLING BACK TO SOURCE.
- D10 TELECOMMUNICATIONS OUTLET TO BE REMOVED. REMOVE SIGNAL CABLING BACK TO SOURCE.
- D11 VAPE SENSORS TO BE REMOVED. REMOVE SIGNAL CABLING BACK TO SOURCE. RETAIN DEVICE FOR REINSTALLATION.
- D12 INTERACTIVE DISPLAY TO BE REMOVED. REMOVE SIGNAL CABLING BACK TO SOURCE. RETAIN DEVICE FOR REINSTALLATION.
- D13 DAS ANTENNA TO BE REMOVED AND REINSTALLED.
- D14 MOTION SENSOR TO BE REMOVED. REMOVE SIGNAL CABLING BACK TO SOURCE.
- D15 AUDIO INPUT TO BE REMOVED. REMOVE SIGNAL CABLING BACK TO SOURCE.
- D16 IP CLOCK/SPEAKER TO BE REMOVED. RETAIN DEVICE AND RELATED HARDWARE. PROTECT SIGNAL CABLING FOR REINSTALLATION.
- D17 ASSISTED LISTENING CONTROLLER TO BE REMOVED. REMOVE SIGNAL CABLING BACK TO SOURCE. RETAIN DEVICE AND ALL RELATED HARDWARE FOR REINSTALLATION.

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1	11/03/2023	ISSUED FOR BID			
"IT IS A VIOLATION OF THE LAW FOR ANY PERSON TO MAKE UNAUTHORIZED ALTERATIONS OR ADDITIONS TO PLANS DRAWING A LICENSED ENGINEER, ARCHITECT OR SURVEYOR'S SEAL."					

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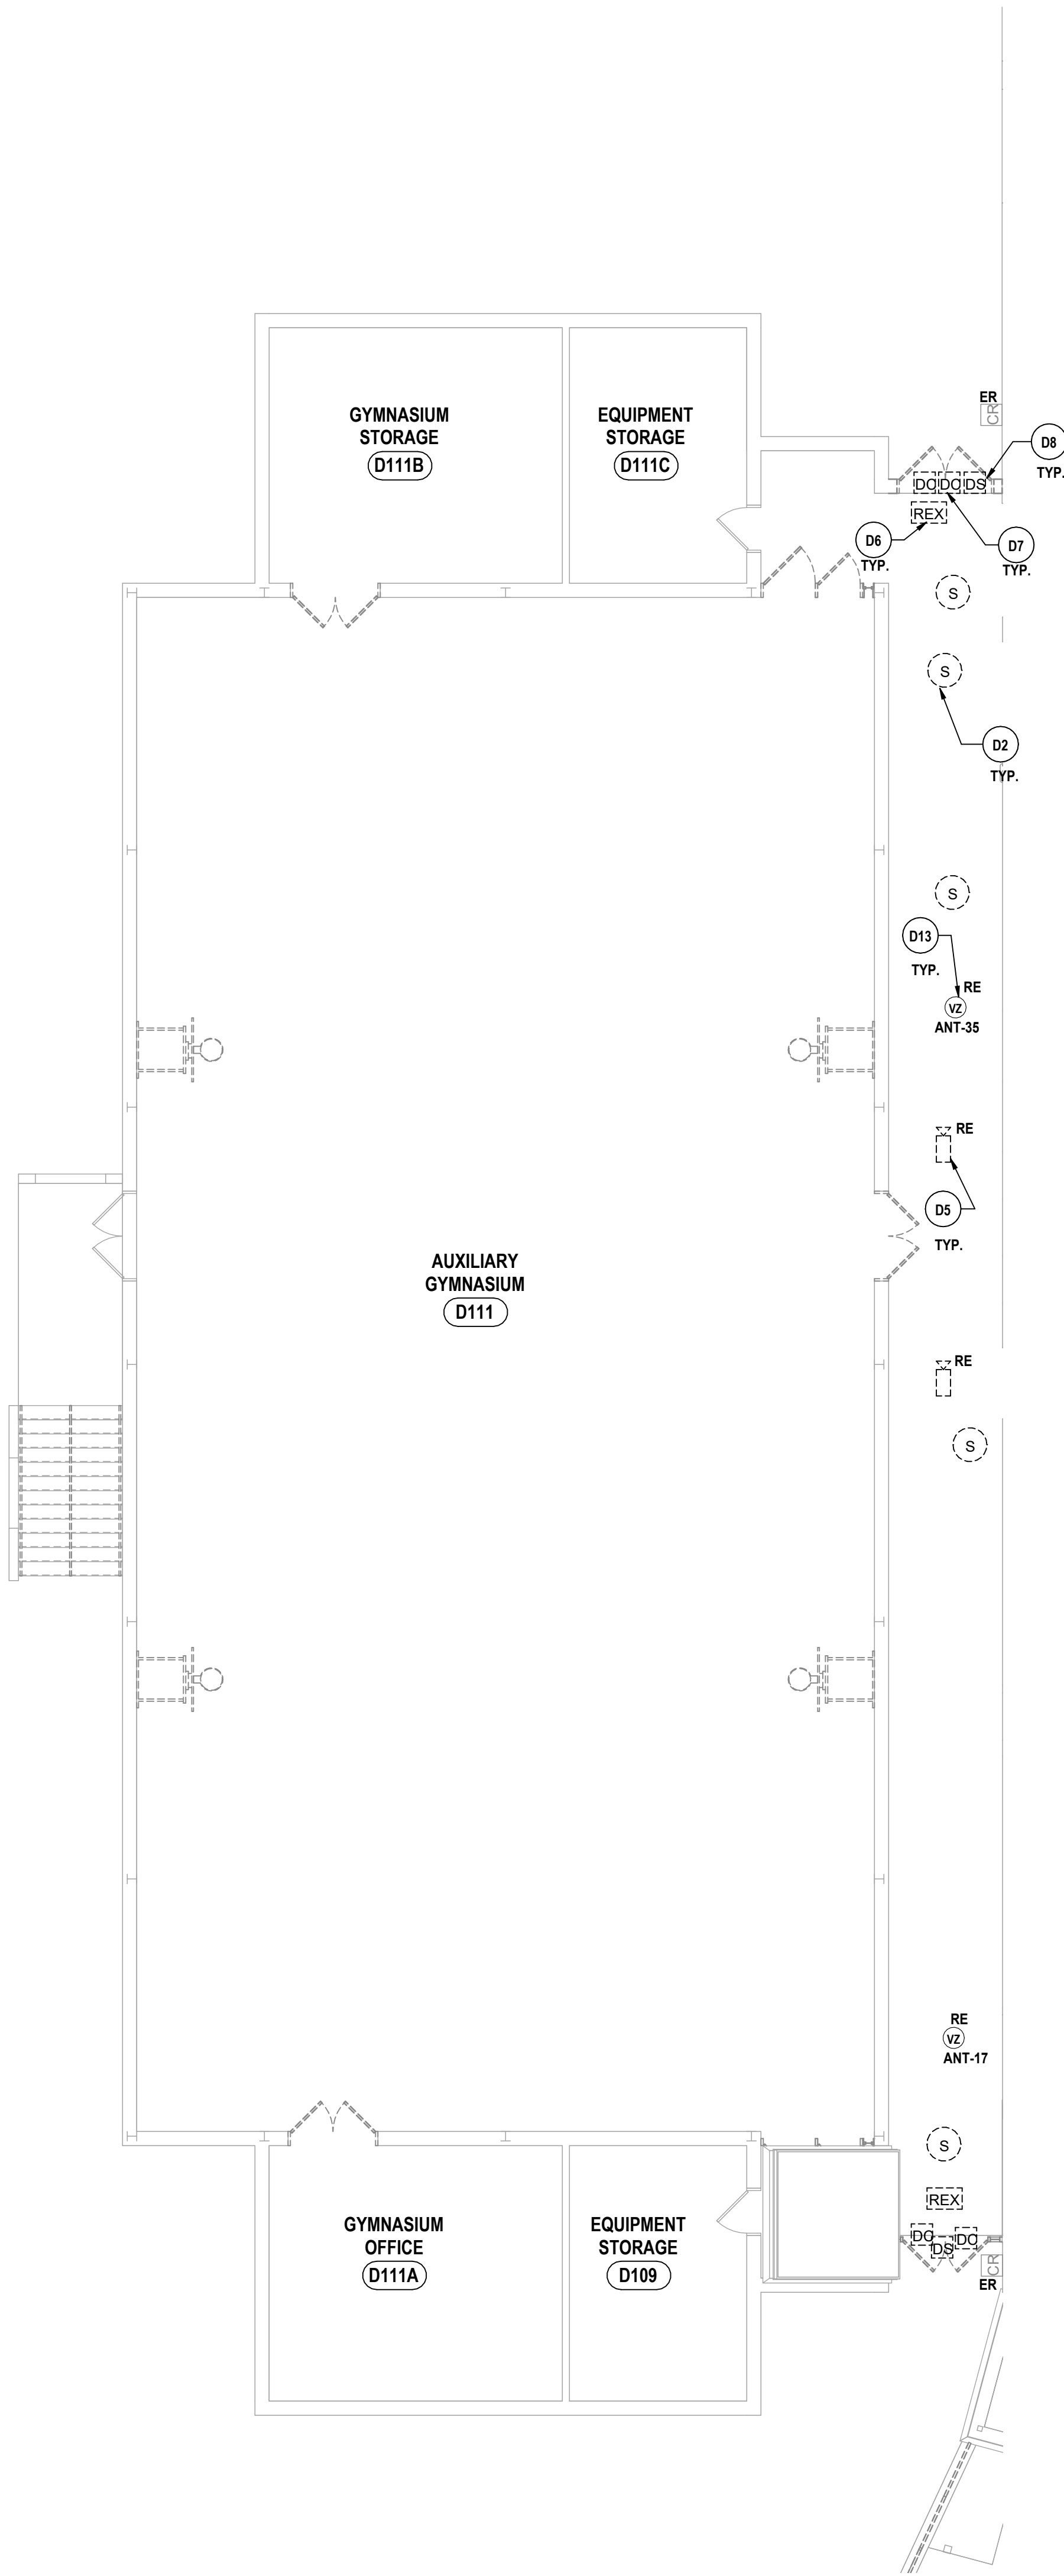
FIRST FLOOR TECHNOLOGY DEMO PLAN - AREA D  
2025 MIDDLE SCHOOL PHASE III ALTERATIONS PROJECT  
CORNING-PAINTED POST ASD

35 VICTORY HIGHWAY, PAINTED POST, NY 14870


MS-T0.3  
PROJECT NO: 2649-133

SED #: 571600-01-002444 - MIDDLE SCHOOL





1 FIRST FLOOR TECHNOLOGY DEMO PLAN - AREA E  
1/8" = 1'-0"

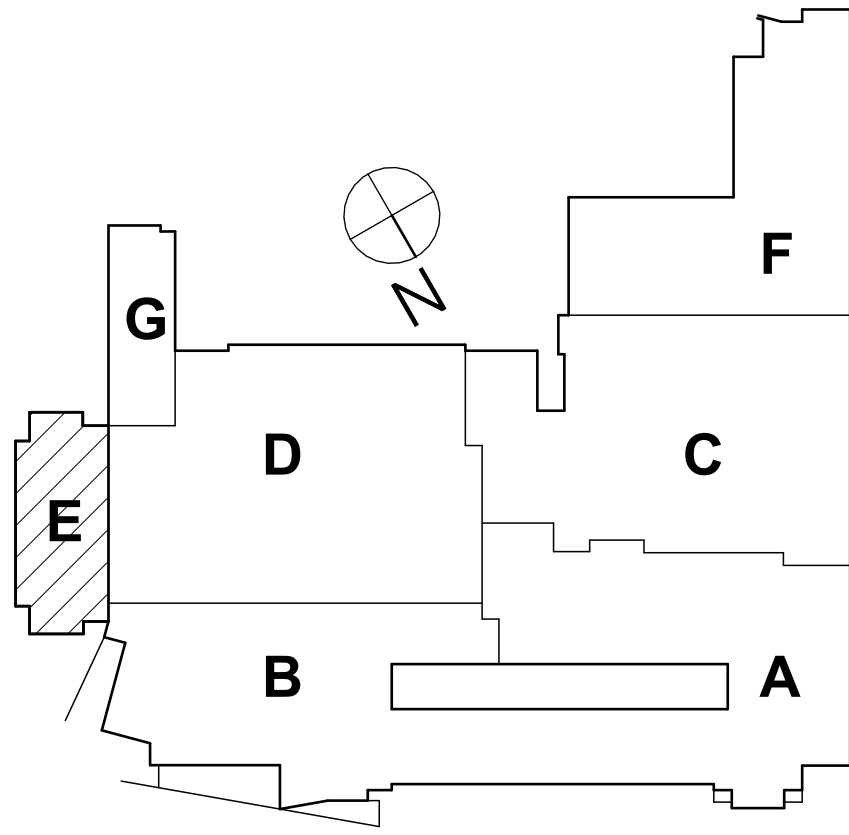


GENERAL NOTES

- A ALL CABLING INSTALLATION AND TERMINATION TO ADHERE TO CURRENT NEC CODES AND RELATED ANSITIA/IEA STANDARDS.
- B DURING INSTALLATION OF CABLING, ANY DAMAGE TO ANY FUNCTIONING CABLING SYSTEM IS THE RESPONSIBILITY OF, AND WILL, BE REPAIRED BY THE CONTRACTOR.
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- D ALL DATA CABLING SHALL BE PLENUM RATED PER SPECIFICATIONS.
- E OWNER TO APPROVE FINAL LOCATION AND VIEW OF ALL CAMERAS.
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DEMOLITION NOTES - TECHNOLOGY

- D1 EXISTING CLOCK TO BE REMOVED. REMOVE CABLING BACK TO SOURCE.
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- D8 ELECTRONIC LOCK TO BE REMOVED. RETAIN SIGNAL CABLING BACK TO SOURCE.
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- D10 TELECOMMUNICATIONS OUTLET TO BE REMOVED. REMOVE SIGNAL CABLING BACK TO SOURCE.
- D11 VAPE SENSORS TO BE REMOVED. REMOVE SIGNAL CABLING BACK TO SOURCE. RETAIN DEVICE FOR REINSTALLATION.
- D12 INTERACTIVE DISPLAY TO BE REMOVED. REMOVE SIGNAL CABLING BACK TO SOURCE. RETAIN DEVICE FOR REINSTALLATION.
- D13 DAS ANTENNA TO BE REMOVED AND REINSTALLED.
- D14 MOTION SENSOR TO BE REMOVED. REMOVE SIGNAL CABLING BACK TO SOURCE.
- D15 AUDIO INPUT TO BE REMOVED. REMOVE SIGNAL CABLING BACK TO SOURCE.
- D16 IP CLOCK/SPEAKER TO BE REMOVED. RETAIN DEVICE AND RELATED HARDWARE. PROTECT SIGNAL CABLING FOR REINSTALLATION.
- D17 ASSISTED LISTENING CONTROLLER TO BE REMOVED. REMOVE SIGNAL CABLING BACK TO SOURCE. RETAIN DEVICE AND ALL RELATED HARDWARE FOR REINSTALLATION.

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CHECKED BY: CSH	
DATE: 05/09/2025	
PHASE: CD	
DESCRIPTION OF REVISION: ISSUED FOR BID	
# DATE	
1 10/02/2025	
IT IS A VIOLATION OF THE LAW FOR ANY PERSON TO MAKE UNAUTHORIZED ALTERATIONS OR ADDITIONS TO PLANS DRAWN BY A LICENSED PROFESSIONAL ENGINEER OR ARCHITECT WITHOUT HIS OR HER SEAL.	



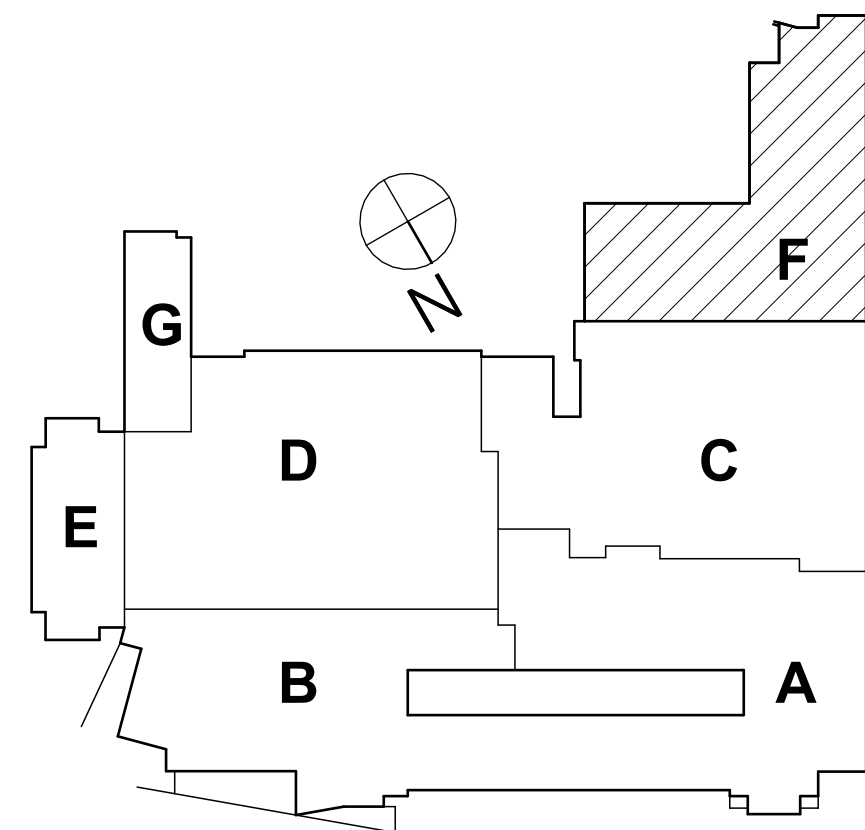

GENERAL NOTES

- A ALL CABLING INSTALLATION AND TERMINATION TO ADHERE TO CURRENT NEC CODES AND RELATED ANSI/TIA/EIA STANDARDS.  
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E OWNER TO APPROVE FINAL LOCATION AND VIEW OF ALL CAMERAS.  
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DATE: 05/09/2025  
PHASE: CD



#	DATE	DESCRIPTION OF REVISION:
1	11/03/2025	ISSUED FOR BID

IT IS A VIOLATION OF THE LAW FOR ANY PERSON TO MAKE UNAUTHORIZED ALTERATIONS OR ADDITIONS TO PLANS  
DRAWN AT LOCALS, UNLESS INDICATED BY ARCHITECT'S SIGNATURE DATE.

**HUNT** ENGINEERS | ARCHITECTS | SURVEYORS  
HORSEHEADS, NY 807-253-1000    ROCHESTER, NY 585-537-7549    TOWNANDA, PA 570-265-4606  
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NY CERTIFICATE NO. 0016220    PA CERTIFICATE NO. TSC220013464-1





FIRST FLOOR TECHNOLOGY KEY PLAN  
2025 MIDDLE SCHOOL PHASE III ALTERATIONS PROJECT  
CORNING-PAINTED POST ASD  
35 VICTORY HIGHWAY, PAINTED POST, NY 14870

MS-T1.1  
PROJECT NO: 2649-133

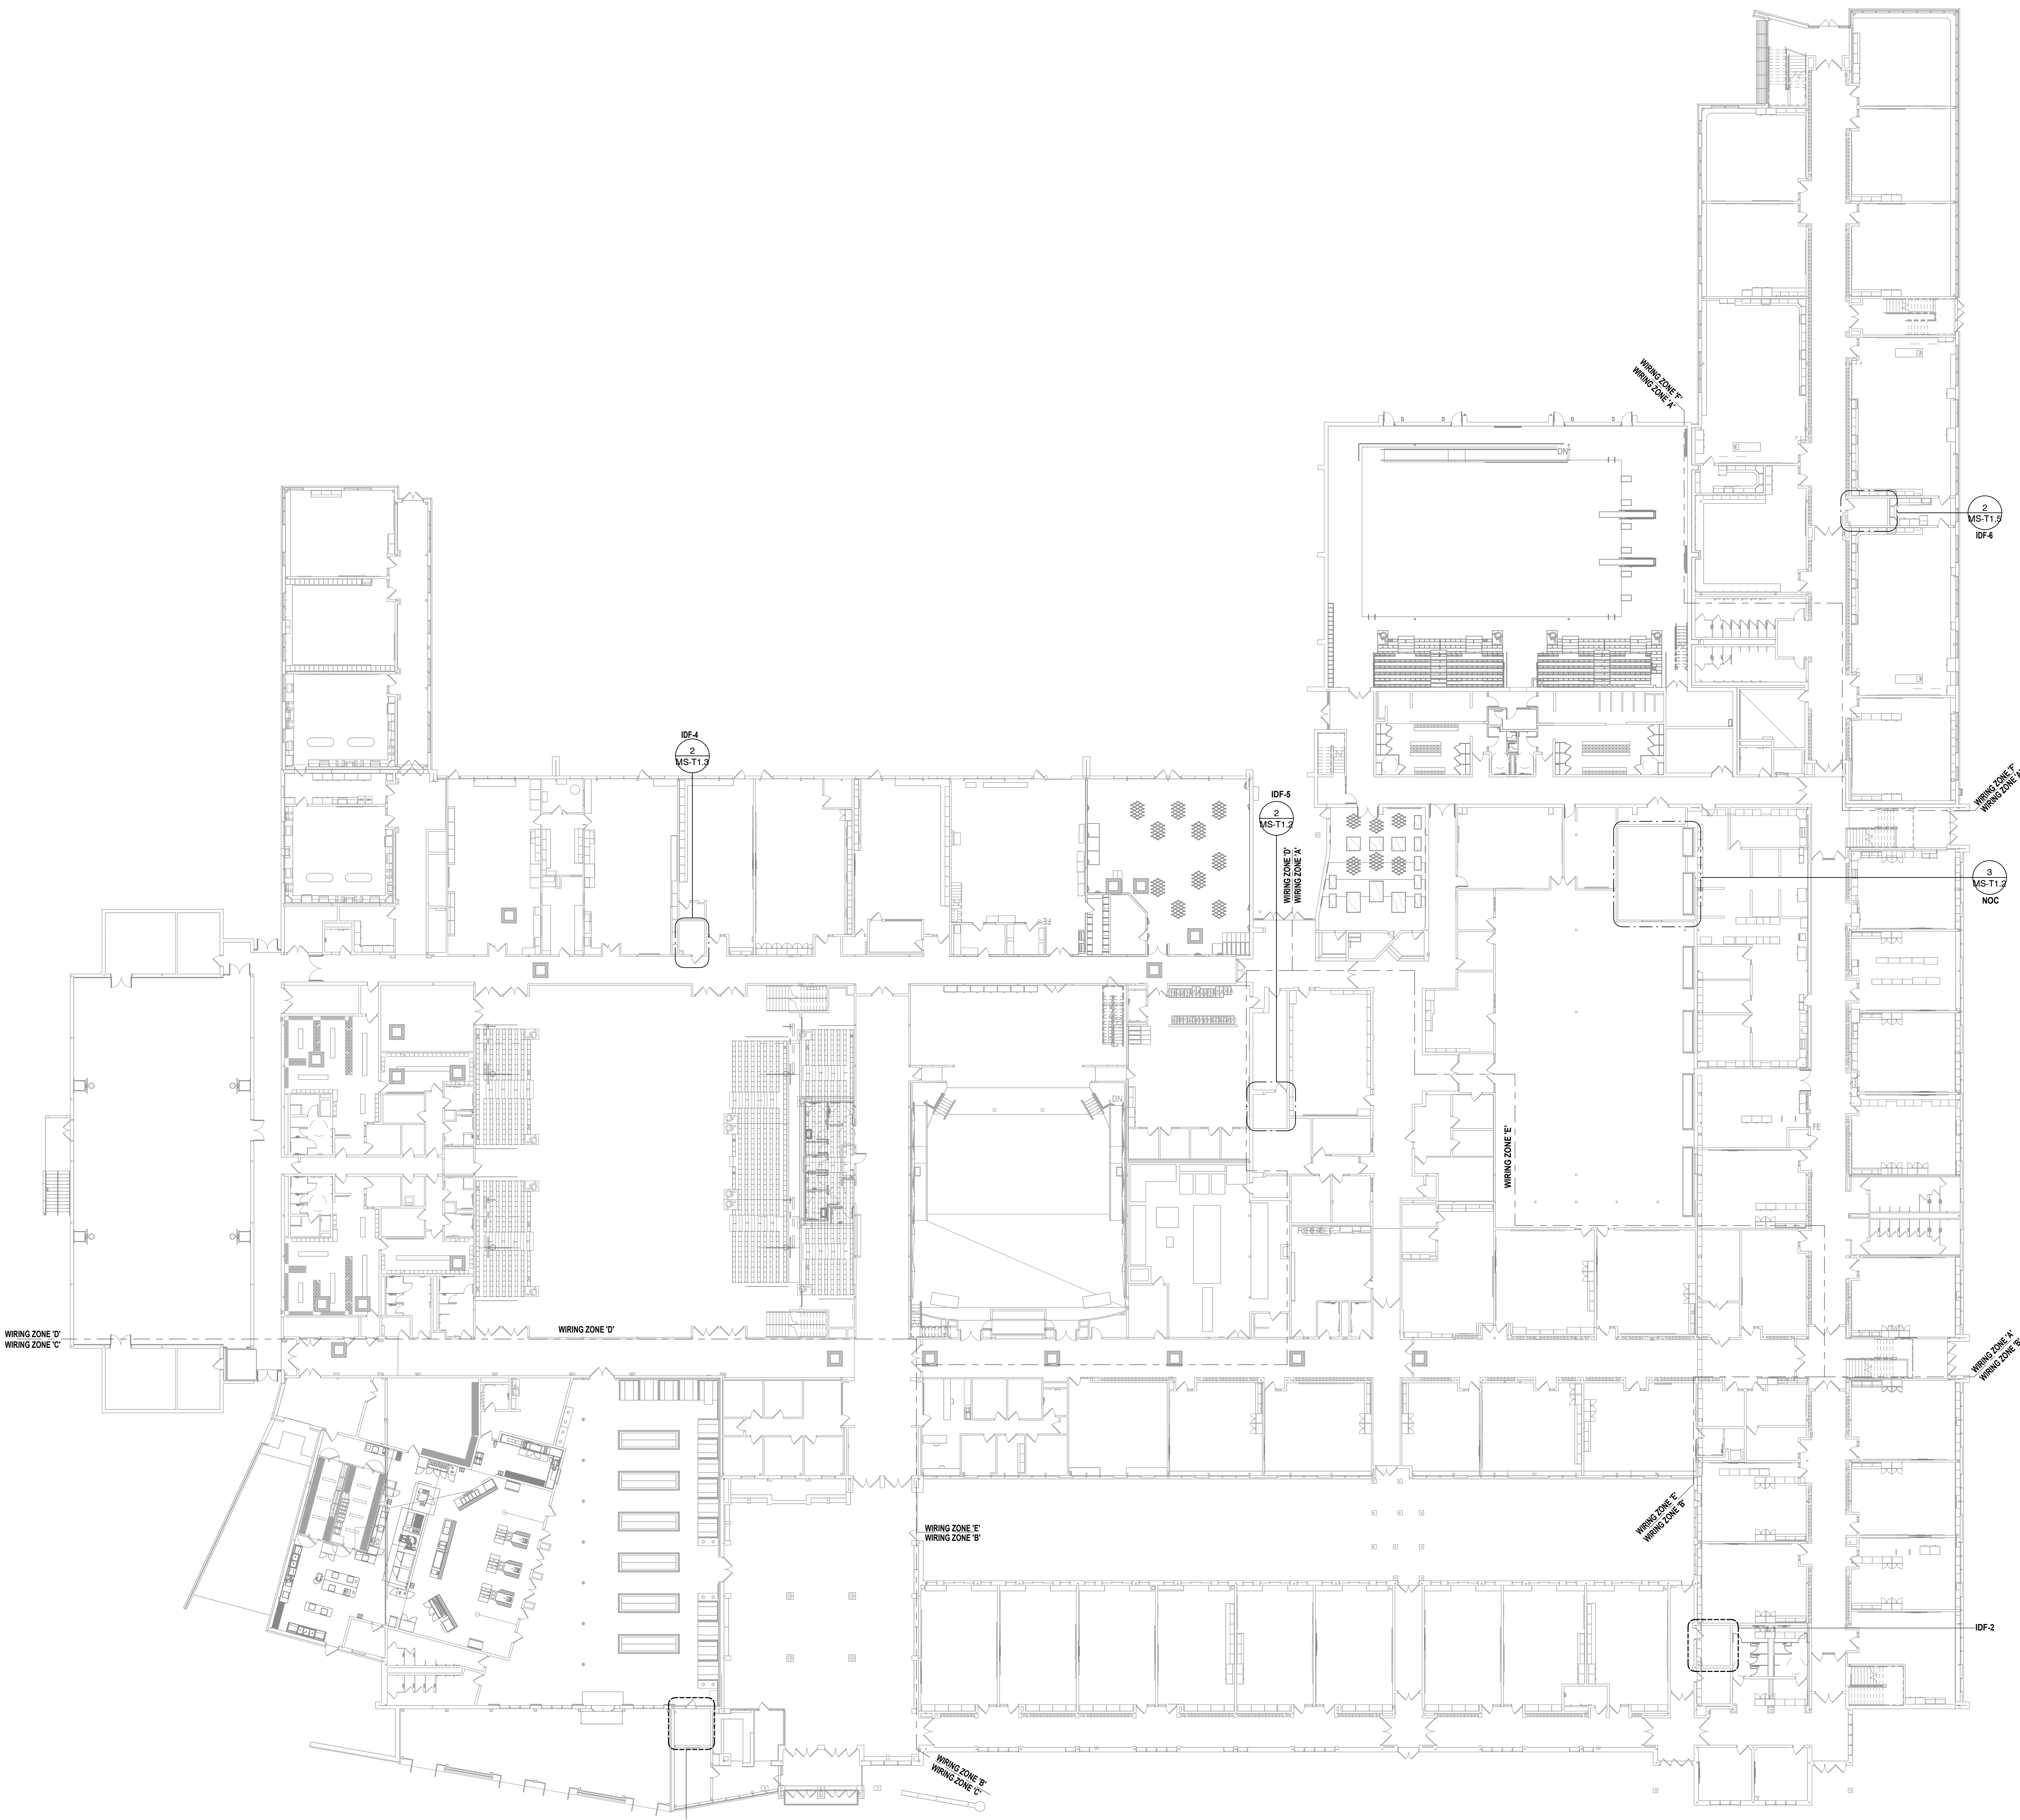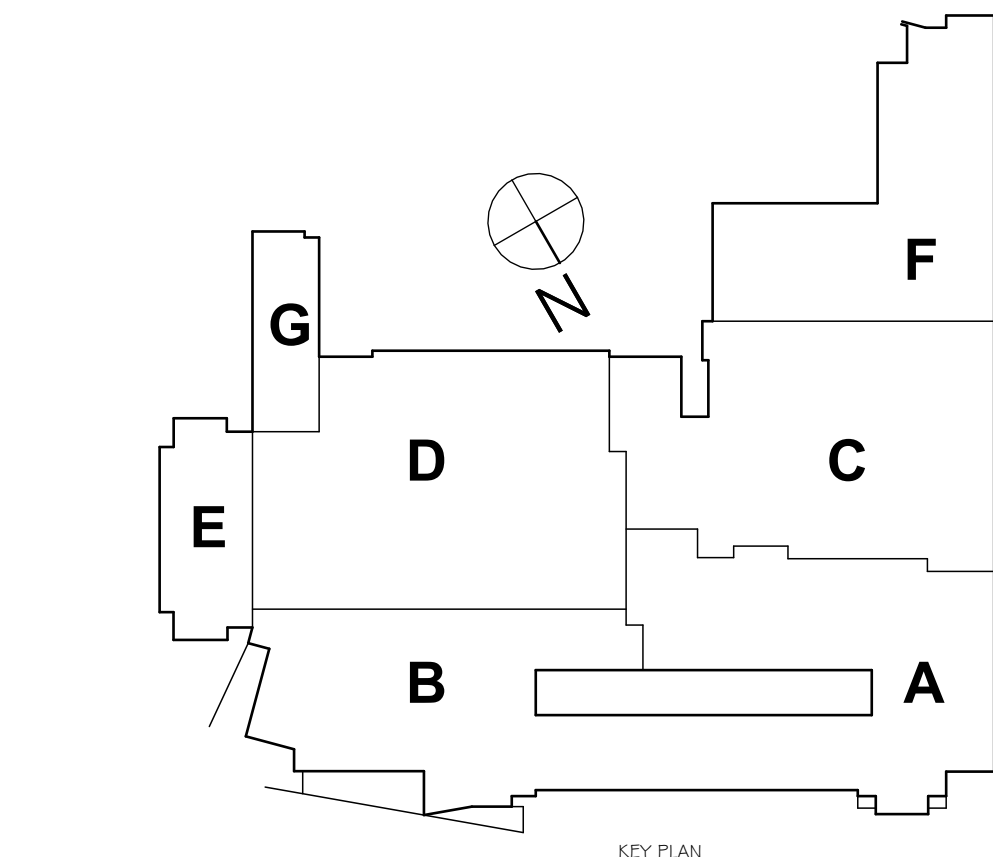

1 FIRST FLOOR TECHNOLOGY KEY PLAN  
1" = 20'-0"

SED #: 57-16-00-41-5024-444 - MIDDLE SCHOOL

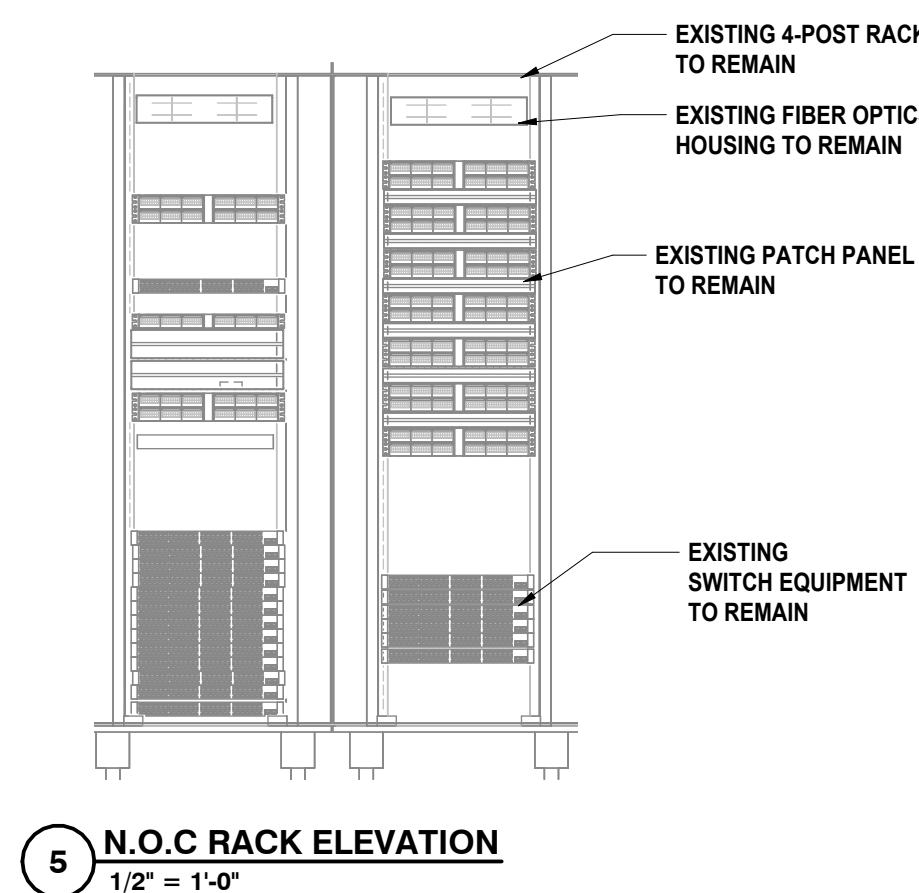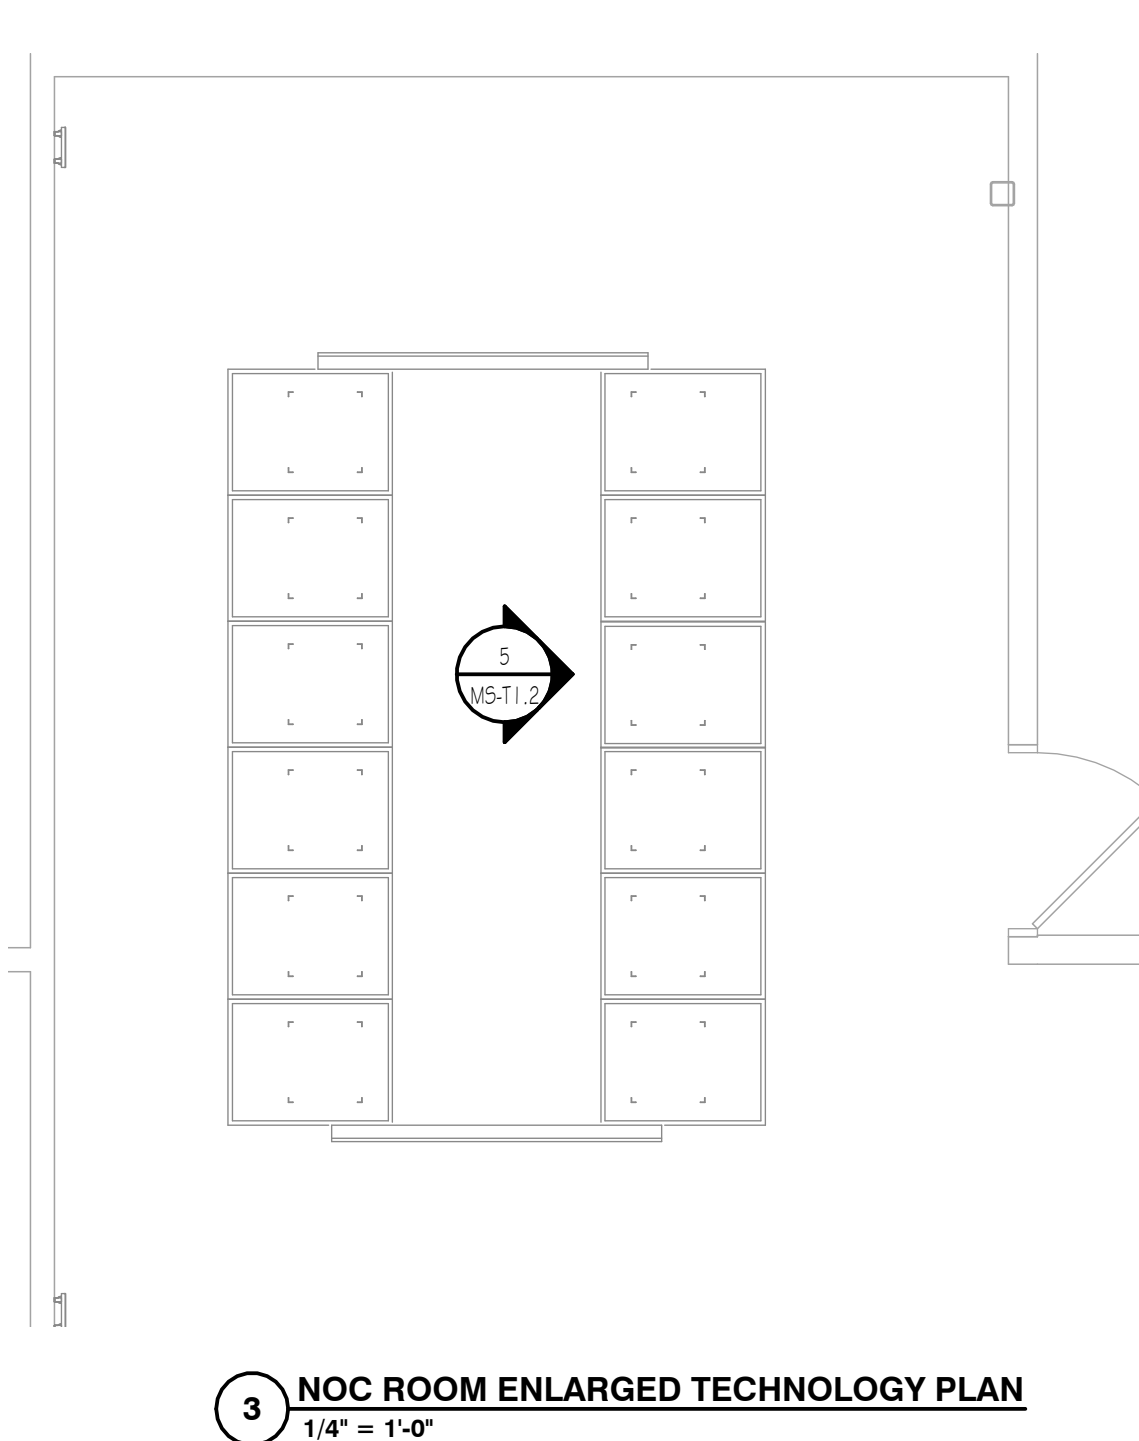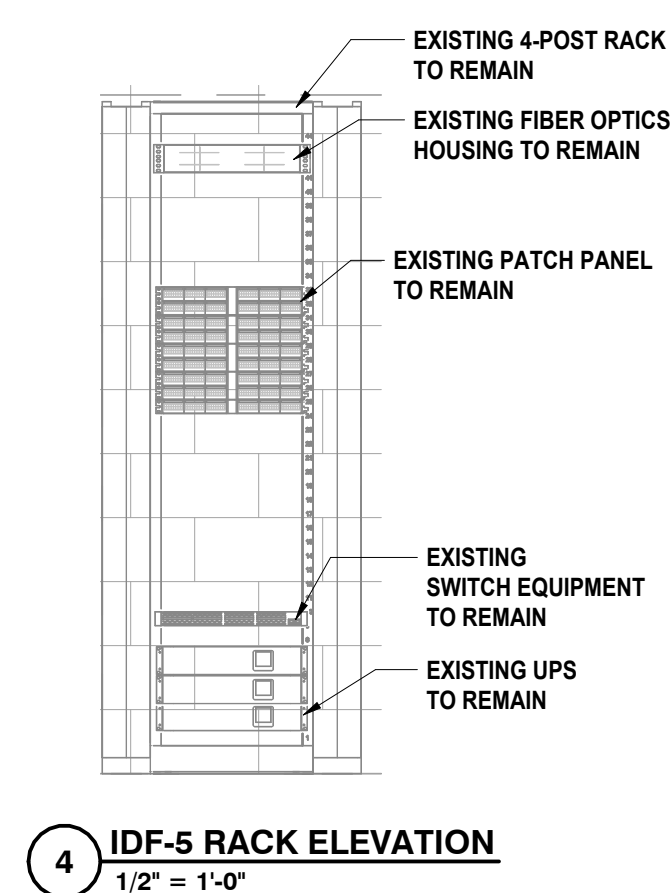
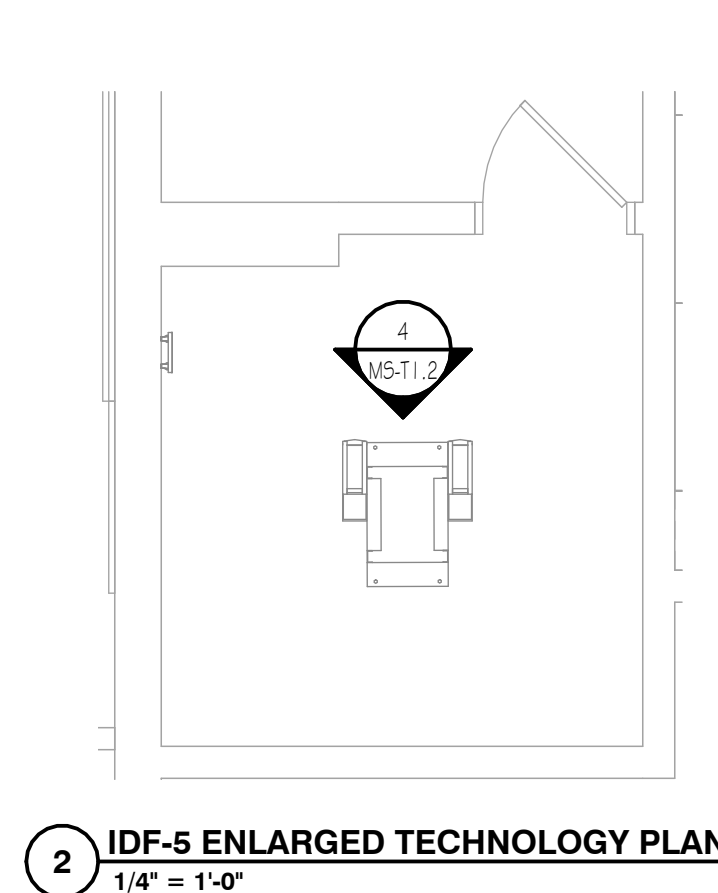


### GENERAL NOTES

- A ALL CABLE INSTALLATION AND TERMINATION TO ADHERE TO CURRENT NEC CODES AND  
B RELATED ANSI/IEA/IEA STANDARDS.  
C DURING INSTALLATION OF CABLEING, ANY DAMAGE TO ANY FUNCTIONING CABLEING SYSTEM IS  
D THE RESPONSIBILITY OF, AND WILL BE REPAIRED BY THE CONTRACTOR.  
E WHEN INSTALLING CEILING MOUNTED DEVICES, ADJUST LOCATION TO AVOID OTHER CEILING  
F DEVICES SUCH AS SPRINKLERS, SMOKE DETECTORS, ETC.  
G ALL DATA CABLEING SHALL BE PLENUM RATED PER SPECIFICATIONS.  
H OWNER TO APPROVE FINAL LOCATION AND VIEW OF ALL CAMERAS.  
I ALL ELECTRONIC AND NETWORKING SERVICES NEED TO BE COORDINATED WITH OWNER PRIOR  
J TO REMOVAL AND DISCONNECTION.  
K ALL CEILING MOUNTED DEVICES DO NOT BE SUPPORTED BY STRUCTURE ABOVE. DO NOT USE  
L CEILING GRID AS SOLE SUPPORT MECHANISM.

### CONSTRUCTION NOTES - TECHNOLOGY

- 1 CLOCK TO BE INSTALLED PER SPECIFICATIONS & DETAILS.
- 2 PAGING SPEAKER TO BE INSTALLED PER SPECIFICATIONS & DETAILS
- 3 WIRELESS ACCESS POINT TO BE INSTALLED PER SPECIFICATIONS & DETAILS.
- 4 ASSISTIVE LISTENING FACELATE TO BE INSTALLED PER SPECIFICATIONS & DETAILS. ATTACH CONTROLLER HANGING FROM WALL
- 5 SURVEILLANCE CAMERA TO BE INSTALLED PER SPECIFICATIONS & DETAILS.
- 6 REQUEST TO EXIT TO BE INSTALLED PER SPECIFICATIONS & DETAILS.
- 7 DOOR CONTACT TO BE INSTALLED PER SPECIFICATIONS & DETAILS.
- 8 ELECTRONIC LOCK TO BE INSTALLED PER SPECIFICATIONS & DETAILS.
- 9 ASSISTIVE LISTING SPEAKER TO BE INSTALLED PER SPECIFICATIONS & DETAILS.
- 10 TELECOMMUNICATIONS OUTLET TO BE INSTALLED PER SPECIFICATIONS & DETAILS.
- 11 VAPE SENSOR TO BE INSTALLED PER SPECIFICATIONS & DETAILS.
- 12 INTERACTIVE DISPLAY TO BE INSTALLED PER SPECIFICATIONS & DETAILS.
- 13 DASH ANTENNA TO BE RENSTALLED.
- 14 CEILING MOUNTING BRACKET FOR SENSOR TO BE INSTALLED PER SPECIFICATIONS & DETAILS.
- 15 ASSISTIVE LISTENING IN SENSOR TO BE INSTALLED PER SPECIFICATIONS & DETAILS.
- 16 IP CLOCK SPEAKER TO BE INSTALLED PER SPECIFICATIONS & DETAILS.
- 17 VISUAL NOTIFICATION TO BE INSTALLED PER SPECIFICATIONS & DETAILS.
- 18 CARD READER TO BE INSTALLED PER SPECIFICATIONS & DETAILS.
- 19 KEYPAD TO BE INSTALLED PER SPECIFICATIONS & DETAILS.
- 20 LOCAL POOL ALARM PULL STATION PER SPECIFICATIONS & DETAILS.
- 21 LOCAL POOL ALARM STROBE/HORN PER SPECIFICATIONS & DETAILS.

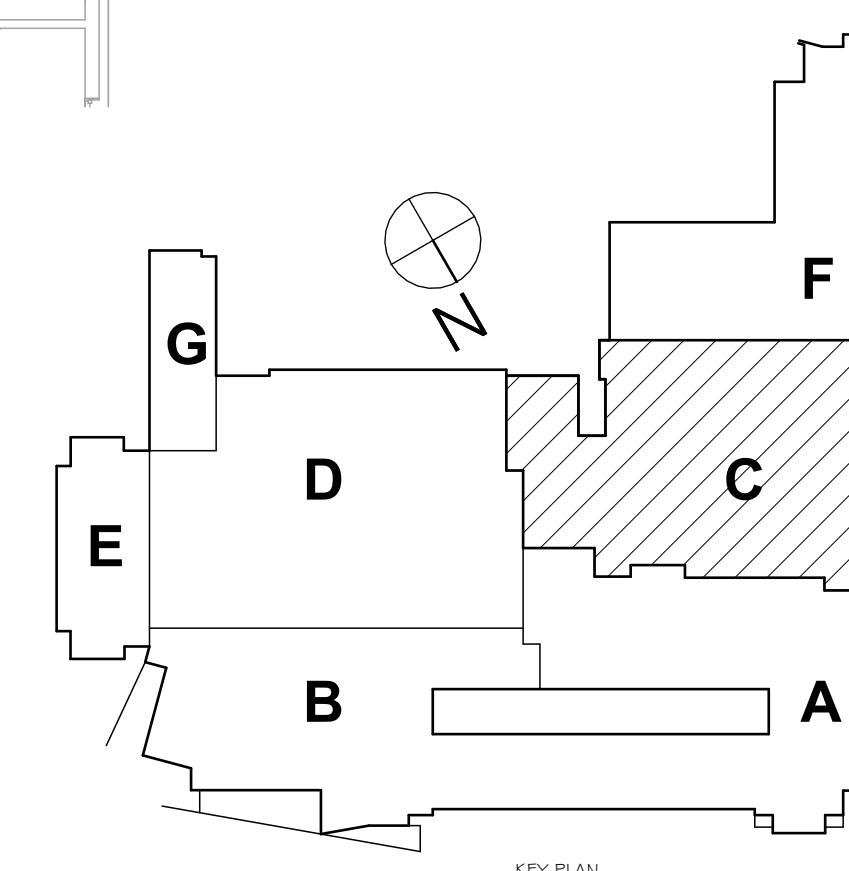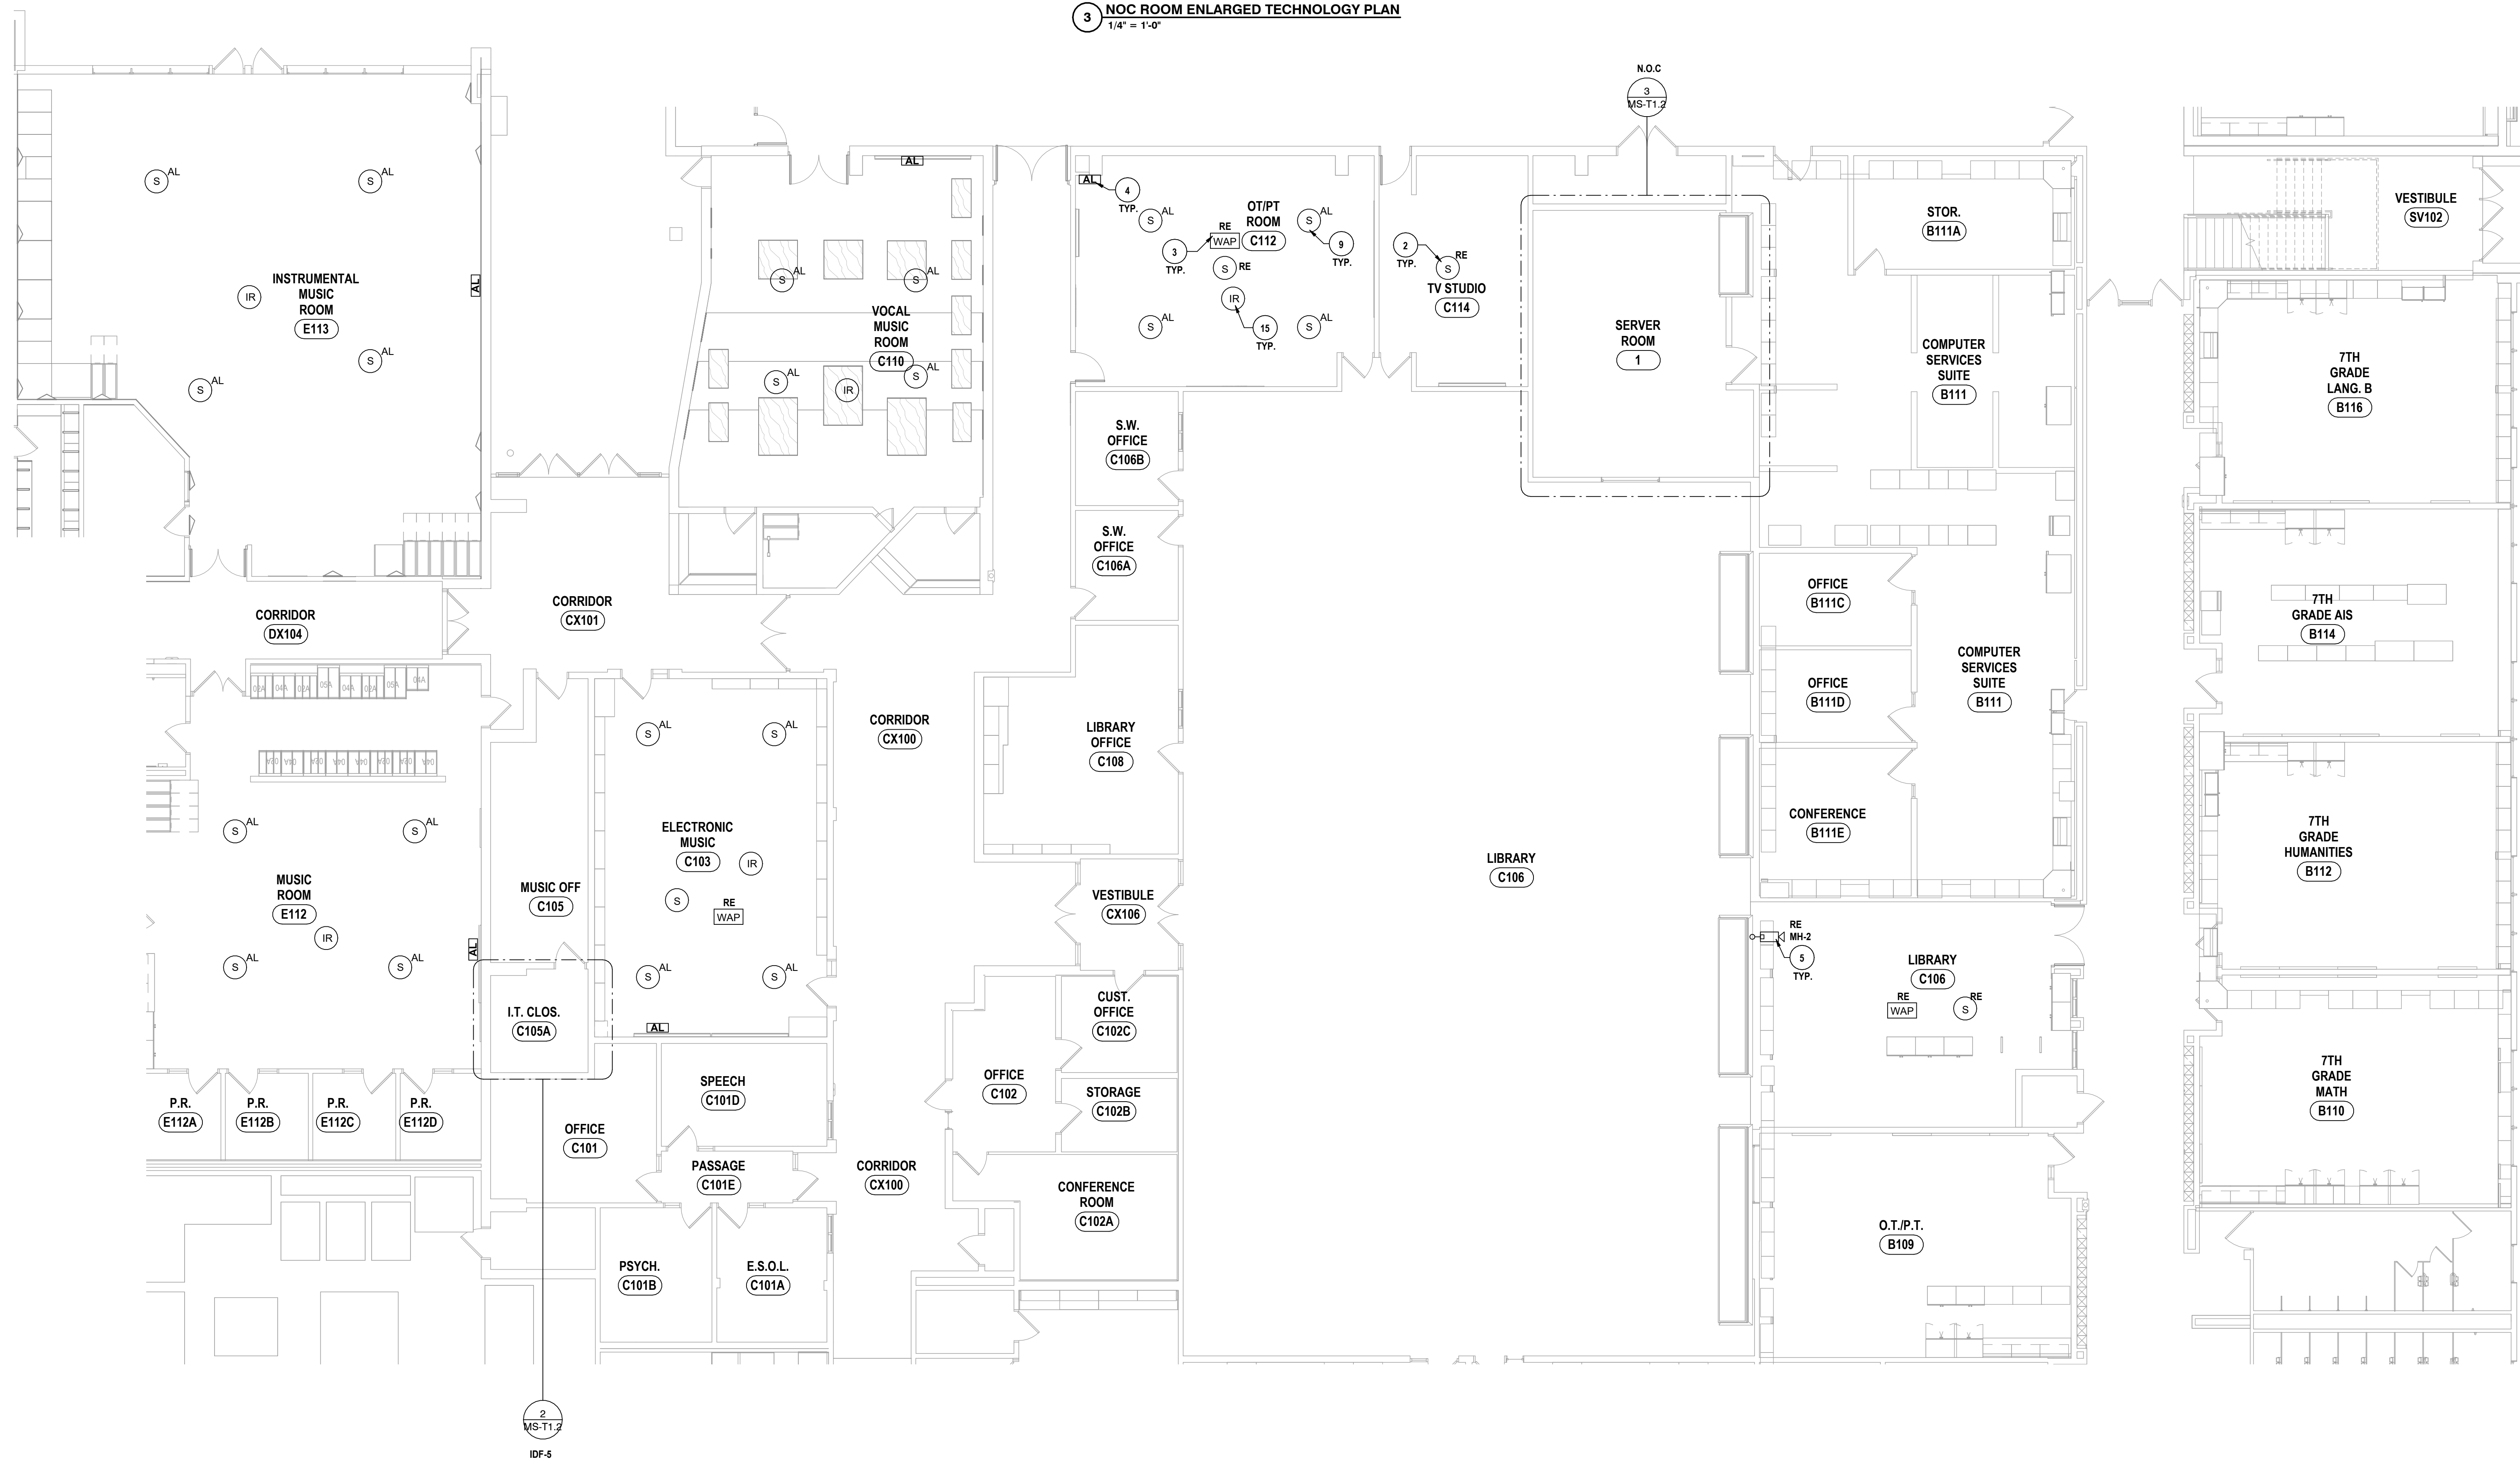

FIRST FLOOR TECHNOLOGY PLAN - AREA C

2025 MIDDLE SCHOOL PHASE III ALTERATIONS PROJECT  
CORNING-PAINTED POST ASD

335 VICTORY HIGHWAY, PAINTED POST, NY 14870


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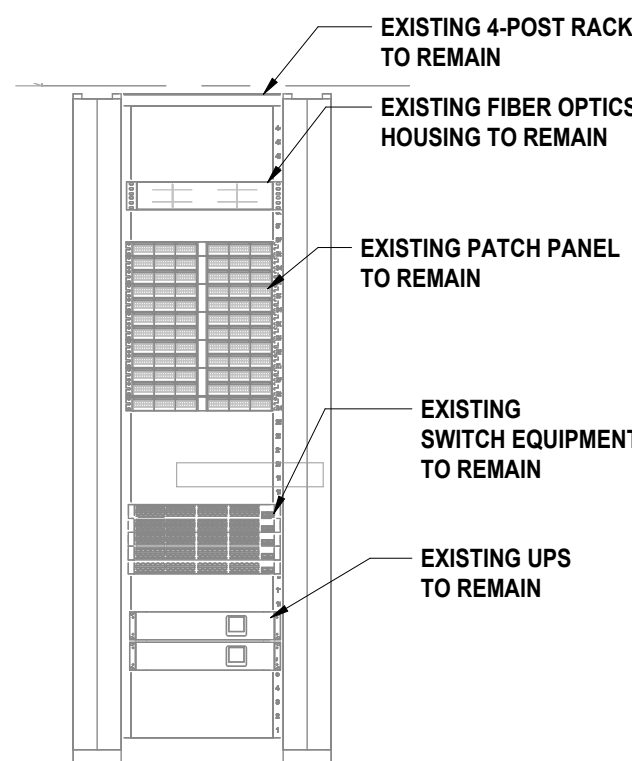
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DATE:	05/09/2025
PHASE:	CD

**"IT IS A VIOLATION OF THE LAW FOR ANY PERSON TO MAKE UNAUTHORIZED ALTERATIONS OR ADDITIONS TO PLANS**






2 IDF-4 ENLARGED TECHNOLOGY PLAN  
1/4" = 1'-0"

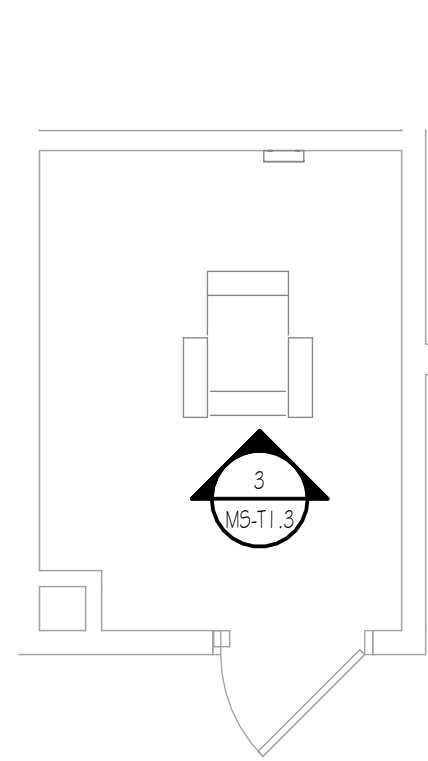

3 IDF-4 RACK ELEVATION  
1/2" = 1'-0"

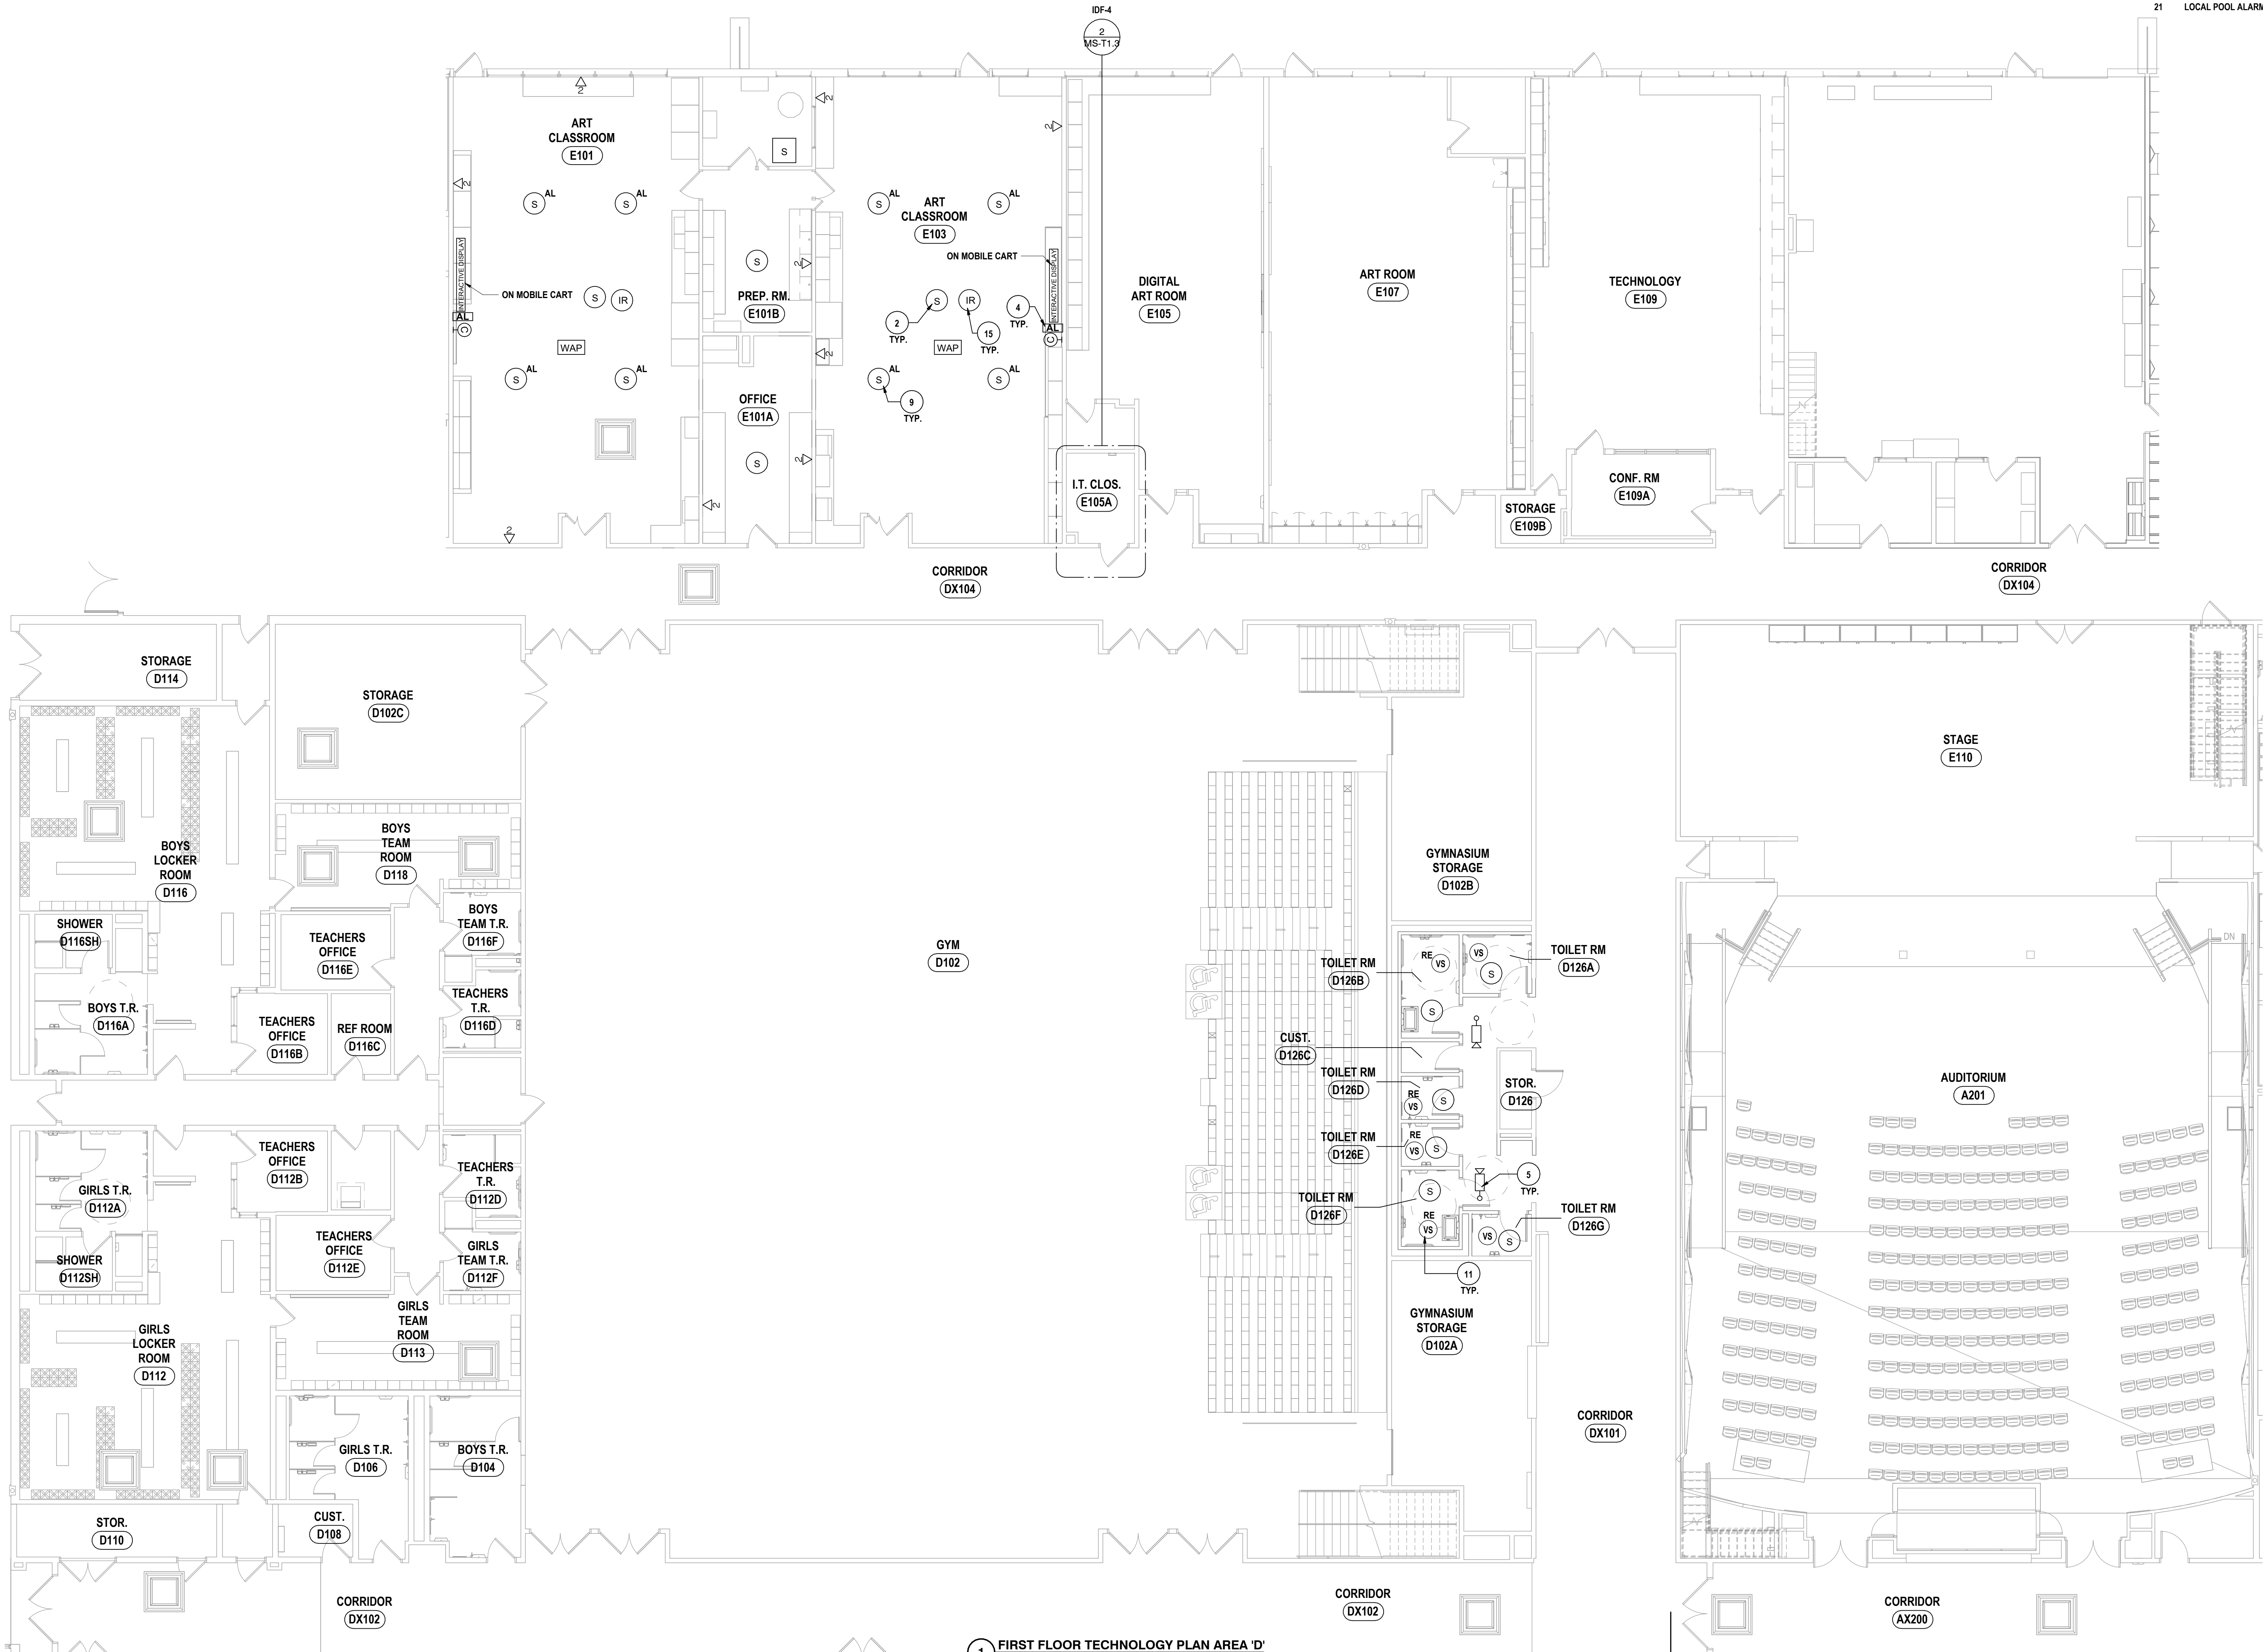

1 FIRST FLOOR TECHNOLOGY PLAN AREA 'D'  
1/8" = 1'-0"

#### GENERAL NOTES

- ALL CABLING INSTALLATION AND TERMINATION TO ADHERE TO CURRENT NEC CODES AND RELATED ANSII/TIA/EIA STANDARDS.
- DURING INSTALLATION OF CABLING, ANY DAMAGE TO ANY FUNCTIONING CABLING SYSTEM IS THE RESPONSIBILITY OF, AND WILL BE REPAIRED BY THE CONTRACTOR.
- WHEN INSTALLING CEILING MOUNTED DEVICES, ADJUST LOCATION TO AVOID OTHER CEILING MOUNTED DEVICES SUCH AS EXIT SIGNS, ECT.
- ALL DATA CABLING SHALL BE PLENUM RATED PER SPECIFICATIONS.
- OWNER TO APPROVE FINAL LOCATION AND VIEW OF ALL CAMERAS.
- ALL ELECTRONIC AND NETWORKING SERVICES NEED TO BE COORDINATED WITH OWNER PRIOR TO REMOVAL AND DISCONNECTION.
- ALL CEILING MOUNTED DEVICES TO BE SUPPORTED BY STRUCTURE ABOVE. DO NOT USE CEILING GRID AS SOLE SUPPORT MECHANISM.

#### CONSTRUCTION NOTES - TECHNOLOGY

- CLOCK TO BE INSTALLED PER SPECIFICATIONS & DETAILS.
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- WIRELESS ACCESS POINT TO BE INSTALLED PER SPECIFICATIONS & DETAILS.
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- SURVEILLANCE CAMERA TO BE INSTALLED PER SPECIFICATIONS & DETAILS.
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- DAS ANTENNA TO BE REINSTALLED.
- CEILING MOUNTED TYPE MOTION SENSOR TO BE INSTALLED PER SPECIFICATIONS & DETAILS.
- ASSISTIVE LISTENING IR SENSOR TO BE INSTALLED PER SPECIFICATIONS & DETAILS.
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- CARD READER TO BE INSTALLED PER SPECIFICATIONS & DETAILS.
- KEYPAD TO BE INSTALLED PER SPECIFICATIONS & DETAILS.
- LOCAL POOL ALARM PULL STATION PER SPECIFICATIONS & DETAILS.
- LOCAL POOL ALARM STROBE/HORN PER SPECIFICATIONS & DETAILS.

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DATE: 05/09/2025	
PHASE: CD	
#	DATE
1	11/03/2025
DESCRIPTION OF REVISION: ISSUED FOR BID	
IT IS A VIOLATION OF THE LAW FOR ANY PERSON TO MAKE UNAUTHORIZED ALTERATIONS OR ADDITIONS TO PLANS DRAWN BY LICENSED ARCHITECTS OR SURVEYORS ONLY.	

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NY CERTIFICATE NO. 0016220 PA CERTIFICATE NO. TSC220013464-1

FIRST FLOOR TECHNOLOGY PLAN - AREA D  
2025 MIDDLE SCHOOL PHASE III ALTERATIONS PROJECT  
CORNING-PAINTED POST ASD  
35 VICTORY HIGHWAY, PAINTED POST, NY 14870

MS-T1.3  
PROJECT NO: 2649-133


SED #: 5716-00-01-0024-044 - MIDDLE SCHOOL

GENERAL NOTES


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- D ALL DATA CABLING SHALL BE PLENUM RATED PER SPECIFICATIONS.
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- F ALL ELECTRONIC AND NETWORKING SERVICES NEED TO BE COORDINATED WITH OWNER PRIOR TO REMOVAL AND DISCONNECTION.
- G ALL CEILING MOUNTED DEVICES TO BE SUPPORTED BY STRUCTURE ABOVE. DO NOT USE CEILING GRID AS SOLE SUPPORT MECHANISM.

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- 21 LOCAL POOL ALARM STROBEHORN PER SPECIFICATIONS & DETAILS.

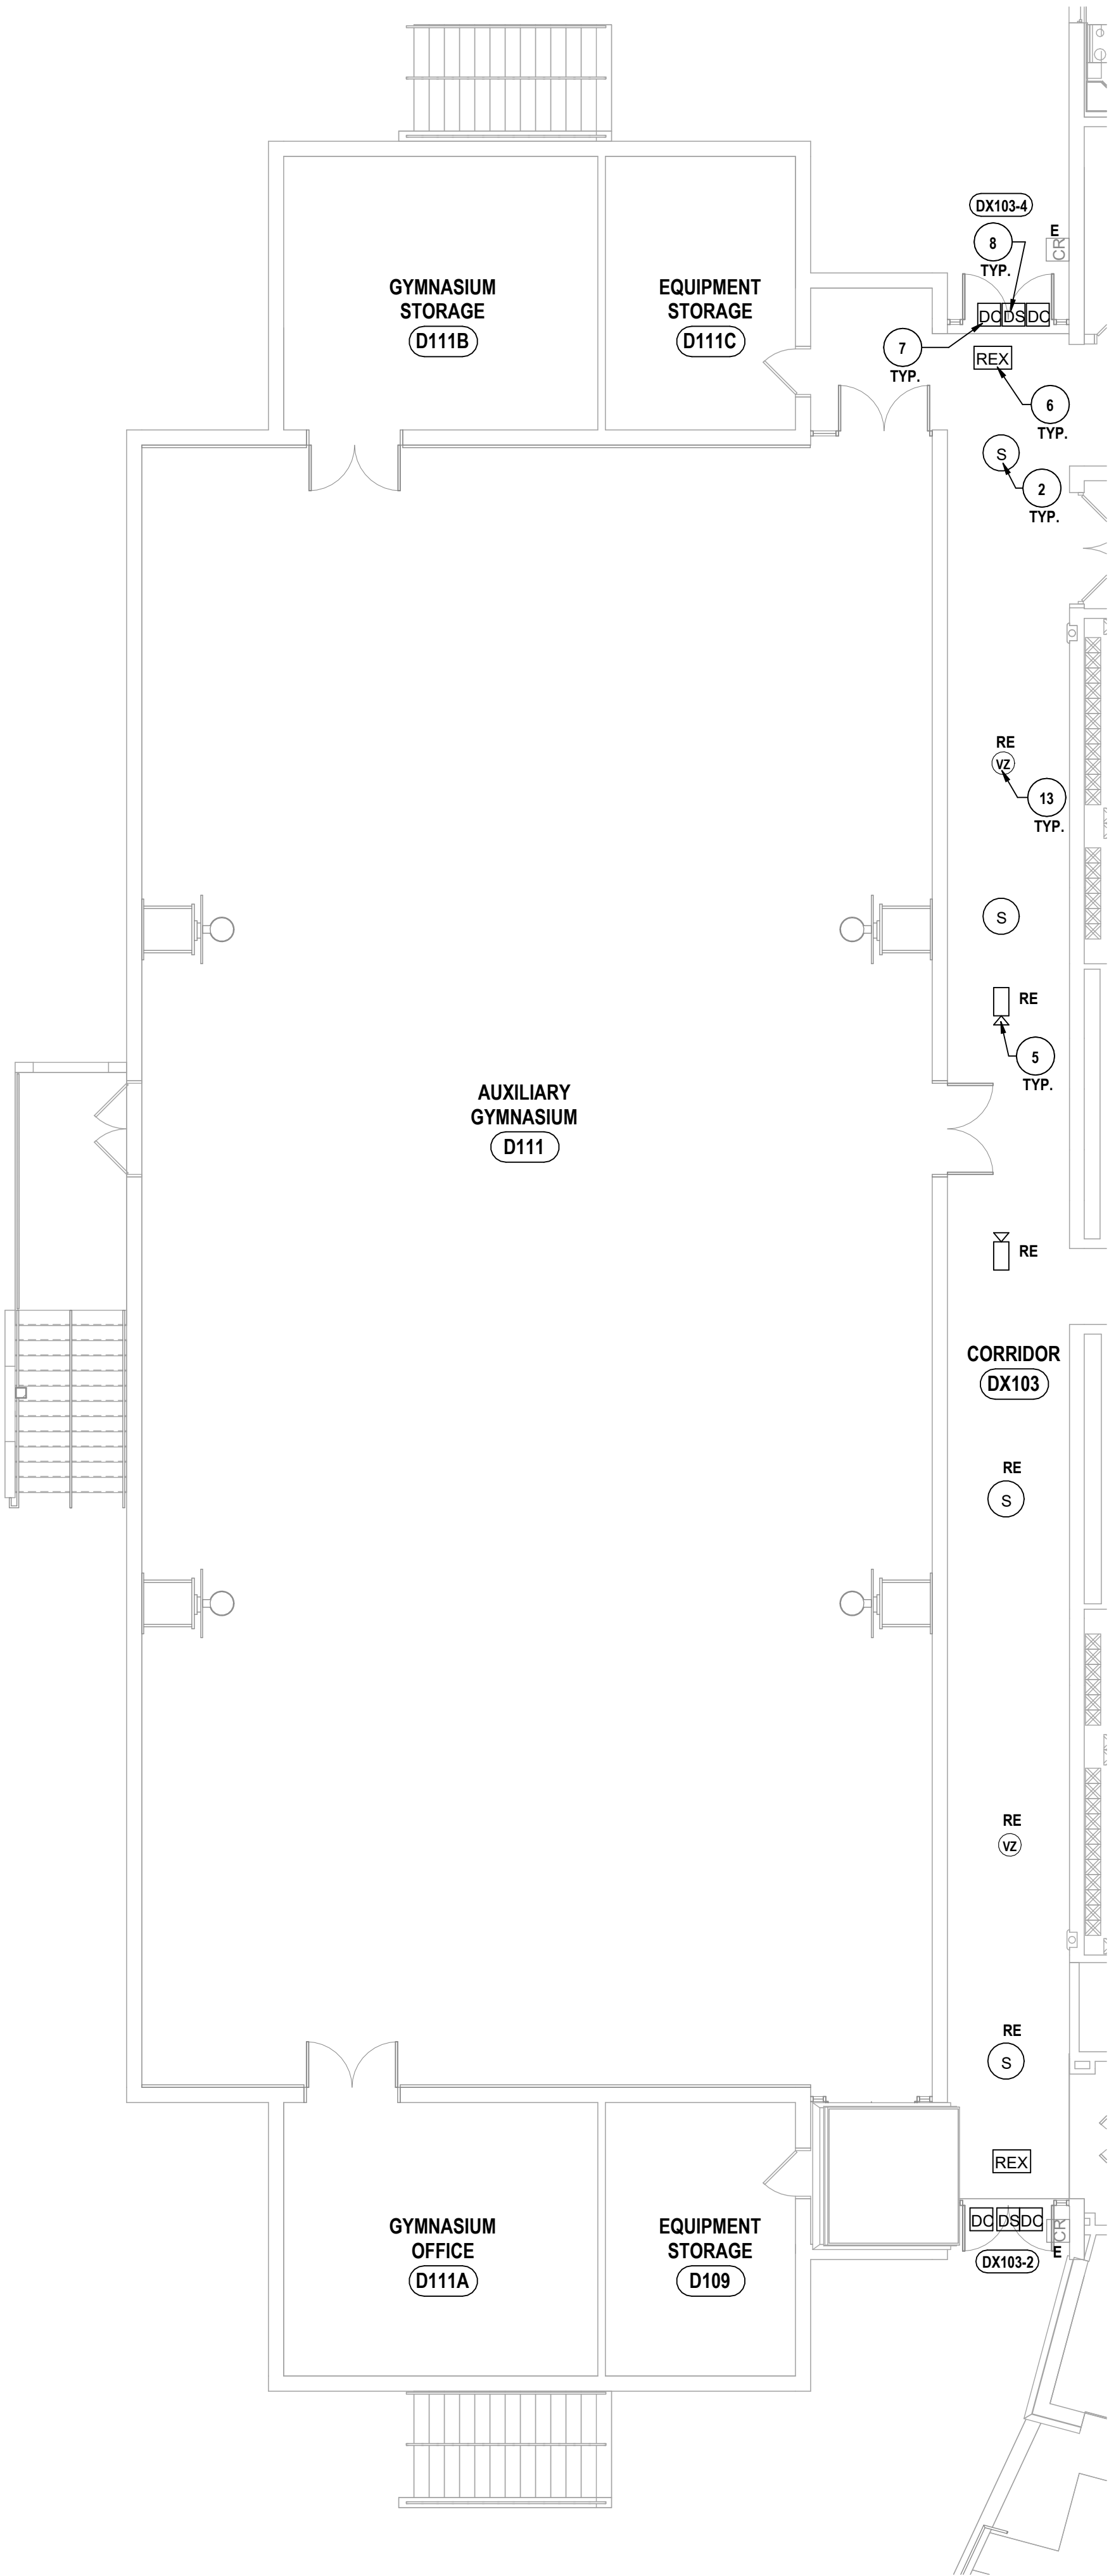

1 FIRST FLOOR TECHNOLOGY PLAN AREA 'E'  
1/8" = 1'-0"

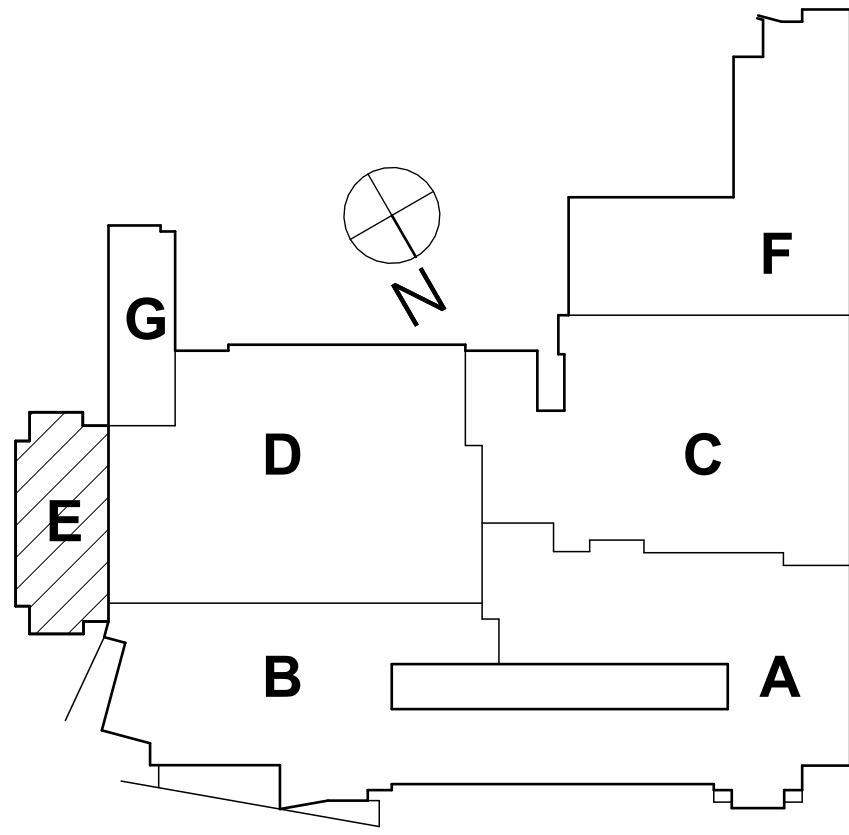

SED #: 57-16-00-01-2-024-044 - MIDDLE SCHOOL


FIRST FLOOR TECHNOLOGY PLAN - AREA E  
2025 MIDDLE SCHOOL PHASE III ALTERATIONS PROJECT  
CORNING-PAINTED POST ASD  
35 VICTORY HIGHWAY, PAINTED POST, NY 14870

MS-T1.4  
PROJECT NO: 2649-133

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		DATE:	05/09/2025	
		PHASE:	CD	



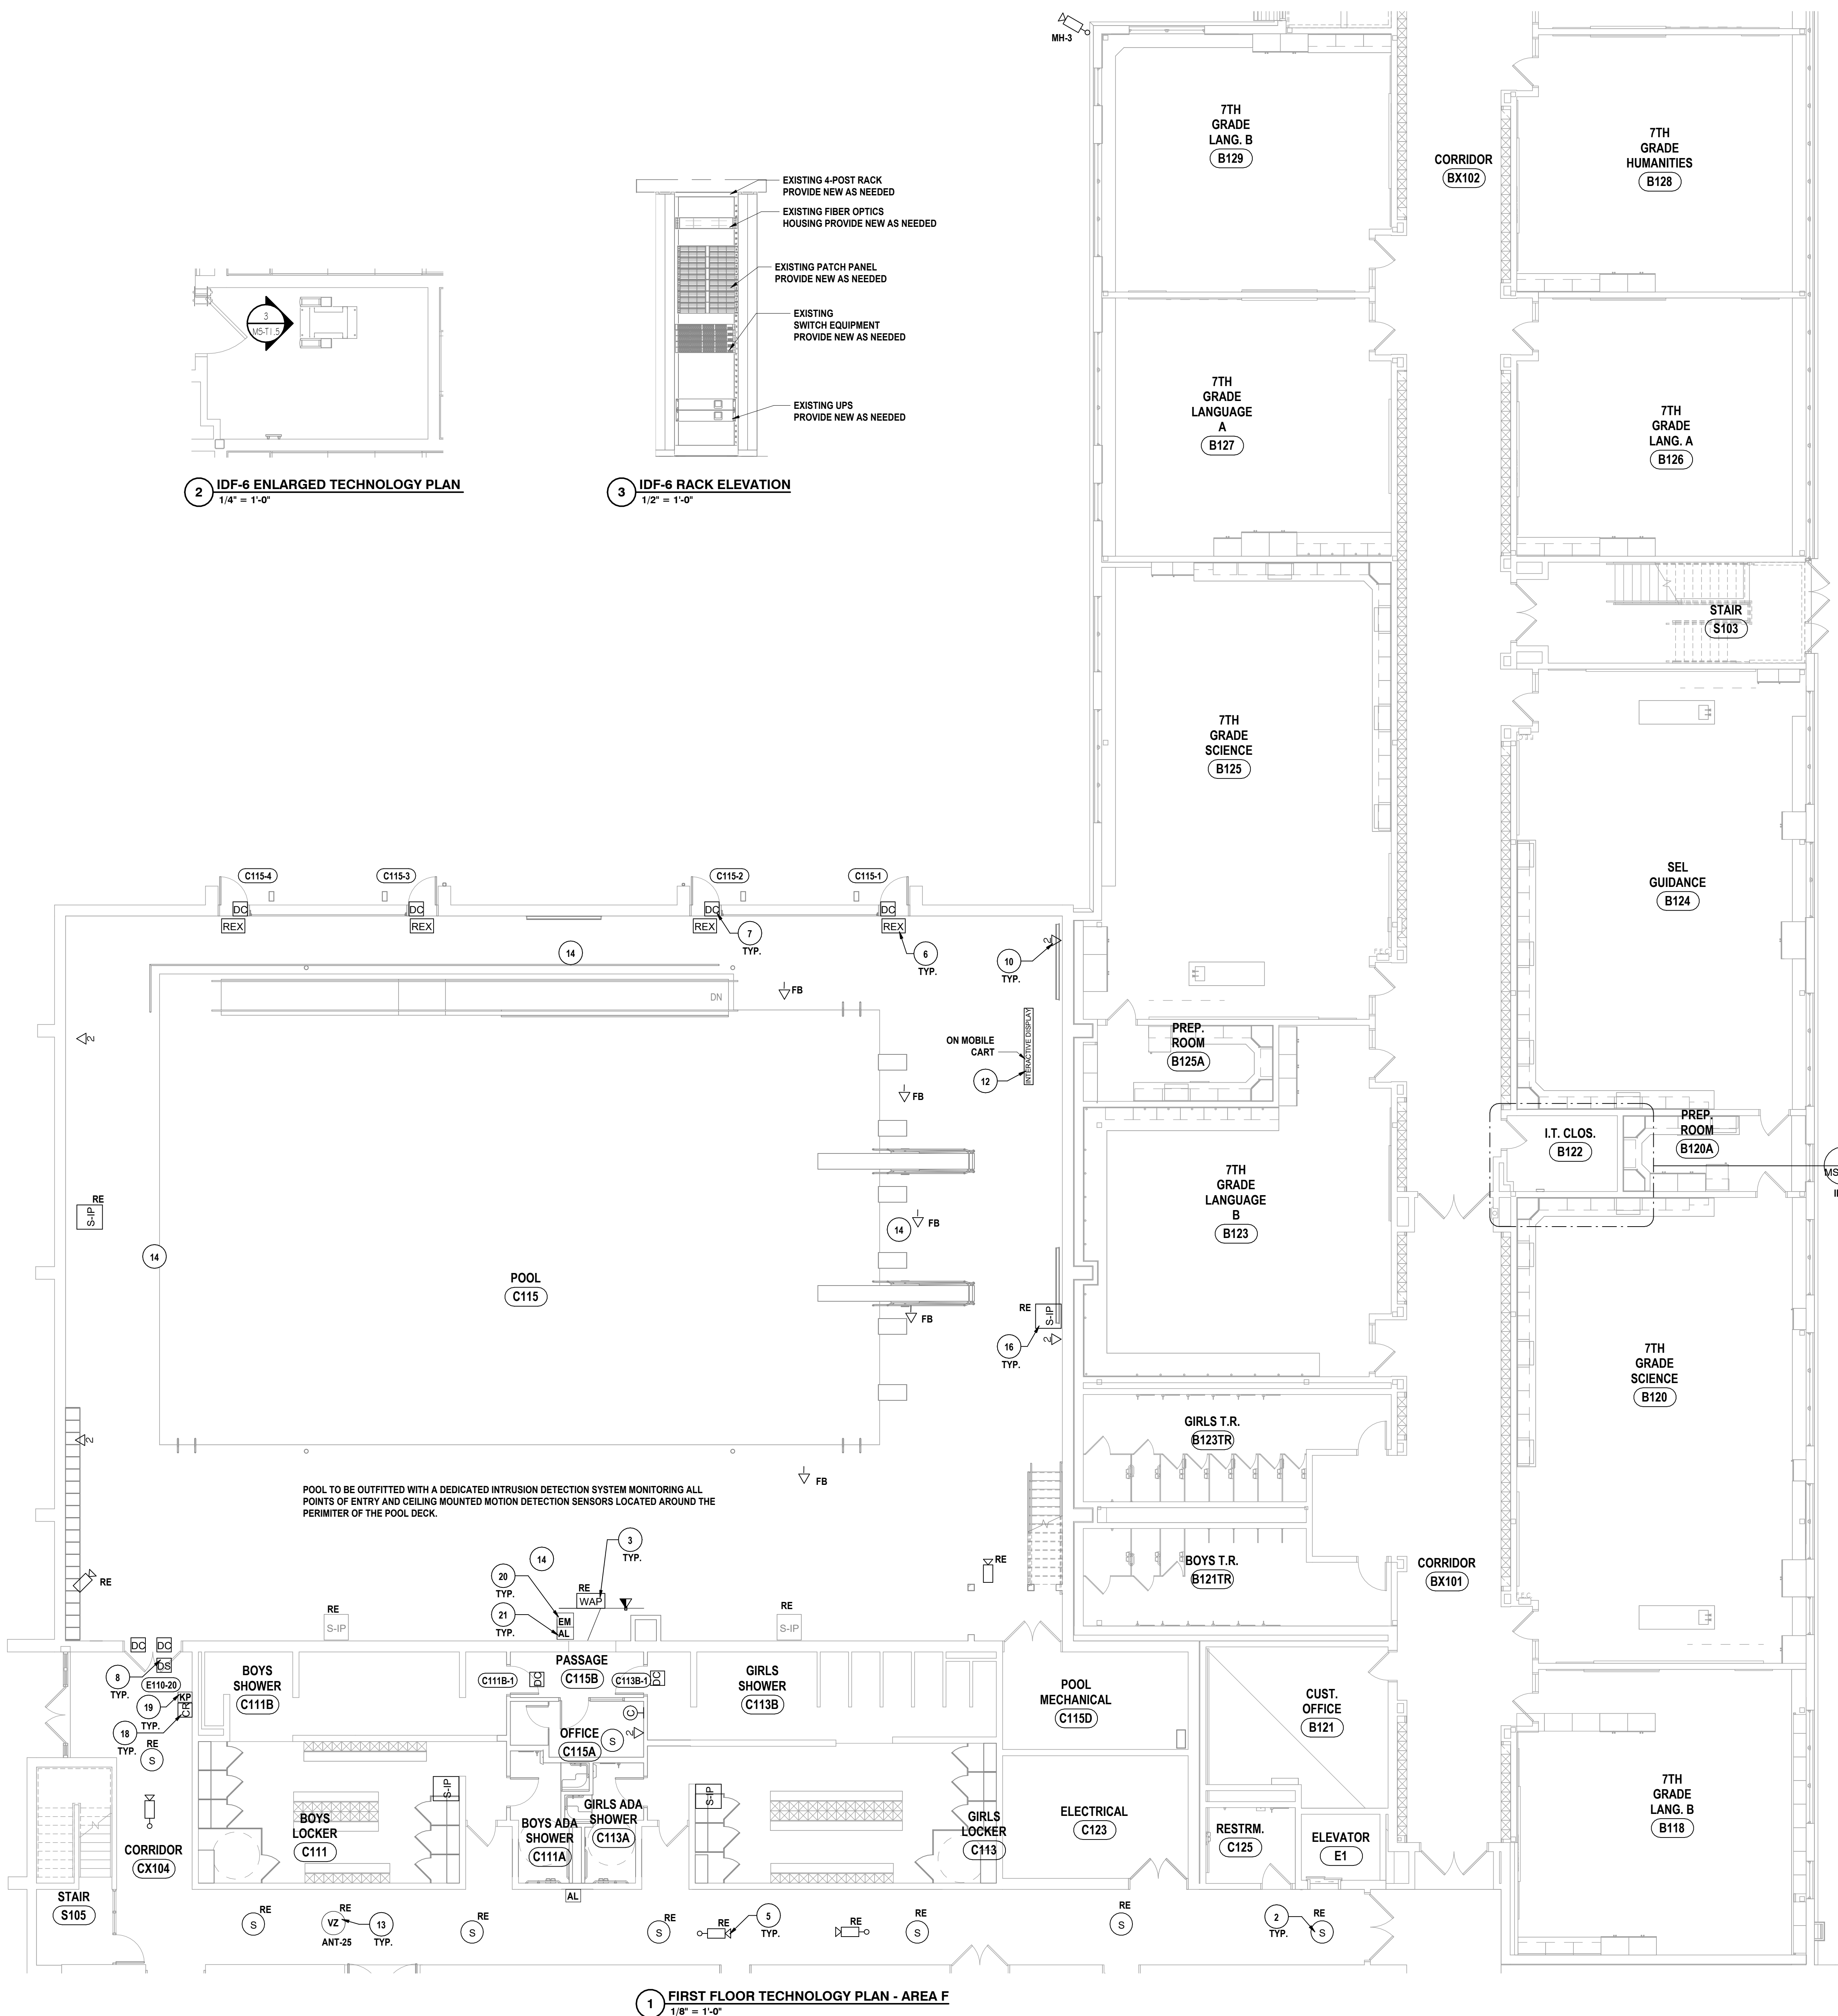

2 IDF-6 ENLARGED TECHNOLOGY PLAN  
1/4" = 1'-0"

3 IDF-6 RACK ELEVATION  
1/2" = 1'-0"


1 FIRST FLOOR TECHNOLOGY PLAN - AREA F  
1/8" = 1'-0"

GENERAL NOTES

- A ALL CABLING INSTALLATION AND TERMINATION TO ADHERE TO CURRENT NEC CODES AND RELATED ANS/IT/IEA STANDARDS.
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- 5 SURVEILLANCE CAMERA TO BE INSTALLED PER SPECIFICATIONS & DETAILS.
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- 19 KEYPAD TO BE INSTALLED PER SPECIFICATIONS & DETAILS.
- 20 LOCAL POOL ALARM PULL STATION PER SPECIFICATIONS & DETAILS.
- 21 LOCAL POOL ALARM STROBEHORN PER SPECIFICATIONS & DETAILS.



SED #: 57-000-01-000-044 - MIDDLE SCHOOL

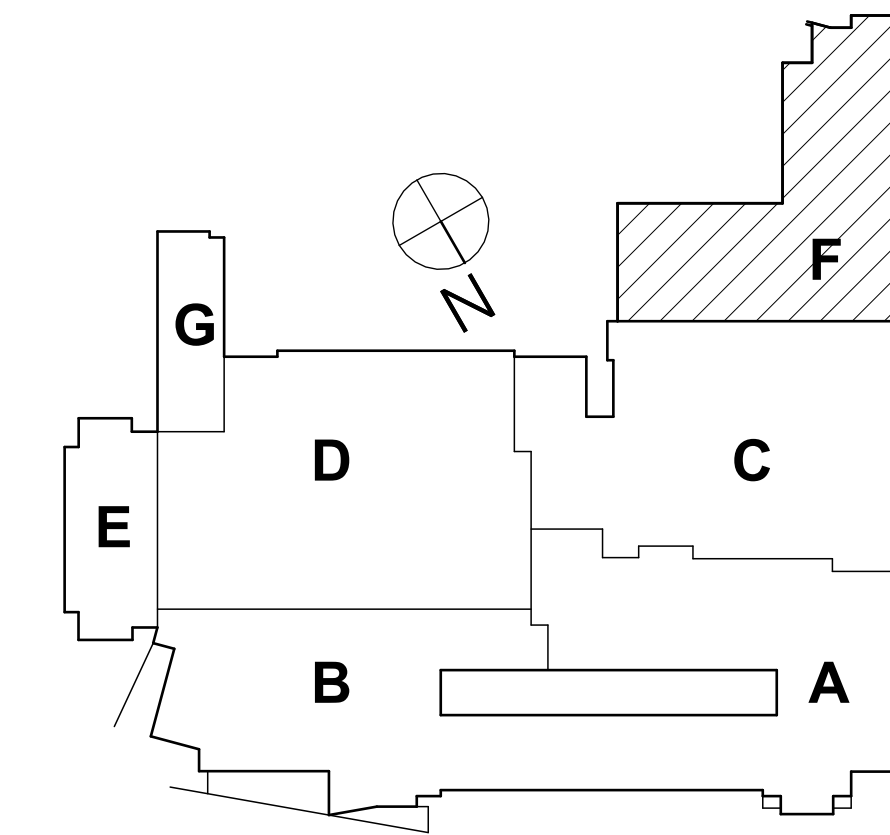FIRST FLOOR TECHNOLOGY PLAN - AREA F  
2025 MIDDLE SCHOOL PHASE III ALTERATIONS PROJECT  
CORNING-PAINTED POST ASD  
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NY CERTIFICATE NO. 001620 PA CERTIFICATE NO. TSC220013/464-1

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DATE: 05/09/2025	
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#	DATE: 11/03/2025
	DESCRIPTION OF REVISION: ISSUED FOR BID
IT IS A VIOLATION OF THE LAW FOR ANY PERSON TO MAKE UNAUTHORIZED ALTERATIONS OR ADDITIONS TO PLANS DRAWN BY LICENSED ENGINEERS, ARCHITECTS, OR SURVEYORS.	

MS-T1.5  
PROJECT NO: 2649-133

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#	DATE:	DESCRIPTION OF REVISION:
1	10/20/2023	ISSUED FOR BID
<p>IT IS A VIOLATION OF THE LAW FOR ANY PERSON TO MAKE UNAUTHORIZED ALTERATIONS OR ADDITIONS TO PLANS BEING A LICENSED ENGINEER, ARCHITECT'S OR SURVEYOR'S SEAL.</p>		

**HUNTER**  
HORSEHEADS, NY

**MS-T2.1**

PROJECT NO: 2649-153

4'-0"

1'-0"

FINISHED FLOOR OR GRADE

WALL

ACCEPTABLE MOUNTING HEIGHT RANGE  
48 INCHES MAX.  
15 INCHES MIN.

Diagram illustrating acceptable mounting height ranges for signs, showing two scenarios: one with a wall and one without.

**Left Diagram (Wall):**

- WALL
- ACCEPTABLE MOUNTING HEIGHT RANGE: 48 INCHES MAX. 15 INCHES MIN.
- OBSTRUCTION: 20 INCHES MAX. DEPTH
- FINISHED FLOOR OR GRADE
- OPEN SPACE, REQUIRED
- Dimensions: 4' - 0" (total height), 1' - 3" (obstruction height), 1' - 0" (obstruction depth).

**Right Diagram (No Wall):**

- WALL
- ACCEPTABLE MOUNTING HEIGHT RANGE: 44 INCHES MAX. 15 INCHES MIN.
- OBSTRUCTION: 25 INCHES MAX. DEPTH
- FINISHED FLOOR OR GRADE
- OPEN SPACE, REQUIRED
- Dimensions: 3' - 0" (total height), 1' - 3" (obstruction height), 2' - 1" (obstruction depth).

**CONTROL WIRING FOR EL AND SENSORS LOCATED WITHIN DOOR TRIM**

**18/4 COND. SHIELDED CONTROL WIRING FOR REX**

**NOTE: ALL CONTROL WIRING PLENUM RATED**

**DOOR HARDWARE JUNCTION BOX WITH POWER SUPPLY AND WIRING TERMINAL (TYP)**

**INSTALL 3 WIRE SIZED FOR DISTANCE / VOLT DROP**

**ELR POWER SUPPLY**

**MIN. 18/3**

**110V AC**

**POWER CIRC.**

**INSTALL CONDUIT & ROUGH IN, TYP.**

**ELECTRIC POWER TRANSFER**

**EXTERIOR DOOR**

**CONTROL WIRING FOR EL AND SENSORS LOCATED WITHIN DOOR TRIM**

**18/4 COND. SHIELDED CONTROL WIRING FOR CARD READER**

**CONTROL WIRING FOR ELR AND SENSORS LOCATED WITHIN DOOR TRIM**

**110V AC**

**POWER CIRC.**

**INSTALL CONDUIT OR RACEWAY & ROUGH IN, TYP.**

**ELECTRIC POWER TRANSFER**

**INTERIOR DOOR**

**INTERCOM CABLING CAT6 FOR IP INTERCOM**

**18/2 CONTROL WIRING FOR DOOR CONTACTS**

**400FT LIMITATION FOR ELECTRIC DOOR STRIKE. SIZE WIRE FOR VOLTAGE DROP.**

**DOOR CONTROLLER**

**110V AC**

**POWER CIRC.**

**SYSTEM CONTROLLER AND POWER SUPPLY(S)**

**ACCESS CONTROL PANEL**

**INSTALLATION OF DOOR CONTROLLER AND WIRING PER MANUFACTURERS REQUIREMENTS TYP. FOR ALL DEVICES SHOWN, INSTALL 10K RESISTORS AS REQUIRED**

**EXISTING ACCESS CONTROL PANEL**

**CONTROL AND POWER WIRING TO ELECTRIC LOCKING HARDWARE**

**ACCESS CONTROL DOOR HARDWARE**

**NOTE: IF EXISTING DOOR FRAME IS FULLY GROUDED SOLID, PROVIDE RACEWAY ON THE SECURED SIDE AND FLEXIBLE METAL CONDUIT TO DOOR HARDWARE.**

**MOUNTING OF CARD READER, INTERCOM, AND ASSOCIATED CONDUIT & BACKBOXES**

NOTE: WHERE A CLEAR FLOOR OR GROUND SPACE ALLOWS A PARALLEL APPROACH TO AN ELEMENT AND THE SIDE REACH IS UNOBSTRUCTED, THE HIGH SIDE REACH SHALL BE 48 INCHES MAXIMUM AND THE LOW SIDE SHALL BE 15 INCHES MINIMUM ABOVE THE FINISHED FLOOR/GRADE.

EXCEPTION: AN OBSTRUCTION SHALL BE PERMITTED BETWEEN THE CLEAR FLOOR/GRADE SPACE AND THE ELEMENT WHERE THE DEPTH OF THE OBSTRUCTION IS 10 INCHES MAXIMUM.

4'-0"

1'-3"

FINISHED FLOOR OR GRADE

1'-0"

WALL

ACCEPTABLE MOUNTING  
HEIGHT RANGE  
48 INCHES MAX.  
15 INCHES MIN.

OBSTRUCTION  
10 INCHES MAX. DEPTH

4'-0"

2'-10"

FINISHED FLOOR OR GRADE

1'-0"

WALL

ACCEPTABLE MOUNTING  
HEIGHT RANGE  
48 INCHES MAX.  
15 INCHES MIN.

OBSTRUCTION  
10 INCHES MAX. DEPTH  
34 INCHES MAX. HEIGHT

4'-0"

2'-10"

FINISHED FLOOR OR GRADE

2'-0"

WALL

ACCEPTABLE MOUNTING  
HEIGHT RANGE  
48 INCHES MAX.  
15 INCHES MIN.

OBSTRUCTION  
24 INCHES MAX. DEPTH  
34 INCHES MAX. HEIGHT

**7 ACCESS CONTROL RISER DIAGRAM**  
NTS

**E: PATCH CABLES ON DATA RACK END TO BE YELLOW**

Diagram illustrating the installation of a Vape Sensor for data collection.

**Installation to Ceiling:**

- Roof Deck
- Patch Cable
- Service Loop
- Suspended Ceiling
- Installation of Vape Sensor to Ceiling Grid per Manufacturer's Instructions.
- Cable to Data Closet per Wiring Zones Laid Out on Key Plan.

**Installation to Wall:**

- Wall Penetration & 3/4" Conduit for Wall Mounted Vape Sensor. Data Jack Above Ceiling on the Opposite Side of the Wall.
- Wall
- Patch Cable
- Patch Panels per Specification as Needed
- Data Rack
- Existing Network Switch

**Notes:**

- Device should be installed at least one 2'x2' ceiling tile away from any air vent or HVAC unit. Do not install next to any air vent/HVAC unit.
- Device should be in an area relatively free of air currents and 8-to-9-foot height from floor. Avoid HVAC exhaust or return ducts, fans, operable windows and areas near the door between two rooms. Device mounting should avoid areas with significant background noise or vibration.

BRIDLE RINGS ARE NOT PERMITTED FOR DATA PATHWAYS

MOUNTING SCREWS/BOLTS

DATA CABLES INSTALLED IN J-HOOKS. FILL COUNT PER J-HOOK SIZE. NO OTHER POWER OR LOW VOLTAGE SYSTEM CABLES TO BE INSTALLED IN J-HOOKS WITH DATA CABLEING.

VIEW A-A

SADDLE STYLE CABLE HANGERS APPROVED FOR USE WITH HIGH SPEED DATA CABLEING. SECURE CABLE HANGERS TO STRUCTURE PER MANUFACTURER'S INSTALLATION INSTRUCTIONS. NO BRIDLE RINGS ARE PERMITTED. PANDUIT J-PRO CABLE SUPPORT SYSTEM

4' MAXIMUM SPACING

MIN. 6"

FINISHED CEILING

N.T.S.

**J-HOOK FILL CHART BASED ON CADDY HP J-HOOKS AT 70% FILL RATE**

CADDY CAT HP PART NUMBER	DIAMETER	CAT 6A CABLE CAPACITY
CAT32HP	2"	35
CAT48HP	3"	60
CAT64HP	4"	140

NOTES:

1. LOW VOLTAGE CABLES SHALL BE INSTALLED IN J-HOOKS AND TIED TOGETHER WITH VELCRO STRAPS WHEN NO CABLE TRAY IS PRESENT
2. REFER TO SPECIFICATIONS FOR ADDITIONAL INSTALLATION REQUIREMENTS FOR CABLEING AND HANGERS
3. USE MULTIPLE HANGERS AT ALL TURNS TO ENSURE THAT THE REQUIRED MINIMUM BEND RADIUS IS MAINTAINED
4. HANGERS SHALL BE LOCATED IN AREAS THAT ARE ACCESSIBLE AFTER THE PROJECT IS COMPLETE
5. HANGERS SHALL BE INSTALLED ALONG WALLS WHERE POSSIBLE AT A MINIMUM OF 6" ABOVE THE FINISHED CEILING AREA
6. NO OTHER POWER OR LOW VOLTAGE SYSTEM CABLES TO BE INSTALLED IN J-HOOKS WITH DATA CABLEING
7. SIZE ALL J-HOOKS TO MAINTAIN 40% FILL FACTOR

CAT6A PATCH CABLE PER SPECIFICATIONS

ROOF DECK

SERVICE LOOP PER SPECIFICATIONS AT DATA JACK

CEILING INSTALLATION

INSTALLATION OF WIRELESS ACCESS POINT FURNISHED BY OWNER USING CEILING GRID CLIP. MOUNT PER MANUFACTURERS INSTRUCTIONS.

INSTALL CAT6A CABLE TO DATA CLOSET PER WIRING ZONES LAYED OUT ON KEY PLAN.

WALL INSTALLATION

WALL

CAT6A PATCH PANELS PER SPECIFICATION AS NEEDED

CAT6A PATCH CABLE PER SPECIFICATIONS

EXISTING NETWORK SWITCH

DATA RACK

**NOTE: THIS DETAIL APPLIES TO BOTH NEW AND EXISTING CABLING HANDLED BY THE CONTRACTOR THIS PROJECT.**

The diagram shows a cable with a label that reads "MDF-1/R1/PPA/24". An arrow points from the text "RACK END AND OUTLET END" to the label. Below the label, the text "TYPICAL LABEL EXAMPLE" is written. The cable is shown entering a rack from the left and exiting to the right.

**INSTALL MECHANICALLY PRINTED WRAP AROUND LABELING FOR ALL DATA CABLES ON BOTH ENDS OF THE CABLE RUN PER SPECIFICATION 27 05 53.**

Diagram illustrating the installation of firestopping in a conduit penetration through a floor or wall. The diagram shows a cross-section of the assembly with the following components and labels:

- NO OTHER POWER OR LOW VOLTAGE SYSTEM CABLES TO BE INSTALLED IN CONDUITS WITH DATA CABLES.** (Text at the top left)
- CABLES** (Label pointing to the cables being installed)
- FIRESTOP PUTTY** (Label pointing to the putty applied to the cables)
- FLOOR OR WALL** (Label pointing to the structure being penetrated)
- INSTALL LABEL ON BOTH SIDES OF PENETRATION. LABEL TO SHOW FIRESTOPPING INFORMATION WHICH SHALL INCLUDE: TYPE OF FIRESTOPPING PRODUCT, CONTRACTOR COMPANY NAME, HOUR RATING, DATE AND HUNT PROJECT NO.** (Text at the top right)
- CLEAN AND DRY SURFACE FOR LABEL** (Label pointing to the surface where the label is attached)
- FORMING MATERIAL (eg. MINERAL WOOL)** (Label pointing to the material used for the firestop)
- FIRESTOPPING PER ARCH DETAILS, SECTION 07 84 00** (Label pointing to the firestopping material)
- FIRESTOP PUTTY** (Label pointing to the putty applied to the cables)
- CONDUIT SLEEVE(S) BELOW 2" DIA.** (Label pointing to the conduit sleeve)

**1 CONDUIT PENETRATION DETAIL**  
NTS

SED #: 57-10-00-01-0-024-044 - MIDDLE SCHOOL



