AVOCA CENTRAL SCHOOL DISTRICT 2025-2026 CAPITAL OUTLAY EXCEPTION PROJECT

CPLteam.com NY ENGINEERING FIRM CERTIFICATE #0021419

PROJECT INFORMATION

AVOCA CENTRAL SCHOOL

2025-2026 CAPITAL OUTLAY

17 OLIVER STREET AVOCA, NEW YORK 14809

EXCEPTION PROJECT

MAIN BUILDING: 57-02-01-04-0-002-027

PROJECT ISSUE & REVISION SCHEDULE

R25.17323.00

255 Woodcliff Drive Suite 200, Fairport, NY 14450

SED NO. MAIN BUILDING 57-02-01-04-0-002-026

DISTRICT OFFICE ADDRESS 17 OLIVER STREET AVOCA, NEW YORK 14809

GENERAL SET NOTES

- DO NOT SCALE DRAWINGS. CONSULT ARCHITECT FOR ANY MISSING DIMENSIONS.
- ANY PERSPECTIVE, 3D, OR AXONOMETRIC VIEWS THAT MAY EXIST WITHIN THIS DRAWING SET ARE PURELY SUPPLEMENTAL AND REPRESENTATIVE IN NATURE AND ILLUSTRATE ONLY THE DESIGN INTENT. THESE VIEWS MAY NOT REFLECT PRESICE/COMPLETE DETAILING. REFER TO TWO-DIMENSIONAL DOCUMENTATION
- GENERAL NOTES AND LEGENDS WITHIN A SERIES (I.E. PLAN NOTES OR PLAN LEGEND) APPLY TO ALL SHEETS WITHIN THAT SERIES, REGARDLESS OF ON WHICH SHEET THE GENERAL NOTES OR LEGEND APPEARS.

GENERAL DEFINITIONS

THIS TERM SHALL DENOTE THE APPROXIMATE PROJECT BOUNDARY.

THE PRESENCE OF "HOLD" IN A DIMENSION STRING INDICATES THAT THE HEIGHT/LENGTH MUST BE EXACTLY THE DIMENSION SPECIFIED. ANY VARIANCE MUST BE REVIEWED BY THE ARCHITECT PRIOR TO CONSTRUCTION. THESE DIMENSIONS SHALL BE FROM OUTSIDE FACE OF FARTHEST FINISH TO OUTSIDE FACE OF FARTHEST FINISH, INCLUDING APPLIED

THE PRESENCE OF "CLEAR" IN A DIMENSION STRING INDICATES THAT THE HEIGHT/LENGTH MUST BE AT LEAST THE DIMENSION SPECIFIED. THESE DIMENSIONS ARE FROM FACE OF FARTHEST FINISH TO FACE OF FARTHEST FINISH, INCLUDING APPLIED FINISHES. ANY DISCREPANCY MUST BE REVIEWED BY THE ARCHITECT. WHERE USED IN CONJUNCTION WITH ANOTHER TERM (I.E. "MIN CLEAR"), SLIGHT VARIATIONS IN THIS DIMENSION ARE ACCEPTABLE SO LONG AS THE MINIMUM SIZE IS MAINTAINED. A VARIANCE OVER 1" MUST BE REVIEWED BY THE ARCHITECT PRIOR TO COMMENCEMENT OF ALL WORK.

MINIMUM OR MIN: THE PRESENCE OF "MIN" OR "MINIMUM" IN A DIMENSION STRING INDICATES A MINIMUM CLEAR HEIGHT/LENGTH OF THE AMOUNT INDICATED. THESE DIMENSIONS ARE FROM FACE OF FARTHEST FINISH TO FACE OF FARTHEST FINISH, INCLUDING APPLIED FINISHES. SLIGHT VARIATIONS IN THIS DIMENSION ARE ACCEPTABLE SO LONG AS THE MINIMUM

MAXIMUM OR MAX:

SIZE IS MAINTAINED.

THE PRESENCE OF "MAX" OR "MAXIMUM" IN A DIMENSION STRING INDICATES A MAXIMUM CLEAR HEIGHT/LENGTH OF THE AMOUNT INDICATED. THESE DIMENSIONS ARE FROM FACE OF FARTHEST FINISH TO FACE OF FARTHEST FINISH, INCLUDING APPLIED FINISHES. SLIGHT VARIATIONS IN THIS DIMENSION ARE ACCEPTABLE SO LONG AS THE MAXIMUM SIZE IS NOT REACHED.

SUPPLY AND DELIVER TO PROJECT SITE, READY FOR UNLOADING, UNPACKING, ASSEMBLY, INSTALLATION, AND SIMILAR OPERATIONS.

OPERATIONS AT PROJECT SITE INCLUDING UNLOADING, TEMPORARILY STORING, UNPACKING, ASSEMBLING, ERECTING, PLACING, ANCHORING, APPLYING, WORKING TO DIMENSION, FINISHING, CURING, PROTECTING, CLEANING, AND SIMILAR OPERATIONS.

FURNISH AND INSTALL, COMPLETE AND READY FOR THE INTENDED USE.

DIMENSIONING NOTES

- ALL CONTENT ON DEMOLITION PLANS INDICATE GRAPHIC REPRESENTATION OF COMMENCEMENT OF ALL DEMOLITION WORK. COORDINATE ANY DISCREPANCIES WITH ARCHITECT PRIOR TO COMMENCEMENT OF ALL WORK.
- S. ALL DIMENSIONS TO GLAZING SYSTEMS ARE TO FINISHED JAMB OR CENTERLINE OF mullion/gasket, unless noted otherwise. These outside dimensions are ROUGH OPENING SIZES, AND GLAZING SYSTEMS ARE TO BE ADJUSTED
- TO ACCOUNT FOR SHIMS, SEALANT, ETC. AS REQUIRED. REFER TO TYPICAL FIXTURE AND ACCESSORY LEGENDS SHEET FOR MORE SPECIFIC DIMENSIONING REQUIREMENTS SURROUDNING FIXTURES AND ACCESSORIES. . FIELD VERIFY ALL APPLICABLE DIMENSIONS PRIOR TO SHOP DRAWING SUBMITTAL.


SYMBOLS LEGEND

(300-1) DOOR TAG

WINDOW TAG ACCESSORY. RE: A700

ROOM NAME ROOM TAG H1234.2

XXX WALL TYPE SEE A/400

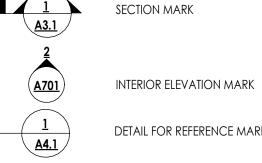

DENOTES FINISH FLOOR GRADE ELEVATION

DETAIL FOR REFERENCE MARK

DRAWING LIST FIRST FLOOR AREA OF WORK PLAN SECOND FLOOR AREA OF WORK PLAN

DEMOLITION AND NEW WORK PLANS

ARCHITECTS/ENGINEERS



ARCHITECT CERTIFICATION

TO THE BEST OF MY KNOWLEDGE, INFORMATION AND BELIEF, THE PLANS AND SPECIFICATIONS ARE IN ACCORDANCE WITH APPLICABLE REQUIREMENTS OF THE BUILDING CODE OF NEW YORK STATE, THE ENERGY CONSERVATION CONSTRUCTION CODE OF NEW YORK STATE, NYSDOL INDUSTRIAL CODE RULE 56 AND THE CONSTRUCTION STANDARD OF THE NEW YORK STATE EDUCATION DEPARTMENT. NO ASBESTOS CONTAINING MATERIALS ARE SPECIFIED FOR USE IN NEW CONSTRUCTION.

09/12/2025 Registered Architect N.Y.S. Registration No. Date

KORY HUNSINGER


ABBREVIATIONS

Α		D		FS	FULL SIZE	LDR	LEADER	PVC	POLYVINYL CHLORIDE	TYP	TYPICAL
AFF	ABOVE FINISHED FLOOR	DP	DAMP PROOFING	FUT	FUTURE	LH	LEFT HAND	PC CONC	PRECAST CONCRETE	U	
AP	ACCESS PANEL	DEMO	DEMOLISH	G	'	LIB	LIBRARY	PRE FAB	PREFABRICATED	UNFIN	UNFINISHED
ACOUS	ACOUSTICAL	DEPT	DEPARTMENT	GALV	GALVANIZED	LT	LIGHT	PT	PRESSURE TREATED	UNO	UNLESS NOTED OTHERWISE
ACT	ACOUSTICAL CEILING TILE	DET,DTL	DETAIL	G	GAS	LW	LIGHT WEIGHT	PL	PROPERTY LINE	U	URINAL
AWP	ACOUSTICAL WALL PANEL	DIA	DIAMETER	GA	GAUGE	М	·	Q		٧	
ADJ	ADJACENT	DIM	DIMENSION	GEN	GENERAL	масн	MACHINE	QTY	QUANTITY	VEN	VENEER
A/C	AIR CONDITIONING	DISP	DISPENSER	GC	GENERAL CONTRACTOR	МН	MAN HOLE	R		VIF	VERIFY IN FIELD
ALT	ALTERNATE	DSP	DISPOSAL	GL	GLASS, GLAZING	мнС	MAN HOLE COVER	RAD	RADIUS	VEST	VESTIBULE
ALUM	ALUMINUM	DO	DITTO, REPEAT, SAME	GB	GRAB BAR	MFR	MANUFACTURE	RECP	RECEPTACLE	VOL	VOLUME
AB	ANCHOR BOLT	DR	DOOR	GR	GRADE, GRADING	MFRR	MANUFACTURER	RE:	REFER TO	W	
ANOD	ANODIZED	DBL	DOUBLE	GSF	GROSS SQUARE FOOT	MAS	MASONRY	REF	REFERENCE	WC	WATER CLOSET
APPROX	APPROXIMATE	DN	DOWN	GYP	GYPSUM	МО	MASONRY OPENING	REFR	REFRIGERATOR	WT	WEIGHT
ARCH	ARCHITECT, ARCHITECTURAL	DS	DOWNSPOUT	GYP BD	GYPSUM BD	MAT	MATERIALS	REINF	REINFORCED(ING)	WWF	WELDED WIRE FABRIC
AD	AREA DRAIN	DT	DRAIN TILE	GWB	GYPSUM WALL BOARD	MAX	MAXIMUM	REQ'D	REQUIRED	WWM	WELDED WIRE MESH
ACM	ASBESTOS CONTAINING MATERIA	.DWR	DRAWER	Н		месн	MECHANICAL	REV	REVISED	W	WEST
@	AT	DWG	DRAWING	HDWR	HARDWARE	MET	METAL	RH	RIGHT HAND	WIND	WINDOW
AUTO	AUTOMATIC	DF	DRINKING FOUNTAIN	HDWD	HARDWOOD	MTL	METAL	R	RISER	W/	WITH
В		E	-	HVAC	HEATING, VENTILATING & AIR	М	METER	RD	ROOF DRAIN	W/O	WITHOUT
BP	BEARING PLATE	EA	EACH		CONDITIONING	MEZZ	MEZZANINE	RM	ROOM	WD	WOOD
ВМ	BENCH MARK	EF	EACH FACE	HT, HGT	HEIGHT	MIN	MINIMUM	RO	ROUGH OPENING	Υ	
BITUM	BITUMINOUS	EW	EACH WAY	HEX	HEXAGONAL	MISC	MISCELLANEOUS	S		YD	YARD
BLK	BLOCK	Е	EAST	HWY	HIGHWAY	MR	MOISTURE RESISTANT	SAN	SANITARY		
BLKG	BLOCKING	ELEC	ELECTRICAL	НМ	HOLLOW METAL	MTD	MOUNTED	SCHED	SCHEDULE		
BD	BOARD	ELEV	ELEVATION	HORZ	HORIZONTAL	N		SEC	SECOND		
BOT	ВОТТОМ	EL	ELEVATOR	НВ	HOSE BIBB	NAT	NATURAL	SECT	SECTION		
BRK	BRICK	EMER	EMERGENCY	HW	HOT WATER	NRC	NOISE REDUCTION COEFFICIENT	SIM	SIMILAR		
BLDG	BUILDING	ENCL	ENCLOSURE	HR	HOUR	NOM	NOMINAL	SSM	SOLID SURFACE MATERIAL		
BN	BULLNOSE	ENTR	ENTRANCE	I		Ν	NORTH	STC	SOUND TRANSMISSION		
С		EQ	EQUAL	IN	INCH	NIC	NOT IN CONTRACT		COEFFICIENT		
САВ	CABINET	EQUIP	EQUIPMENT	INCL	INCLUDING	NTS	NOT TO SCALE	SPEC	SPECIFICATION		
Cl	CAST IRON	EST	ESTIMATE(D)	ID	INSIDE DIAMETER	NO, #	NUMBER	SQ	SQUARE		
СВ	CATCH BASIN OR CHALK BOARD	EXHST	EXHAUST	INSUL	INSULATION	0		SS	STAINLESS STEEL		
CLG	CEILING	EXIST	EXISTING	INT	INTERIOR	ОС	ON CENTER	STD	STANDARD		
CLG HT	CEILING HEIGHT	EXP	EXPANSION	INTERM	INTERMEDIATE	OPNG	OPENING	STL	STEEL		
CL	CENTER LINE	EJ	EXPANSION JOINT	INV	INVERT	OD	OUTSIDE DIAMETER	STOR	STORAGE		
CER	CERAMIC	F		J		ОН	OVERHEAD	SGFT	STRUCTURAL GLAZED FACING TIL	•	
CIRC		FAB	FABRICATE	JAN	JANITOR	Р		ST STL	STRUCTURAL STEEL		
СО		FT	FEET	JS	JANITOR SINK	PT	PAINT(ED)	STRUCT	STRUCTURE, STRUCTURAL		
CLR	CLEAR	FIG	FIGURE	JT	JOINT	PR	PAIR	SUSP	SUSPENDED		
COL		FIN	FINISH	K		PTR	PAPER TOWEL RECEPTOR	SAT	SUSPENDED ACOUSTICAL TILE		
CONC	CONCRETE	FF	FINISH FLOOR	KIT	KITCHEN	PKG	PARKING	T			
CMU		FEC	FIRE EXTINGUISHER CABINET	L		PART BD	PARTICLE BOARD	TEL	TELEPHONE		
CONST		FH	FIRE HOSE	LBL	LABEL	PART	PARTITION	TEMP	TEMPERATURE		
CJT		FL,FLR	FLOOR	LAB	LABORATORY	PVMT	PAVEMENT	THK	THICKNESS		
CONT		FD	FLOOR DRAIN	LAM	LAMINATE(D)	PL	PLATE	TPD	TOILET PAPER DISPENSER		
CONTR		FTG	FOOTING	LAV	LAVATORY	PLBG	PLUMBING	TOS	TOP OF SLAB/STEEL		
CJ		FND	FOUNDATION	LYR	LAYER	PLYWD	PLYWOOD	TOW	TOP OF WALL	1	

MATERIAL SYMBOLS PICID INSIII ATIO 1 LIB DATING

	<u>EARTH</u>	<u>Brick</u>		RIGID INSULATION	1 HR RATING
	GYPSUM BOARD	STEEL		BATT OR LOOSE INSULATION	2 HR RATING
	GRAVEL TYPE 1 (ENGINEERED FILL)	GROUT		CAVITY DRAINAGE MAT	 SMOKE RATING
- 'A' A'	PRECAST CONCRETE	ROUGH WOOD BLOCKING		<u>ALUMINUM</u>	EXISTING BUILDING MATERIALS
	CRUSHED STONE	ROUGH WOOD BLOCKING, NON-CONTINUOUS		STANDING SEAM ROOF	
	CONCRETE MASONRY UNIT (CMU)	WOOD, FINISHED WOODWORK	\(\tag{+} \)	CONCRETE, POURED	
	METAL STUD PARTITION	PLYWOOD (LARGE SCALE)		<u>TERRAZZO</u>	

LOCATION PLAN

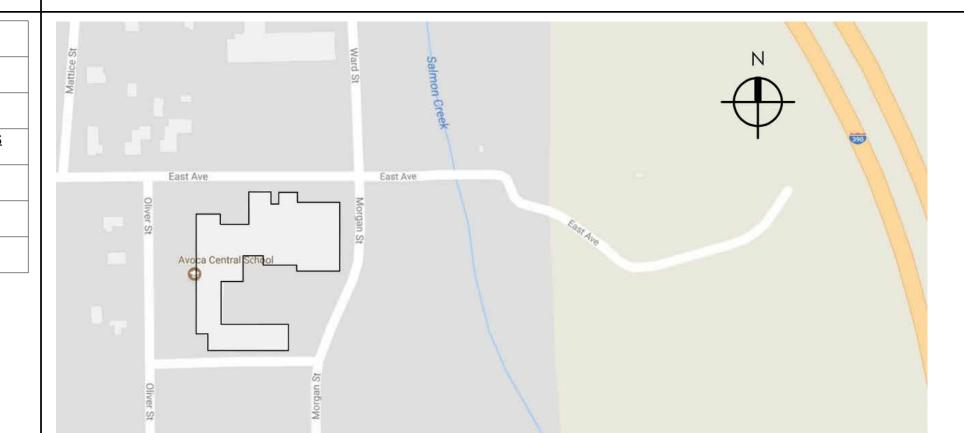


SED USE ONLY

SHEET INFORMATION

11/03/2025

PROFESSIONAL STAMPS

CONSTRUCTION DOCUMENTS

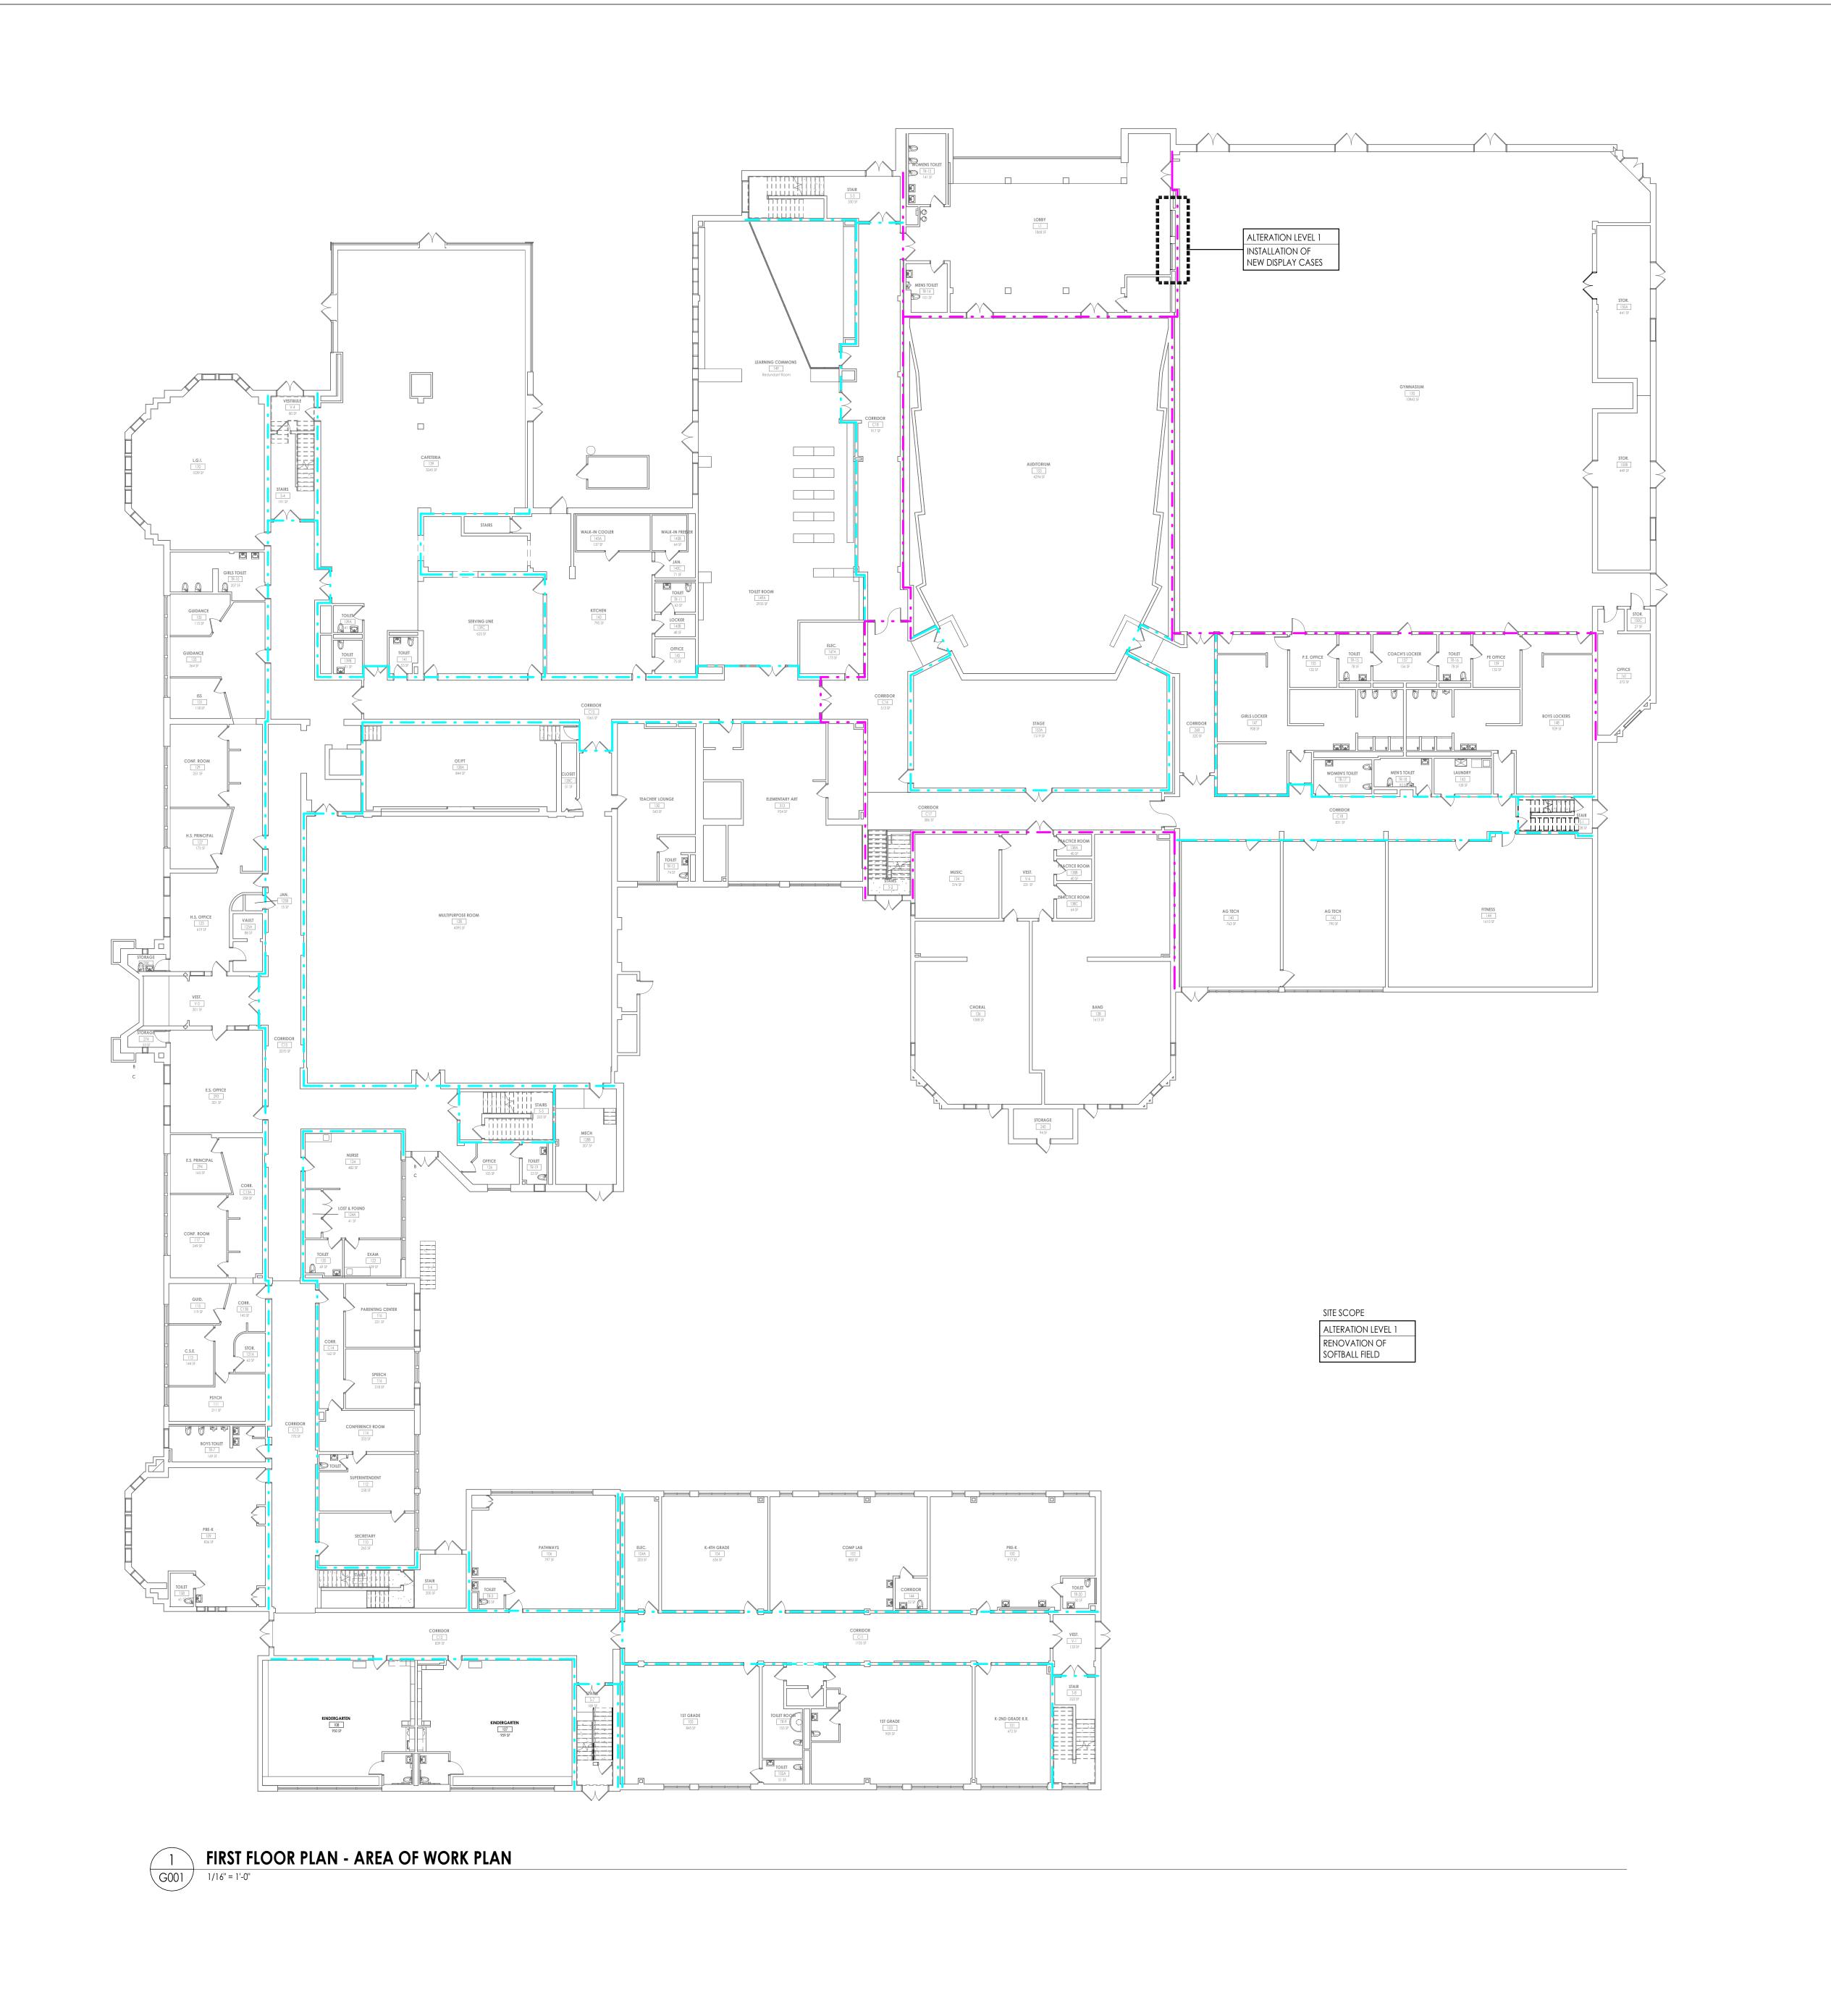

F WORK KEY STRUCTION TO REMAIN RATION - LEVEL 1 L LEGEND ACCESSIBLE BUILDING ENTRANCE EXIT EXIT UNITS
EXIT UNITS
EXIT UNITS
L LEGEND ACCESSIBLE BUILDING ENTRANCE EXIT EXIT UNITS
ACCESSIBLE BUILDING ENTRANCE EXIT EXIT UNITS
ACCESSIBLE BUILDING ENTRANCE EXIT EXIT UNITS
EXIT EXIT UNITS
EXIT UNITS
EVIT ACCESS DOOD
EXIT ACCESS DOOR
EXIT DISCHARGE
HORIZONTAL EXIT
EXIT SIGN
ROOM NAME ROOM NUMBER ROOM AREA
PROVIDED WIDTH
REQUIRED WIDTH
ANTICIPATED LOAD
CLEAR WIDTH
REQUIRED WIDTH ANTICIPATED LOAD
AREA OF REFUGE
RESCUE WINDOW
TRAVEL DISTANCE TO EXIT
COMMON PATH OF EGRESS DISTANCE
MAXIMUM TRAVEL DISTANCE TO EXIT
MAXIMUM COMMON PATH OF EGRESS
DEAD END DISTANCE
NON-RATED SMOKE TIGHT BARRIER 1 HOUR FIRE RATED & SMOKE BARRIER
1 HOUR RATED FIRE PARTITION
1 HOUR RATED FIRE BARRIER
2 HOUR RATED FIRE BARRIER
2 HOUR RATED BUILDING SEPARATION
SUITES
STOREFRONT IN SMOKE PARTITION EXIT ACCESS CORRIDOR
EXISTING FIRE EXTINGUISHER/HOSE CABINE
CONDITIONS.
NEW FIRE EXTINGUISHER/HOSE CABINET CONDITIONS
PUBLIC TELEPHONE
ACCESSIBLE PUBLIC TELEPHONE
1 HR RATED FLOOR ASSEMBLY - UL-D902

FIRE SHUTTER

1 HR

PROFESSIONAL STAMPS



CPL | Architecture Engineering Planning 255 Woodcliff Drive Suite 200, Fairport, NY 14450

CPLteam.com

NY ENGINEERING FIRM CERTIFICATE #0021419

PROJECT INFORMATION

AVOCA CENTRAL SCHOOL

2025-2026 CAPITAL OUTLAY

District Office Address
17 OLIVER STREET AVOCA, NEW YORK 14809

EXCEPTION PROJECT

MAIN BUILDING: 57-02-01-04-0-002-027

R25.17323.00

SHEET INFORMATION

Issued Scale
11/03/2025 As indicated
Project Status
CONSTRUCTION DOCUMENTS
Drawn By Checked By
SAY KLH
Drawing Title
FIRST FLOOR AREA OF WORK
PLAN

MB G001



USE AND OCCUPANCY CLASSIFICATION CLASSIFICATION OF WORK KEY EXISTING CONSTRUCTION TO REMAIN CPL | Architecture Engineering Planning 255 Woodcliff Drive Suite 200, Fairport, NY 14450

AREAS OF ALTERATION - LEVEL 1

CPLteam.com NY ENGINEERING FIRM CERTIFICATE #0021419

PROJECT INFORMATION

R25.17323.00

AVOCA CENTRAL SCHOOL Project Name

2025-2026 CAPITAL OUTLAY

EXCEPTION PROJECT

District Office Address
17 OLIVER STREET AVOCA, NEW YORK 14809


MAIN BUILDING: 57-02-01-04-0-002-027



SHEET INFORMATION

11/03/2025 Project Status CONSTRUCTION DOCUMENTS

SECOND FLOOR AREA OF WORK

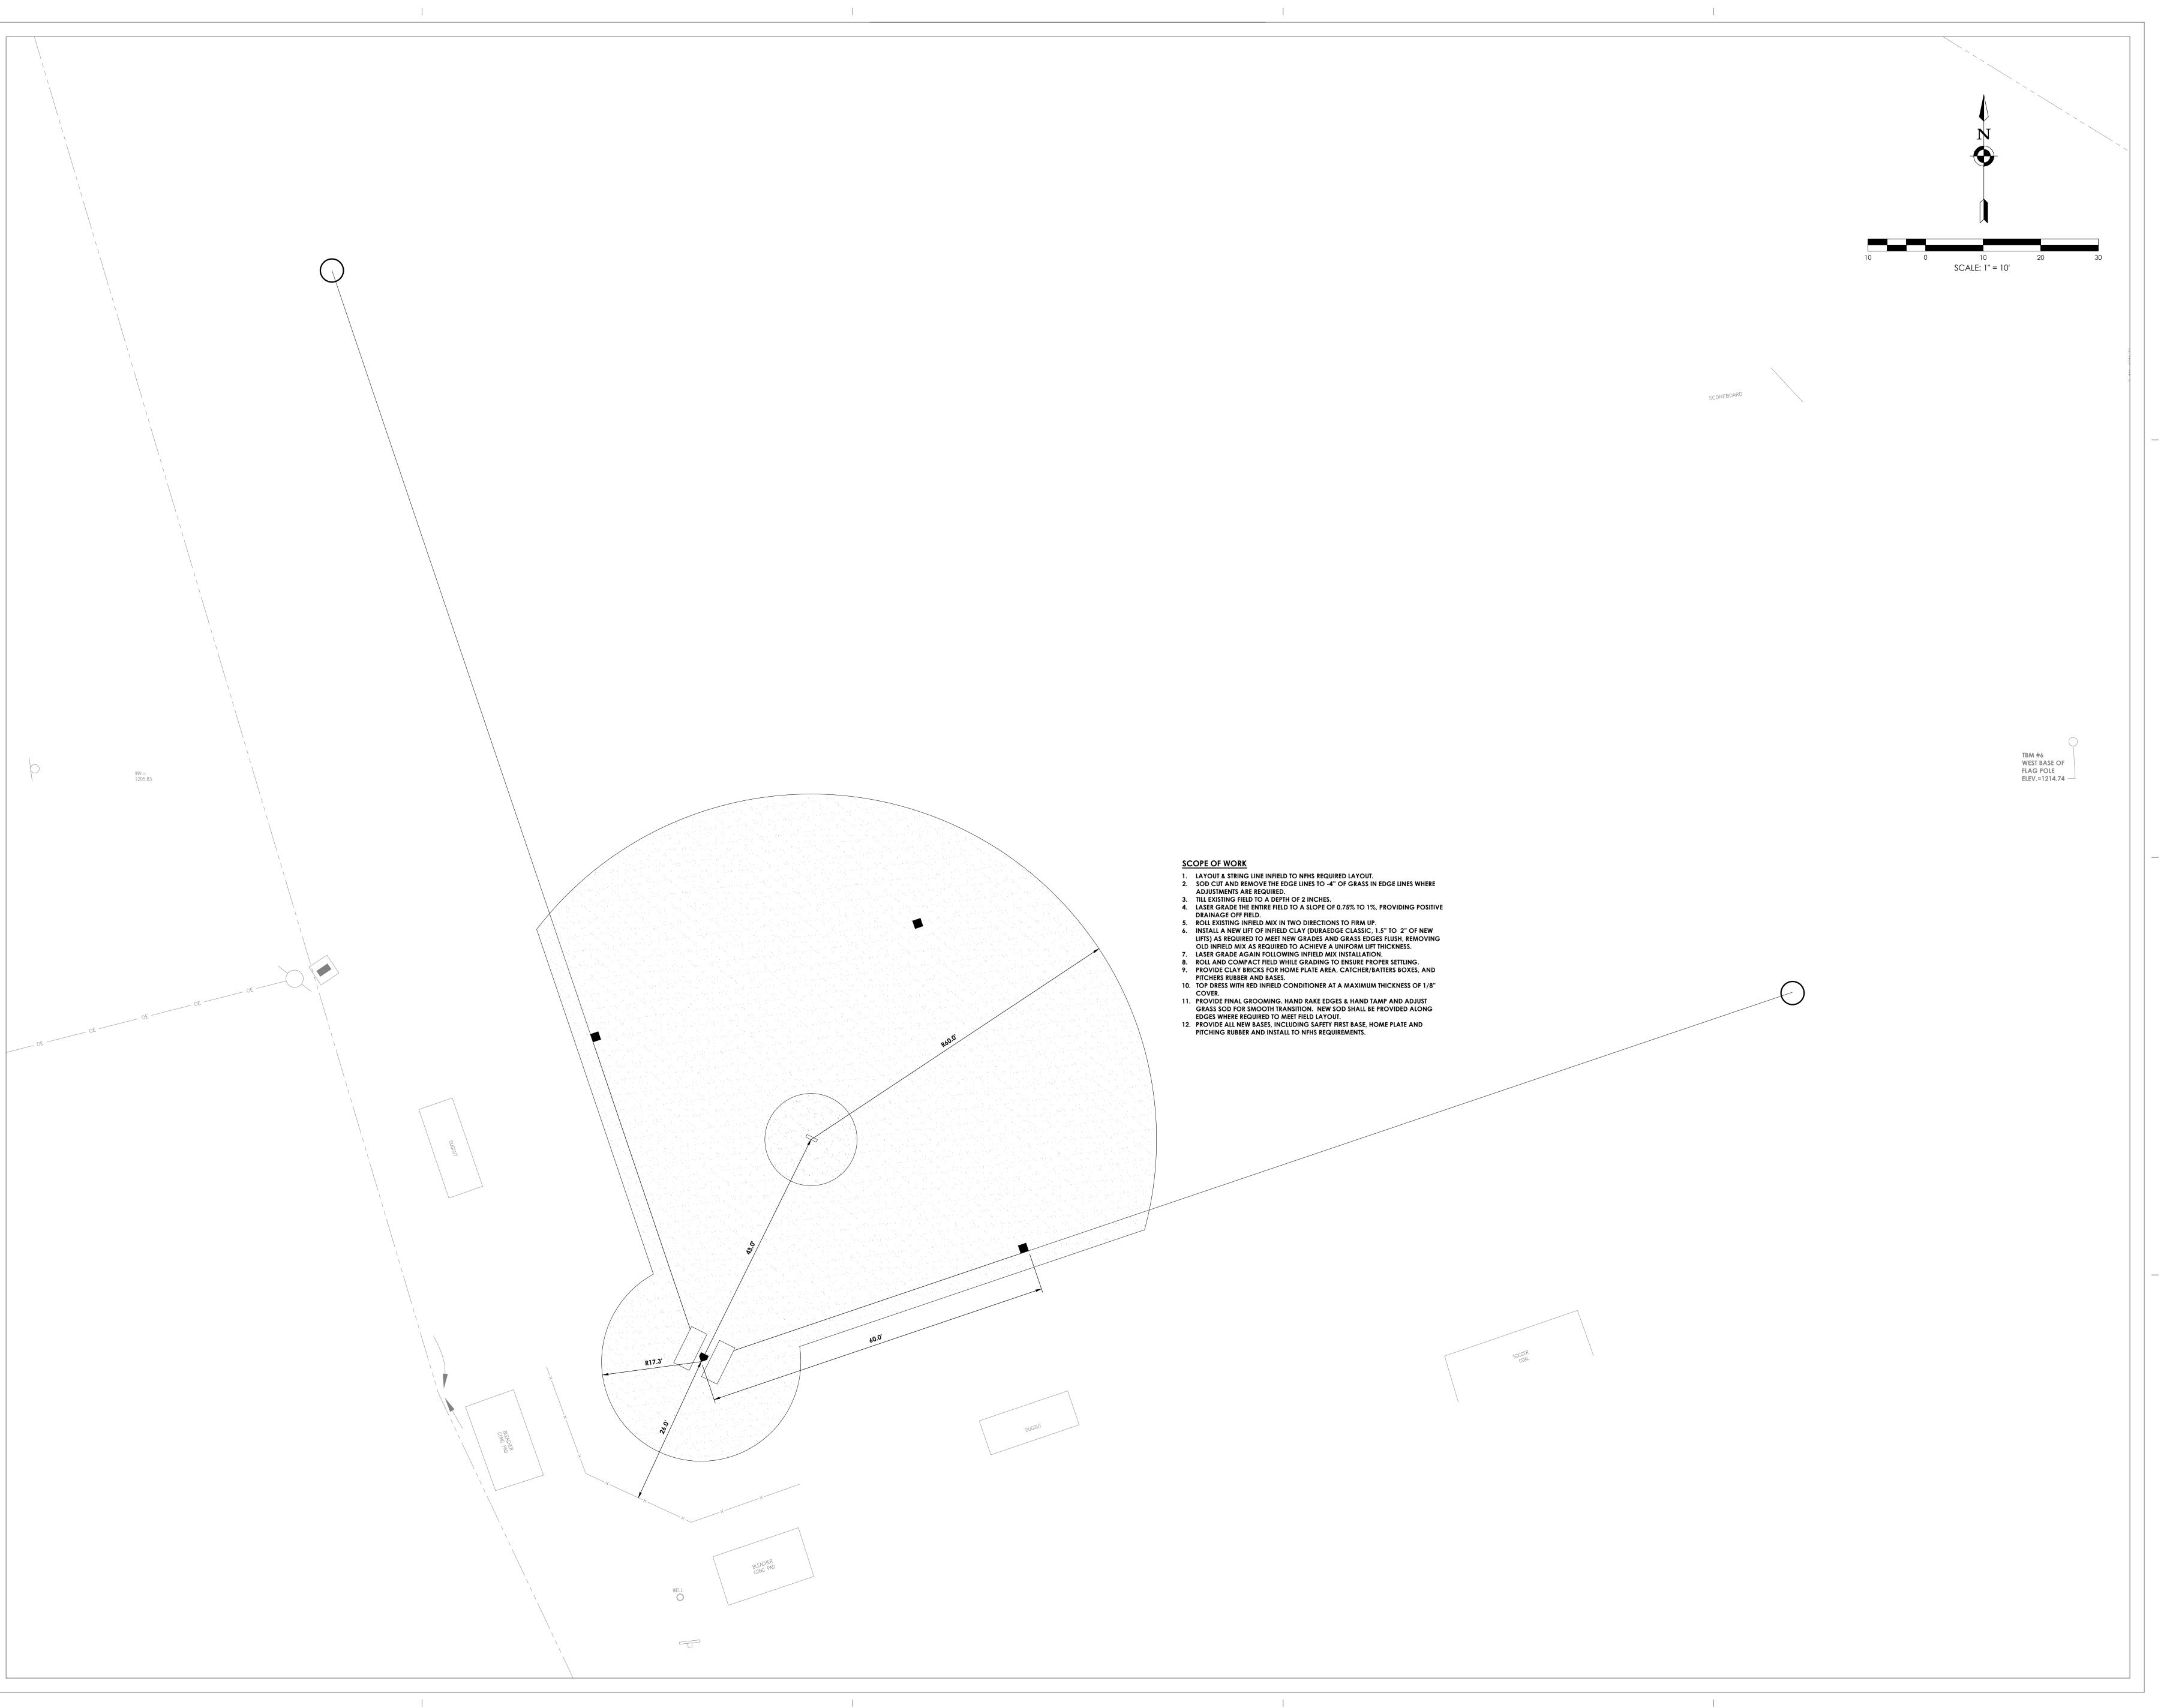



255 Woodcliff Drive, Suite 200 Fairport, NY 14450 CPLteam.com NY ENGINEERING FIRM CERTIFICATE #0021419

PROJECT INFORMATION

Project Number
R25.17323.00
Client Name

AVOCA CENTRAL SCHOOL DISTRICT

2025-2026 CAPITAL OUTLAY EXCEPTION PROJECT

District Office Address 17 OLIVER ST. AVOCA, NY 14809

AVOCA CSD

MAIN BUILDING: 57-02-01-04-002-027

PRO IECT ISSUE & REVISION SCHEDULE

PROFESSIONAL STAMPS



NEW YORK STATE EDUCATION STATEMENT

IT IS A VIOLATION OF THE NEW YORK STATE EDUCATION LAW AND THE COMMISSIONER'S
REGULATIONS FOR ANY PERSON, UNLESS ACTING UNDER THE DIRECTION OF A LICENSED
ARCHITECT, ENGINEER OR LAND SURVEYOR, TO ALIER AN HEM IN ANY WAY, IF AN HEM
BEARING THE SEAL OF AN ARCHITECT, ENGINEER OR SURVEYOR IS ALTERED, THE ALTERING
PARTY SHALL AFFR TO THE HEM THER SEAL AND THE NOTATION "ALTERED BY" FOLLOWED BY
THER SIGNATURE AND THE DATE OF SUCH ALTERATION, AND A SPECIFIC DESCRIPTION OF THE
ALTERATION.

SHEET INFORMATION

Issued Scale

11/03/2025 1" = 10'

Project Status Civil Revision Number


CONSTRUCTION DOCUMENTS

Drawn By Checked By

MN NG

Drawing Title
SITE PLAN

MB

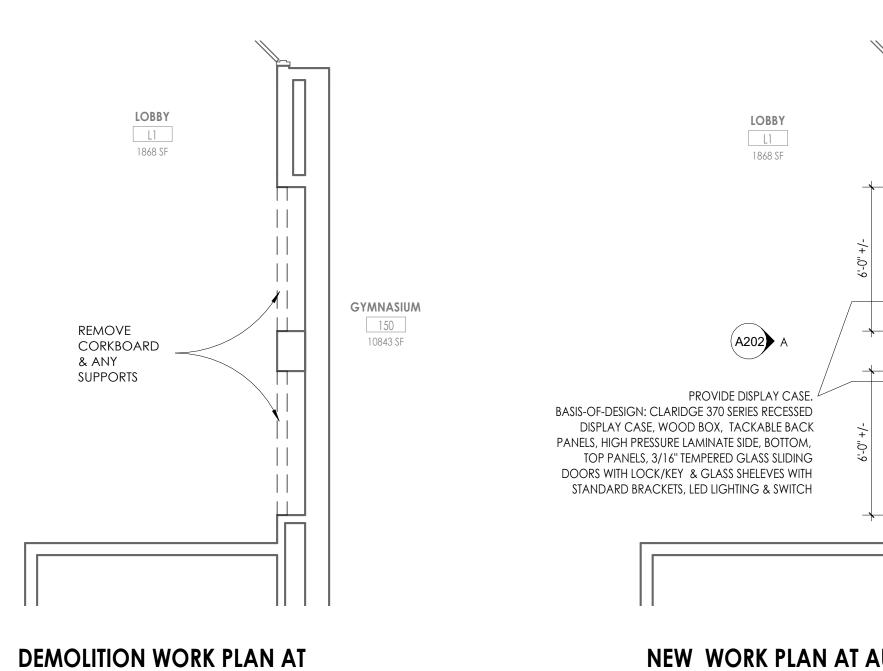




ELECTRICAL NOTE FOR BOTH DISPLAY CASES: CIRCUIT NEW DISPLAY CASE LIGHTING TO EXISTING DISPLAY CASE BRANCH CIRCUIT WITHIN LOBBY WITH (2)#12, #12GND IN 1/2" CONDUIT. NEW DISPLAY CASE LIGHTING SHALL

BE CONTROLLED WITH EXISTING DISPLAY CASES

VIA EXISTING WALL MOUNTED KEYED SWITCH

WITHIN LOBBY.

GYMNASIUM

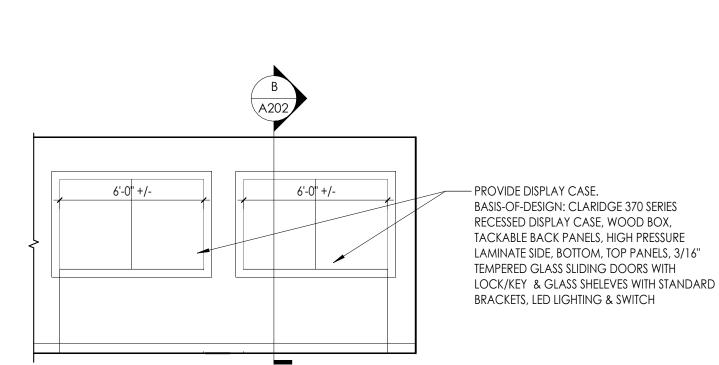



— SCHEDULED PARTITION




AUDITORIUM LOBBY- FIRST FLOOR

A202 1/4" = 1'-0"

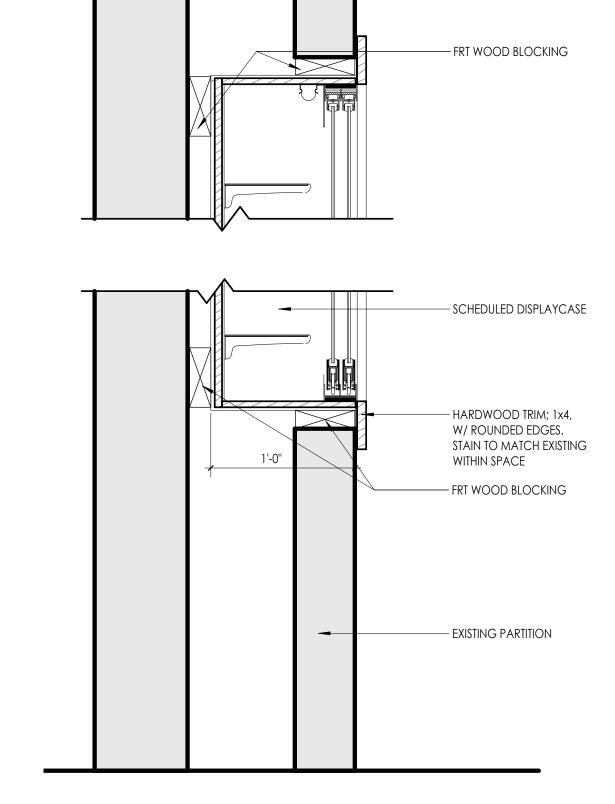

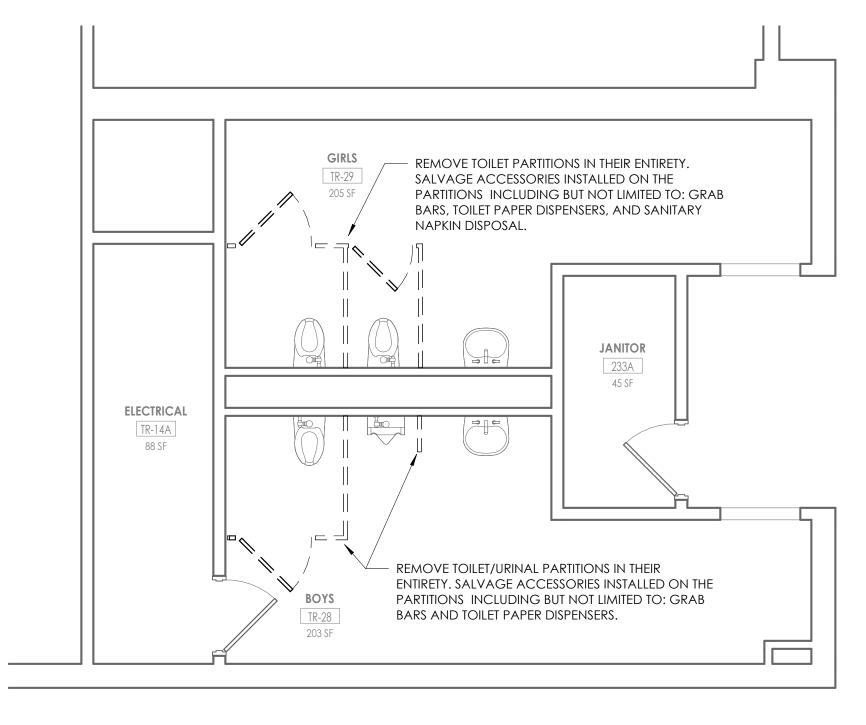



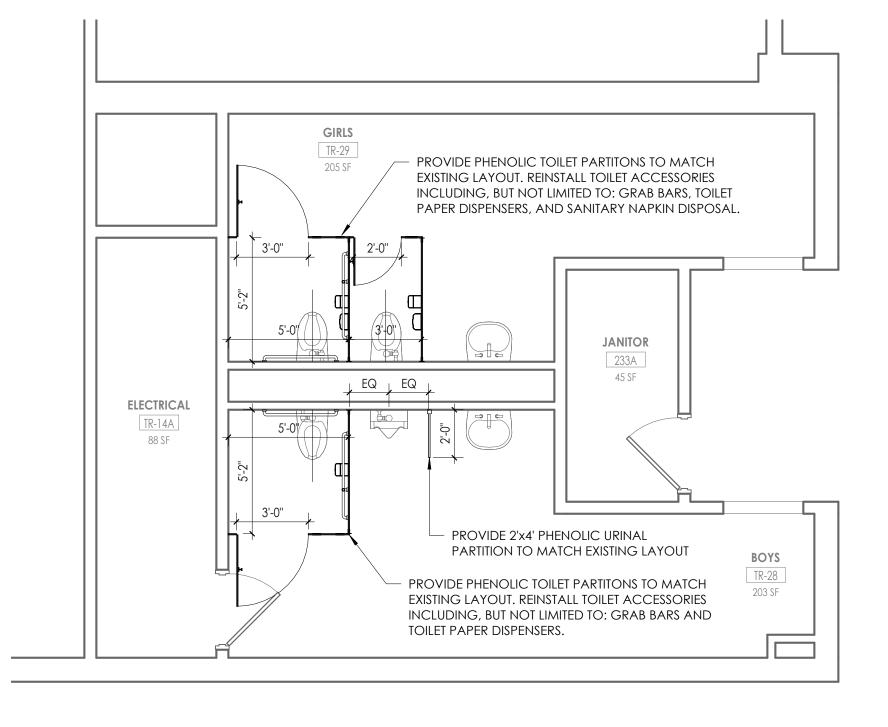



DEMOLITION GENERAL NOTES

- ALL DRAWINGS ARE GRAPHIC REPRESENTATION OF APPROXIMATE LOCATIONS OF MATERIALS TO BE REMOVED. IT IS THE CONTRACTORS RESPONSIBILITY TO FIELD VERIFY ALL EXISTING CONDITIONS & DIMENSIONS PRIOR TO COMMENCEMENT OF ALL
- DEMOLITION WORK. ALL ITEMS TO BE SALVAGED WITHIN THE DEMOLITION AREA WILL BE REMOVED BY THE OWNER PRIOR TO ONSET OF DEMOLITION WORK UNLESS OTHERWISE NOTED. REMAINING SUBSTRATES SHALL BE LEFT IN A CONDITION ACCEPTABLE TO RECEIVE NEW WORK. WHERE NEW FINISHES ARE SCHEDULED AT EXISTING CONDITIONS, REMOVE EXISTING FINISHES DOWN TO SUBSTRATE AMD PREPARE SURFACE FOR NEW FINISH.
- I. THE CONTRACTOR IS RESPONSIBLE FOR DAMAGE TO ANY EXISTING FINISHES AND EQUIPMENT NOT REMOVED UNDER THE SCOPE OF WORK. ANY DAMAGE WILL BE REPAIRED TO THE OWNER/ARCHITECT'S SATISFACTION. WORK AREAS SHALL BE MAINTAINED AND ALL WORK AREAS SHALL BE LEFT BROOM CLEANED AT END OF EACH DAY.
- OWNER HAS THE RIGHT TO SALVAGE ANY FIXTURES AND/OR MILLWORK WITHIN AN AREA OF DEMOLITION PRIOR TO CONTRACTOR STARTING WORK IN THAT ZONE. COORDINATE TIMING OF SUCH REMOVALS WITH OWNER.

CONTRACTOR FOR REQUIRED TESTING AND/OR REMOVALS.

IN THE CASE THAT ANY SUSPICIOUS MATERIALS ARE UNCOVERED THAT APPEAR TO CONTAIN HAZARDOUS MATERIALS SUCH AS BUT NOT LIMITED TO MOLD, LEAD PAINT OR ASBESTOS, LEAVE THE PREMISES AND NOTIFY THE OWNER & ABATEMENT

FLOOR PLAN GENERAL NOTES

OF EQUIPMENT AND ACCESSORIES.

- CONTRACTOR TO PROVIDE ADEQUATE WALL BLOCKING FOR ALL WALL-MOUNTED CABINETS, FIXTURES, ACCESSORIES, AND EQUIPMENT, INCLUDING ITEMS FURNISHED BY OTHERS. REFER TO TYPICAL FIXTURE AND ACCCESSORY LEGENDS. PATCH AND FINISH ALL EXISTING WALLS TO REMAIN WITHIN THE PROJECT LIMIT AREA TO RECEIVE SPECIFIED FINISHES. PROVIDE CONCRETE FLOOR PATCH AND FLOOR LEVELING AT EXISTING CONCRETE
- FLOORS FOR NEW FINISHES. 4. ALL EXISTING EXPANSION JOINT COVERS OR ASSEMBLIES ARE TO BE PROTECTED AND MAINTAINED DURING THE COURSE OF CONSTRUCTION UNLESS NOTED OTHERWISE. COORDINATE WITH OTHER TRADES FOR SEQUENCING OF WORK. REFER TO TYPICAL FIXTURE & ACCESSORIES LEGEND FOR FURNISH AND INSTALL SCOPE
- EQUIPMENT SHOWN ON THESE DOCUMENTS IS FOR REFERENCE ONLY AND IS FOR COORDINATION OF REQUIRED MEP INFRASTRUCTURE. REFER TO OWNER FURNISHED EQUIPMENT DRAWINGS AND SUBMITTALS FOR FINAL COORDINATION AND INSTALLATION REQUIREMENTS INCLUDING BUT NOT LIMITED TO: DIMENSIONS, LOCATIONS & MEP CONNECTION LOCATIONS.
- 8. ALL FURNITURE IS PROVIDED BY OWNER, UNLESS NOTED OTHERWISE. 9. CONSULT WITH ARCHITECT TO FINALIZE LOCATIONS OF ANY EXPOSED CONTROL JOINTS PRIOR TO INSTALLATION.
- 10. ALL QUANTITIES / SQUARE FOOTAGES SHOWN ARE FOR REFERENCE ONLY AND ARE TO BE VERIFIED BY THE CONTRACTOR.

PROJECT INFORMATION

R25.17323.00

AVOCA CENTRAL SCHOOL

CPL | Architecture Engineering Planning

255 Woodcliff Drive Suite 200,

Fairport, NY 14450

CPLteam.com

NY ENGINEERING FIRM CERTIFICATE #0021419


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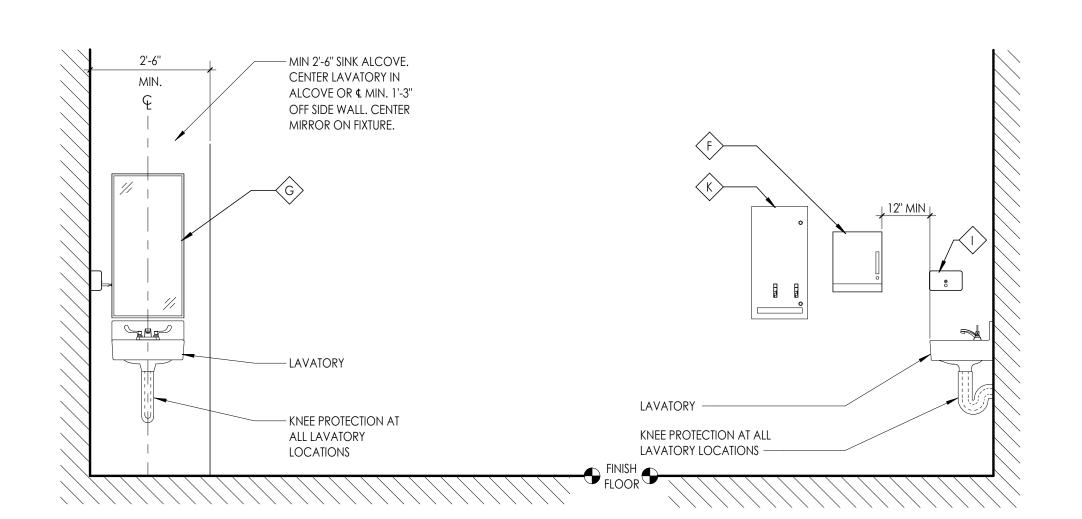
Date Description

TYPICAL TOILET AND SHOWER ACCESSORY LOCATIONS




LOCATION AT TOILET

(REF. ABOVE FOR TYP. HEIGHTS) SCALE 1/2"=1'-0"

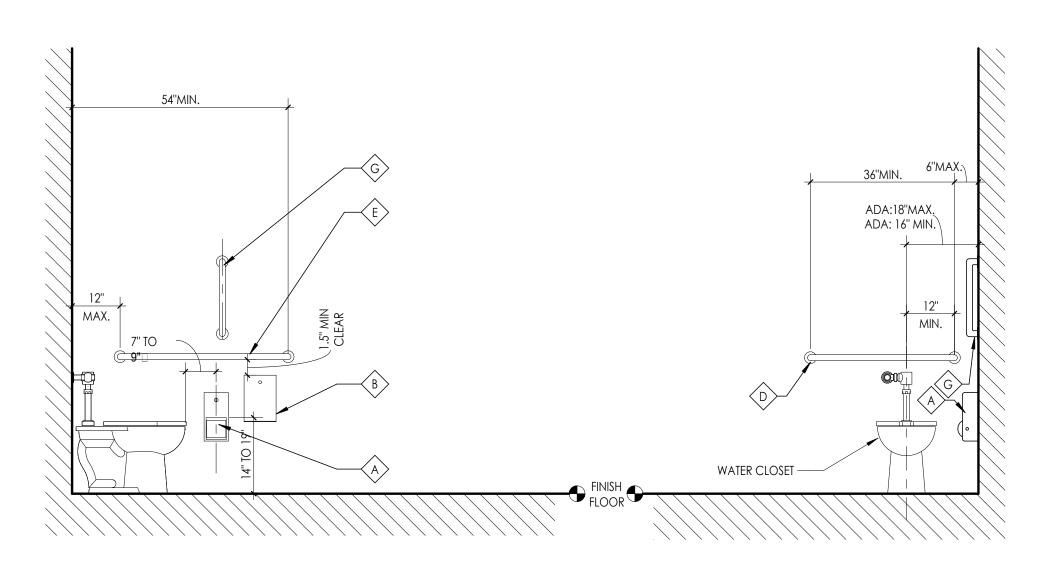

LOCATION AT SINK

SCALE 1/2"=1'-0" (REF. ABOVE FOR TYP. HEIGHTS)

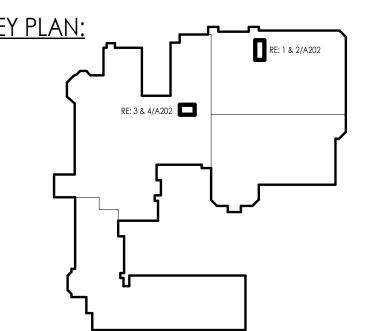

SHEET INFORMATION 11/03/2025 Project Status CONSTRUCTION DOCUMENTS

PROFESSIONAL STAMPS

LICENSE EXPIRATION DATE: 07/31/2027

DEMOLITION AND NEW WORK